
## EROSION CONTROL LEGEND

4 4	TEMPORARY EROSION CONTROL SEEDING AND MULCH METHOD 2	-\$-	TEMPORARY DITCH CHECK	1.	SEE PROPOSED DRAINAGE PLANS FOR STORM SEWER INFORMATION.
	TEMPORARY EROSION CONTROL SEEDING AND TEMPORARY EROSION CONTROL BLANKET	-\$-	TEMPORARY DITCH CHECK INSTALLED IN PREVIOUS STAGE	2.	PERIMETER EROSION BARRIER SHALL BE ERECTED ADJACENT TO R.O.W., EASEMENT, AND CONSTRUCTION LIMITS AND AS DIRECTED
	PERMANENT SEEDING (SEE NOTE 3)	⊕	INLET & PIPE PROTECTION		BY THE ENGINEER.
	TEMPORARY EROSION CONTROL SEEDING OR PERMANENT SEEDING INSTALLED IN A PREVIOUS STAGE	÷	INLET & PIPE PROTECTION INSTALLED IN PREVIOUS STAGE		SEE LANDSCAPING PLANS FOR LANDSCAPING REQUIREMENTS.
	TEMPORARY PAVEMENT	-~>	FLOW DIRECTION (SEE NOTE 4)	4.	SEE STAGE 1 CROSS SECTIONS FOR GRADING INFORMATION.
	PERIMETER EROSION BARRIER (SEE NOTE 2)	<b>bb</b>	PROPOSED STORM SEWER (SEE NOTE 1)		
	PERIMETER EROSION BARRIER INSTALLED IN PREVIOUS STAGE	►►	PROPOSED STORM SEWER INSTALLED IN PREVIOUS STAGE		
$\Leftrightarrow$	INLET FILTER	<u>&gt;</u> >	TEMPORARY PIPE CULVERT		
$\Leftrightarrow$	INLET FILTER INSTALLED IN PREVIOUS STAGE	27)	PERMANENT DRAINAGE STRUCTURE NUMBER (SEE NOTE 1)		

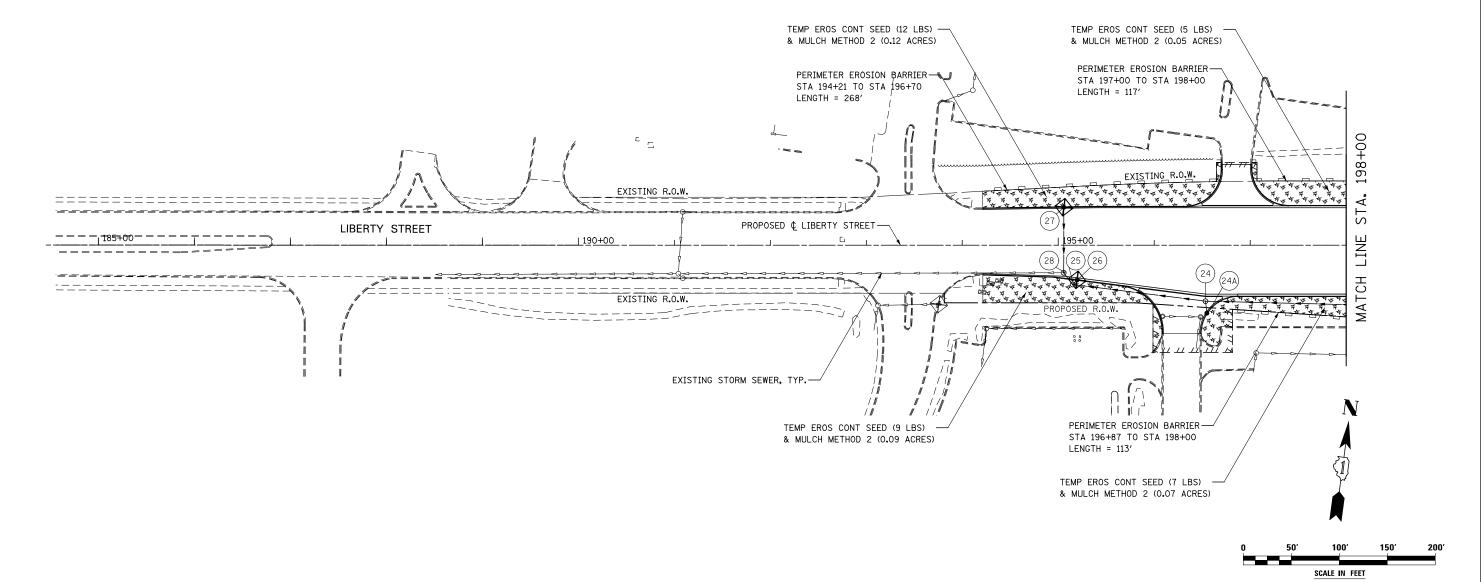

				SCALE IN FEET	
DESIGNED PJO	REVISED -	STATE OF ILLINOIS DEPARTMENT OF TRANSPORTATION	EROSION CONTROL – STAGE 1, 1A, 1B, 1C AND 1D	F.A.P. RTE. SECTION	COUNTY TOTAL SHEE
DRAWN KES	REVISED -		LIBERTY STREET	338 (112 & 113) WRS-7	DUPAGE 1156 713
CHECKED JCM	REVISED -				CONTRACT NO. 60R30
DATE 12/14	/2012 REVISED -		SCALE: AS SHOWN SHEET NO. 23 OF 70 SHEETS STA. 185+00 TO STA. 198+00	ILLINOIS FED. AID	PROJECT

## NOTES

ON.