
## EROSION CONTROL LEGEND NOTES TEMPORARY EROSION CONTROL SEEDING <u>и и и и и</u> 444444444 и и и и и -⊕-1. SEE PROPOSED DRAINAGE PLANS FOR STORM SEWER INFORMATION. TEMPORARY DITCH CHECK AND MULCH METHOD 2 TEMPORARY EROSION CONTROL SEEDING TEMPORARY DITCH CHECK INSTALLED 2. PERIMETER EROSION BARRIER SHALL BE ERECTED ADJACENT TO AND TEMPORARY EROSION CONTROL BLANKET IN PREVIOUS STAGE R.O.W., EASEMENT, AND CONSTRUCTION LIMITS AND AS DIRECTED BY THE ENGINEER. ⊕ PERMANENT SEEDING (SEE NOTE 3) INLET & PIPE PROTECTION 3. SEE LANDSCAPING PLANS FOR LANDSCAPING REQUIREMENTS. ⊕ TEMPORARY EROSION CONTROL SEEDING OR PERMANENT INLET & PIPE PROTECTION INSTALLED SEEDING INSTALLED IN A PREVIOUS STAGE IN PREVIOUS STAGE 4. SEE STAGE 1 CROSS SECTIONS FOR GRADING INFORMATION. TEMPORARY PAVEMENT FLOW DIRECTION (SEE NOTE 4) \_~> 5. PROPOSED STRUCTURE SHALL BE BURIED AND TEMPORARILY COVERED/CLOSED WITH STEEL PLATE OF THICKNESS SPECIFIED PERIMETER EROSION BARRIER (SEE NOTE 2) PROPOSED STORM SEWER (SEE NOTE 1) AND APPROVED BY THE ENGINEER. PAYMENT FOR THIS TEMPORARY COVER INSTALLATION AND REMOVAL SHALL BE CONSIDERED PERIMETER EROSION BARRIER INSTALLED PROPOSED STORM SEWER INSTALLED INCLUDED IN THE COST OF THE PROPOSED STRUCTURE. IN PREVIOUS STAGE IN PREVIOUS STAGE $\oplus$ INLET FILTER TEMPORARY PIPE CULVERT PERMANENT DRAINAGE STRUCTURE $\bigoplus$ INLET FILTER INSTALLED IN PREVIOUS STAGE (27) NUMBER (SEE NOTE 1)

(\*) - SEE NOTE 5

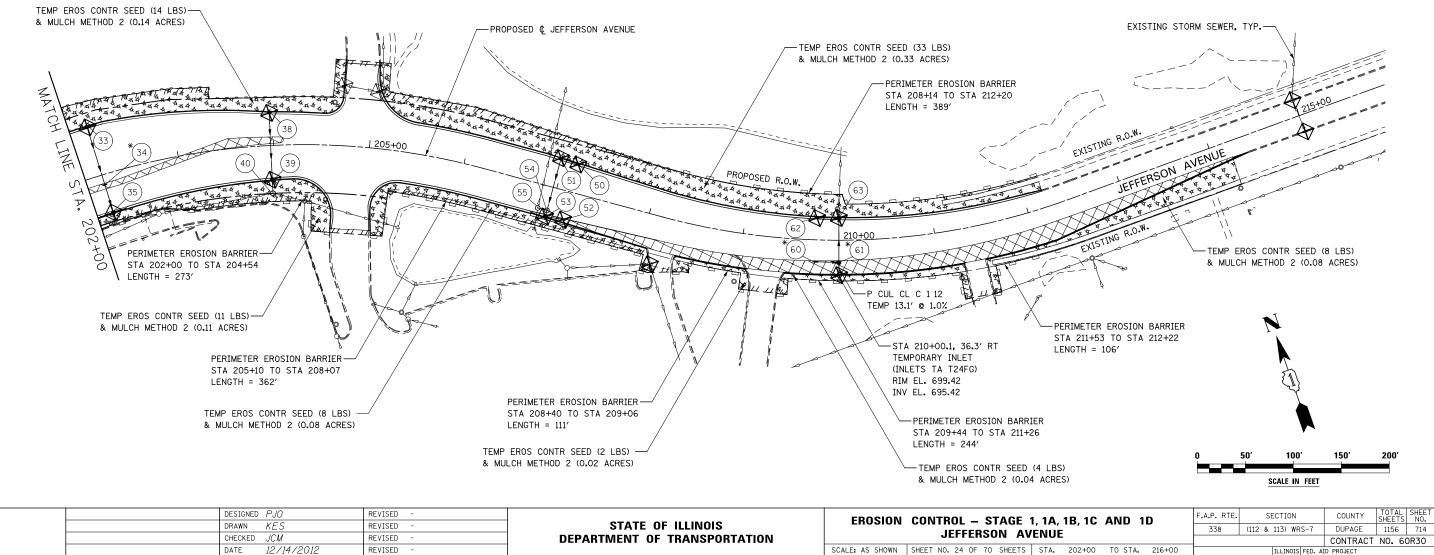

SCALE: AS SHOWN SHEET NO. 24 OF 70 SHEETS STA. 202+00 TO STA. 216+00