



## NOTES

- 1. SEE PROPOSED DRAINAGE PLANS FOR STORM SEWER INFORMATION.
- PERIMETER EROSION BARRIER SHALL BE ERECTED ADJACENT TO R.O.W., EASEMENT, AND CONSTRUCTION LIMITS AND AS DIRECTED BY THE ENGINEER.
- 3. SEE LANDSCAPING PLANS FOR LANDSCAPING REQUIREMENTS.
- 4. SEE STAGE 2 CROSS SECTIONS FOR GRADING INFORMATION.
- 5. PROPOSED STRUCTURE SHALL BE BURIED AND TEMPORARILY COVERED/CLOSED WITH STEEL PLATE OF THICKNESS SPECIFIED AND APPROVED BY THE ENGINEER. PAYMENT FOR THIS TEMPORARY COVER INSTALLATION AND REMOVAL SHALL BE CONSIDERED INCLUDED IN THE COST OF THE PROPOSED STRUCTURE.
- STORM SEWERES TO BE FULLY CONSTRUCTED ACROSS ENTIRE ROADWAY, USING A SINGLE LANE NIGHT TIME CLOSURE.

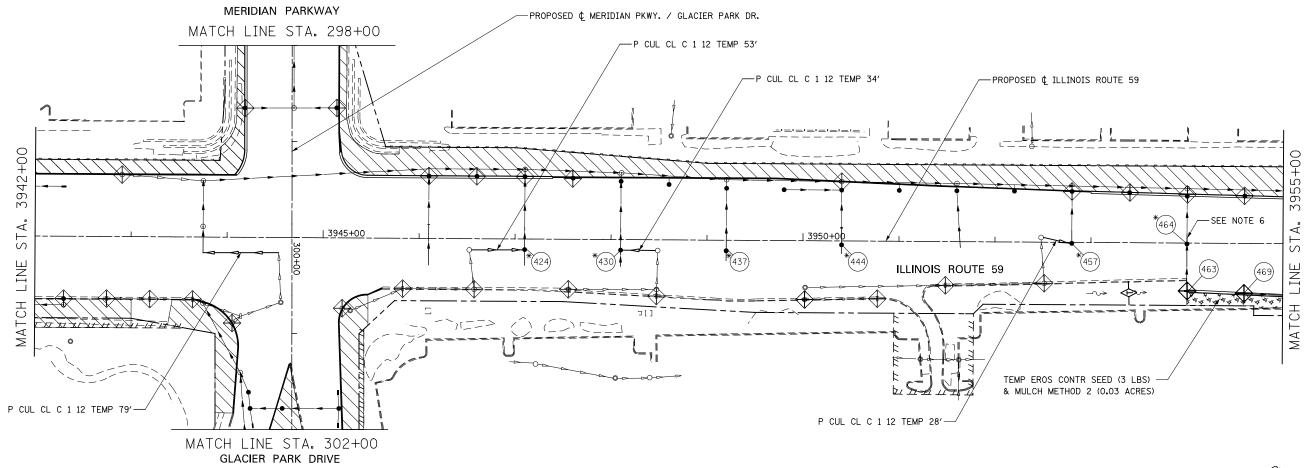

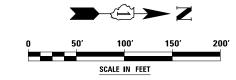

DESIGNED PJO	REVISED -		EROSION CONTROL – STAGE 2, 2A AND 2B	F.A.P. RTE.	SECTION	COUNTY	TOTAL SHEET SHEETS NO.
DRAWN KES	REVISED -	STATE OF ILLINOIS	ILLINOIS ROUTE 59	338	(112 & 113) WRS-7	DUPAGE	1156 722
CHECKED JCM  DATE 12/14/2012	REVISED -	DEPARTMENT OF TRANSPORTATION	SCALE: AS SHOWN SHEET NO. 32 OF 70 SHEETS STA. 3942+00 TO STA. 3955+00		TILL TAILOTE EED. AT	CONTRACT	T NO. 60R30