
EROSION CONTROL LEGEND

ERUSION C	UNIRUL LEGEND		NOTES			
4 4	TEMPORARY EROSION CONTROL SEEDING AND MULCH METHOD 2	-\$	TEMPORARY DITCH CHECK	1. SEE PROPOSED DRAINAGE PLANS FOR STORM SEWER INFORMATION		
	TEMPORARY EROSION CONTROL SEEDING AND TEMPORARY EROSION CONTROL BLANKET	-\$-	TEMPORARY DITCH CHECK INSTALLED IN PREVIOUS STAGE	2. PERIMETER EROSION BARRIER SHALL BE ERECTED ADJACENT TO		
	PERMANENT SEEDING (SEE NOTE 3)	⊕	INLET & PIPE PROTECTION	R.O.W., EASEMENT, AND CONSTRUCTION LIMITS AND AS DIRECTED BY THE ENGINEER.		
	TEMPORARY EROSION CONTROL SEEDING OR PERMANENT SEEDING INSTALLED IN A PREVIOUS STAGE	÷	INLET & PIPE PROTECTION INSTALLED IN PREVIOUS STAGE	3. SEE LANDSCAPING PLANS FOR LANDSCAPING REQUIREMENTS.		
	TEMPORARY PAVEMENT	-~->	FLOW DIRECTION (SEE NOTE 4)	4. SEE STAGE 2 CROSS SECTIONS FOR GRADING INFORMATION.		
	PERIMETER EROSION BARRIER (SEE NOTE 2)	> >	PROPOSED STORM SEWER (SEE NOTE 1)			
	PERIMETER EROSION BARRIER INSTALLED IN PREVIOUS STAGE	►►_	PROPOSED STORM SEWER INSTALLED IN PREVIOUS STAGE			
\Leftrightarrow	INLET FILTER		TEMPORARY PIPE CULVERT			
\Leftrightarrow	INLET FILTER INSTALLED IN PREVIOUS STAGE	(27)	PERMANENT DRAINAGE STRUCTURE NUMBER (SEE NOTE 1)			

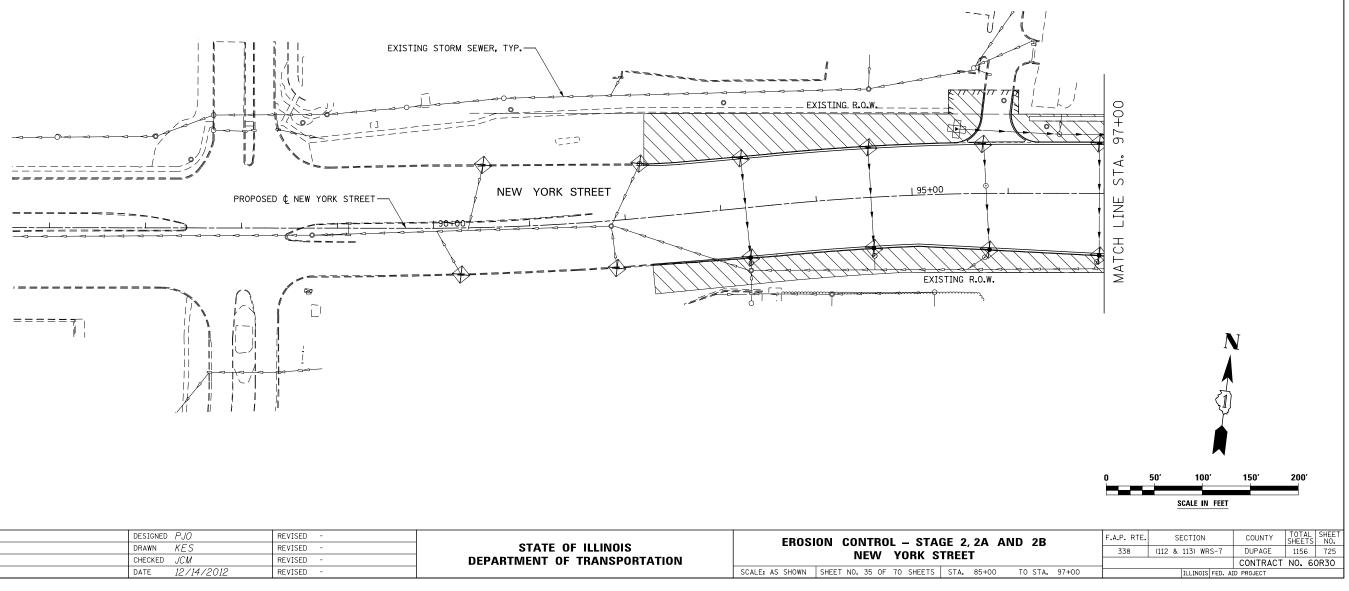

	DESIGNED PJO	REVISED -		EROSION CONTROL – STAGE 2, 2A AND 2B				
	DRAWN KES	REVISED -	STATE OF ILLINOIS					
	CHECKED JCM	REVISED -	DEPARTMENT OF TRANSPORTATION	NEW YORK STREET				
	DATE 12/14/2012	REVISED -		SCALE: AS SHOWN	SHEET NO. 35 OF 70 SHEETS	STA. 85+00	TO STA. 97+00	

DN.