
EROSION C	ONTROL LEGEND			NOTES
* * * * * * * * * * * * * * * * * * *	TEMPORARY EROSION CONTROL SEEDING AND MULCH METHOD 2	-\$-	TEMPORARY DITCH CHECK	1. SEE PROPOSED DRAINAGE PLANS FOR STORM SEWER INFORMATION.
	TEMPORARY EROSION CONTROL SEEDING AND TEMPORARY EROSION CONTROL BLANKET	{}-	TEMPORARY DITCH CHECK INSTALLED IN PREVIOUS STAGE	 PERIMETER EROSION BARRIER SHALL BE ERECTED ADJACENT TO R.O.W., EASEMENT, AND CONSTRUCTION LIMITS AND AS DIRECTED
	PERMANENT SEEDING (SEE NOTE 3)	⊕	INLET & PIPE PROTECTION	BY THE ENGINEER.
	TEMPORARY EROSION CONTROL SEEDING OR PERMANENT SEEDING INSTALLED IN A PREVIOUS STAGE	÷	INLET & PIPE PROTECTION INSTALLED IN PREVIOUS STAGE	 SEE LANDSCAPING PLANS FOR LANDSCAPING REQUIREMENTS. SEE STAGE 4 CROSS SECTIONS FOR GRADING INFORMATION.
	TEMPORARY PAVEMENT	-~>	FLOW DIRECTION (SEE NOTE 4)	
- <u></u>	PERIMETER EROSION BARRIER (SEE NOTE 2)		PROPOSED STORM SEWER (SEE NOTE 1)	
	PERIMETER EROSION BARRIER INSTALLED IN PREVIOUS STAGE	- -	PROPOSED STORM SEWER INSTALLED IN PREVIOUS STAGE	
\Leftrightarrow	INLET FILTER	> >	TEMPORARY PIPE CULVERT	
\Leftrightarrow	INLET FILTER INSTALLED IN PREVIOUS STAGE	(27)	PERMANENT DRAINAGE STRUCTURE NUMBER (SEE NOTE 1)	

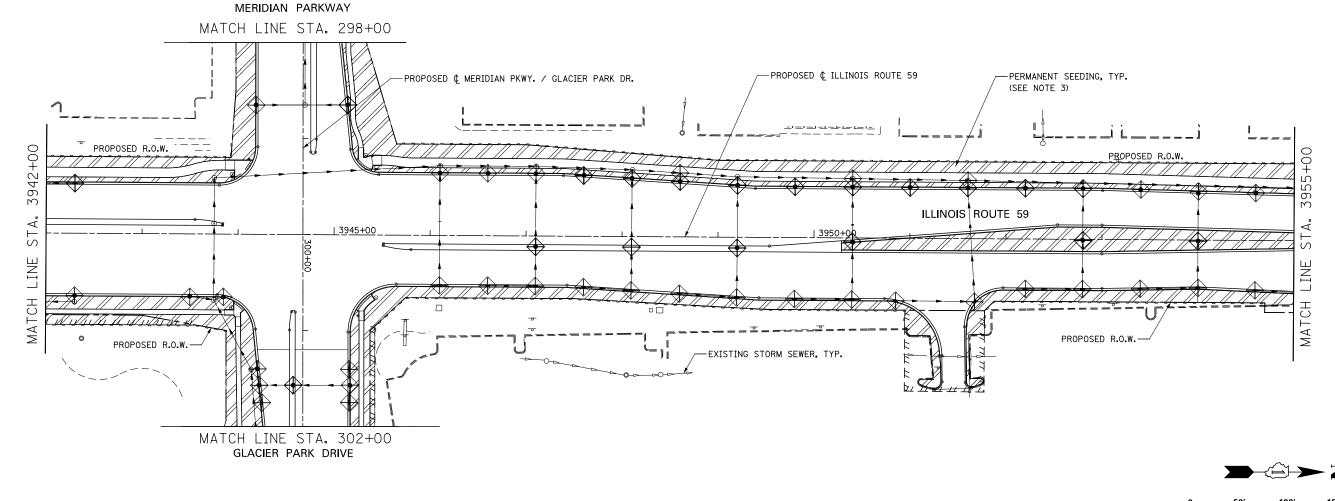

		DESIGNED PJO	REVISED -		EBOSION CONTROL - ST	
		DRAWN KES	REVISED -	STATE OF ILLINOIS	ILLINOIS ROU	
		CHECKED JCM	REVISED -	DEPARTMENT OF TRANSPORTATION	ILLINUIS RUU	
		DATE 12/14/2012	REVISED -		SCALE: AS SHOWN SHEET NO. 60 OF 70 SHEETS	

	0	50′ 100′	150′	200'			
	SCALE IN FEET						
STAGE 4 AND 4A	F.A.P. RTE.	SECTION	COUNTY	TOTAL	SHEET NO.		
OUTE 59	338	(112 & 113) WRS-7	DUPAGE	1156	750		
			CONTRACT	NO. 60	DR30		
TS STA. 3942+00 TO STA. 3955+00	ILLINOIS FED. AID PROJECT						

DN.