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(27)

INLET & PIPE PROTECTION INSTALLED

PROPOSED STORM SEWER (SEE NOTE 1)

PROPOSED STORM SEWER INSTALLED

PERMANENT DRAINAGE STRUCTURE

FLOW DIRECTION (SEE NOTE 4)

IN PREVIOUS STAGE

IN PREVIOUS STAGE

NUMBER (SEE NOTE 1)

TEMPORARY PIPE CULVERT

TEMPORARY EROSION CONTROL SEEDING OR PERMANENT SEEDING INSTALLED IN A PREVIOUS STAGE

PERIMETER EROSION BARRIER (SEE NOTE 2)

INLET FILTER INSTALLED IN PREVIOUS STAGE

DRAWN KES CHECKED JCM DATE

12/14/201

PERIMETER EROSION BARRIER INSTALLED

TEMPORARY PAVEMENT

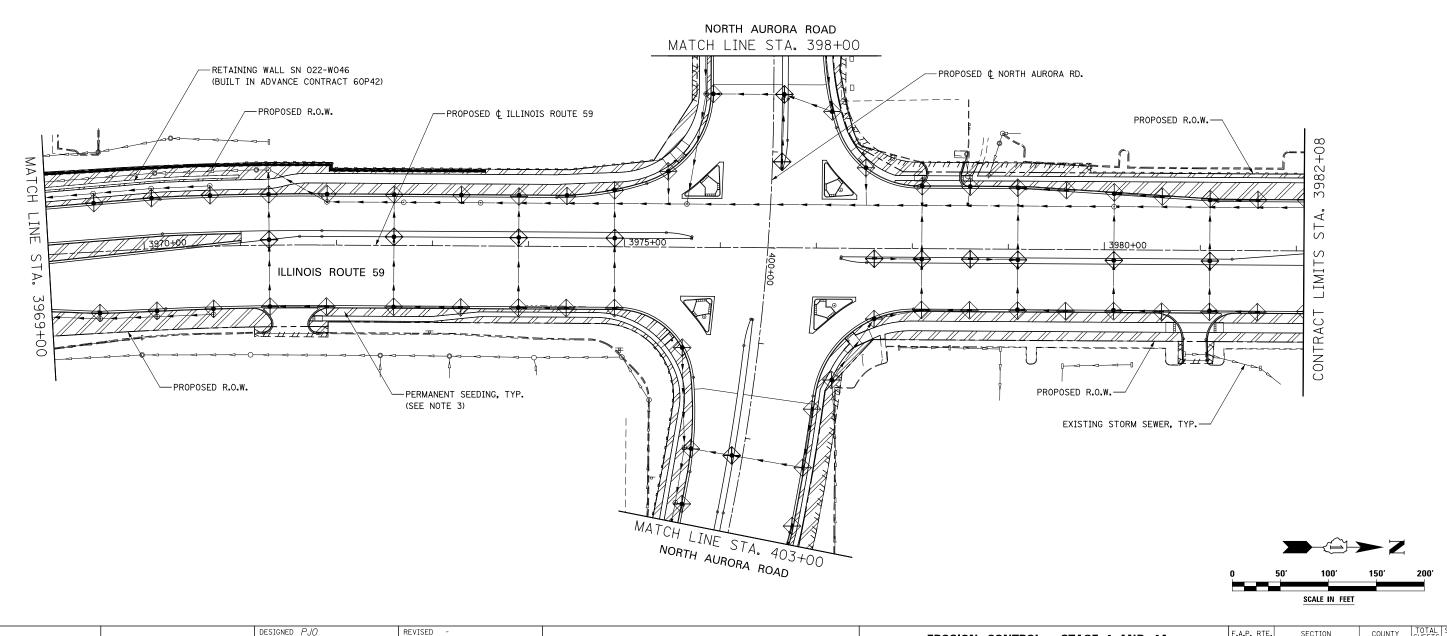
IN PREVIOUS STAGE

INLET FILTER

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- 1. SEE PROPOSED DRAINAGE PLANS FOR STORM SEWER INFORMATION.
- 2. PERIMETER EROSION BARRIER SHALL BE ERECTED ADJACENT TO R.O.W., EASEMENT, AND CONSTRUCTION LIMITS AND AS DIRECTED BY THE ENGINEER.
- 3. SEE LANDSCAPING PLANS FOR LANDSCAPING REQUIREMENTS.
- 4. SEE STAGE 4 CROSS SECTIONS FOR GRADING INFORMATION.



REVISED -	STATE OF ILLINOIS	EROSION CONTROL – STAGE 4 AND 4A Illinois Route 59				F.A.P. RTE.	SECTION	COUNTY	TOTAL	SHEET		
REVISED -						338	(112 & 113) WRS-7	DUPAGE	1156	752		
REVISED -	DEPARTMENT OF TRANSPORTATION						CONTRACT NO. 6			OR30		
REVISED -	SCALE: AS SHOWN SHEET NO. 62 OF 70 SHEETS STA. 3969+00 TO STA. 3982+08							ILLINOIS FED. AID PROJECT				