EROSION CONTROL LEGEND TEMPORARY EROSION CONTROL SEEDING AND MULCH METHOD 2 TEMPORARY DITCH CHECK TEMPORARY EROSION CONTROL SEEDING TEMPORARY DITCH CHECK INSTALLED AND TEMPORARY EROSION CONTROL BLANKET IN PREVIOUS STAGE PERMANENT SEEDING (SEE NOTE 3) INLET & PIPE PROTECTION TEMPORARY EROSION CONTROL SEEDING OR PERMANENT INLET & PIPE PROTECTION INSTALLED SEEDING INSTALLED IN A PREVIOUS STAGE IN PREVIOUS STAGE TEMPORARY PAVEMENT FLOW DIRECTION (SEE NOTE 4) PERIMETER EROSION BARRIER (SEE NOTE 2) PROPOSED STORM SEWER (SEE NOTE 1) PROPOSED STORM SEWER INSTALLED PERIMETER EROSION BARRIER INSTALLED IN PREVIOUS STAGE IN PREVIOUS STAGE INLET FILTER TEMPORARY PIPE CULVERT

CHECKED JCM

12/14/201

DATE

REVISED

REVISED

INLET FILTER INSTALLED IN PREVIOUS STAGE

PERMANENT DRAINAGE STRUCTURE

NUMBER (SEE NOTE 1)

NOTES

- 1. SEE PROPOSED DRAINAGE PLANS FOR STORM SEWER INFORMATION.
- 2. PERIMETER EROSION BARRIER SHALL BE ERECTED ADJACENT TO R.O.W., EASEMENT, AND CONSTRUCTION LIMITS AND AS DIRECTED BY THE ENGINEER.
- 3. SEE LANDSCAPING PLANS FOR LANDSCAPING REQUIREMENTS.


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CONTRACT NO. 60R30

NEW YORK STREET

SCALE: AS SHOWN SHEET NO. 63 OF 70 SHEETS STA. 85+00 TO STA. 97+00

4. SEE STAGE 4 CROSS SECTIONS FOR GRADING INFORMATION.

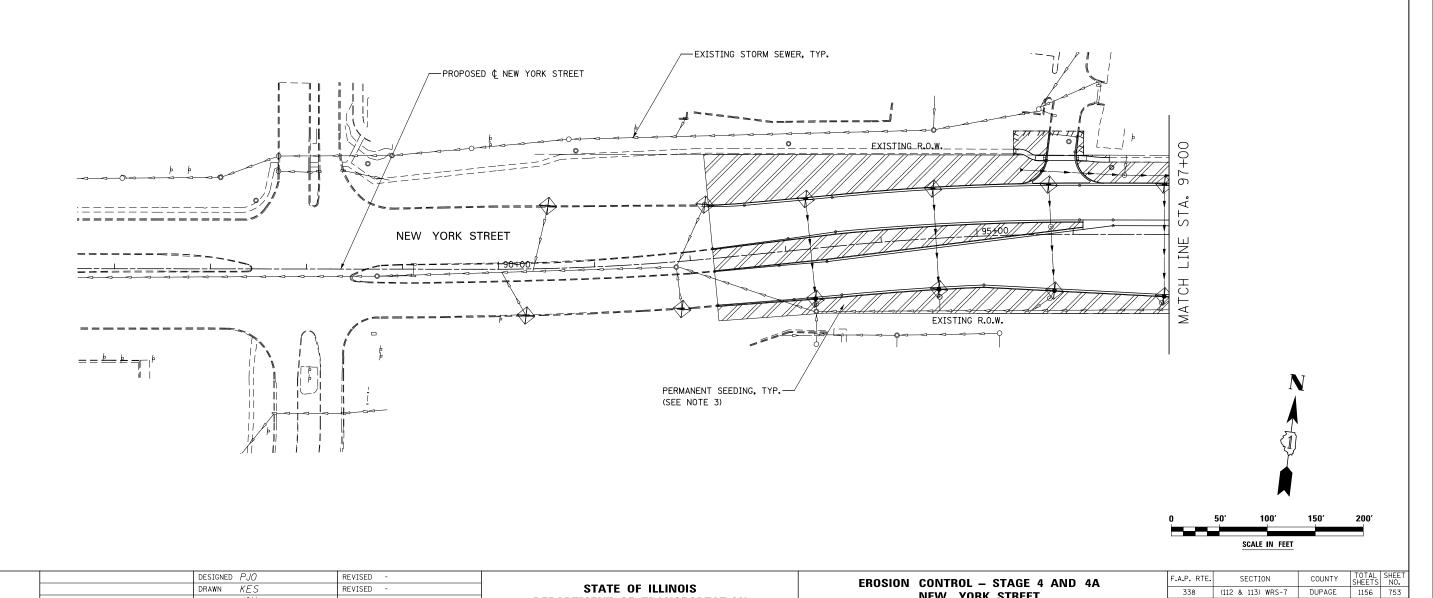

DEPARTMENT OF TRANSPORTATION