
EROSION CONTROL LEGEND

				1.1.	5125
क्षेद्वेद्वेद्वेद्वेद्वेद्वे इ इ इ इ इ इ द वेद्वेद्वेद्वेद्वेद्वे	TEMPORARY EROSION CONTROL SEEDING AND MULCH METHOD 2	-\$-	TEMPORARY DITCH CHECK	1.	SEE PROPOSED DRAI
	TEMPORARY EROSION CONTROL SEEDING AND TEMPORARY EROSION CONTROL BLANKET	{T}	TEMPORARY DITCH CHECK INSTALLED IN PREVIOUS STAGE	2.	PERIMETER EROSION R.O.W., EASEMENT, A
	PERMANENT SEEDING (SEE NOTE 3)	⊕	INLET & PIPE PROTECTION		BY THE ENGINEER.
	TEMPORARY EROSION CONTROL SEEDING OR PERMANENT SEEDING INSTALLED IN A PREVIOUS STAGE	÷	INLET & PIPE PROTECTION INSTALLED IN PREVIOUS STAGE	3.	SEE LANDSCAPING PI
	TEMPORARY PAVEMENT	-~>	FLOW DIRECTION (SEE NOTE 4)	4.	SEE STAGE 4 CROSS
	PERIMETER EROSION BARRIER (SEE NOTE 2)		PROPOSED STORM SEWER (SEE NOTE 1)		
	PERIMETER EROSION BARRIER INSTALLED IN PREVIOUS STAGE	>	PROPOSED STORM SEWER INSTALLED IN PREVIOUS STAGE		
\Leftrightarrow	INLET FILTER	>>_	TEMPORARY PIPE CULVERT		
\Leftrightarrow	INLET FILTER INSTALLED IN PREVIOUS STAGE	(27)	PERMANENT DRAINAGE STRUCTURE NUMBER (SEE NOTE 1)		

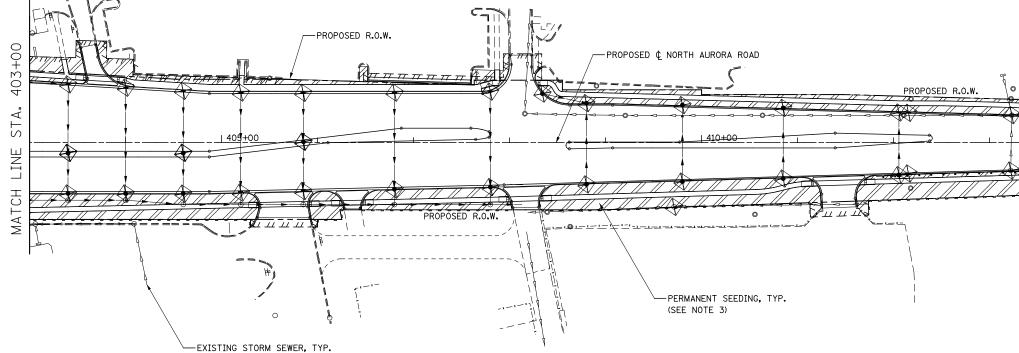

DESIGNED PJO	REVISED -	STATE OF ILLINOIS	EROSION CONTROL – STAGE 4 AND 4A		SECTION	COUNTY	TOTAL SHEET
DRAWN KES	REVISED -		NORTH AURORA ROAD	338	(112 & 113) WRS-7	DUPAGE	1156 760
CHECKED JCM	REVISED -	DEPARTMENT OF TRANSPORTATION				CONTRACT	
DATE 12/14/2012	REVISED -		SCALE: AS SHOWN SHEET NO. 70 OF 70 SHEETS STA. 403+00 TO STA. 416+00	ILLINOIS FED. AID PROJECT			

NOTES

- 1. SEE PROPOSED DRAINAGE PLANS FOR STORM SEWER INFORMATION.
- PERIMETER EROSION BARRIER SHALL BE ERECTED ADJACENT TO R.O.W., EASEMENT, AND CONSTRUCTION LIMITS AND AS DIRECTED BY THE ENGINEER.
- 3. SEE LANDSCAPING PLANS FOR LANDSCAPING REQUIREMENTS.
- 4. SEE STAGE 4 CROSS SECTIONS FOR GRADING INFORMATION.

