



END CONTRACT 60R30
STA. 3982+08
NOTE 8

BEGIN CONTRACT 60R31
STA. 3982+08

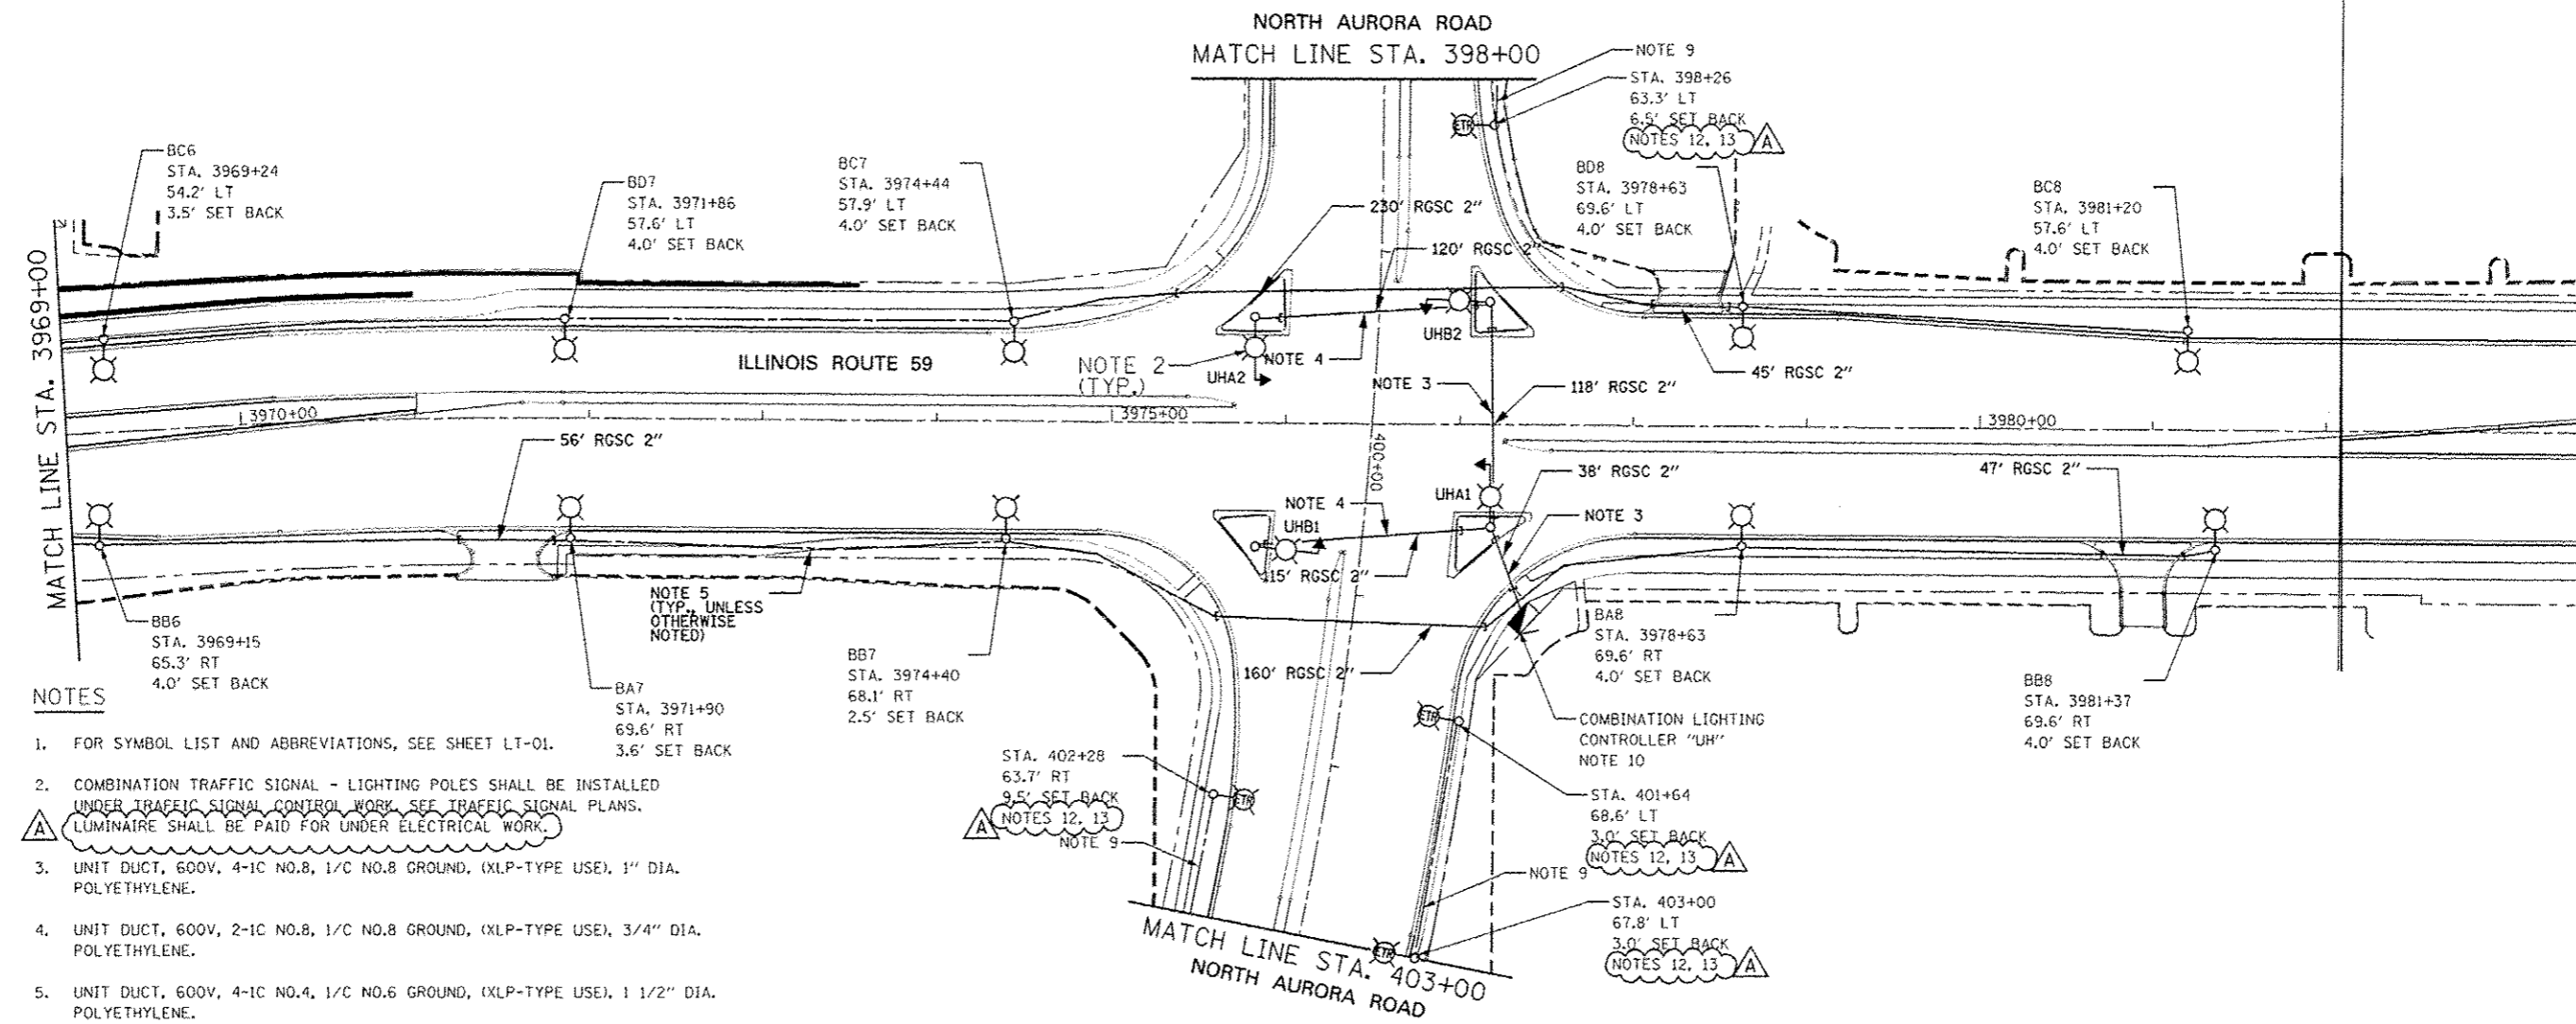

NOTES

1. FOR SYMBOL LIST AND ABBREVIATIONS, SEE SHEET LT-01.
2. COMBINATION TRAFFIC SIGNAL - LIGHTING POLES SHALL BE INSTALLED UNDER TRAFFIC SIGNAL CONTROL WORK. SEE TRAFFIC SIGNAL PLANS. LUMINAIRE SHALL BE PAID FOR UNDER ELECTRICAL WORK.
3. UNIT DUCT, 600V, 4-1C NO.8, 1/C NO.8 GROUND, (XLP-TYPE USE), 1" DIA. POLYETHYLENE.
4. UNIT DUCT, 600V, 2-1C NO.8, 1/C NO.8 GROUND, (XLP-TYPE USE), 3/4" DIA. POLYETHYLENE.
5. UNIT DUCT, 600V, 4-1C NO.4, 1/C NO.6 GROUND, (XLP-TYPE USE), 1 1/2" DIA. POLYETHYLENE.
6. UNIT DUCT, 600V, 8-1C NO.4, 1/C NO.6 GROUND, (XLP-TYPE USE), 1 1/2" DIA. POLYETHYLENE.
7. POLE SET-BACK SHALL BE MEASURED FROM THE BACK OF THE CURB TO THE CENTER OF THE POLE/BASE.
8. COORDINATE LIGHTING WORK WITH CONTRACT 60R31.
9. UNIT DUCT, 600V, 4-1C NO.6, 1/C NO.6 GROUND, (XLP-TYPE USE), 1 1/4" DIA. POLYETHYLENE.
10. COMBINATION LIGHTING CONTROLLER SHALL BE ATTACHED TO TRAFFIC SIGNAL CONTROL CABINET. SEE EXACT LOCATION ON TRAFFIC SIGNAL PLANS. CONTROLLER OWNED AND MAINTAINED BY I.D.O.T..
11. SEE DISTRICT 1 DETAIL BE-230 FOR COMBINATION LIGHTING AND TRAFFIC SIGNAL ELECTRIC SERVICE DISCONNECT.
12. POLE SHALL BE WIRED TO CITY OF NAPERVILLE CONTROLLER.
13. BOLT CIRCLE AND ANCHOR BOLTS NUMBER AND LAYOUT OF THE FOUNDATION SHALL MATCH THE BE-INSTALLED POLE.

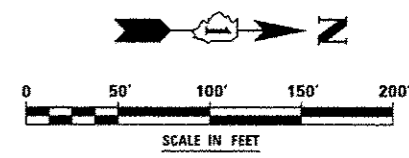

DESIGNED <i>MCP</i>	REVISED - ADDENDUM A 02/20/2013	STATE OF ILLINOIS DEPARTMENT OF TRANSPORTATION	LIGHTING PLAN - ILLINOIS ROUTE 59		F.A.P. RTE.	SECTION	COUNTY	TOTAL SHEETS	SHEET NO.
DRAWN <i>MLB</i>	REVISED -		338	(112 & 113) WRS-7	DUPAGE	1156	787		
CHECKED <i>MCP</i>	REVISED -		SCALE: AS SHOWN SHEET NO. 6 OF 15 SHEETS STA. TO STA.		LT-17		CONTRACT NO. 60R30		
DATE <i>12/14/2012</i>	REVISED -				ILLINOIS FED. AID PROJECT				