


3‰″ - 16NC STAINLESS STEEL STUD W∕ NUT (TYP.) 4 PER VERTICAL 3 PER HORIZONTAL

NOTES:

								-	+	+	
TR NO.*	PAY ITEM	MANHOLE DIAMETER		RESTRICTOR TYPE	RESTRICTOR DIAMETER (d)	INVERT OF RESTRICTOR	ELEVATION OF TOP OF PLATE OVERFLOW	-	+	+	
275A	MANHOLE WITH RESTRICTOR PLATE	9′	T1-OL	2	19.0″	688.03	693.54				i i
362	MANHOLE WITH RESTRICTOR PLATE	8′	T1-OL	2	19.0″	688.31	692.25				
342A**	MANHOLE WITH RESTRICTOR PLATE	9′	T1-OL	2	14.0″	693.16	700.91	-	$+ \parallel$	+	
	MANHOLES, TY A, 6'-DIA.W/ 2 TY1 FR, OPEN LIDS, RESTRICTOR PLATE	6′	T1-OL	2	21.5″	691.52	696.27				
		8′	T1-OL	2	27.0"	694,62	700,89				

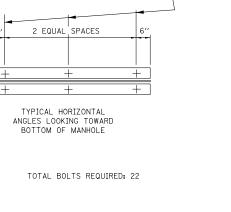

BOLT LOCATIONS -

1 RE-ENTRA TUBE 1 ENGTH: 1/2 TO C=.52


\*\* REMOVAL OF EXISTING STORM SEWER FOR RESTRICTOR MANHOLE PLACEMENT TO BE INCLUDED IN THE COST OF "MANHOLE WITH RESTRICTOR PLATE"

TYPICAL VERTICAL ANGLES LOOKING TOWARD MANHOLE WALL

STEEL ANGLE BOLTING DETAILS

-BOLT LOCATIONS

 DESIGNED	PJO REVISED	- 06/20/2012		DRAINAGE DETAILS	F.A.P. RTE.	SECTION	COUNTY TOTAL SHEET
DRAWN	KES REVISED	S REVISED - STATE OF ILLINOIS	MANHOLES, WITH RESTRICTOR PLATE	338	(112 & 113) WRS-7	DUPAGE 1156 501	
CHECKED	JCM REVISED	-	DEPARTMENT OF TRANSPORTATION	WANNULES, WITH RESTRICTOR FLATE	DD-	-02	CONTRACT NO. 60R30
DATE	12/14/2012 REVISED	-		SCALE: AS SHOWN SHEET NO. 2 OF 2 SHEETS STA. TO STA.			D PROJECT

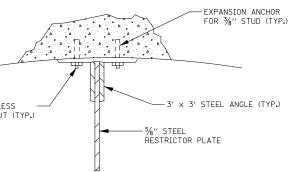

ANGLE FASTENER DETAIL


1. ANGLES SHOULD BE 3"×3"×3#8"

2. VERTICAL ANGLES SHOULD EXTEND FROM THE BOTTOM OF THE RESTRICTOR PLATE TO THE TOP.

3. HORIZONTAL ANGLES SHOULD EXTEND FROM VERTICAL ANGLE TO VERTICAL ANGLE.


4. ALL STEEL ANGLES AND PLATES TO BE GALVANIZED AFTER FABRICATION.

5. BASIS OF PAYMENT: "MANHOLES, WITH RESTRICTOR PLATE" WILL BE PAID FOR AS EACH. THE PAY ITEM SHALL INCLUDE THE CONCRETE MANHOLE, THE FRAMES AND LIDS, THE RESTRICTOR PLATE AND ALL ANGLES AND HARDWARE SHOWN IN THIS DRAWING.

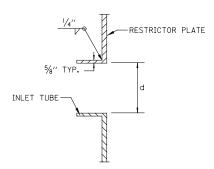

INLET TUBE DETAIL

	2	3	4	5	6	
ANT	SHARP EDGES	SQUARE EDGED	RE-ENTRAN TUBE	T SQUARE EDO	ED ROUNDE	D
			- <b>-</b>			
) 1 DIA.		LENGTH: 1 TO 2 DIA.	LENGTH: 2-1/2	DIA. LENGTH: 2-1/2	DIA.	
2	C=.61	C=.61	C=.73	C=.82	C=.98	
		VALUES OF "C" AND SQUARE		R		
	•		F.A.P. RTE.	SECTION	COUNTY	TOTAL SHEETS
ETAIL	.5		770	(110 0 117) WDC		SHEETS

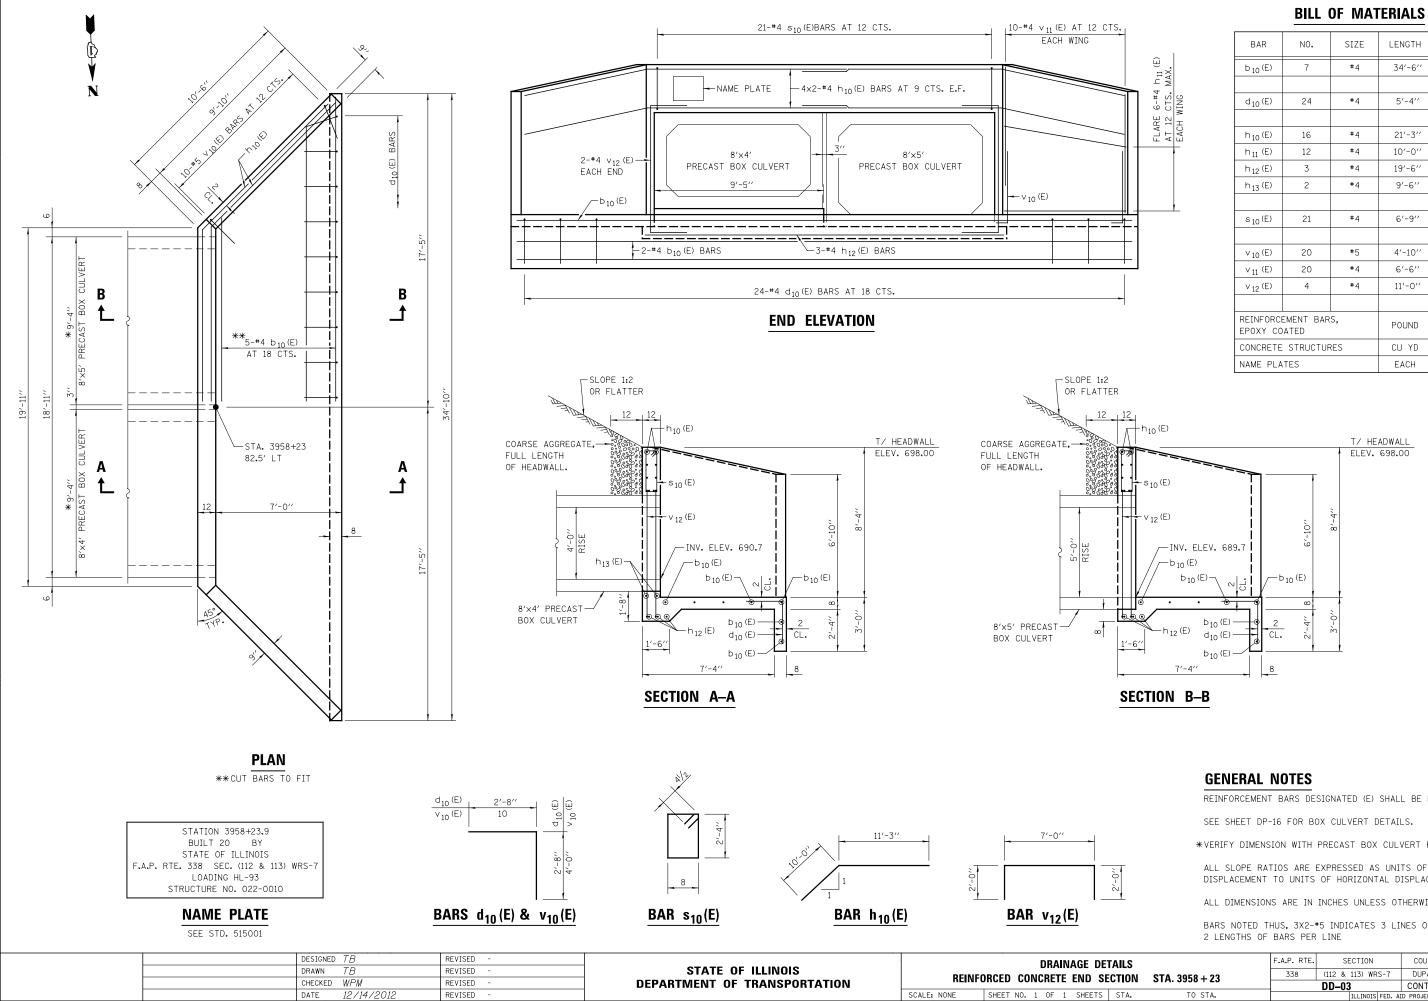

	BILL		ERIAL2	
BAR	NO.	SIZE	LENGTH	SHAPE
ь <sub>10</sub> (Е)	7	#4	34'-6''	
d <sub>10</sub> (E)	24	#4	5′-4′′	
h <sub>10</sub> (E)	16	#4	21'-3''	
h <sub>11</sub> (E)	12	#4	10'-0''	
h <sub>12</sub> (E)	3	#4	19'-6''	
h <sub>13</sub> (E)	2	#4	9′-6′′	
s <sub>10</sub> (E)	21	#4	6'-9''	
∨ <sub>10</sub> (E)	20	#5	4'-10''	
∨ <sub>11</sub> (E)	20	#4	6'-6''	
v <sub>12</sub> (E)	4	#4	11'-0''	
REINFORC EPOXY CC	EMENT BAR DATED	s,	POUND	920
CONCRETE	STRUCTUR	RES	CU YD	16.1
NAME PLA	TES		EACH	1

REINFORCEMENT BARS DESIGNATED (E) SHALL BE EPOXY COATED. SEE SHEET DP-16 FOR BOX CULVERT DETAILS.


\*VERIFY DIMENSION WITH PRECAST BOX CULVERT FABRICATOR.

ALL SLOPE RATIOS ARE EXPRESSED AS UNITS OF VERTICAL DISPLACEMENT TO UNITS OF HORIZONTAL DISPLACEMENT (V:H).

ALL DIMENSIONS ARE IN INCHES UNLESS OTHERWISE SHOWN.

BARS NOTED THUS, 3X2-#5 INDICATES 3 LINES OF BARS WITH

ETAILS		F.A.P. RTE.	SECTION	COUNTY	TOTAL SHEETS	SHEET NO.	
		STA. 3958 + 23	338	(112 & 113) WRS-7	DUPAGE	1156	502
		51A: 5550   25		DD-03	CONTRACT	NO. 60	DR30
5	STA.	TO STA.		ILLINOIS FED. AI	D PROJECT		

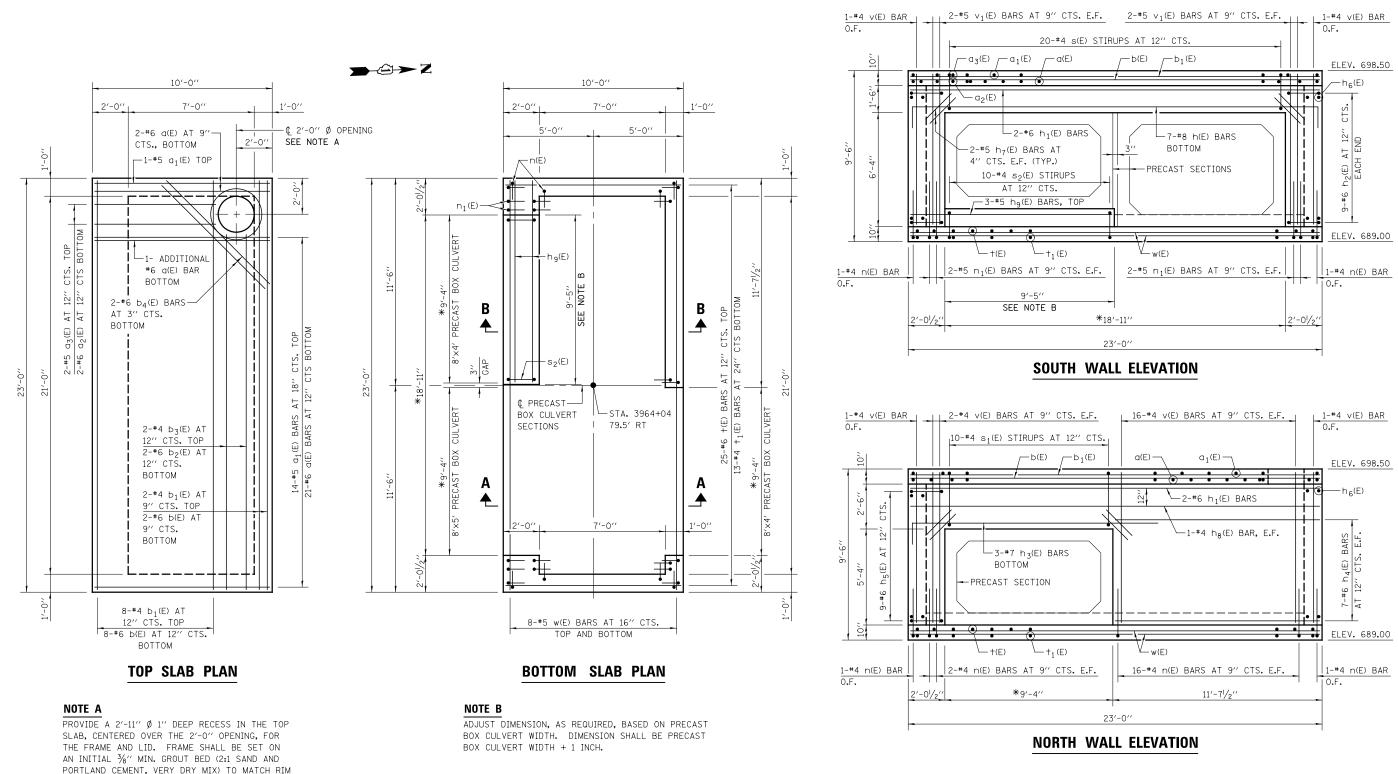

ELEVATION SHOWN ON DRAINAGE PLANS.

LEG	END
E.F.	EACH
I.F.	INSIE
0.F.	OUTS

	DESIGNED TB	REVISED -		DRAINAGE DETAILS	F.A.P. RTE. SECTION	COUNTY TOTAL SHEET SHEETS NO.
	drawn <i>TB</i>	REVISED -	STATE OF ILLINOIS	770 //		DUPAGE 1156 503
	CHECKED WPM	REVISED -	DEPARTMENT OF TRANSPORTATION		DD_04	CONTRACT NO. 60R30
	DATE <i>12/14/2012</i>	REVISED -		SCALE: NONE SHEET NO. 1 OF 2 SHEETS STA. TO STA.	ILLINOIS FED.	AID PROJECT

EACH FACE INSIDE FACE

OUTSIDE FACE


# **GENERAL NOTES**


REINFORCEMENT BARS DESIGNATED (E) SHALL BE EPOXY COATED.

SEE SHEET DD-05 FOR SECTIONS A-A AND B-B, ADDITIONAL ELEVATIONS AND DETAILS.

#### SEE SHEET DP-16 FOR BOX CULVERT DETAILS.


\*VERIFY DIMENSION WITH PRECAST BOX CULVERT FABRICATOR

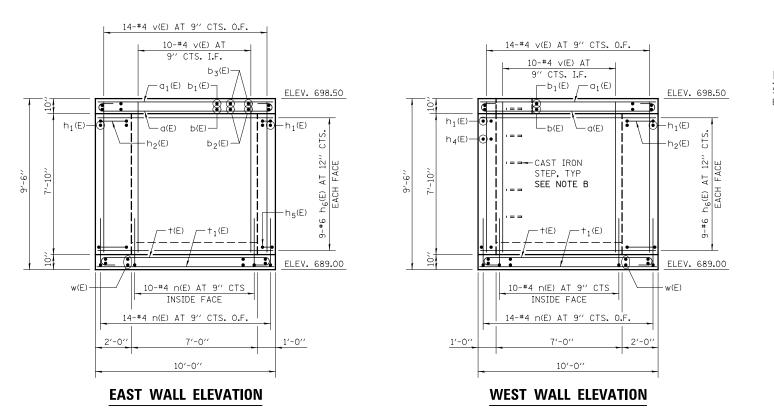


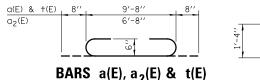




# BARS a(E), a<sub>2</sub>(E) & t(E)

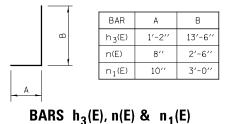

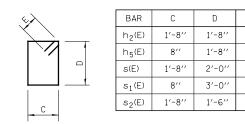


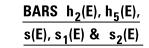

LEGEND
--------

E.F. EACH FACE INSIDE FACE I.F. O.F. OUTSIDE FACE


DESIGNED TB	REVISED -			DRAINAGE DETAILS	F.A.P. RTE.	SECTION	COUNTY TOTAL SHEET
DRAWN TB	REVISED -	STATE OF ILLINOIS			338	(112 & 113) WRS-7	DUPAGE 1156 504
CHECKED WPM	REVISED -	DEPARTMENT OF TRANSPORTATION				DD-05	CONTRACT NO. 60R30
DATE 12/14/2012	REVISED -		SCALE: NONE	SHEET NO. 2 OF 2 SHEETS STA. TO STA.		ILLINOIS FED. A	AID PROJECT

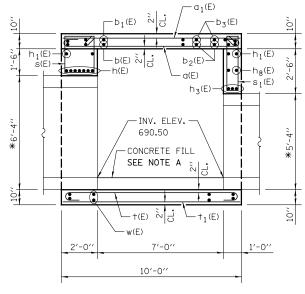



### NOTE A


PLACE CONCRETE FILL AFTER INSTALLATION OF BOX CULVERT AND JUNCTION CHAMBER WALLS. MATCH TOP OF FILL ELEVATION TO BOX CULVERT INVERT ELEVATION 690,50,

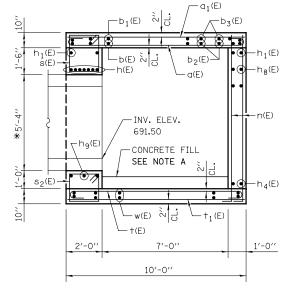

# **SECTION B-B**

	DILL		LNIALS	
BAR	NO.	SIZE	LENGTH	SHAPE
a(E)	24	#6	11'-0''	C
a <sub>1</sub> (E)	15	#5	9'-8''	
a <sub>2</sub> (E)	2	#6	8'-0''	
a <sub>3</sub> (E)	2	#5	6'-8''	
D(E)	10	#6	22'-8''	
ь <sub>1</sub> (Е)	10	#4	22'-8''	
ь <sub>2</sub> (Е)	2	#6	19'-8''	
Ь <sub>3</sub> (Е)	2	#4	19'-8''	
ь <sub>4</sub> (Е)	2	#6	7′-6′′	
h(E)	7	#8	25'-4''	
h <sub>1</sub> (E)	4	#6	22'-8''	
h <sub>2</sub> (E)	18	#5	7'-7''	
h <sub>3</sub> (E)	3	#7	14'-8''	
h <sub>4</sub> (E)	14	#6	11'-3''	
h <sub>5</sub> (E)	9	#5	5'-7''	
h <sub>6</sub> (E)	36	#6	9′-8′′	
h <sub>7</sub> (E)	16	#5	2'-0''	
h <sub>8</sub> (E)	2	#4	22'-8''	
hg(E)	3	#5	11'-0''	
n(E)	88	#4	3'-2''	
n <sub>1</sub> (E)	8	#5	3'-10''	
s(E)	20	#4	8'-1''	
s <sub>1</sub> (E)	10	#4	8'-1''	
s <sub>2</sub> (E)	10	#4	7'-1''	
+(E)	25	#6	11'-0''	$\Box$
+1(E)	13	#4	9'-8''	
		# 4	0/ 1//	
V(E)	88	#4	8'-4''	
∨1(E)	8	#5	8'-4''	
w(E)	16	#5	22'-8''	
W(E)	16	#D	22 -0	
REINFORC	L EMENT BAR DATED	:S,	POUND	4800
CONCRETE	STRUCTUR	RES	CU YD	33.7
FRAMES A OPEN LID	ND LIDS, '	TYPE 1,	EACH	1
CAST IRO	N STEPS		EACH	5
	-			

# **BILL OF MATERIALS**

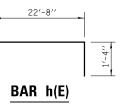

E	
5 <sup> </sup> /2″	
5 <sup> </sup> /2′′	
4 <sup>1</sup> /2″	
4 <sup>1</sup> /2′′	
4 <sup>1</sup> /2′′	

# **GENERAL NOTES**


REINFORCEMENT BARS DESIGNATED (E) SHALL BE EPOXY COATED.


SEE SHEET DP-16 FOR BOX CULVERT DETAILS.

SEE STANDARD 602401 FOR DETAILS OF CAST IRON STEPS.

SEE STANDARD 604001 FOR DETAILS OF FRAME AND LID.

\*VERIFY DIMENSION WITH PRECAST BOX CULVERT FABRICATOR

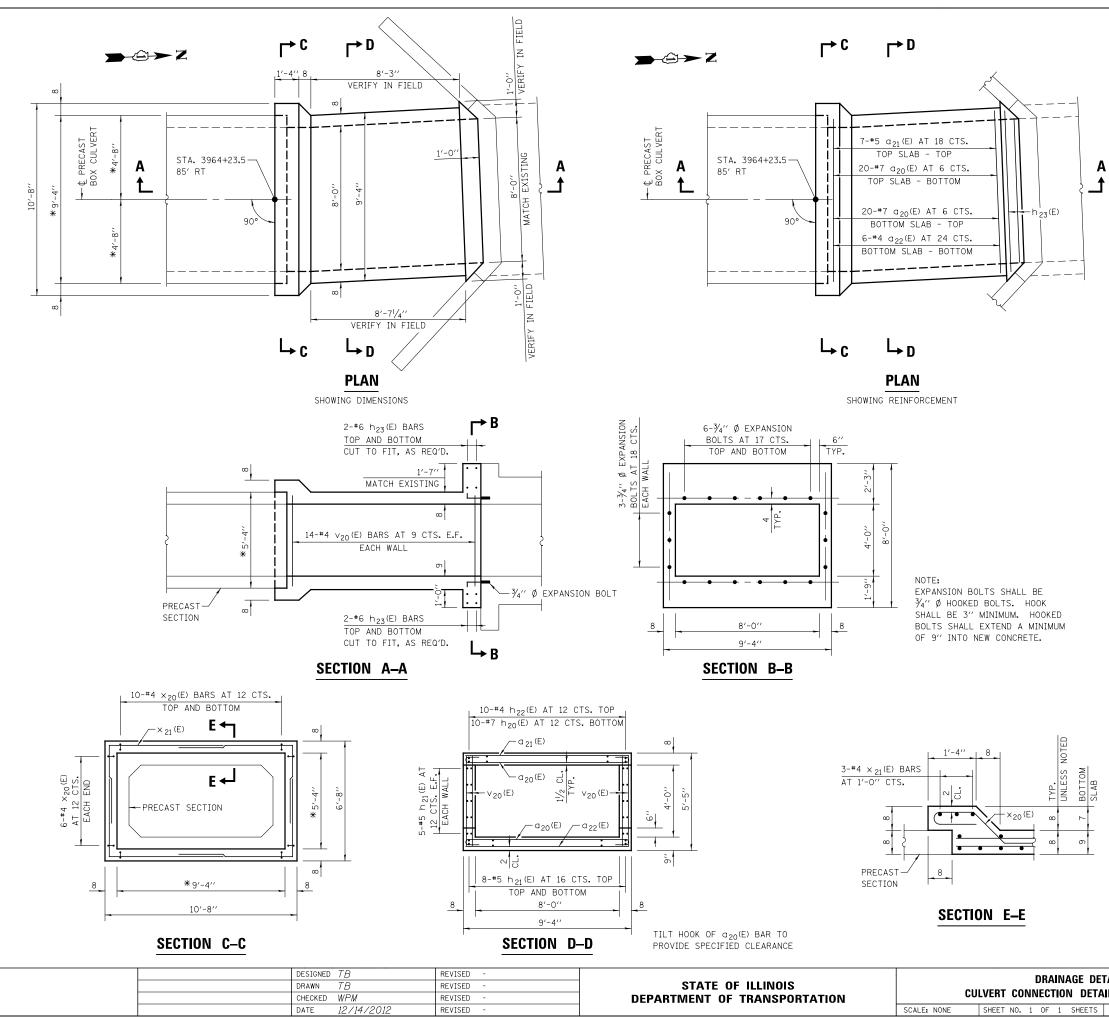

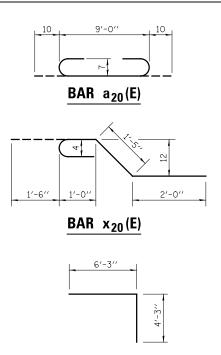

BAR x<sub>21</sub>(E)

## **BILL OF MATERIALS**

BAR	NO.	SIZE	LENGTH	SHAPE
a <sub>20</sub> (E)	40	#7	10'-8''	
a <sub>21</sub> (E)	7	#5	9'-0''	
a <sub>22</sub> (E)	6	#4	9'-0''	
h <sub>20</sub> (E)	10	#7	10'-0''	
h <sub>21</sub> (E)	36	#5	10'-0''	
h <sub>22</sub> (E)	10	#4	10'-0''	
h <sub>23</sub> (E)	8	#6	9'-6''	
v <sub>20</sub> (E)	56	#4	5'-0''	
× <sub>20</sub> (E)	32	#4	5'-11''	
× <sub>21</sub> (E)	12	#4	10'-6''	L
REINFORCEMENT BARS, EPOXY COATED		POUND	2140	
CONCRETE	STRUCTUR	RES	CU YD	10.1
EXPANSIO	N BOLTS ∛	4 INCH	EACH	18

## **GENERAL NOTES**


REINFORCEMENT BARS DESIGNATED (E) SHALL BE EPOXY COATED.

SEE SHEET DP-16 FOR BOX CULVERT DETAILS.

\*VERIFY DIMENSION WITH PRECAST BOX CULVERT FABRICATOR.

ALL DIMENSIONS ARE IN INCHES UNLESS OTHERWISE SHOWN.


E	TAILS	ETAILS		SECTION	COUNTY TOTAL SH SHEETS N				
۰.	AIL STA. 3964 + 23.5		338	(112 & 113) WRS-7	DUPAGE	1156	505		
_			_	DD-06	CONTRACT NO. 60R30				
	STA.	TO STA.	ILLINOIS FED. AID PROJECT						

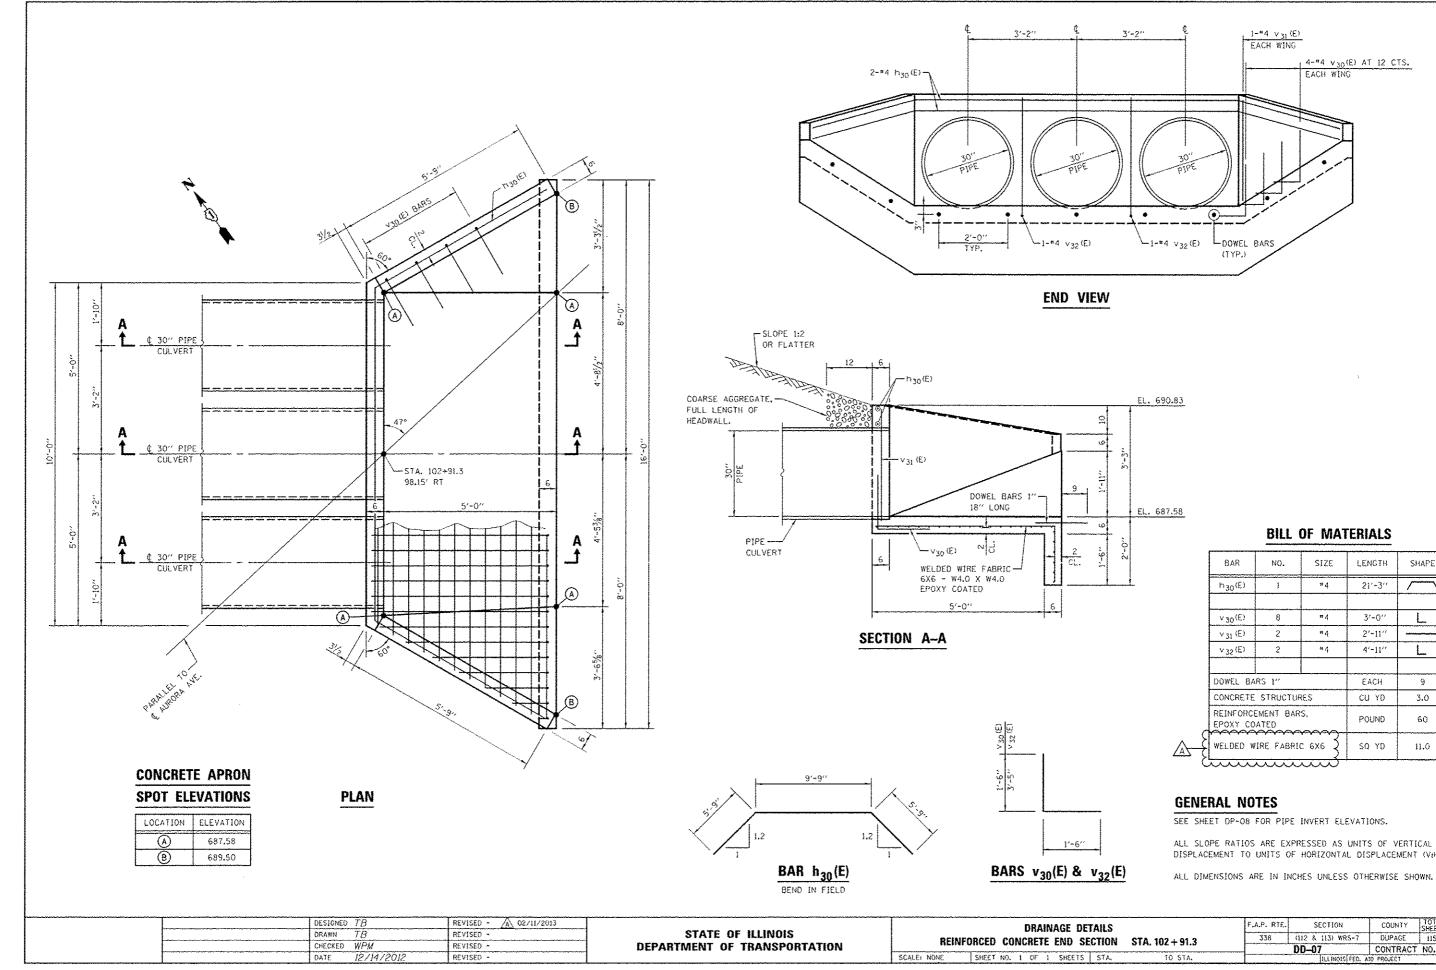

NO.		1	
NU.	SIZE	LENGTH	SHAPE
1	¥4	21'-3''	
8	*4	3'-0''	Ļ
2	#4	2'~11''	
2	#4	4'-11''	L
RS 1''	[	EACH	9
STRUCTUR	ŧεs	CU YD	3.0
ATED	POUND	60	
	SQ YD	11.0	
	2 2 RS 1" STRUCTUF EMENT BAR ATED TIRE FABRID	8 = 4 2 = 4 2 = 4 2 = 4 RS 1" STRUCTURES EMENT BARS,	8         #4         3'-0''           2         #4         2'-11''           2         #4         4'-11''           2         #4         4'-11''           RS         1''         EACH           STRUCTURES         CU YD           EMENT BARS, ATED         POUND           VIRE PABRIC 6X6         SQ YD

ALL SLOPE RATIOS ARE EXPRESSED AS UNITS OF VERTICAL DISPLACEMENT TO UNITS OF HORIZONTAL DISPLACEMENT (V:H).

ILS		F.A.P. RTE.	SECTION	COUNTY TOTAL SHE SHEETS NO		
TION	STA. 102 + 91.3	338	(112 & 113) WRS-7	DUPAGE	1156	506
		-	DD-07	CONTRACT NO. 60R30		
STA.	TO STA.		ILLINOIS FED. A	ID PROJECT		

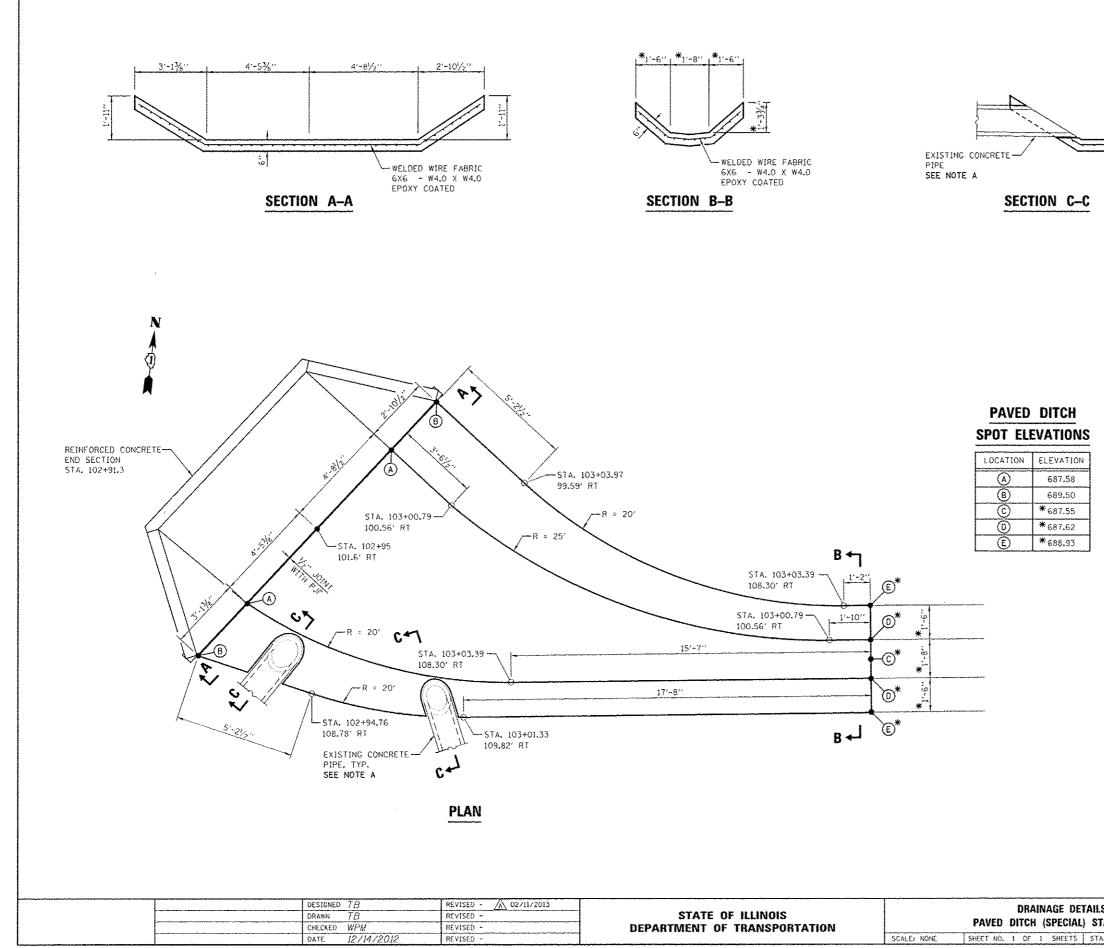

### NOTE A

PROVIDE A NOTCH IN THE PAVED DITCH AROUND THE EXISTING CONCRETE PIPE. THE NOTCH SHALL BE 1" WIDER ON EACH SIDE OF THE CONCRETE PIPE. PROVIDE 1" PJF BETWEEN THE PAVED DITCH AND THE CONCRETE PIPE. MODIFY THE END OF EXISTING CONCRETE PIPE TO MATCH SLOPE OF PAVED DITCH. BOTH THE NOTCH IN THE PAVED DITCH AND THE MODIFICATIONS TO THE EXISTING CONCRETE PIPE SHALL BE AS DIRECTED AND TO THE SATISFACTION OF THE ENGINEER.

## BILL OF MATERIALS

ITEM	UNIT	QUANTITY
CONCRETE STRUCTURES	CU YD	4.6
WELDED WIRE FABRIC 6X6	SQ YD	31.0

## LEGEND

PJF PREFORMED JOINT FILLER

## **GENERAL NOTES**

ALL SLOPE RATIOS ARE EXPRESSED AS UNITS OF VERTICAL DISPLACEMENT TO UNITS OF HORIZONTAL DISPLACEMENT (V:H).

╈MATCH EXISTING

AILS	F.A.P. RTE.	SECTION	COUNTY	SHEET NO.	
STA. 102 + 95	338	(112 & 113) WRS-7	DUPAGE	1156	507
01R, 102 1 33		DD08	CONTRACT NO. 60R30		
STA. TO STA.	ILLINOIS FED. AID PROJECT				

#### GENERAL NOTES


- 1. FOR PROPOSED LIGHTING INFORMATION, SEE LIGHTING PLANS.
- 2. FOR DRAINAGE INFORMATION, SEE DRAINAGE PLAN/PROFILE.
- 3. SEE REMOVAL PLANS FOR REMOVAL OF EXISTING WATER MAIN ITEMS.
- 4. FOR SANITARY SEWER INFORMATION, SEE SANITARY PLAN/PROFILE.
- 5. SEE REMOVAL PLANS FOR FIRE HYDRANTS TO BE MOVED, RELOCATED OR REMOVED.
- 6. SEE IDOT STANDARD 000001-06 FOR DEFINITION OF ADDITIONAL SYMBOLS.
- 7. ALL FITTINGS, STOPS, VALVES, & PIPE SHALL BE WRAPPED WITH POLYETHYLENE ENCASEMENT. SEE WATER MAIN DETAILS.
- 8. WATER MAIN JOINTS SHALL BE PUSH-ON RUBBER GASKET JOINTS EXCEPT AT VALVE, SLEEVE AND FITTING LOCATIONS. MECHANICAL JOINTS SHALL BE USED AT VALVE, SLEEVE, AND FITTING LOCATIONS AS INDICATED IN THE STANDARD DRAWING DETAILS.
- 9. CONCRETE THRUST BLOCKS SHALL BE USED TO PREVENT MOVEMENT OF THE WATER MAIN SYSTEM. CONCRETE THRUST BLOCKS SHALL BE CONSTRUCTED AT EACH BEND, TEE, CAP, VALVE AND HYDRANT. SEE CITY OF NAPERVILLE STANDARD DETAIL 6 "THRUST BLOCK INSTALLATION."
- 10. WHERE CONDITIONS PREVENT THE USE OF CONCRETE THRUST BLOCKS, TIED JOINTS OR RESTRAINED JOINTS IN ACCORDANCE WITH THE SPECIAL PROVISIONS SHALL BE USED. TIED OR RESTRAINED JOINTS SHALL NOT BE PAID FOR SEPARATELY, BUT SHALL BE INCLUDED WITH THE COST OF CONCRETE THRUST BLOCKS.
- 11. CUT AND CAP EXISTING WATER MAIN SHALL NOT BE PAID FOR SEPARATELY BUT IS INCLUDED WITH ABANDON EXISTING WATER MAIN, FILL WITH CLSM.
- 12. THE CONTRACTOR SHALL BE REQUIRED TO PROVIDE RECORD DRAWINGS WITH SURVEYED GPS COORDINATES AND ELEVATIONS FOR ALL STRUCTURES INSTALLED INCLUDING VALVE VAULTS, FIRE HYDRANTS, DOMESTIC WATER SERVICE BOXES, AND MANHOLES. THE COORDINATES SHALL CONFORM TO THE PROJECT DATUM DEFINED IN THE ALIGNMENT, BENCHMARK AND TIES PLANS. ACTUAL INSTALLED ELEVATIONS AND LOCATIONS OF BENDS AND FITTINGS SHALL BE DETERMINED AND RECORDED ON THE RECORD DRAWINGS. LOCATIONS FOR BENDS SHALL HAVE ONE MEASUREMENT ALONG THE CENTERLINE OF THE WATER MAIN OR ELECTRIC DUCT BANK AND A MINIMUM OF ONE ADDITIONAL MEASUREMENT FROM ANOTHER FIXED POINT. TOP OF PIPE ELEVATIONS OF ALL UTILITIES OR CASING PIPE AT PROPOSED CROSSINGS SHALL BE SHOWN ON THE RECORD DRAWINGS. ALL DEVIATIONS FROM THE PROPOSED PLAN SHALL ALSO BE NOTED WITHIN THE RECORD DRAWINGS. DIMENSIONS SHALL BE RECORDED ON THE RECORD DRAWINGS. RECORD DRAWINGS SHALL BE KEPT UP TO DATE THROUGHOUT THE CONSTRUCTION. THIS WORK WILL NOT BE PAID FOR SEPARATELY, BUT SHALL BE INCLUDED IN THE CONTRACT UNIT PRICE FOR THE VARIOUS DUCTILE IRON WATER MAIN PAY ITEMS.
- 13. VAULTS SHALL BE CONSTRUCTED OF PRECAST CONCRETE SECTIONS CONFORMING TO ASTM C-478 AND IN ACCORDANCE TO THE DETAIL PROVIDED. ITS FRAME AND LID SHALL BE AS INDICATED IN THE PLAN DETAILS. SEE STANDARD DRAWINGS FOR FURTHER INFORMATION.
- 14. WHEN CONNECTING TO AN EXISTING LINE, WORK MUST BE COORDINATED WITH THE MUNICIPALITY'S DEPARTMENT OF PUBLIC UTILITIES WITH 48 HOURS NOTICE (630)-420-4122. PERSONNEL FROM THE DEPARTMENT OF PUBLIC UTILITIES ARE THE ONLY ONES WHO ARE TO OPERATE WATER MAIN VALVES. WHEN WATER IS NEEDED TO CHLORINATE NEW LINES FROM ADJACENT CITY MAINS WHICH ARE IN SERVICE, DEPARTMENT OF PUBLIC UTILITIES PERSONNEL MUST BE PRESENT TO OPERATE OR WITNESS THE CONTRACTOR OPERATION OF EXISTING CITY VALVES.
- WHEN EXTENDING AN EXISTING LINE, THE CONTRACTOR MUST CHLORINATE AND 15. PRESSURE TEST BOTH NEW AND VALVED SECTION OF EXISTING LINES IN ACCORDANCE WITH CITY OF NAPERVILLE STANDARDS.


- 16. CONNECTIONS TO EXISTING WATER MAIN SHALL BE MADE AT AN EXISTING JOINT. EXCEPT WHERE SHOWN ON THE PLANS, ANY ADDITIONAL SLEEVES, FITTINGS, COUPLINGS, OR OTHER APPURTENANCES NEEDED TO CONNECT EXISTING WATER MAIN TO PROPOSED WATER MAIN WILL NOT BE PAID FOR SEPARATELY, BUT SHALL BE INCLUDED IN THE COST OF DUCTILE IRON WATER MAIN. REMOVAL OF EXISTING WATER MAIN LIMITS SHALL BE ADJUSTED AND PAID ACCORDINGLY.
- AT&T AND NICOR FACILITIES ARE TO REMAIN AND WILL NOT BE RELOCATED FROM 17. WHAT IS SHOWN ON THE PLANS. IN THE EVENT THAT A CONFLICT ARISES DURING CONSTRUCTION BETWEEN ANY FACILITY AND THE PROPOSED WATER MAIN FACILITY, THE CONTRACTOR SHALL NOTIFY THE ENGINEER. ANY CHANGE TO THE PROPOSED WATER MAIN DESIGN FROM THAT SHOWN ON THE PLANS MUST BE APPROVED BY THE ENGINEER PRIOR TO CONSTRUCTION.


DESIGNE	D CEO	REVISED -		WATER MAIN G	ENERAL	F.A.P. RTE.	SECTION	COUNTY TOTAL SHEE
DRAWN CMW		REVISED -	STATE OF ILLINOIS	NOTES AND LEGEND			(112 & 113) WRS-7	DUPAGE 1156 508
CHECKED		REVISED -	DEPARTMENT OF TRANSPORTATION					CONTRACT NO. 60R30
DATE	12/14/2012	REVISED -	SCALE:	SCALE: AS SHOWN SHEET NO. 1 OF 1 SHEETS	STA. TO STA.	ILLINOIS FED. AID PR		D PROJECT

## LEGEND:


0	DOMESTIC WATER SERVICE BOX
•	WATER MAIN FITTING
ullet	WATER MAIN VALVE
	WATER MAIN REDUCER
•	CUT AND CAP EXISTING WATER MAIN
•	WATER MAIN LINE STOP
t W I	ABANDON EXISTING WATER MAIN, FILL WITH CLSM
	WATER MAIN REMOVAL
Ν	ELEVATION AT FIRE HYDRANT NOZZLE CAP
R	ELEVATION AT RIM (PR GROUND LINE)
С	ELEVATION AT PIPE CROWN
I	ELEVATION AT PIPE INVERT
VM	VERTICAL MOUNT (VERTICAL CHANGE IN PIPE AT INDICATED FITTING)

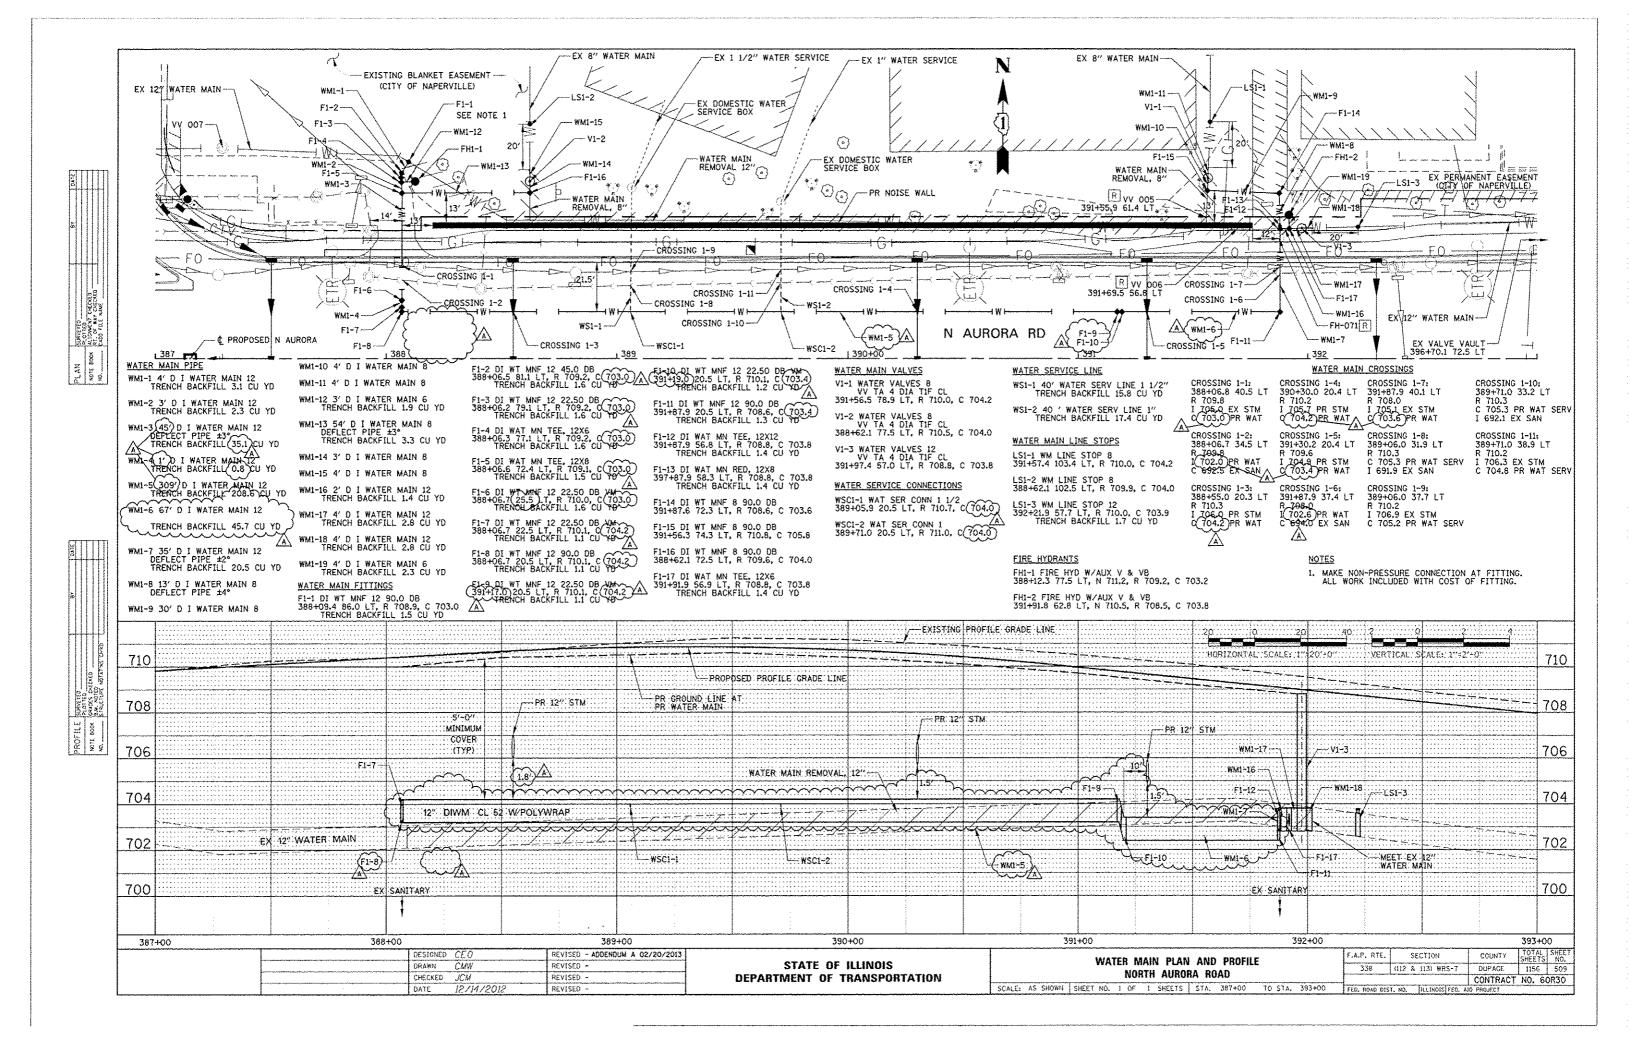

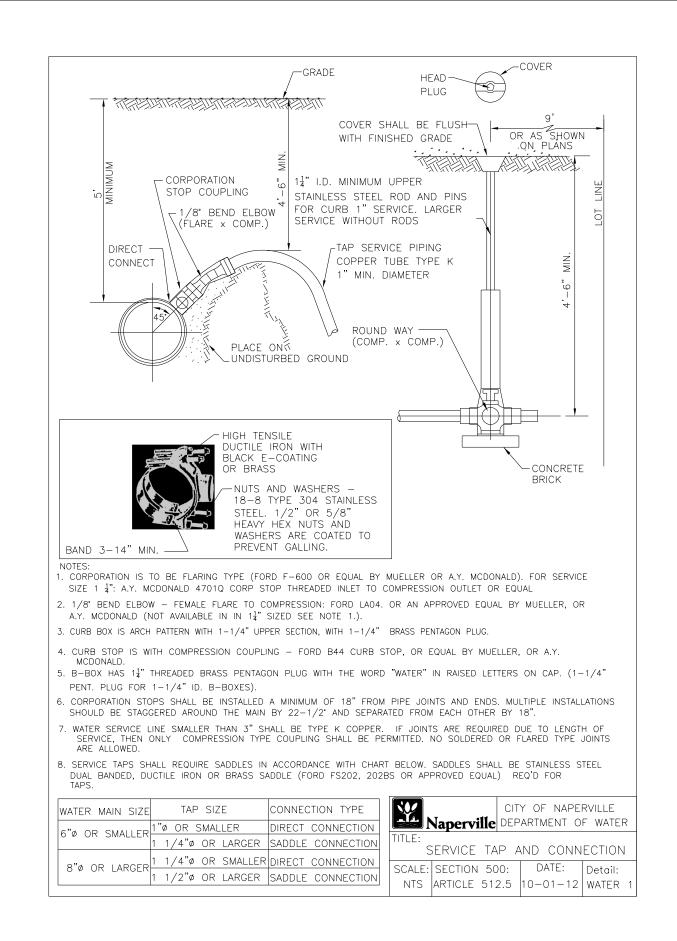


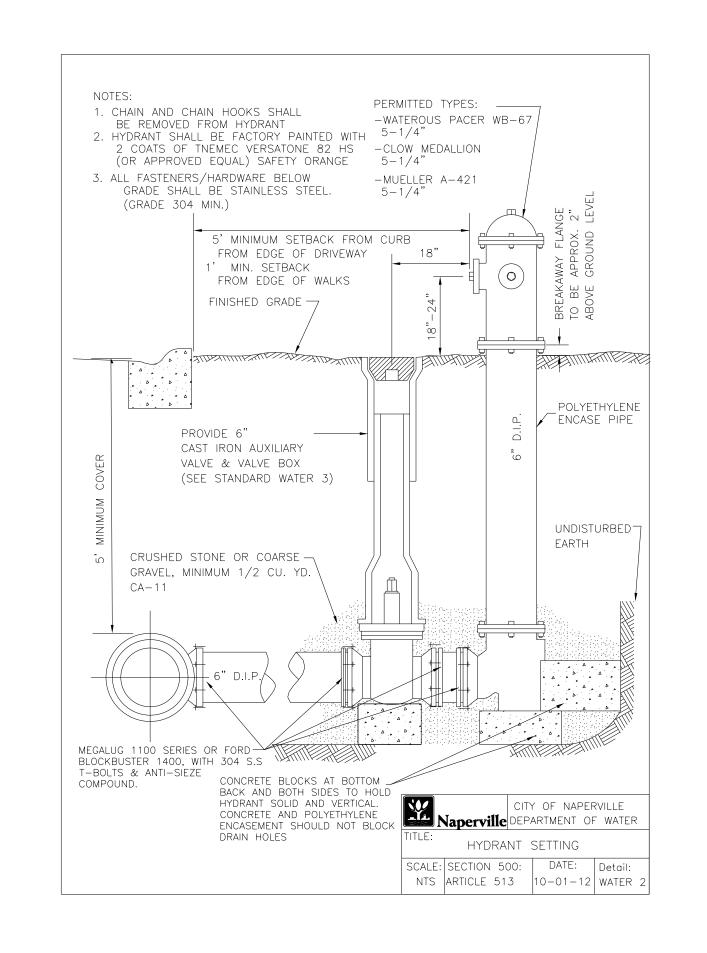


DESIGNED PJO	REVISED -		WATER MAIN STANDARD DRAWINGS CITY OF NAPERVILLE			. SECTION	COUNTY TOTAL SHEETS	SHEET NO.
DRAWN KES CHECKED JCM	REVISED - REVISED -	STATE OF ILLINOIS				(112 & 113) WRS-7	DUPAGE 1156	510
		DEPARTMENT OF TRANSPORTATION				WAT STD-1	CONTRACT NO. 60	R30
DATE 12/14/2012	REVISED -			SHEET NO. 1 OF 8 SHEETS STA. TO STA.		ILLINOIS FED. A	AID PROJECT	

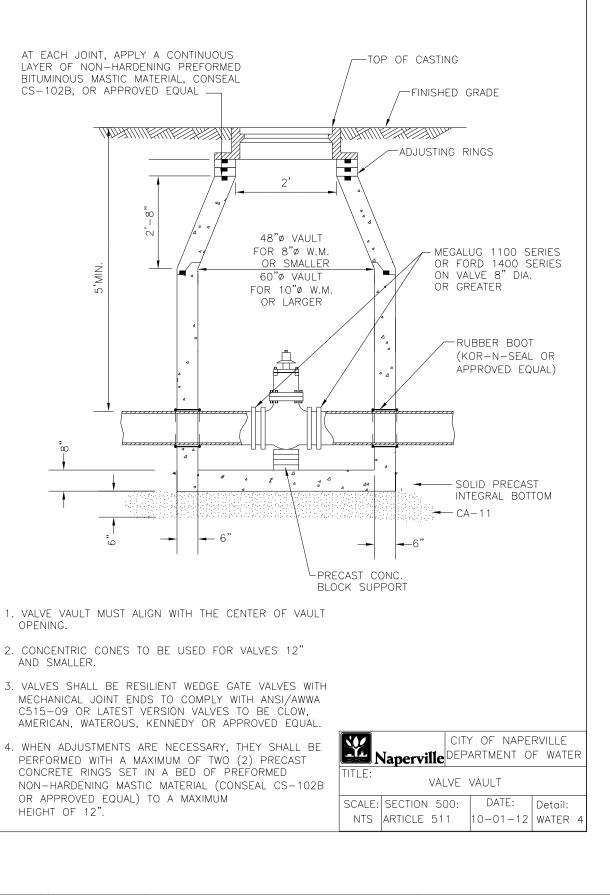


	DESIGNED PJU	JO	REVISED -		WATER MAIN STANDARD DRAWINGS CITY OF NAPERVILLE			F.A.P. RTE.	. SECTION	COUNTY	TOTAL SHEE
-	DRAWN KES	ES	REVISED -	STATE OF ILLINOIS				338	(112 & 113) WRS-7	DUPAGE	1156 51
	CHECKED JC/	CM	REVISED -	DEPARTMENT OF TRANSPORTATION				WAT STD-2		CONTRACT NO	
	DATE 12/	2/14/2012	REVISED -	SCALE	SCALE: NONE	SHEET NO. 2 OF 8 SHEETS	STA. TO STA.		ILLINOIS FED. AI		

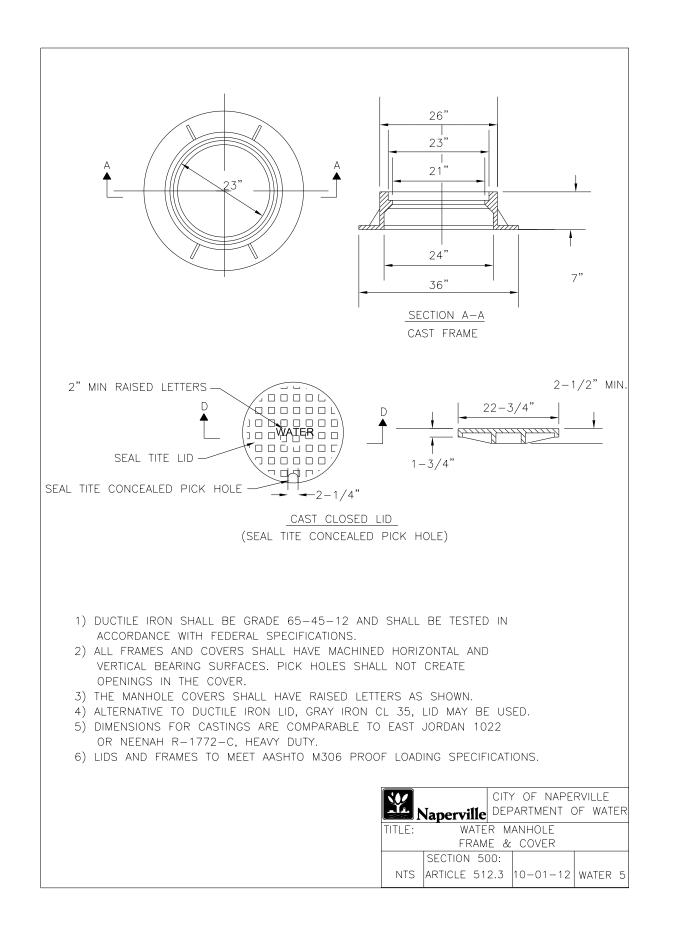


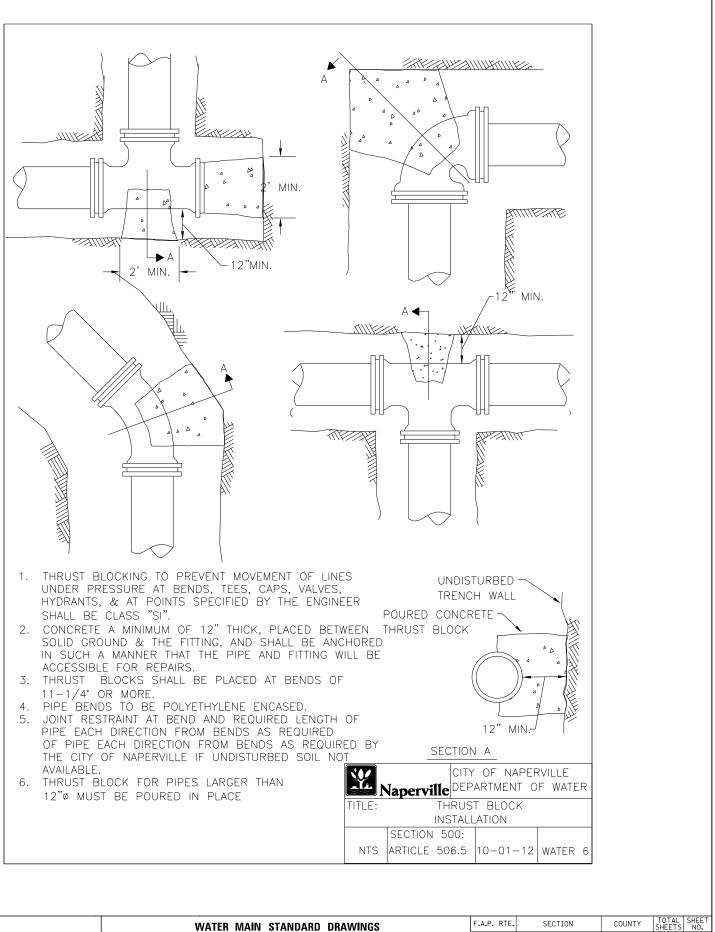

DESIGNED PJO	REVISED -	STATE OF ILLINOIS DEPARTMENT OF TRANSPORTATION	WATER MAIN STANDARD DRAWINGS	F.A.P. RTE. SECTION	COUNTY TOTAL SHEET
DRAWN KES	REVISED -	STATE OF ILLINOIS		338 (112 & 113) WRS-7	DUPAGE 1156 512
CHECKED JCM	REVISED -	DEPARTMENT OF TRANSPORTATION	WATER         MAIN         STANDARD         DRAWINGS           CITY         OF         NAPERVILLE           SCALE:         NONE         SHEET NO. 3 OF 8 SHEETS         STA.         TO STA.	WAT STD-3	CONTRACT NO. 60R30
DATE 12/14/2012	REVISED -	SC	SCALE: NONE SHEET NO. 3 OF 8 SHEETS STA. TO STA.		AID PROJECT

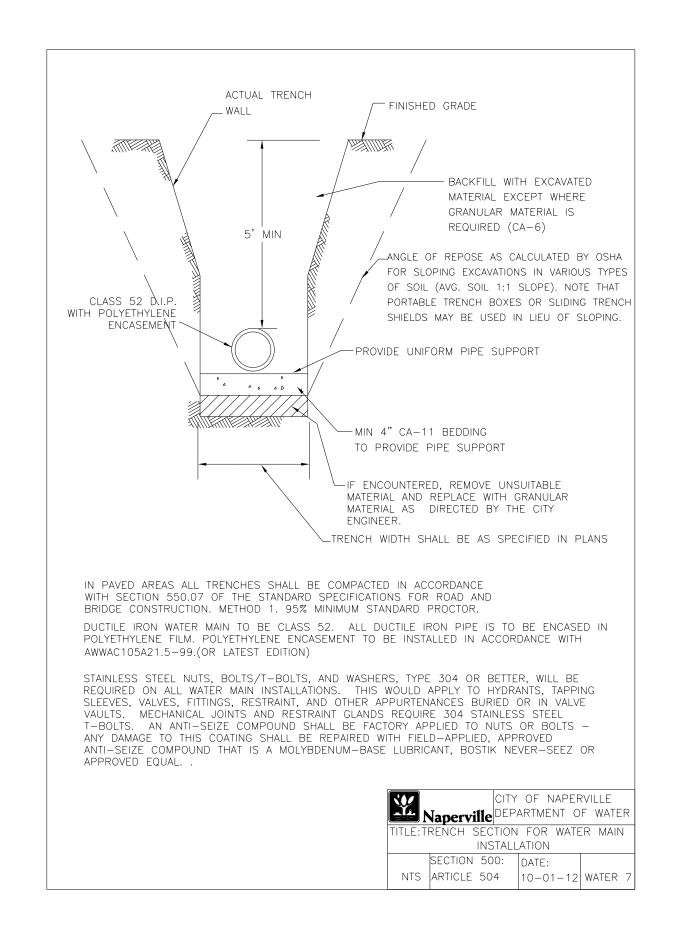

	DESIGNED PJO	REVISED -			WATER MAIN STANDARD DRAWINGS				COUNTY TOTAL SHEETS	SHEET NO.
( – –	DRAWN KES	REVISED -	STATE OF ILLINOIS				338	(112 & 113) WRS-7	DUPAGE 1156	513
	CHECKED JCM	REVISED -	DEPARTMENT OF TRANSPORTATION	CITY OF NAPERVILLE		WAT STD-4	CONTRACT NO. 60	DR30		
	DATE 12/14/2012	REVISED -		SCALE: NONE	SHEET NO. 4 OF 8 SHEETS	STA. TO STA.		ILLINOIS FED. /	AID PROJECT	

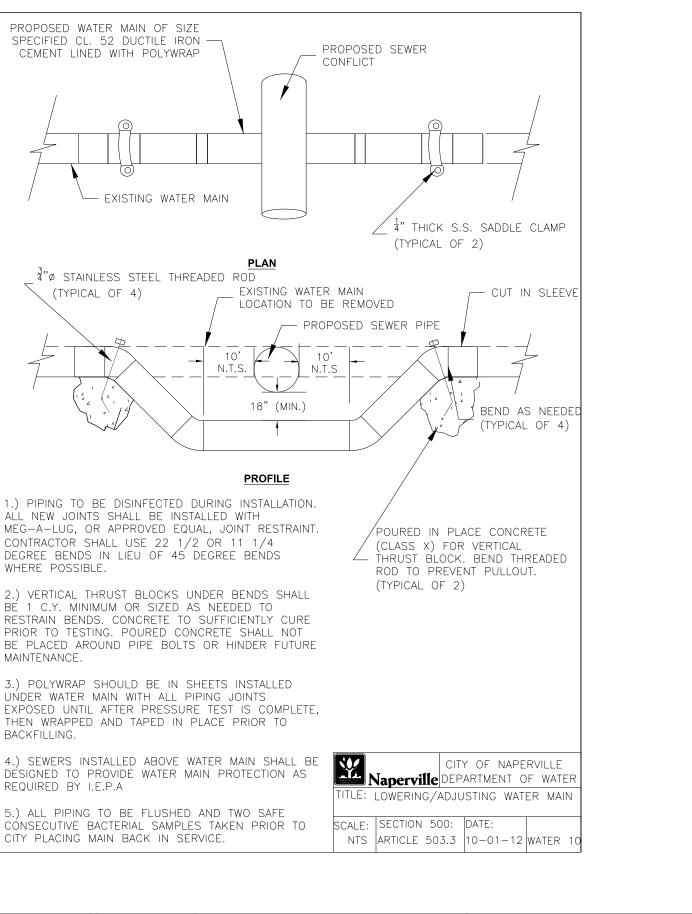


BÉ 1 C.Y. MINIMUM OR SIZED AS NEEDED TO MAINTENANCE.


3.) POLYWRAP SHOULD BE IN SHEETS INSTALLED UNDER WATER MAIN WITH ALL PIPING JOINTS THEN WRAPPED AND TAPED IN PLACE PRIOR TO BACKFILLING.


REQUIRED BY I.E.P.A


5.) ALL PIPING TO BE FLUSHED AND TWO SAFE CITY PLACING MAIN BACK IN SERVICE.


DESIGNED PJO	REVISED -			WATER MAIN STANDARD D	NBAWINGS	F.A.P. RTE.	SECTION	COUNTY	TOTAL	HEET
DRAWN KES	REVISED -	STATE OF ILLINOIS					(112 & 113) WRS-7	DUPAGE	1156	514
CHECKED JCM	REVISED -	DEPARTMENT OF TRANSPORTATION	CITY OF NAPERVILLE	.Ը	v	VAT STD-5	CONTRACT	. NO. 60		
DATE 12/14/2012	REVISED -		SCALE: NONE	SHEET NO. 5 OF 8 SHEETS STA.	. TO STA.			AID PROJECT		

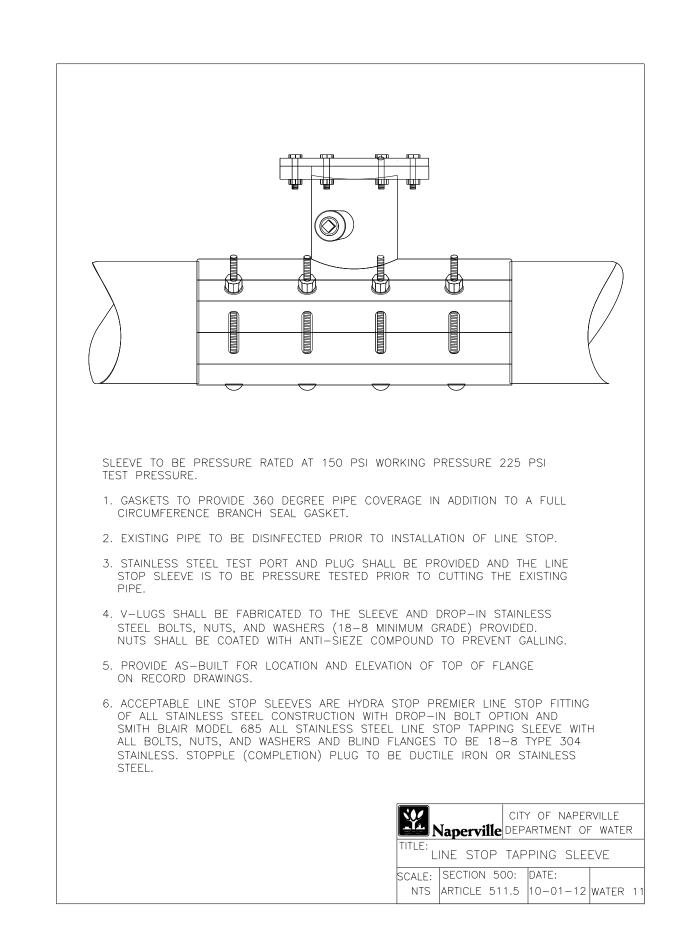

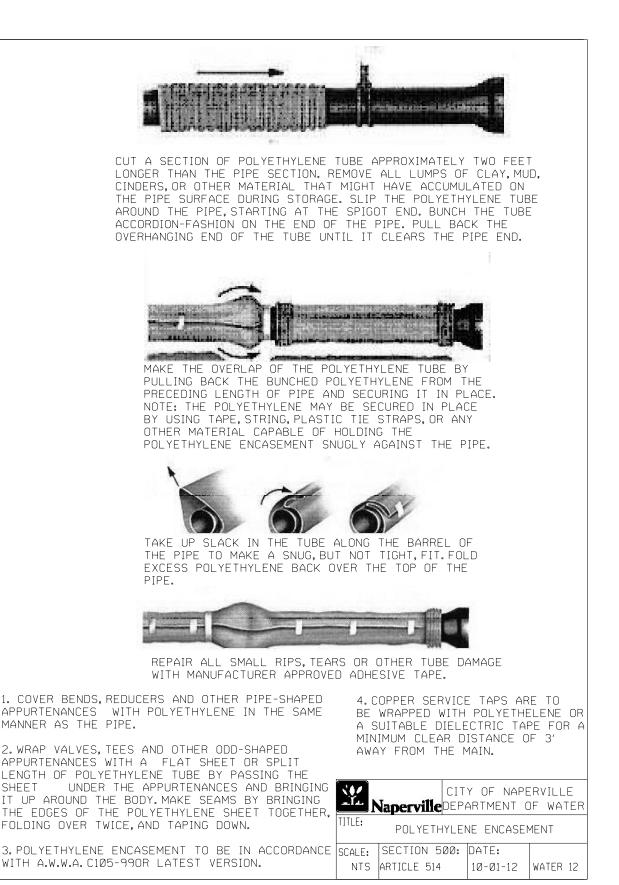

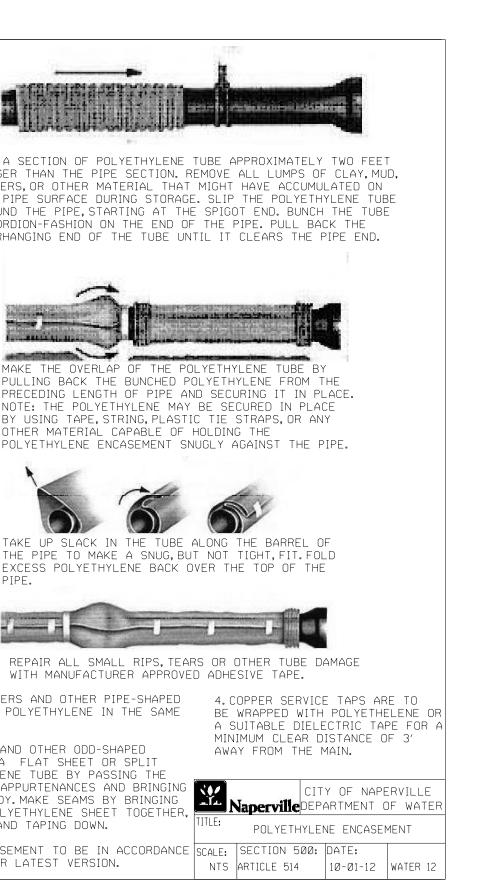

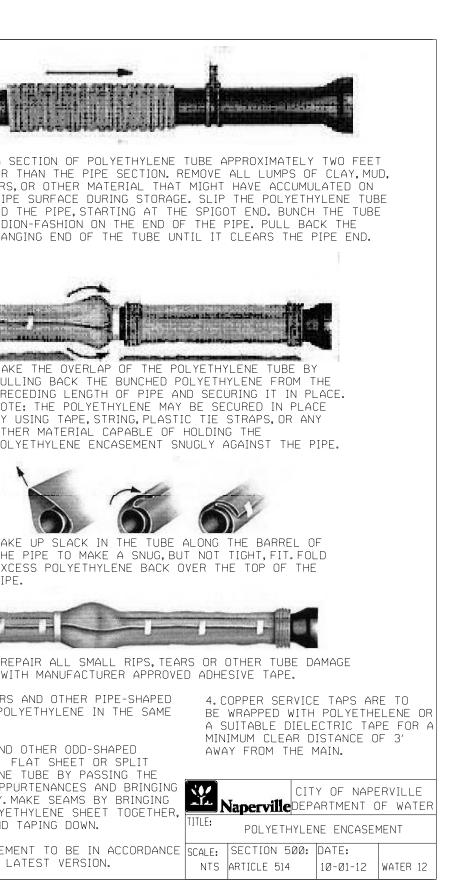

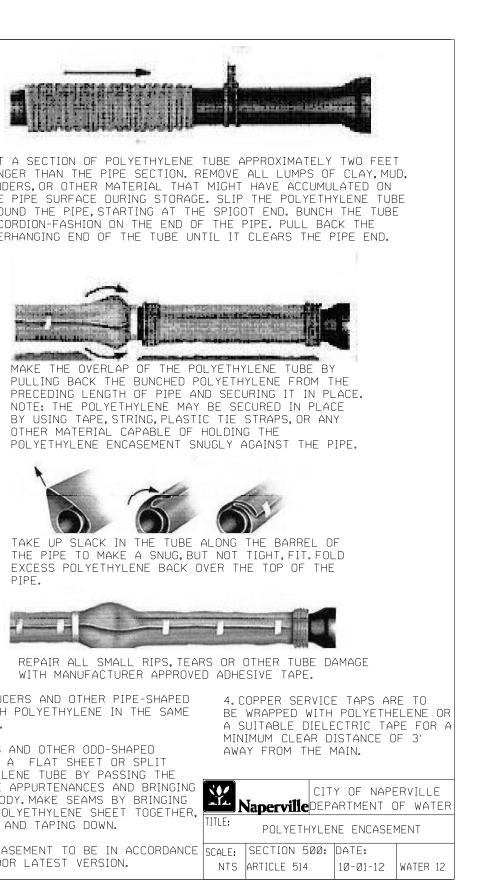


1. COVER BENDS, REDUCERS AND OTHER PIPE-SHAPED APPURTENANCES WITH POLYETHYLENE IN THE SAME MANNER AS THE PIPE.


2. WRAP VALVES, TEES AND OTHER ODD-SHAPED APPURTENANCES WITH A FLAT SHEET OR SPLIT LENGTH OF POLYETHYLENE TUBE BY PASSING THE SHEET UNDER THE APPURTENANCES AND BRINGING IT UP AROUND THE BODY. MAKE SEAMS BY BRINGING THE EDGES OF THE POLYETHYLENE SHEET TOGETHER, FOLDING OVER TWICE, AND TAPING DOWN.

WITH A.W.W.A. C105-990R LATEST VERSION.

DESIGNED PJO	REVISED -		WATER MAIN STANDARD DRAWINGS		F.A.P. RTE.	SECTION	COUNTY	TOTAL SHEET SHEETS NO.
DRAWN KES	REVISED -	STATE OF ILLINOIS	CITY OF NAPERVILLE			(112 & 113) WRS-7	DUPAGE	1156 515
CHECKED JCM	REVISED -	DEPARTMENT OF TRANSPORTATION	CITY OF NAPERVILLE		N N	AT STD-6	CONTRACT	NO. 60R30
DATE 12/14/2012	REVISED -		SCALE: NONE	SHEET NO. 6 OF 8 SHEETS STA. TO STA.			ID PROJECT	

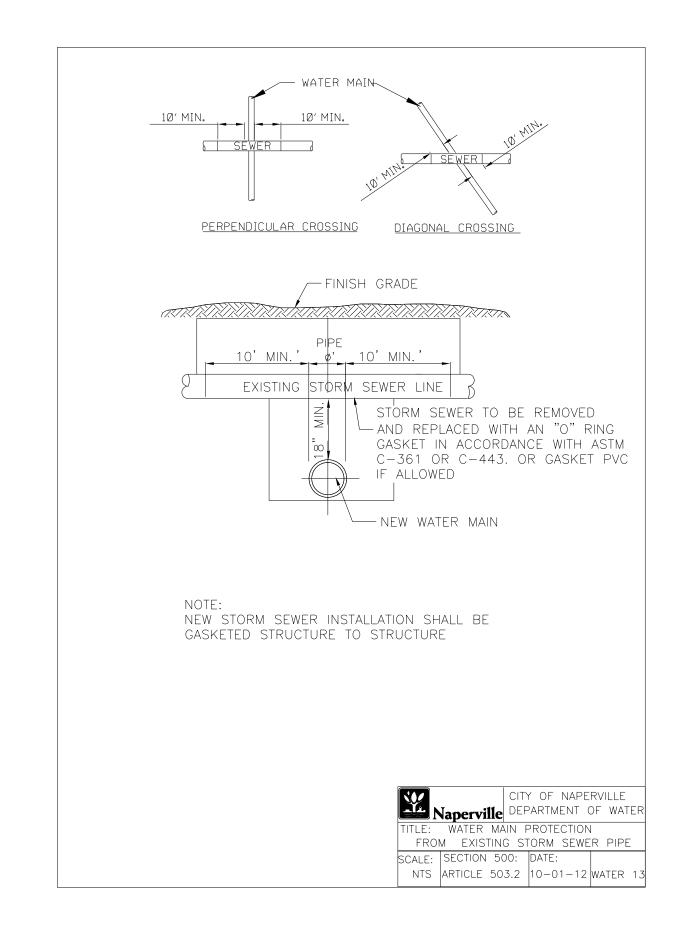


	DESIGNED <i>PJO</i>	REVISED -		WATER MAIN STANDARD DRAWINGS CITY OF NAPERVILLE		F.A.P. RTE	SECTION	COUNTY TOTAL SHEET
	DRAWN KES	REVISED -	STATE OF ILLINOIS			338	(112 & 113) WRS-7	DUPAGE 1156 516
	CHECKED JCM	REVISED -	DEPARTMENT OF TRANSPORTATION				WAT STD-7	CONTRACT NO. 60R30
	DATE 12/14/2012	REVISED -	SC/		SHEET NO. 7 OF 8 SHEETS STA. TO STA.		ILLINOIS FED. AID PROJECT	

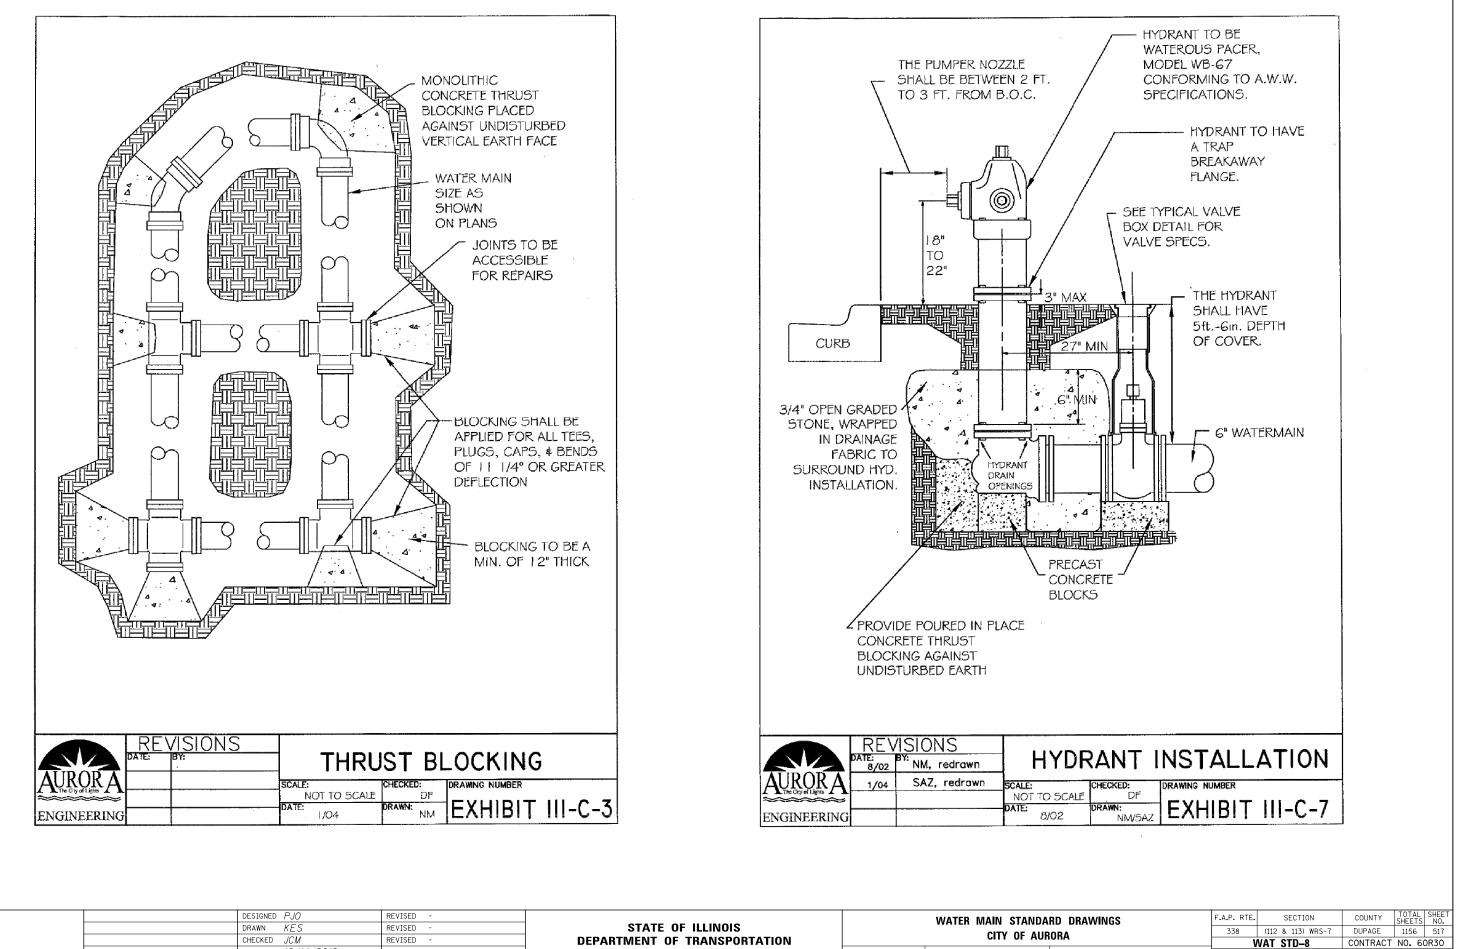

TO STA.


ATD PROJECT

	DESIGNED	PJO	REVISED	-			WATER N	AIN STAND	DARD DRA
	DRAWN	KES	REVISED	-	STATE OF ILLINOIS				
	CHECKED	JCM	REVISED	-	DEPARTMENT OF TRANSPORTATION			CITY OF A	URORA
	DATE	12/14/2012	REVISED	-		SCALE: AS SHOWN	SHEET NO. 8	OF 8 SHEET	S STA.

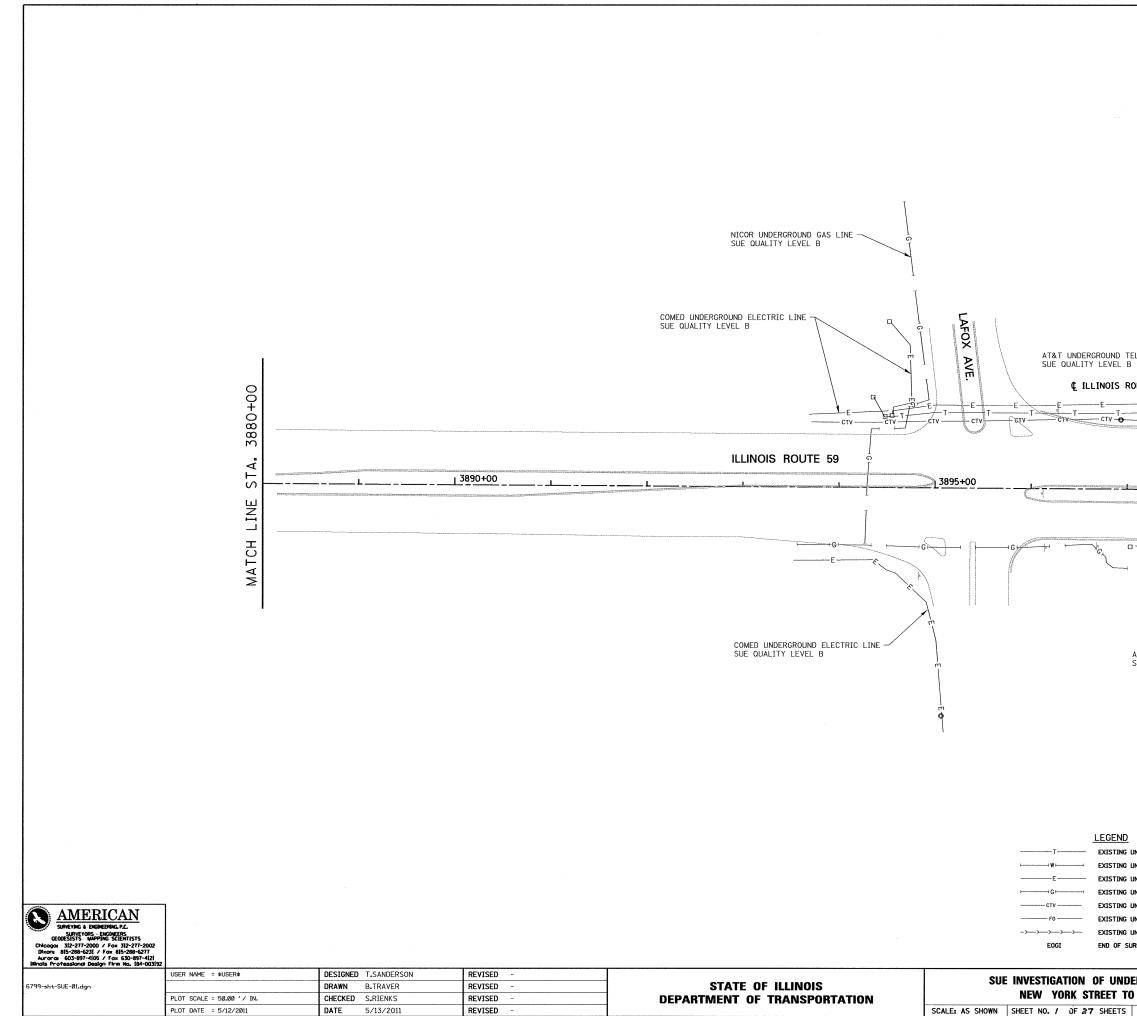

COMED UNDERGROUND E SUE QUALITY LEVEL B COMCAST UNDERGROUND	$\mathbb{N}$
SUE QUALITY LEVEL B EOGI	
	τ <u>τ</u> <u>ε</u> <u>τ</u> <u>ε</u>
	Υ. Υ.
н————————————————————————————————————	MATO
AT&T UNDERGROUND TELEPHONE LIN SUE QUALITY LEVEL B NICOR UNDERGROUND GAS L	~
SUE QUALITY LEVEL B	
	STATE OF ILLINOIS ) COUNTY OF COOK ) S.S. UTILITYLESS SHOWN HEREON HAVE BEEN INVESTIGATED BY ASE IN ACCORDANCE WITH SUE INDUSTRY STANDARDS QUALITY LEVEL B (QLB), ALL OTHER INFORMATION SHOWN HAS BEEN PROVIDED BY OTHERS.
	FROVIDED BOY OTHER. FIELD WORK WAS PERFORMED BETWEEN THE 28TH OF OCTOBER, A.D., 2010 AND THE 8TH DAY OF MAY, A.D., 2011. IN WITNESS WHEREOF, I HAVE HEREUNTO SET MY HAND AND SEAL THIS 13TH DAY OF MAY A.D., 2011. CHICAGO, IL.
	Steven M. Riends STEVEN M. RIENKS - ILLINOIS PROFESSIONAL
UNDERGROUND TELEPHONE UNDERGROUND WATER UNDERGROUND ELECTRIC	ENGINEER NUMBER 62-044619 WY LICENSE EXPIRES 11/30/2011
UNDERGROUND GAS UNDERGROUND CABLE TV UNDERGROUND FIBER OPTIC	0 50' 100' 150' 200'
UNDERGROUND SANITARY SEWER URFACE GEOPHYSICAL INFORMATION	SCALE IN FEET


ERGROUND UTILITIES		F.A.P. RTE.	F.A.P. RTE. SECTION			COUNTY TOTAL SI SHEETS			
		338/IL 59	(112 &	113) WR	s- 7	DUPAGE	1156	518	
, , , , , , , , , , , , , , , , , , , ,							CONTRACT	NO.6	0R30
STA.	TO STA.	3900+00			ILLINOIS	FED. AI	D PROJECT		

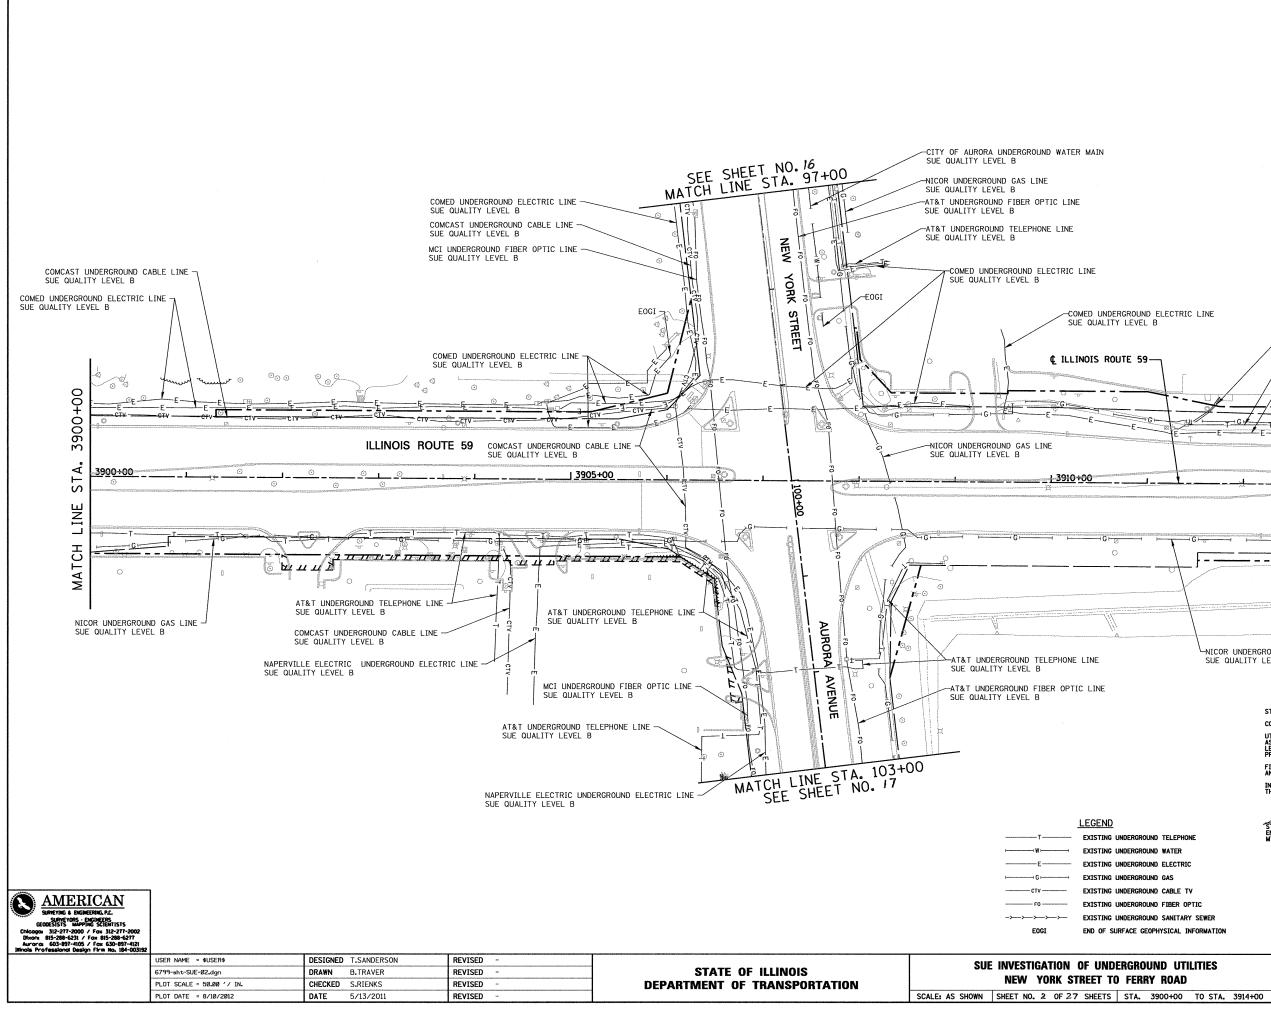


-AT&T UNDERGROUND TELEPHONE LINE SUE QUALITY LEVEL B -COMED UNDERGROUND ELECTRIC LINE SUE QUALITY LEVEL B COMED UNDERGROUND ELECTRIC LINE SUE QUALITY LEVEL B -NICOR UNDERGROUND GAS LINE SUE QUALITY LEVEL B 00+ GH 3914-Å -S. LINE MATCH чици UNICOR UNDERGROUND GAS LINE SUE QUALITY LEVEL B STATE OF ILLINOIS ) COUNTY OF COOK ) S.S. UTILITY(IES) SHOWN HEREON HAVE BEEN INVESTIGATED BY ASE IN ACCORDANCE WITH SUE INDUSTRY STANDARDS QUALITY LEVEL B (QLB). ALL OTHER INFORMATION SHOWN HAS BEEN PROVIDED BY OTHERS. FIELD WORK WAS PERFORMED BETWEEN THE 28TH OF OCTOBER, A.D., 2010 AND THE 8TH DAY OF MAY, A.D., 2011, AND THE 25TH OF JULY, A.D., 2012. IN WITNESS WHEREOF, I HAVE HEREUNTO SET MY HAND AND SEAL THIS 10TH DAY OF AUGUST A.D., 2012, CHICAGO, IL. M. STEVEN M. RIENKS TI I INOIS PROFESSIONAL INEER NUMBER 62-044619 LICENSE EXPIRES 11/30/2013 EXISTING UNDERGROUND TELEPHONE EXISTING UNDERGROUND WATER EXISTING UNDERGROUND ELECTRIC EXISTING UNDERGROUND GAS EXISTING UNDERGROUND CABLE TV EXISTING UNDERGROUND FIBER OPTIC EXISTING UNDERGROUND SANITARY SEWER SCALE IN FEET END OF SURFACE GEOPHYSICAL INFORMATION TOTAL SHEET SHEETS NO. 1156 519 A.P. RTE. SECTION COUNTY 338/IL 59 (112 & 113) WRS-7 DUPAGE CONTRACT NO. 60R30


ILLINOIS FED. AID PROJECT

**>**-Ĝ->Z

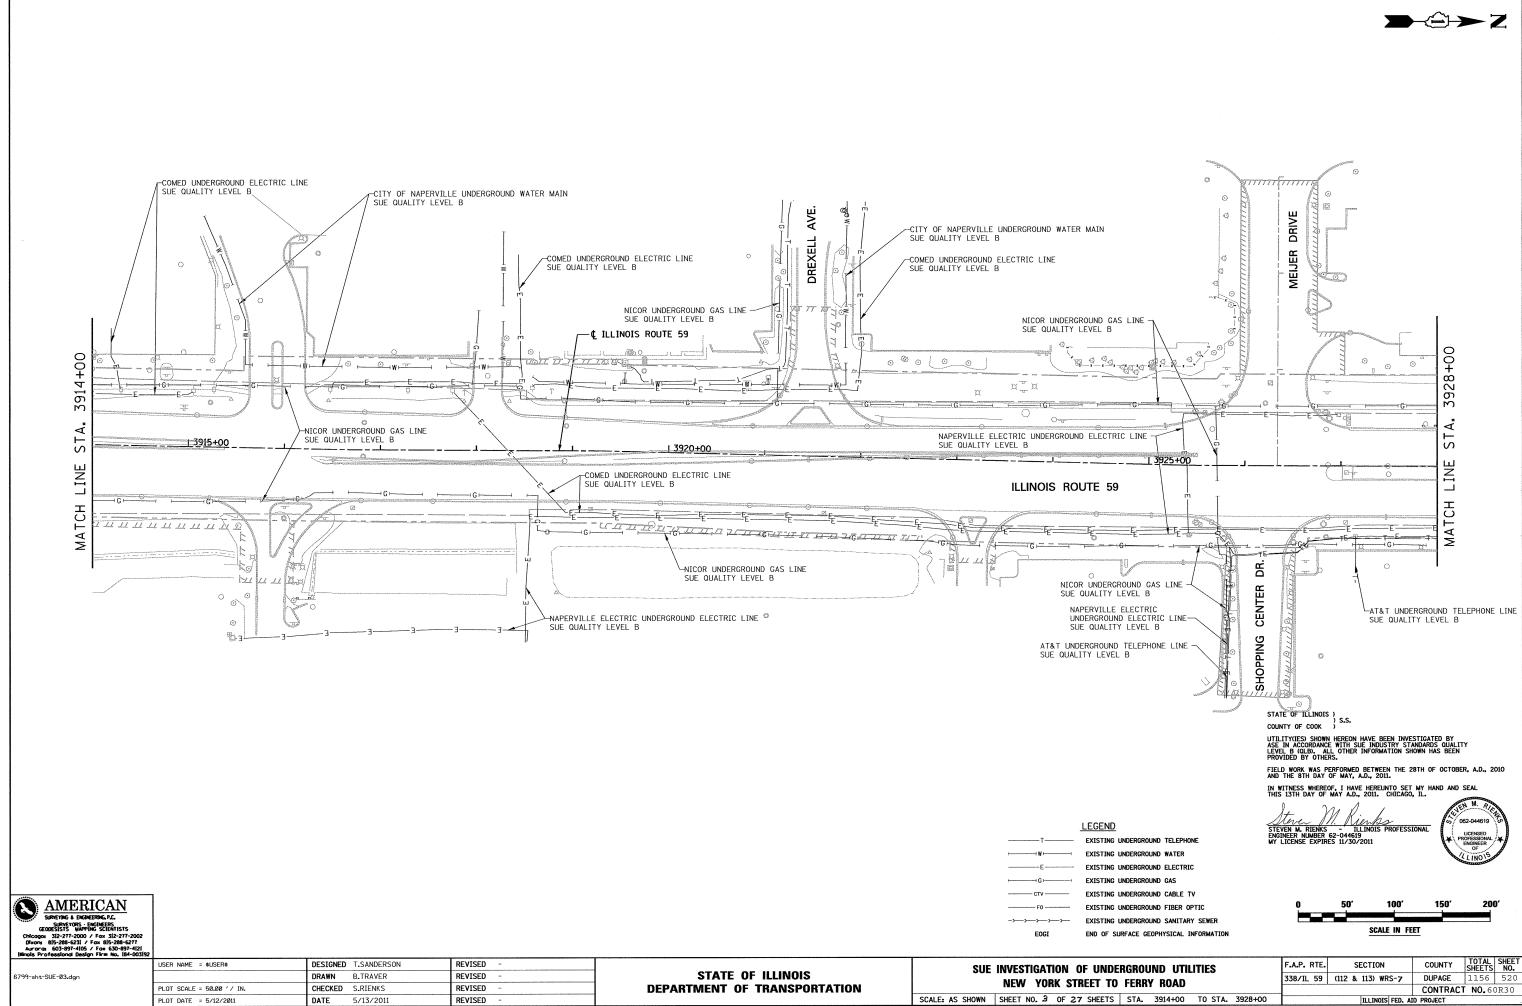

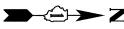


E	ERGROUND UTILITIES			F.A.P. RTE.	SEC	TION	COUNTY	SHEETS	NO.	
n	) FERRY ROAD				338/IL 59	(112 & 11	3) WRS-7	DUPAGE	1156	520
						CONTRACT	NO.60	DR30		
;	STA.	3914+00	TO STA.	3928+00		IL	LINOIS FED.	AID PROJECT		~

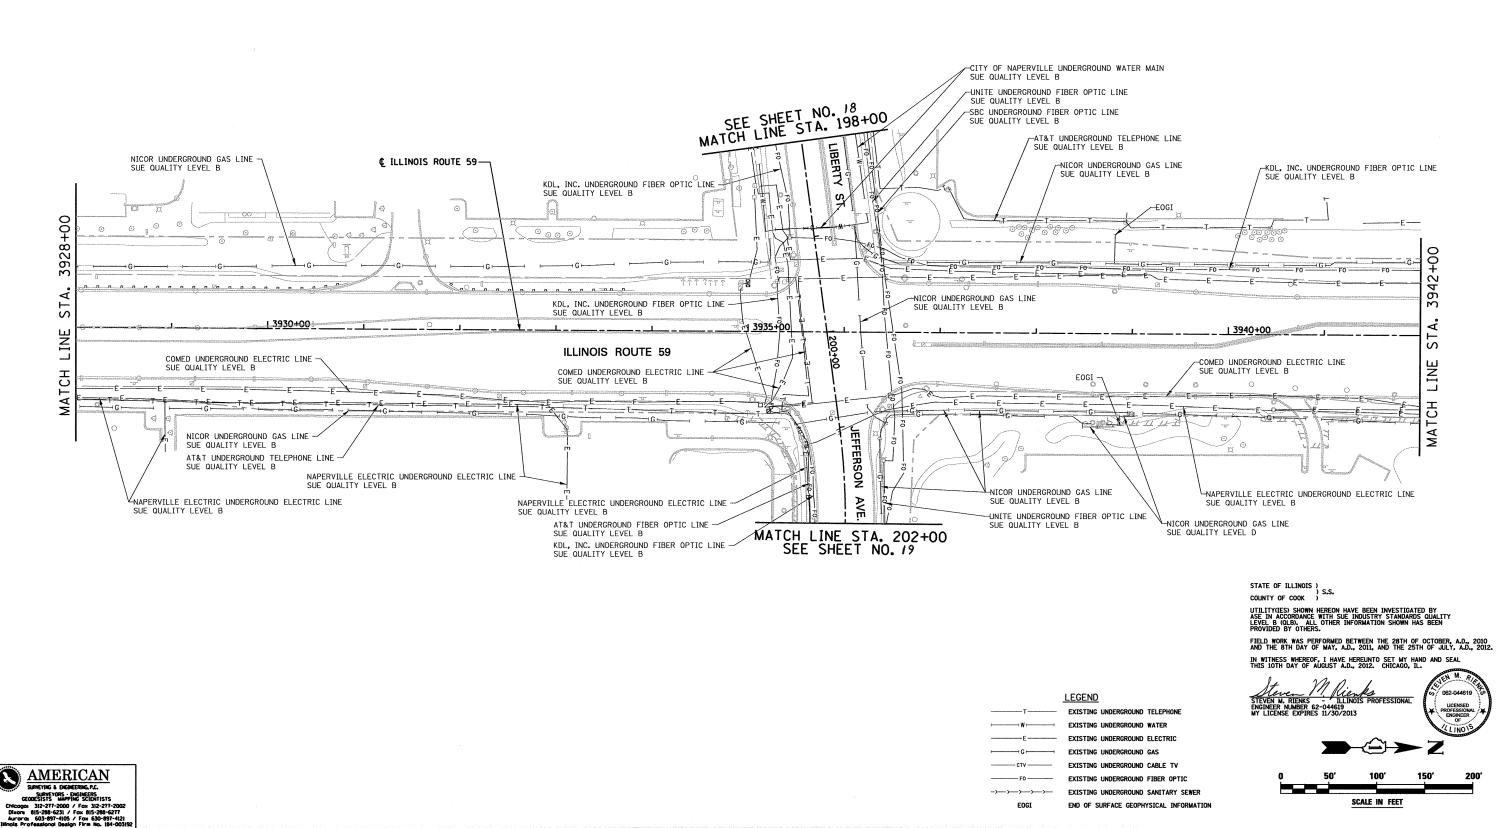

EOGI	end of sur
	EXISTING UN
F0	EXISTING UN
CTV	EXISTING UN
H	EXISTING UN
EEE	EXISTING UN
H	EXISTING UN
T	EXISTING UN
	LEGEND

	AMERICAN	
	SURVEYING & ENGINEERING, P.C.	
	SURVEYORS · ENGINEERS EODESISTS MAPPING SCIENTISTS	
Chicog	a: 312-277-2000 / Fax 312-277-2002	
Dixon	815-288-6231 / Fax 815-288-6277	

NO. 184-003192									4
	USER NAME = \$USER\$	DESIGNED T.SANDERSON	REVISED -		SUE INVESTIGATION OF UNDERGROUND UTILITIES	F.A.P. RTE.	SECTION	COUNTY TOTAL SHEET	1
	6799-sht-SUE-04.dgn	DRAWN B.TRAVER	REVISED -	STATE OF ILLINOIS		338/IL 59 (112 8	& 113) WRS-7	DUPAGE 1156 521	i i
	PLOT SCALE = 50.00 '/ IN.	CHECKED S.RIENKS	REVISED -	DEPARTMENT OF TRANSPORTATION	NEW YORK STREET TO FERRY ROAD			CONTRACT NO. 60R30	1
	PLOT DATE = 8/10/2012	DATE 5/13/2011	REVISED -		SCALE: AS SHOWN SHEET NO. 4 OF 27 SHEETS STA. 3928+00 TO STA. 3942+00			PROJECT	i i

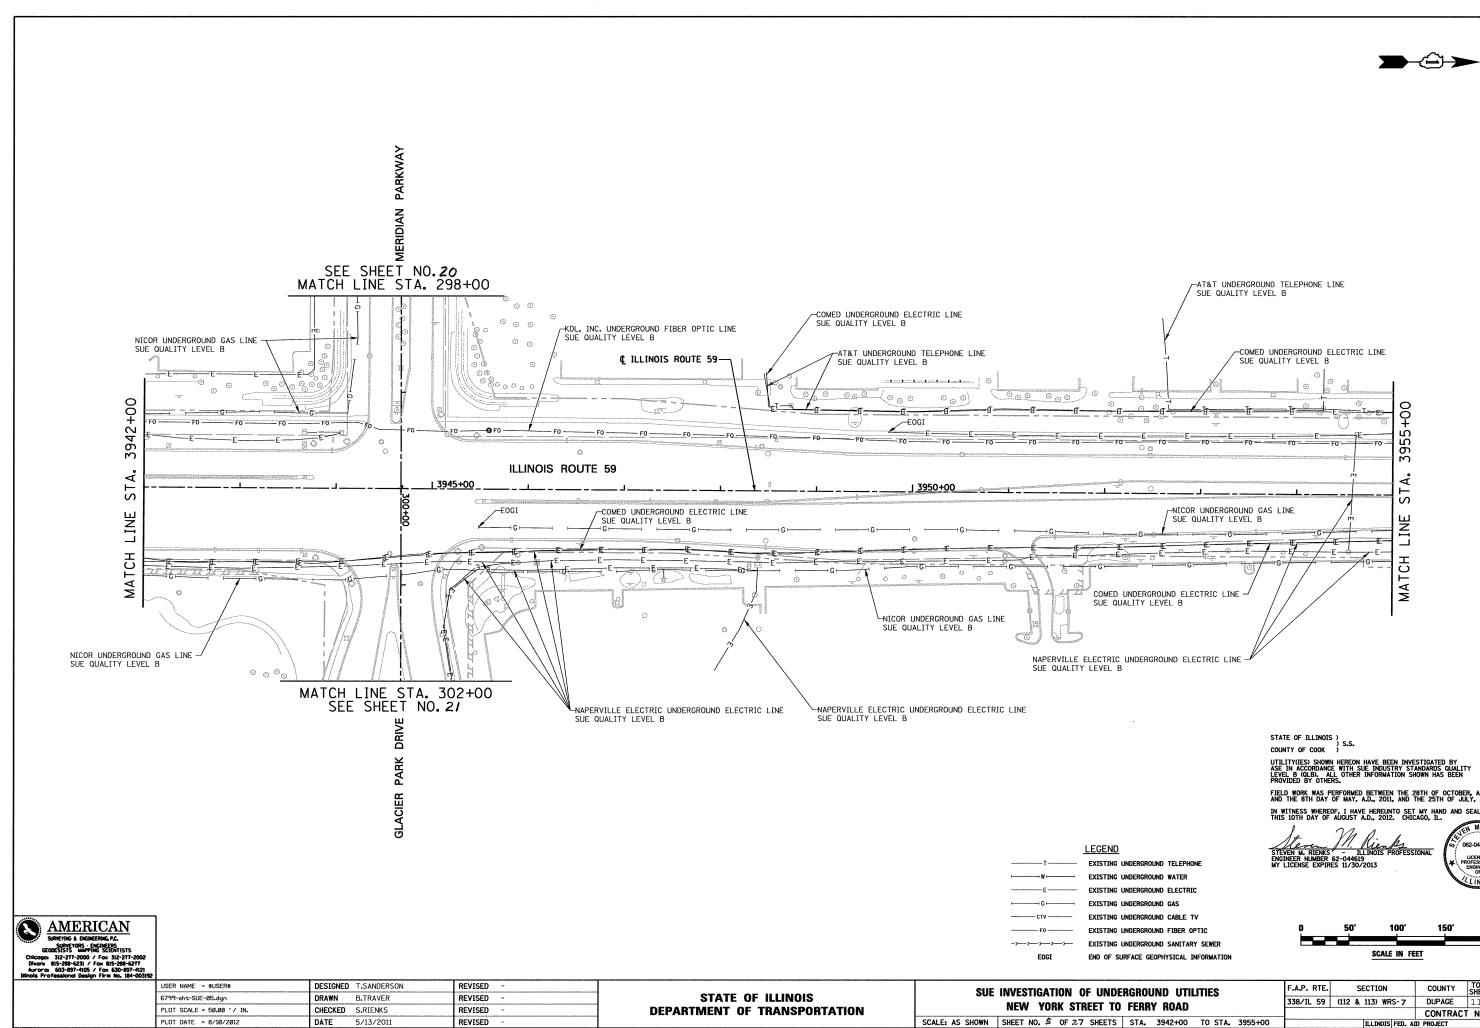

ERGROUND UTILITIES	F.A.P. RTE.	SECTION	COUNTY	TOTAL SHEETS	SHEET NO.
FERRY ROAD	338/IL 59	(112 & 113) WRS-7	DUPAGE	1156	522
			CONTRAC	T NO.60	DR30
STA. 3942+00 TO STA. 3955+00		ILLINOIS FED. AI	D PROJECT		


0	50'	100'	150'	200
		SCALE IN FEFT		

STEVEN M. RIENKS - ILLINOIS PROFESSIONAL BROINEER NUMBER 52-044619 MY LICENSE EXPIRES 11/30/2013

FIELD WORK WAS PERFORMED BETWEEN THE 28TH OF OCTOBER, A.D., 2010 AND THE 8TH DAY OF MAY, A.D., 2011, AND THE 25TH OF JULY, A.D., 2012.

UTILITY(IES) SHOWN HEREON HAVE BEEN INVESTIGATED BY ASE IN ACCORDANCE WITH SUE INDUSTRY STANDARDS QUALITY LEVEL B (QLB), ALL OTHER INFORMATION SHOWN HAS BEEN PROVIDED BY OTHERS.


**→** → Z

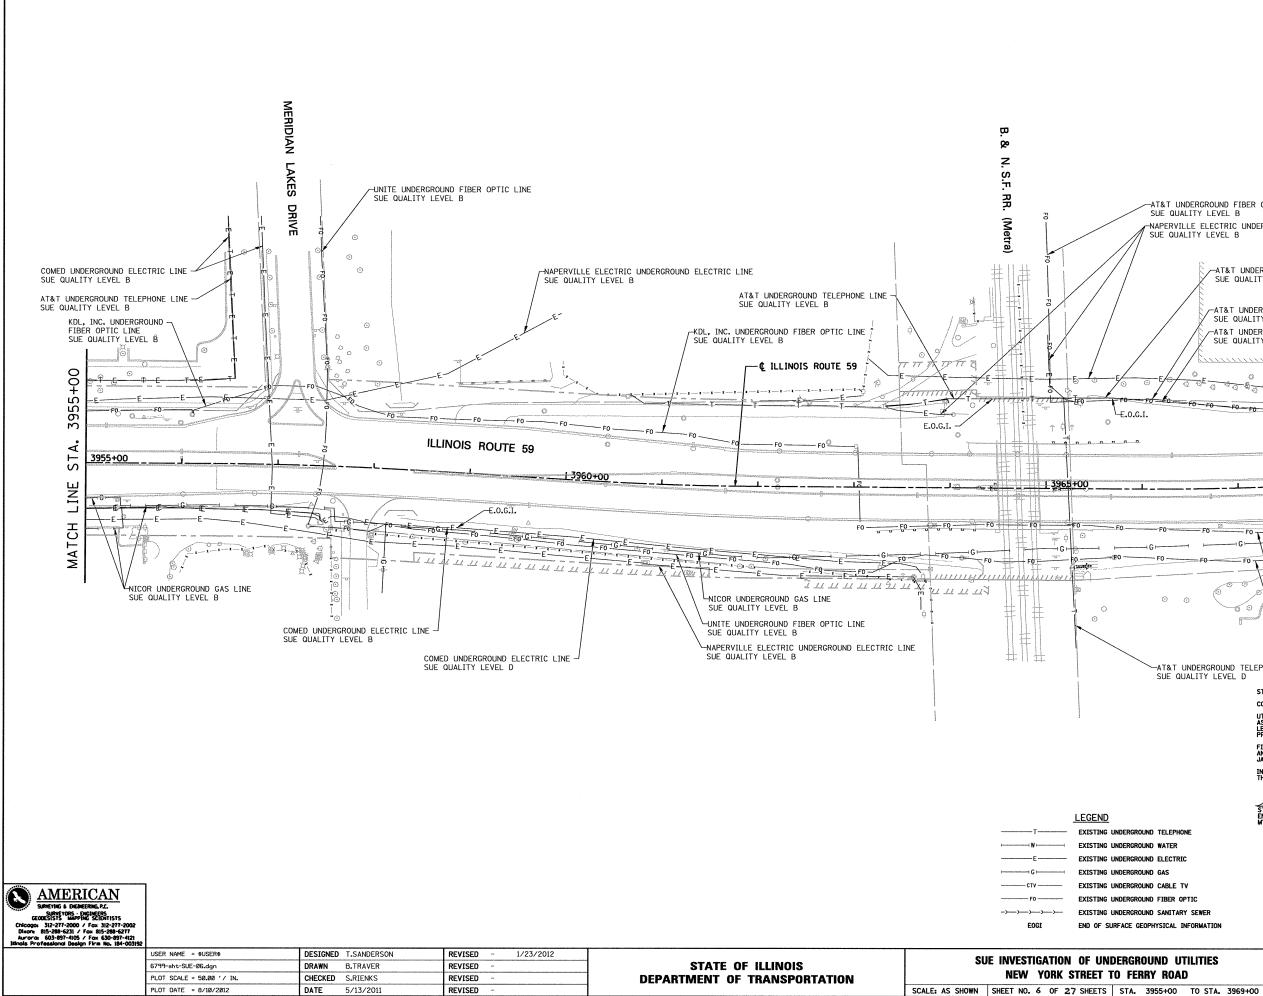

-AT&T UNDERGROUND FIBER OPTIC LINE SUE QUALITY LEVEL B NAPERVILLE ELECTRIC UNDERGROUND ELECTRIC LINE SUE QUALITY LEVEL B -AT&T UNDERGROUND TELEPHONE LINE SUE QUALITY LEVEL D -AT&T UNDERGROUND FIBER OPTIC LINE (COMMON DUCT) SUE QUALITY LEVEL B AT&T UNDERGROUND TELEPHONE LINE (COMMON DUCT) SUE QUALITY LEVEL B MATCH -F0--F0 -E.O.G.I. LINE S \_\_\_\_. ,T A З 6963 +00 -KDL, INC. UNDERGROUND FIBER OPTIC LINE SUE QUALITY LEVEL B UNITE UNDERGROUND FIBER OPTIC LINE SUE QUALITY LEVEL B -AT&T UNDERGROUND TELEPHONE LINE SUE QUALITY LEVEL D STATE OF ILLINOIS ) COUNTY OF COOK } S.S. UTILITY(IES) SHOWN HEREON HAVE BEEN INVESTIGATED BY ASE IN ACCORDANCE WITH SUE INDUSTRY STANDARDS QUALITY LEVEL B (QLB), ALL OTHER INFORMATION SHOWN HAS BEEN PROVIDED BY OTHERS. FIELD WORK WAS PERFORMED BETWEEN THE 28TH OF OCTOBER, A.D., 2010 AND THE 8TH DAY OF MAY, A.D., 2011 AND ON THE 19TH DAY OF JANUARY, A.D., 2012, AND THE 25TH DAY OF JULY, A.D., 2012. IN WITNESS WHEREOF, I HAVE HEREUNTO SET MY HAND AND SEAL THIS 10TH DAY OF AUGUST A.D., 2012. CHICAGO, IL. M. Aleven M. RIENKS - ILLINOIS PROFESSIONAL ENGINEER NUMBER 62-044619 WY LICENSE EXPIRES 11/30/2013 EXISTING UNDERGROUND TELEPHONE EXISTING UNDERGROUND WATER EXISTING UNDERGROUND ELECTRIC EXISTING UNDERGROUND GAS EXISTING UNDERGROUND CABLE TV 200 EXISTING UNDERGROUND FIBER OPTIC EXISTING UNDERGROUND SANITARY SEWER SCALE IN FEET END OF SURFACE GEOPHYSICAL INFORMATION COUNTYTOTAL<br/>SHEETSSHEET<br/>NO.DUPAGE1156523 F.A.P. RTE. SECTION 338/IL 59 (112 & 113) WRS-7 CONTRACT NO.60R30

ILLINOIS FED. AID PROJECT

≫-⊖→Z

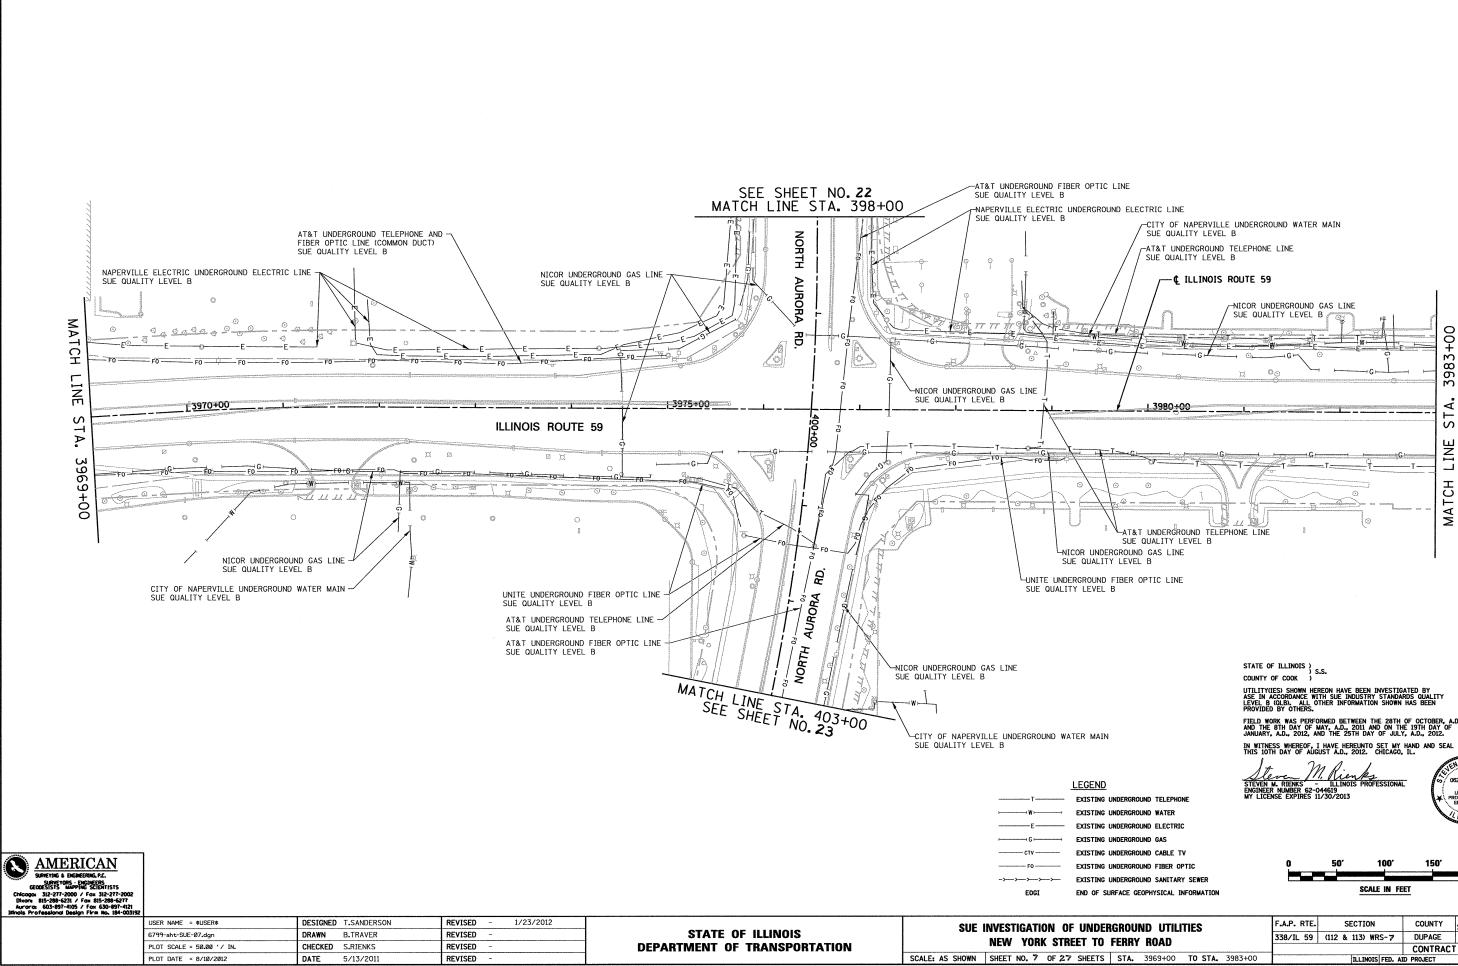

IURFACE GEOPHYSICAL INFORMATION SCALE IN FEET								
RGRO	UND UTIL	TIES		F.A.P. RTE.	SECTION	COUNTY	TOTAL SHEETS	SHEET NO.
FERRY ROAD			338/IL 59	(112 & 113) WRS-7	DUPAGE	1156	524	
I LIU	CONTRACT NO.60R30							
STA	. 3969+00	TO STA.	3983+00		ILLINOIS FED. AI	D PROJECT		

Q	50'	100'	150'	200'
		SCALE IN FEFT	•	

FIELD WORK WAS PERFORMED BETWEEN THE 28TH OF OCTOBER, A.D., 2010 AND THE 8TH DAY OF MAY, A.D., 2011 AND ON THE 19TH DAY OF JANUARY, A.D., 2012, AND THE 25TH DAY OF JULY, A.D., 2012.


►⇔Z

	6799-sht-SUE-02A.dgn PLOT SCALE = 50.00 '/ IN. PLOT DATE = 8/10/2012	DRAWN     B.TRAVER       CHECKED     S.RIENKS       DATE     5/13/2011	REVISED - REVISED - REVISED -	STATE OF ILLINOIS DEPARTMENT OF TRANSPORTATION	NEW YORK STREET TO FI
AMERICAN SUPETING & DIGHEDING, P.L. GEODESISTS Chocopa SU-277-2000 / Fox 312-217-2002 Dison 815-288-6231 / Fox 615-288-6277 Aurora 603-897-612 / Fox 615-289-6277 Harols Professional Design Firm No. 184-003132	USER NAME = \$USER\$	DESIGNED T.SANDERSON	REVISED -	STATE OF ILLINOIS	LEGEND         T       EXISTING UNDERI         WI       EXISTING UNDERI         E       EXISTING UNDERI         CI       EXISTING UNDERI         FO       EXISTING UNDERI         FO       EXISTING UNDERI         EOGI       END OF SURFACE
		<u> </u>		AT&T UNDERGROUND TELEPHONE LINE SUE QUALITY LEVEL B COMED UNDERGROUND ELECTRIC LINE SUE QUALITY LEVEL D COMED UNDERGROUND ELECTRIC LINE	COMED UNDERGROUND ELECTRIC LINE SUE QUALITY LEVEL D
	0 0 0 0 0 0 0 0 0 0 0 0 0 0 0 0 0 0 0	×00	NEW YORK STR	<u>90+00</u>	

CITY OF AURORA UNDERGROUND W SUE QUALITY LEVEL B AT&T UNDERGROUND TELEPHONE LINE SUE QUALITY LEVEL B THE ENTRE E THE ETHER E THE E			o old a bring	
SUE QUAL	ITY LEVEL B	) CABLE LINE — <sup>7</sup> ROUND WATER MAIN		
CO UT AS FR FR AN IN TH ST ST ST	ELD WORK WAS P D THE 8TH DAY	S.S. HEREON HAVE BEEN INVE E WITH SUE INDUSTRY ST L OTHER INFORMATION SI NS. ENFORMED BETWEEN THE OF MAY, A.D., 2011, AND OF, I HAVE HEREUNTO SET AUGUST A.D., 2012. CHIL M. LILINOIS PROFESS 62-044619 PROFESS 62-044619	28TH OF OCTOB THE 25TH OF JI MY HAND AND CAGO, IL.	ER, A.D., 2010 ULY, A.D., 2012.
UNDERGROUND FIBER OPTIC UNDERGROUND SANITARY SEWER SURFACE GEOPHYSICAL INFORMATION		50' 100' Scale in Fe	150' ET	200'
DERGROUND UTILITIES	F.A.P. RTE.	SECTION		TOTAL SHEET SHEETS NO.

FERRY ROAD         338/IL 59         (112 & 113) WRS-7         DUPAGE         1156         525           STA.         TO STA.         97+00         Inlinois/FED. AD PROJECT         CONTRACT NO.60R30	KGRUUND UIILIIIES		[F.A.P. ]	(IE.		SECTI	ON	COUNTY	SHEETS	NO.
CONTRACT NO.60R30			338/IL	59	(112 8	& 113)	WRS-7	DUPAGE	1156	525
STA. TO STA. 97+00 ILLINOIS FED. AID PROJECT								CONTRACT	NO.60	)R30
	STA.	TO STA.	97+00	ILLINOIS FED. AID PROJECT						

MATCH LINE STA. 103+00	$\begin{array}{c} & & & & \\ & & & & \\ & & & \\ & & & \\ & & & \\ & & & \\ & & & & \\ & & & \\ & & & &$		PO FO	NE NAPERVILLE ELECTRIC UNDERGROUND ELECTRIC LINE SUE QUALITY LEVEL B (a) $(b)$ $(c)$	EOGI EO EO EO EO EO EO EO EO EO EO	VILLE UNDERGROUND WATER MAIN EVEL D TILLE UNDERGROUND WATER MAIN EVEL B TITY OF NAPERVILLE UNDERGROUND WATER MAIN SUE QUALITY LEVEL D AT&T UNDERGROUND FIBER OPTIC LINE SUE QUALITY LEVEL B CONTINUE CON
AMERICAN SIMETIKA & DISIMETRIKA, P.C. SEMETIKA & DISIMETRIKA, P.C. SECONSTRUCTION OF CAN 312-217-2002 CHOOGON 315-207-2000 / Fax 312-217-2002 CHOOGON 315-207-2000 / Fax 312-217-2002 CHOOGON 315-207-2000 / Fax 312-217-2002 Marcira Gol-897-4105 / Fax 530-857-4121 Bindok Profession Design Firm An. 184-2031-2012					T       EXISTING UNDERGROUND TELEPHONE         WI       EXISTING UNDERGROUND WATER         E       EXISTING UNDERGROUND BLECTRIC         E       EXISTING UNDERGROUND GAS         CTV       EXISTING UNDERGROUND CABLE TV         F0       EXISTING UNDERGROUND FIBER OPTIC         CTV       EXISTING UNDERGROUND FIBER OPTIC         E       EXISTING UNDERGROUND SANITARY SEWER         EOGI       END OF SURFACE GEOPHYSICAL INFORMATION	COUNTY OF COOK } SS. UTILITYIESS SHOWN HEREON HAVE BEEN INVESTIGATED BY AREA DATABASE WITH HEREON HAVE BEEN INVESTIGATED BY AREA DATABASE WITH USE INDUSTRY STANDARD COLLITY LEVEL B (OLB). ALL OTHER INFORMATION SHOWN HAS BEEN FIELD WORK WAS PERFORMED BETWEEN THE 28TH OF OCTOBER, A.D., 2010. AND THE 9TH DAY OF MAY, A.D., 2011. AND THE 28TH OF JULY, A.D., 2010. IN WITNESS WHEREOF, I HAVE HEREINTH 28TH OF AND AND SEAL INTINESS WHEREOF, I HAVE HEREINTH SET WY HAND AND SEAL STEVEN M. RIENES - ILLINOIS PROFESSIONAL STEVEN M. RIENES - ILLINOIS PROFESSIONAL WY LICENSE EXPIRES 11/30/2013 UCENSED 0 50' 100' 150' 200' LINOIS
	USER NAME = #USER\$ 6799-sht-SUE-02B.dgn PLOT SCALE = 50.00 '/ IN. PLOT DATE = 8/10/2012	DESIGNED     T.SANDERSON       DRAWN     B.TRAVER       CHECKED     S.RIENKS       DATE     5/13/2011	REVISED         -           REVISED         -           REVISED         -           REVISED         -           REVISED         -	STATE OF ILLINOIS DEPARTMENT OF TRANSPORTATION	SUE INVESTIGATION OF UNDERGROUND UTILITIES NEW YORK STREET TO FERRY ROAD           SCALE: AS SHOWN         SHEET NO. /7 OF 27 SHEETS         STA.         103+00         TO STA.	F.A.P. RTE.         SECTION         COUNTY         TOTAL SHEETS         NO.           338/IL 59         (112 & 113) WRS-7         DUPAGE         1156         526           CONTRACT NO.60R30           ILLINOIS/FED. AID PROJECT

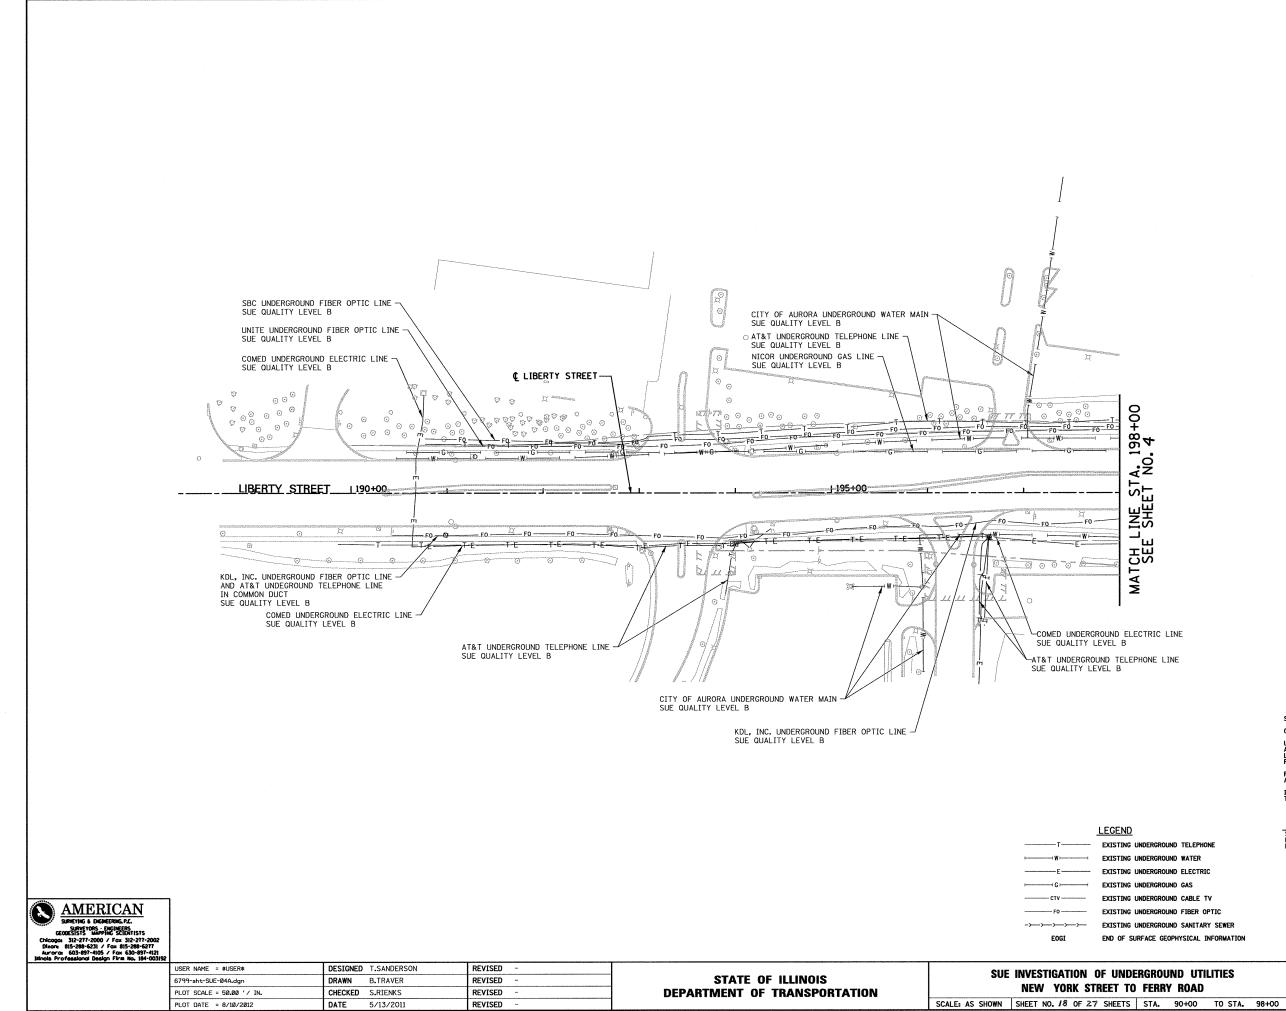

864 No.1 INE ST SHEET SEE

STATE OF ILLINOIS ) S.S. COUNTY OF COOK

UTILITY(IES) SHOWN HEREON HAVE BEEN INVESTIGATED BY ASE IN ACCORDANCE WITH SUE INDUSTRY STANDARDS QUALITY LEVEL B (QLB), ALL OTHER INFORMATION SHOWN HAS BEEN PROVIDED BY OTHERS.

FIELD WORK WAS PERFORMED BETWEEN THE 28TH OF OCTOBER, A.D., 2010 AND THE 8TH DAY OF MAY, A.D., 2011, AND THE 25TH OF JULY, A.D., 2012.


N


IN WITNESS WHEREOF, I HAVE HEREUNTO SET MY HAND AND SEAL THIS 10TH DAY OF AUGUST A.D., 2012. CHICAGO, IL.

M. STEVEN M. RIENKS - LLINDIS PROFESSIONAL ENGINEER NUMBER 62-044619 MY LICENSE EXPIRES 11/30/2013

0	50'	100'	150'	200
		SCALE IN FEET		

TOTAL SHEET SHEETS NO. F.A.P. RTE. SECTION COUNTY 338/IL 59 (112 & 113) WRS-7 DUPAGE 1156 527 CONTRACT NO.60R30 ILLINOIS FED. AID PROJECT

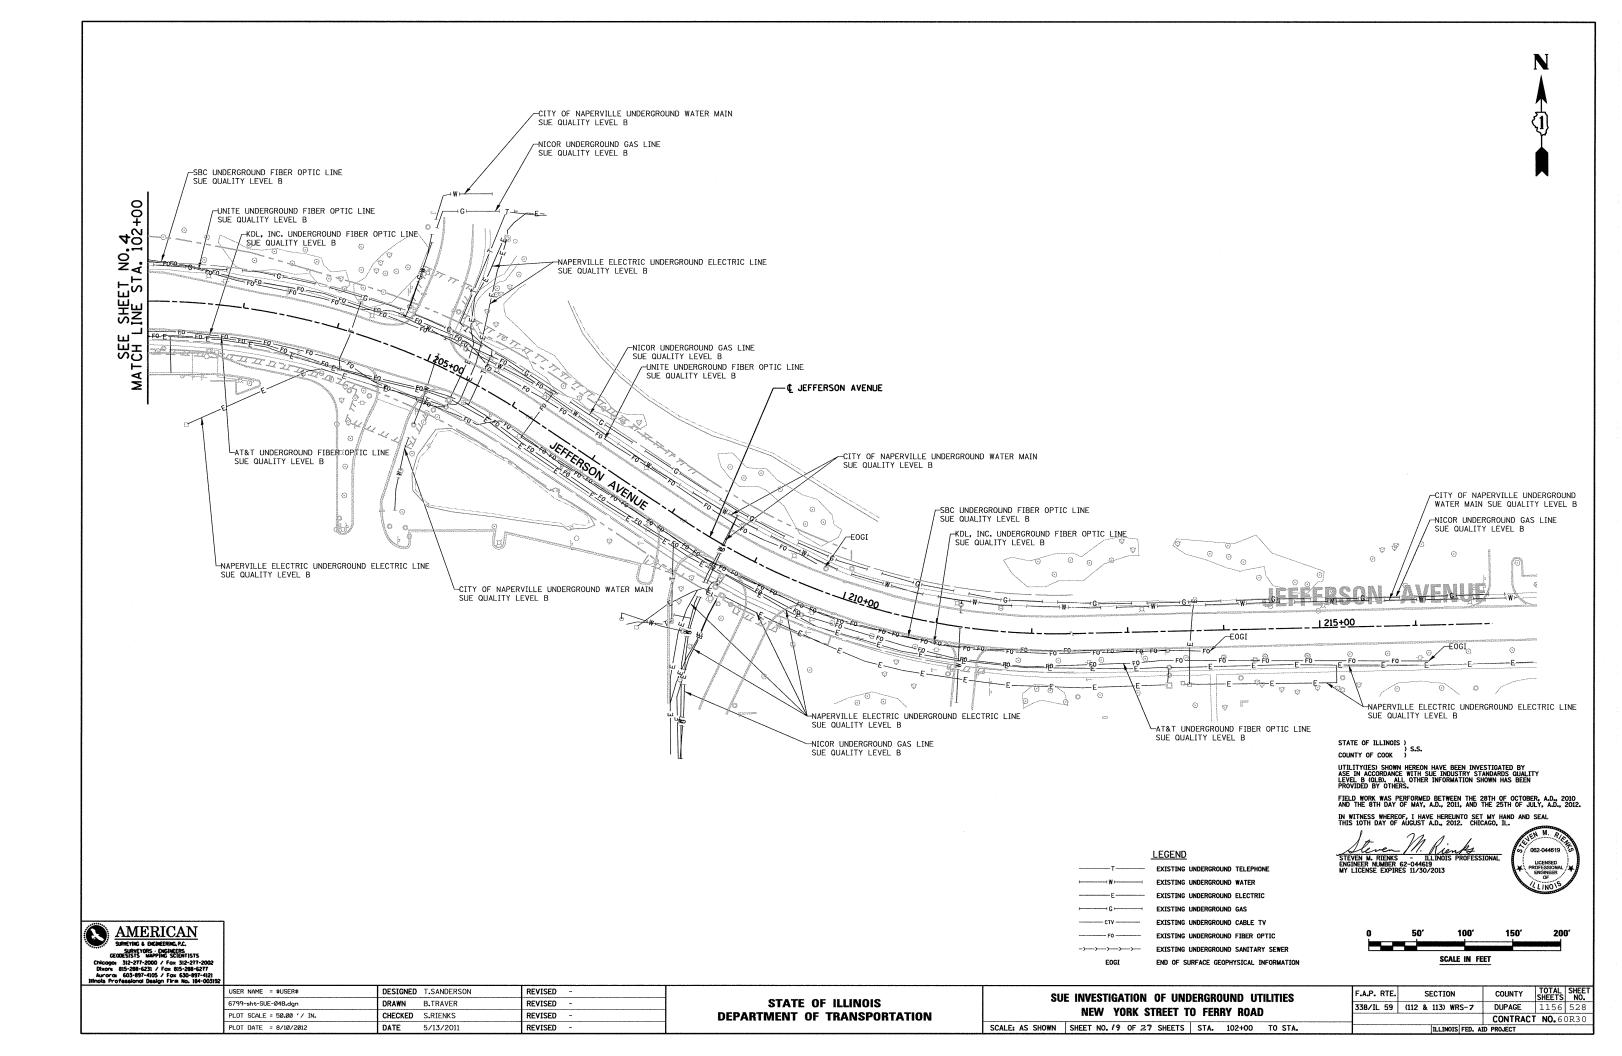

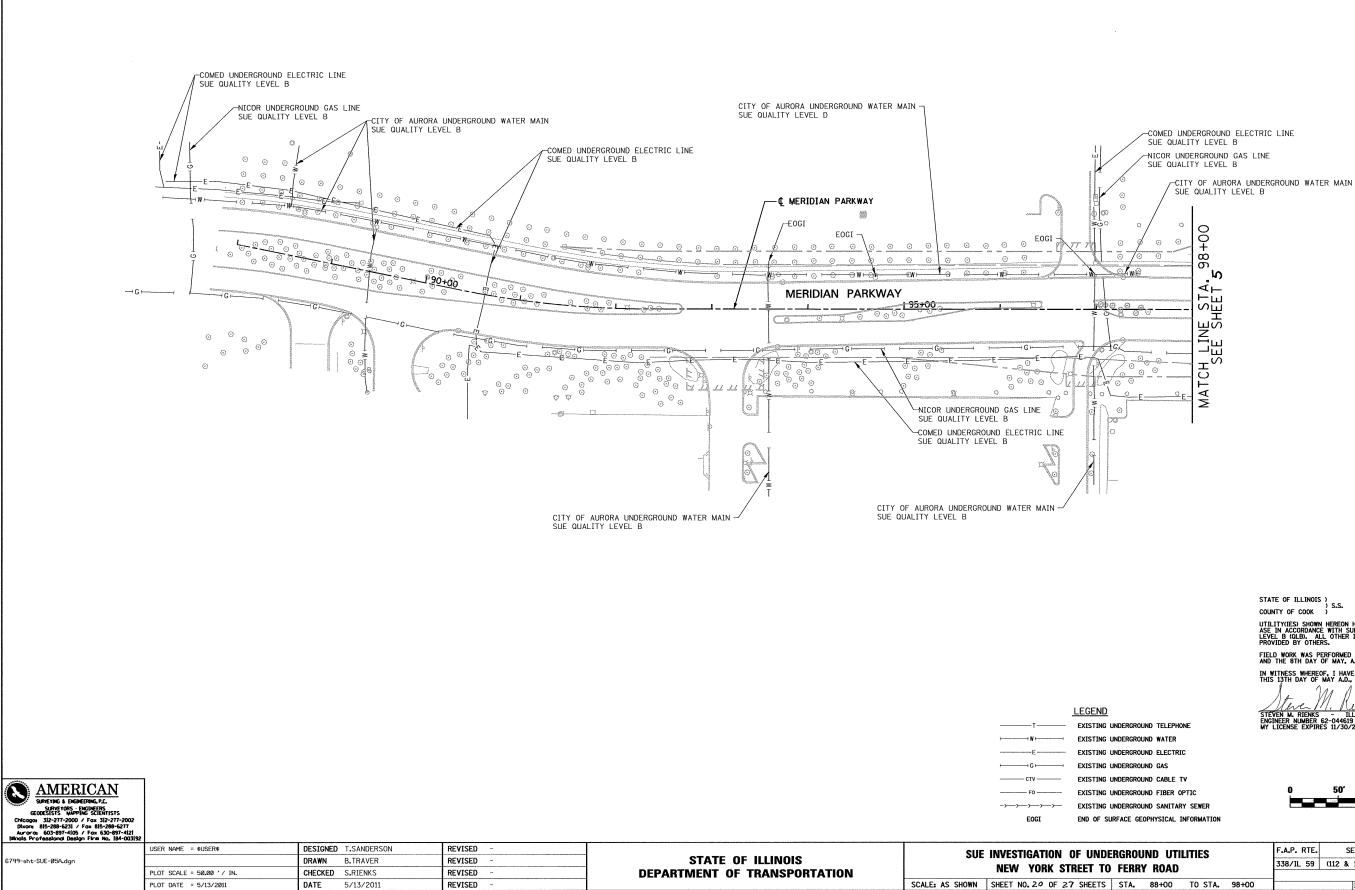

Ν

UTILITY(IES) SHOWN HEREON HAVE BEEN INVESTIGATED BY ASE IN ACCORDANCE WITH SUE INDUSTRY STANDARDS QUALITY LEVEL B (ULB), ALL OTHER INFORMATION SHOWN HAS BEEN PROVIDED BY OTHERS.


FIELD WORK WAS PERFORMED BETWEEN THE 28TH OF OCTOBER, A.D., 2010 AND THE 8TH DAY OF MAY, A.D., 2011.

IN WITNESS WHEREOF, I HAVE HEREUNTO SET MY HAND AND SEAL THIS 13TH DAY OF MAY A.D., 2011. CHICAGO, IL.

STEVEN M. RIENKS - ILLINO ENGINEER NUMBER 62-044619 MY LICENSE EXPIRES 11/30/2011 ILLINOIS PROFESSIONAL

Q	50'	100'	150'	200'
	2 			
	·	SCALE IN FEE	ŗ	

ERGROUND UTILITIES			F.A.P. RTE.	F.A.P. RTE. SECTION		TOTAL SHEETS	SHEET NO.			
		' ROAD			338/IL 59	(112 & 113) WRS-7	DUPAGE	1156	529	
,	FLANT	NUAU					CONTRACT	NO.60	)R30	
	STA.	88+00	TO STA.	98+00	ILLINOIS FED. AID PROJECT					

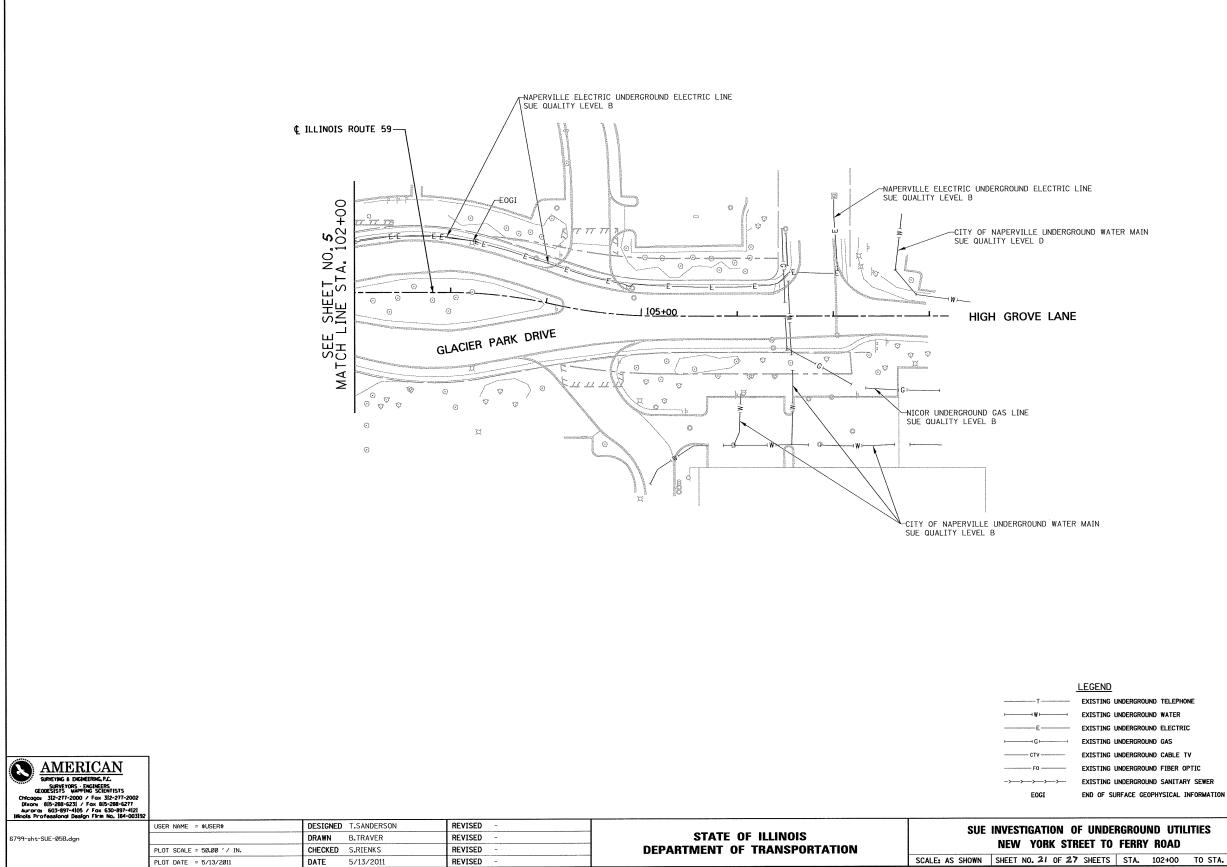

TOTAL SHEET SHEETS NO. F.A.P. RTE. SECTION COUNTY 338/IL 59 (112 & 113) WRS-7 DUPAGE 1156 530 CONTRACT NO.60R30 ILLINOIS FED. AID PROJECT

UNDERGROUND W	ATER
UNDERGROUND E	LECTRIC
UNDERGROUND G	SAS
UNDERGROUND C	ABLE TV
UNDERGROUND F	IBER OPTIC
UNDERGROUND S	SANITARY SEWER
URFACE GEOPHYS	SICAL INFORMATION

Q	50'	100′	150'	200'
		SCALE IN FEET		

-01	400/	450	2007


Stever M. Rienks	215
STEVEN M. RIENKS - ILLINOIS PROFESSIONAL ENCINEER NUMBER 62-044619 MY LICENSE EXPIRES 11/30/2011	×

UTILITY(IES) SHOWN HEREON HAVE BEEN INVESTIGATED BY ASE IN ACCORDANCE WITH SUE INDUSTRY STANDARDS QUALITY LEVEL B (QLB), ALL OTHER INFORMATION SHOWN HAS BEEN PROVIDED BY OTHERS.


FIELD WORK WAS PERFORMED BETWEEN THE 28TH OF OCTOBER, A.D., 2010 AND THE 8TH DAY OF MAY, A.D., 2011.




STATE OF ILLINOIS ) COUNTY OF COOK )

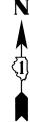



CITY OF NAPERVILLE UNDERGROUND WATER MAIN	CITY OF NAPERVILLE UNDERGROUND WATER MAIN
SUE QUALITY LEVEL D COMCAST UNDERGROUND CABLE LINE SUE QUALITY LEVEL B COMED UNDERGROUND ELECTRIC LINE SUE QUALITY LEVEL B COMED UNDERGROUND ELECTRIC LINE SUE QUALITY LEVEL B CITY OF NAPERVILLE UNDERGROUND WATER MAIN SUE QUALITY LEVEL D CITY OF NAPERVILLE UNDERGROUND TELEPHONE L SUE QUALITY LEVEL D CITY OF NAPERVILLE UNDERGROUND TELEPHONE L CITY OF NAPERVILLE UNDERGROUND TELEPHONE L SUE QUALITY LEVEL D CITY OF NAPERVILLE UNDERGROUND TELEPHONE L SUE QUALITY LEVEL D CITY OF NAPERVILLE UNDERGROUND TELEPHONE L CITY OF NAPERVILLE UNDERGROUND TELEPHONE L CITY OF NAPERVILLE D CITY OF NAPERVILLE UNDERGROUND TELEPHONE L CITY OF NAPERVILLE UNDERGROUND TELEPHONE L CIT	SUE QUALITY LEVEL B
EXAMPLE 2 AVEC AND A STATUS AND	$\frac{\text{LEGEND}}{\text{T}} = \frac{\text{Existing underground releptione}}{Existing underground date for the existing un$
6799-sht-SUE-07A.dgn     DRAWN     B.TRAVER     REVISED     -       PLOT SCALE = 50.00 '/ IN.     CHECKED     S.RIENKS     REVISED     -       PLOT DATE     = 8/10/2012     DATE     5/13/2011     REVISED     -	SUE         INVESTIGATION OF UNDERGROUND UTILITIES NEW YORK STREET TO FERRY ROAD         F.A.P. RTE.         SECTION         COUNTY         TOTAL SHEETS         Image: Non- State           SCALE: AS SHOWN         SHEET NO. 22 OF 27 SHEETS         STA.         84+00         TO STA.         98+00         ILLINOIS/FED. AID PROJECT         CONTRACT NO. 6 0 R30

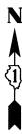


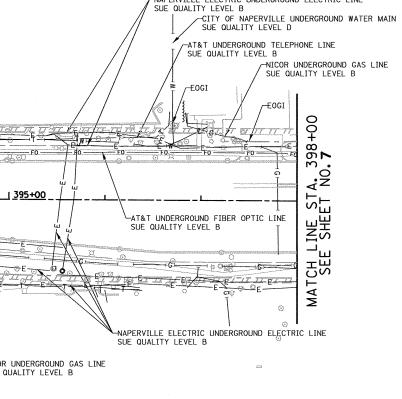


Q	50'	100'	150'	200'				
SCALE IN FEFT								

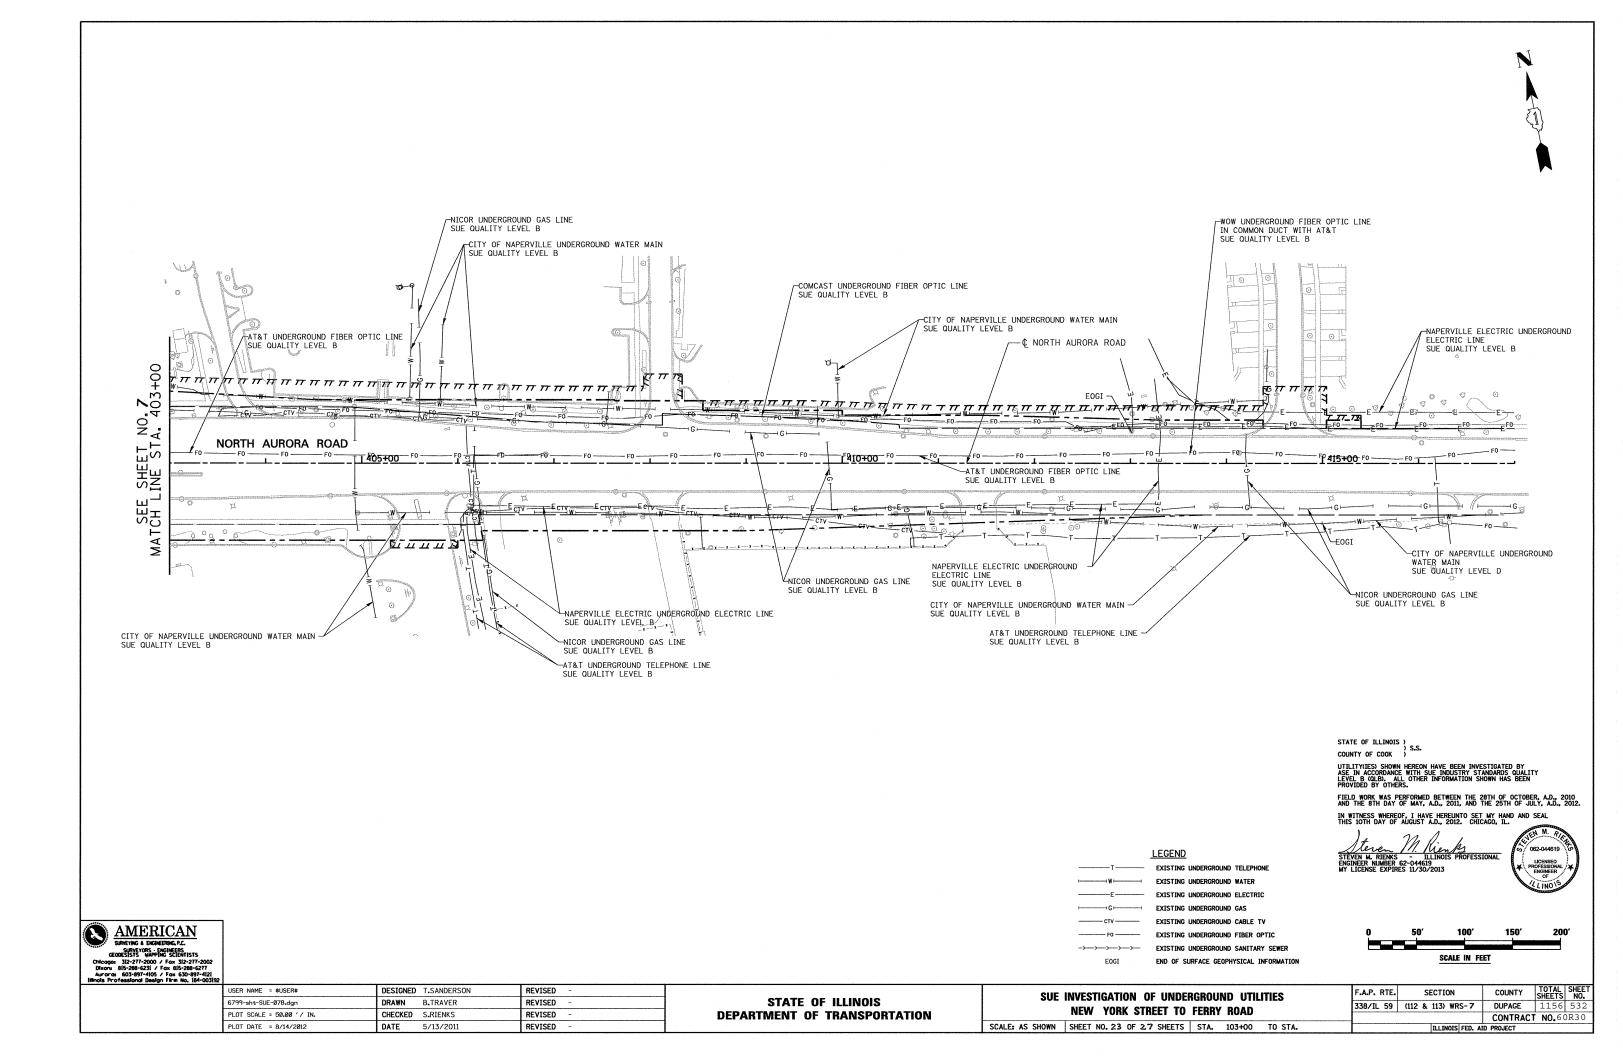


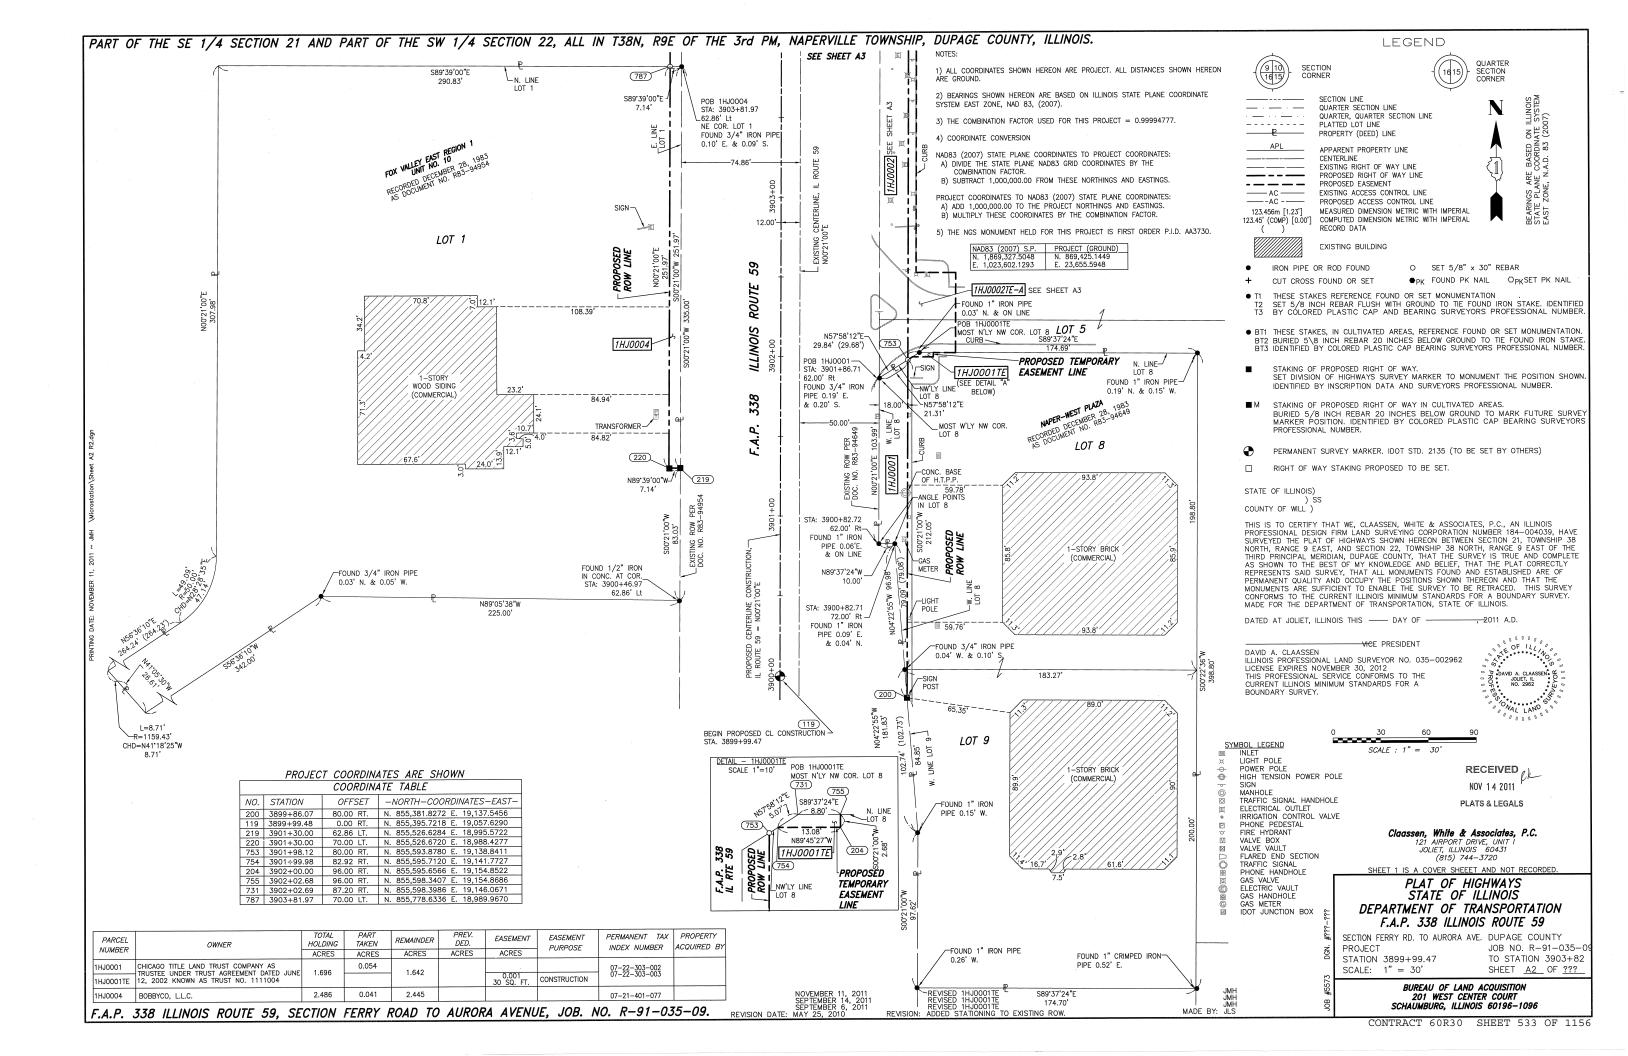


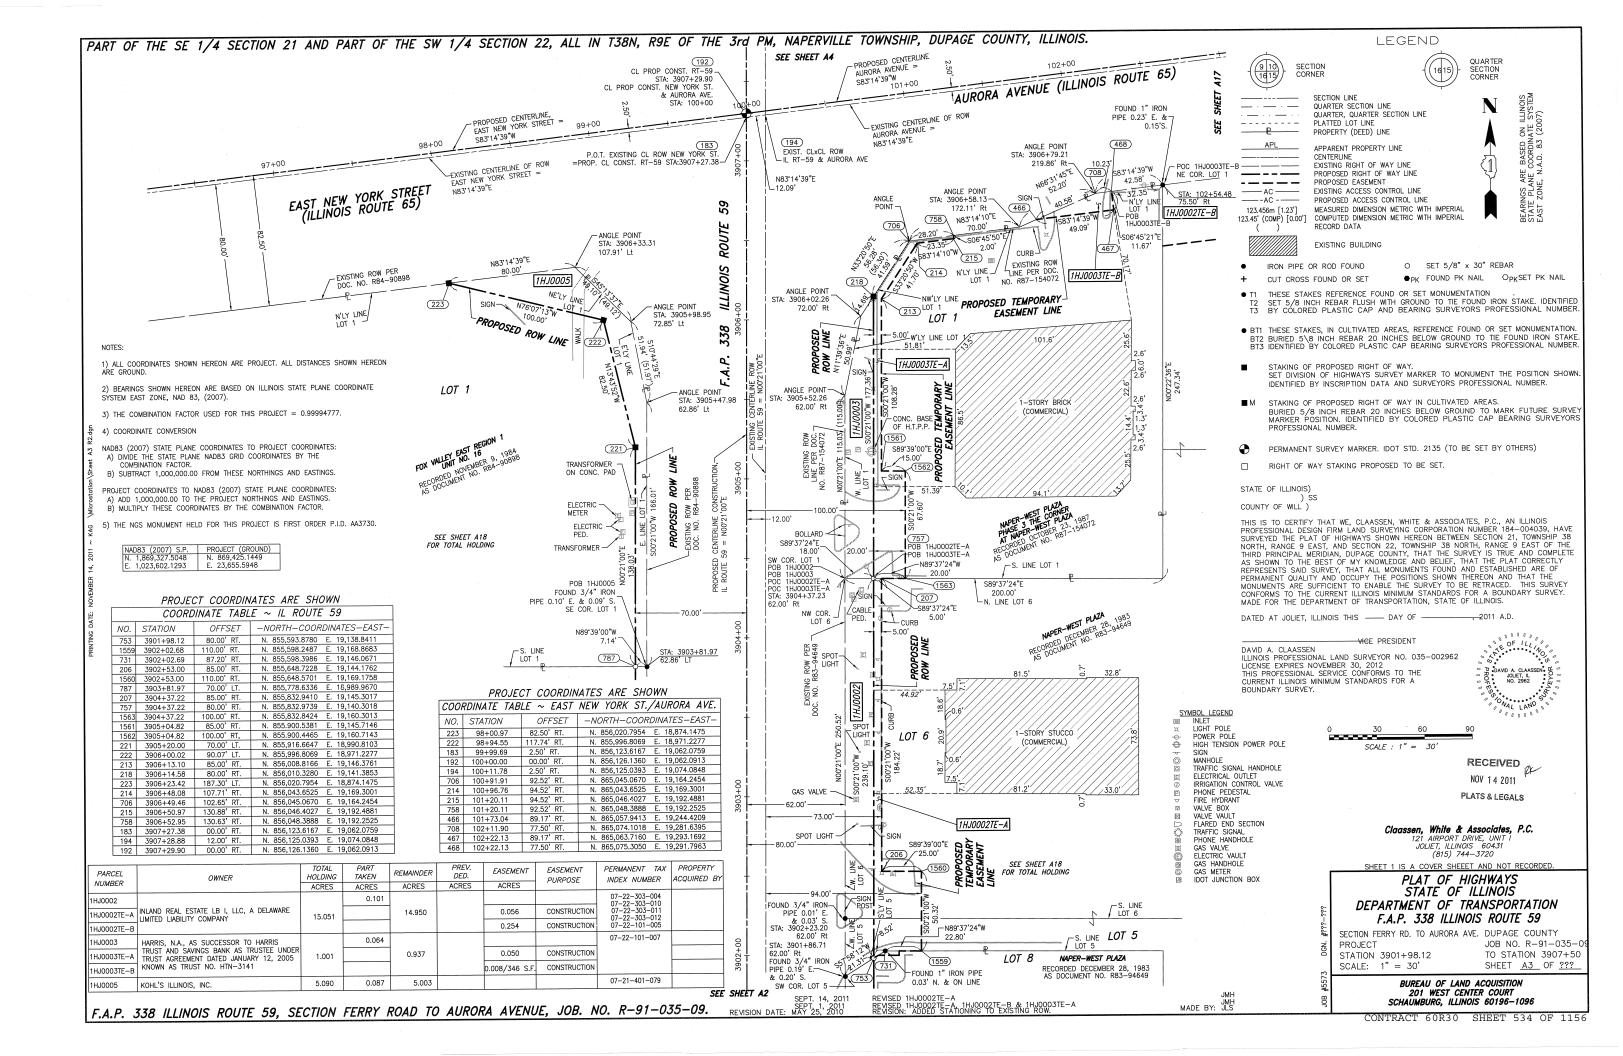

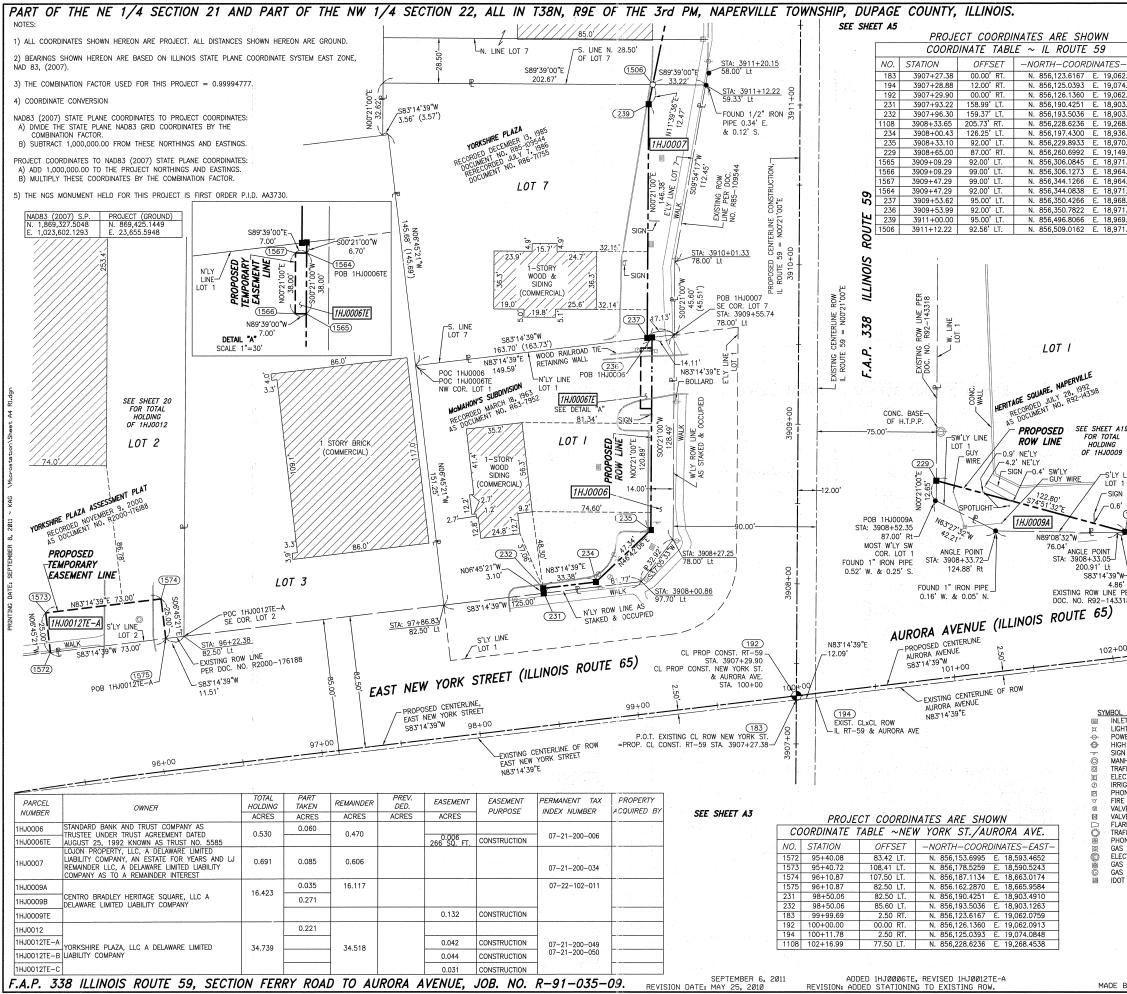


	Legend							
FACT	9		TION NER		-(16 15)-	QUARTER SECTION CORNER		
5-EAST- 62.0759 74.0848 62.0913 03.4910 03.1263		P	SECTION LINE QUARTER SECTIO QUARTER, QUART PLATTED LOT LI PROPERTY (DEED	ER SECTION LI	NE	N	BASED ON ILLINOIS COORDINATE SYSTEM .A.D. 83 (2007)	
68.4538           36.2723           70.7234           49.9150           71.1889           64.1890           64.4212           71.4210           68.4597	, , ,	APL AC	APPARENT PROP CENTERLINE EXISTING RIGHT PROPOSED RIGHT PROPOSED EASEI EXISTING ACCESS PROPOSED ACCE: MEASURED DIMEN COMPUTED DIMEN RECORD DATA	OF WAY LINE OF WAY LINE MENT CONTROL LINE SS CONTROL LI ISION METRIC W	NE ITH IMPERIAL		BEARINGS ARE BASED STATE PLANE COORDIN EAST ZONE, N.A.D. 83	
71.4620 69.3540 71.8736			EXISTING BUILD	ING				
	• + • TI T2 T3	CUT CROSS THESE STAR SET 5/8 IN	R ROD FOUND FOUND OR SET ES REFERENCE CH REBAR FLUS D PLASTIC CAN	FOUND OR SE	FOUND PK T MONUMENT ND TO TIE F	TATION . OUND IRON S	K SET PK NAIL TAKE. IDENTIFIED SIONAL NUMBER.	
	BTI     BT2     BT3	BURIED 5\8	INCH REBAR 2	O INCHES BEL	OW GROUND	TO TIE FOU	MONUMENTATION. ND IRON STAKE. SSIONAL NUMBER.	
	■ STAKING OF PROPOSED RIGHT OF WAY. SET DIVISION OF HIGHWAYS SURVEY MARKER TO MONUMENT THE POSITION SHOWN. IDENTIFIED BY INSCRIPTION DATA AND SURVEYORS PROFESSIONAL NUMBER.							
	M	BURIED 5/8	SITION. IDENTIF	O INCHES BE	LOW GROUNE	D TO MARK I	FUTURE SURVEY ING SURVEYORS	
119	<ul> <li>PERMANENT SURVEY MARKER. IDOT STD. 2135 (TO BE SET BY OTHERS)</li> <li>RIGHT OF WAY STAKING PROPOSED TO BE SET.</li> </ul>							
9 1 LINE 1	STATE OF ILLINOIS) SCOUNTY OF WILL )							
N S' <u>NE'LY</u> (1108) W W	THIS IS TO CERTIFY THAT WE, CLAASSEN, WHITE & ASSOCIATES, P.C., AN ILLINOIS PROFESSIONAL DESIGN FIRM LAND SURVEYING CORPORATION NUMBER 184-004039, HAVE SURVEYED THE PLAT OF HIGHWAYS SHOWN HEREON BETWEEN SECTION 21, TOWNSHIP 38 NORTH, RANCE 9 EAST, AND SECTION 22, TOWNSHIP 38 NORTH, RANCE 9 EAST OF THE THIRD PRINCIPAL MERDIAN, DUPAGE COUNTY, THAT THE SURVEY IS TRUE AND COMPLETE AS SHOWN TO THE BEST OF MY KNOWLEDGE AND BELIEF, THAT THE PLAT CORRECTLY REPRESENTS SAID SURVEY, THAT ALL MONUMENTS FOUND AND ESTABLISHED ARE OF PERMANENT OULAILTY AND OCCUPY THE POSITIONS SHOWN THEREON AND THAT THE MONUMENTS ARE SUFFICIENT TO ENABLE THE SURVEY TO BE RETRACED. THIS SURVEY CONFORMS TO THE CURRENT ILLINOIS MINIMUM STANDARDS FOR A BOUNDARY SURVEY. MADE FOR THE DEPARTMENT OF TRANSPORTATION, STATE OF ILLINOIS.							
PER_J <b>I JJHS</b>	DATED	AT JOLIET,	ILLINOIS THIS		NT	, 2011 A		
2EE 20								
L <u>LEGEND</u> LET				30 6		0	÷	
GHT POLE OWER POLE GH TENSION GN	POWER F	POLE	50	XALE : 1" =	30'		EIVED A/ 1 3 2011	
NHOLE AFFIC SIGNAL ECTRICAL OU RIGATION COM IONE PEDEST RE HYDRANT	ITLET NTROL VA					PLATS	& LEGALS	
LVE BOX LVE VAULT ARED END S AFFIC SIGNAL IONE HANDHO	_ ^		SH	121	AIRPORT DRI LIET, ILLINOI: (815) 744-1	S 60431 3720		
IS VALVE ECTRIC VAUL IS HANDHOLE				PLA	T OF HI	GHWAYS		
IS METER OT JUNCTION	DN BOX STATE OF ILLINOIS DEPARTMENT OF TRANSPORTATION F.A.P. 338 ILLINOIS ROUTE 59 SECTION FERRY RD. TO AURORA AVE. DUPAGE COUNTY							
			STATION	3907+00	AURORA AV	JOB NO. TO STA	R-91-035-09 TION 3911+50	
JMH			SCALE:	201	WEST CEN	ACQUISITION		
BY: JLS		NICCION CONTRACTOR CONTRA		ONTRACT			35 OF 1156	

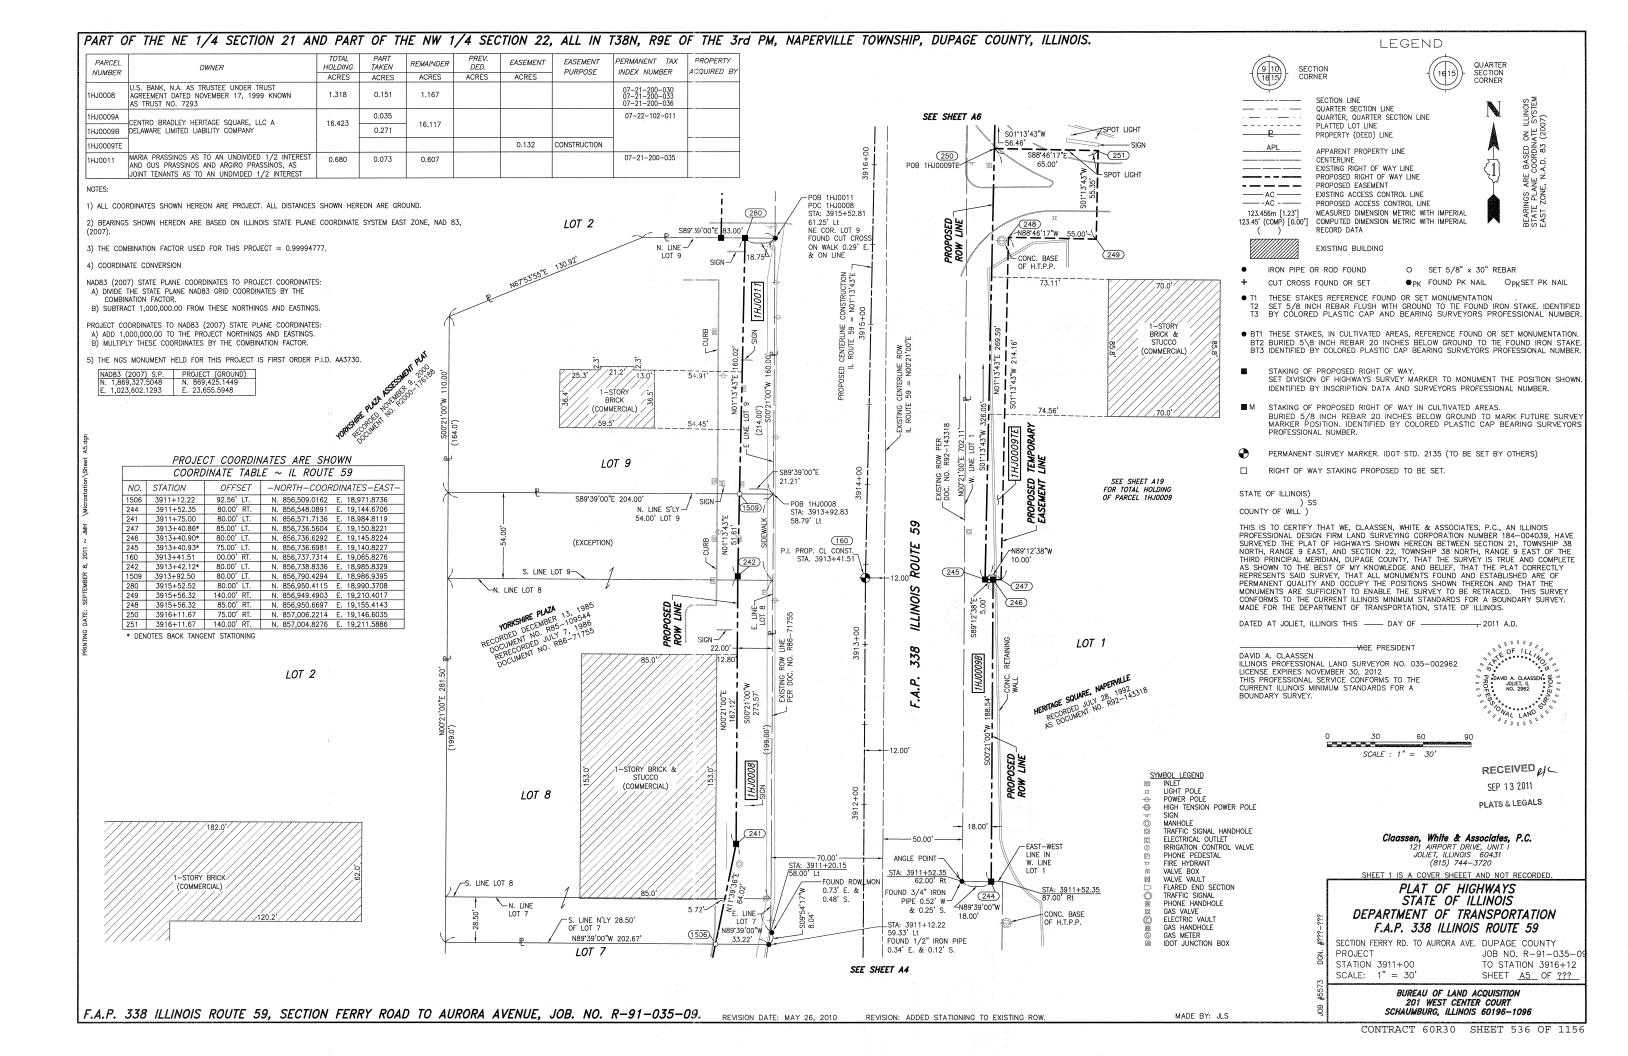


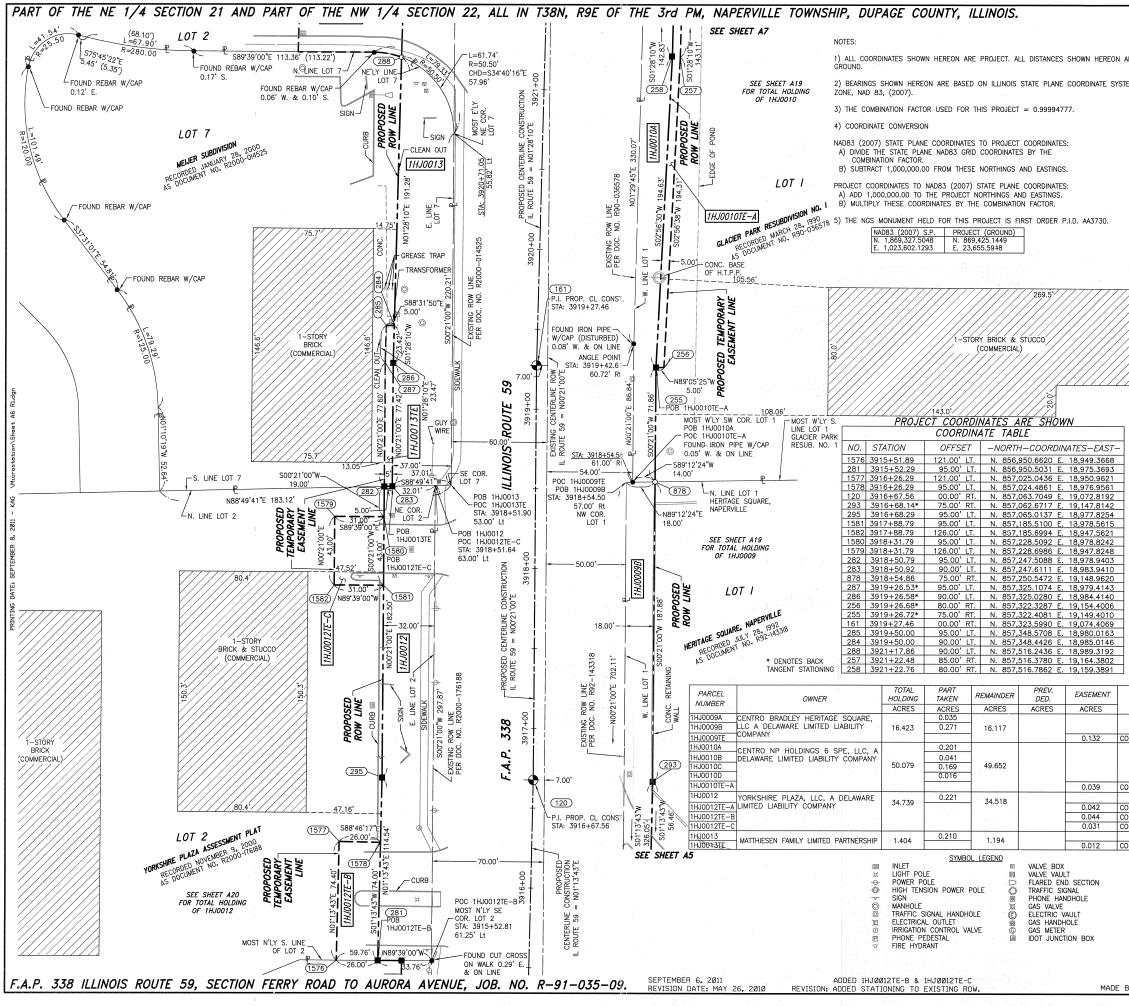


				LEGEND		
	(	9 10) SECTIO	N	G	QUARTER	
ARE	-	IG IS CORNEL	3	- (16	15)- SECTION CORNER	
TEM EAST		QL	CTION LINE JARTER SECTION JARTER, QUARTEI ATTED LOT LINE COPERTY (DEED)	R SECTION LINE	N	BASED ON ILLINOIS COORDINATE SYSTEM .A.D. 83 (2007)
	123.	CE CE CE CE CE CE CE CE CE CE		WAY LINE DF WAY LINE NT CONTROL LINE		BEARNGS ARE BASED 1 STATE PLANE COORDIN EAST ZONE, N.A.D. 83 EAST ZONE, N.A.D. 83
		( ) RE	CORD DATA			шол
		IRON PIPE OR I	KISTING BUILDIN		∕8" × 30" REBAR	
	+	CUT CROSS FO		€PK FOUND		SET PK NAIL
7777	• TI T2 T3			OUND OR SET MONU WITH GROUND TO T AND BEARING SUR		TAKE. IDENTIFIED IONAL NUMBER.
	• BT BT BT	2 BURIED 5\8 IN	CH REBAR 20	D AREAS, REFERENC INCHES BELOW GRO TIC CAP BEARING SI	OUND TO THE FOUL	ND IRON STAKE.
			OF HIGHWAYS S	OF WAY. URVEY MARKER TO TA AND SURVEYORS		
//126	■ M	BURIED 5/8 IN	ICH REBAR 20 ION. IDENTIFIE	OF WAY IN CULTIV INCHES BELOW GR D BY COLORED PL	OUND TO MARK F	UTURE SURVEY NG SURVEYORS
]	•			IDOT STD. 2135 (T)	D BE SET BY OTH	ERS)
		E OF ILLINOIS)	STAKING PRUP	OSED TO BE SET.		
		TY OF WILL )				
	THIS IS TO CERTIFY THAT WE, CLAASSEN, WHITE & ASSOCIATES, P.C., AN ILLINOIS PROFESSIONAL DESIGN FIRM LAND SURVEYING CORPORATION NUMBER 184-004039, HAVE SURVEYED THE PLAT OF HIGHWAYS SHOWN HEREON BETWEEN SECTION 21, TOWNSHIP 38 NORTH, RANGE 9 EAST, AND SECTION 22, TOWNSHIP 38 NORTH, RANGE 9 EAST OF THE THIRD PRINCIPAL MERIDIAN, DUPAGE COUNTY, THAT THE SURVEY IS TRUE AND COMPLETE AS SHOWN TO THE BEST OF MY KNOWLEDGE AND BELIEF, THAT THE PLAT CORRECTLY REPRESENTS SAID SURVEY, THAT ALL MONUMENTS FOUND AND ESTABLISHED ARE OF PERMANENT QUALITY AND OCCUPY THE POSITIONS SHOWN THEREON AND THAT THE MONUMENTS ARE SUFFICIENT TO ENABLE THE SURVEY TO BE RETRACED. THIS SURVEY CONFORMS TO THE CURRENT ILLINOIS MINIMUM STANDARDS FOR A BOUNDARY SURVEY. MADE FOR THE DEPARTMENT OF TRANSPORTATION, STATE OF ILLINOIS.					
	DATE	D AT JOLIET, ILLI		DAY OF	, 2011 A.D	
	ILLINC LICEN THIS CURRI	A. CLAASSEN DIS PROFESSIONAL SE EXPIRES NOVE PROFESSIONAL SE ENT ILLINOIS MININ DARY SURVEY.	LAND SURVEY MBER 30, 2012 RVICE CONFORM	IS TO THE		
EASEMEN PURPOSE		ERMANENT TAX NDEX NUMBER	PROPERTY ACQUIRED BY	0	30	
ONCTRUCTO	NI.	07-22-102-011			SCALE : 1"	60 90 = 30'
ONSTRUCTIO	an l				RECEIV	EDAC
		07-22-102-009 07-22-102-010			SEP 132 PLATS & LE	
ONSTRUCTIO	N	07-21-200-049 07-21-200-050		Claassen, White	& Associates, I	
ONSTRUCTIO	N	07-21-200-044		JOLIET, ILL	DRIVE, UNIT I LINOIS 60431 744-3720	
ONSTRUCTIO	N				HIGHWAYS	NOT RECORDED.
		222-222#			F ILLINOIS TRANSPOR	
		DGN	PROJECT STATION 3	RRY RD. TO AUROR/ 3915+50 " = 30'	JOB NO. TO STAT	COUNTY R-9I-035-09 ION 392I+22.76 A6 OF _???_
JMH BY: JLS		JOB #5573		BUREAU OF L	AND ACQUISITION CENTER COURT	
			CON	ITRACT 60R30	) SHEET 5:	37 OF 1156

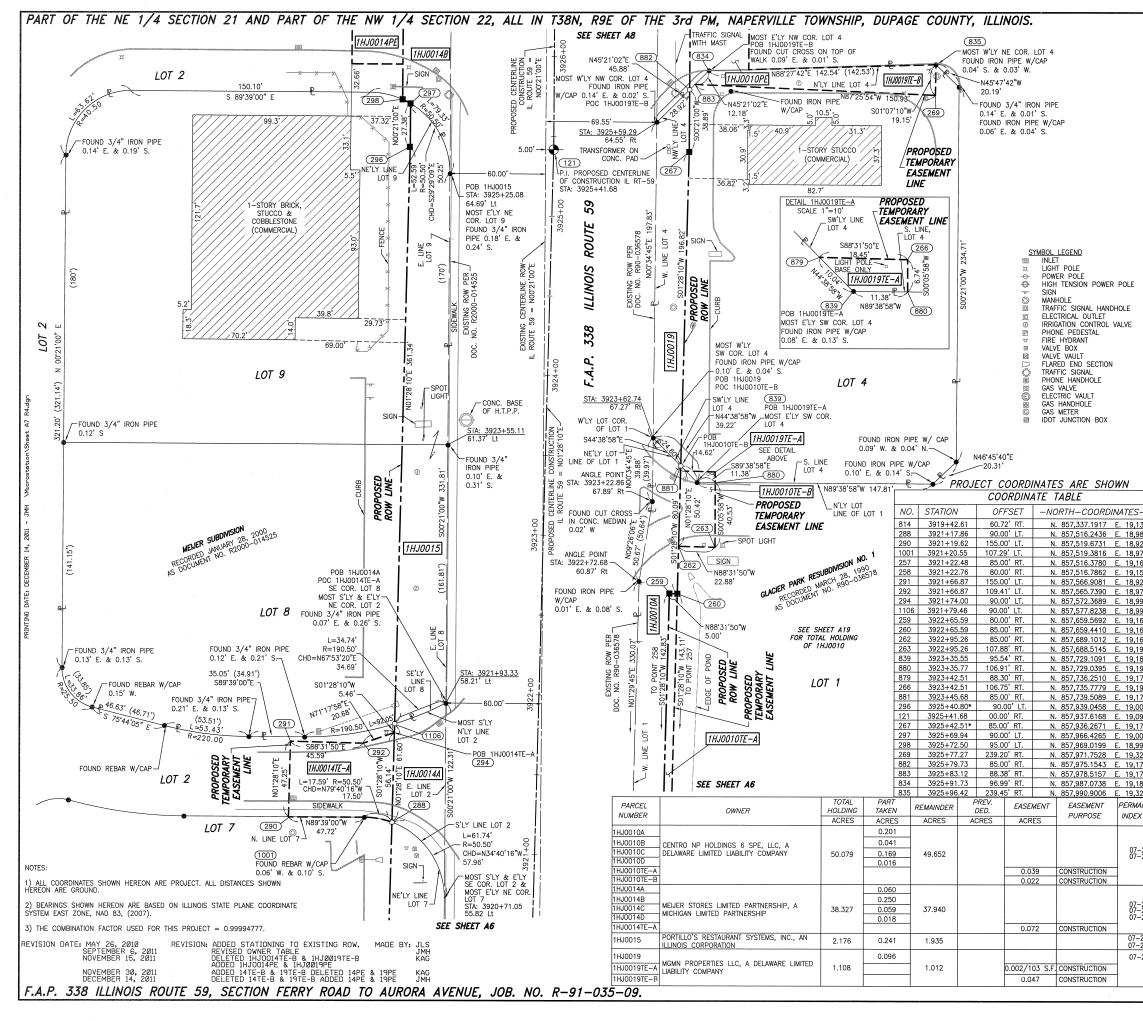


		_			gend 		
	-(		ECTION ORNER		16 15	QUARTER SECTION CORNER	
			QUA QUA PLA	TION LINE RTER SECTION LINE RTER, QUARTER SEC TTED LOT LINE PERTY (DEED) LINE	TION LINE		BASED ON ILLINOIS COORDINATE SYSTEM .A.D. 83 (2007)
	123	APL AC AC AC AC AC AC () () () () () ()	CEN EXIS PRO PRO EXIS PRO MEA ] COM	ARENT PROPERTY LII ITERLINE STING RIGHT OF WAY POSED RIGHT OF WAY POSED EASEMENT STING ACCESS CONTR POSED ACCESS CONT SURED DIMENSION ME IPUTED DIMENSION ME ORD DATA	LINE Y LINE OL LINE TROL LINE TRIC WITH IMPERIA		BEARNGS ARE BASED STATE PLANE COORDIN EAST ZONE, N.A.D. 83 EAST ZONE, N.A.D. 83
				STING BUILDING			
	•			OD FOUND		" × 30" REBAR	
	+ • T T	THESE S	TAKES I	ND OR SET REFERENCE FOUND REBAR FLUSH WITH LASTIC CAP AND	GROUND TO TIE	NTATION FOUND IRON	
	В	T2 BURIED 5	N8 INC	IN CULTIVATED ARE H REBAR 20 INCHE OLORED PLASTIC C	ES BELOW GROUN	ND TO TIE FO	UND IRON STAKE.
		SET DIVIS	SION OF	POSED RIGHT OF N HIGHWAYS SURVE ISCRIPTION DATA A	Y MARKER TO M		
	■ M STAKING OF PROPOSED RIGHT OF WAY IN CULTIVATED AREAS. BURIED 5/8 INCH REBAR 20 INCHES BELOW GROUND TO MARK FUTURE SURVE MARKER POSITION, IDENTIFIED BY COLORED PLASTIC CAP BEARING SURVEYOR PROFESSIONAL NUMBER.						
	•			VEY MARKER. IDOT		BE SET BY OT	HERS)
	STA	RIGHT OF		STAKING PROPOSED	IU BE SET.		
		NTY OF WILL	) SS				
- <i>EAST</i>	THIS IS TO CERTIFY THAT WE, CLAASSEN, WHITE & ASSOCIATES, P.C., AN ILLINOIS PROFESSIONAL DESIGN FIRM LAND SURVEYING CORPORATION NUMBER 184-004039, HAVE SURVEYED THE PLAT OF HIGHWAYS SHOWN HEREON BETWEEN SECTION 21, TOWNSHIP 38 NORTH, RANGE 9 EAST, AND SECTION 22, TOWNSHIP 38 NORTH, RANGE 9 EAST OF THE THIRD PRINCIPAL MERIDIAN, DUPAGE COUNTY, THAT THE SURVEY IS TRUE AND COMPLETE AS SHOWN TO THE BEST OF MY KNOWLEDGE AND BELIEF, THAT THE PLAT CORRECTLY REPRESENTS SAID SURVEY, THAT ALL MONUMENTS FOUND AND ESTABLISHED ARE OF PERMANENT QUALITY AND OCCUPY THE POSITIONS SHOWN THEREON AND THAT THE MONUMENTS ARE SUFFICIENT TO ENABLE THE SURVEY TO BE RETRACED. THIS SURVEY. CONFORMS TO THE CURRENT ILLINOIS MINIMUM STANDARDS FOR A BOUNDARY SURVEY. MADE FOR THE DEPARTMENT OF TRANSPORTATION, STATE OF ILLINOIS.						
00.8989           03.0519           03.0502           03.8111           01.6836           00.3775           01.7539           01.7539           01.7656           01.7656           01.7657           01.7657	DATED AT JOLIET, ILLINOIS THIS DAY OF, 2011 A.D.						0
00.1653 00.1583 75.1516					0	30	60 90
00.3326 95.3484		ENOTES STATIO M BACK TANGE		DECEN	<b>-</b>	SCALE : 1'	' = 30'
29.5670 75.3892 78.7921				DEC 14 2			
78.7921 37.4555 29.9412				PLATS & LEO			
NENT TA NUMBER		PROPERTY ACQUIRED BY		Clac	<b>issen, White &amp;</b> 121 AIRPORT D	Associates,	P.C.
22-102-00 22-102-01	9			SHEET ! !!	JOLIET, ILLIN (815) 744 S A COVER SHEE	0IS 60431 1-3720	RECORDED
			22		PLAT OF H STATE OF MENT OF 1	HIGHWAYS ILLINOIS	5
21-200-04 21-200-05 21-200-05			DGN. #???-???		P. 338 ILLIN	IOIS ROUT	E 59
21-200-042 21-200-043 22-102-00	3			PROJECT STATION 3920 SCALE: I" =	+50	JOB NO TO STA	TION 3926+00
			JOB #5573		BUREAU OF LAN 201 WEST CE IAUMBURG, ILLIN	ID ACQUISITIO NTER COURT	w
				CONTR	ACT 60R30	SHEET	538 OF 1156

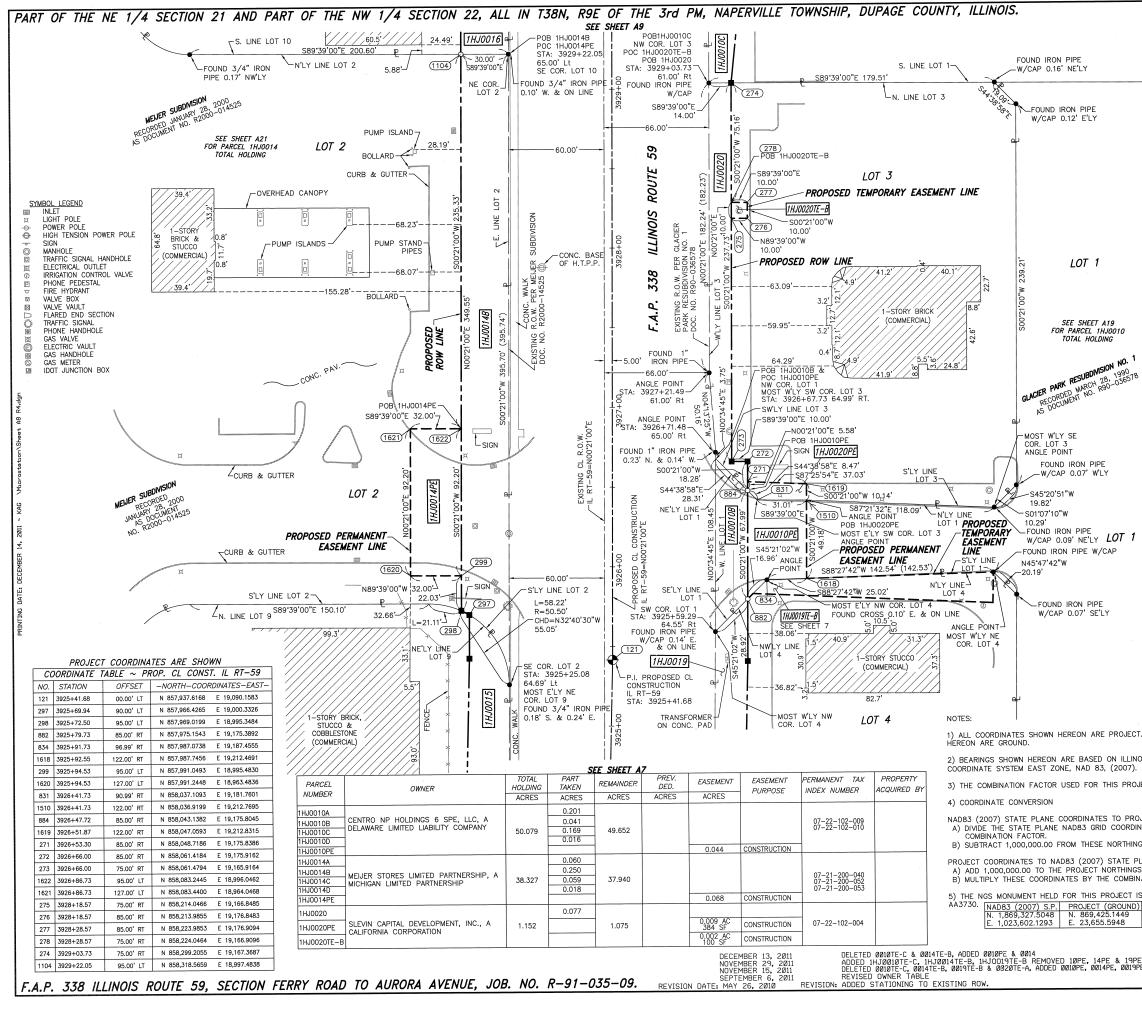


,								
				LEQ	Bend	±		
	9		SECTION			(16 15)	QUARTER SECTION CORNER	
			QUAR QUAR PLAT	ON LINE TER SECTION LINE TER, QUARTER SEC <sup>T</sup> TED LOT LINE ERTY (DEED) LINE	TION LINE	I	N	BASED ON ILLINDIS COORDINATE SYSTEM .A.D. 83 (2007)
	A(	C n [l.23']	- CENTE - EXIST - PROPO - PROPO - EXIST - PROPO MEASI ('] COMP	RENT PROPERTY LIN FRLINE ING RIGHT OF WAY DSED RIGHT OF WAY DSED ACKESS CONTR OSED ACCESS CONTR URED DIMENSION ME UTED DIMENSION ME RD DATA	LINE Y LINE OL LINE ROL LINE TRIC WITH			BEARINGS ARE BASED STATE PLANE COORDI EAST ZONE, N.A.D. 83 EAST ZONE, N.A.D. 83
			EXIST	TING BUILDING				
			E OR ROU	D FOUND D OR SET		SET 5/8" FOUND PK	× 30" REBA NAIL O	R PFK SET PK NAIL
	T2 9	SET 5/8	NCH RE	EFERENCE FOUND BAR FLUSH WITH ASTIC CAP AND	GROUND	TO TIE F	OUND IRON	STAKE. IDENTIFIED SSIONAL NUMBER.
	BT2	BURIED	5\8 INCH	REBAR 20 INCH	ES BELO	W GROUND	TO TIE FO	T MONUMENTATION. DUND IRON STAKE. ESSIONAL NUMBER.
1		SET DIV	ISION OF	POSED RIGHT OF HIGHWAYS SURVE SCRIPTION DATA 4	Y MARKE	R TO MON EYORS PR	NUMENT THE ROFESSIONAL	POSITION SHOWN. NUMBER.
578		BURIED MARKER	578 INCH	N. IDENTIFIED BY	IES BELO	W GROUN	D TO MARK	FUTURE SURVEY ARING SURVEYORS
		PERMAN	ENT SURV	YEY MARKER. IDOT	STD. 21	35 (TO BE	E SET BY O	THERS)
		RIGHT O	F WAY S	TAKING PROPOSED	TO BE	SET.		
	STATE (		) SS					
1	THIS IS TO CERTIFY THAT WE, CLAASSEN, WHITE & ASSOCIATES, P.C., AN ILLINOIS PROFESSIONAL DESIGN FIRM LAND SURVEYING CORPORATION NUMBER 184-004039, HAVE SURVEYED THE PLAT OF HIGHWAYS SHOWN HEREON BETWEEN SECTION 21, TOWNSHIP 38 NORTH, RANGE 9 EAST, AND SECTION 22, TOWNSHIP 38 NORTH, RANGE 9 EAST OF THE THRD PRINCIPAL MERIDIAN, DUPAGE COUNTY, THAT THE SURVEY IS TRUE AND COMPLETE AS SHOWN TO THE BEST OF MY KNOWLEDGE AND BELIEF, THAT THE PLAT CORRECTLY REPRESENTS SAID SURVEY, THAT ALL MONUMENTS FOUND AND ESTABLISHED ARE OF PERMANENT QUALITY AND OCCUPY THE POSITIONS SHOWN THEREON AND THAT THE MONUMENTS ARE SUFFICIENT TO ENABLE THE SURVEY TO BE RETRACED. THIS SURVEY CONFORMS TO THE UERENT ILLINOIS MINIMUM STANDARDS FOR A BOUNDARY SURVEY. MADE FOR THE DEPARTMENT OF TRANSPORTATION, STATE OF ILLINOIS.							
	DATED	AT JOLI	ET, ILLING	DIS THIS [	DAY OF		, 2011	A.D.
	ILLINOIS LICENSE THIS PR CURREN	A. CLAAS PROFES EXPIRE ROFESSIO T ILLINO RY SURV	SSIONAL L S NOVEMI NAL SER' DIS MINIMU	VICE PI AND SURVEYOR N BER 30, 2012 VICE CONFORMS T IM STANDARDS FO	NO. 035-0 O THE	002962	AL.	A. CLAASSEN CO JOUET IL NO. 2962
							SION,	AL LAND
						0	30	60 90
						- <b>*</b> -*-*	SCALE :	1" = 30'
ECT. ALL [	DISTANCE	S SHOW	N	RECE	ived <sub>(c)</sub>	K		
LINOIS STA 7).	TE PLAN	E		DEC 14	2011			
ROJECT =	0.99994	777.		PLATS &	LEGALS			
ROJECT C		TES:			JOL	IET, ILLINO (815) 744		
HINGS AND			Inner	SHEET	PLA1	OF H	IIGHWA)	
NGS AND I	PLANE COORDINATES: IGS AND EASTINGS. INVITON FOR THE OF ILLINOIS DEPARTMENT OF TRANSPORTATION							
T IS FIRST	ORDER	P.I.D.	DGN. #777-277	F.A. SECTION FERRY PROJECT STATION 392	RD. TO		JOB I	
		JMH	. 2		30′		SHEE	T <u>A8</u> OF <u>???</u>
9PE 19PE & ØØ		JMH JMH KAG JMH BY: JLS	 0B #55	S	201	WEST CE	D ACQUISII NTER COUR IOIS 60196	?T
			and the second second	CONT		60020	CULEDO	F 539 OF 115

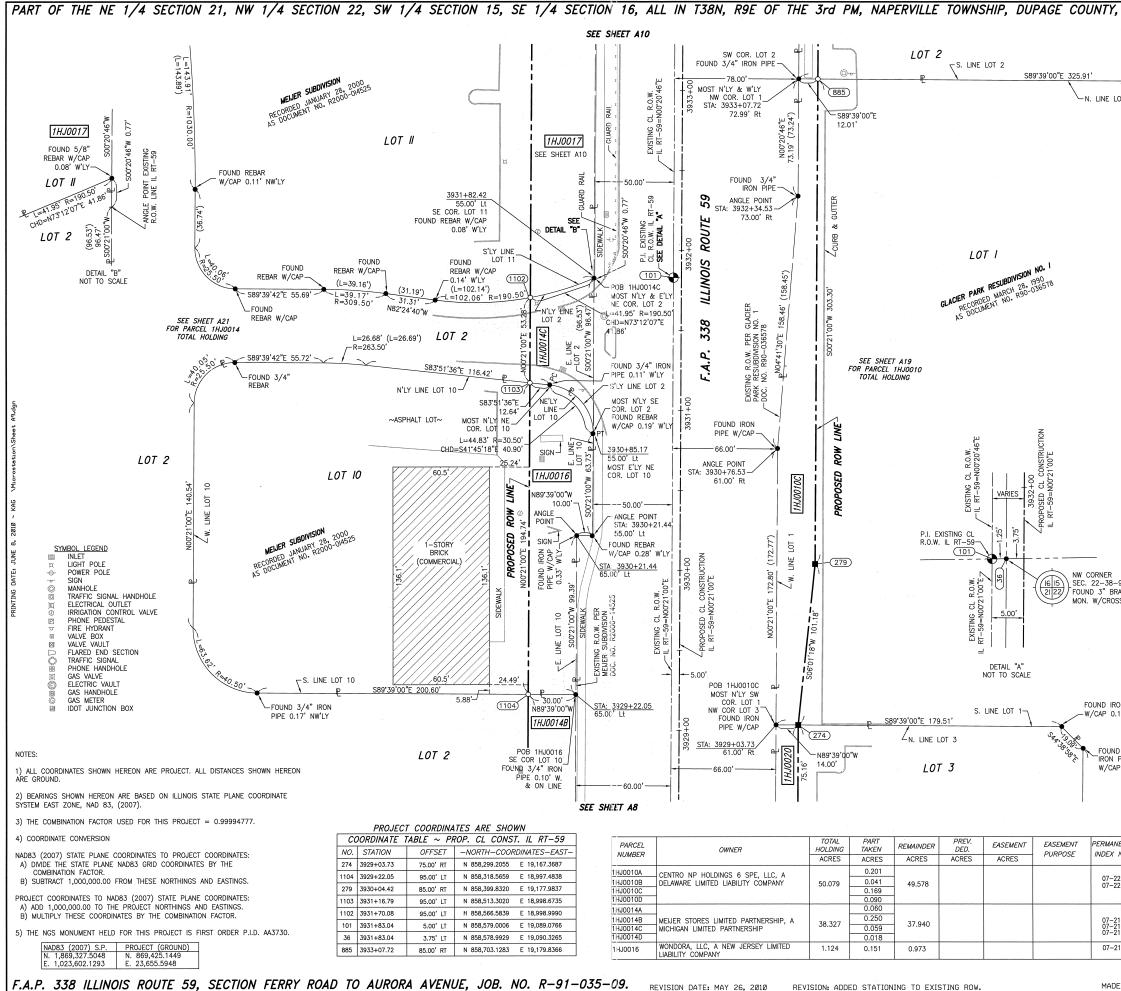


, ILLINO	VS.		L	egend			
	9			-(	(16 15) - SE	JARTER CTION DRNER	
		QU, QU, PL,	CTION LINE ARTER SECTION LIN ARTER, QUARTER S ATTED LOT LINE OPERTY (DEED) LINE	ECTION LINE			E BASED ON ILLINOIS COORDINATE SYSTEM A.A.D. 83 (2007)
	A(	CEN     EXI     EXI     PR     I	PARENT PROPERTY NTERLINE ISTING RIGHT OF WA OPOSED RIGHT OF N OPOSED EASEMENT STING ACCESS CON OPOSED ACCESS CON OPOSED ACCESS CO ASURED DIMENSION MPUTED DIMENSION	Y LINE VAY LINE TROL LINE NTROL LINE METRIC WITH I		Y	BEARINGS ARE BASED ( STATE PLANE COORDIN, EAST ZONE, N.A.D. 83
	123.45' (CO)	) RE(	CORD DATA	METRIC WITH I			Ξνü
	• 1	RON PIPE OR R		O SE	T 5/8" × 3	O" REBAR	
		UT CROSS FOU THESE STAKES	JND OR SET REFERENCE FOUN		UND PK NAI		SET PK NAIL
	T2 S	SET 5/8 INCH	REBAR FLUSH WIT PLASTIC CAP AN	H GROUND T	O TIE FOUN	D IRON STA	
	BT2 E	BURIED 5\8 INC	IN CULTIVATED A CH REBAR 20 INC COLORED PLASTIC	HES BELOW	GROUND TO	TIE FOUNI	D IRON STAKE.
	5	SET DIVISION O	OPOSED RIGHT OF F HIGHWAYS SURV NSCRIPTION DATA	EY MARKER			
	E	BURIED 5/8 IN	OPOSED RIGHT OF CH REBAR 20 IN ION. IDENTIFIED F NUMBER.	CHES BELOW	GROUND T	O MARK FL	JTURE SURVEY IG SURVEYORS
	Ð F	PERMANENT SUP	RVEY MARKER. ID	OT STD. 2135	6 (TO BE SE	T BY OTHE	RS)
	D F	RIGHT OF WAY	STAKING PROPOSE	ED TO BE SE	ET.		
		F ILLINOIS) ) SS OF WILL )					
	PROFESS SURVEYE TOWNSHIF COUNTY, KNOWLED ALL MON THE POS THE SUR MINIMUM	IONAL DESIGN I D THE PLAT O P 38 NORTH, R THAT THE SUI GE AND BELIEF UMENTS FOUNE ITIONS SHOWN VEY TO BE RE	IAT WE, CLAASSE FIRM LAND SURVE OF HIGHWAYS SHOU ANGE 9 EAST OF RVEY IS TRUE AN , THAT THE PLA D AND ESTABLISH THEREON AND TH THEREON AND TH TRACED. THIS S OR A BOUNDARY S OF A BOUNDARY S	YING CORPOF VN HEREON E THE THIRD ID COMPLETE T CORRECTL' ED ARE OF F AT THE MON URVEY CONF	RATION NUME BETWEEN SEG PRINCIPAL M AS SHOWN Y REPRESEN PERMANENT UMENTS ARE ORMS TO TH	BER 184-004 CTION 21, 2: MERIDIAN, DU TO THE BE TS SAID SL QUALITY AN E SUFFICIEN HE CURRENT	1039, HAVE 2, I5 AND I6, JPAGE EST OF MY JRVEY, THAT JD OCCUPY T TO ENABLE T ILLINOIS
-9 RASS		T JOLIET, ILLIN		DAY OF		, 2010 A.D.	
SS	ILLINOIS LICENSE THIS PRO CURRENT	EXPIRES NOVER	VICE LAND SURVEYOR MBER 30, 2010 RVICE CONFORMS IUM STANDARDS F	NO. 035-002 TO THE		18.00	
ON PIPE .16' NE'LY					с. с	30	60 90
					SC	ALE : 1" =	= 30'
D 1" PIPE					RECE	ac	-
P 0.12'E'LY					JUN 0 9		
			Ci	JOLIET		<b>ociates, P.</b> UNIT I 60431	С.
VENT TAX NUMBER	PROPERT ACQUIRED		SHEET	IS A COVER		ND NOT REC	CORDED.
22-102-009 22-102-010		2.22.2.2#	1		' OF ILL OF TRAI	.INOIS NSPORT.	
21-200-040 21-200-052 21-200-053		DGN. #2	SECTION FERRY PROJECT STATION 392			JOB NO. TO STATI	R-9I-035-09 ION 3933+08
E BY: JLS		JOB #5573		BUREAU O	OF LAND AC	QUISITION COURT	<u>49</u> OF <u>???</u> 96
			CONT	RACT 601	R30 SH	EET 54	0 OF 1156

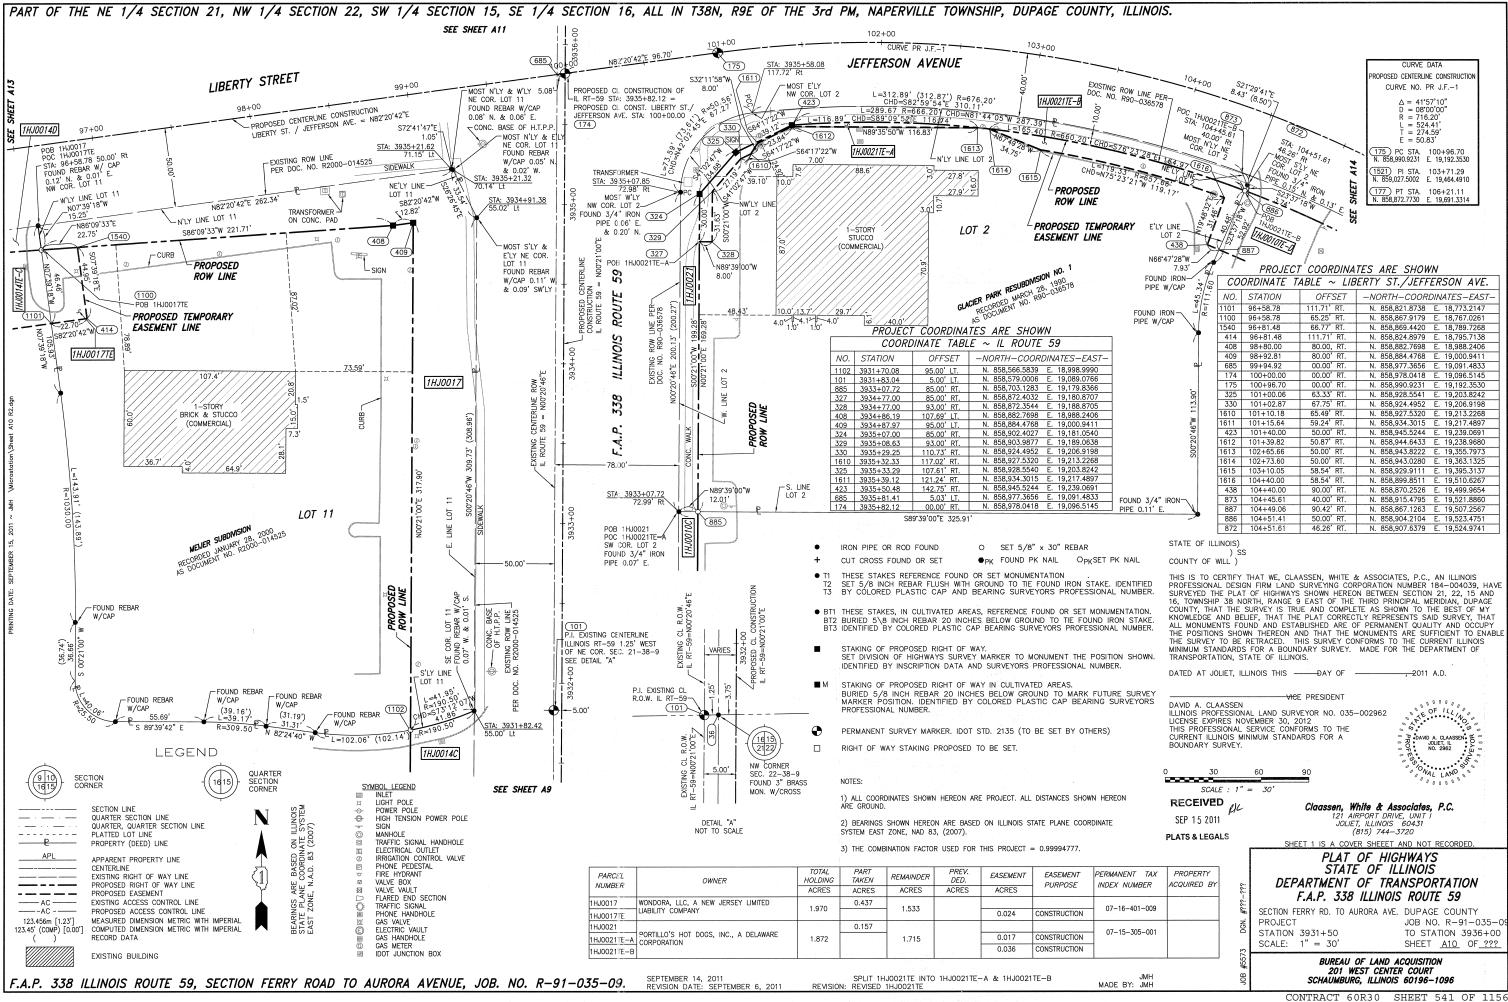

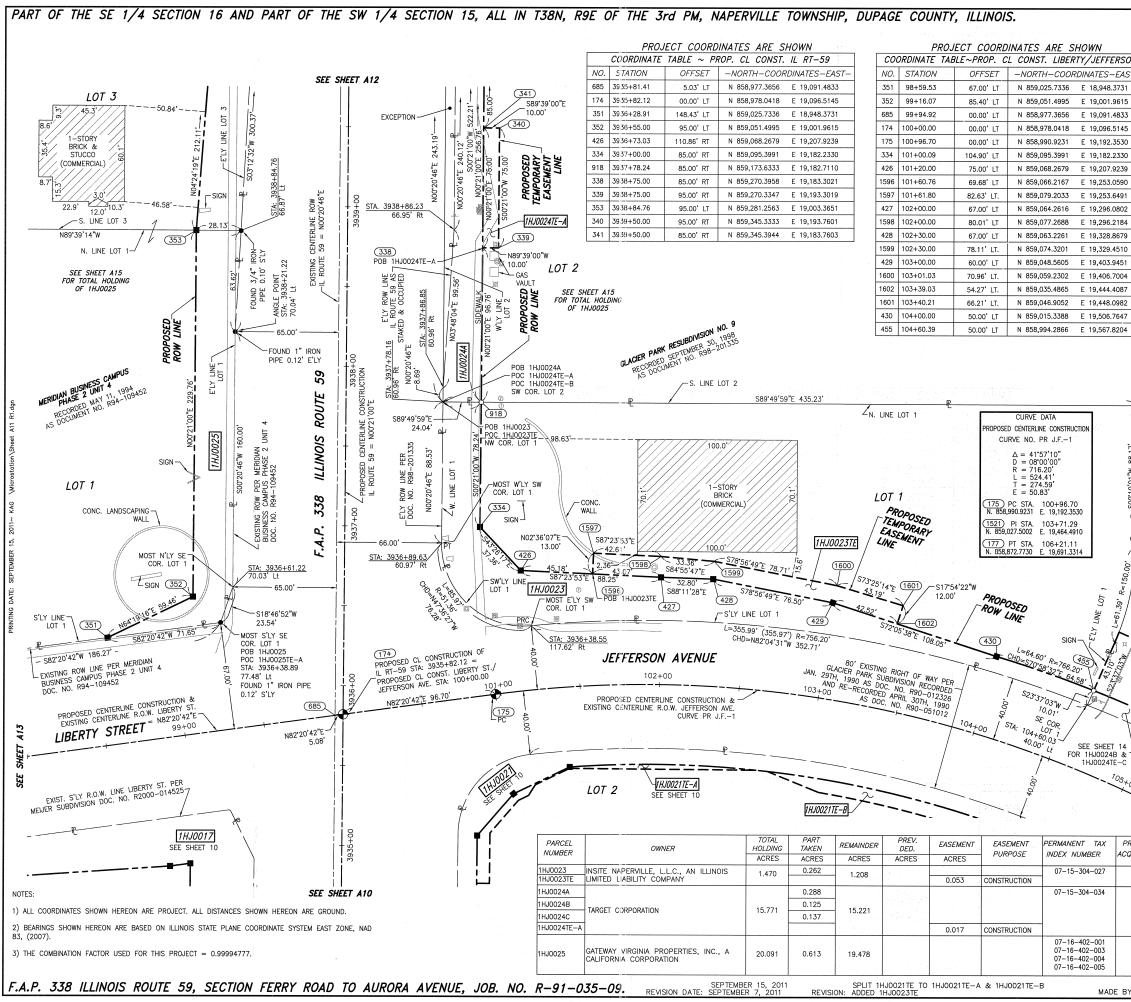

					******	1	
			LE	IGEND			
N	910	SECTION CORNER		- (1615)	QUARTER SECTION CORNER		
<u>T-</u>		QUARTI	ON LINE ER SECTION LINE ER, QUARTER SEC ED LOT LINE RTY (DEED) LINE	CTION LINE	N	E BASED ON ILLINOIS COORDINATE SYSTEM .A.D. 83 (2007)	
	APL APL APL APL APL APL APL APL APL APL	CENTEF     EXISTIN     PROPO     PROPO     EXISTIN     PROPO     EXISTIN     PROPO 23'] MEASU [0.00'] COMPU	NG RIGHT OF WAY ISED RIGHT OF WAY ISED EASEMENT NG ACCESS CONTH ISED ACCESS CON IRED DIMENSION N	LINE AY LINE ROL LINE		BEARINGS ARE BASED STATE PLANE COORDIN EAST ZONE, N.A.D. 83	
		EXISTI	NG BUILDING				
	+ CUT C • T1 THESE T2 SET 5	5/8 INCH REB	OR SET FERENCE FOUND BAR FLUSH WITH	O SET 5/8" PK FOUND PK OR SET MONUMER I GROUND TO TIE BEARING SURVEY	NTATION . FOUND IRON S	TAKE, IDENTIE	FIFD
	BT1 THESE     BT2 BURIE	E STAKES, IN D 5∖8 INCH	CULTIVATED ARI REBAR 20 INC	EAS, REFERENCE F HES BELOW GROUN CAP BEARING SURV	OUND OR SET ND TO TIE FOL	MONUMENTATI JND IRON ST	ON. AKE.
	SET D	VISION OF H	DSED RIGHT OF IIGHWAYS SURVI CRIPTION DATA	WAY. EY MARKER TO MO AND SURVEYORS F	DNUMENT THE PROFESSIONAL	POSITION SHO	OWN.
7	BURIE MARK	D 5/8 INCH	REBAR 20 INC IDENTIFIED B	WAY IN CULTIVATE HES BELOW GROU Y COLORED PLAS	JND TO MARK	FUTURE SUR	VEY ORS
	PERM.	ANENT SURVE	Y MARKER. IDO	T STD. 2135 (TO E	BE SET BY OTH	IERS)	
20.1	RIGHT	OF WAY STA	KING PROPOSED	) TO BE SET.			
	STATE OF ILL	INOIS) ) SS					
10 01 005	COUNTY OF V	/ILL )					
	PROFESSIONAN SURVEYED TH NORTH, RANG THIRD PRINCIF AS SHOWN TC REPRESENTS PERMANENT ( MONUMENTS / CONFORMS TC MADE FOR TH	L DESIGN FIRM E PLAT OF HI PAL MERIDIAN, D THE BEST C SAID SURVEY, JUALITY AND ARE SUFFICIEN D THE CURREN IE DEPARTMEN	M LAND SURVEY IGHWAYS SHOW ND SECTION 16, DUPAGE COUN F MY KNOWLED THAT ALL MON OCCUPY THE P NT TO ENABLE NT ILLINOIS MINI	WHITE & ASSOCIA ING CORPORATION N HEREON BETWEE TOWNSHIP 38 NOI GE AND BELIEF, TI UMENTS FOUND THE SUITONS SHOWN T THE SURVEY TO B MUM STANDARDS RIATION, STATE O Y OF	NUMBER 184- N SECTION 15, RTH, RANGE 9 RVEY IS TRUE HAT THE PLAT ND ESTABLISH HEREON AND E RETRACED. FOR A BOUND	-004039, HAV TOWNSHIP 34 EAST OF THE AND COMPLET CORRECTLY ED ARE OF THAT THE THIS SURVEY	8 E TE
	DAVID A. CLA	ASSEN		DENT	SE OF	144,00	
<u>,</u>	ILLINOIS PROF LICENSE EXPIR THIS PROFESS	ESSIONAL LAN RES NOVEMBE SIONAL SERVIC NOIS MINIMUM	ND SURVEYOR N R 30, 2012 DE CONFORMS T STANDARDS FO	IO. 035-002962 O THE DR A	JOLIE NO. 2		
7	INL INL	<u>l legend</u> .et :ht pole			" NAT		
	P0 SIC	WER POLE		0	30	60	90
$\sqrt{2}$	🖾 TR	NHOLE AFFIC SIGNAL H ECTRICAL OUTLE	ANDHOLE		SCALE : 1"	= 30'	
T AI	0 IRF P PH	RIGATION CONTR ONE PEDESTAL	ROL VALVE	RECE	VED		
· 00 SEE SHEET	🖾 VA	RE HYDRANT LVE BOX LVE VAULT		SEP 15	2011		
SEE '		ARED END SECT AFFIC SIGNAL		PLATS & L	EGALS		. [
	III GA	ONE HANDHOLE S VALVE ECTRIC VAULT		121 AIRPORT D	Associates, F	?. <i>C</i> .	
ROPERTY	GA G GA	S HANDHOLE S METER		JOLIET, ILLINOI (815) 744	IS 60431		
UIRED BI		T JUNCTION B	SHEET 1	S A COVER SHEEE	T AND NOT RE	CORDED.	
				PLAT OF H			
		:59		MENT OF TH			
		557-2922 #222-292		<b>P. 338 ILLING</b> RD. TO AURORA A			
	_	zj P	PROJECT		JOB NO.	R-91-035	
		s	SCALE: 1" =			<u>A11</u> OF ?	
INAL!		B #5573		BUREAU OF LAND 201 WEST CEN	TER COURT		
JMH /: JMH		BOL		ACT 60R30	DIS 60196-10 SHEET 5		156
			CONTR	TICT OOKOU	2 1001 3	UF 1	- J O

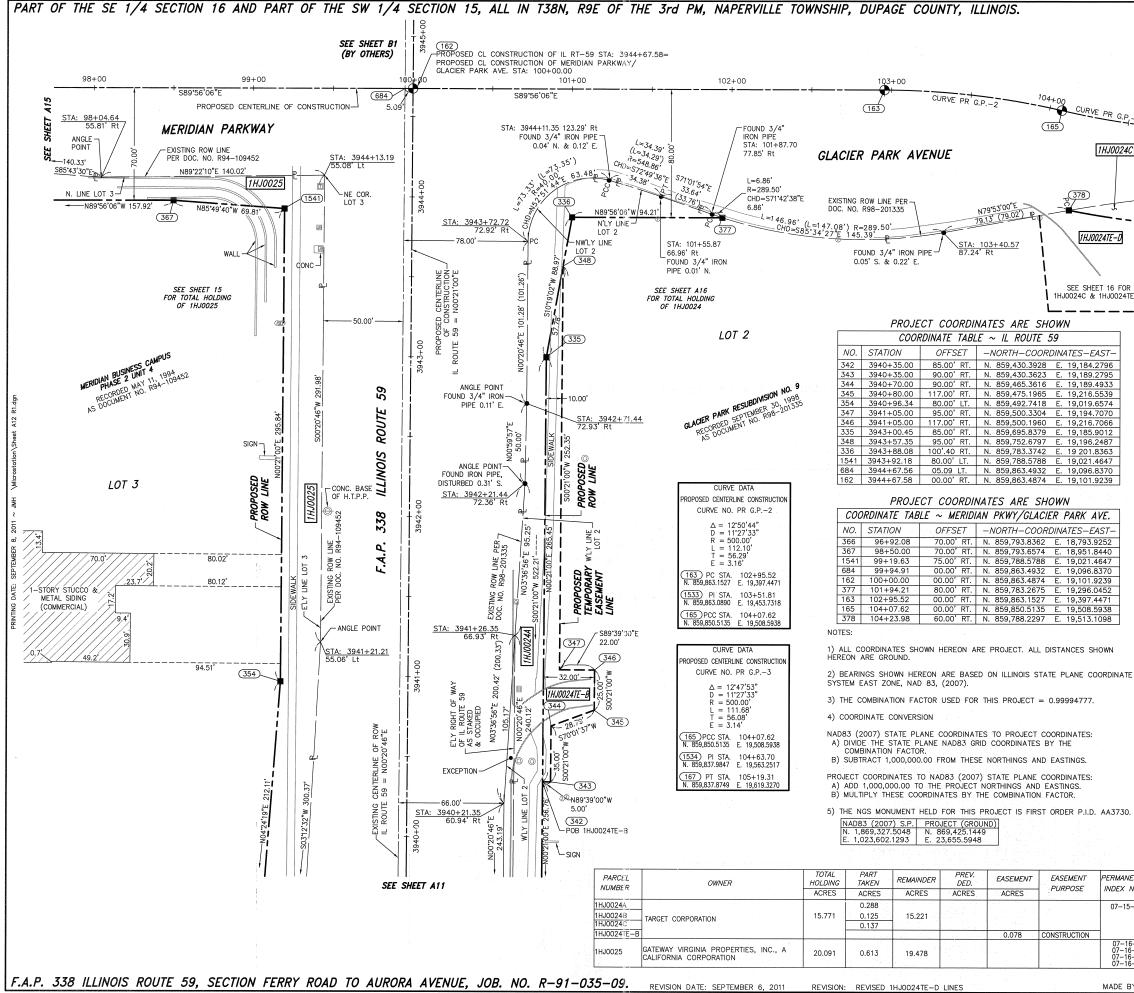

			LEGE	ND _	
		SECTION CORNER		-{ (1615) }- SE	JARTER ECTION DRNER
5	e	SECTION LIN QUARTER SE QUARTER, Q PLATTED LO PROPERTY (	ECTION LINE WARTER SECTION LIN T LINE	IE .	ON ILLINOIS ATE SYSTEM (2007)
SEE SHEET AN	APL AC AC 123.456m [1.23'] 123.45′ (COMP) [0.0	CENTERLINE EXISTING RIC PROPOSED F PROPOSED F EXISTING AC PROPOSED / MEASURED [ 0'] COMPUTED [	CESS CONTROL LINE ACCESS CONTROL LIN DIMENSION METRIC W DIMENSION METRIC W	NE ITH IMPERIAL	BEARINGS ARE BASED ON IL STATE PLANE COORDINATE : EAST ZONE, N.A.D. 83 (200
		RECORD DA			
	IRON PIP	E OR ROD FOU		SET 5/8" x 3	)" REBAR
		SS FOUND OR		FOUND PK NAI	L O <sub>PK</sub> SET PK NAIL
—D	T2 SET 5/8 T3 BY COLO	INCH REBAR F DRED PLASTIC	CAP AND BEARIN	ID TO TIE FOUN NG SURVEYORS	ID IRON STAKE. IDENTIFIED PROFESSIONAL NUMBER.
	BT2 BURIED BT3 IDENTIFIE	5\8 INCH REBA	AR 20 INCHES BEL PLASTIC CAP BEA	OW GROUND T	OR SET MONUMENTATION. O TIE FOUND IRON STAKE. RS PROFESSIONAL NUMBER.
	SET DIVI	SION OF HIGHW	RIGHT OF WAY. AYS SURVEY MARI ON DATA AND SUI		ENT THE POSITION SHOWN. SSIONAL NUMBER.
	BURIED MARKER	5/8 INCH REB.	NTIFIED BY COLO	LOW GROUND	REAS. TO MARK FUTURE SURVEY CAP BEARING SURVEYORS
		NT SURVEY MA	RKER. IDOT STD.	2135 (TO BE SE	ET BY OTHERS)
	RIGHT OF	WAY STAKING	PROPOSED TO BE	SET.	
	STATE OF ILLINO	) SS			
	SURVEYED THE F NORTH, RANGE S THIRD PRINCIPAL AS SHOWN TO T REPRESENTS SAI PERMANENT QUA MONUMENTS ARE CONFORMS TO TI MADE FOR THE (	PLAT OF HIGHW, MERIDIAN, DUF HE BEST OF M' D SURVEY, THA LITY AND OCCL SUFFICIENT TO HE CURRENT ILL DEPARTMENT OF	AYS SHOWN HERE ECTION 16, TOWNSI PAGE COUNTY, THA Y KNOWLEDGE AND AT ALL MONUMENTS IPY THE POSITIONS	DN BETWEEN SE HIP 38 NORTH, AT THE SURVEY BELLEF, THAT S FOUND AND E S SHOWN THERE RVEY TO BE RE ANDARDS FOR I, STATE OF ILL	IBER 184-004039, HAVE CTION 15, TOWNSHIP 38 RANGE 9 EAST OF THE IS TRUE AND COMPLETE THE PLAT CORRECTLY STABLISHED ARE OF CON AND THAT THE TRACED. THIS SURVEY A BOUNDARY SURVEY. INOIS.
			<del>VIC</del> E PRESIDENT		SE OF ILLING
	DAVID A. CLAAS: ILLINOIS PROFESS LICENSE EXPIRES THIS PROFESSION CURRENT ILLINOI: BOUNDARY SURV	SIONAL LAND SI NOVEMBER 30 IAL SERVICE CO S MINIMUM STA	URVEYOR NO. 035 1, 2012 DNFORMS TO THE NDARDS FOR A		Polavid A. CLAASSEN M P PR JAVId A. CLAASSEN M P JULET, IL NO. 2962 JU V
S M X	INLET LIGHT POLE				
¢ <b>⊕</b> ⊧ ⊚	POWER POLE HIGH TENSION P SIGN MANHOLE TRAFFIC SIGNAL ELECTRICAL OUT	HANDHOLE			ALE : 1" = 30'
	IRRIGATION CONT PHONE PEDESTA FIRE HYDRANT VALVE BOX	ROL VALVE		SEP <b>13 201</b> Plats & L <b>ega</b>	n 1
	VALVE VAULT FLARED END SEC TRAFFIC SIGNAL PHONE HANDHOL GAS VALVE ELECTRIC VAULT		121	<b>White &amp; Asso</b> AIRPORT DRIVE, IET, ILLINOIS 6 (815) 744–37.	UNIT Î 10431
6	GAS HANDHOLE GAS METER IDOT JUNCTION E	зох		VER SHEEET AN	ND NOT RECORDED.
INT TAX	PROPERTY ACQUIRED BY	<i>ل</i> ان ا	STAT DEPARTMENT	TE OF ILL	INOIS ISPORTATION
-304–034		ਤੂਂ PROJ	ON FERRY RD. TO	AURORA AVE. I	<b>KUUIL 39</b> DUPAGE COUNTY JOB NO. R-91-035-09 TO STATION 3945+00
-402-001 -402-003 -402-004		SCAL	E: 1" = 30'		SHEET <u>A12</u> OF <u>???</u>
-402-005		JOB #5573	201	OF LAND ACC WEST CENTER	COURT
Y: JMH		ř	CONTRACT (	<b>rg, illinois (</b> 50r30 sh	EET 543 OF 1156
			Sommer (		

### PART OF THE SE 1/4 SECTION 16 IN T38N, R9E OF THE 3rd PM, NAPERVILLE TOWNSHIP, DUPAGE COUNTY. ILLINOIS.

REMAINDER

ACRES

37.940

1.165

19.478

PRF

DED.

ACRES

EASEMENT

ACRES

0.067

0.019

EASEMENT

PURPOSE

CONSTRUCTION

CONSTRUCTION

PERMANENT TAX

INDEX NUMBER

07-21-200-040 07-21-200-052 07-21-200-053

07-16-401-008

7-16-402-001 7-16-402-003 7-16-402-004 7-16-402-005

PROPERTY

ACQUIRED B

TOTAL HOLDING

ACRES

38.327

1.215

20.091

TAKEN

ACRES

0.060

0.250

0.059

0.018

0.050

0.613

PARCEL

NUMBER

1HJ0014A

1HJ0014B 1HJ0014C

1HJ00140

111,0018

1HJ0025

1HJ0014TE-0

OWNER

JRFIN PROPERTIES AURORA, LLC, AN ILLINOIS

MEIJER STORES LIMITED PARTNERSHIP, A

MICHIGAN LIMITED PARTNERSHIP

IMITED LIABILITY COMPANY

THJ0025TE-A GATEWAY VIRGINIA PROPERTIES, INC., A CALIFORNIA CORPORATION

NOTES

1) ALL COORDINATES SHOWN HEREON ARE PROJECT. ALL DISTANCES SHOWN HEREON ARE GROUND

2) BEARINGS SHOWN HEREON ARE BASED ON ILLINOIS STATE PLANE COORDINATE SYSTEM EAST ZONE, NAD 83, (2007).

OFFSET

60.00' RT

50.00' RT

60.00' RT

111 71' RT

61.25' RT

111.71' RT

65.25' RT

66.29'LT

86.12' LT

66.84' IT

86.12' LT

-NORTH-COORDINATES-EAST-

N 858,836.1604 E 18,491.3193

N 858,846.0712 E 18,489.9873

N 858,862.6290 E 18,688.2500

N 858.813.8813 F 18.713.7494

N 858.863.8898 E 18.707.0279

N 858,821.8738 E 18,773.2147

858.867.9179 E 18.767.0261

N 858,999.1201 E 18,755.6893

N 859.018.7722 E 18.753.0479

N 859.005.2597 E 18.797.2417

N 859,024.3670 E 18,794.6736

3) THE COMBINATION FACTOR USED FOR THIS PROJECT = 0.99994777


4) COORDINATE CONVERSION


NAD83 (2007) STATE PLANE COORDINATES TO PROJECT COORDINATES: A) DIVIDE THE STATE PLANE NAD83 GRID COORDINATES BY THE COMBINATION FACTOR.

B) SUBTRACT 1.000.000.00 FROM THESE NORTHINGS AND FASTINGS.

PROJECT COORDINATES TO NAD83 (2007) STATE PLANE COORDINATES: A) ADD 1,000,000.00 TO THE PROJECT NORTHINGS AND EASTINGS. B) MULTIPLY THESE COORDINATES BY THE COMBINATION FACTOR.


5) THE NGS MONUMENT HELD FOR THIS PROJECT IS FIRST ORDER P.I.D. AA3730.

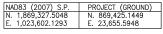


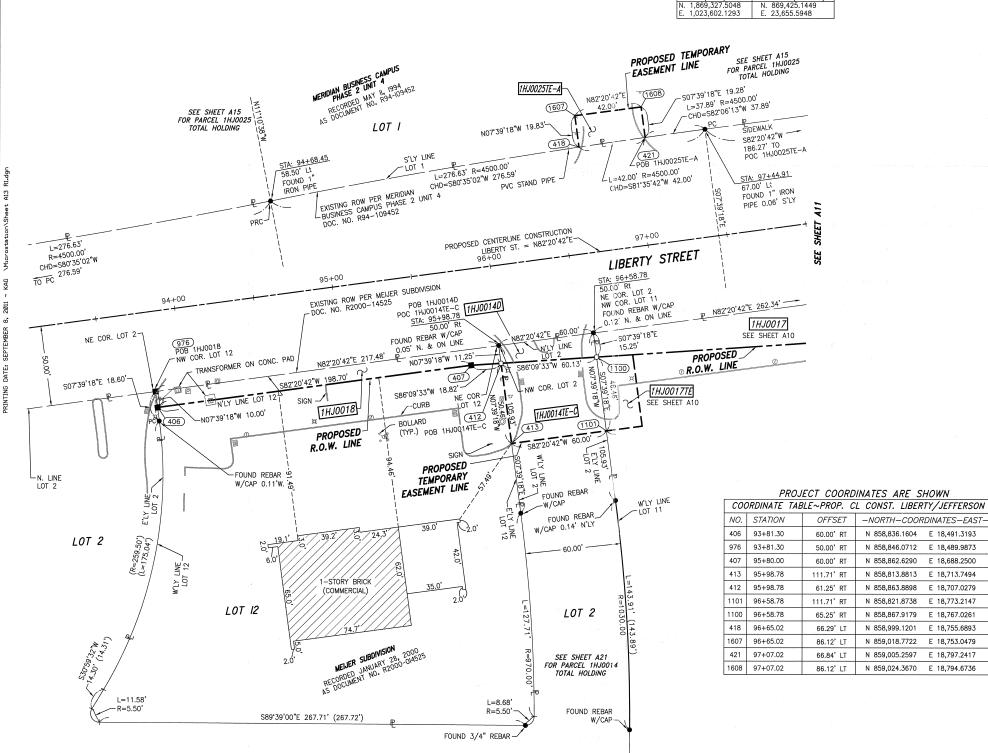



SYMBOL LEGEND INLET POWER POLE SIGN MANHOLE TRAFFIC SIGNAL HANDHOLE FLECTRICAL OUTLET IRRIGATION CONTROL VALVE PHONE PEDESTAL FIRE HYDRANT VALVE BOX VALVE VAULT FLARED END SECTION TRAFFIC SIGNAL PHONE HANDHOLE GAS VALVE ELECTRIC VAULT GAS HANDHOLE GAS METER IDOT JUNCTION BOX

n

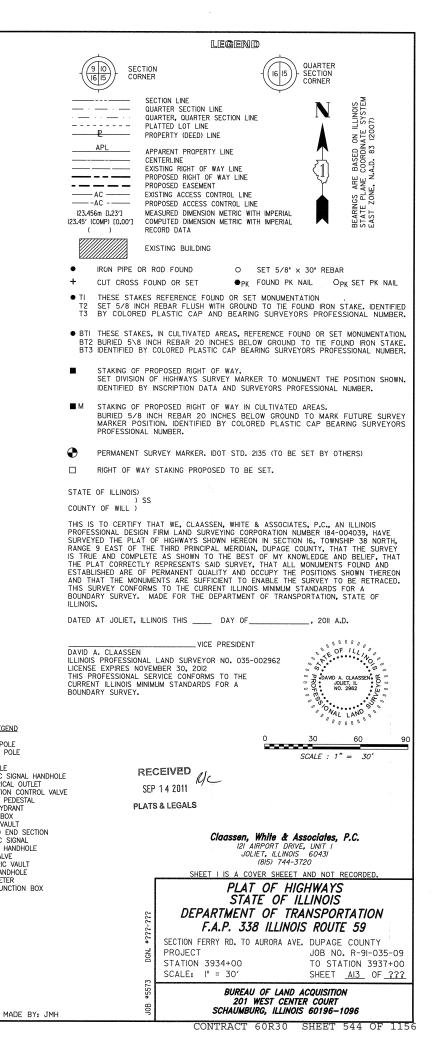

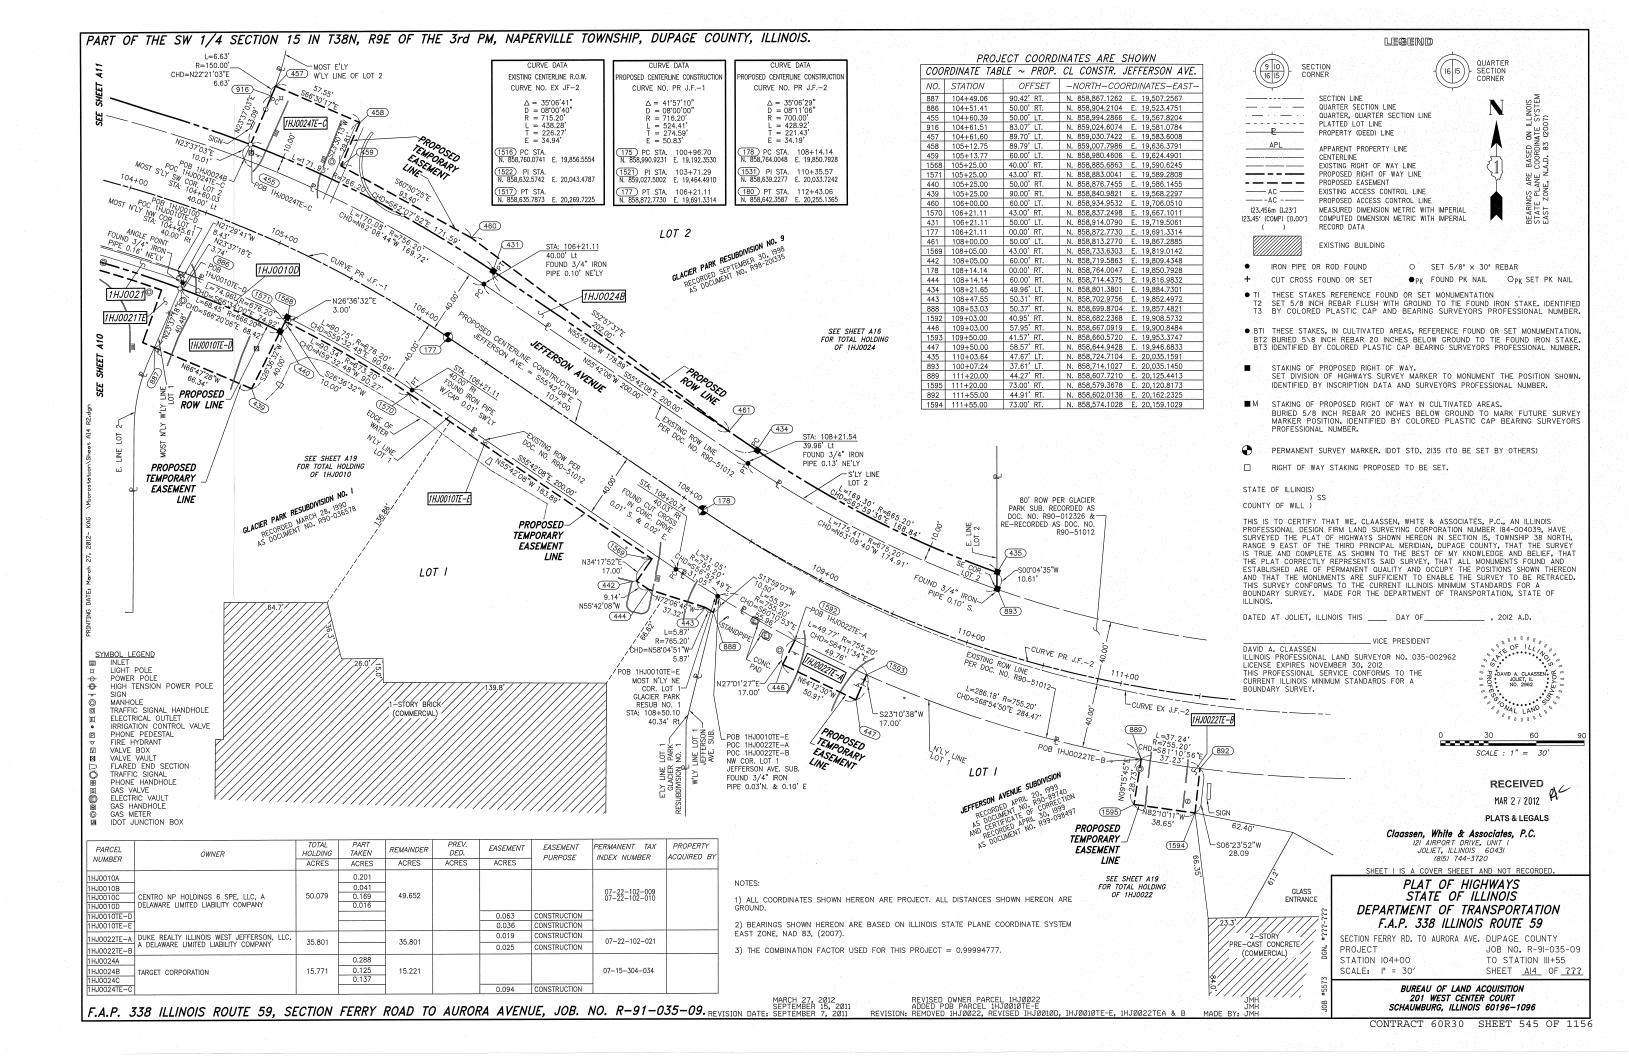

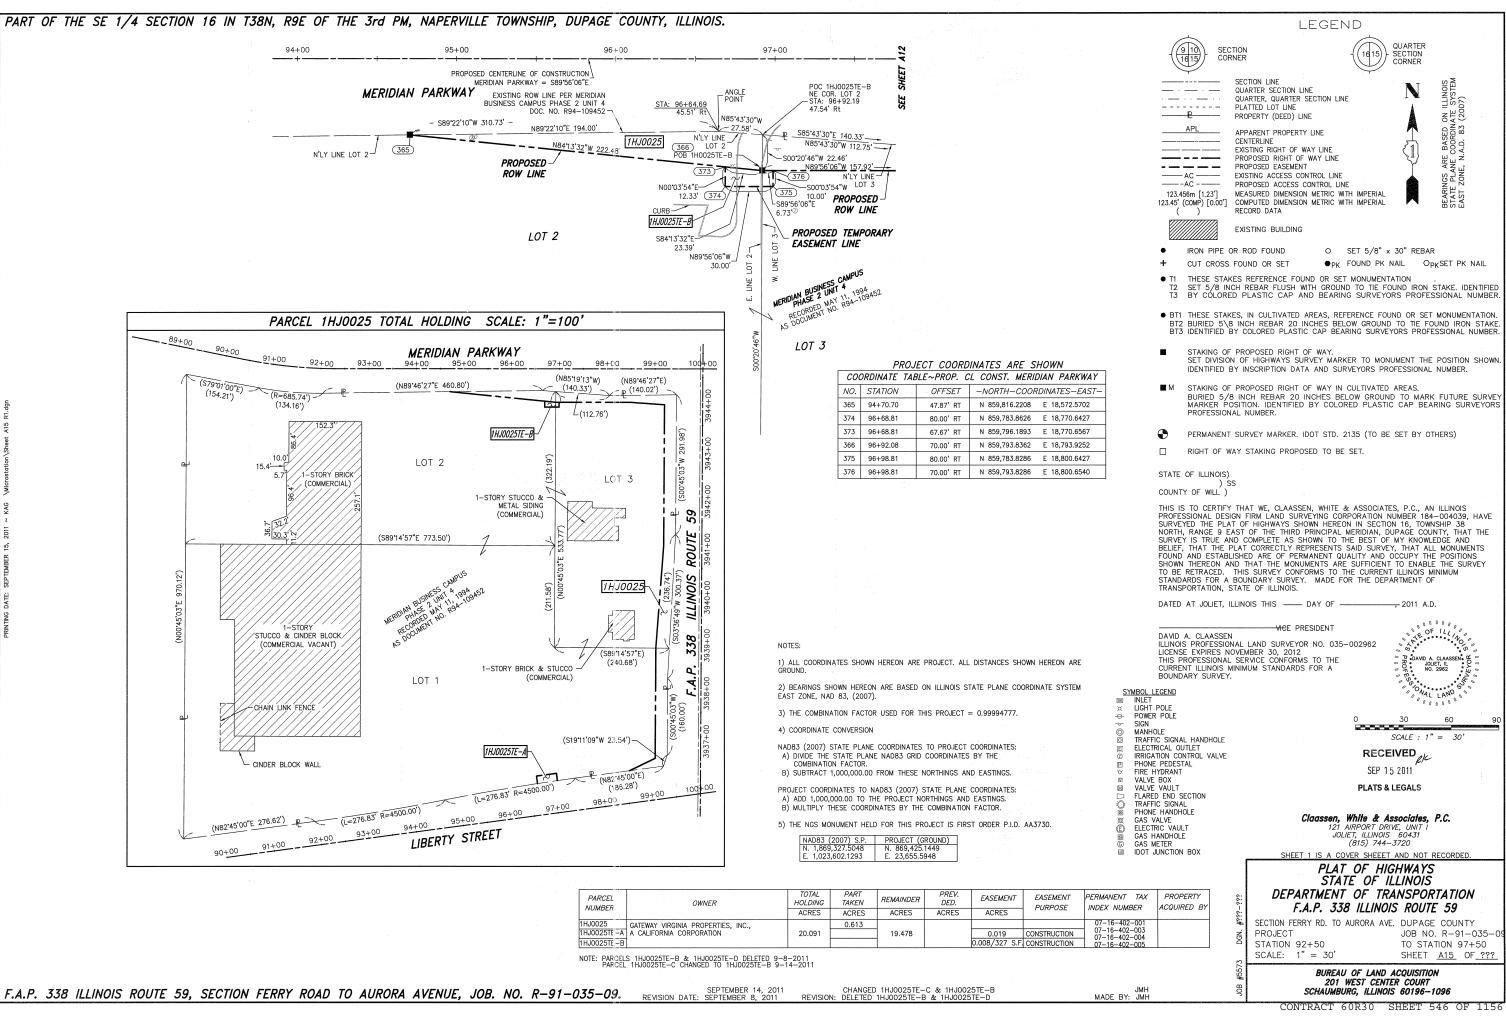


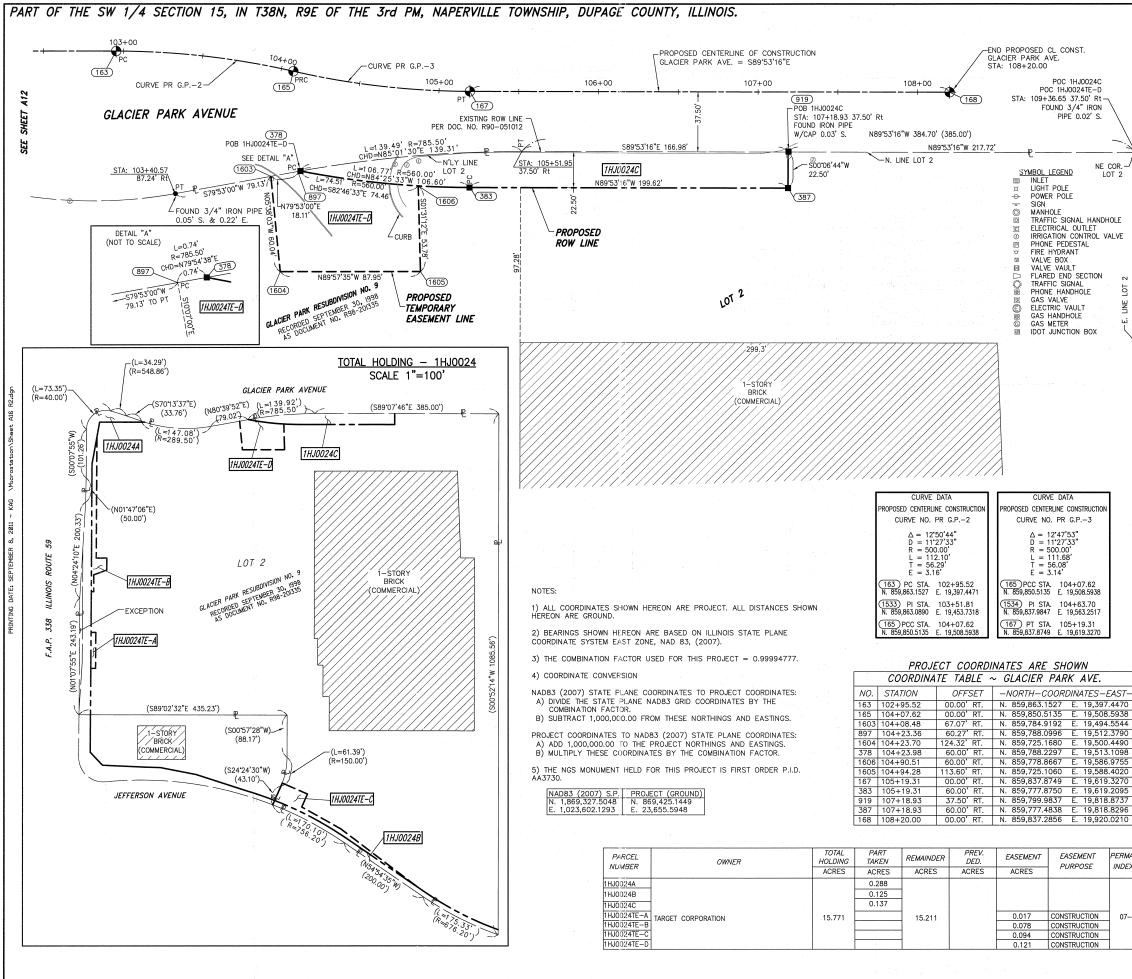

F.A.P. 338 ILLINOIS ROUTE 59, SECTION FERRY ROAD TO AURORA AVENUE, JOB. NO. R-91-035-09. REVISION DATE: SUBTEMENT 25, 2011


REVISED 1HJØØ24TE-D REVISION: REMOVED 1HJØØ24TE-E MZ

LEGEND 910 QUARTER SECTION SECTION SECTION LINE QUARTER SECTION LINE ILLINOIS SYSTE ----- · ----------QUARTER, QUARTER SECTION LINE . . \_\_\_\_ . . . . . . . . . . PLATTED LOT LINE ON ATE PROPERTY (DEED) LINE APL BASED COORDIN APPARENT PROPERTY LINE CENTERLINE EXISTING RIGHT OF WAY LINE ------PROPOSED RIGHT OF WAY LINE ARE ANE NE, N PROPOSED EASEMENT . ..... ..... ..... ------ AC ------EXISTING ACCESS CONTROL LINE CS PL --AC ------PROPOSED ACCESS CONTROL LINE BEARIN STATE EAST 123.456m [l.23'] MEASURED DIMENSION METRIC WITH IMPERIAL COMPUTED DIMENSION METRIC WITH IMPERIAL 123.45' (COMP) [0.00'] RECORD DATA EXISTING BUILDING O SET 5/8" × 30" REBAR IRON PIPE OR ROD FOUND CUT CROSS FOUND OR SET ●PK FOUND PK NAIL OPK SET PK NAIL THESE STAKES REFERENCE FOUND OR SET MONUMENTATION SET 5/8 INCH REBAR FLUSH WITH GROUND TO TIE FOUND IRON STAKE, IDENTIFIED T2 BY COLORED PLASTIC CAP AND BEARING SURVEYORS PROFESSIONAL NUMBER THESE STAKES, IN CULTIVATED AREAS, REFERENCE FOUND OR SET MONUMENTATION. BT2 BURIED 5\8 INCH REBAR 20 INCHES BELOW GROUND TO TIE FOUND IRON STAKE. BT3 IDENTIFIED BY COLORED PLASTIC CAP BEARING SURVEYORS PROFESSIONAL NUMBER. STAKING OF PROPOSED RIGHT OF WAY. SET DIVISION OF HIGHWAYS SURVEY MARKER TO MONUMENT THE POSITION SHOWN. IDENTIFIED BY INSCRIPTION DATA AND SURVEYORS PROFESSIONAL NUMBER. STAKING OF PROPOSED RIGHT OF WAY IN CULTIVATED AREAS. BURIED 5/8 INCH REBAR 20 INCHES BELOW GROUND TO MARK FUTURE SURVEY MARKER POSITION. IDENTIFIED BY COLORED PLASTIC CAP BEARING SURVEYORS PROFESSIONAL NUMBER. PERMANENT SURVEY MARKER. IDOT STD. 2135 (TO BE SET BY OTHERS) RIGHT OF WAY STAKING PROPOSED TO BE SET. STATE OF ILLINOIS) ) SS COUNTY OF WILL ) THIS IS TO CERTIFY THAT WE, CLAASSEN, WHITE & ASSOCIATES, P.C., AN ILLINOIS THIS IS TO CERTIFY THAT WE, CLAASSEN, WHITE & ASSOCIATES, P.C., AN ILLINOIS PROFESSIONAL DESIGN FIRM LAND SURVEYING CORPORATION NUMBER 184-004039, HAVE SURVEYED THE PLAT OF HIGHWAYS SHOWN HEREON IN SECTION 15, TOWNSHIP 38 NORTH, RANGE 9 EAST, OF THE THIRD PRINCIPAL MERIDIAN, DUPAGE COUNTY, THAT THE SURVEY IS TRUE AND COMPLETE AS SHOWN TO THE BEST OF MY KNOWLEDGE AND BELIEF, THAT THE PLAT CORRECTLY REPRESENTS SAID SURVEY, THAT ALL MONUMENTS FOUND AND ESTABLISHED ARE OF PERMANENT GUALITY AND OCCUPY THE POSITIONS SHOWN THEREON AND THAT THE MONUMENTS ARE SUFFICIENT TO ENABLE THE SURVEY TO BE RETRACED. THIS SURVEY CONFORMS TO THE CURRENT ILLINOIS MINIMUM STANDARDS FOR A DOWNDARD CURVEY. BOUNDARY SURVEY. MADE FOR THE DEPARTMENT OF TRANSPORTATION, STATE OF ILLINOIS. DATED AT JOLIET, ILLINOIS THIS \_\_\_\_\_ DAY OF\_\_\_\_\_ 2011 A D . . . . . . VICE PRESIDENT THE OF ILLING DAVID A. CLAASSEN ILLINOIS PROFESSIONAL LAND SURVEYOR NO. 035-002962 LICENSE EXPIRES NOVEMBER 30, 2012 THIS PROFESSIONAL SERVICE CONFORMS TO THE JOLIET, IL NO. 2962 CURRENT ILLINOIS MINIMUM STANDARDS FOR A BOUNDARY SURVEY. SCALE : 1" = 30' RECEIVED SEP 13 2011 PLATS & LEGALS Claassen, White & Associates, P.C. I2I AIRPORT DRIVE, UNIT I JOLIET, ILLINOIS 6043I (8I5) 744-3720 SHEET I IS A COVER SHEEET AND NOT RECORDED PROPERTY PERMANENT TAX PLAT OF HIGHWAYS ACQUIRED BY INDEX NUMBER STATE OF ILLINOIS DEPARTMENT OF TRANSPORTATION F.A.P. 338 ILLINOIS ROUTE 59 222 SECTION FERRY RD. TO AURORA AVE, DUPAGE COUNTY 07-15-304-034 ĞN. PROJECT JOB NO. R-91-035-09 STATION 103+00 TO STATION 108+20 SHEET AIG OF ??? SCALE: |" = 30' BUREAU OF LAND ACQUISITION 201 WEST CENTER COURT JMH MADE BY: JLS SCHAUMBURG, ILLINOIS 60196-1096 CONTRACT 60R30 SHEET 547 OF 115

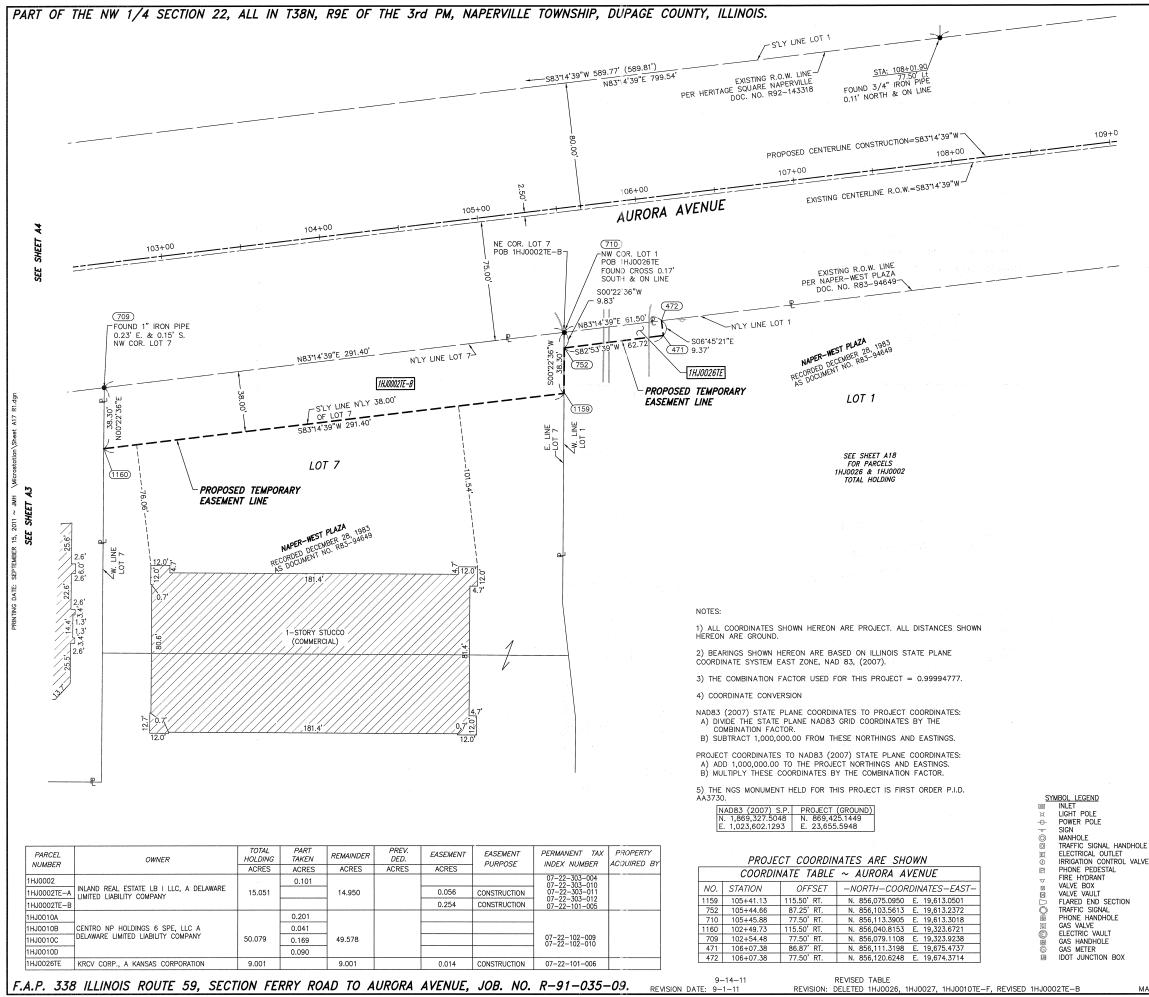


in the state of the


		LEGEND		
		ORNER - (1615	QUARTER SECTION CORNER	ILLINOIS SYSTEM 007)
	₽	SECTION LINE QUARTER SECTION LINE QUARTER, QUARTER SECTION PLATTED LOT LINE PROPERTY (DEED) LINE		BASED ON ILL COORDINATE S A.D. 83 (2007)
	APL	APPARENT PROPERTY LINE CENTERLINE	<1)	GS ARE BA PLANE CO ONE, N.A.E
-	AC	EXISTING RIGHT OF WAY LINE PROPOSED RIGHT OF WAY LIN PROPOSED EASEMENT EXISTING ACCESS CONTROL LI		BEARINGS ARE STATE PLANE ( EAST ZONE, N./
- 12		PROPOSED ACCESS CONTROL MEASURED DIMENSION METRIC	LINE WITH IMPERIAL	ST EA
		RECORD DATA EXISTING BUILDING		
			· · · ·	
	RON PIPE OR RO		5/8" x 30" REBAR	
• T1 T		D OR SET @PK FOU EFERENCE FOUND OR SET MO EBAR FLUSH WITH GROUND TO		
тз в • вт1 т	IY CÓLORED PL. HESE STAKES, IN	ASTIC CAP AND BEARING S	URVEYORS PROFESSIONAL	NUMBER.
BT2 B BT3 IC	URIED 5\8 INCH DENTIFIED BY CO	I REBAR 20 INCHES BELOW LORED PLASTIC CAP BEARING	GROUND TO TIE FOUND IR( SURVEYORS PROFESSIONAL	DN STAKE. NUMBER.
s	ET DIVISION OF	POSED RIGHT OF WAY. HIGHWAYS SURVEY MARKER SCRIPTION DATA AND SURVEY		
B	URIED 5/8 INC	POSED RIGHT OF WAY IN CUL H REBAR 20 INCHES BELOW N. IDENTIFIED BY COLORED JMBER.	GROUND TO MARK FUTUR	E SURVEY JRVEYORS
•	ERMANENT SURV	EY MARKER. IDOT STD. 2135	(TO BE SET BY OTHERS)	
	IGHT OF WAY ST	TAKING PROPOSED TO BE SET	-	
		0 30	60 90	
		SCALE : 1" =	30'	
STATE	OF ILLINOIS)			
	TY OF WILL )			4
PROFE SURVE NORTH SURVE BELIEF FOUND SHOWN TO BE STANE	ESSIONAL DESIGN YED THE PLAT H, RANGE 9 EAS EY IS TRUE AND F, THAT THE PLA D AND ESTABLISI N THEREON AND E RETRACED. TH DARDS FOR A BC	HAT WE, CLAASSEN, WHITE & FIPM LAND SURVEYING CORI OF HIGHWAYS SHOWN HEREOD T OF THE THIRD PRINCIPAL N COMPLETE AS SHOWN TO TH ALC ARE OF PERMARENT QU THAT THE MONUMENTS ARE HIS SURVEY CONFORMS TO TH DUNDARY SURVEY. MADE FO	PORATION NUMBER 184-000 IN SECTION 22, TOWNSHIE RENDIAN, DUPAGE COUNTY, IE BEST OF MY KNOWLEDGE SAID SURVEY, THAT ALL MO ALITY AND OCCUPY THE PO SUFFICIENT TO ENABLE THI IE CURRENT ILLINOIS MINIM	4039, HAVE 38 THAT THE AND NUMENTS SITIONS E SURVEY
	SPORTATION, STA	NOIS THISDAY OF	, 2011 A.D.	
DAME		VICE PRESIDENT	002962 - U DAND A. CLAASEN	0
CURRE	A. CLAASSEN IS PROFESSIONA SE EXPIRES NOV PROFESSIONAL S ENT ILLINOIS MIN DARY SURVEY.	L LAND SURVEYOR NO. 035- EMBER 30, 2012 ERVICE CONFORMS TO THE IMUM STANDARDS FOR A	NO. 2962	" " " " " " " " " " " " " " " " " " "
	RECE	IVED	CONTRACTION OF THE OWNER	
	SEP 15	5 2011 Claassen, Wi	hite & Associates, P.C.	
	PLATS &	LEGALS JOLIET	PORT DRIVE, UNIT I , ILLINOIS 60431 815) 744–3720	
		SHEET 1 IS A COVER	R SHEEET AND NOT RECORD	DED.
<u>E</u>	<b>~</b> .	STATE	OF HIGHWAYS OF ILLINOIS OF TRANSPORTATI	ION
	iii−iii#		ILLINOIS ROUTE 59	
	DGN. #??	SECTION FERRY RD. TO AU PROJECT	RORA AVE. DUPAGE COU JOB NO. R-9	
		STATION 104+50 SCALE: 1" = 30'	STATION 113 SHEET A17	+50
	#5573	BUREAU O	F LAND ACQUISITION	
JMH ADE BY: JMH	B	SCHAUMBURG	ST CENTER COURT , ILLINOIS 60196—1096	
A CONTRACTOR OF THE OWNER			R30 SHEET 548	OF 1156

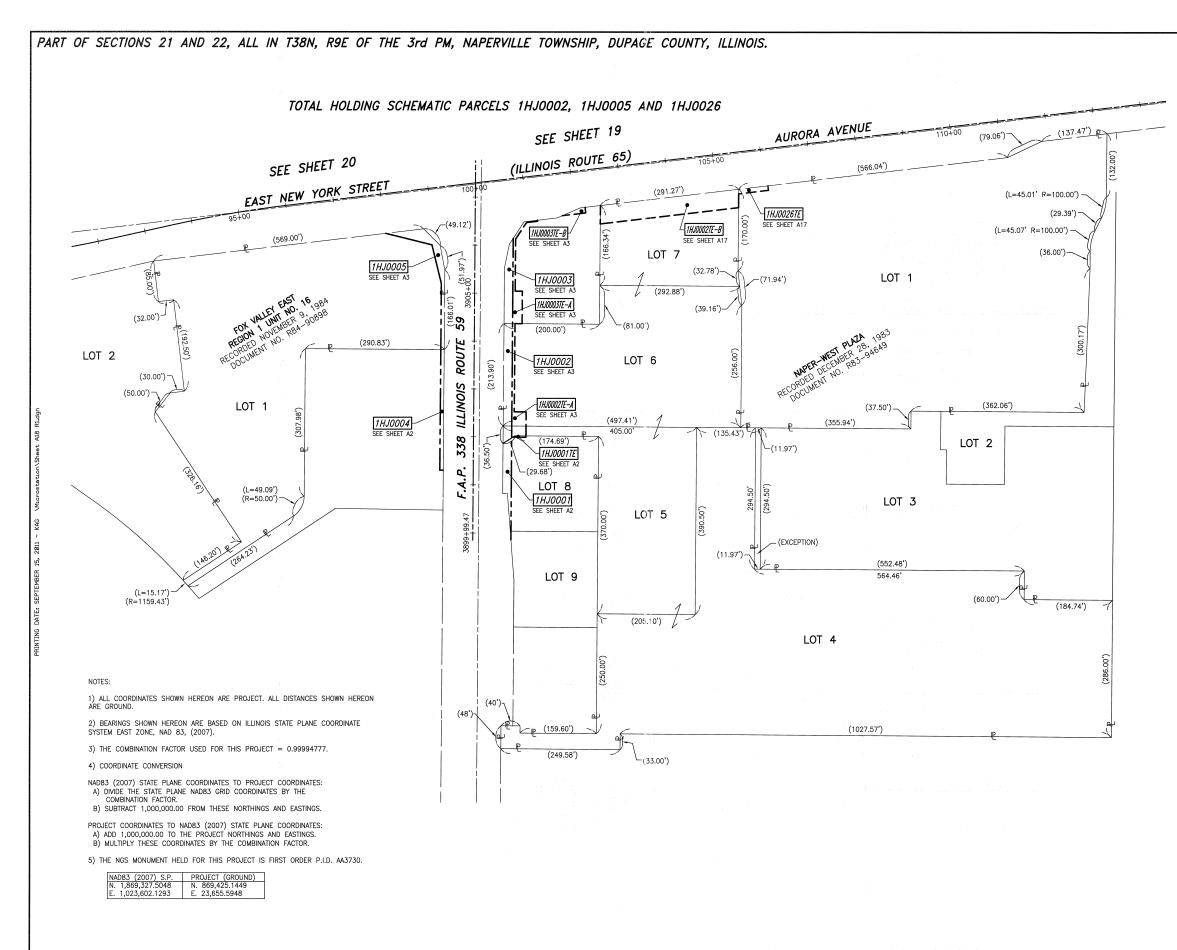


F.A.P. 338 ILLINOIS ROUTE 59, SECTION FERRY ROAD TO AURORA AVENUE, JOB. NO. R-91-035-09. REVISION DATE: SEPTEMBER 7, 2011 REVISION: REVI

MADE BY: JMH

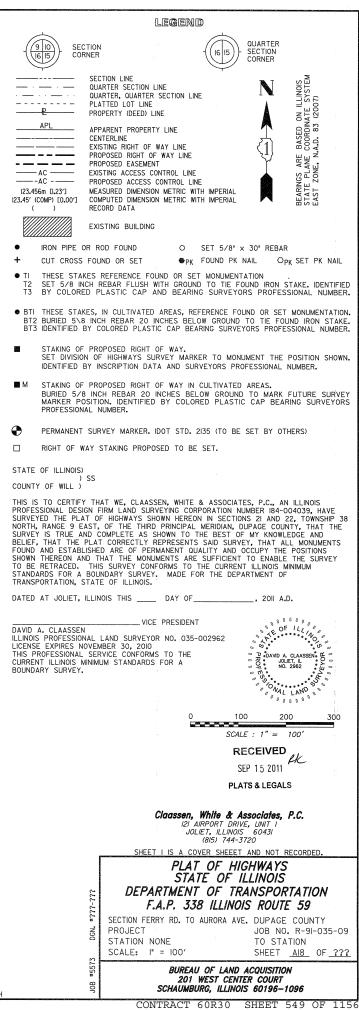


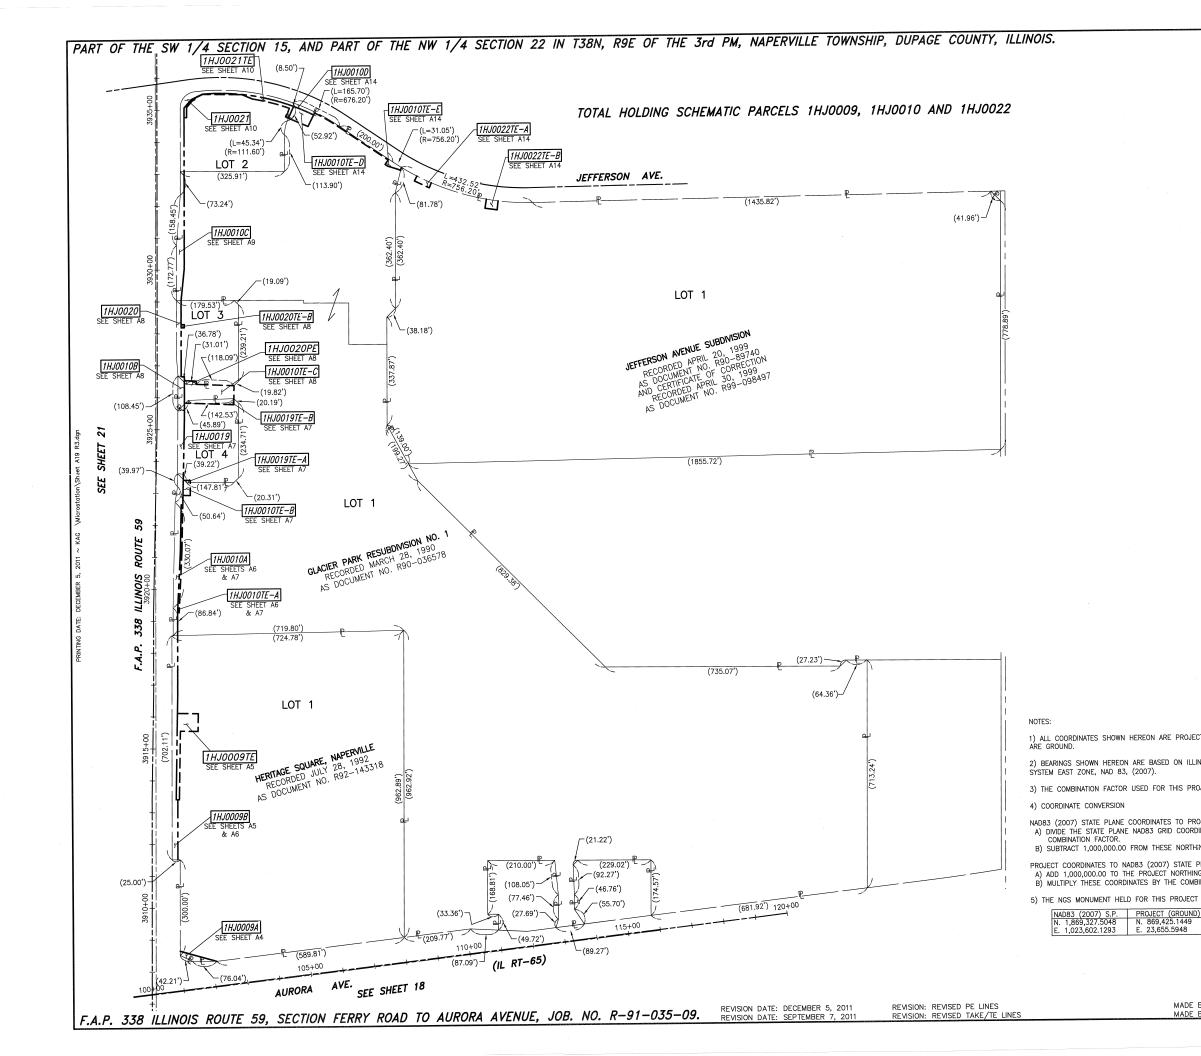



910 SECTION 1615 CORNER	16 UUARTER SECTION CORNER					
QUAR QUAR PLATT	DN LINE TER SECTION LINE TER, QUARTER SECTION LINE ED LOT LINE RENT PROPERTY RENT PROPERTY LINE RENT PROPERTY RENT PROPERTY REN					
CENTE CENTE EXISTI PROPO AC — PROPO AC — EXISTI — AC — PROPO 123.456m [1.23'] MEASI [123.45' (COMP) [0.00'] COMP	RENT PROPERTY LINE RELINE ING RIGHT OF WAY LINE DSED RIGHT OF WAY LINE DSED RIGHT OF WAY LINE DSED ACCESS CONTROL LINE USED ACCESS CONTROL LINE URED DIMENSION METRIC WITH IMPERIAL UTED DIMENSION METRIC WITH IMPERIAL UTED DIMENSION METRIC WITH IMPERIAL DIMENSION METRIC WITH IMPERIAL					
	ING BUILDING					
TO SET 5 /8 INCH PE						
BT2 BURIED 5\8 INCH	I CULTIVATED AREAS, REFERENCE FOUND OR SET MONUMENTATION. I REBAR 20 INCHES BELOW GROUND TO TIE FOUND IRON STAKE. LORED PLASTIC CAP BEARING SURVEYORS PROFESSIONAL NUMBER.					
SET DIVISION OF	POSED RIGHT OF WAY. HIGHWAYS SURVEY MARKER TO MONUMENT THE POSITION SHOWN. SCRIPTION DATA AND SURVEYORS PROFESSIONAL NUMBER.					
BURIED 5/8 INC	POSED RIGHT OF WAY IN CULTIVATED AREAS. H REBAR 20 INCHES BELOW GROUND TO MARK FUTURE SURVEY N. IDENTIFIED BY COLORED PLASTIC CAP BEARING SURVEYORS JMBER.					
PERMÁNENT SURV	YEY MARKER. IDOT STD. 2135 (TO BE SET BY OTHERS)					
RIGHT OF WAY S	TAKING PROPOSED TO BE SET.					
STATE OF ILLINOIS) ) SS						
PROFESSIONAL DESIGN FI SURVEYED THE PLAT OF 38 NORTH, RANGE 9 EAS THE SURVEY IS TRUE AN BELIEF, THAT THE PLAT FOUND AND ESTABLISHEL CUONN THEFOON AND T	T WE, CLAASSEN, WHITE & ASSOCIATES, P.C., AN ILLINOIS RM LAND SURVEYING CORPORATION NUMBER 184-004039, HAVE HIGHWAYS SHOWN HERCON IN SECTIONS 15 AND 22, TOWNSHIP ST, OF THE THIRD PRINCIPAL MERIDIAN, DUPAGE COUNTY, THAT ID COMPLETE AS SHOWN TO THE BEST OF MY KNOWLEDGE AND CORRECTLY REPRESENTS SAID SURVEY, THAT ALL MONUMENTS ) ARE OF PERMANENT QUALITY AND OCCUPY THE POSITIONS 1AT THE MONUMENTS ARE SUFFICIENT TO ENABLE THE SURVEY SURVEY CONFORMS TO THE CURRENT ILLINOIS MINIMUM 4DARY SURVEY. MADE FOR THE DEPARTMENT OF OF ILLINOIS.					
DATED AT JOLIET, ILLINO	IS THIS DAY OF					
DAVID A. CLAASSEN ILLINOIS PROFESSIONAL I LICENSE EXPIRES NOVEM THIS PROFESSIONAL SER CURRENT ILLINOIS MINIMU BOUNDARY SURVEY.	VICE CONFORMS TO THE					
CT. ALL DISTANCES SHOWN HEREON	0 150 300 450					
INOIS STATE PLANE COORDINATE	SCALE : 1" = 150'					
OJECT = 0.99994777.	DEC 05 2011					
OJECT COORDINATES:	PLATS & LEGALS					
DINATES BY THE IINGS AND EASTINGS.	<b>Claassen, White &amp; Associates, P.C.</b> 121 AIRPORT DRIVE, UNIT I JOLIET, ILLINOIS 60431					
PLANE COORDINATES: IGS AND EASTINGS.	(\$15) 744–3720 SHEET 1 IS A COVER SHEEET AND NOT RECORDED.					
BINATION FACTOR.	PLAT OF HIGHWAYS STATE OF ILLINOIS DEPARTMENT OF TRANSPORTATION F.A.P. 338 ILLINOIS ROUTE 59					
€ DGN. #???−???	SECTION FERRY RD. TO AURORA AVE. DUPAGE COUNTY PROJECT JOB NO. R-91-035-0 STATION NONE TO STATION					
BY: KAG	SCALE: 1" = 150' SHEET <u>A19</u> OF <u>???</u> BUREAU OF LAND ACQUISITION 201 WEST CENTER COURT SCHAUMBURG, ILLINOIS 60196–1096					
BY: JMH	CONTRACT 60R30 SHEET 550 OF 115					

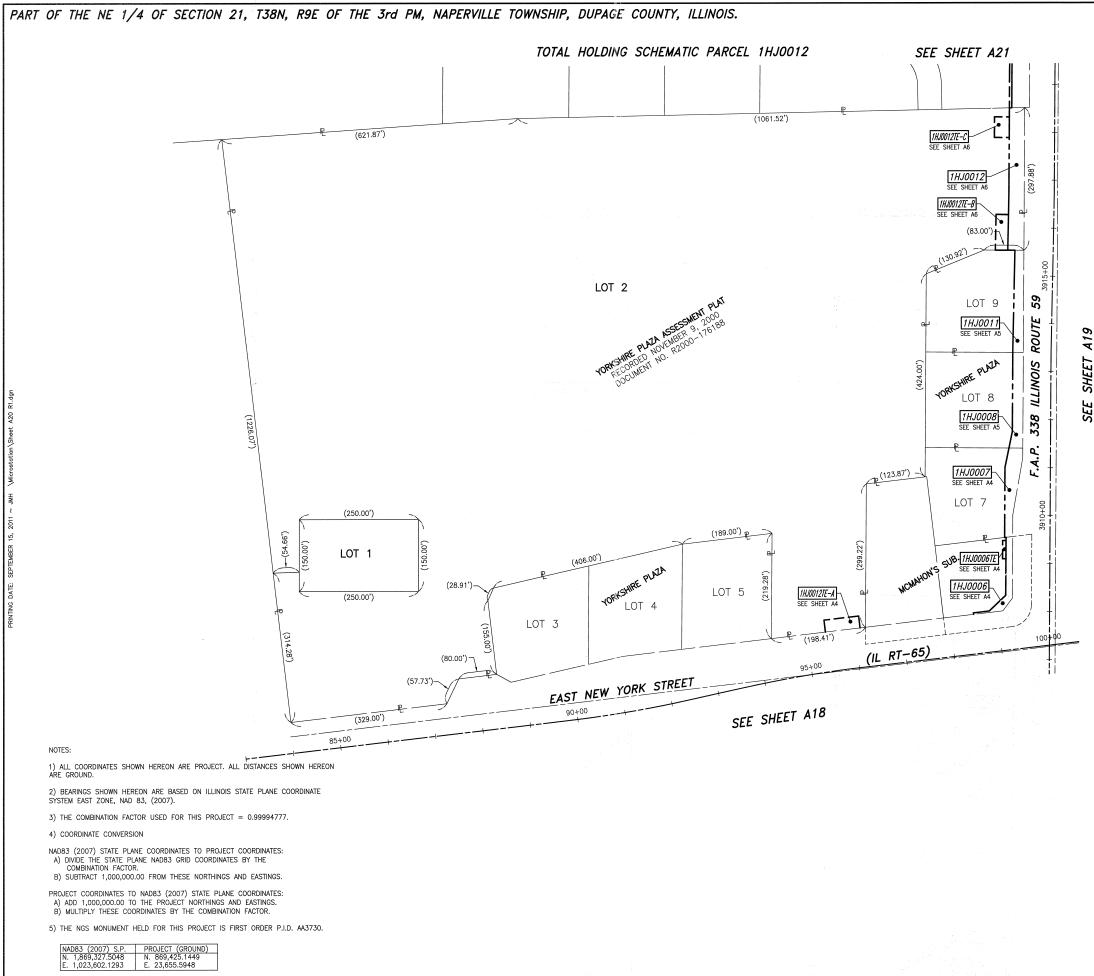


ADDED PL SYMBOLS REVISION: REVISED TAKE/TE LINES F.A.P. 338 ILLINOIS ROUTE 59, SECTION FERRY ROAD TO AURORA AVENUE, JOB. NO. R-91-035-09. REVISION DATE: SEPTEMBER 14, 2011 SEPTEMBER 7, 2011

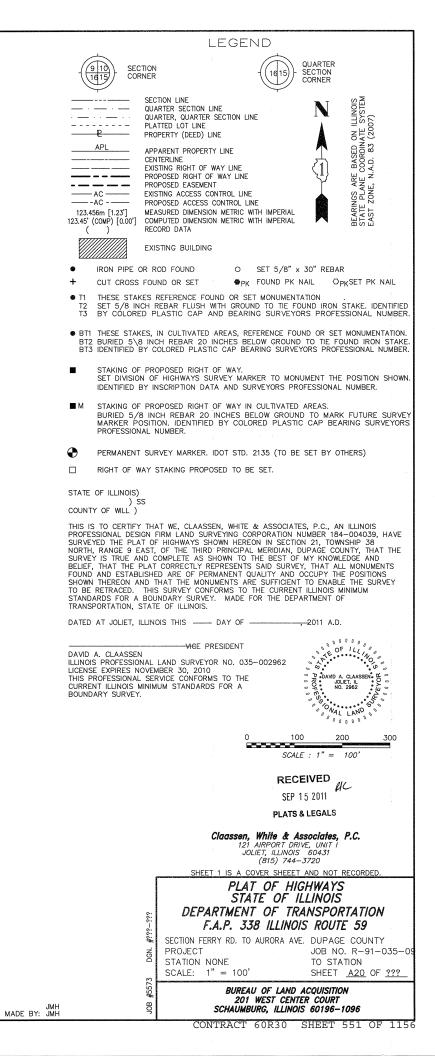

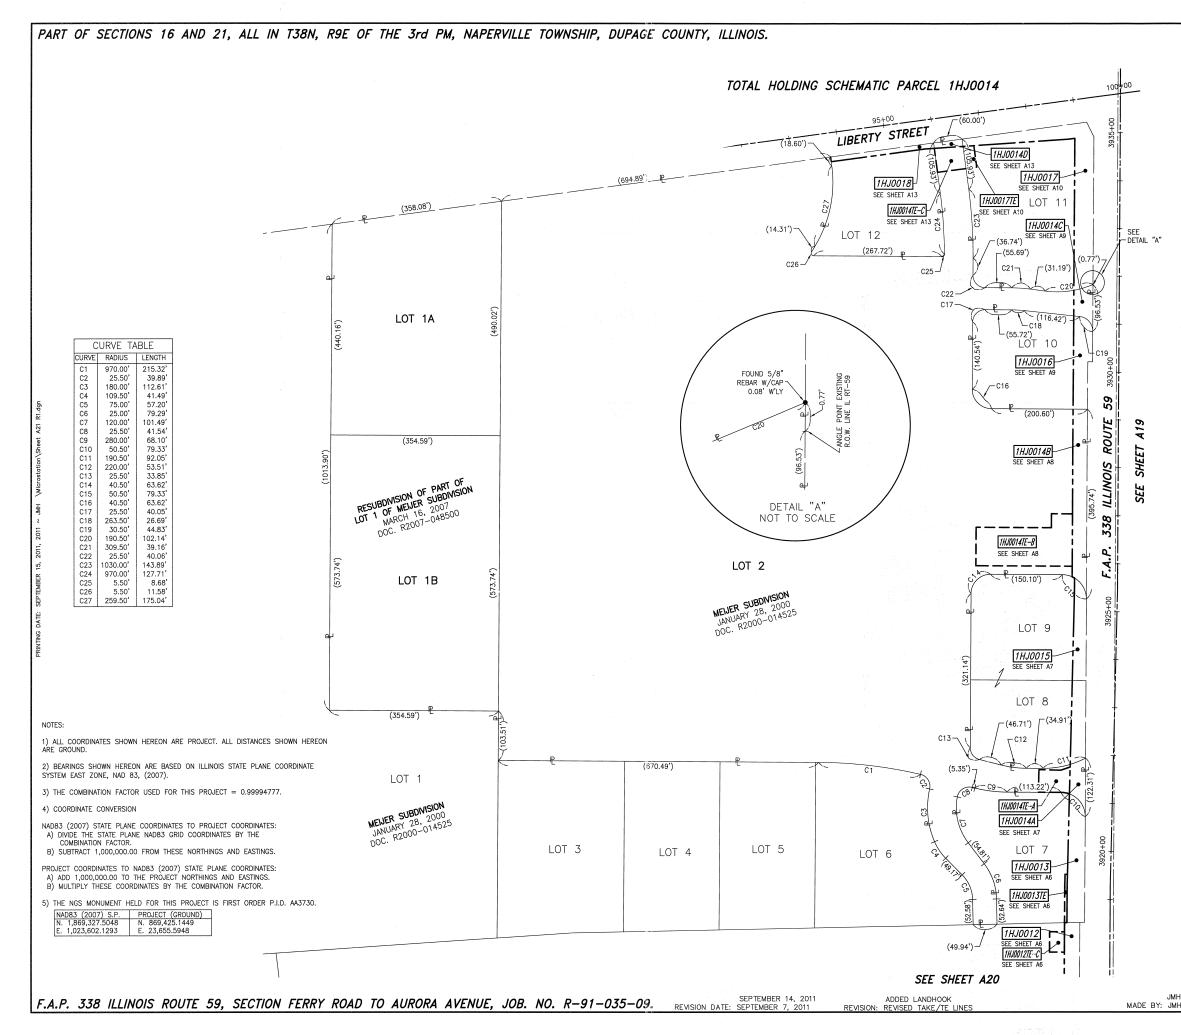


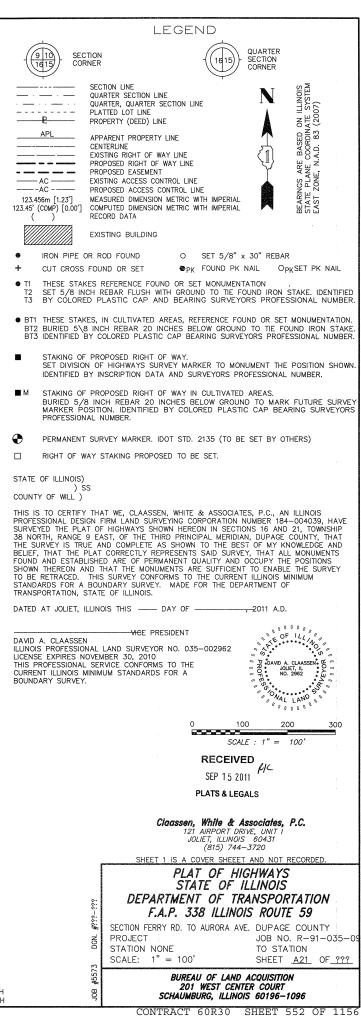

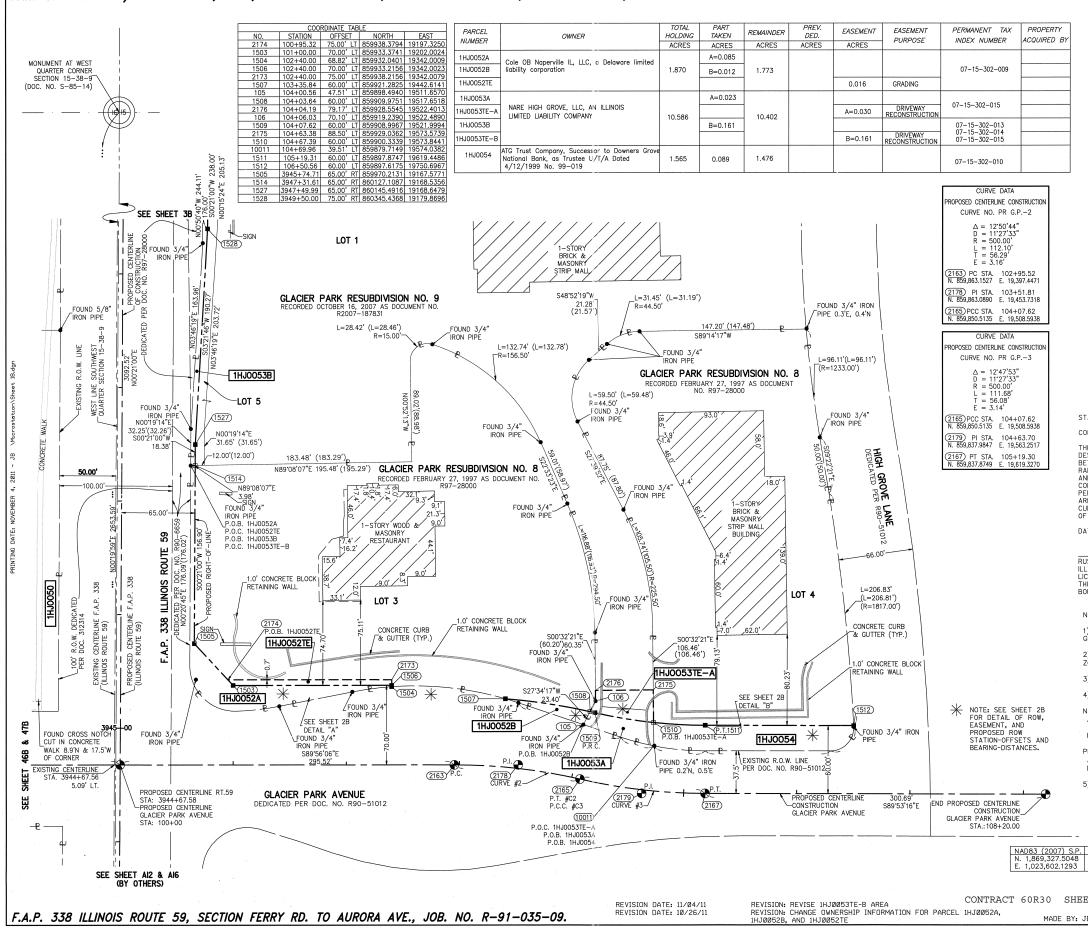


PART OF THE SW 1/4 SECTION 15, T38N, R9E OF THE 3rd PM, NAPERVILLE TOWNSHIP, DUPAGE COUNTY, ILLINOIS.

(9 10) SECTION (6 15) CORNER - (16 15) OUARTER SECTION CORNER
SECTION LINE     SECTION LINE     OUARTER SECTION LINE     OUARTER, QUARTER SECTION LINE     PLATTED LOT LINE     PROPERTY QUEED LINE     APL APPARENT PROPERTY LINE     CENTERLINE     CENTERLINE     SECTION RIGHT OF WAY LINE     SECTION RIGHT OF WAY LINE
AC     AC
$\begin{array}{c ccccccccccccccccccccccccccccccccccc$
IRON PIPE OR ROD FOUND     O SET 5/8" x 30" REBAR
<ul> <li>CUI CROSS FOUND OR SEI</li> <li>OPK FOUND PK NAIL</li> <li>OPK SET PK NAIL</li> <li>TI THESE STAKES REFERENCE FOUND OR SET MONUMENTATION.</li> <li>SET 578 INCH REBAR FLUSH WITH GROUND TO TIE FOUND IRON STAKE. IDENTIFIED</li> <li>T3 BY COLORED PLASTIC CAP AND BEARING SURVEYORS PROFESSIONAL NUMBER.</li> </ul>
● BTI THESE STAKES, IN CULTIVATED AREAS, REFERENCE FOUND OR SET MONUMENTATION. BT2 BURIED 5\8 INCH REBAR 20 INCHES BELOW GROUND TO TIE FOUND IRON STAKE. BT3 IDENTIFIED BY COLORED PLASTIC CAP BEARING SURVEYORS PROFESSIONAL NUMBER.
■ STAKING OF PROPOSED RIGHT OF WAY. SET DIVISION OF HIGHWAYS SURVEY MARKER TO MONUMENT THE POSITION SHOWN. IDENTIFIED BY INSCRIPTION DATA AND SURVEYORS PROFESSIONAL NUMBER.
■M STAKING OF PROPOSED RIGHT OF WAY IN CULTIVATED AREAS. BURIED 5/8 INCH REBAR 20 INCHES BELOW GROUND TO MARK FUTURE SURVEY MARKER POSITION. IDENTIFIED BY COLORED PLASTIC CAP BEARING SURVEYORS PROFESSIONAL NUMBER.
PERMANENT SURVEY MARKER. IDOT STD. 2135 (TO BE SET BY OTHERS)
□ RIGHT OF WAY STAKING PROPOSED TO BE SET.
ATE OF ILLINOIS) ) SS JNTY OF DUPAGE)
S IS TO CERTIFY THAT WE, MIDWEST TECHNICAL CONSULTANTS, INC., AN ILLINOIS PROFESSIONAL SIGN FIRM NUMBER 184-002917, HAVE SURVEYED THE PLAT OF HICHWAYS SHOWN HEREON TWEEN SECTION 15, TOWNSHIP 38 NORTH, RANGE 9 EAST, AND SECTION 16, TOWNSHIP 38 NORTH, NGE 9 EAST OF THE THRD PRINCIPAL MERIDIAN, DUPAGE COUNTY, THAT THE SURVEY IS TRUE D COMPLETE AS SHOWN TO THE BEST OF MY KNOWLEDGE AND BELIEF, THAT THE PLAT RECITLY REPRESENTS SAID SURVEY, THAT LL MONUMENTS FOUND AND ESTABLISHED ARE OF RWANENT QUALITY AND OCCUPY THE POSITIONS SHOWN THEREON AND THAT THE MONUMENTS E SUFFICIENT OF EARLE THE SURVEY TO BE RETRACED. THIS SURVEY CONFORMS TO THE RENULLINDIS MINIMUM STANDARDS FOR A BOUNDARY SURVEY. MADE FOR THE DEPARTMENT
TRANSPORTATION, STATE OF ILLINOIS. TED AT NAPERVILLE, ILLINOIS THIS DAY OF, 2011 A.D.
SSELL W. OLSEN INDIS PROFESSIONAL LAND SURVEYOR NO. 035-002718
ENSE EXPIRES NOVEMBER 30, 2012 S PROFESSIONAL SERVICE CONFORMS TO THE CURRENT ILLINOIS MINIMUM STANDARDS FOR A JNDARY SURVEY. Midwest Technical Consultants, Inc. 1805 N. MILL STREET, SUITE L
OTES: NODER VIIIE, ILLINUS BOSS (630)55-000 ) ALL COORDINATES SHOWN HEREON ARE PROJECT. ALL DISTANCES SHOWN HEREON ARE
ROUND. ) BEARINGS SHOWN HEREON ARE BASED ON ILLINOIS STATE PLANE COORDINATE SYSTEM EAST
DNE, NAD 83, (2007). ) THE COMBINATION FACTOR USED FOR THIS PROJECT = 0.99994777.
) COORDINATE CONVERSION
AD83 (2007) STATE PLANE COORDINATES TO PROJECT COORDINATES: A) DIVIDE THE STATE PLANE NAD83 GRID COORDINATES BY THE COMBINATION FACTOR. B) SUBTRACT 1,000,000.00 FROM THESE NORTHINGS AND EASTINGS. NOV 0.4 2011
ROJECT COORDINATES TO NAD83 (2007) STATE PLANE COORDINATES: PLATS & LEGALS A) ADD 1,000,000.00 TO THE PROJECT NORTHINGS AND EASTINGS. B) MULTIPLY THESE COORDINATES BY THE COMBINATION FACTOR.
) THE NGS MONUMENT HELD FOR THIS PROJECT IS IS FIRST ORDER P.I.D. AA3730.
PLAT OF HIGHWAYS         STATE OF ILLINOIS         DEPARTMENT OF TRANSPORTATION
F.A.P. 338 ILLINOIS ROUTE 59 SECTION: FERRY RD. TO AURORA AVE. DUPAGE COUNTY
Resp. 225,1449         PROJECT: ROUTE 59         JOB NO. R-91-035-09           K. 869,425,1449         STATION 3944+67.58         TO STATION 3949+50           S. STATION 100+00         TO STATION 108+20           SCALE:         I" = 40'         SHEET IB OF 47           T 553 OF 1156         Image: State of the s
T 553 OF 1156 물 BUREAU OF LAND ACQUISITION 201 WEST CENTER COURT 3 SCHAUMBURG, ILLINOIS 60196-1096

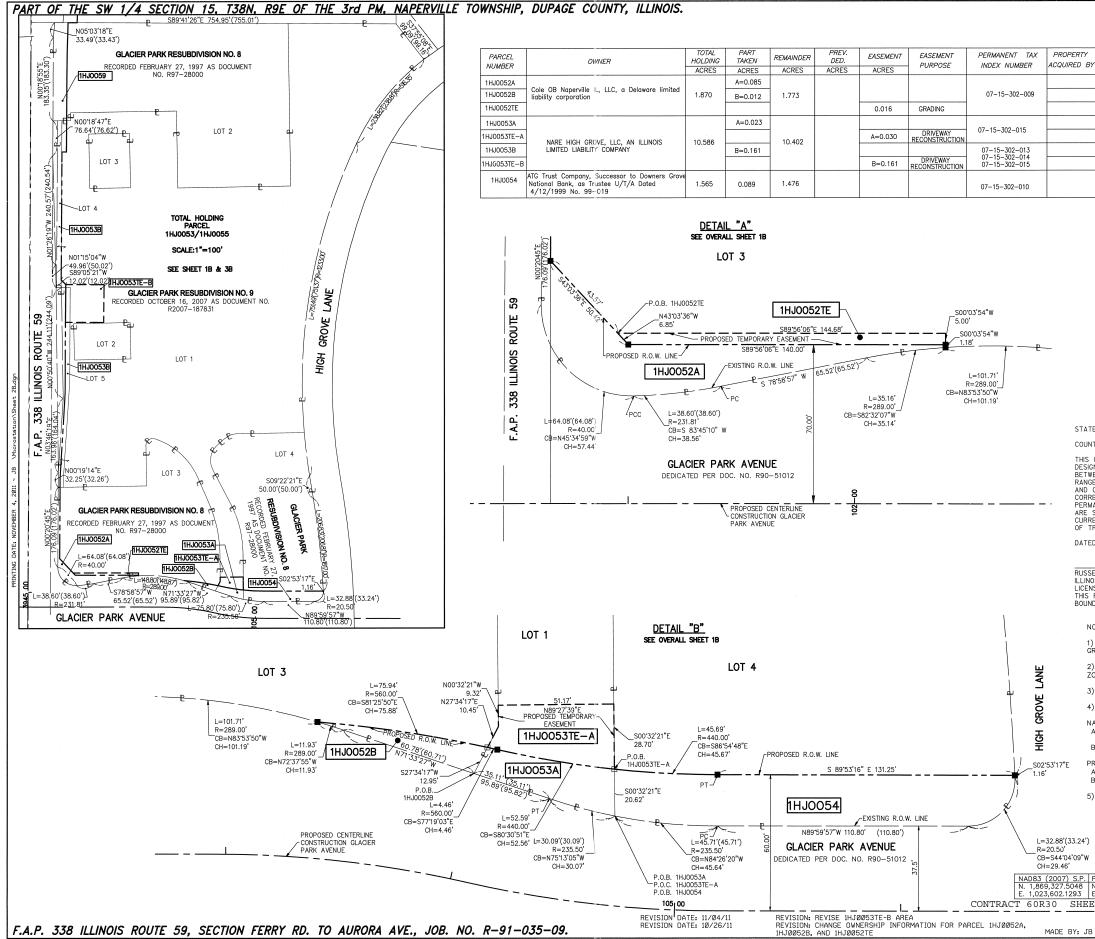

LEGEND					
(9 10) SECTION CORNER (16 15) SECTION CORNER					
BY     SECTION LINE     Number of the section line       ULARTER SECTION LINE     OUARTER SECTION LINE       PLATTED LOT LINE     PLATTED LOT LINE       PLATTED LOT LINE     APPARENT PROPERTY LINE       APL     APPARENT PROPERTY LINE       CENTERLINE     CENTERLINE       PROPERTY GEED LINE     CENTERLINE					
APL APPARENT PROPERTY LINE CENTERLINE CENTERLINE CENTERLINE CENTERLINE EXISTING RIGHT OF WAY LINE PROPOSED RIGHT OF WAY LINE PROPOSED RASEMENT EXISTING ACCESS CONTROL LINE PROPOSED CASEMENT () RECORD DATA CENTERLINE CENT					
SCALE : 1" = 20'         IRON PIPE OR ROD FOUND       O       SET 5/8" × 30" REBAR         CUT CROSS FOUND OR SET       •PK FOUND PK NAIL       OPK SET PK NAIL         TI       THESE STAKES REFERENCE FOUND OR SET MONUMENTATION.					
<ul> <li>T2 SET 5/8 INCH REBAR FLUSH WITH GROUND TO TIE FOUND IRON STAKE. IDENTIFIED</li> <li>T3 BY COLORED PLASTIC CAP AND BEARING SURVEYORS PROFESSIONAL NUMBER.</li> <li>BTI THESE STAKES, IN CULTIVATED AREAS, REFERENCE FOUND OR SET MONUMENTATION.</li> </ul>					
BT2 BURIED 5\8 INCH REBAR 20 INCHES BELOW GROUND TO TIE FOUND IRON STAKE. BT3 IDENTIFIED BY COLORED PLASTIC CAP BEARING SURVEYORS PROFESSIONAL NUMBER.					
■ STAKING OF PROPOSED RIGHT OF WAY. SET DIVISION OF HIGHWAYS SURVEY MARKER TO MONUMENT THE POSITION SHOWN. IDENTIFIED BY INSCRIPTION DATA AND SURVEYORS PROFESSIONAL NUMBER.					
■M STAKING OF PROPOSED RIGHT OF WAY IN CULTIVATED AREAS. BURIED 5/8 INCH REBAR 20 INCHES BELOW GROUND TO MARK FUTURE SURVEY MARKER POSITION. IDENTIFIED BY COLORED PLASTIC CAP BEARING SURVEYORS PROFESSIONAL NUMBER.					
● PERMANENT SURVEY MARKER, IDOT STD. 2135 (TO BE SET BY OTHERS)					
□ RIGHT OF WAY STAKING PROPOSED TO BE SET. TE OF ILLINOIS)					
) SS NTY OF DUPAGE)					
IS TO CERTIFY THAT WE, MIDWEST TECHNICAL CONSULTANTS, INC., AN ILLINOIS PROFESSIONAL GR FIRM NUMBER 184-002917, HAVE SURVEYED THE PLAT OF HIGHWAYS SHOWN HEREON WEEN SECTION 15, TOWNSHIP 38 NORTH, RANCE 9 EAST, AND SECTION 16, TOWNSHIP 38 NORTH, GE 9 EAST OF THE THIRD PRINCIPAL MERDIAN DUPAGE COUNTY, THAT THE SURVEY IS TRUE COMPLETE AS SHOWN TO THE BEST OF MY KNOWLEDGE AND BELIEF, THAT THE PLAT RECTLY REPRESENTS SAID SURVEY, THAT ALL MONUMENTS FOUND AND ESTABLISHED ARE OF MANENT QUALITY AND OCCUPY THE POSITIONS SHOWN THEREON AND THAT THE MONUMENTS SUFFICIENT TO ENABLE THE SURVEY TO BE RETRACED. THIS SURVEY CONFORMS TO THE RENT ILLINOIS MINMUM STANDARDS FOR A BOUNDARY SURVEY. MADE FOR THE DEPARTMENT TRANSPORTATION, STATE OF ILLINOIS.					
ED AT NAPERVILLE, ILLINOIS THIS DAY OF, 2011 A.D.					
SELL W. OLSEN IOIS PROFESSIONAL LAND SURVEYOR NO. 035-002718 NSE EXPIRES NOVEMBER 30, 2012 PROFESSIONAL SERVICE CONFORMS TO THE CURRENT ILLINOIS MINIMUM STANDARDS FOR A					
NDARY SURVEY. <i>Midwest Technical Consultants, Inc.</i> 1805 N. MILL STREET, SUITE L NOTES: Naperville, ILLINOIS 60563					
(630)505-0101 ) ALL COORDINATES SHOWN HEREON ARE PROJECT. ALL DISTANCES SHOWN HEREON ARE					
SROUND. 2) BEARINGS SHOWN HEREON ARE BASED ON ILLINOIS STATE PLANE COORDINATE SYSTEM EAST 20NE, NAD 83, (2007).					
<ol> <li>THE COMBINATION FACTOR USED FOR THIS PROJECT = 0.99994777.</li> </ol>					
4) COORDINATE CONVERSION					
ADB3 (2007) STATE PLANE COORDINATES TO PROJECT COORDINATES: A) DIVIDE THE STATE PLANE NADB3 GRID COORDINATES BY THE COMBINATION FACTOR. B) SUBTRACT 1,000,000.00 FROM THESE NORTHINGS AND EASTINGS. NOV 0 4 2011					
PROJECT COORDINATES TO NAD83 (2007) STATE PLANE COORDINATES: A) ADD 1,000,000.00 TO THE PROJECT NORTHINGS AND EASTINGS. B) MULTIPLY THESE COORDINATES BY THE COMBINATION FACTOR.					
5) THE NGS MONUMENT HELD FOR THIS PROJECT IS IS FIRST ORDER P.I.D. AA3730.					
PLAT OF HIGHWAYS STATE OF ILLINOIS DEPARTMENT OF TRANSPORTATION					
ECTION: FERRY RD. TO AURORA AVE. DUPAGE COUNTY PROJECT: ROUTE 59 JOB NO. R-91-035-09					
PROJECT (GROUND)         S           N. 869,425.1449         5           E. 23,655.5948         SCALE:           I'' = 20'         SHEET           2B         OF					
B SCHAUMBURG, ILLINOIS 60196-1096					

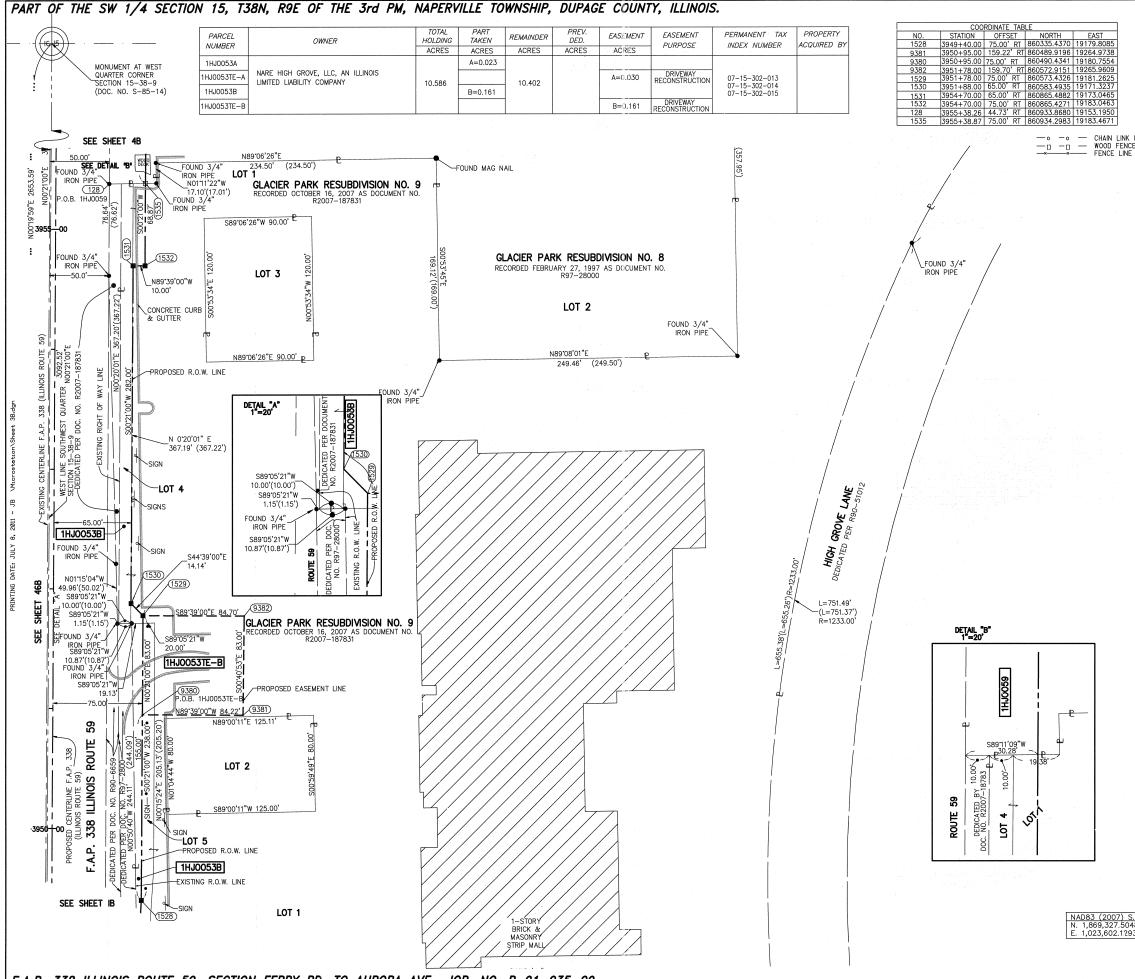


F.A.P. 338 ILLINOIS ROUTE 59, SECTION FERRY RD. TO AURORA AVE., JOB. NO. R-91-035-09.

REVISION DATE: JULY 8, 2011 REVISION: REVISE 1HJ0053TE-B


MADE BY: JB

		LE	GEND			
	9 10 16 15 SECTIO		- (16 15)	QUARTER SECTION CORNER	LLINOIS SYSTEM 37)	
 	Q	ECTION LINE UARTER SECTION LINE UARTER, QUARTER SE( LATTED LOT LINE ROPERTY (DEED) LINE	CTION LINE	N	RE BASED ON ILLINOIS VE COORDINATE SYSTE N.A.D. 83 (2007)	
	APL A C P P AC P	PPARENT PROPERTY L ENTERLINE XISTING RIGHT OF WAY ROPOSED RIGHT OF W/ ROPOSED ASSEMENT XISTING ACCESS CONTI ROPOSED ACCESS CON ECORD DATA	LINE AY LINE ROL LINE		BEARNGS ARE STATE PLANE ( EAST ZONE, N.	
	mmm	XISTING BUILDING	0	<b>4</b> 0 ε	120	
			<u></u>	SCALE : 1" =	40'	
● +	IRON PIPE OR CUT CROSS FO		O SET 5/	8" × 30" REBAF PK NAIL OF	R PK SET PK NAIL	
• TI T2 T3	SET 5/8 INCH	S REFERENCE FOUND REBAR FLUSH WITH PLASTIC CAP AND	GROUND TO TH	E FOUND IRON S	STAKE. IDENTIFIED SIONAL NUMBER.	
<ul> <li>BTI BT2 BT3</li> </ul>	2 BURIED 5\8 II	, IN CULTIVATED AR NCH REBAR 20 INCH COLORED PLASTIC	ES BELOW GROU	JND TO TIE FO	UND IRON STAKE.	
	SET DIVISION	ROPOSED RIGHT OF OF HIGHWAYS SURVE INSCRIPTION DATA	EY MARKER TO M			
• <b>■</b> M		ROPOSED RIGHT OF NCH REBAR 20 INC TION, IDENTIFIED B' NUMBER.			FUTURE SURVEY RING SURVEYORS	
	PERMANENT S	URVEY MARKER. IDO	T STD. 2135 (TO	BE SET BY OT	HERS)	
		STAKING PROPOSED	) TO BE SET.			
STATE OF ILLI	) SS					
THIS IS TO CERTIFY THAT WE, MIDWEST TECHNICAL CONSULTANTS, INC., AN ILLINOIS PROFESSIONAL DESIGN FIRM NUMBER 184-002917, HAVE SURVEYED THE PLAT OF HICHWAYS SHOWN HEREON BETWEEN SECTION IS, TOWNSHIP 38 NORTH, RANGE 9 EAST, AND SECTION IG, TOWNSHIP 38 NORTH, RANGE 9 EAST, AND SECTION IG, TOWNSHIP 38 NORTH, AND COMPLETE AS SHOWN TO THE BEST OF MY KNOWLEDGE AND BELIEF, THAT THE PLAT CORRECTLY REPRESENTS SAID SURVEY, THAT ALL MONUMENTS FOUND AND ESTABLISHED ARE OF PERMANENT OUALITY AND COCUPY THE POSITIONS SHOWN THEREON AND THAT THE MONUMENTS ARE SUFFICIENT TO ENABLE THE SURVEY TO BE RETRACED. THIS SURVEY CONFORMS TO THE CURRENT ILLINOIS MINIMUM STANDARDS FOR A BOUNDARY SURVEY. MADE FOR THE DEPARTMENT OF TRANSPORTATION, STATE OF ILLINOIS.						
DATED AT NA	PERVILLE, ILLINO	IS THIS DAY	OF	, 2011 A.D.		
RUSSELL W. OLSEN ILLINOIS PROFESSIONAL LAND SURVEYOR NO. 035-002718 LICENSE EXPIRES NOVEMBER 30, 2012 THIS PROFESSIONAL SERVICE CONFORMS TO THE CURRENT ILLINOIS MINIMUM STANDARDS FOR A BOUNDARY SURVEY. Midwest Technical Consultants, Inc. 1805 N. MILL STREET, SUITE L NOTES.						
1) ALL COOF GROUND.	RDINATES SHOW	(630)505-01 N HEREON ARE PRO		NCES SHOWN H	EREON ARE	
		N ARE BASED ON I	LINOIS STATE PI	LANE COORDINA	TE SYSTEM EAST	
		OR USED FOR THIS F	PROJECT = 0.999	994777.		
<ul> <li>4) COORDINATE CONVERSION</li> <li>NADB3 (2007) STATE PLANE COORDINATES TO PROJECT COORDINATES:</li> <li>A) DIVIDE THE STATE PLANE NADB3 GRID COORDINATES BY THE COMBINATION FACTOR.</li> <li>B) SUBTRACT 1,000,000.00 FROM THESE NORTHINGS AND EASTINGS.</li> <li>JUL 14 2011</li> </ul>						
PROJECT COORDINATES TO NAD83 (2007) STATE PLANE COORDINATES: A) ADD 1,000,000.00 TO THE PROJECT NORTHINGS AND EASTINGS. B) MULTIPLY THESE COORDINATES BY THE COMBINATION FACTOR.						
5) THE NGS	MONUMENT HEL	D FOR THIS PROJEC				
	7h_17	DEPARI		HIGHWAYS F ILLINOIS TRANSPOR		
	NUC	F.A.	P. 338 ILLI	NOIS ROUT	E 59	
.P. PROJECT ( 18 N. 869,425 3 E. 23,655.5	GROUND)	SECTION: FERRY	9+50	JOB NO. To sta	PAGE COUNTY R-91-035-09 FION 3955+50	
	5948	SCALE:  " =	40' BUREAU OF LA		<u>3B_</u> OF <u>47</u>	
				ENTER COURT		

CONTRACT 60R30 SHEET 555 OF 1156

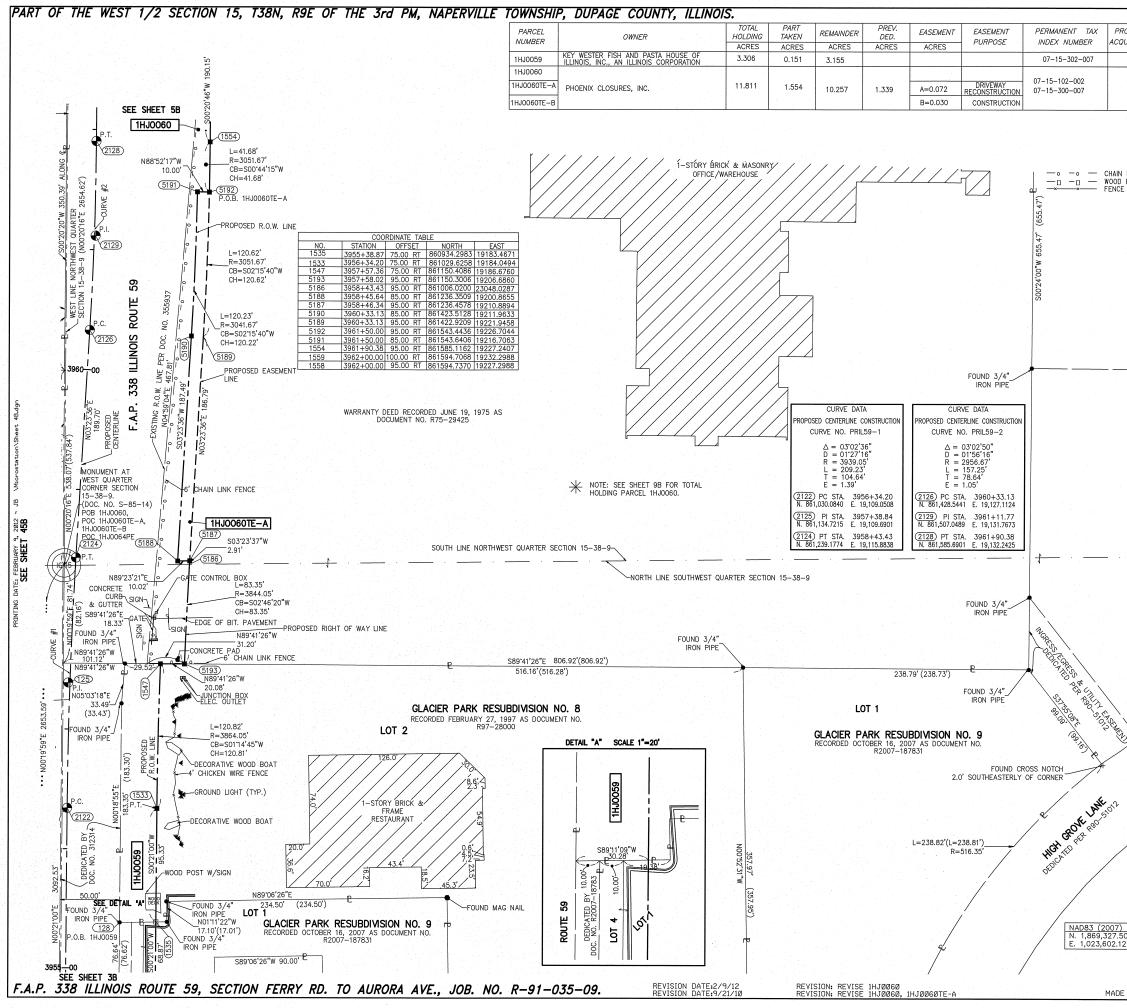


OPERTY JIRED BY	LEGEND	
- (9 10) - CORNER		GUARTER SIGUATION SIGUATIO
	CTION LINE ARTER, SECTION LINE ARTER, QUARTER SECTION LINE ATTED LOT LINE OPERTY (DEED) LINE PARENT PROPERTY LINE ISTING CENTERLINE OPOSED CANTERLINE ISTING RIGHT OF WAY LINE OPOSED RIGHT OF WAY LINE OPOSED RIGHT OF WAY LINE OPOSED ACSEMENT ISTING ACCESS CONTROL LINE OPOSED ACCESS CONTROL LINE OPOSED ACCESS CONTROL LINE CORD DATA	BEARINGS ARE BASED ON ILLINOIS STATE PLANE COORDINATE SYSTEM EAST ZONE, N.A.D. 83 (2007)
7/////////	ISTING BUILDING O	40 80 120
		SCALE : 1" = 40'
<ul> <li>IRON PIPE OR F</li> <li>CUT CROSS FO</li> <li>TI THESE STAKES</li> <li>T2 SET 5/8 INCH</li> <li>T3 BY COLORED F</li> </ul>	UND OR SET ●PK FOU REFERENCE FOUND OR SET MC	5/8" × 30" REBAR IND PK NAIL OPK SET PK NAIL NUMENTATION. D TIE FOUND IRON STAKE, IDENTIFIED URVEYORS PROFESSIONAL NUMBER.
BT2 BURIED 5\8 IN	CH REBAR 20 INCHES BELOW (	NCE FOUND OR SET MONUMENTATION. ROUND TO THE FOUND HRON STAKE. SURVEYORS PROFESSIONAL NUMBER.
SET DIVISION O	OPOSED RIGHT OF WAY. F HIGHWAYS SURVEY MARKER T NSCRIPTION DATA AND SURVEYO	TO MONUMENT THE POSITION SHOWN. DRS PROFESSIONAL NUMBER.
BURIED 5/8 IN	ION. IDENTIFIED BY COLORED	TIVATED AREAS. GROUND TO MARK FUTURE SURVEY PLASTIC CAP BEARING SURVEYORS
PERMANENT SU	RVEY MARKER. IDOT STD. 2135	(TO BE SET BY OTHERS)
RIGHT OF WAY STATE OF ILLINOIS) ) SS	STAKING PROPOSED TO BE SET	
DESIGN FIRM NUMBER 184-00291 BETWEEN SECTION 15, TOWNSHIF RANGE 9 EAST OF THE THIRD AND COMPLETE AS SHOWN TO CORRECTLY REPRESENTS SAID PERMANENT QUALITY AND OCCL	7, HAVE SURVEYED THE PLAT > 38 NORTH, RANGE 9 EAST, A PRINCIPAL MERIDIAN, DUPAGE C THE BEST OF MY KNOWLEDGE , SURVEY, THAT ALL MONUMENTS IPY THE POSITIONS SHOWN THEF IE SURVEY TO BE RETRACED, NDARDS FOR A BOUNDARY SURV F ILLINOIS,	NTS, INC., AN ILLINOIS PROFESSIONAL OF HIGHWAYS SHOWN HEREON ND SECTION IG, TOWNSHIP 38 NORTH, JUNTY, THAT THE SURVEY IS TRUE AND BELIEF, THAT THE PLAT FOUND AND ESTABLISHED ARE OF REON AND THAT THE MONUMENTS THIS SURVEY CONFORMS TO THE YEY. MADE FOR THE DEPARTMENT , 2010 A.D.
BOUNDARY SURVEY. Mic	, 2012	L
NOTES:	(630)505-0101 IEREON ARE PROJECT. ALL DIS	
GROUND.		PLANE COORDINATE SYSTEM FAST
ZÓNE, NAD 83, (2007).	USED FOR THIS PROJECT = $0.5$	
4) COORDINATE CONVERSION	0.3ED FOR THIS PROJECT = 0.5	<i>33334777</i> .
<ul> <li>A) DIVIDE THE STATE PLANE COMBINATION FACTOR.</li> </ul>	COORDINATES TO PROJECT COOP NAD83 GRID COORDINATES BY ROM THESE NORTHINGS AND EA	THE #EB 1 4 2012
A) ADD 1,000,000.00 TO THE B) MULTIPLY THESE COORDIN	083 (2007) STATE PLANE COOF PROJECT NORTHINGS AND EAS ATES BY THE COMBINATION FAC	ITINGS. STOR.
5) THE NGS MONOMENT HELD	FOR THIS PROJECT IS IS FIRST	F HIGHWAYS
DGN. #4B-47	STATE DEPARTMENT O	OF ILLINOIS F TRANSPORTATION LLINOIS ROUTE 59
S.P. PROJECT (GROUND)	PROJECT: ROUTE 59 STATION 3955+00	ORA AVE. DUPAGE COUNTY JOB NO. R-91-035-09 TO STATION 3962+00
148 N. 869,425,1449 5. 93 E. 23,655,5948	SCALE: I" = 40' BURFAU OF	SHEET <u>4B</u> OF <u>47</u>
# BY: JB	201 WEST	LAND ACCOUSTION T CENTER COURT ILLINOIS 60196-1096
	CONTRACT 60R	

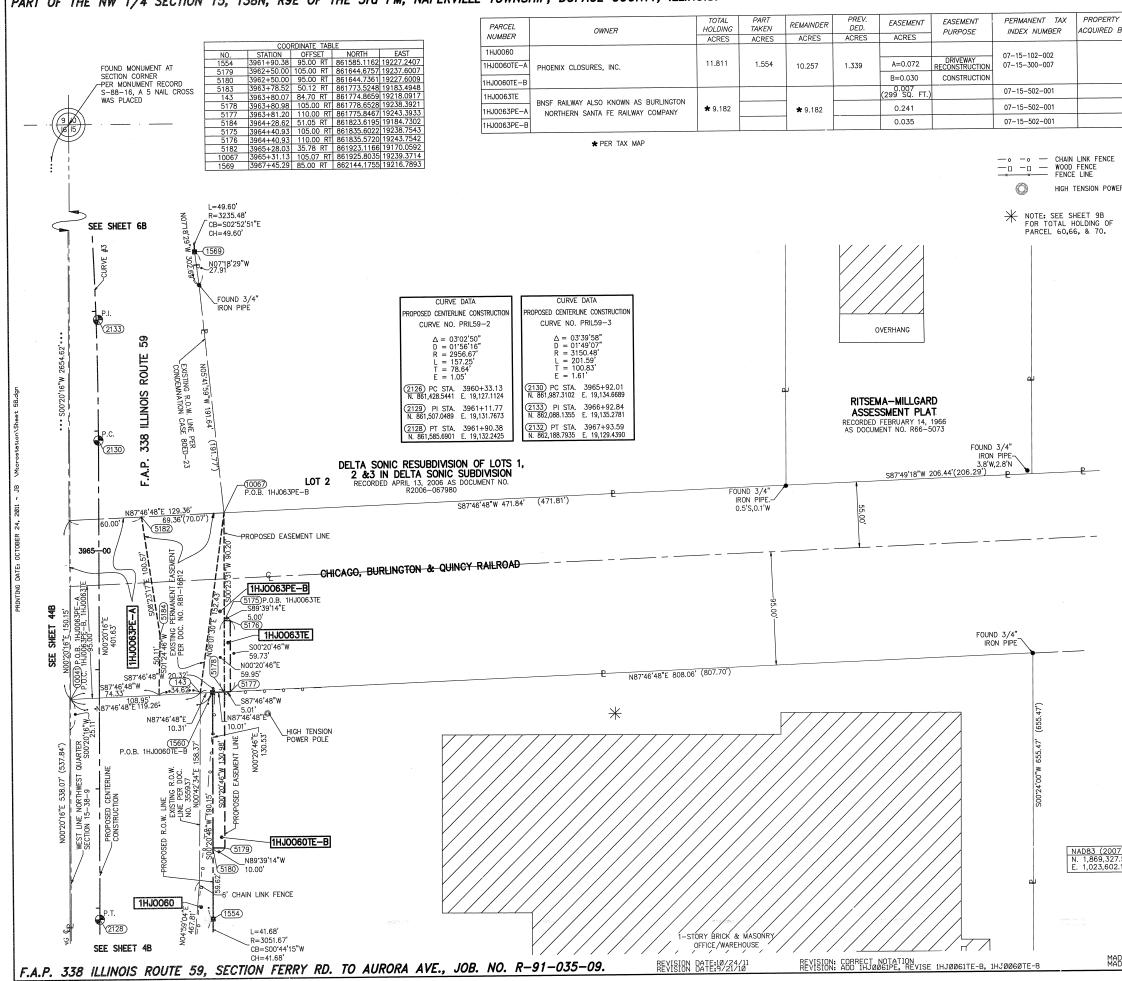


## PART OF THE NW 1/4 SECTION 15, T38N, R9E OF THE 3rd PM, NAPERVILLE TOWNSHIP, DUPAGE COUNTY, ILLINOIS.


		LE	BEND		
	SECTION CORNER		- (16 15)	QUARTER SECTION CORNER	SYSTEM 57) 37)
	OUAR            PLAT            PLAT            APPA            PROP            PROP            PROP           AC	ION LINE TER, SECTION LINE TER, QUARTER SECT TED LOT LINE ERTY (DEED) LINE RENT PROPERTY LIN ING CENTERLINE OSED CENTERLINE OSED RIGHT OF WAY OSED ACCESS CONTR OSED ACCESS CONTR OSED ACCESS CONT RD DATA	INE LINE V LINE OL LINE		BEARNOS ARE BASED ON ILLINOIS STATE PLANE COORDINATE SYSTE EAST ZONE, N.A.D. 83 (2007)
R POLE	EXIS	TING BUILDING	0	40 80	) 120
				CALE : 1" = × 30" REBAR	40'
• +	IRON PIPE OR RO CUT CROSS FOUN		O SET 5/8" PK FOUND PH		K SET PK NAIL
• TI T2 T3	SET 5/8 INCH RE	REFERENCE FOUND EBAR FLUSH WITH ASTIC CAP AND	GROUND TO THE	FOUND IRON S	TAKE. IDENTIFIED SIONAL NUMBER.
<ul> <li>BTI BT2 BT3</li> </ul>	BURIED 518 INCH	N CULTIVATED ARE I REBAR 20 INCH DLORED PLASTIC C	ES BELOW GROUN	ID TO TIE FOU	IND IRON STAKE.
	SET DIVISION OF	POSED RIGHT OF HIGHWAYS SURVE SCRIPTION DATA 4	Y MARKER TO MO	NUMENT THE PROFESSIONAL I	POSITION SHOWN. NUMBER.
M	BURIED 5/8 INC	POSED RIGHT OF H REBAR 20 INCH NN. IDENTIFIED BY UMBER.	HES BELOW GROU	ND TO MARK	FUTURE SURVEY RING SURVEYORS
•	PERMANENT SUR	VEY MARKER. IDOT	T STD. 2135 (TO E	BE SET BY OT	HERS)
		STAKING PROPOSED	TO BE SET.		
STATE OF ILLINOI COUNTY OF DUPA	) SS				5.
DESIGN FIRM NUM BETWEEN SECTION RANGE 9 EAST O AND COMPLETE A CORRECTLY REPR PERMANENT QUAL ARE SUFFICIENT CURRENT ILLINOIS OF TRANSPORTAT	BER 184-002917, F N 15, TOWNSHIP 38 F THE THIRD PRIN S SHOWN TO THE ESENTS SAID SUR ITY AND OCCUPY TO ENABLE THE S MINIMUM STANDA ION, STATE OF IL	WEST TECHNICAL HAVE SURVEYED T SINORTH, RANGE S (CIPAL MERIDIAN, I BEST OF MY KN VEY, THAT ALL M THE POSITIONS SI UNIVEY TO BE RE RDS FOR A BOUNI LINOIS. HIS DAY O	HE PLAT OF HIGH 3 EAST, AND SEC DUPACE COUNTY, OWLEDGE AND BEI IONUMENTS FOUND HOWN THEREON AI TRACED. THIS SI DARY SURVEY. M	WATS SHOWN F TION 16, TOWNS THAT THE SUM LIEF, THAT THE AND ESTABLIS ND THAT THE URVEY CONFOR MADE FOR THE	PROFESSIONAL TEREON SHIP 38 NORTH, IVEY IS TRUE E PLAT SHED ARE OF MONUMENTS MS TO THE DEPARTMENT
	IONAL LAND SURV	EYOR NO. 035-00	12718		
THIS PROFESSION BOUNDARY SURVE		orms to the cui est Technical Co		NIMUM STANDAI	RDS FOR A
NOTES:	18	05 N. MILL STREE Naperville, ILLINO (630)505-0	ET, SUITE L IS 60563		
1) ALL COORI	DINATES SHOWN H	IEREON ARE PROJ		CES SHOWN HE	REON ARE
GROUND. 2) BEARINGS	SHOWN HEREON	ARE BASED ON IL	LINOIS STATE PLA	NE COORDINAT	E SYSTEM EAST
ZONE, NAD 8		USED FOR THIS P	ROJECT = 0.9999	4777.	
,	TE CONVERSION				
A) DIVIDE TI COMBINA	HE STATE PLANE	COORDINATES TO F NAD83 GRID COOF ROM THESE NORTI	RDINATES BY THE	NGS.	
PROJECT COO A) ADD 1,00	DRDINATES TO NAI DO,000.00 TO THE	D83 (2007) STATE PROJECT NORTHI ATES BY THE COM	E PLANE COORDIN	ATES: GS. <b>PLA</b>	CT 2 4 2011 TS & LEGALS
5) THE NGS	MONUMENT HELD	FOR THIS PROJEC	T IS IS FIRST OR	DER P.I.D. AA3	730.
) S.P. PROJECT (G 5048 N. 869,425, 1293 E. 23,655.5	1449 948 85 NG	F.A. SECTION: FERRY PROJECT: RC		TRANSPOI TRANSPOI NOIS ROUT AVE. DU JOB NO.	<b>RTATION</b> <b>TE 59</b> PAGE COUNTY R-91-035-09
	I35-09	STATION 396		TO STA SHEET	TION 3967+50 <u>5B</u> OF <u>47</u>
	#R-9I-035-09	SCALE: I" =	BUREAU OF LA	ND ACQUISITIO	 DN
E BY: TL E BY: JB	# 80f	S	201 WEST C CHAUMBURG, ILL	ENTER COURT INOIS 60196-	
•0		CONTE	RACT 60R30	SHEET	557 OF 1156

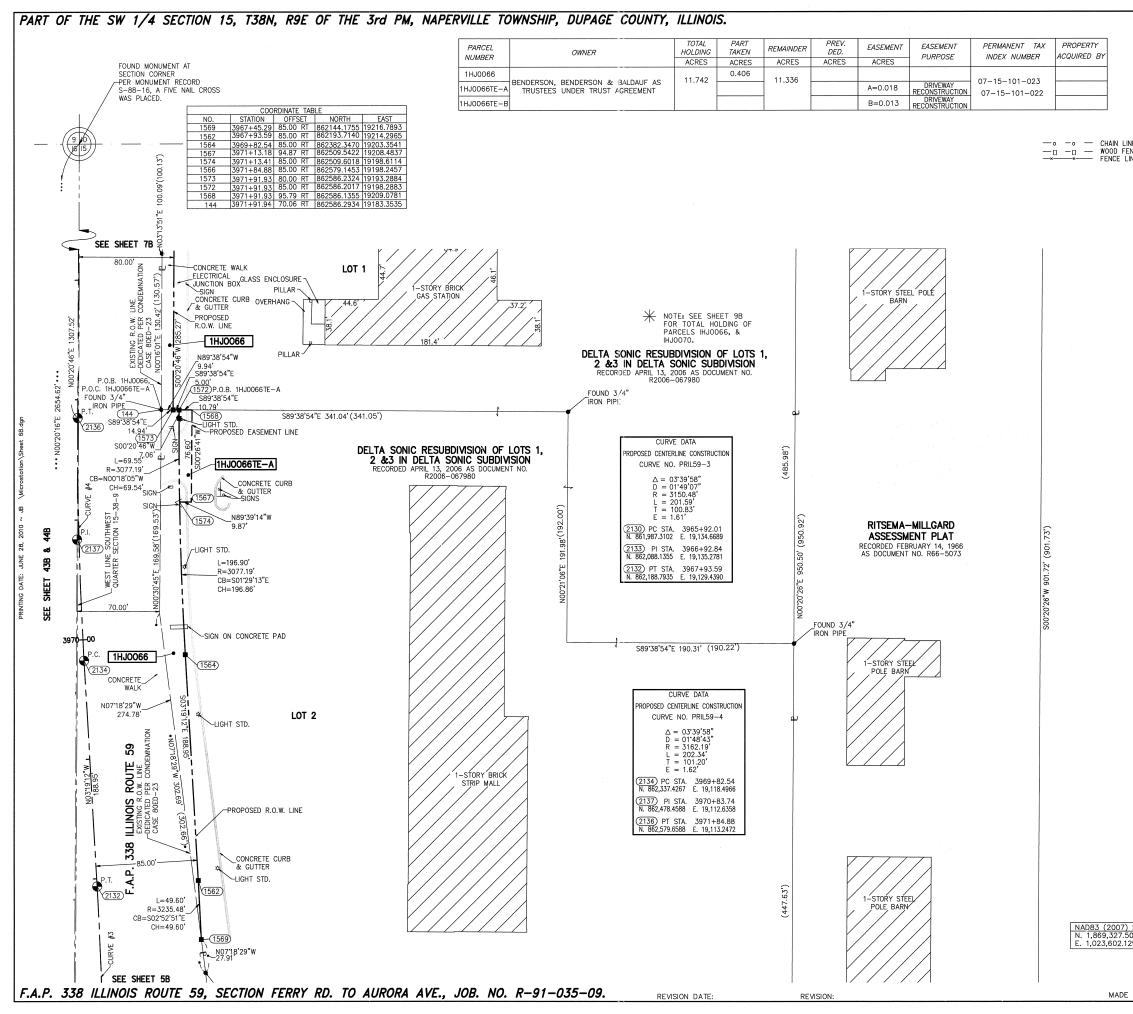

		LE	GEND	· .		
	SECTION 515 CORNER			QUARTER - SECTION CORNER	ON ILLINOIS NATE SYSTEM 3 (2007)	
	QU QU PL	CTION LINE ARTER SECTION LINE ARTER, QUARTER SEC ATTED LOT LINE DPERTY (DEED) LINE	TION LINE	N	BASED COORDI	
K FENCE	APL AP CE EX PR APL AP CE EX PR	PARENT PROPERTY LI VTERLINE STING RIGHT OF WAY DPOSED RIGHT OF WA DPOSED EASEMENT STING ACCESS CONTR	LINE Y LINE		BEARINGS ARE E STATE PLANE C EAST ZONE, N.A	
	-AC PR ) RE	DPOSED ACCESS CONT CORD DATA	ROL LINE	A		
				40 8 CALE : 1" =	30 1 40'	120
•	IRON PIPE OR F		O SET 5/8"	× 30" REBAF	2	
• TI T2 T3	THESE STAKES	REFERENCE FOUND REBAR FLUSH WITH PLASTIC CAP AND	PK FOUND PK     OR SET MONUMEN     GROUND TO TIE I     BEARING SURVEY	TATION.	PK SET PK N. STAKE. IDENT SIONAL NUM	
BTI     BT2     BT3	BURIED 5\8 IN	IN CULTIVATED ARE CH REBAR 20 INCHI COLORED PLASTIC C	ES BELOW GROUND	D TO TIE FO	UND IRON ST	TAKE.
	SET DIVISION O	OPOSED RIGHT OF F HIGHWAYS SURVE NSCRIPTION DATA A	Y MARKER TO MO			IOWN.
M	BURIED 5/8 IN	OPOSED RIGHT OF CH REBAR 20 INCH ON. IDENTIFIED BY NUMBER.	ES BELOW GROUN	D TO MARK	FUTURE SUF	RVEY YORS
•	PERMANENT SU	RVEY MARKER. IDOT	STD. 2135 (TO B	E SET BY OT	HERS)	
STATE OF ILLIN		STAKING PROPOSED	TO BE SET.			
COUNTY OF DUP	AGE)					
DESIGN FIRM LA HIGHWAYS SHOW SECTION IG, TOV COUNTY, THAT AND BELIEF, TH FOUND AND EST THEREON AND T THIS SURVEY CC MADE FOR THE	ND SURVEYING C N HEREON BETWE VNSHIP 38 NORTI THE SURVEY IS AT THE PLAT C ABLISHED ARE C HAT THE MONUM NAFORMS TO THE DEPARTMENT OF	MIDWEST TECHNICAL ORPORATION NUMBE IEN SECTION 15, TO 4, RANGE 9 EAST ( TRUE AND COMPLET TRECTLY REPRESE F PERMANENT QUAI ENTS ARE SUFFICIE CURRENT ILLINOIS TRANSPORTATION,	R IB4-002917, HAV WNSHIP 38 NORTH, DF THE THIRD PRI TE AS SHOWN TO NTS SAID SURVEY, ITY AND OCCUPY NT TO ENABLE TH MINIMUM STANDAF STATE OF ILLINOI	VE SURVEYED , RANGE 9 EA NCIPAL MERIDI THE BEST OF , THAT ALL M THE POSITION HE SURVEY T RDS FOR A BI S.	THE PLAT C IST, AND AN, DUPAGE MONUMENTS VS SHOWN O BE RETRAC OUNDARY SUF	DGE CED. RVEY.
		THIS DAY				
LICENSE EXPIRES	SIONAL LAND SL S NOVEMBER 30, NAL SERVICE CO	RVEYOR NO. 035-0 2010 NFORMS TO THE CL		INIMUM STAND	ARDS FOR A	
NOTES:	Midw	<b>est Technical Col</b> 1840 Centre Poin Naperville, ILLINOI: (630)505-01	t Circle 5 60563			
1) ALL COORE GROUND.	DINATES SHOWN	HEREON ARE PROJ		ES SHOWN HE	REON ARE	
2) BEARINGS ZONE, NAD 8		ARE BASED ON ILL	INOIS STATE PLAN	NE COORDINA	IE SYSTEM E	AST
·		USED FOR THIS PR	ROJECT = 0.99994	1777.		
, NAD83 (2007 A) DIVIDE TH		COORDINATES TO P NAD83 GRID COOR			ECEIVED	K
B) SUBTRAC PROJECT COO	T 1,000,000.00   RDINATES TO NA	FROM THESE NORTH D83 (2007) STATE E PROJECT NORTHIN	PLANE COORDINA	TES:	18 & LEGALS	;
		FOR THIS PROJECT		FR PID AA3	730	
o, me noo i			PLAT OF H	IGHWAYS	5	
	#6B-47	DEPART	STATE OF MENT OF T			
			P. 338 ILLIN RD. TO AURORA		<b>e 59</b> Page coun	ITY :
S.P. PROJECT (GR 048 N. 869,425.1 93 E. 23,655.59	ROUND)	PROJECT: ROL STATION 3967			R-91-035- TION 3973+	
	60-520-16-2	SCALE: I" =			<u>6B</u> 0F <u>4</u>	7
	UOB #R-		BUREAU OF LANI 201 WEST CEN	NTER COURT		
BY: JB	ې بې		ACT 60R30			1156

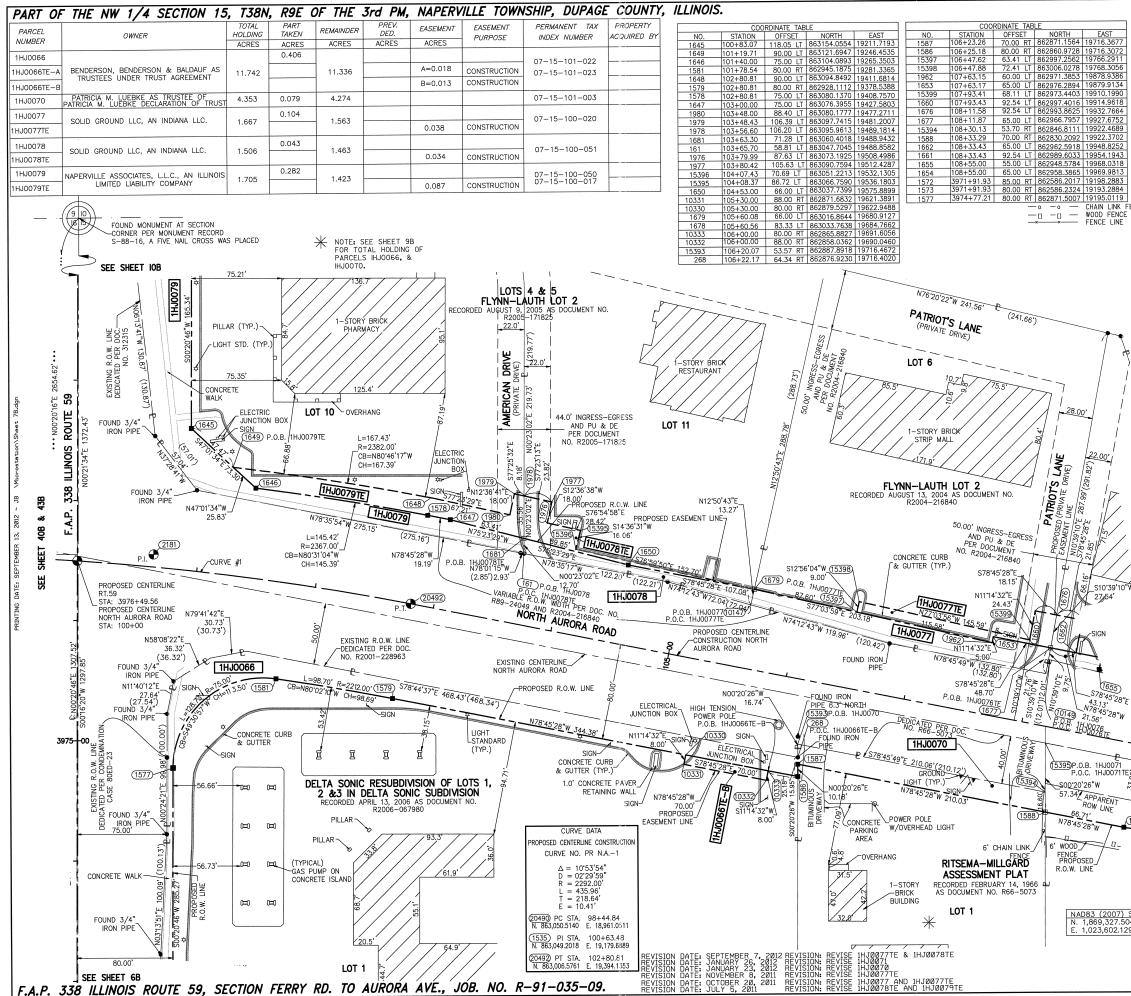


				LEGEND	-	
	6	- Tio SECT	TION			
		CORN		-((	16 15 SECTION CORNER	SYSTE SYSTE 37)
			SECTION LINE QUARTER SECTION QUARTER, QUARTER PLATTED LOT LINE PROPERTY (DEED)	R SECTION LINE	N	Z BASED ON ILLINOIS COORDINATE SYSTEM V.A.D. 83 (2007)
		APL	APPARENT PROPER CENTERLINE EXISTING RIGHT OF PROPOSED RIGHT ( PROPOSED EASEME EXISTING ACCESS	WAY LINE DF WAY LINE INT		BEARINGS ARE STATE PLANE ( EAST ZONE, N.
		AC	PROPOSED ACCESS RECORD DATA			
ENCE			EXISTING BUILDIN	G O	40	80 120
	•		R ROD FOUND	o se	<i>SCALE : 1"</i> T 5/8" × 30" REI	
	+		FOUND OR SET			OPK SET PK NAIL
	• TI T2 T3	SET 5/8 IN(	ES RÉFERENCE F CH REBAR FLUSH D PLASTIC CAP	WITH GROUND T	O TIE FOUND IRO	N STAKE. IDENTIFIED ESSIONAL NUMBER.
	BT2	BURIED 5\8	INCH REBAR 20	INCHES BELOW	GROUND TO TIE	SET MONUMENTATION. FOUND IRON STAKE. DFESSIONAL NUMBER.
		SET DIVISION		SURVEY MARKER	TO MONUMENT T YORS PROFESSION	HE POSITION SHOWN. AL NUMBER.
	M	BURIED 5/8	SITION. IDENTIFIE	INCHES BELOW	GROUND TO MA	RK FUTURE SURVEY EARING SURVEYORS
	Ð	PERMANENT	SURVEY MARKER	. IDOT STD. 2135	(TO BE SET BY	OTHERS)
			AY STAKING PROF	POSED TO BE SE	<b>T.</b>	
STATE C		) SS				
DESIGN F BETWEEN RANGE 9 AND CON CORRECT PERMANE ARE SUF CURRENT OF TRAN	FIRM NU SECTION EAST APLETE LY REF ENT QUA FICIENT ILLINO SPORTA	IMBER 184-00 ON 15, TOWNS OF THE THIF AS SHOWN 1 RESENTS SA ALITY AND OI TO ENABLE IS MINIMUM S ATION, STATE	2917, HAVE SURV SHIP 38 NORTH, F RD PRINCIPAL MEF TO THE BEST OF ID SURVEY, THAT CCUPY THE POSIT THE SURVEY TO THE SURVEY TO TANDARDS FOR /	EYED THE PLAT RANGE 9 EAST, A RIDIAN, DUPAGE C MY KNOWLEDGE ALL MONUMENT TIONS SHOWN THE BE RETRACED. A BOUNDARY SUF	OF HIGHWAYS SH AND SECTION 16, JOUNTY, THAT TH AND BELIEF, THA S FOUND AND ES EREON AND THAT THIS SURVEY CC RVEY. MADE FOR	E SURVEY IS TRUE T THE PLAT TABLISHED ARE OF THE MONUMENTS INFORMS TO THE THE DEPARTMENT
DATED 4	AT NAPE	ERVILLE, ILLI	NOIS THIS	DAY OF	, 2011 A	D.
LICENSE THIS PRI BOUNDAF	PROFES EXPIRE OFESSIO RY SUR	S NOVEMBER NAL SERVICE VEY: <b>Midwe</b> /8	) SURVEYOR NO. 30, 2012 CONFORMS TO <b>st Technical Co</b> 05 N. MILL STRE Naperville, ILLING	THE CURRENT ILL onsultants, Inc TET, SUITE L	.inois minimum st	ANDARDS FOR A
NOTES			(630)505-	0101	ISTANCES SHOWN	HEREON ARE
	ARINGS	SHOWN HERE 3, (2007).	ON ARE BASED	ON ILLINOIS STA	TE PLANE COORDI	NATE SYSTEM EAST
3) THE	Е СОМВ	INATION FAC	TOR USED FOR T	HIS PROJECT =	0.99994777.	
	(2007	TE CONVERSI	NE COORDINATES			
Ee/ <b>F</b> A) D	IVIDE TH OMBINA	HE STATE PL	ANE NAD83 GRID	COORDINATES B	Y THE	RECEIVED
а) а в) м	DD 1,00 ULTIPLY	0,000.00 TO THESE COO	NAD83 (2007) THE PROJECT N RDINATES BY THE	ORTHINGS AND E COMBINATION F	ASTINGS. ACTOR.	SEP 13 2012 W/ PLATS & LEGALS
5) THI	E NGS	MONUMENT H	ELD FOR THIS PF		ST ORDER P.I.D.	
048 N. 869	<u>CT (GR</u> 9,425.14 655.594	149	SECTION: I PROJECT	STATE PARTMENT F.A.P. 338 FERRY RD. TO A : ROUTE 59 3973+00 100+00	JOB TO S TO S	D/S PORTATION UTE 59 DUPAGE COUNTY NO. R-91-035-09 TATION 3979+00 TATION 108+50
			60 STATION STATION SCALE:		SHEE OF LAND ACQUIS	SITION
		MADE BY: J	and		G, ILLINOIS 6019	96-1096

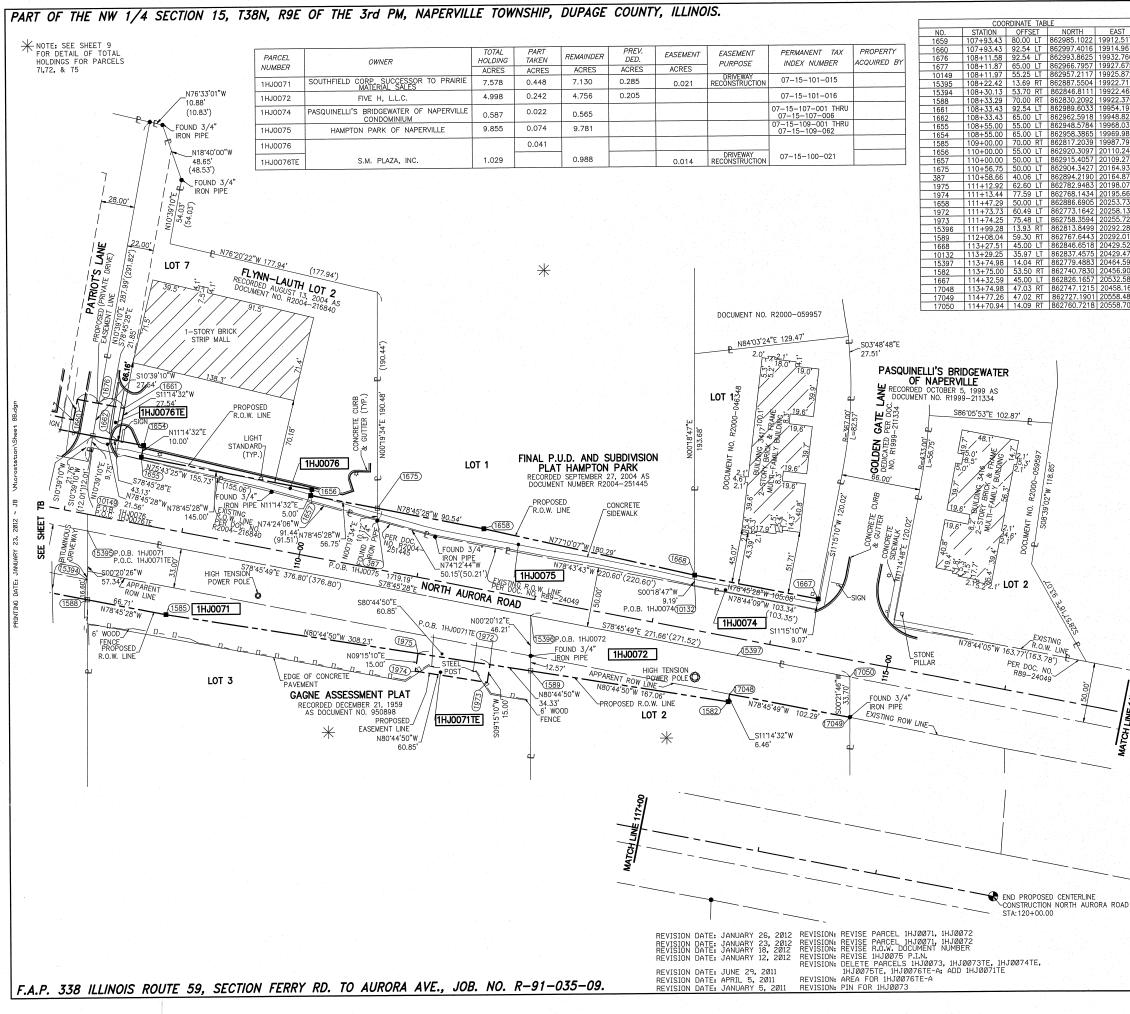


T I		
71 18 52 52 52 52 52 52 52 52 55 55		OUARTER WELS SECTION SIDES CORNER NULS CORNER NULS CORNER SIDES CORNER SIDES
25 QUAR 10 QUAR 89 PLAT	ION LINE TER SECTION LINE TER, QUARTER SECTION LINE TED LOT LINE ERTY (DEED) LINE	BASED ON COORDINAT A.D. 83 (2
18           CENT           13          EXIST            87          PROP         PROP           95          PROP         PROP         PROP           47           PROP         PROP           40           PROP         REC0           36           REC0         REC0	RENT PROPERTY LINE ERLINE ING RIGHT OF WAY LINE OSED RIGHT OF WAY LINE OSED EASEMENT ING ACCESS CONTROL LINE OSED ACCESS CONTROL LINE RD DATA	BEARINGS ARE STATE PLANE ( EAST ZONE, N.
17 85 EXIS		40 80 120
<u>00</u> — n — n — WOOD	E LINE D FOUND O SET 5/8	SCALE : 1" = 40' " × 30" REBAR "K NAIL OPK SET PK NAIL
12 79 11 12 79 11 12 72 5/8 INCH RI 73 BY COLORED PL	EFERENCE FOUND OR SET MONUME EBAR FLUSH WITH GROUND TO TIE ASTIC CAP AND BEARING SURVE	FOUND IRON STAKE, IDENTIFIED
BT2 BURIED 5\8 INCH	N CULTIVATED AREAS, REFERENCE H REBAR 20 INCHES BELOW GROU DLORED PLASTIC CAP BEARING SUR	ND TO TIE FOUND IRON STAKE.
SET DIVISION OF	POSED RIGHT OF WAY. HIGHWAYS SURVEY MARKER TO M SCRIPTION DATA AND SURVEYORS	
BURIED 5/8 INC	POSED RIGHT OF WAY IN CULTIVAT H REBAR 20 INCHES BELOW GROU N. IDENTIFIED BY COLORED PLAS JMBER.	JND TO MARK FUTURE SURVEY
PERMANENT SUR	VEY MARKER. IDOT STD. 2135 (TO	BE SET BY OTHERS)
☐ RIGHT OF WAY S STATE OF ILLINOIS)	TAKING PROPOSED TO BE SET.	
) SS COUNTY OF DUPAGE)		
DESIGN FIRM NUMBER 184-00291T BETWEEN SECTION 15, TOWNSHIP RANGE 9 EAST OF THE THIRD P AND COMPLETE AS SHOWN TO T CORRECTLY REPRESENTS SAID S PERMANENT QUALITY AND OCCUP ARE SUFFICIENT TO ENABLE THE	DARDS FOR A BOUNDARY SURVEY.	HGHWAYS SHOWN HEREON SECTION 16, TOWNSHIP 38 NORTH, 'Y, THAT THE SURVEY IS TRUE BELIEF, THAT THE PLAT UND AND ESTABLISHED ARE OF I AND THAT THE MONUMENTS S SURVEY CONFORMS TO THE
DATED AT NAPERVILLE, ILLINOIS		, 2012 A.D.
KURT K. APER ILLINOIS PROFESSIONAL LAND SU LICENSE EXPIRES NOVEMBER 30,	2012	
THIS PROFESSIONAL SERVICE CO	NFORMS TO THE CURRENT ILLINOIS <b>west Technical Consultants, In</b> 1805 N. MILL STREET, SUITE L Naperville, ILLINOIS 60563	
1) ALL COORDINATES SHOWN F	(630)505-0101 IEREON ARE PROJECT. ALL DISTAN	ICES SHOWN HEREON ARE
GROUND. 2) BEARINGS SHOWN HEREON ZONE, NAD 83, (2007).	ARE BASED ON ILLINOIS STATE PL	ANE COORDINATE SYSTEM EAST
	USED FOR THIS PROJECT = 0.999	94777.
4) COORDINATE CONVERSION		
<ul><li>A) DIVIDE THE STATE PLANE COMBINATION FACTOR.</li><li>B) SUBTRACT 1,000,000.00 F</li></ul>	COORDINATES TO PROJECT COORDI NAD83 GRID COORDINATES BY TH ROM THESE NORTHINGS AND EAST	E <b>RECEIVED</b> INGS. JAN 2 7 2012
A) ADD 1,000,000.00 TO THE B) MULTIPLY THESE COORDIN	D83 (2007) STATE PLANE COORDI PROJECT NORTHINGS AND EASTIN ATES BY THE COMBINATION FACTC	IGS. JR.
5) THE NGS MONUMENT HELD	FOR THIS PROJECT IS IS FIRST OF	
NAD83 (2007) S.P. 5		HIGHWAYS F ILLINOIS
N. 1,869,327.5048 E. 1,023,602.1293	DEPARTMENT OF	TRANSPORTATION
PROJECT (GROUND) N. 869,425.1449 E. 23,655.5948	<i>F.A.P. 338 ILLI</i> SECTION FERRY RD. TO AURORA PROJECT: ROUTE 59	NOIS ROUTE 59 AVE. DUPAGE COUNTY JOB NO. R-9I-035-09
<b>35-09</b>	STATION 108+00	TO STATION 117+00 SHEET 8B OF 47
60- 520 МАДЕ ВҮ: ЈВ -6- -6- -6-		ND ACQUISITION
MADE BY: TL B MADE BY: JB		EENTER COURT INOIS 60196-1096

CONTRACT	60R30	SHEET	560	OF	1156

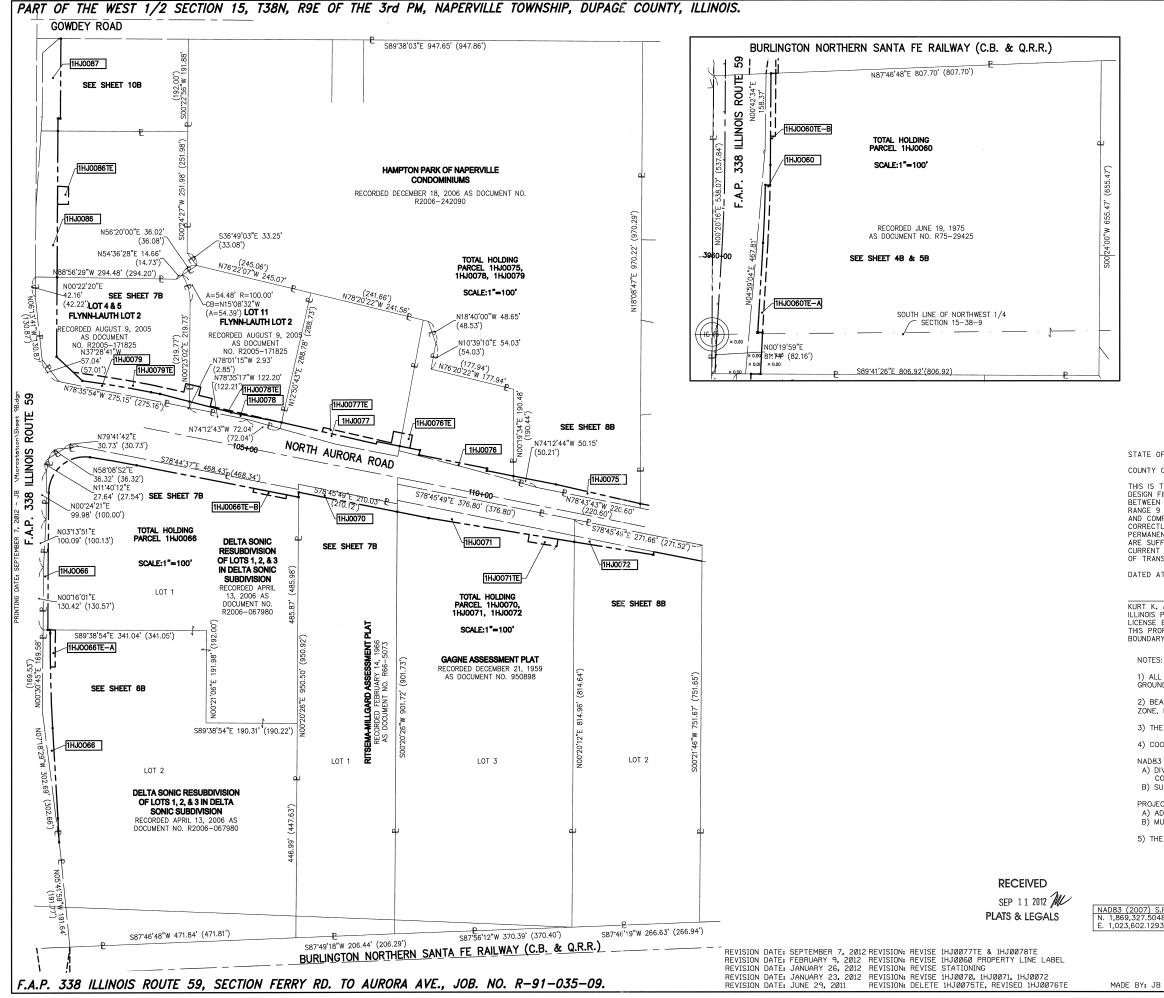

LEGEND
SECTION SECTION SECTION UNE SECTION LINE SECTION LINE SECTION LINE SECTION LINE SECTION LINE SECTION LINE SECTION LINE SECTION LINE
· — · · · — · · · QUARTER, QUARTER SECTION LINE ↓ ■ G G G G G G G G G G G G G G G G G G
APL     APPARENT PROPERTY LINE     APL     APL<
EXISTING BUILDING 0 100 200 300
<ul> <li>SCALE : 1" = 100'</li> <li>IRON PIPE OR ROD FOUND</li> <li>O SET 5/8" × 30' REBAR</li> <li>CUT CROSS FOUND OR SET</li> <li>PK FOUND PK NAIL</li> <li>OPK SET PK NAIL</li> </ul>
• TI THESE STAKES REFERENCE FOUND OR SET MONUMENTATION. 12 SET 5/8 INCH REBAR FLUSH WITH GROUND TO TIE FOUND IRON STAKE. IDENTIFIED 13 BY COLORED PLASTIC CAP AND BEARING SURVEYORS PROFESSIONAL NUMBER.
<ul> <li>BTI THESE STAKES, IN CULTIVATED AREAS, REFERENCE FOUND OR SET MONUMENTATION.</li> <li>BT2 BURIED 5\8 INCH REBAR 20 INCHES BELOW GROUND TO TIE FOUND IRON STAKE.</li> <li>BT3 IDENTIFIED BY COLORED PLASTIC CAP BEARING SURVEYORS PROFESSIONAL NUMBER.</li> </ul>
■ STAKING OF PROPOSED RIGHT OF WAY. SET DIVISION OF HIGHWAYS SURVEY MARKER TO MONUMENT THE POSITION SHOWN. IDENTIFIED BY INSCRIPTION DATA AND SURVEYORS PROFESSIONAL NUMBER.
■ M STAKING OF PROPOSED RIGHT OF WAY IN CULTIVATED AREAS. BURIED 5/8 INCH REBAR 20 INCHES BELOW GROUND TO MARK FUTURE SURVEY MARKER POSITION. IDENTIFIED BY COLORED PLASTIC CAP BEARING SURVEYORS PROFESSIONAL NUMBER.
PERMANENT SURVEY MARKER. IDOT STD. 2135 (TO BE SET BY OTHERS)
□ RIGHT OF WAY STAKING PROPOSED TO BE SET.
STATE OF ILLINOIS) ) SS
COUNTY OF DUPAGE)
THIS IS TO CERTIFY THAT WE, MIDWEST TECHNICAL CONSULTANTS, INC., AN ILLINOIS PROFESSIONAL DESIGN FIRM NUMBER 184-002917, HAVE SURVEYED THE PLAT OF HIGHWAYS SHOWN HEREON BETWEEN SECTION 16, TOWNSHIP 38 NORTH, RANGE 9 EAST, AND SECTION 16, TOWNSHIP 38 NORTH, RANGE 9 EAST OF THE THIRD PRINCIPAL MERIDIAN, DUPAGE COUNTY, THAT THE SURVEY IS TRUE AND COMPLETE AS SHOWN TO THE BEST OF MY KNOWLEDGE AND BELIEF, THAT THE PLAT CORRECTLY REPRESENTS SAID SURVEY, THAT ALL MONIMENTS FOUND AND ESTABLISHED ARE OF PERMANENT QUALITY AND OCCUPY THE POSITIONS SHOWN THEREON AND THAT THE MONUMENTS ARE SUFFICIENT TO ENABLE THE SURVEY TO BE RETRACED. THIS SURVEY CONFORMS TO THE CURRENT ILLINOIS MINIMUM STANDARDS FOR A BOUNDARY SURVEY. MADE FOR THE DEPARTMENT
OF TRANSPORTATION, STATE OF ILLINOIS. DATED AT NAPERVILLE, ILLINOIS THIS DAY OF, 2012 A.D.
KURT K. APER ILLINOIS PROFESSIONAL LAND SURVEYOR NO. 035-003265 LICENSE EXPIRES NOVEMBER 30, 2012 THIS PROFESSIONAL SERVICE CONFORMS TO THE CURRENT ILLINOIS MINIMUM STANDARDS FOR A BOUNDARY SURVEY. <i>Midwest Technical Consultants, Inc.</i>
IBO5 N. MILL STREET, SUITE L Naper VIIe, ILLINOIS 60563
(630)505-0101 1) ALL COORDINATES SHOWN HEREON ARE PROJECT. ALL DISTANCES SHOWN HEREON ARE GROUND.
2) BEARINGS SHOWN HEREON ARE BASED ON ILLINOIS STATE PLANE COORDINATE SYSTEM EAST ZONE, NAD 83, (2007).
3) THE COMBINATION FACTOR USED FOR THIS PROJECT = 0.99994777.
4) COORDINATE CONVERSION
NAD83 (2007) STATE PLANE COORDINATES TO PROJECT COORDINATES: A) DIVIDE THE STATE PLANE NAD83 GRID COORDINATES BY THE COMBINATION FACTOR. B) SUBTRACT 1,000,000.00 FROM THESE NORTHINGS AND EASTINGS.
PROJECT COORDINATES TO NAD83 (2007) STATE PLANE COORDINATES: A) ADD 1,000,000.00 TO THE PROJECT NORTHINGS AND EASTINGS. B) MULTIPLY THESE COORDINATES BY THE COMBINATION FACTOR.
5) THE NGS MONUMENT HELD FOR THIS PROJECT IS IS FIRST ORDER P.I.D. AA3730.
PLAT OF HIGHWAYS       STATE OF ILLINOIS       DEPARTMENT OF TRANSPORTATION
(2007)         S.P.         PROJECT (GROUND)         SECTION         FERRY RD. TO AURORA AVE.         DUPAGE COUNTY           9,327.5048         N. 869,425.1449         PROJECT: ROUTE 59         JOB NO. R-9I-035-09           3,602.1293         E. 23,655.5948         Total and the second seco
SCALE: I" = 100' SHEET <u>9B</u> OF <u>47</u>
BUREAU OF LAND ACQUISITION 201 WEST CENTER COURT SCHAUMBURG, ILLINOIS 60196-1096


CONTRACT 60R30 SHEET 561 OF 1156

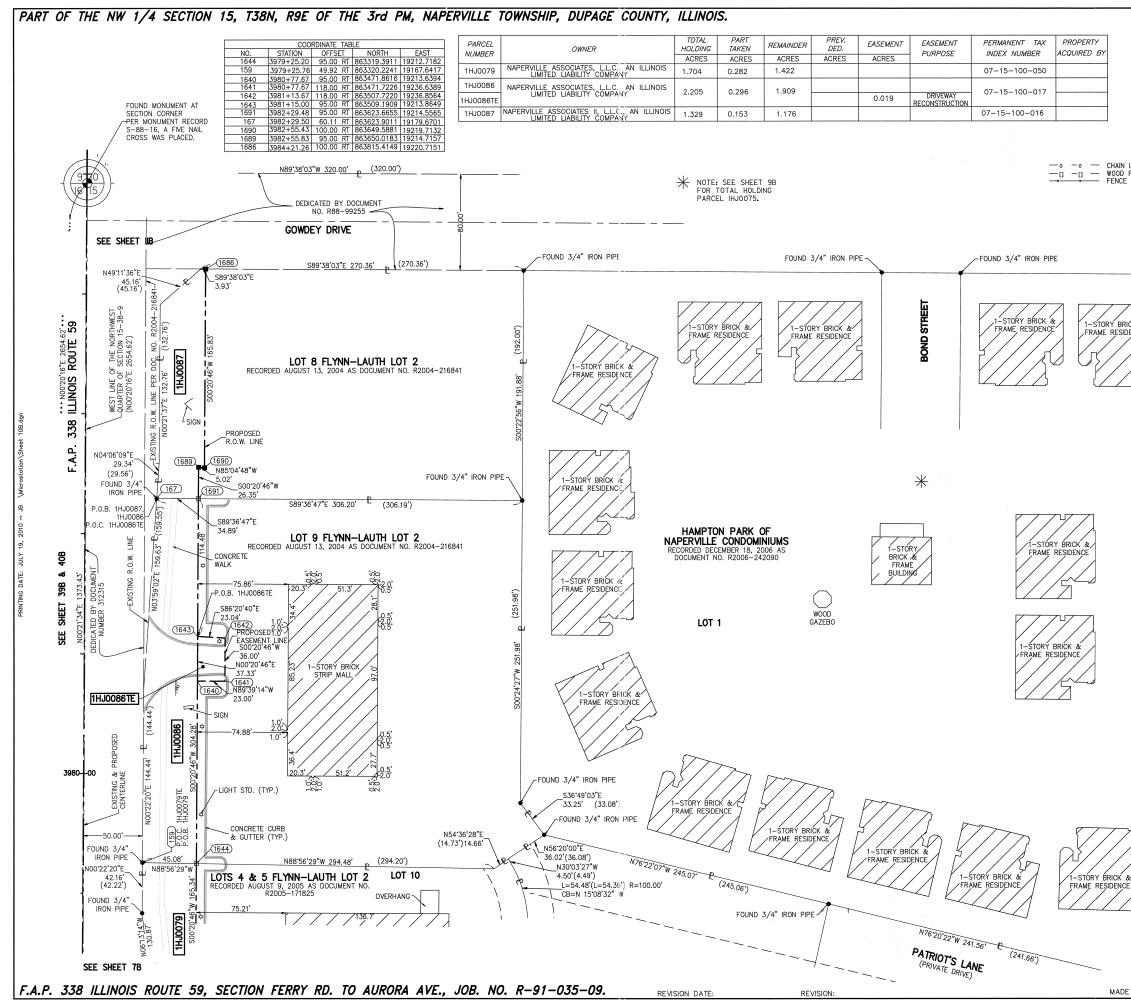

	LEGEND		
9 ID 16 IS CORNER		UUARTER SECTION CORNER	SYSTEM 07)
QUA	TION LINE RTER SECTION LINE RTER, QUARTER SECTION LINE TTED LOT LINE PERTY (DEED) LINE		COORDINATE SYSTEM
APL APP CENN PRO APL APP CENN PRO AC PRO AC PRO AC PRO	ARENT PROPERTY LINE TERLINE TING RIGHT OF WAY LINE POSED RIGHT OF WAY LINE POSED EASEMENT TING ACCESS CONTROL LINE FOSED ACCESS CONTROL LINE ORD DATA	BE ARINGS AFF	EAST ZONE, N.A
EXIS	STING BUILDING O	40 80 SCALE : 1" = 40	120
<ul> <li>IRON PIPE OR RO</li> <li>CUT CROSS FOU</li> </ul>		5/8" × 30" REBAR	ET PK NAIL
- TI THESE STAKES I T2 SET 5/8 INCH R T3 BY COLORED PI	REFERENCE FOUND OR SET MON IEBAR FLUSH WITH GROUND TO LASTIC CAP AND BEARING SUI	UMENTATION. TIE FOUND IRON STAK RVEYORS PROFESSION	KE. IDENTIFIED NAL NUMBER.
BT2 BURIED 5\8 INC	IN CULTIVATED AREAS, REFEREN H REBAR 20 INCHES BELOW GF OLORED PLASTIC CAP BEARING	ROUND TO THE FOUND	IRON STAKE.
SET DIVISION OF	PPOSED RIGHT OF WAY. HIGHWAYS SURVEY MARKER TO ISCRIPTION DATA AND SURVEYOF		
BURIED 5/8 INC	POSED RIGHT OF WAY IN CULTI H REBAR 20 INCHES BELOW G NN IDENTIFIED BY COLORED P IUMBER.	ROUND TO MARK FUT	
PERMANENT SUR	VEY MARKER. IDOT STD. 2135 (	TO BE SET BY OTHER	S)
RIGHT OF WAY S	STAKING PROPOSED TO BE SET.		
) SS COUNTY OF DUPAGE)			
THIS IS TO CERTIFY THAT WE, M DESIGN FIRM LAND SURVEYING CC HIGHWAYS SHOWN HEREON BETWEI SECTION 16, TOWNSHIP 38 NORTH, COUNTY, THAT THE SURVEY IS T AND BELIEF, THAT THE PLAT CO FOUND AND ESTABLISHED ARE OF THEREON AND THAT THE MONUME THIS SURVEY CONFORMS TO THE MADE FOR THE DEPARTMENT OF	ORPORATION NUMBER 184-002917, EN SECTION 15, TOWNSHIP 38 NG, RANGE 9 EAST OF THE THIRD RUE AND COMPLETE AS SHOWN RRECTLY REPRESENTS SAID SUF PERMANENT OUALITY AND OCC ENTS ARE SUFFICIENT TO ENABL CURRENT ILLINOIS MINIMUM STA	HAVE SURVEYED THE DRTH, RANGE 9 EAST, PRINCIPAL MERIDIAN, TO THE BEST OF MY RVEY, THAT ALL MONU CUPY THE POSITIONS 3 E THE SURVEY TO B NDARDS FOR A BOUNI	E PLAT OF AND DUPAGE VKNOWLEDGE JMENTS SHOWN E RETRACED.
DATED AT NAPERVILLE, ILLINOIS	THIS DAY OF	, 2010 A.D.	
RUSSELL W. OLSEN ILLINOIS PROFESSIONAL LAND SUF LICENSE EXPIRES NOVEMBER 30, THIS PROFESSIONAL SERVICE CON BOUNDARY SURVEY.	2010	DIS MINIMUM STANDARD	S FOR A
NOTES:	est Technical Consultants, I 1840 Centre Point Circle Naperville, ILLINOIS 60563 (630)505-0101 HEREON ARE PROJECT. ALL DIS		ON ARE
GROUND. 2) BEARINGS SHOWN HEREON	ARE BASED ON ILLINOIS STATE		
ZONE, NAD 83, (2007). 3) THE COMBINATION FACTOR	USED FOR THIS PROJECT = 0	.99994777.	
4) COORDINATE CONVERSION			
<ul> <li>A) DIVIDE THE STATE PLANE COMBINATION FACTOR.</li> </ul>	COORDINATES TO PROJECT COO NAD83 GRID COORDINATES BY FROM THESE NORTHINGS AND E	THE RI	ECEIVED L 20 2010 PK
A) ADD 1,000,000.00 TO TH	AD83 (2007) STATE PLANE COO E PROJECT NORTHINGS AND EA NATES BY THE COMBINATION FA	DRDINATES: PLAT STINGS.	S& LEGALS
5) THE NGS MONUMENT HELD	FOR THIS PROJECT IS IS FIRS		0.
<ul> <li>NAD83 (2007) S.P.</li> <li>N. 1,869,327,5048</li> <li>E. 1,023,602,1293</li> <li>PROJECT (GROUND)</li> <li>N. 869,425,1449</li> <li>E. 23,655,5948</li> </ul>	STATE OF DEPARTMENT OF	LINOIS ROUTE	<b>59</b> E COUNTY 91-035-09
E. 23,655.5948 60-550-66-48	SCALE:  " = 40'	SHEET <u>IOE</u>	0F_47_
ВХ: ЛВ ВД: ЛВ	201 WEST	LAND ACQUISITION CENTER COURT ILLINOIS 60196-109	6
	CONTRACT 60R	30 SHEET 56	2 OF 1156

# PART OF THE SOUTHEAST 1/4 SECTION 9 AND THE NORTHEAST 1/4 SECTION 16, T38N, R9E OF THE 3rd PM, NAPERVILLE TOWNSHIP, DUPAGE COUNTY, ILLINOIS.

PARCEL	OWNER	TOTAL HOLDING	PART TAKEN	REMAINDER	PREV. DED.	EASEMENT	EASEMENT PURPOSE	PERMANENT TAX	PROPERTY
NUMBER		ACRES	ACRES	ACRES	ACRES	ACRES	TONTOSE		
1HJ0088	NORTH PLAZA PARTNERS, LLC, AN ILLINOIS		0.122	4.040				07-16-207-001	
1HJ0088TE	LIMITED LIABILITY COMPANY	1.970		1.848		0.052	DRIVEWAY RECONSTRUCTION	07-10-207-001	
1HJ0089	NEWDEARBORN STATION CONDOMINIUM ASSOCIATION	4 5 9 9	0.038	1.482				07-09-408-048	
1HJ0089TE-A	AN ILLINOIS NOT-FOR-PROFIT CORPORATION	1.520		1.482		A=0.008 (356 SQ FT)	DRIVEWAY RECONSTRUCTION	0, 00 100 010	
1HJ0089TE-B						B=0.014	CONSTRUCTION		
1HJ0090		8,436	0.019	8.417				07-09-408-050	
1HJ0090TE	NEUMANN HOMES, INC.			0.417		0.034	DRIVEWAY RECONSTRUCTION		

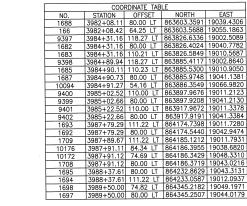



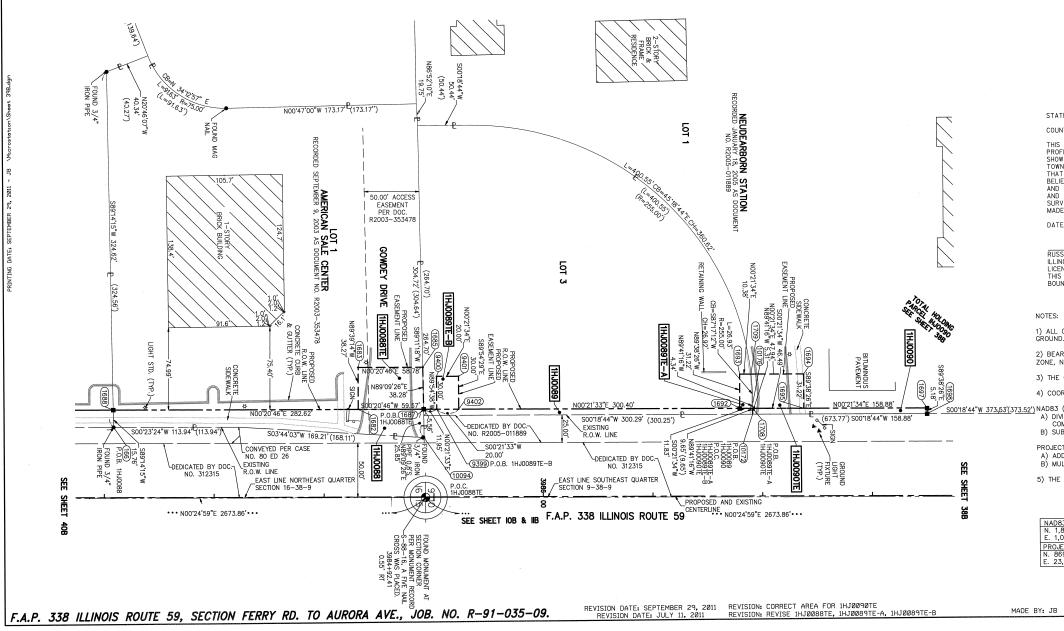


Image: section display="block statement of the section sectio
(43)     SECTION     SECTION       910     CORNER     (43)       SECTION     SECTION       OUARTER SECTION LINE     UNARTER SECTION LINE       OUARTER, OUARTER SECTION LINE     OUARTER, OUARTER SECTION LINE       PROPERTY INCED LINE     Section Line       PROPERTY INCED LINE     Section Line
APL APPARENT PROPERTY LINE
CENTERLINE     CENTERLINE     CENTERLINE     CENTERLINE     CENTERLINE     PROPOSED RIGHT OF WAY LINE     PROPOSED FASEMENT     CENTERLINE     AC     FINISTING ACCESS CONTROL LINE     SUBJECT:
EXISTING BUILDING 
← CUT CROSS FOUND OR SET ●PK FOUND PK NAIL OPK SET PK NAIL     ●TI THESE STAKES REFERENCE FOUND OR SET MONUMENTATION.
T2 SET 5/8 INCH REBAR FLUSH WITH GROUND TO TIE FOUND IRON STAKE. IDENTIFIED T3 BY COLORED PLASTIC CAP AND BEARING SURVEYORS PROFESSIONAL NUMBER.
<ul> <li>BTI THESE STAKES, IN CULTIVATED AREAS, REFERENCE FOUND OR SET MONUMENTATION.</li> <li>BTZ BURIED 5-8 INCH REBAR 20 INCHES BELOW GROUND TO TIE FOUND IRON STAKE.</li> <li>BT3 IDENTIFIED BY COLORED PLASTIC CAP BEARING SURVEYORS PROFESSIONAL NUMBER.</li> </ul>
■ STAKING OF PROPOSED RIGHT OF WAY. SET DIVISION OF HIGHWAYS SURVEY MARKER TO MONUMENT THE POSITION SHOWN. IDENTIFIED BY INSCRIPTION DATA AND SURVEYORS PROFESSIONAL NUMBER.
■M STAKING OF PROPOSED RIGHT OF WAY IN CULTIVATED AREAS. BURIED 5/8 INCH REBAR 20 INCHES BELOW GROUND TO MARK FUTURE SURVEY MARKER POSITION. IDENTIFIED BY COLORED PLASTIC CAP BEARING SURVEYORS PROFESSIONAL NUMBER.
PERMANENT SURVEY MARKER, IDOT STD. 2135 (TO BE SET BY OTHERS)
C RIGHT OF WAY STAKING PROPOSED TO BE SET. TE OF ILLINOIS)
NTY OF DUPAGE) 5 IS TO CERTIFY THAT WE, MIDWEST TECHNICAL CONSULTANTS, INC., AN ILLINOIS
S IS TO CERTIFIT THAT WE, MUMBER 184-002917, HAVE SURVEYED THE PLAT OF HIGHWAYS FESSIONAL DESIGN FIRM NUMBER 184-002917, HAVE SURVEYED THE PLAT OF HIGHWAYS WN HEREON BETWEEN SECTION 9, TOWNSHIP 38 NORTH, RANCE 9 EAST, AND SECTION 16, INSHIP 38 NORTH, RANCE 9 EAST OF THE THIRD PRINCIPAL MERIDIAN, DUPAGE COUNTY, T THE SURVEY IS TRUE AND COMPLETE AS SHOWN TO THE BEST OF MY KNOWLEDGE AND HEF, THAT THE PLAT CORRECTLY REPRESENTS SAD SURVEY, THAT ALL MONUMENTS FOUND 1 ESTABLISHED ARE OF PERMANENT OUALITY AND OCCUPY THE POSITIONS SHOWN THEREON 1 THAT THE MONUMENTS ARE SUFFICIENT TO ENABLE THE SURVEY TO BE RETRACED. THIS VEY CONFORMS TO THE CURRENT ILLINOIS MINIMUM STANDARDS FOR A BOUNDARY SURVEY. 16 FOR THE DEPARTMENT OF TRANSPORTATION, STATE OF ILLINOIS
ED AT NAPERVILLE, ILLINOIS THIS DAY OF, 2011 A.D.
SELL W. OLSEN NOIS PROFESSIONAL LAND SURVEYOR NO. 035-002718 ENSE EXPIRES NOVEMBER 30, 2012 S PROFESSIONAL SERVICE CONFORMS TO THE CURRENT ILLINOIS MINIMUM STANDARDS FOR A INDARY SURVEY.
Midwest Technical Consultants, Inc. 1805 N. MILL STREET, SUITE L Naperville, ILLINOIS 60563 (630)505-0101
COORDINATES SHOWN HEREON ARE PROJECT. ALL DISTANCES SHOWN HEREON ARE D.
RINGS SHOWN HEREON ARE BASED ON ILLINOIS STATE PLANE COORDINATE SYSTEM EAST NAD 83, (2007).
COMBINATION FACTOR USED FOR THIS PROJECT = 0.99994777.
(2007) STATE PLANE COORDINATES TO PROJECT COORDINATES:     RECEIVED       VIDE THE STATE PLANE NADB3 GRID COORDINATES BY THE     NOV 2 1 2011
IBTRACT 1,000,000.00 FROM THESE NORTHINGS AND EASTINGS.  PLATS & LEGALS  CT COORDINATES TO NADB3 (2007) STATE PLANE COORDINATES:
DD 1,000,000.00 TO THE PROJECT NORTHINGS AND EASTINGS. JLTIPLY THESE COORDINATES BY THE COMBINATION FACTOR. NGS MONUMENT HELD FOR THIS PROJECT IS IS FIRST ORDER P.I.D. AA3730.
PLAT OF HIGHWAYS
STATE OF ILLINOIS DEPARTMENT OF TRANSPORTATION
F.A.P. 338     ILLINOIS     ROUTE     59       023.602.1293     SECTION FERRY RD. TO AURORA AVE.     DUPAGE COUNTY       ECT (GROUND)     PROJECT: ROUTE     59     JOB NO. R-9I-035-09
60 / 25 1// 9
BUREAU OF LAND ACQUISITION
201 WEST CENTER COURT SCHAUMBURG, ILLINOIS 60196–1096
CONTRACT 60R30 SHEET 563 OF 1150

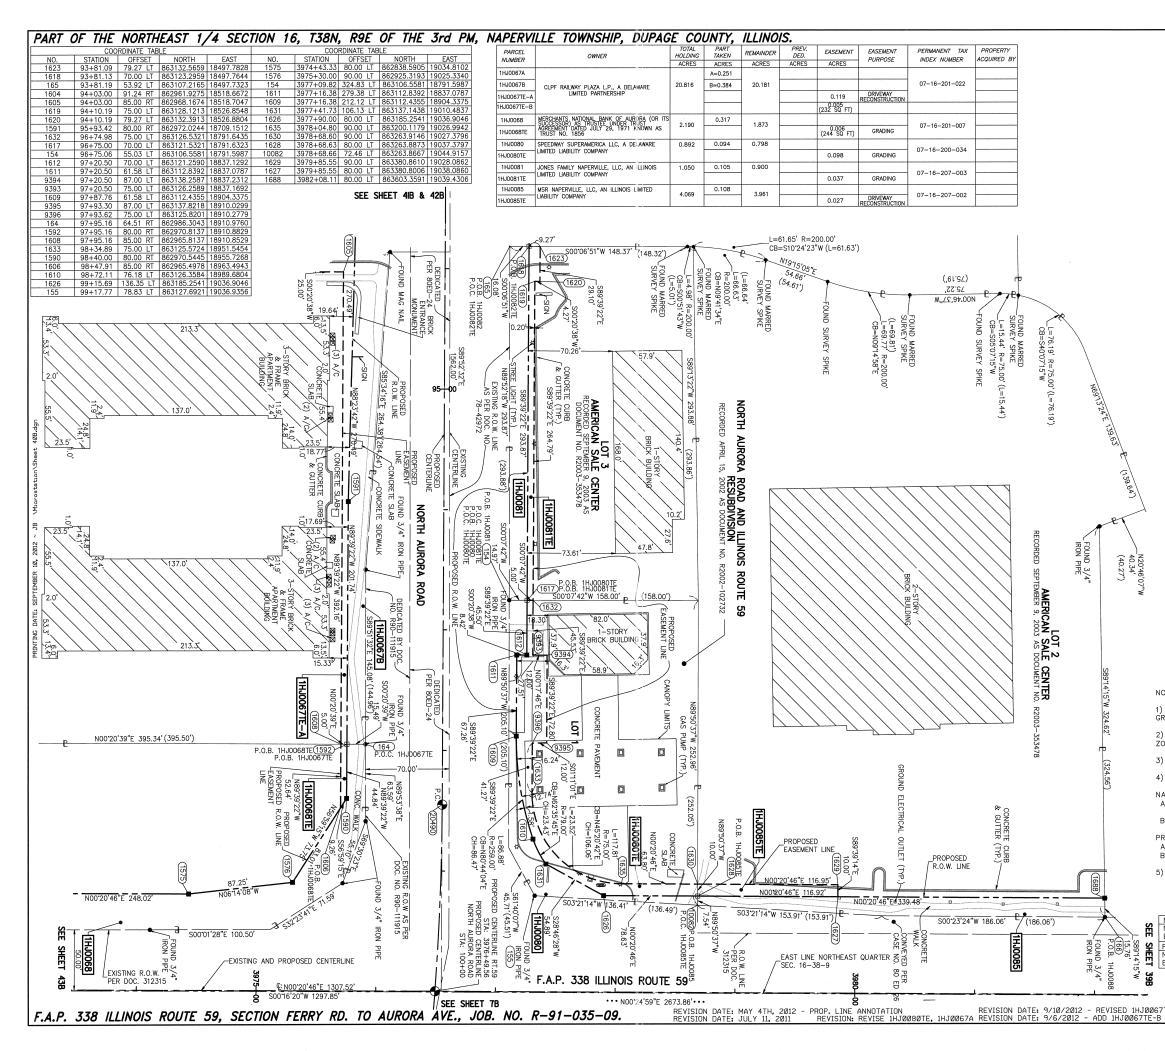

legend
Image: Section conner     Image: Section conner       Image: Section conner     Image: Section conner
Image: Section connection     Section connection     Section connection     Substance       Image: Section connection     Section connection     Substance     Substance       Image: Section connection     Section connection     Substance     Substance       Image: Section connection     Section     Substance     Substance       Image: Section connection     Substance     Substance     Substance       Image: Section     Substance     Substance     Substance
APL APPARENT PROPERTY LINE
CENTERLINE     C
$-\circ$ $-\circ$ CHAIN LINK FENCE
− WOUD FENCE SCALE : T = 40     − FENCE LINE     IRON PIPE OR ROD FOUND O SET 5/8" × 30" REBAR
<ul> <li>CUT CROSS FOUND OR SET</li> <li>OFK FOUND PK NAIL</li> <li>OPK SET PK NAIL</li> <li>TI THESE STAKES REFERENCE FOUND OR SET MONUMENTATION.</li> </ul>
T2 SET 5/8 INCH REBAR FLUSH WITH GROUND TO TIE FOUND IRON STAKE. IDENTIFIED T3 BY COLORED PLASTIC CAP AND BEARING SURVEYORS PROFESSIONAL NUMBER.
● BTI THESE STAKES, IN CULTIVATED AREAS, REFERENCE FOUND OR SET MONUMENTATION. BT2 BURIED 5\8 INCH REBAR 20 INCHES BELOW GROUND TO TIE FOUND IRON STAKE. BT3 IDENTIFIED BY COLORED PLASTIC CAP BEARING SURVEYORS PROFESSIONAL NUMBER.
■ STAKING OF PROPOSED RIGHT OF WAY. SET DIVISION OF HIGHWAYS SURVEY MARKER TO MONUMENT THE POSITION SHOWN. IDENTIFIED BY INSCRIPTION DATA AND SURVEYORS PROFESSIONAL NUMBER.
STAKING OF PROPOSED RIGHT OF WAY IN CULTIVATED AREAS. BURIED 5/8 INCH REBAR 20 INCHES BELOW GROUND TO MARK FUTURE SURVEY MARKER POSITION. IDENTIFIED BY COLORED PLASTIC CAP BEARING SURVEYORS PROFESSIONAL NUMBER.
PERMANENT SURVEY MARKER, IDOT STD. 2135 (TO BE SET BY OTHERS)
☐ RIGHT OF WAY STAKING PROPOSED TO BE SET. STATE OF ILLINOIS) ) SS COUNTY OF DUPAGE)
THIS IS TO CERTIFY THAT WE, MUMBEST TECHNICAL CONSULTANTS, INC., AN ILLINOIS PROFESSIONAL DESIGN FIRM NUMBER 184-002917, HAVE SURVEYED THE PLAT OF HIGHWAYS SHOWN HEREON BETWEEN SECTION 16, TOWNSHIP 38 NORTH, RANGE 9 EAST, AND SECTION 15, TOWNSHIP 38 NORTH, RANGE 9 EAST OF THE THIRD PRINCIPAL MERIDIAN, DUPAGE COUNTY, THAT THE SURVEY IS TRUE AND COMPLETE AS SHOWN TO THE BEST OF MY KNOWLEDGE AND BELIEF, THAT THE PLAT CORRECTLY REPRESENTS SAID SURVEY, THAT ALL MONUMENTS FOUND AND ESTABLISHED ARE OF PERMANENT QUALITY AND OCCUPY THE POSITIONS SHOWN THEREON AND THAT THE MONUMENTS ARE SUFFICIENT TO ENABLE THE SURVEY TO BE RETRACED. THIS SURVEY CONFORMS TO THE CURRENT ILLINOIS MINIMUM STANDARDS FOR A BOUNDARY SURVEY, MADE FOR THE DEPARTMENT OF TRANSPORTATION, STATE OF ILLINOIS.
DATED AT NAPERVILLE, ILLINOIS THIS DAY OF, 2012 A.D.
KURT K. APER ILLINOIS PROFESSIONAL LAND SURVEYOR NO. 035-003265 LICENSE EXPIRES NOVEMBER 30, 2012 THIS PROFESSIONAL SERVICE CONFORMS TO THE CURRENT ILLINOIS MINIMUM STANDARDS FOR A BOUNDARY SURVEY.
Midwest Technical Consultants, Inc. 1805 N. MILL STREET, SUITE L
Naperville, ILLINOIS 60563 IOTES: (630)505-0101
) ALL COORDINATES SHOWN HEREON ARE PROJECT. ALL DISTANCES SHOWN HEREON ARE ROUND.
2) BEARINGS SHOWN HEREON ARE BASED ON ILLINOIS STATE PLANE COORDINATE SYSTEM EAST ONE, NAD 83, (2007).
THE COMBINATION FACTOR USED FOR THIS PROJECT = 0.99994777.
IADB3 (2007) STATE PLANE COORDINATES TO PROJECT COORDINATES: A) DIVIDE THE STATE PLANE NADB3 GRID COORDINATES BY THE COMBINATION FACTOR. B) SUBTRACT 1,000,000.00 FROM THESE NORTHINGS AND EASTINGS. B) SUBTRACT 1,000,000.00 FROM THESE NORTHINGS AND EASTINGS.
PROJECT COORDINATES TO NAD83 (2007) STATE PLANE COORDINATES: A) ADD 1,000,000.00 TO THE PROJECT NORTHINGS AND EASTINGS. B) MULTIPLY THESE COORDINATES BY THE COMBINATION FACTOR.
i) THE NGS MONUMENT HELD FOR THIS PROJECT IS IS FIRST ORDER P.I.D. AA3730.
PLAT OF HIGHWAYS STATE OF ILLINOIS DEPARTMENT OF TRANSPORTATION
TRADES (2007) 5.1.
E. 1,023,602.1293 SECTION FERRY RD. TO AURORA AVE. DUPAGE COUNTY PROJECT (GROUND) PROJECT: ROLLEF 59 JOB NO. R-91-035-09
N 869 425 1449
P         SCALE:         I" = 40'         SHEET         40B         OF         47
TE-A SCHAUMBURG, ILLINOIS 60196-1096

CONTRACT 60R30 SHEET 564 OF 1156

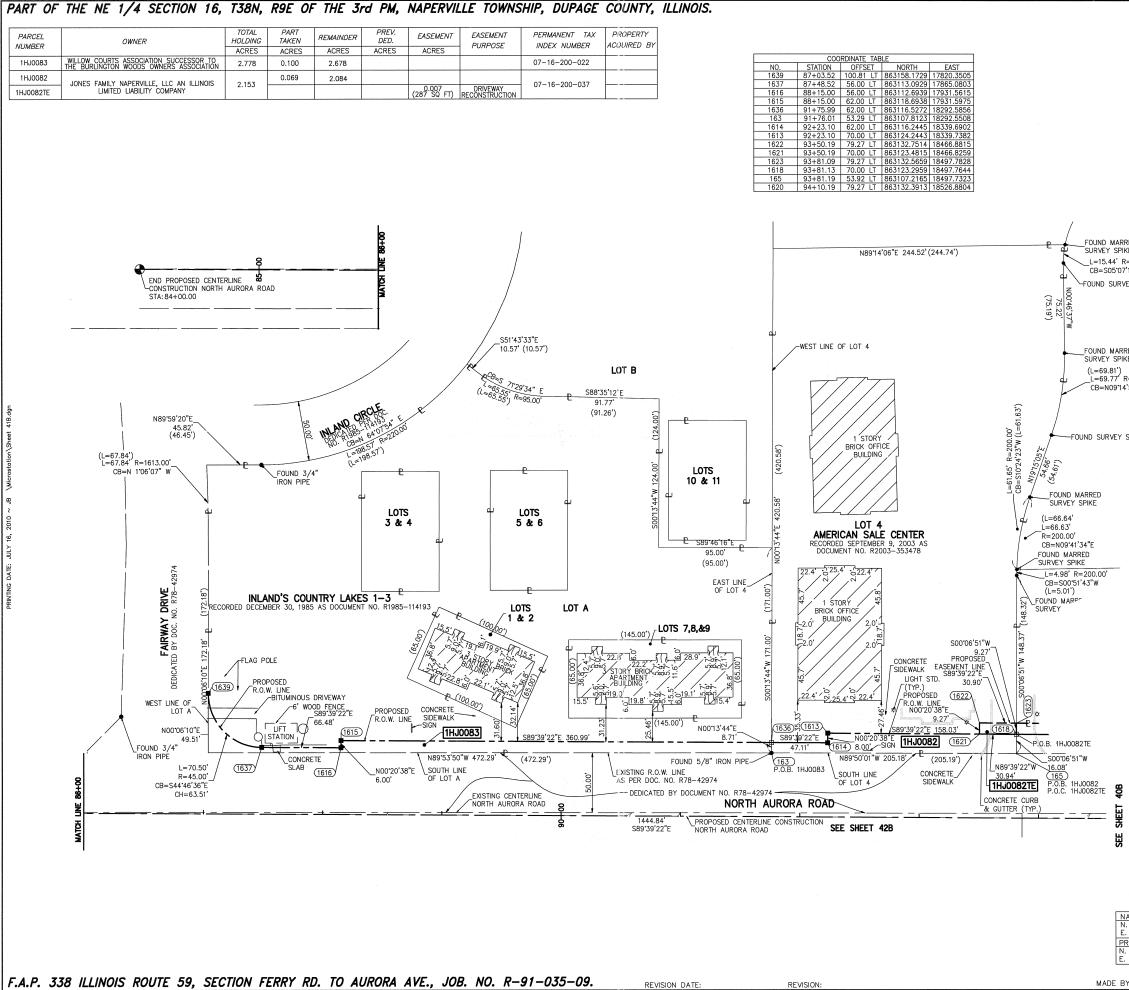


F.A.P. 338 ILLINOIS ROUTE 59, SECTION FERRY RD. TO AURORA AVE., JOB. NO. R-91-035-09.


REVISION:

MADE BY


		LEC	iend			
-	SECTION 15 CORNER		- (16 15	QUARTER SECTION CORNER	ON ILLINOIS NATE SYSTEM 3 (2007)	
	QU, QU, PL,	CTION LINE ARTER SECTION LINE ARTER, QUARTER SECT ATTED LOT LINE DPERTY (DEED) LINE	ION LINE	N	3ASED ON COORDINATI 1.D. 83 (2)	
		PARENT PROPERTY LINI NTERLINE STING RIGHT OF WAY L DPOSED RIGHT OF WAY DPOSED RASEMENT STING ACCESS CONTRO DPOSED ACCESS CONTRO DPOSED ACCESS CONTFO	LINE LINE L LINE		BEARINGS ARE E STATE PLANE C EAST ZONE, N.A	
	-0 -0 - CH -0 -0 - WO *			40 8 SCALE : 1" = 3" × 30" REBAR	40'	120
E + =75.00' TI 15"W T2 EY SPIKE T3	SET 5/8 INCH	JND OR SET REFERENCE FOUND REBAR FLUSH WITH PLASTIC CAP AND E	GROUND TO TIE	ENTATION. FOUND IRON S	PK SET PK N STAKE. IDENT SIONAL NUM	TIFIED
<ul> <li>BTI BT2 BT3</li> </ul>	BURIED 5\8 INC	IN CULTIVATED ARE/ CH REBAR 20 INCHE: COLORED PLASTIC CA	S BELOW GROU	ND TO TIE FOL	JND IRON ST	TAKE.
ED E	SET DIVISION O	OPOSED RIGHT OF W F HIGHWAYS SURVEY NSCRIPTION DATA AN	MARKER TO M			IOWN.
R=200.00' ■ M '58"E	BURIED 5/8 IN	OPOSED RIGHT OF W CH REBAR 20 INCHE ION. IDENTIFIED BY NUMBER.	S BELOW GROU	JND TO MARK		
•	PERMANENT SUF	RVEY MARKER. IDOT	STD. 2135 (TO	BE SET BY OT	HERS)	
SPIKE STATE OF COUNTY OF	RIGHT OF WAY ILLINOIS) ) SS	STAKING PROPOSED				
PROFESSION SURVEYED NORTH, RAI PRINCIPAL TO THE BE SURVEY, TI OCCUPY TH ENABLE TH MINIMUM ST TRANSPORT	HAL DESIGN FIRM THE PLAT OF NOE 9 EAST, AN MERIDIAN, DUPAC ST OF MY KNOU HAT ALL MONUM E POSITIONS SH E SURVEY TO E ANDARDS FOR / ATION, STATE C	WE, MIDWEST TECHN 4 LAND SURVEYING C IGHWAYS SHOWN HER 4D SECTION 16, TOWN 5E COUNTY, THAT TH MLEDGE AND BELIEF, IENTS FOUND AND E 5E RETRACED. THIS A BOUNDARY SURVEY 5F ILLINOIS. INOIS THIS D	CORPORATION NU JEON BETWEEN : ISHIP 38 NORTH HE SURVEY IS T THAT THE PLA STABLISHED ARE THAT THE MONU SURVEY CONFO . MADE FOR T	JMBER 184-0029 SECTION 15, TO 1, RANGE 9 EAS IRUE AND COMF AT CORRECTLY E OF PERMANEN JMENTS ARE SL DRMS TO THE C	NT, HAVE WNSHIP 38 ST OF THE PLETE AS SI REPRESENTS IT QUALITY JFFICIENT TC SURRENT ILLI IT OF	HOWN S SAID AND D
LICENSE E>	OFESSIONAL LAN PIRES NOVEMBE ESSIONAL SERVIC	E CONFORMS TO TH dwest Technical C 1840 Centre Pa Naperville, ILLIN	E CURRENT ILLI <b>consultants, In</b> int Circle 0IS 60563		STANDARDS	FOR A
1) ALL (	COORDINATES SH	-630)505 OWN HEREON ARE F		ISTANCES SHOW	WN HEREON	ARE
		EREON ARE BASED 0 2007).	N ILLINOIS STAT	TE PLANE COOF	DINATE SYS	STEM
3) THE	COMBINATION FA	ACTOR USED FOR TH	IS PROJECT =	0.99994777.		
4) COOF	DINATE CONVER	SION				
A) DIVI COM	DE THE STATE I IBINATION FACTO	LANE COORDINATES PLANE NAD83 GRID OR. 0.00 FROM THESE N	COORDINATES B	IY THE	JUL 20 2010	ple
A) ADD	) 1,000,000.00 '	TO NAD83 (2007) S TO THE PROJECT NO DORDINATES BY THE	RTHINGS AND E	ASTINGS.	.ዳገሜ & LEG,4	LS
5) THE	NGS MONUMENT	HELD FOR THIS PRO	DJECT IS IS FIR	ST ORDER P.I.D	. AA3730.	
AD83 (2007) S.F 1,869,327.5048 1,023,602.1293	5-09	DEPARTM F.A.P. SECTION FERRY R PROJECT: ROUT STATION 84+00	TE 59 )	TILLINOIS TRANSPOR NOIS ROUT AVE. DUF JOB NO. TO STAT	<b>PTATION</b> <b>59</b> PAGE COUN R-91-035- TION 94+00	-09 0
COJECT (GROUND 869,425.1449 23,655.5948	4 0-16-1	SCALE: I" = 4	UREAU OF LAI		<u>4IB_</u> 0F_4	<u>+ (</u>
23,633.3948 Y: JB		SCH	201 WEST CE AUMBURG, ILLI	ENTER COURT NOIS 60196-1	1096	
		CONTRA	ACT 60R30	SHEET	565 OF	115

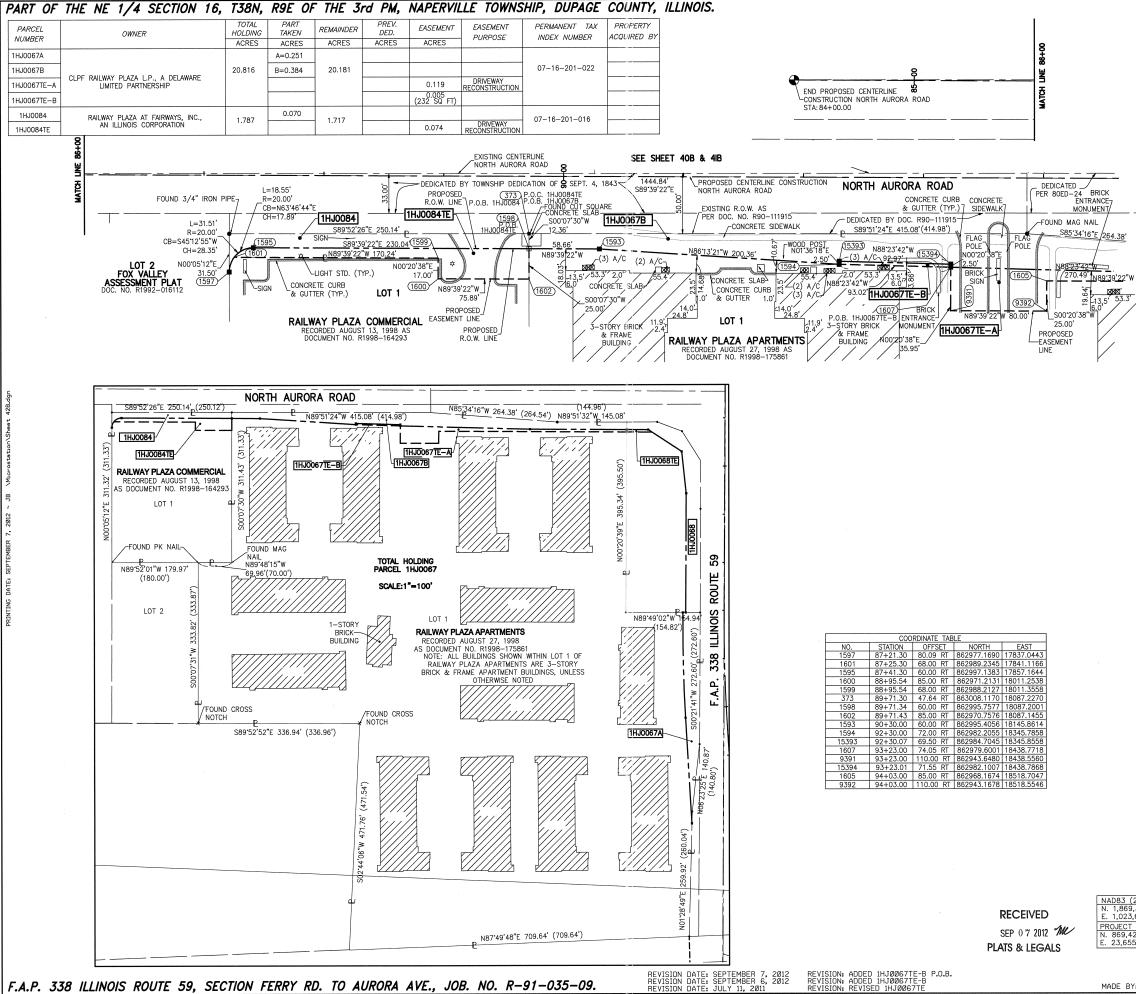


				[	egend	)		
	96	10 15	SECTIO			-UIG IS- QUAR SECT CORN	TER SIONITA SIONITA ER 001)	
			QI QI PI	ECTION LINE JARTER SECTION LI JARTER, QUARTER S LATTED LOT LINE ROPERTY (DEED) LIN	SECTION LINE		BASED ON ILLINOIS COORDINATE SYSTEM	
40B		APL	PI PI PI - PI - PI - PI - PI	PPARENT PROPERTY INTERLINE KISTING RIGHT OF W ROPOSED RIGHT OF ROPOSED EASEMENT KISTING ACCESS CO ROPOSED ACCESS C ECORD DATA	AY LINE WAY LINE NTROL LINE		BEARINGS ARE STATE PLANE EAST ZONE, N.	
SHEET			E	XISTING BUILDING	0	40	80	120
estere • •		1 — [] RON PI	PE OR	HAIN LINK FENCE DOD FENCE ENCE LINE ROD FOUND DUND OR SET		<i>SCALE :</i> SET 5/8" × 30" FOUND PK NAIL		K NAII
• 392.16'	TI T2	THESE SET 5/	STAKES	REFERENCE FOU REBAR FLUSH W PLASTIC CAP AN	ND OR SET TH GROUND	MONUMENTATION	RON STAKE. ID	ENTIFIED
. •	BT2 B	BURIED	5\8 IM	, IN CULTIVATED NCH REBAR 20 IN COLORED PLASTIC	CHES BELO	W GROUND TO T	E FOUND IRON	STAKE.
		SET DI	VISION	ROPOSED RIGHT C DF HIGHWAYS SUF INSCRIPTION DAT	VEY MARKE			SHOWN.
	1	BURIED MARKE	5/8 II R POSI	ROPOSED RIGHT C NCH REBAR 20 II TION. IDENTIFIED NUMBER.	F WAY IN ( NCHES BELC BY COLORI	CULTIVATED AREA DW GROUND TO ED PLASTIC CAP	S. MARK FUTURE BEARING SUF	SURVEY RVEYORS
e	<b>)</b> I	PERMAN	NENT SI	JRVEY MARKER. I	OT STD. 2	35 (TO BE SET	BY OTHERS)	
	E OF I	RIGHT LLINOIS DUPAC	;) ) SS	STAKING PROPOS	ED TO BE	SET.		
PROFE SHOWN TOWNS THAT BELIEI FOUNC THERE RETRA BOUND	ESSION N HERE SHIP 3 THE S F, THA D AND EON AN ACED. DARY S	AL DES EON BE 8 NOR SURVEY T THE ESTAE ND THA THIS SURVEY	SIGN FIF TWEEN TH, RAN IS TRI PLAT BLISHED T THE SURVEY SURVEY	WE, MIDWEST TI M NUMBER 184-00 SECTION 15, TOW IGE 9 EAST OF T JE AND COMPLET ORRECTLY REPR ARE OF PERMANN MONUMENTS ARE CONFORMS TO T E FOR THE DEPA LLINOIS THIS	D2917, HAVE NSHIP 38 NG HE THIRD F E AS SHOWI ESENTS SAU ENT QUALIT SUFFICIENT 'HE CURREN RTMENT OF	SURVEYED THE ORTH, RANGE 9 E RINCIPAL MERDIA N TO THE BEST D SURVEY, THAT Y AND OCCUPY T TO ENABLE THE T ILLINOIS MINIMU TRANSPORTATIOI	PLAT OF HIGH EAST, AND SEC N, DUPAGE COI OF MY KNOWLE ALL MONUMEN HE POSITIONS SURVEY TO E IM STANDARDS N, STATE OF II	SHOWN BE FOR A
ILLINO LICEN THIS	SE EXI PROFE	DFESSIO	NOVEMB L SERV	AND SURVEYOR NO ER 30, 2012 ICE CONFORMS TO			MUM STANDARI	DS FOR A
	TES:	SURVEI		l <b>idwest Technico</b> 1805 N. MILL Naperville, 1 (630)	<b>al Consulto</b> STREET <b>,</b> SU LLINOIS 60 505-0101	<b>ants, Inc.</b> ITE L 0563		
	ALL C OUND.	OORDIN	NATES S	SHOWN HEREON A	RE PROJEC	T. ALL DISTANCES	S SHOWN HERE	ON ARE
			HOWN H D 83, 1	IEREON ARE BASE (2007).	ED ON ILLIN	OIS STATE PLANE	COORDINATE	SYSTEM
			ATION F	FACTOR USED FOR	THIS PRO	JECT = 0.999947	77.	
NA A	D83 (: ) DIVIE COM	2007) DE THE BINATIO	STATE STATE ON FAC	PLANE COORDINA PLANE NAD83 G TOR.	RID COORDII	NATES BY THE		
PR A	, OJECT ) ADD	COORI 1,000,	DINATES	00.00 FROM THES TO NAD83 (200 TO THE PROJECT COORDINATES BY	7) STATE P NORTHING	LANE COORDINAT 5 AND EASTINGS.		
				T HELD FOR THIS			R P.I.D. AA373	0.
			ţ	-		OF HIGHN E OF ILLIN		
	- ·				RTMENT	OF TRANS	PORTATIC	NN
2007) S.P. 327.5048 502.1293	-			SECTION FERF	RY RD. TO		DUPAGE CI NO. R-91-0	
(GROUND) 5.1449	-		c.				STATION 94	
.5948			#D 01 035 00	SCALE: I	= 40'	SHE		DF <u>47</u>
10			a 4		201	OF LAND ACQL WEST CENTER C RG, ILLINOIS 60	OURT	
: JB				-	FRACT 6		ET 566 0	F 1156

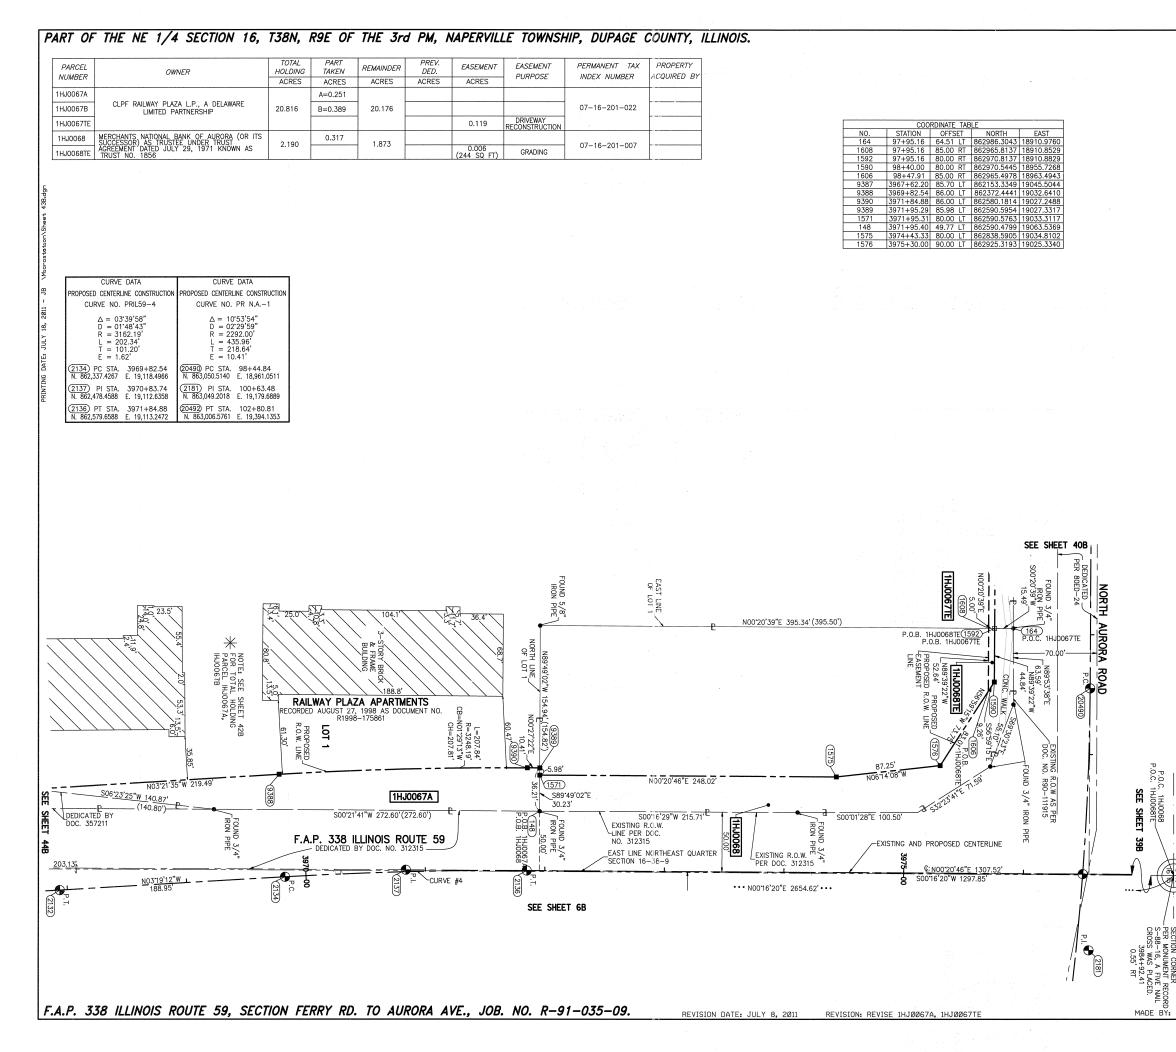


	LEGEND	
9 10 16 15 SECTION CORNER		GENER SECTION SOLUTION
QU/ QU/ QU/	CTION LINE ARTER SECTION LINE ARTER, QUARTER SECTION LINE ATTED LOT LINE	BASED ON ILLINOIS COORDIMATE SYSTEM
APLAPI	DPERTY (DEED) LINE PARENT PROPERTY LINE NTERLINE	. ARE BA LANE CO NE, N.A.I
EXI PR 	STING RIGHT OF WAY LINE DPOSED RIGHT OF WAY LINE DPOSED EASEMENT STING ACCESS CONTROL LINE DPOSED ACCESS CONTROL LINE	BEARINGS ARE STATE PLANE C EAST ZONE, N.,
<i>\\\\\\\\\\\\\\\\\\\\\\\\\\\\\\\\\\\\\</i>	ISTING BUILDING 0	40 80 120
WOC	NIN LINK FENCE DD FENCE ICE LINE ROD FOUND O SE	SCALE : 1" = 40' ET 5/8" × 30" REBAR
+ CUT CROSS FOL		DUND PK NAIL OPK SET PK NAIL
T2 SET 5/8 INCH	REFERENCE FOUND OR SET M REBAR FLUSH WITH GROUND PLASTIC CAP AND BEARING	MONUMENTATION. TO THE FOUND IRON STAKE, IDENTIFIED SURVEYORS PROFESSIONAL NUMBER.
BT2 BURIED 5\8 INC	CH REBAR 20 INCHES BELOW	RENCE FOUND OR SET MONUMENTATION. GROUND TO TIE FOUND IRON STAKE. NG SURVEYORS PROFESSIONAL NUMBER.
SET DIVISION OF		TO MONUMENT THE POSITION SHOWN. YORS PROFESSIONAL NUMBER.
		ILTIVATED AREAS. 9 GROUND TO MARK FUTURE SURVEY 9 PLASTIC CAP BEARING SURVEYORS
e e	RVEY MARKER. IDOT STD. 213	
STATE OF ILLINOIS)	STAKING PROPOSED TO BE SI	ET.
) SS COUNTY OF DUPAGE)		
PROFESSIONAL DESIGN FIRM I SHOWN HEREON BETWEEN SEL TOWNSHIP 38 NORTH, RANGE THAT THE SURVEY IS TRUE BELIEF, THAT THE PLAT COR AND ESTABLISHED ARE OF P AND THAT THE MONUMENTS SURVEY CONFORMS TO THE MADE FOR THE DEPARTMENT	ARE SUFFICIENT TO ENABLE CURRENT ILLINOIS MINIMUM ST OF TRANSPORTATION, STATE	RVEYED THE PLAT OF HIGHWAYS H, RANCE 9 EAST, AND SECTION IG, CIPAL MERIDIAN, DUPAGE COUNTY, D THE BEST OF MY KNOWLEDGE AND URVEY, THAT ALL MONUMENTS FOUND UPY THE POSITIONS SHOWN THEREON THE SURVEY TO BE RETRACED. THIS ANDARDS FOR A BOUNDARY SURVEY. OF ILLINOIS.
DATED AT NAPERVILLE, ILLIN	UIS THIS DAY OF	, 2011 A.D.
	30, 2012	ILLINOIS MINIMUM STANDARDS FOR A
BOUNDARY SURVEY.	Midwest Technical Cons 1805 N. MILL STREET,	SUITE L
NOTES: 1) ALL COORDINATES GROUND.	(630)505-010	60563
2) BEARINGS SHOWN SYSTEM EAST ZONE, I		IOIS STATE PLANE COORDINATE
	FACTOR USED FOR THIS PRO	JECT = 0.99994777.
A) DIVIDE THE STATE	PLANE COORDINATES TO PRO E PLANE NAD83 GRID COORDI	
	000.00 FROM THESE NORTHIN	IGS AND EASTINGS. PLATS & LEGALS
A) ADD 1,000,000.00 B) MULTIPLY THESE	S TO NAD83 (2007) STATE P D TO THE PROJECT NORTHING COORDINATES BY THE COMBIN	S AND EASTINGS. NATION FACTOR.
		IS IS FIRST ORDER P.I.D. AA3730.
NAD83 (2007) S.P. N 1 869 327 5048 #	STATE	OF ILLINOIS OF TRANSPORTATION
	F.A.P. 338	ILLINOIS ROUTE 59
PROJECT (GROUND)	SECTION FERRY RD. TO AL PROJECT: ROUTE 59	JOB NO. R-91-035-09
MONUMENT AT	STATION 3968+50 SCALE: I" = 40'	TO STATION 3976+50 SHEET <u>43B</u> OF <u>47</u>
AT H	BUREAU C	DF LAND ACQUISITION EST CENTER COURT
JB B	SCHAUMBURG	S, ILLINOIS 60196-1096

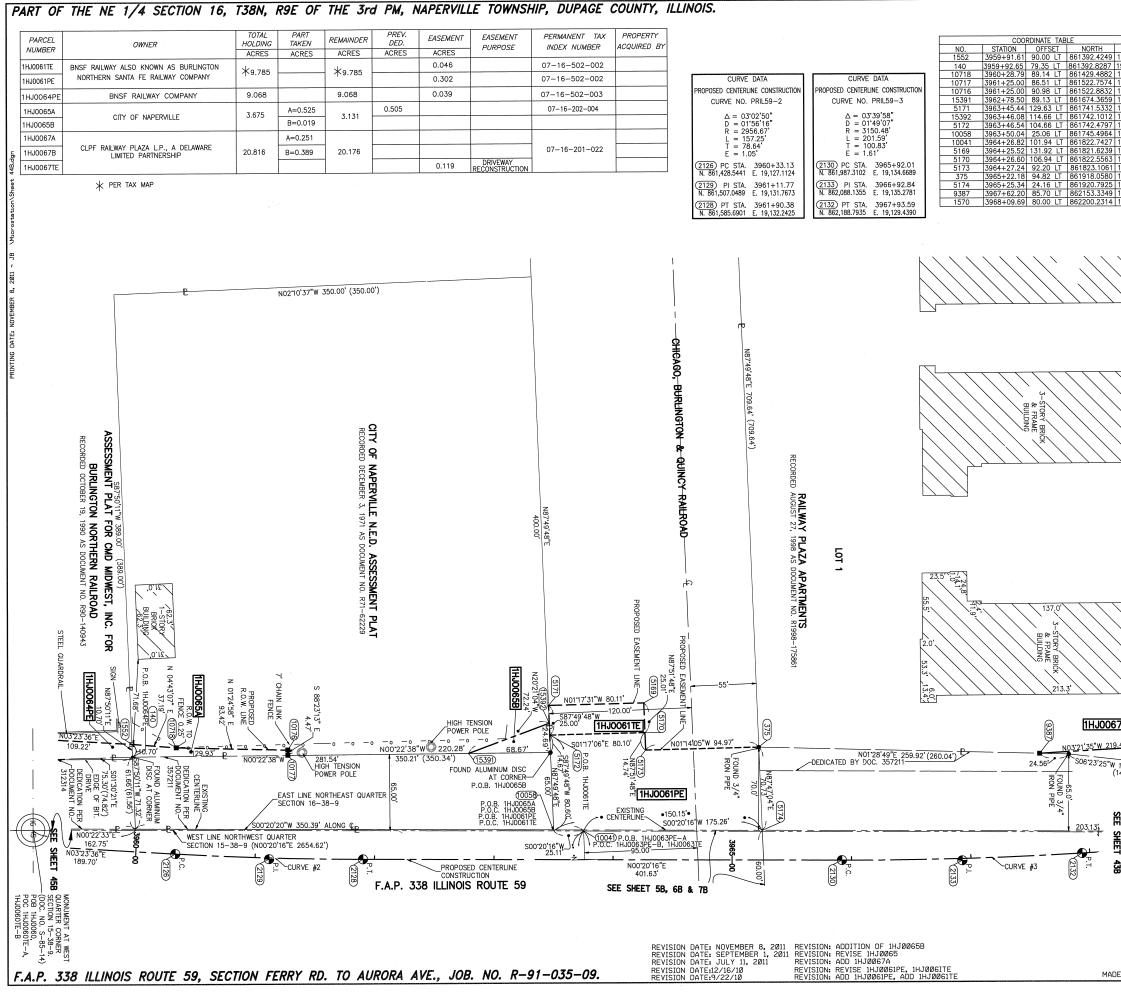


				LE	gend			
EAST 19034.81 19045.50	13		SECTION L		-(	(16 15))- 3	QUARTER SECTION CORNER	BASED ON ILLINOIS COORDINATE SYSTEM .A.D. 83 (2007)
19037.87 19044.64 19040.18 19043.64 19003.55 19018.54 19028.53 19108.14 19031.73 19001.74 19026.73 19041.47 19039.42	462	P APL APL APL AC AC 	QUARTER, PLATTED I PROPERTY APPARENT EXISTING O PROPOSED EXISTING F PROPOSED EXISTING A	(DEED) LINE PROPERTY LI CENTERLINE CENTERLINE RIGHT OF WAY EASEMENT ACCESS CONTF	NE LINE Y LINE ROL LINE	-		BEARINGS ARE BASED O STATE PLANE COORDINA EAST ZONE, N.A.D. 83 (
<u>19110.1(</u> 19045.5( 19048.64	)44	-0 -0 -0 IRON PIPE C		CE E UND		40 <i>SCAL</i> ET 5/8" × OUND PK N	E : 1" = 30" REBA	80 120 <i>40'</i> R PK SET PK NAIL
$\langle \rangle$	• TI T2 T3	THESE STAK SET 5/8 IN BY COLORE	CES REFER CH REBAR D PLASTI	ENCE FOUND FLUSH WITH C CAP AND	OR SET GROUND BEARING	MONUMENTA TO TIE FOU SURVEYOR	TION. JND IRON S PROFE	STAKE. IDENTIFIED SSIONAL NUMBER.
$\sum$	BTI     BT2     BT3	THESE STAK BURIED 5\8 IDENTIFIED E	ES, IN CUI INCH REE BY COLORE	LTIVATED AR 3AR 20 INCH 2D PLASTIC 1	EAS, REFE ES BELOW CAP BEARII	RENCE FOU GROUND NG SURVEY	ND OR SE TO TIE FO ORS PROF	T MONUMENTATION. DUND IRON STAKE. ESSIONAL NUMBER.
	•	SET DIVISIO	N OF HIGH BY INSCRIP	TION DATA	Y MARKEF AND SURVE	EYORS PROP	ESSIONAL	POSITION SHOWN. NUMBER.
$\overline{/}$	M M	BURIED 5/8	S INCH RE	ENTIFIED B	HES BELO	N GROUND	TO MARK	FUTURE SURVEY ARING SURVEYORS
$\langle \rangle$	•			MARKER. IDO <sup>.</sup> NG PROPOSEI			SET BY O	THERS)
$\langle \rangle$	STATE OF IL	) SS						
F SS T T E V V S N	PROFESSIONA SHOWN HERE FOWNSHIP 34 THAT THE S BELIEF, THA AND ESTABL AND THAT T SURVEY CON MADE FOR	ISHED ARE C	RM NUMBE SECTION NGE 9 EAS RUE AND C CORRECTL F PERMAN ITS ARE S HE CURRE IENT OF T	R 184-002917 15, TOWNSHI ST OF THE COMPLETE AS Y REPRESEN IENT QUALITY UFFICIENT T NT ILLINOIS RANSPORTAT	, HAVE SU 38 NORT THIRD PRIN 5 SHOWN T ITS SAID S 7 AND OCC 0 ENABLE MINIMUM S ION, STAT	JRVEYED TH H, RANGE CIPAL MERI O THE BESS SURVEY, TH CUPY THE F THE SURVE TANDARDS E OF ILLING	HE PLAT ( 9 EAST, A DIAN, DUP 5T OF MY AT ALL N POSITIONS EY TO BE FOR A BC	DF HIGHWAYS IND SECTION 16, AGE COUNTY, KNOWLEDGE AND IONUMENTS FOUND SHOWN THEREON RETRACED. THIS UNDARY SURVEY,
	RUSSELL W. LLINOIS PRO	OLSEN DFESSIONAL L PIRES NOVEM	AND SURV	EYOR NO. 0	35-002718			TANDARDS FOR A
	THIS PROFES	SSIONAL SERV		о̀кти́я то тн dwest Tech 1805 N. Mi	nical Con	sultants,		TANDARDS FOR A
$\langle \rangle$	NOTES: 1) ALL COO GROUND.	ORDINATES SI	HOWN HER	Napervili (6	'⊖, ILLINOIS 30)505-01	5 60563 Ol	ES SHOWN	HEREON ARE
Ζ,	2) BEARING	GS SHOWN HI 83, (2007).		E BASED ON	ILLINOIS S	STATE PLAN	NE COORD	NATE SYSTEM EAST
	,	MBINATION F		ED FOR THIS	PROJECT	= 0.99994	1777.	
<u>49'</u> <u>506'2.</u> 140.87' 40.88')	<ul> <li>A) DIVIDE</li> <li>COMBI</li> </ul>	007) STATE F THE STATE NATION FACT ACT 1,000,00	PLANE NA OR.	D83 GRID CO	DORDINATE	S BY THE	GS.	NOV 0 8 2011
1	A) ADD 1 B) MULTIF	COORDINATES ,000,000.00 PLY THESE C	TO THE PE OORDINATE	ROJECT NOR S BY THE C	THINGS AN OMBINATIC	D EASTING N FACTOR.	S.	_ATS & LEGALS
	5) THE NG	S MONUMENT	HELD FO	R THIS PRO.	PLAT	OF HIC	GHWAY	S
	N. 1,869 E. 1,023 PROJECT	(2007) S.P. 9,327.5048 3,602.1293 T (GROUND) 425.1449 55.5948	PR 60 ST	F.A. CTION FERRY OJECT: RC ATION 395	TMENT P. 338 RD. TO A UTE 59	ILLINO	ANSPO IS ROU I. DI JOB NO	RTATION
E BY: J	IB		-IOB #R-9I-		BUREAU 201 W	OF LAND VEST CENT RG, ILLINOI	ACQUISIT	 ION T
			I	CONTI	RACT 6	0R30	SHEET	568 OF 1156

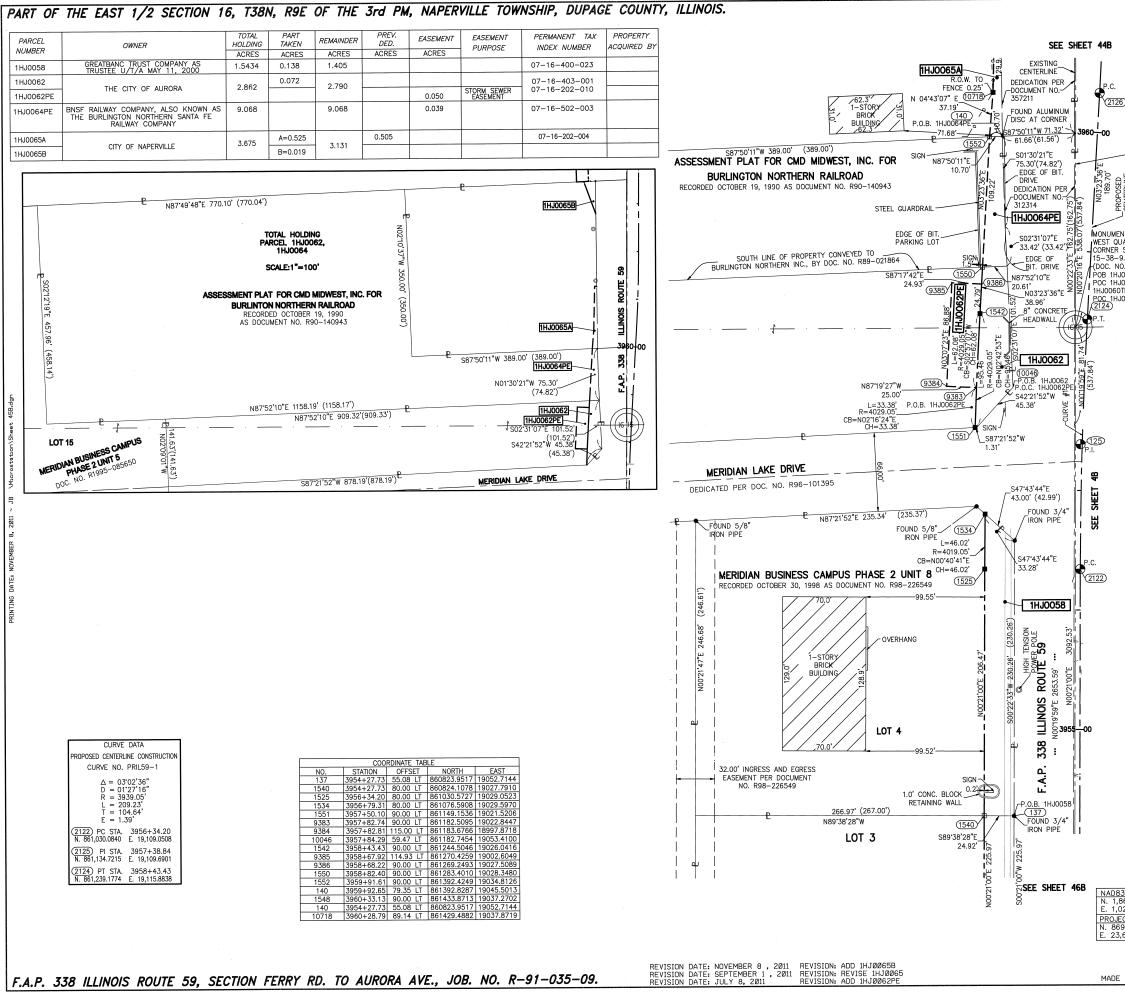


<u>୍</u>			LEGEND
(3) West line Northwest Quarter Section 15-38-9 (No0'20'16"e 2654.62'			NON ER SECTION LINE DUARTER SECTION LINE DUARTER, OLARTER SECTION LINE PROPERTY (DEED) LINE DOLARTER SECTION LINE PROPERTY (DEED) LINE
			APPARENT PROPERTY LINE CENTERLINE EXISTING RIGHT OF WAY LINE PROPOSED RASEMENT EXISTING ACCESS CONTROL LINE EXISTING ACCESS CONTROL LINE RECORD DATA
CENTERLINE		е • • - • — с	EXISTING BUILDING CHAIN LINK FENCE NOOD FENCE SCALE : 1" = 40'
INT AT JARTER SECTION 9.	• •	IRON PIPE OR	ENCE LINE
0. S-85 J0060, J0060TE- DTE-B		SET 5/8 INCH BY COLORED	ES REFERENCE FOUND OR SET MONUMENTATION. H REBAR FLUSH WITH GROUND TO TIE FOUND IRON STAKE. IDENTIFIED D PLASTIC CAP AND BEARING SURVEYORS PROFESSIONAL NUMBER.
J0064PE	BT2 BT3	BURIED 5\8 IDENTIFIED BY	IS, IN CULTIVATED AREAS, REFERENCE FOUND OR SET MONUMENTATION. INCH REBAR 20 INCHES BELOW GROUND TO TIE FOUND IRON STAKE. Y COLORED PLASTIC CAP BEARING SURVEYORS PROFESSIONAL NUMBER.
		SET DIVISION	PROPOSED RIGHT OF WAY. OF HIGHWAYS SURVEY MARKER TO MONUMENT THE POSITION SHOWN. Y INSCRIPTION DATA AND SURVEYORS PROFESSIONAL NUMBER.
	M	BURIED 5/8	PROPOSED RIGHT OF WAY IN CULTIVATED AREAS. INCH REBAR 20 INCHES BELOW GROUND TO MARK FUTURE SURVEY SITION. IDENTIFIED BY COLORED PLASTIC CAP BEARING SURVEYORS L NUMBER.
	STATE OF	RIGHT OF WA	SURVEY MARKER. IDOT STD. 2135 (TO BE SET BY OTHERS) AY STAKING PROPOSED TO BE SET.
	COUNTY O	) SS F DUPAGE)	
	PROFESSIO SHOWN HEI TOWNSHIP THAT THE BELIEF, TH FOUND ANI THEREON RETRACED. BOUNDARY	NAL DESIGN F. REON BETWEEN 38 NORTH, RA SURVEY IS TI HAT THE PLAT D ESTABLISHEL AND THAT THE . THIS SURVE SURVEY. MA	AT WE, MIDWEST TECHNICAL CONSULTANTS, INC., AN ILLINOIS IMM NUMBER 184-002917, HAVE SURVEYED THE PLAT OF HIGHWAYS N SECTION 15, TOWNSHIP 38 NORTH, RANGE 9 EAST, AND SECTION 16, ANGE 9 EAST OF THE THIRD PRINCIPAL MERIDIAN, DUPAGE COUNTY, RUE AND COMPLETE AS SHOWN TO THE BEST OF MY KNOWLEDGE AND "CORRECTLY REPRESENTS SAID SURVEY, THAT ALL MONUMENTS D ARE OF PERMANENT OULALITY AND OCCUPY THE POSITIONS SHOWN E MONUMENTS ARE SUFFICIENT TO ENABLE THE SURVEY TO BE EY CONFORMS TO THE CURRENT ILLINOIS MINIMUM STANDARDS FOR A ADE FOR THE DEPARTMENT OF TRANSPORTATION, STATE OF ILLINOIS. ILLINOIS THIS DAY OF, 2011 A.D.
	LICENSE E	ROFESSIONAL L XPIRES NOVEM ESSIONAL SER SURVEY.	VICE CONFORMS TO THE CURRENT ILLINOIS MINIMUM STANDARDS FOR A
	NOTES:		Midwest Technical Consultants, Inc. 1805 N. MILL STREET, SUITE L Naperville, ILLINOIS 60563 (630)505-0101
	GROUNE	).	SHOWN HEREON ARE PROJECT. ALL DISTANCES SHOWN HEREON ARE
	EAST Z	ONE, NAD 83,	
		COMBINATION	FACTOR USED FOR THIS PROJECT = 0.99994777. VERSION
	A) DIV CO	NDE THE STAT	E PLANE COORDINATES TO PROJECT COORDINATES: TE PLANE NADB3 GRID COORDINATES BY THE CTOR. ,000.00 FROM THESE NORTHINGS AND EASTINGS. NOV 08 2011
	A) AD	D 1,000,000.0	ES TO NAD83 (2007) STATE PLANE COORDINATES: <b>PLATS &amp; LEGALS</b> 10 TO THE PROJECT NORTHINGS AND EASTINGS. COORDINATES BY THE COMBINATION FACTOR.
	5) THE	NGS MONUME	ENT HELD FOR THIS PROJECT IS IS FIRST ORDER P.I.D. AA3730.
3 (200	7) S.P.		PLAT OF HIGHWAYS STATE OF ILLINOIS DEPARTMENT OF TRANSPORTATION F.A.P. 338 ILLINOIS ROUTE 59
869,327 023,602 ECT (GR	.5048 .1293 OUND)		PROJECT: ROUTE 59 JOB NO. R-9I-035-09
9,425.1 ,655.59			SCALE: I" = 40' SHEET <u>45B</u> OF 47
			BUREAU OF LAND ACQUISITION 201 WEST CENTER COURT SCHAUMBURG, ILLINOIS 60196-1096
BY: JI	8		CONTRACT 60R30 SHEET 569 OF 1150

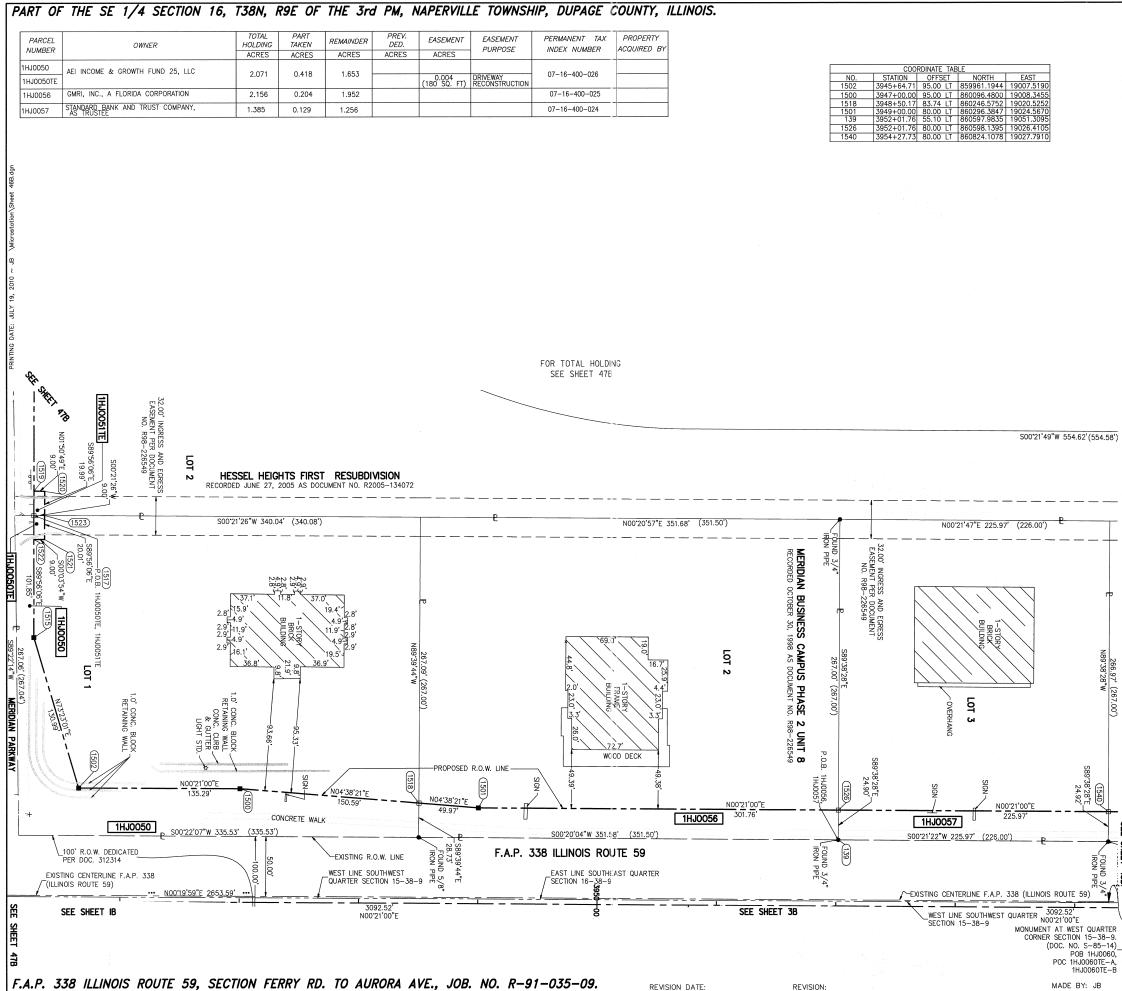

		LE	GEND			
		TION LINE RTER SECTION LINE		QUARTER - SECTION CORNER	BASED ON ILLINOIS COORDINATE SYSTEM .A.D. 83 (2007)	
	PLA PROI	RTER, QUARTER SEC TTED LOT LINE PERTY (DEED) LINE			RE BASED IE COORDI N.A.D. 8	
	CEN EXIS PRO PRO PRO PRO CAC PRO EXIS PRO	ARENT PROPERTY LI TERLINE TING RIGHT OF WAY POSED RIGHT OF WA POSED EASEMENT TING ACCESS CONTR POSED ACCESS CONT ORD DATA	LINE Y LINE OL LINE		BEARINGS AN STATE PLAN EAST ZONE,	
	EXIS	STING BUILDING	0	40 80	) 1	120
	-[] —[] — WOOD	N LINK FENCE D FENCE E LINE	SC	ALE : 1" =	40'	3
• +	IRON PIPE OR RO		O SET 5∕8" ●PK FOUND PK	× 30" REBAR	K SET PK N	AIL
• TI T2 T3	SET 5/8 INCH R	EBAR FLUSH WITH	OR SET MONUMEN GROUND TO TIE F BEARING SURVEY	TATION. FOUND IRON S	TAKE. IDENT	IFIED
	2 BURIED 5\8 INC 3 IDENTIFIED BY C	H REBAR 20 INCH OLORED PLASTIC C	EAS, REFERENCE F ES BELOW GROUND AP BEARING SURVI	) TO TIE FOU	ND IRON ST	AKE.
•	SET DIVISION OF	ISCRIPTION DATA A	Y MARKER TO MOI ND SURVEYORS PP	ROFESSIONAL N		OWN.
M		H REBAR 20 INCH DN. IDENTIFIED BY	WAY IN CULTIVATE IES BELOW GROUN COLORED PLAST		FUTURE SUF ING SURVEN	RVEY YORS
$\bullet$	PERMANENT SUR	VEY MARKER. IDOT	STD. 2135 (TO B	E SET BY OTH	IERS)	
STATE OF ILLING	DIS)	STAKING PROPOSED	TO BE SET.			
COUNTY OF DUP	) SS AGE)					
DESIGN FIRM LAN HIGHWAYS SHOWN IO, TOWNSHIP 38 THAT THE SURVE BELIEF, THAT TH AND ESTABLISHEI THAT THE MONUI CONFORMS TO T THE DEPARTMENT	ND SURVEYING COF I HEREON BETWEEI NORTH, RANGE 9 EY IS TRUE AND HE PLAT CORRECT D ARE OF PERMAL MENTS ARE SUFFI HE CURRENT ILLIN T OF TRANSPORT/	RPORATION NUMBER N SECTION 9, TOW EAST OF THE TH COMPLETE AS SHO LY REPRESENTS S NENT QUALITY AND CIENT TO ENABLE		SURVEYED T RANGE 9 EAS RIDIAN, DUPAGE OF MY KNOWL ALL MONUME SITIONS SHOWN BE RETRACED	HE PLAT OF T, AND SEC E COUNTY, EDGE AND NTS FOUND I THEREON A THIS SUR	- TION AND VEY
RUSSELL W. OLS ILLINOIS PROFESS LICENSE EXPIRES THIS PROFESSION BOUNDARY SURVI NOTES:	SIONAL LAND SURY NOVEMBER 30, 2 IAL SERVICE CONF EY. <i>Midwest</i> 18	/EYOR NO. 035-00 2010 ORMS TO THE CUI <sup>4</sup> <b>Technical Cons</b> 40 Centre Point perville, ILLINOIS (630)505-010	RRENT ILLINOIS MIN <b>cultants, Inc.</b> Circle 60563	IIMUM STANDAF	RDS FOR A	
1) ALL COO	RDINATES SHOWN		JECT. ALL DISTAN	CES SHOWN HI	EREON ARE	
	S SHOWN HEREON 83, (2007).	ARE BASED ON I	LLINOIS STATE PLA	ANE COORDINA	TE SYSTEM	EAST
		USED FOR THIS	PROJECT = 0.9999	4777.		
	IATE CONVERSION D7) STATE PLANE	COORDINATES TO	PROJECT COORDIN		JUL 20 2010	pe
COMBIN B) SUBTRA	ATION FACTOR. ACT 1,000,000.00	FROM THESE NOR	DRDINATES BY THE	NGS. PL	.ATE & LEGA	
A) ADD 1, B) MULTIPI	000,000.00 TO TH LY THESE COORDII	E PROJECT NORTH NATES BY THE CO	E PLANE COORDIN IINGS AND EASTING MBINATION FACTOF CT IS IS FIRST OR	GS. R.	7770	
		FOR THIS FROM	PLAT OF H		5750.	
	*468-47	DEPART	STATE OF MENT OF T	ILLINOIS	TATION	
<u> </u>	<sup>*</sup> DCN	F.A.1	P. 338 ILLING	OIS ROUTE	59	ITV
NAD83	(2007) S.P.	PROJECT: ROL STATION 3946		JOB NO.	AGE COUN R-9I-035- ION 3954+	09
/   E. 1,02	9,327.5048 3,602.1293 یخ <u>(GROUND)</u> 425.1449 ج	STATION 3946 SCALE:  " =		SHEET _		
N. 869,	55.5948 🛱		BUREAU OF LANL 201 WEST CEN	) ACQUISITION ITER COURT	N	
	BOL		ACT 60R30	OIS 60196-1 SHEET 5		115

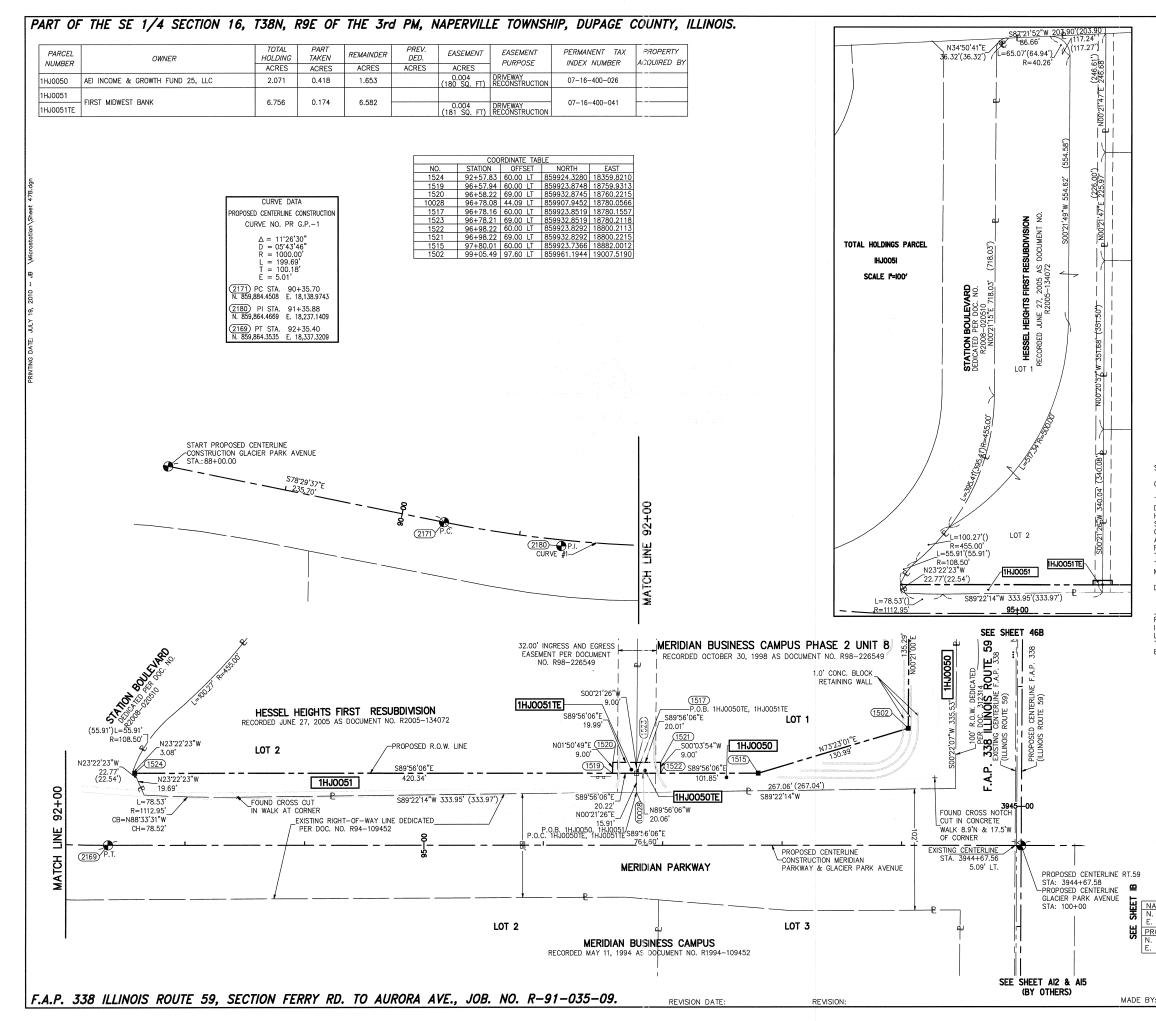


		LEGEND		
	SECTION CORNER		GUARTER SECTION CORNER	ILLINOIS E SYSTEM DO7)
	SECTION LINE QUARTER SECT QUARTER, QUAF PLATTED LOT PROPERTY (DEE	RTER SECTION LINE		RE BASED ON ILLINOIS VE COORDINATE SYSTE N.A.D. 83 (2007)
APL	<ul> <li>PROPOSED EAS</li> <li>EXISTING ACCES</li> </ul>	OF WAY LINE T OF WAY LINE		BEARINGS ARE STATE PLANE EAST ZONE, N.
	EXISTING BUIL — CHAIN LINK FEN — WOOD FENCE	0	40 8 SCALE : 1" =	0 120 40'
_	FENCE LINE FENCE LINE IPE OR ROD FOUND ROSS FOUND OR SE	_	5/8" x 30" REBAR	
● TI THESE T2 SET 5, T3 BY CO	STAKES REFERENCE /8 INCH REBAR FLU LORED PLASTIC C/	FOUND OR SET MO SH WITH GROUND TO AP AND BEARING SU	NUMENTATION. TIE FOUND IRON S JRVEYORS PROFES:	TAKE. IDENTIFIED SIONAL NUMBER.
<ul> <li>BTI THESE</li> <li>BT2 BURIED</li> <li>BT3 IDENTIF</li> </ul>	STAKES, IN CULTIVA 5\8 INCH REBAR IED BY COLORED PI	TED AREAS, REFERE 20 INCHES BELOW G ASTIC CAP BEARING	NCE FOUND OR SET ROUND TO TIE FOL SURVEYORS PROFE	MONUMENTATION. JND IRON STAKE. SSIONAL NUMBER.
SET DI		GHT OF WAY. S SURVEY MARKER T DATA AND SURVEYC		
BURIED	5/8 INCH REBAR	CHT OF WAY IN CULT 20 INCHES BELOW FIED BY COLORED	GROUND TO MARK	FUTURE SURVEY NNG SURVEYORS
	NENT SURVEY MARK	ER. IDOT STD. 2135	(TO BE SET BY OT	HERS)
RIGHT STATE OF ILLINOIS)	OF WAY STAKING PI	ROPOSED TO BE SET	•	
) SS COUNTY OF DUPAGE)	5			
THIS IS TO CERTIFY TH DESIGN FIRM LAND SUF HIGHWAYS SHOWN HERE'SECTION IG, TOWNSHIP COUNTY, THAT THE SU AND BELIEF, THAT THE FOUND AND ESTABLISHI THEREON AND THAT TH THIS SURVEY CONFORM MADE FOR THE DEPAR DATED AT NAPERVILLE,	ON BETWEEN SECTIG 38 NORTH, RANGE RVEY IS TRUE AND PLAT CORRECTLY ED ARE OF PERMAN IE MONUMENTS ARE S TO THE CURRENT FMENT OF TRANSPO	IN 15, TOWNSHIP 38 9 EAST OF THE THIF COMPLETE AS SHOW REPRESENTS SAID S ENT QUALITY AND O SUFFICIENT TO ENA ILLINOIS MINIMUM S' RTATION, STATE OF	NTS, INC., AN ILLINC 17, HAVE SURVEYED NORTH, RANGE 9 E. 20 PRINCIPAL MERIDI 10 TO THE BEST OF URVEY, THAT ALL 1 CCUPY THE POSITIOI BLE THE SURVEY T TANDARDS FOR A B ILLINOIS. , 2010 A.D.	AST, AND IAN, DUPAGE MY KNOWLEDGE MONUMENTS NS SHOWN O BE RETRACED. OUNDARY SURVEY.
RUSSELL W. OLSEN ILLINOIS PROFESSIONAL LICENSE EXPIRES NOVE THIS PROFESSIONAL SE BOUNDARY SURVEY.	MBER 30, 2010 RVICE CONFORMS TO <i>Midwest Techn</i>	D THE CURRENT ILLII ical Consultants. I		)ARDS FOR A
NOTES:		re Point Circle , ILLINOIS 60563 0)505-0101		
1) ALL COORDINATES GROUND.			STANCES SHOWN HE	EREON ARE
2) BEARINGS SHOWN EAST ZONE, NAD 83		ED ON ILLINOIS STAT	E PLANE COORDINA	TE SYSTEM
3) THE COMBINATION	I FACTOR USED FOR	R THIS PROJECT = C	).99994777.	
4) COORDINATE CON				ECEIVED
COMBINATION F	TE PLANE NAD83 G ACTOR.	TES TO PROJECT CO RID COORDINATES B SE NORTHINGS AND I	THE PLA	UL 20 2010
	DO TO THE PROJECT	7) STATE PLANE COU NORTHINGS AND EA THE COMBINATION FA	ASTINGS.	
5) THE NGS MONUM	ENT HELD FOR THIS	PROJECT IS IS FIRS	T ORDER P.I.D. AA3	3730.
	41B-41		F HIGHWAYS OF ILLINOIS	•
D83 (2007) S.P.		PARTMENT O		
1,869,327.5048 1,023,602.1293 OJECT (GROUND)		<i>F.A.P. 338 II</i> FERRY RD. TO AUR T: ROUTE 59		2 59 AGE COUNTY R-91-035-09
869,425.1449 23,655.5948	60	N 88+00	TO STAT	10N 100+20 47B 0F 47
	-6-8	BUREAU OF	LAND ACQUISITIO	
: JB	# 80		T CENTER COURT ILLINOIS 60196-1	096
	(	CONTRACT 60F	R30 SHEET	571 OF 115

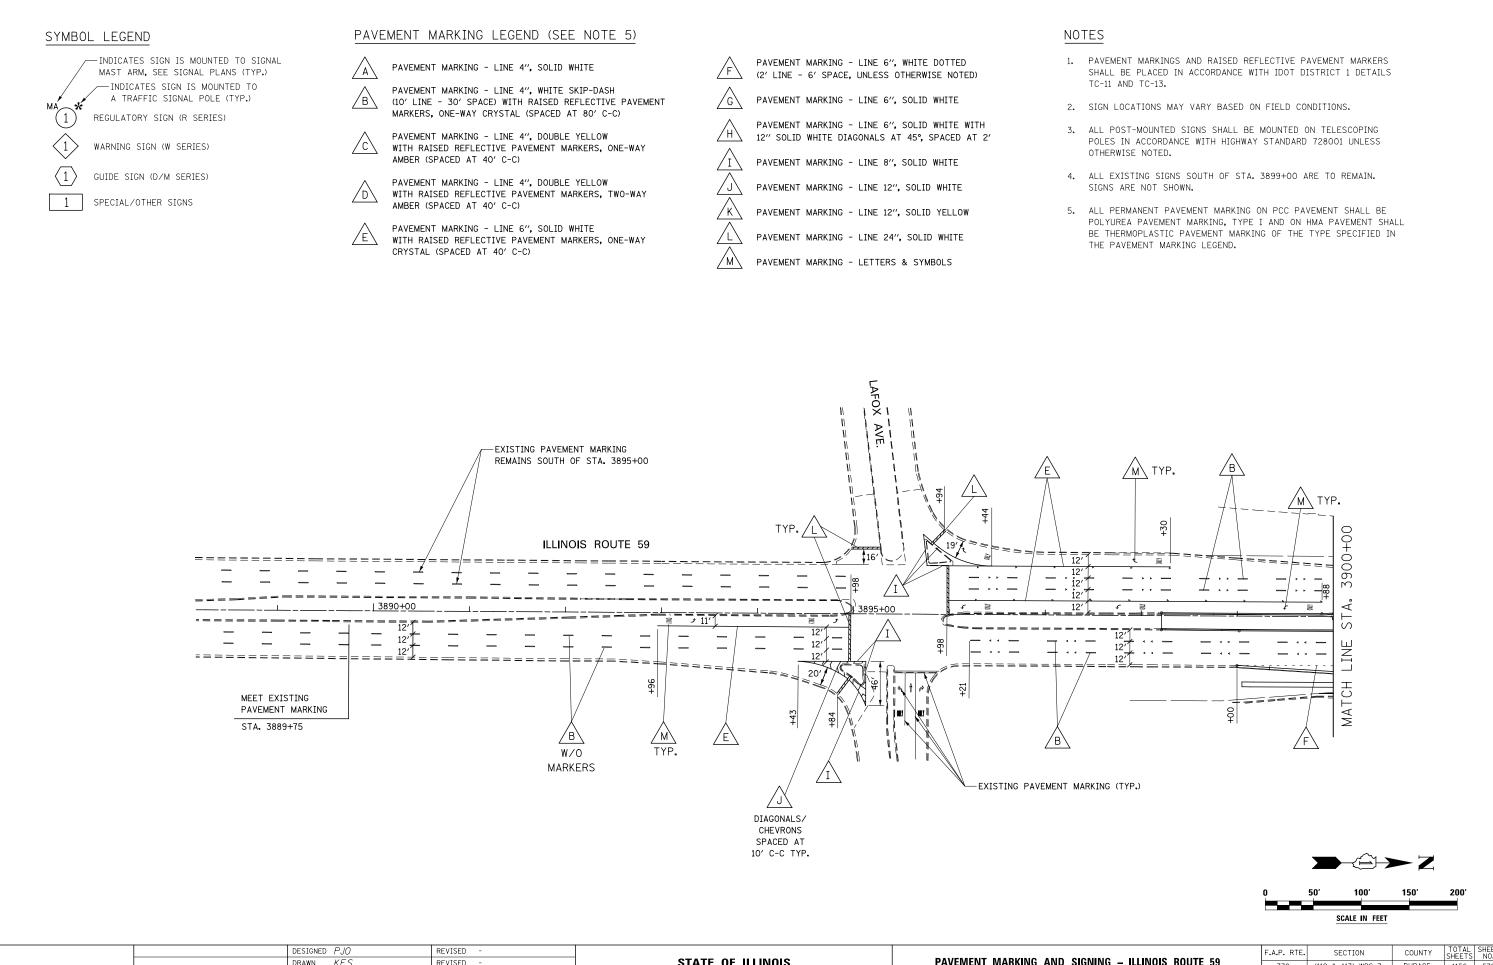

	, 00					
	DRAWN KES		REVISED -	STATE OF ILLINOIS	PAVEME	ENT MARKING AND SIGI
	CHECKED JCM		REVISED -	DEPARTMENT OF TRANSPORTATION		
	DATE 12/14/20	012	REVISED -		SCALE: AS SHOWN	SHEET NO. 1 OF 21 SHEET

	F.A.P. RTE.	SECTION	COUNTY	TOTAL SHEETS	SHEET NO.
NING – ILLINOIS ROUTE 59	338	(112 & 113) WRS-7	DUPAGE	1156	572
			CONTRACT	NO. 60	DR30
S STA. 3889+00 TO STA. 3900+00	ILLINOIS FED. AID PROJECT				

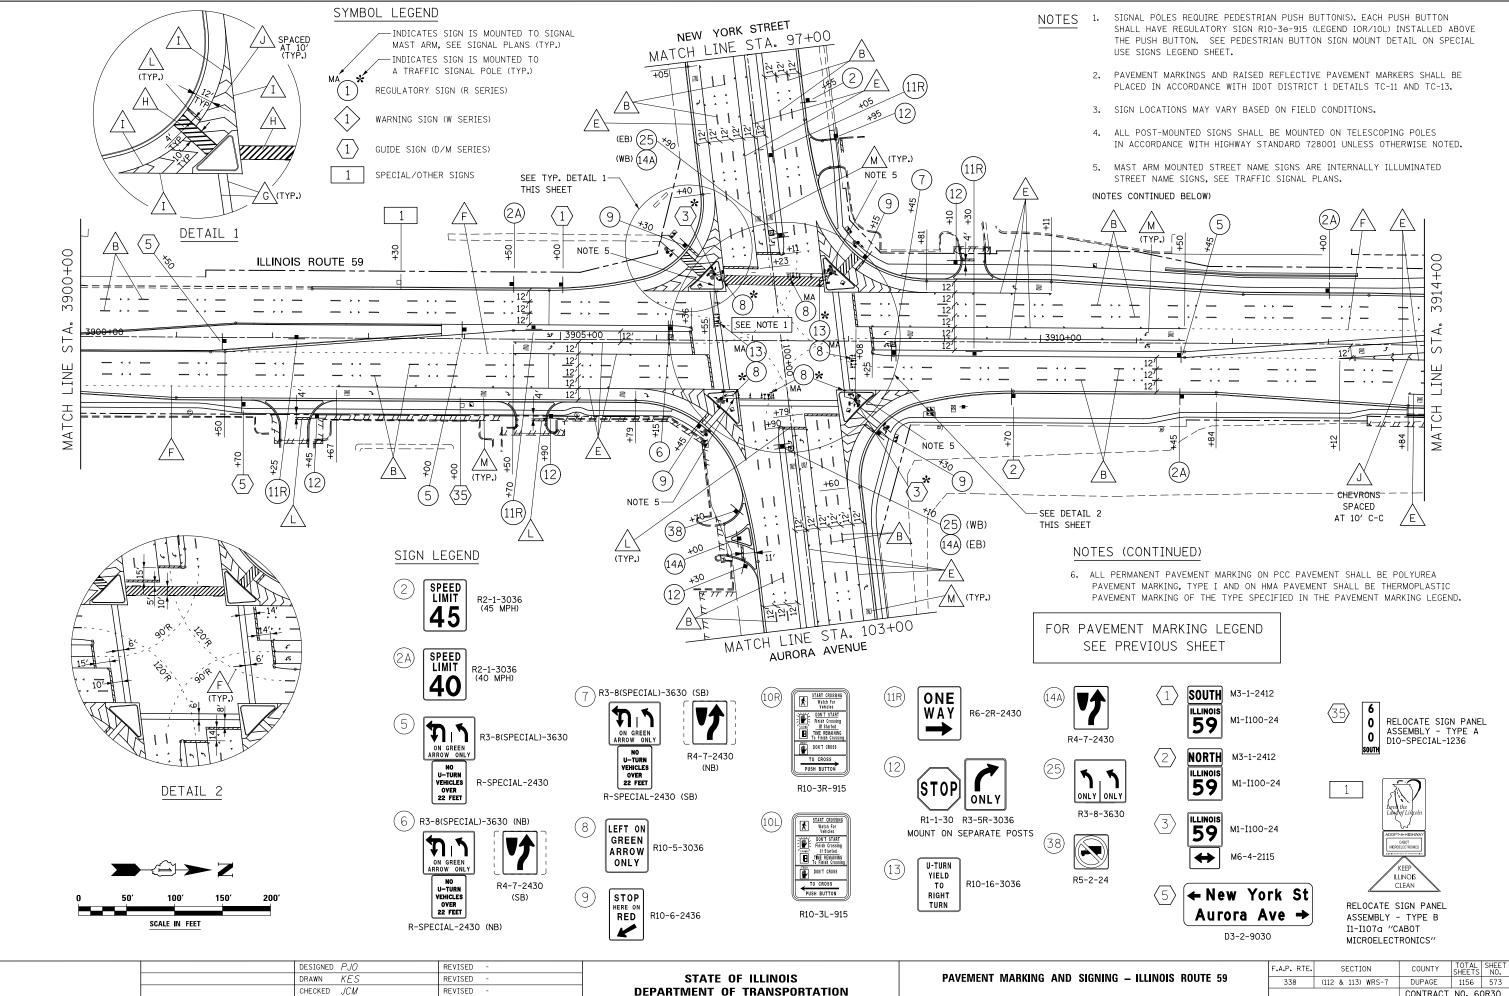


REVISED -	DEPARTMENT OF TRANSPORTATION		
REVISED -		SCALE: AS SHOWN	SHEET NO. 2 OF 21

12/14/2012

DATE

SHEETS

			DOUTE		F.A.P. RTE.	S	ECTION		COUNTY	SHEETS	SHEET NO.
ur	lG -	ILLINOIS	KUUTE	59	338	(112 &	113) WF	RS-7	DUPAGE	1156	573
									CONTRACT	NO. 60	JR30
S	STA.	3900+00	TO STA.	3914+00			ILLINOIS	S FED. AI	D PROJECT		

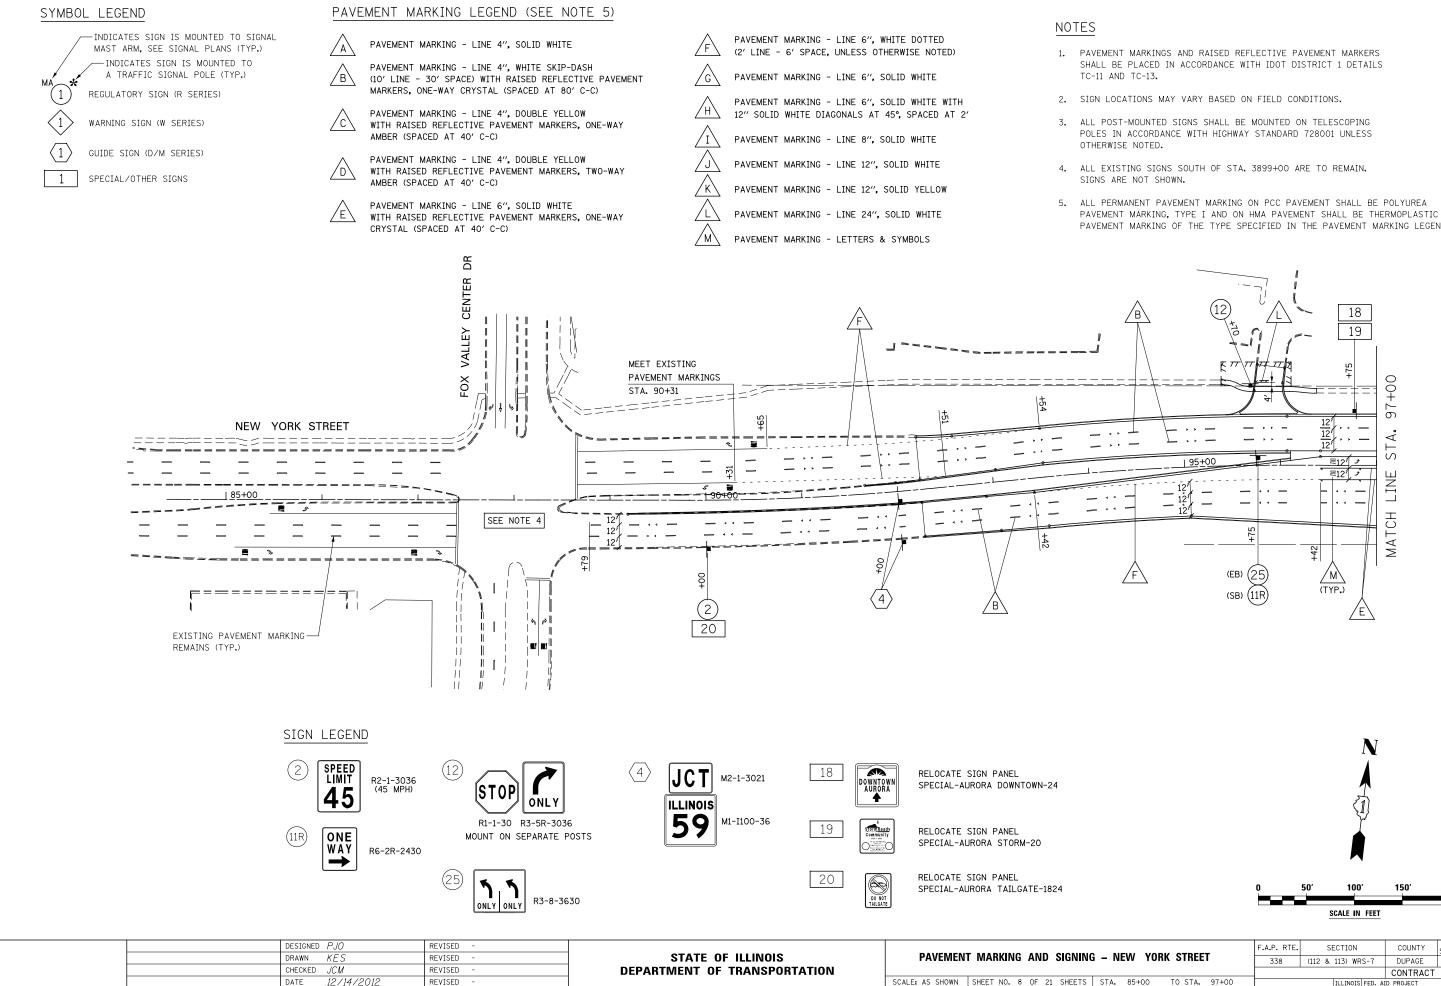

DATE


12/14/201

REVISED

PAVEMENT MARKING OF THE TYPE SPECIFIED IN THE PAVEMENT MARKING LEGEND.

200

				r	F.A.P. RTE.	SECTION	COUNTY	TOTAL SHEETS	SHEET NO.		
NG – NEW YORK STREET				I	338	(112 & 113) WRS-7	DUPAGE	1156	574		
							CONTRACT	NO. 60	OR30		
5	STA.	85+00	TO STA.	97+00	ILLINOIS FED. AID PROJECT						

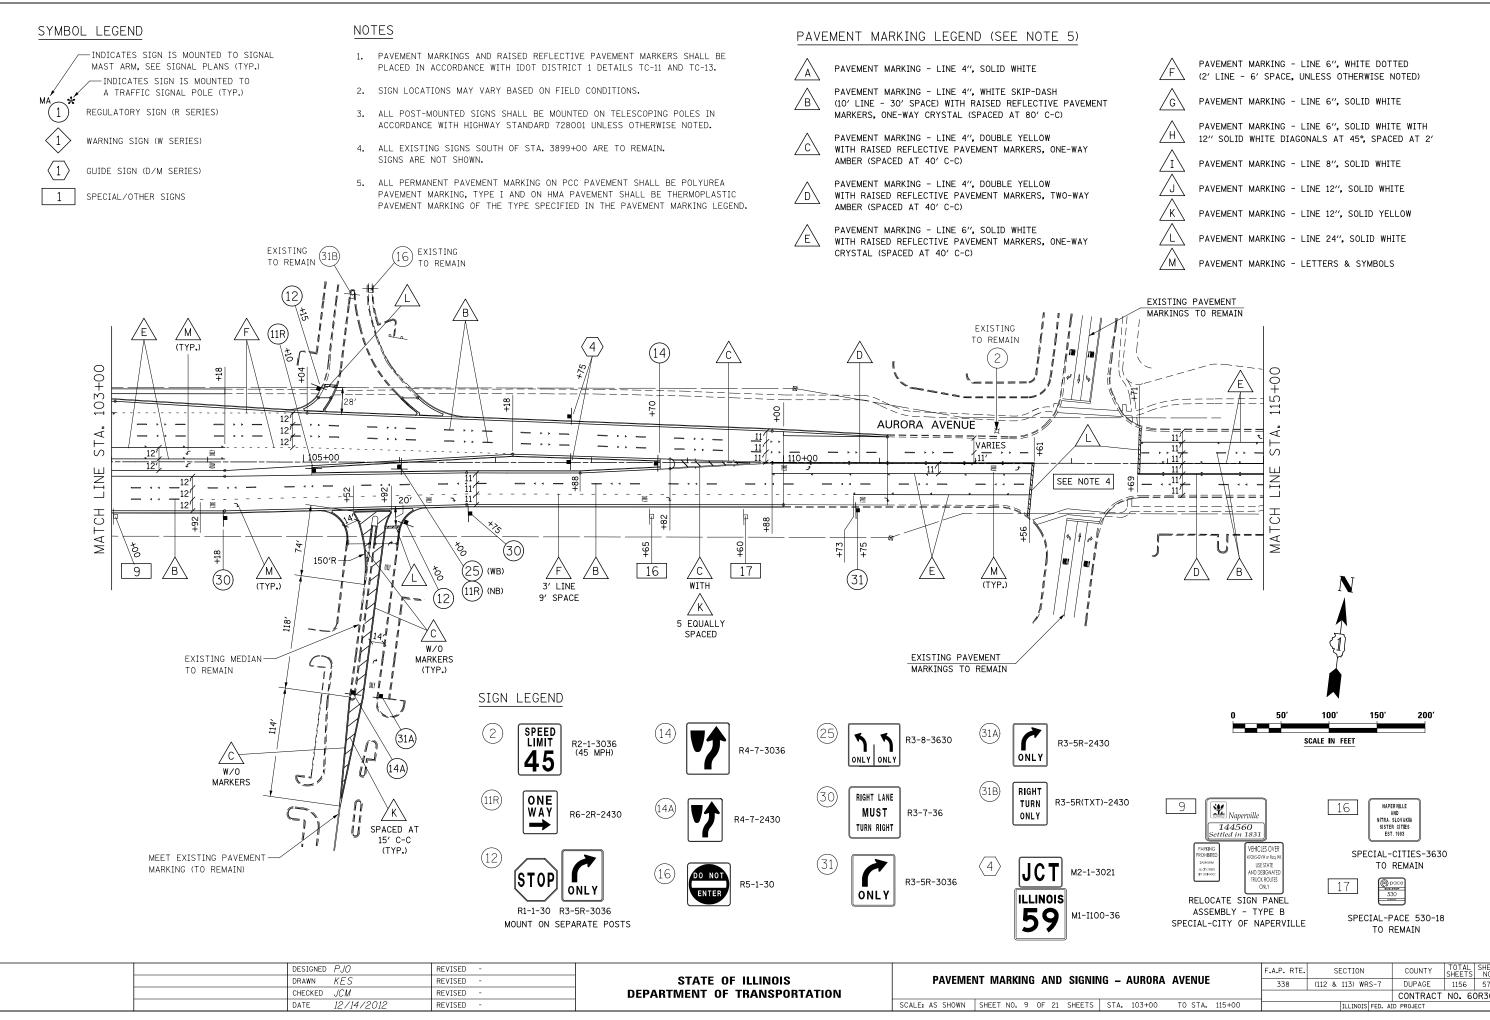

ING – AURUKA AVENUE 338 (112 & 113) WRS-7 DUPAGE 1156 575 CONTRACT NO. 60R30		F.A.P. RTE.	SECTION	COUNTY	TOTAL SHEETS	SHEET NO.	
CONTRACT NO. 60R30	ING – AURORA AVENUE	338	(112 & 113) WRS-7	DUPAGE	1156	575	
				CONTRACT	NO. 60	OR30	
S STA. 103+00 TO STA. 115+00 ILLINOIS FED. AID PROJECT	5 STA. 103+00 TO STA. 115+00	ILLINOIS FED. AID PROJECT					


# NOTES

- 1. PAVEMENT MARKINGS AND RAISED REFLECTIVE PAVEMENT MARKERS SHALL BE PLACED IN ACCORDANCE WITH IDOT DISTRICT 1 DETAILS TC-11 AND TC-13.
- 2. SIGN LOCATIONS MAY VARY BASED ON FIELD CONDITIONS,
- ALL POST-MOUNTED SIGNS SHALL BE MOUNTED ON TELESCOPING POLES IN ACCORDANCE WITH HIGHWAY STANDARD 728001 UNLESS OTHERWISE NOTED.
- 4. ALL EXISTING SIGNS SOUTH OF STA. 3899+00 ARE TO REMAIN. SIGNS ARE NOT SHOWN.
- 5. ALL PERMANENT PAVEMENT MARKING ON PCC PAVEMENT SHALL BE POLYUREA PAVEMENT MARKING, TYPE I AND ON HMA PAVEMENT SHALL BE THERMOPLASTIC PAVEMENT MARKING OF THE TYPE SPECIFIED IN THE PAVEMENT MARKING LEGEND.

# PAVEMENT MARKING LEGEND (SEE NOTE 5)

- PAVEMENT MARKING LINE 4", SOLID WHITE / A \ PAVEMENT MARKING - LINE 4", WHITE SKIP-DASH /в\ (10' LINE - 30' SPACE) WITH RAISED REFLECTIVE PAVEMENT MARKERS, ONE-WAY CRYSTAL (SPACED AT 80' C-C) PAVEMENT MARKING - LINE 4", DOUBLE YELLOW
- /c\ WITH RAISED REFLECTIVE PAVEMENT MARKERS, ONE-WAY AMBER (SPACED AT 40' C-C)
- PAVEMENT MARKING LINE 4", DOUBLE YELLOW WITH RAISED REFLECTIVE PAVEMENT MARKERS, TWO-WAY / D \ AMBER (SPACED AT 40' C-C)
- PAVEMENT MARKING LINE 6", SOLID WHITE EWITH RAISED REFLECTIVE PAVEMENT MARKERS, ONE-WAY CRYSTAL (SPACED AT 40' C-C)

F	PAVEMENT (2′ LINE -	
G	PAVEMENT	MARKIN
H	PAVEMENT 12″ SOLID	
I	PAVEMENT	MARKIN
Ĺ	PAVEMENT	MARKIN
K	PAVEMENT	MARKIN
	PAVEMENT	MARKIN

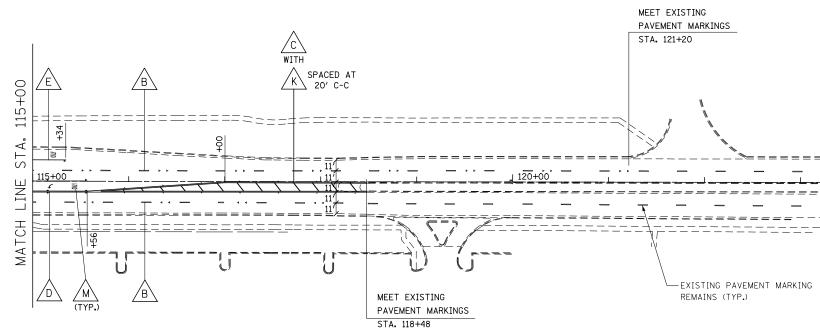

DESIGNED PJO	REVISED -			F.A.P. RTE.	SECTION	COUNTY	TOTAL SHEET SHEETS NO.
DRAWN KES	REVISED -	STATE OF ILLINOIS	PAVEMENT MARKING AND SIGNING – AURORA AVENUE	338	(112 & 113) WRS-7	DUPAGE	1156 576
CHECKED JCM	REVISED -	DEPARTMENT OF TRANSPORTATION				CONTRACT	T NO. 60R30
DATE 12/14/2012	REVISED -		SCALE: AS SHOWN SHEET NO. 10 OF 21 SHEETS STA. 115+00 TO STA. 123+00		ILLINOIS FED. AI	D PROJECT	

NG - LINE 6", WHITE DOTTED ACE, UNLESS OTHERWISE NOTED)

NG - LINE 6", SOLID WHITE

NG - LINE 6", SOLID WHITE WITH DIAGONALS AT 45°, SPACED AT 2'

NG - LINE 8", SOLID WHITE

NG - LINE 12", SOLID WHITE


NG - LINE 12", SOLID YELLOW


NG - LINE 24", SOLID WHITE


M PAVEMENT MARKING - LETTERS & SYMBOLS


\_


AURORA AVENUE

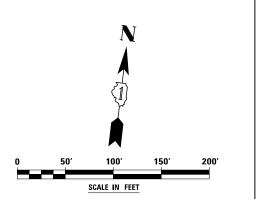

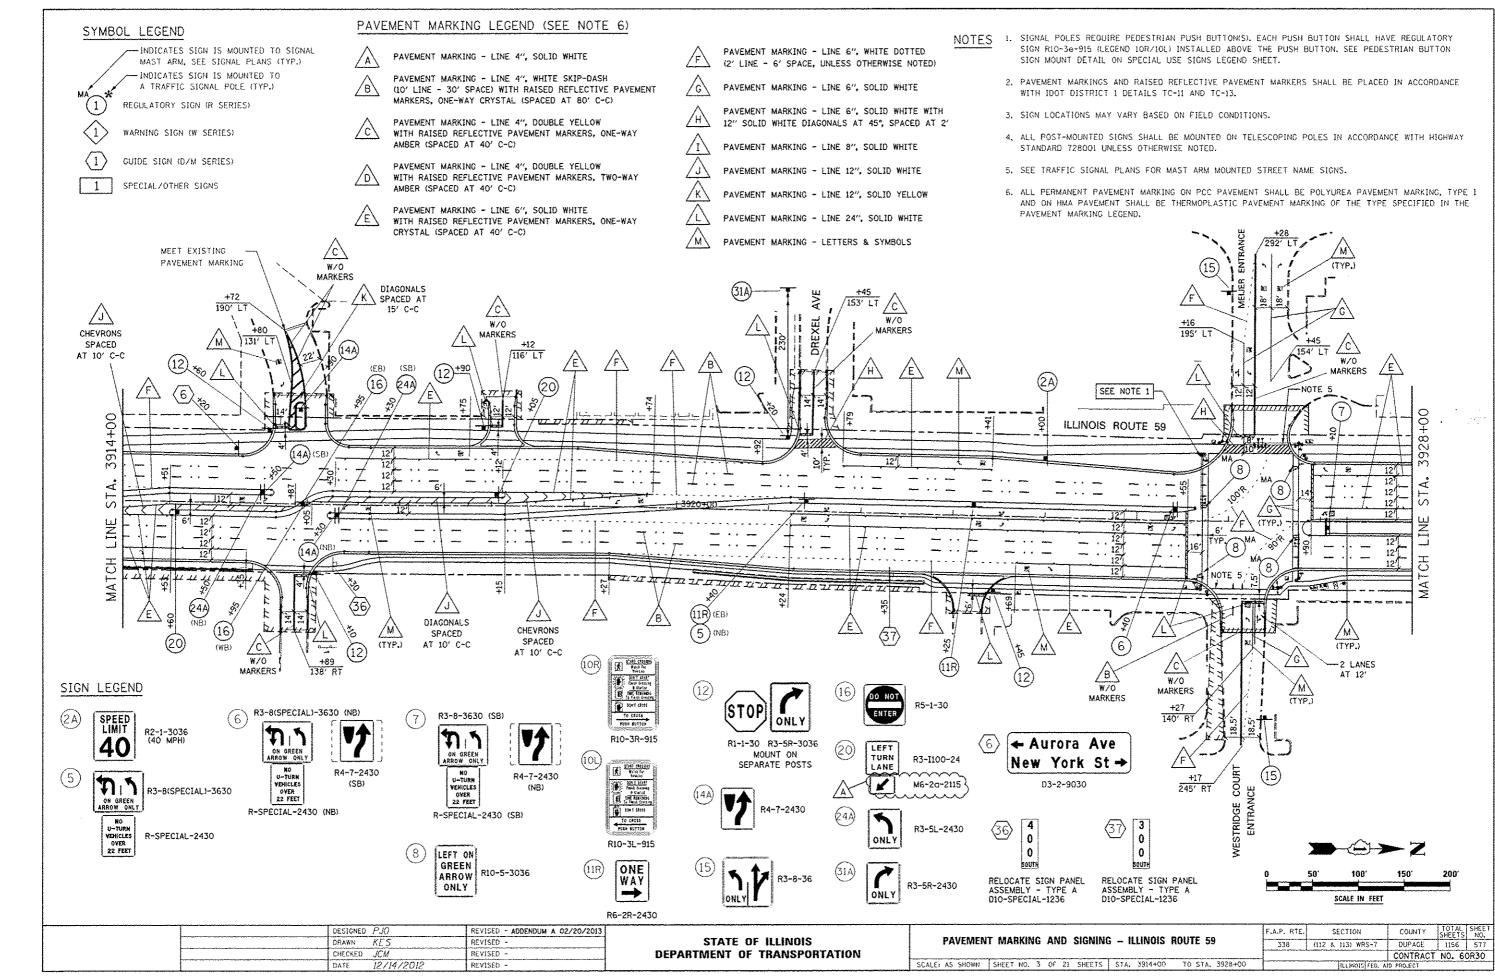


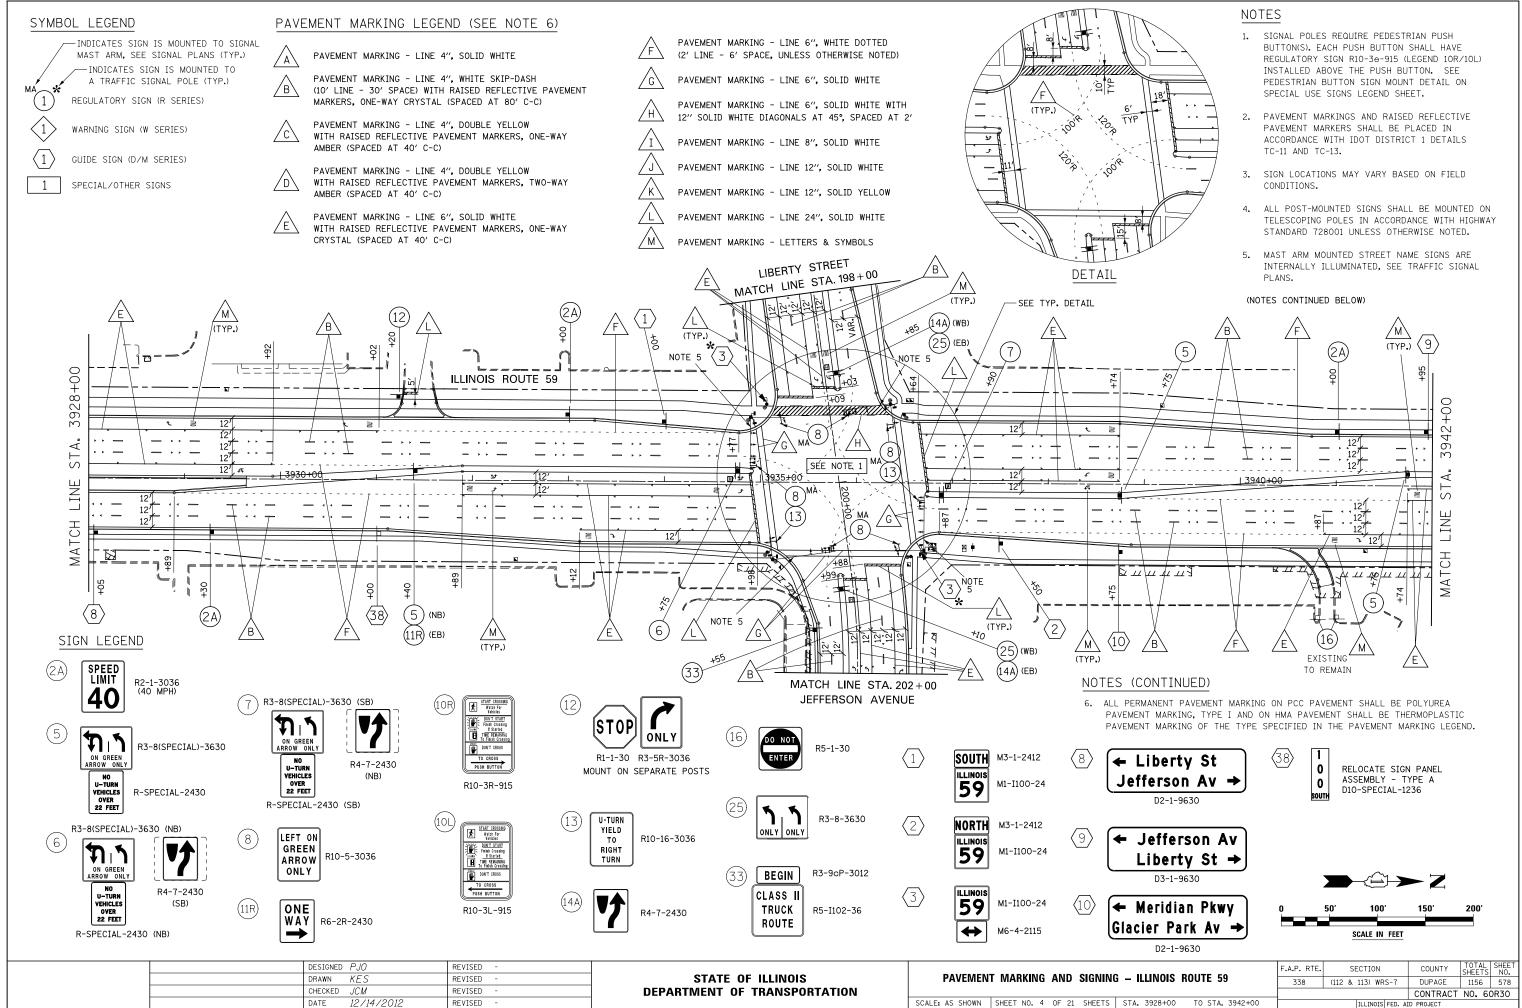


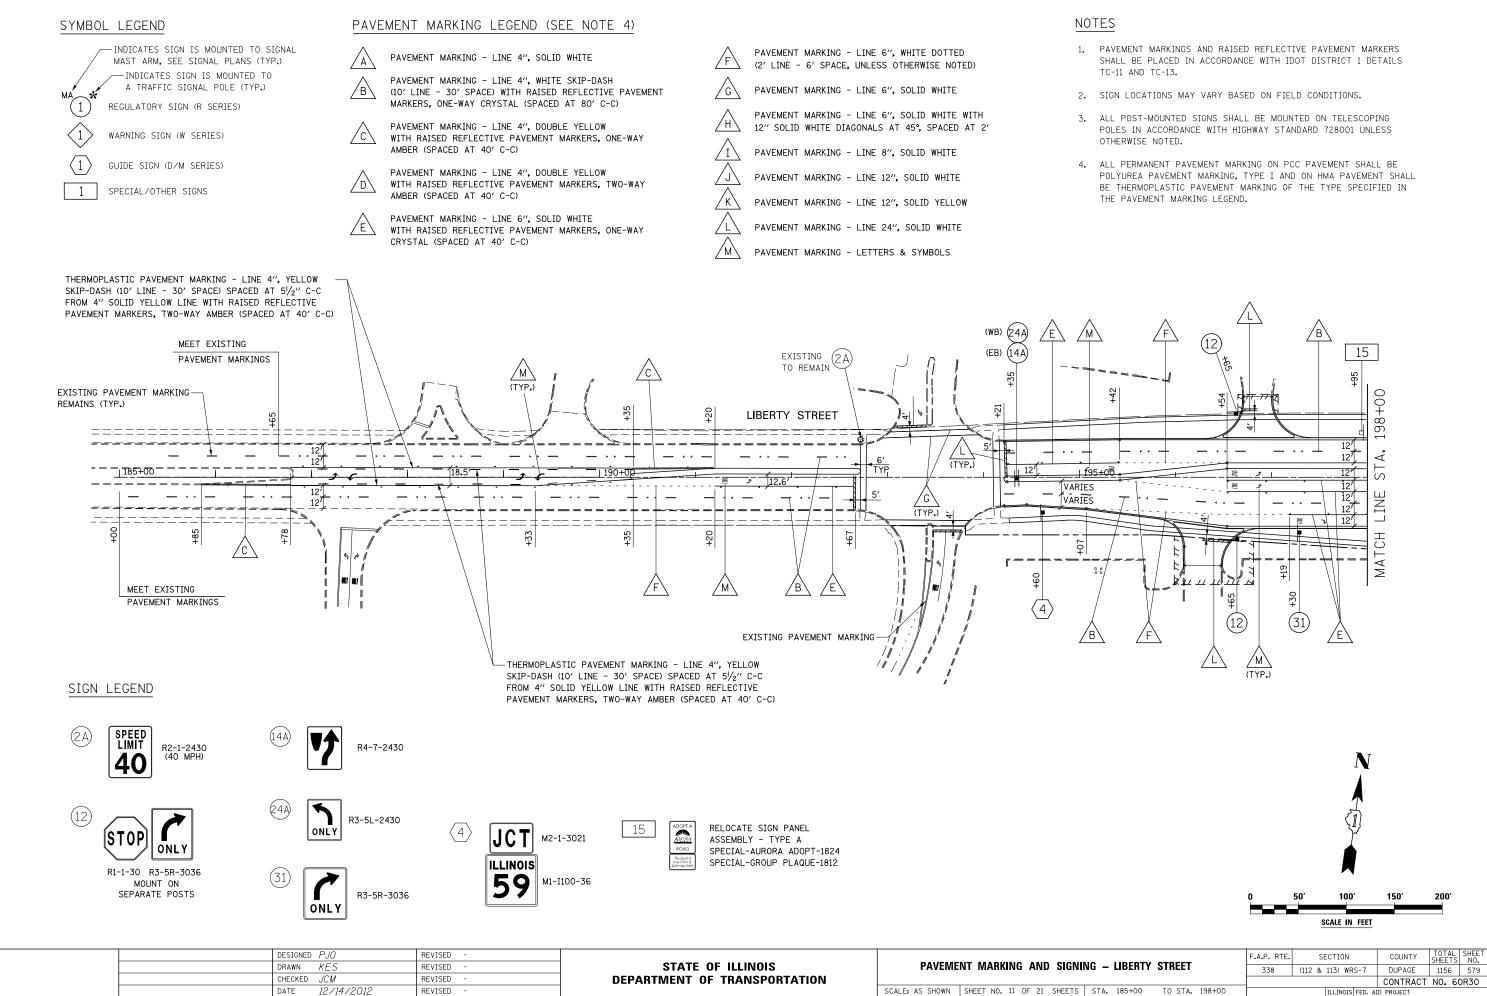

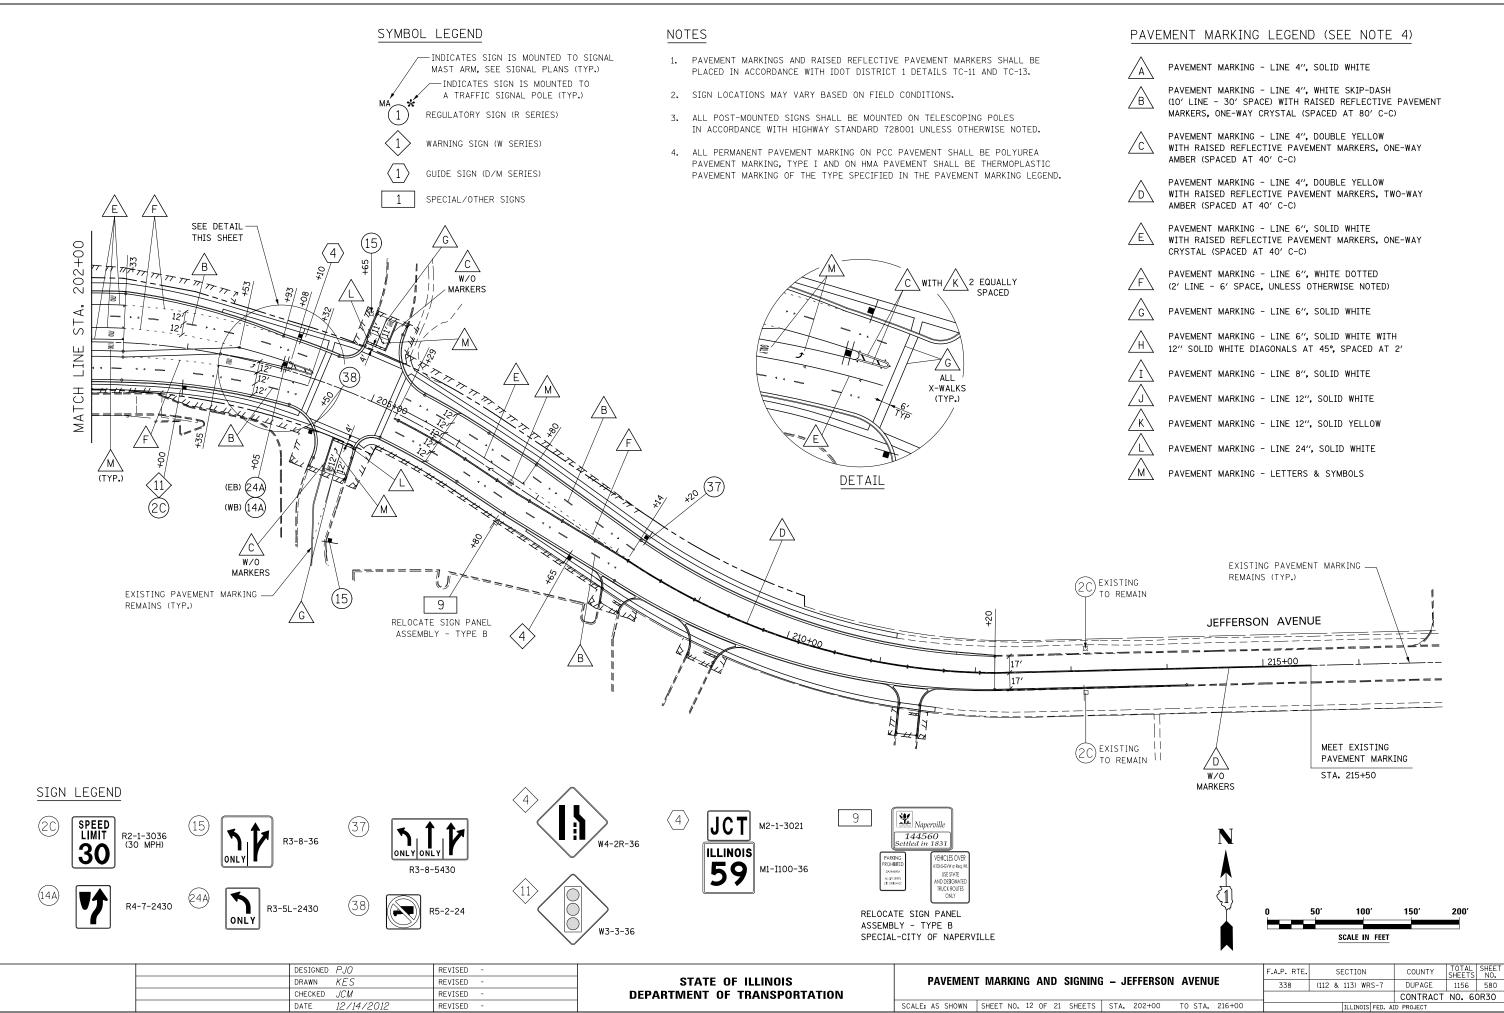


A	PAVEMENT MARKING - LINE 4", SOLID WHITE
B	PAVEMENT MARKING - LINE 4", WHITE SKIP-DASH (10' LINE - 30' SPACE) WITH RAISED REFLECTIVE PAVEMENT MARKERS, ONE-WAY CRYSTAL (SPACED AT 80' C-C)
<u> </u>	PAVEMENT MARKING - LINE 4", DOUBLE YELLOW WITH RAISED REFLECTIVE PAVEMENT MARKERS, ONE-WAY AMBER (SPACED AT 40' C-C)
	PAVEMENT MARKING - LINE 4", DOUBLE YELLOW WITH RAISED REFLECTIVE PAVEMENT MARKERS, TWO-WAY AMBER (SPACED AT 40' C-C)
E	PAVEMENT MARKING - LINE 6", SOLID WHITE WITH RAISED REFLECTIVE PAVEMENT MARKERS, ONE-WAY CRYSTAL (SPACED AT 40' C-C)
F	PAVEMENT MARKING - LINE 6", WHITE DOTTED (2' LINE - 6' SPACE, UNLESS OTHERWISE NOTED)
G	PAVEMENT MARKING - LINE 6", SOLID WHITE
H	PAVEMENT MARKING - LINE 6", SOLID WHITE WITH 12" SOLID WHITE DIAGONALS AT 45°, SPACED AT 2"
	PAVEMENT MARKING - LINE 8", SOLID WHITE
$\int$	PAVEMENT MARKING - LINE 12", SOLID WHITE
K	PAVEMENT MARKING - LINE 12", SOLID YELLOW
	PAVEMENT MARKING - LINE 24", SOLID WHITE
M	PAVEMENT MARKING - LETTERS & SYMBOLS

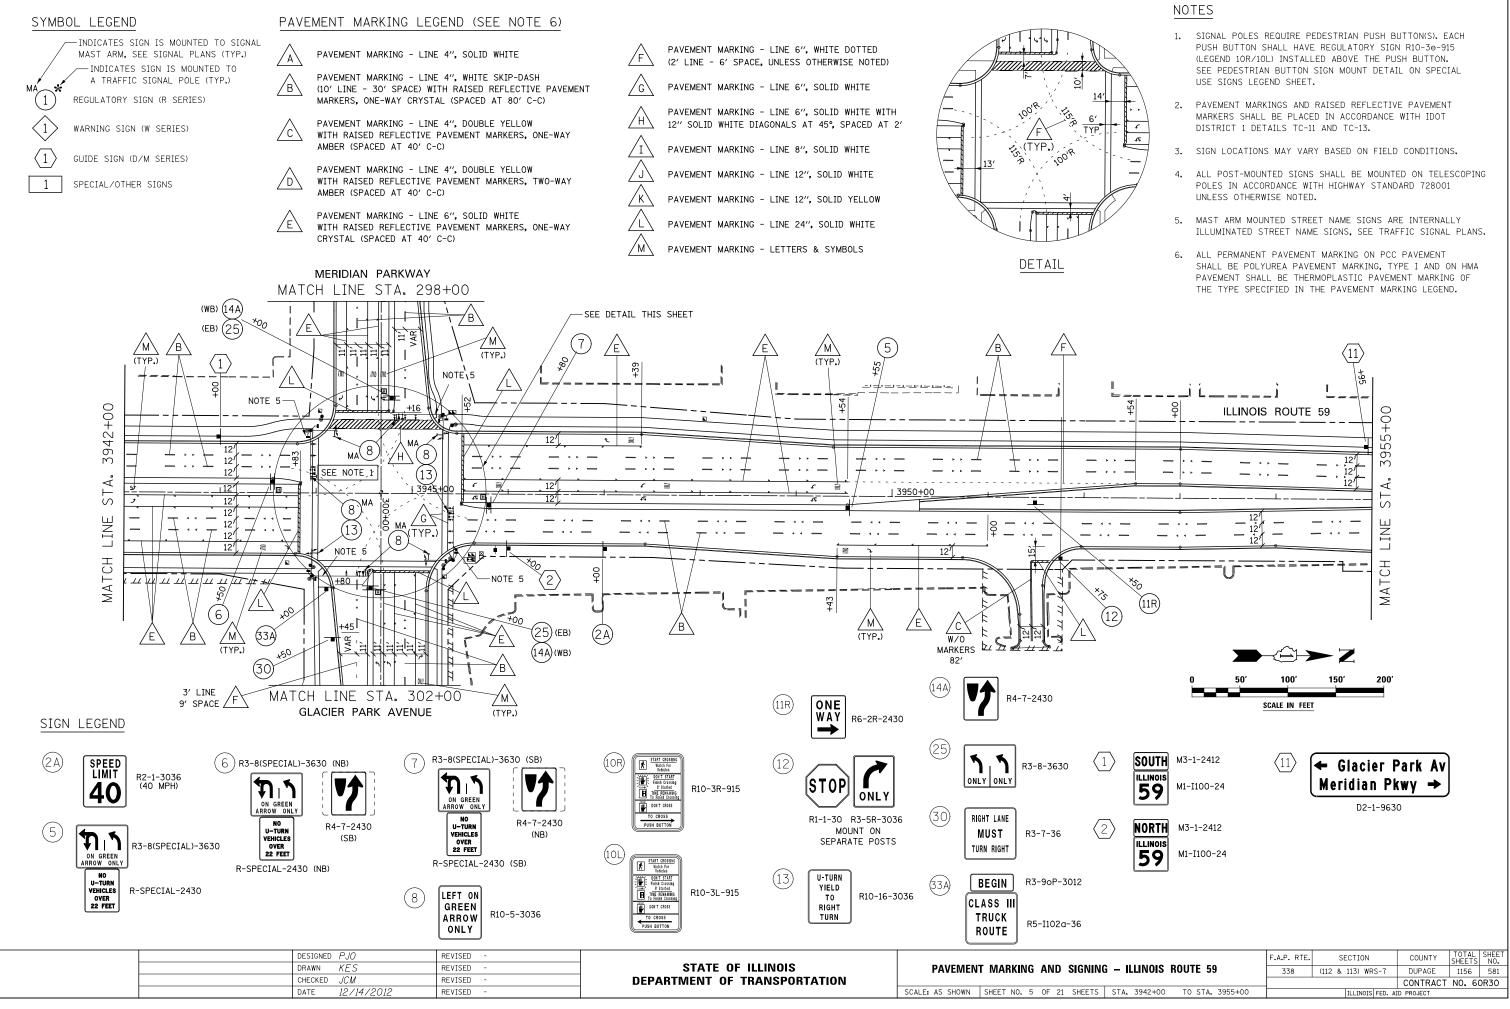

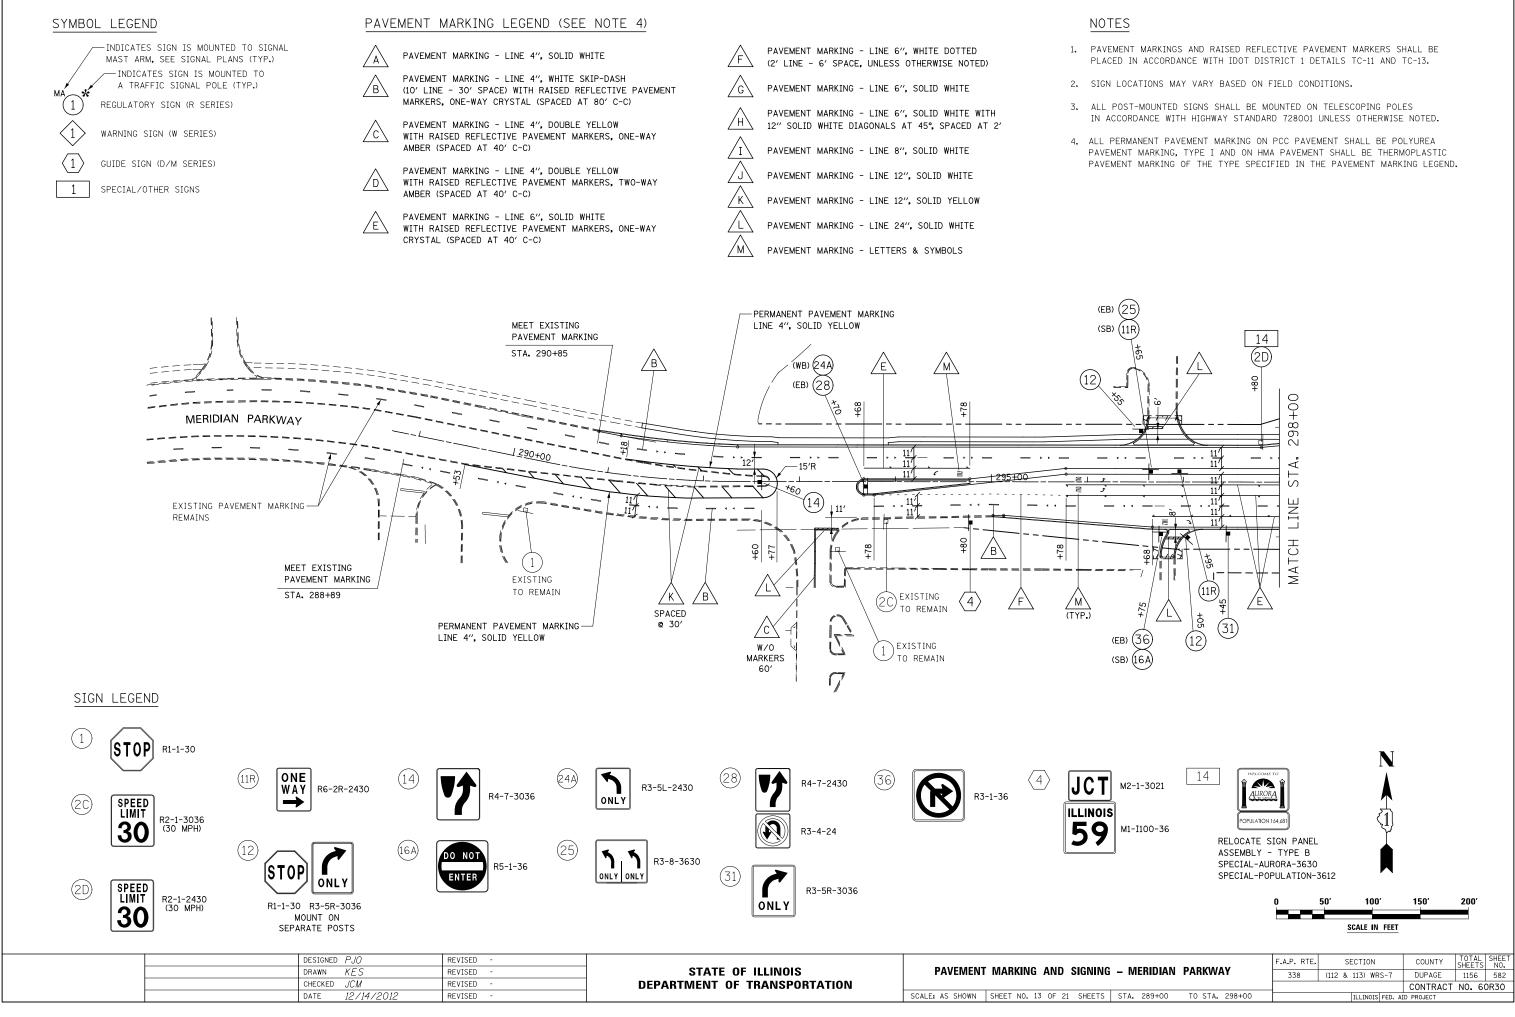

# SYMBOL LEGEND

MA

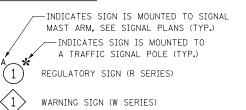




1 SPECIAL/OTHER SIGNS

## PAVEMENT MARKING LEGEND (SEE NOTE 4)

A PAVEMENT MARKING - LINE 4", SOLID WHITE

B PAVEMENT MARKING - LINE 4", WHITE SKIP-DASH (10' LINE - 30' SPACE) WITH RAISED REFLECTIVE PAVEMENT MARKERS, ONE-WAY CRYSTAL (SPACED AT 80' C-C)

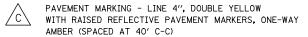


- D PAVEMENT MARKING LINE 4", DOUBLE YELLOW WITH RAISED REFLECTIVE PAVEMENT MARKERS, TWO-WAY AMBER (SPACED AT 40' C-C)
- PAVEMENT MARKING LINE 6", SOLID WHITE WITH RAISED REFLECTIVE PAVEMENT MARKERS, ONE-WAY CRYSTAL (SPACED AT 40' C-C)

F	PAVEMENT MARKING - LINE 6", WHITE DOTTED (2' LINE - 6' SPACE, UNLESS OTHERWISE NOTED)	1.	l
G	PAVEMENT MARKING - LINE 6", SOLID WHITE	2.	
H	PAVEMENT MARKING - LINE 6", SOLID WHITE WITH 12" SOLID WHITE DIAGONALS AT 45°, SPACED AT 2'	3.	
I	PAVEMENT MARKING - LINE 8", SOLID WHITE	4.	ł
Ĺ	PAVEMENT MARKING - LINE 12", SOLID WHITE		
K	PAVEMENT MARKING - LINE 12", SOLID YELLOW		

L PAVEMENT MARKING - LINE 24", SOLID WHITE

M PAVEMENT MARKING - LETTERS & SYMBOLS

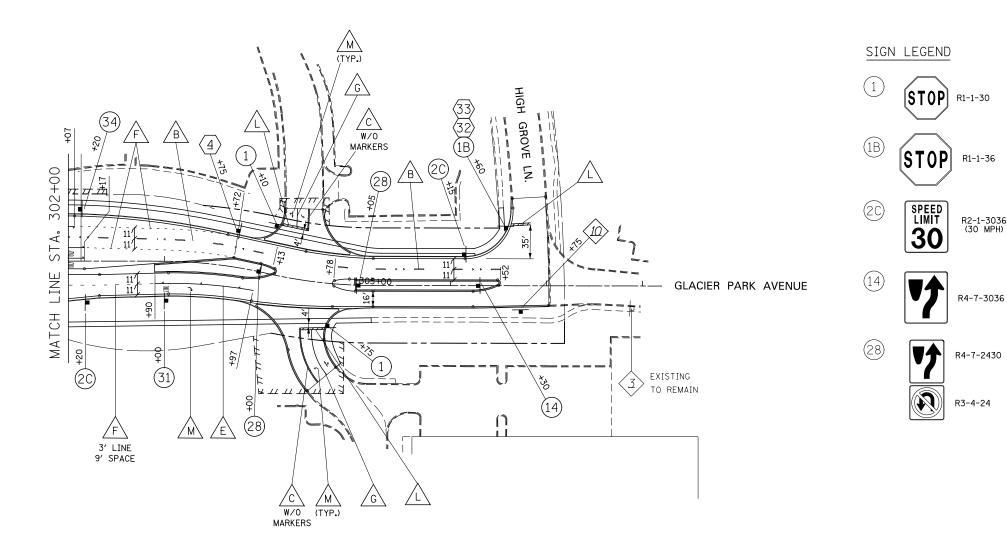

	DESIGNED DRAWN CHECKED	PJO KES JCM	REVISED REVISED REVISED		STATE OF ILLINOIS DEPARTMENT OF TRANSPORTATION	PAVEMENT	MARKING AND	SIGNING
	DATE	12/14/2012	REVISED	-		SCALE: AS SHOWN	SHEET NO. 14 OF	21 SHEETS


# NOTES


PAVEMENT MARKINGS AND RAISED REFLECTIVE PAVEMENT MARKERS SHALL BE PLACED IN ACCORDANCE WITH IDOT DISTRICT 1 DETAILS TC-11 AND TC-13.


SIGN LOCATIONS MAY VARY BASED ON FIELD CONDITIONS.

ALL POST-MOUNTED SIGNS SHALL BE MOUNTED ON TELESCOPING POLES IN ACCORDANCE WITH HIGHWAY STANDARD 728001 UNLESS OTHERWISE NOTED.


ALL PERMANENT PAVEMENT MARKING ON PCC PAVEMENT SHALL BE POLYUREA PAVEMENT MARKING, TYPE I AND ON HMA PAVEMENT SHALL BE THERMOPLASTIC PAVEMENT MARKING OF THE TYPE SPECIFIED IN THE PAVEMENT MARKING LEGEND.

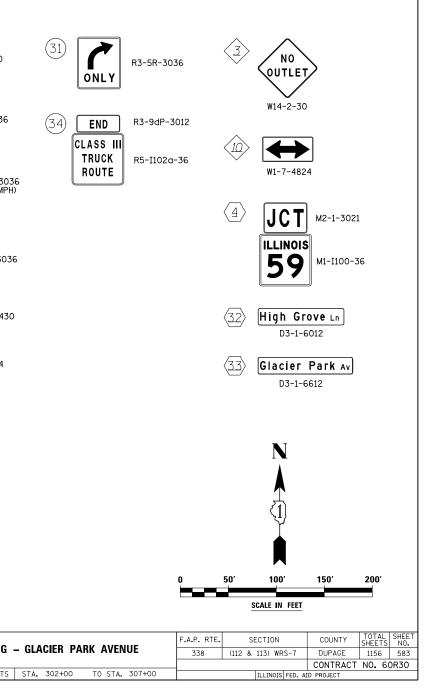


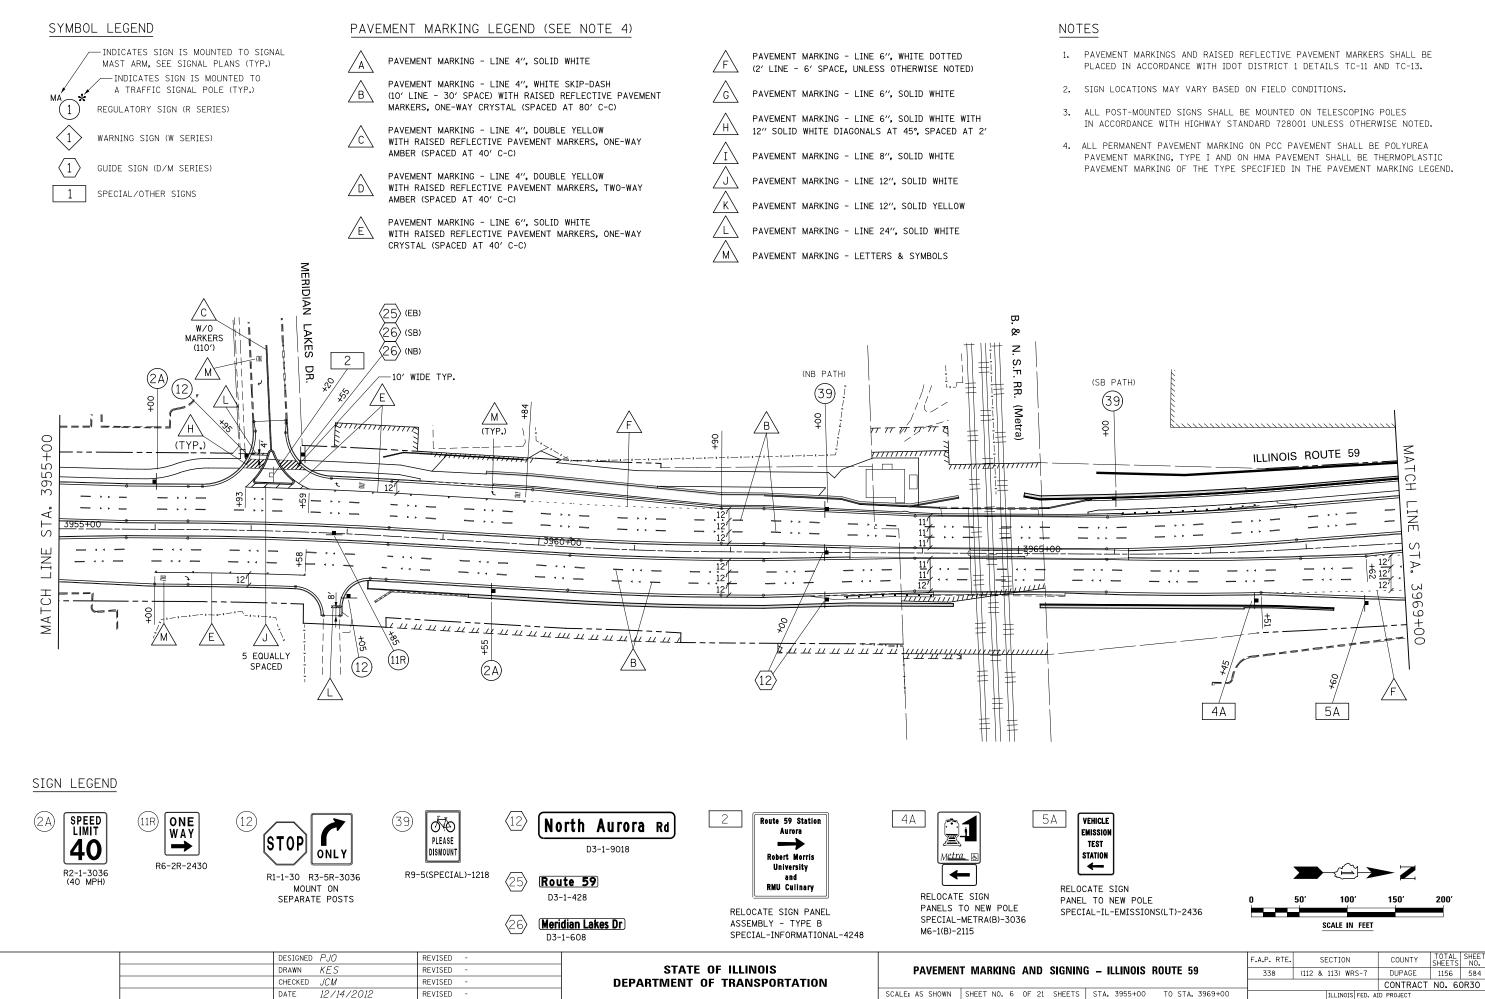

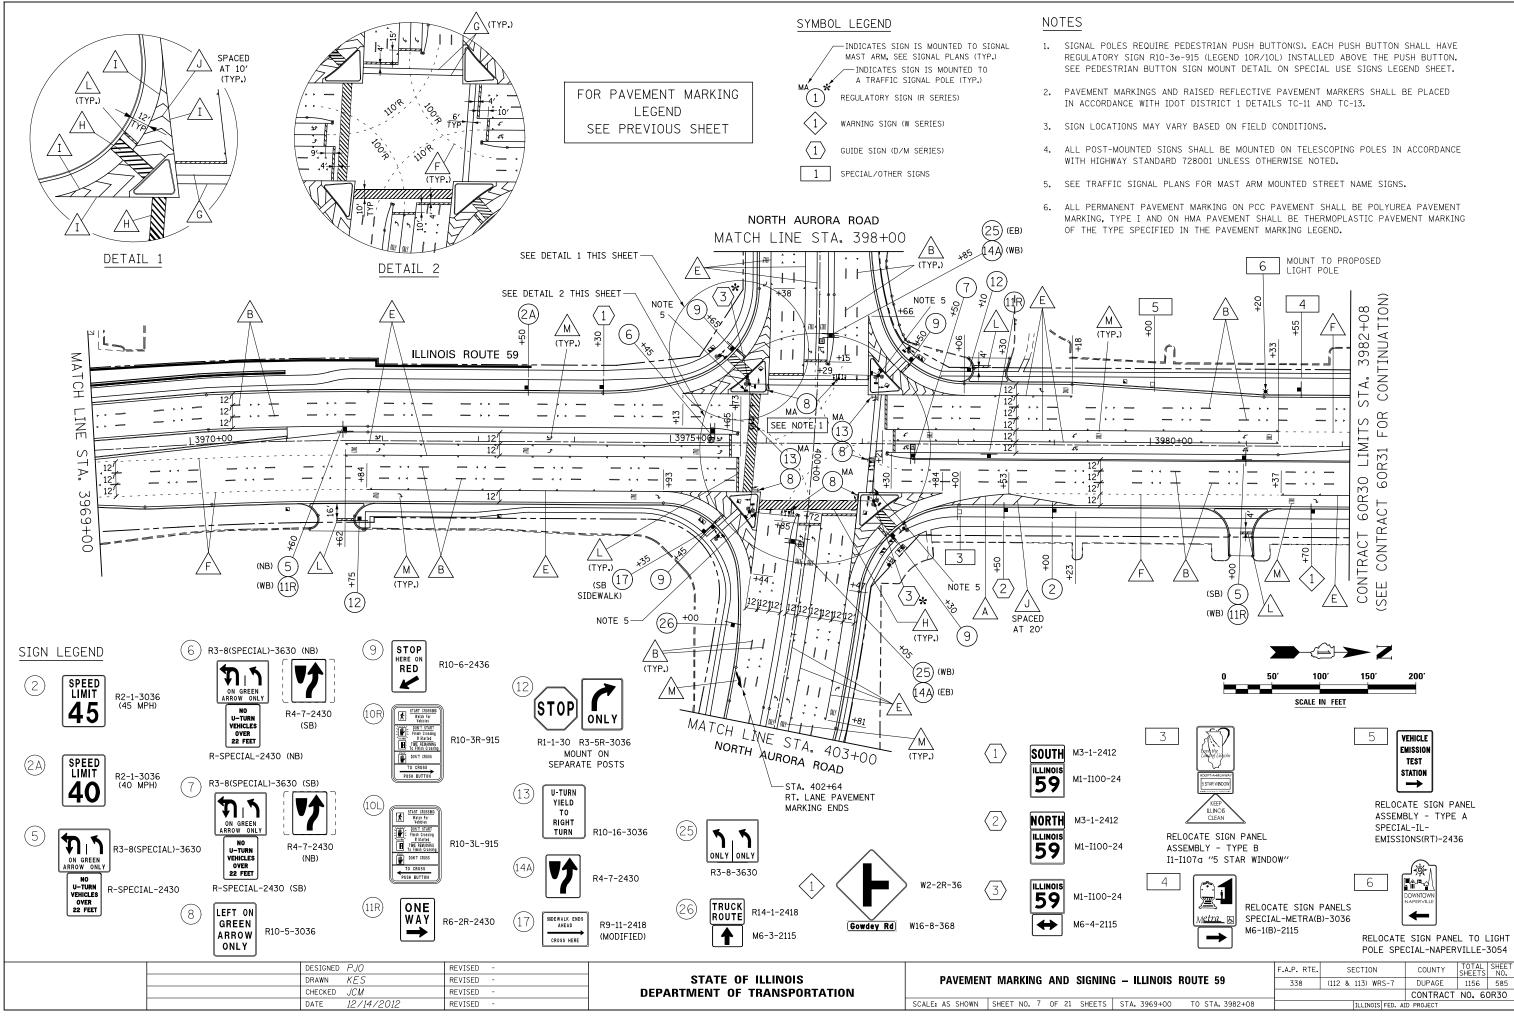


# PAVEMENT MARKING LEGEND (SEE NOTE 7)

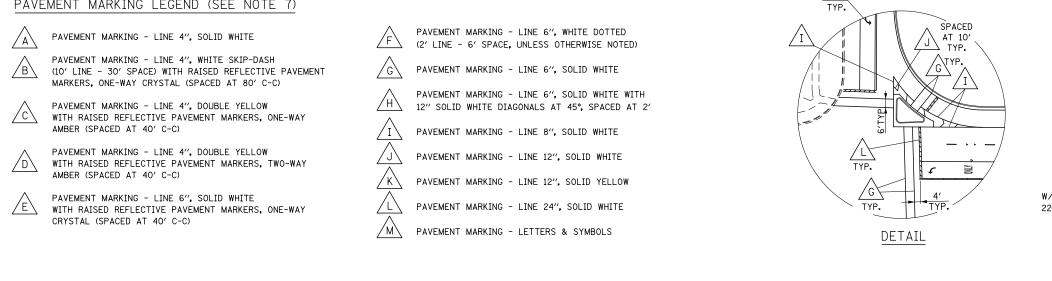

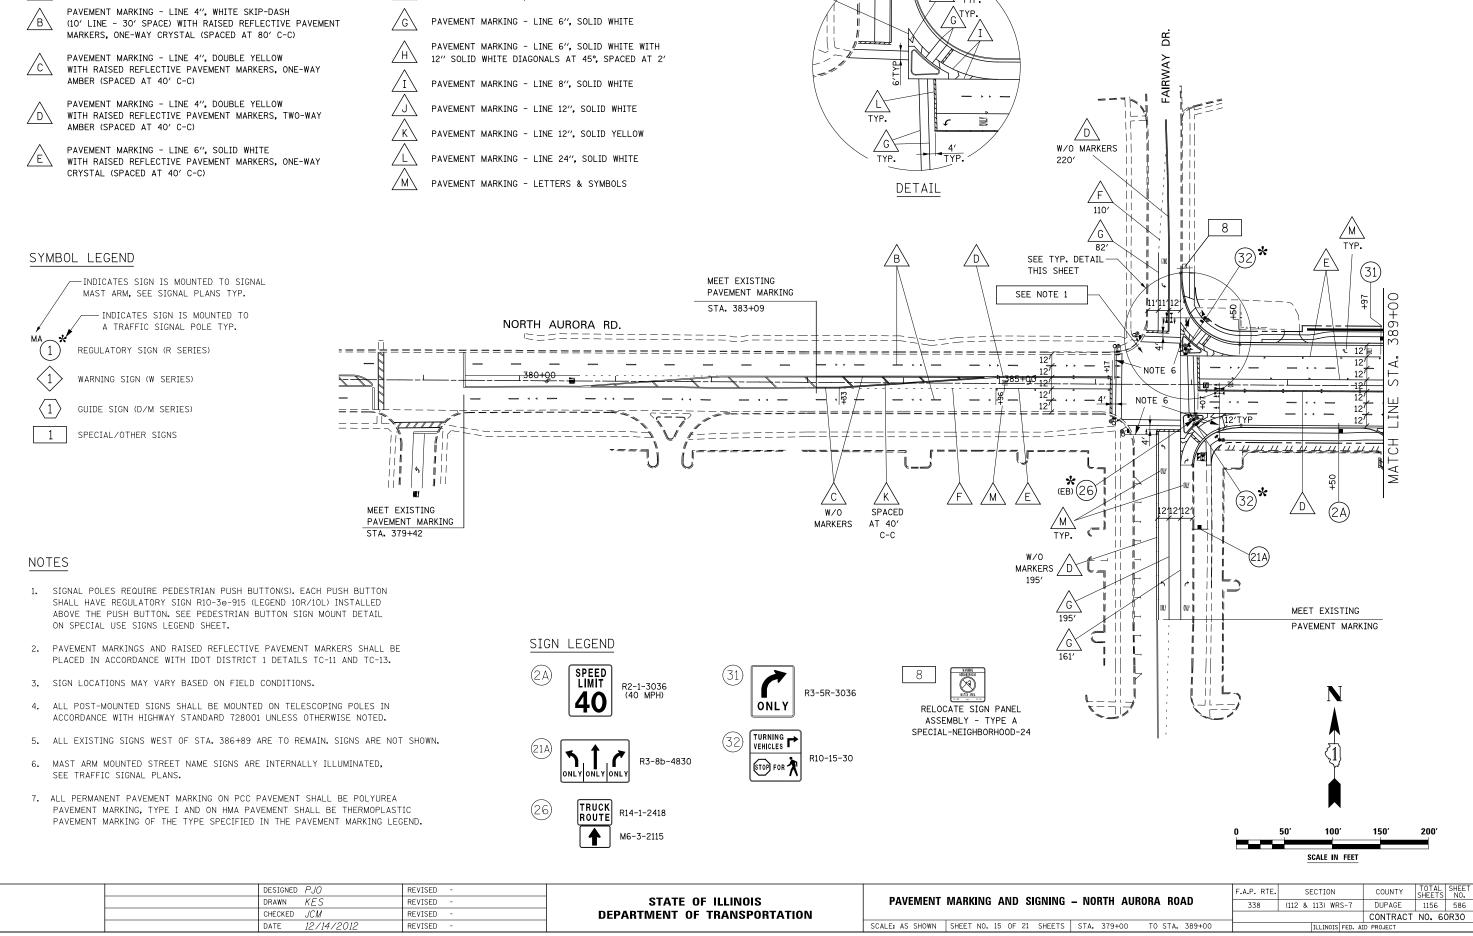

/M

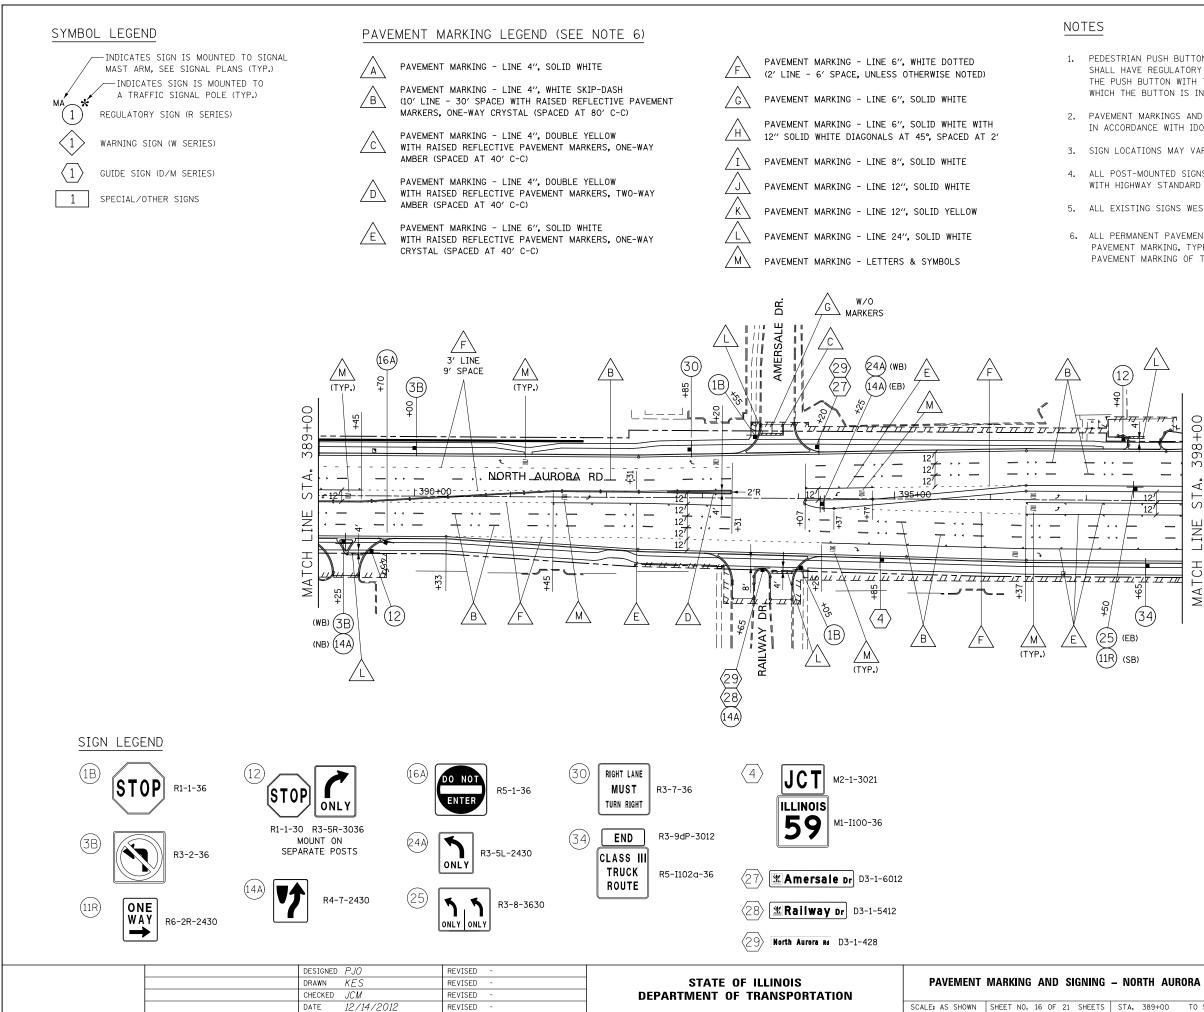

 PEDESTRIAN PUSH BUTTON SIGNING IS NOT SHOWN FOR CLARITY. EACH PUSH BUTTON SHALL HAVE REGULATORY SIGN R10-30-915 (SEE LEGEND 10R/10L) INSTALLED ABOVE THE PUSH BUTTON WITH THE ARROW ORIENTED PARALLEL TO THE CROSSWALK FOR WHICH THE BUTTON IS INTENDED.


2. PAVEMENT MARKINGS AND RAISED REFLECTIVE PAVEMENT MARKERS SHALL BE PLACED IN ACCORDANCE WITH IDOT DISTRICT 1 DETAILS TC-11 AND TC-13.

3. SIGN LOCATIONS MAY VARY BASED ON FIELD CONDITIONS.

4. ALL POST-MOUNTED SIGNS SHALL BE MOUNTED ON TELESCOPING POLES IN ACCORDANCE WITH HIGHWAY STANDARD 728001 UNLESS OTHERWISE NOTED.


5. ALL EXISTING SIGNS WEST OF STA. 86+89 ARE TO REMAIN, SIGNS ARE NOT SHOWN.

6. ALL PERMANENT PAVEMENT MARKING ON PCC PAVEMENT SHALL BE POLYUREA PAVEMENT MARKING, TYPE I AND ON HMA PAVEMENT SHALL BE THERMOPLASTIC PAVEMENT MARKING OF THE TYPE SPECIFIED IN THE PAVEMENT MARKING LEGEND.

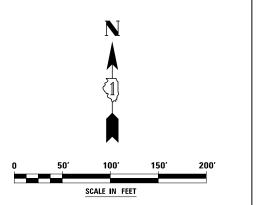


	F.A.P. RTE.	SECTION	COUNTY	TOTAL SHEETS	SHEET NO.
– NORTH AURORA ROAD	338	(112 & 113) WRS-7	DUPAGE	1156	587
			CONTRACT	NO. 60	DR30
STA. 389+00 TO STA. 398+00		ILLINOIS FED. A	ID PROJECT		



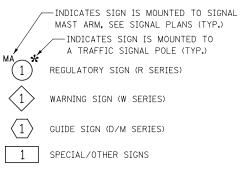


# PAVEMENT MARKING LEGEND (SEE NOTE 4)

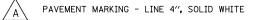

PAVEMENT MARKING - LINE 4", WHITE SKIP-DASH


∠b∕ (10' LINE - 30' SPACE) WITH RAISED REFLECTIVE PAVEMENT MARKERS, ONE-WAY CRYSTAL (SPACED AT 80' C-C)

- PAVEMENT MARKING LINE 4", DOUBLE YELLOW /c\ WITH RAISED REFLECTIVE PAVEMENT MARKERS, ONE-WAY AMBER (SPACED AT 40' C-C)
- PAVEMENT MARKING LINE 4", DOUBLE YELLOW WITH RAISED REFLECTIVE PAVEMENT MARKERS, TWO-WAY ∠d∕ AMBER (SPACED AT 40' C-C)
- PAVEMENT MARKING LINE 6", SOLID WHITE /E/ WITH RAISED REFLECTIVE PAVEMENT MARKERS, ONE-WAY CRYSTAL (SPACED AT 40' C-C)

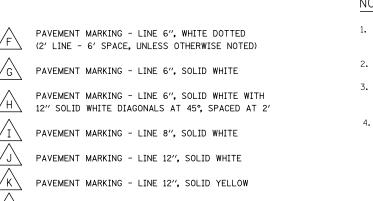


PAVEMENT MARKING - LINE 24", SOLID WHITE

/м\ PAVEMENT MARKING - LETTERS & SYMBOLS

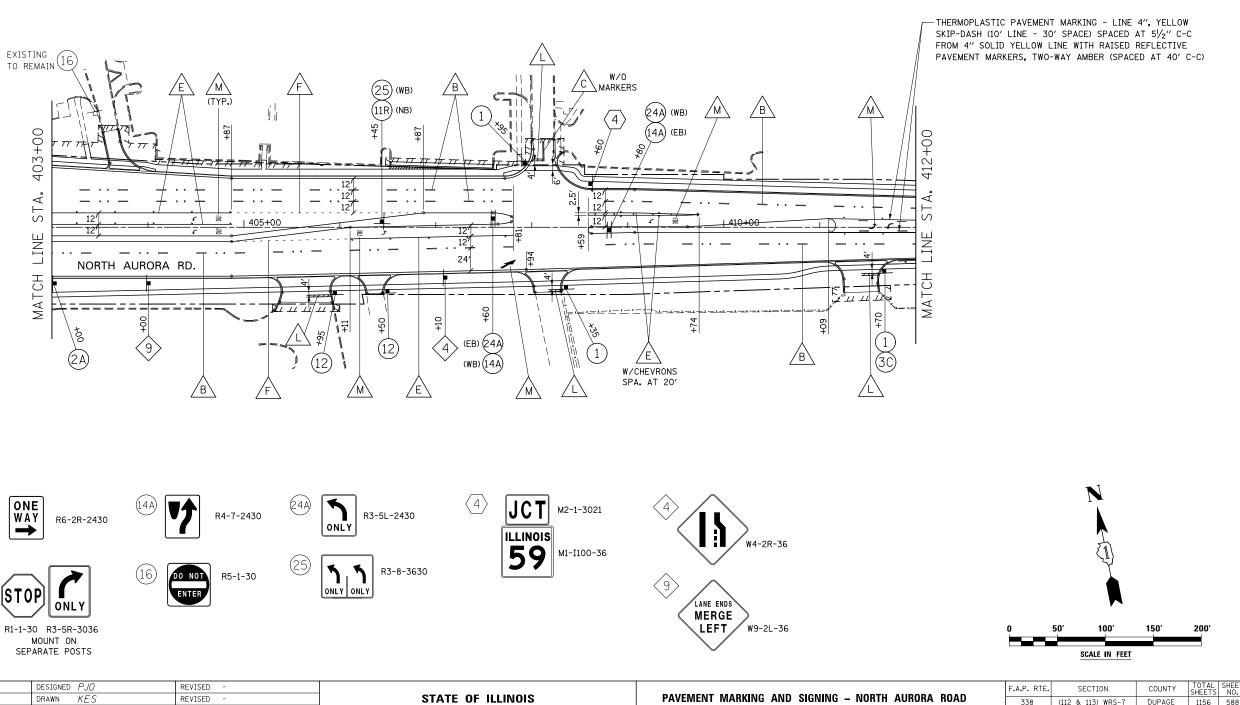

SIGN LEGEND

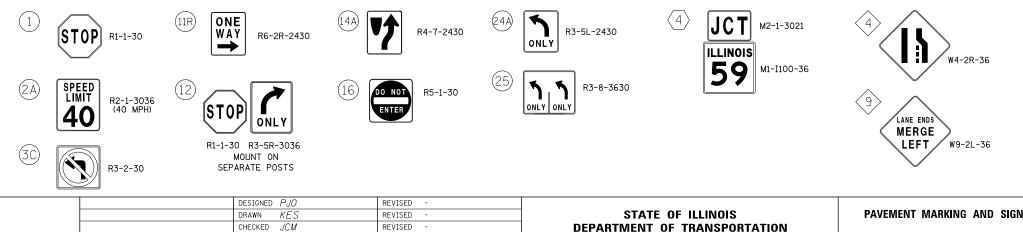

12/14/20.


REVISED

DATE


# NOTES

- PAVEMENT MARKINGS AND RAISED REFLECTIVE PAVEMENT MARKERS SHALL BE PLACED IN ACCORDANCE WITH IDOT DISTRICT 1 DETAILS TC-11 AND TC-13.
- 2. SIGN LOCATIONS MAY VARY BASED ON FIELD CONDITIONS.
- ALL POST-MOUNTED SIGNS SHALL BE MOUNTED ON TELESCOPING POLES IN ACCORDANCE WITH HIGHWAY STANDARD 728001 UNLESS OTHERWISE NOTED.
- 4. ALL PERMANENT PAVEMENT MARKING ON PCC PAVEMENT SHALL BE POLYUREA PAVEMENT MARKING, TYPE I AND ON HMA PAVEMENT SHALL BE THERMOPLASTIC PAVEMENT MARKING OF THE TYPE SPECIFIED IN THE PAVEMENT MARKING LEGEND.

SCALE: AS SHOWN SHEET NO. 17 OF 21 SHEETS STA. 403+00 TO STA. 412+00 ILLINOIS FED. AID PROJECT	PAVEMENT	MARKING	AND	SIGNING	– NORTH AU	KUKA KUAD		338	(112 & 113) WRS-7	DUPAGE	1156	588
SCALE: AS SHOWN SHEET NO. 17 OF 21 SHEETS STA. 403+00 TO STA. 412+00 ILLINOIS FED. AID PROJECT										CONTRACT	NO. 60	0R30
	SCALE: AS SHOWN	SHEET NO.	17 OF	21 SHEETS	STA. 403+00	TO STA. 412+00	0		ILLINOIS FED. A	ID PROJECT		

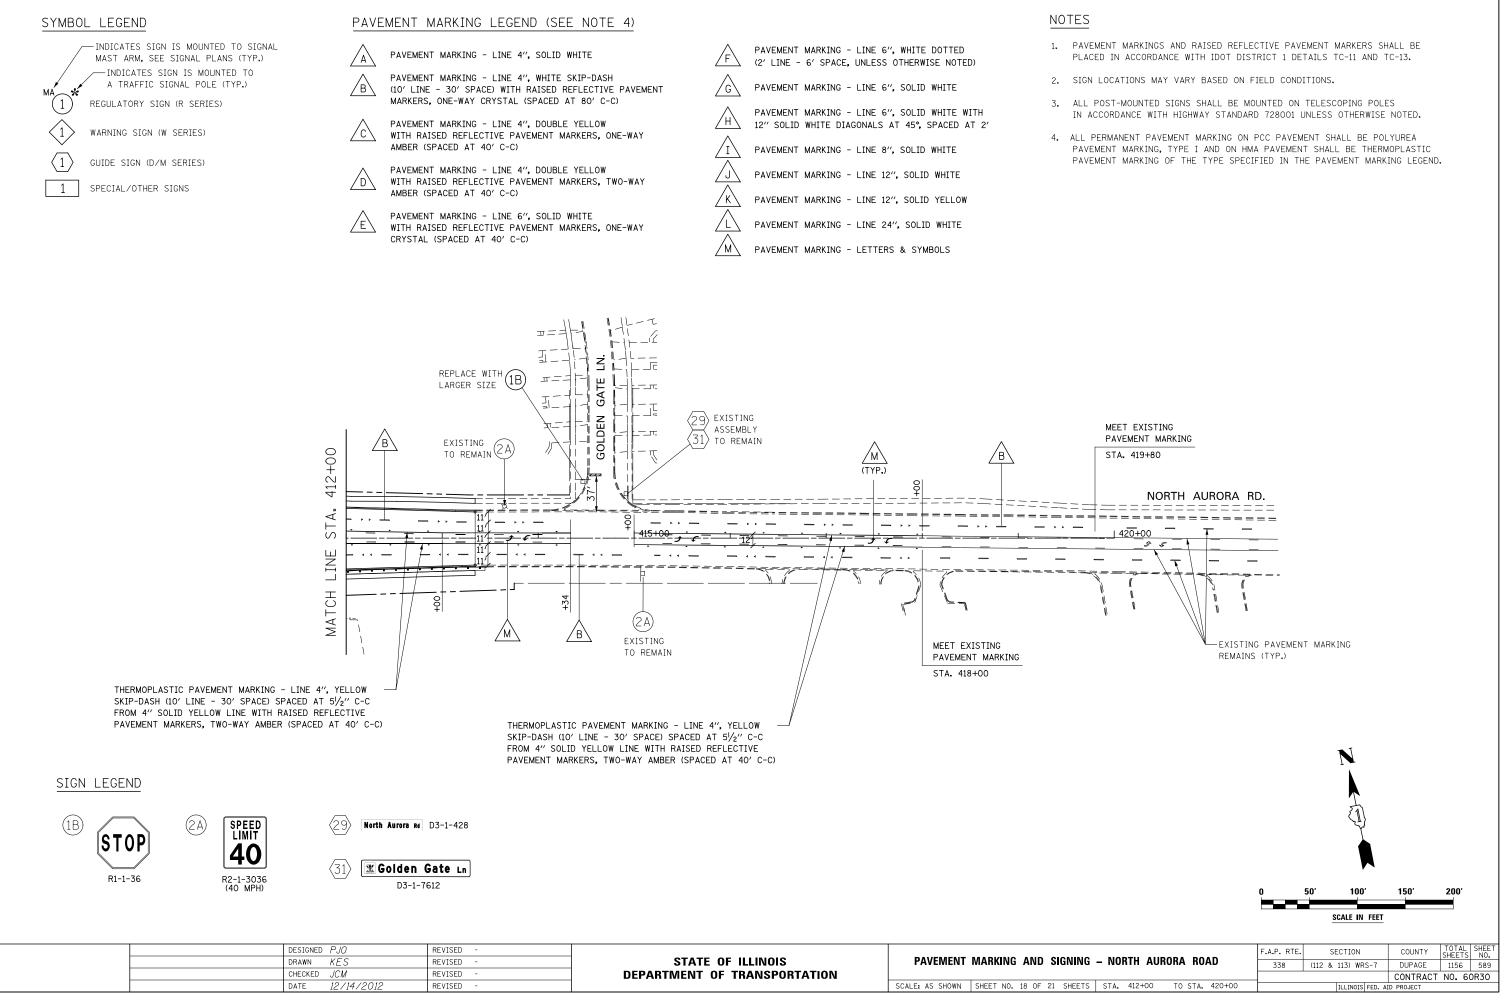

	DESIGNED PJO DRAWN KES	REVISED - REVISED -	STATE OF ILLINOIS	PAVEMENT	MARKING AND SIGNING
	CHECKED JCM	REVISED -	DEPARTMENT OF TRANSPORTATION		
	DATE 12/14/2012	REVISED -		SCALE: AS SHOWN	SHEET NO. 18 OF 21 SHEETS

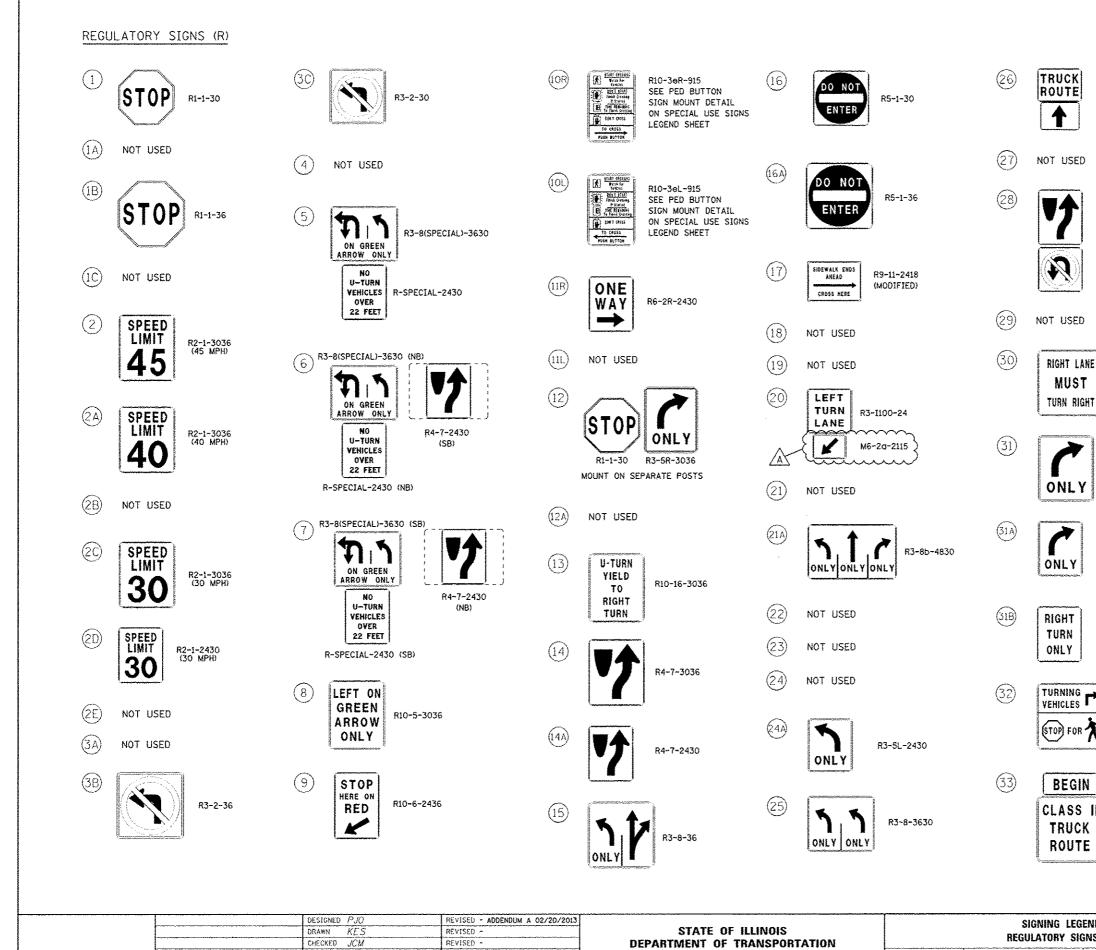


DATE 12/14/2012 REVISED .

.

DEPARTMENT OF TRANSPORTATION


**REGULATORY SIGN** SCALE: NONE SHEET NO. 19 OF 21 SHEETS STA.

R14-1-2418 M6-3-2115	33A)	CL	BEGIN ASS III RUCK OUTE		90P-3012 (102a-36		
R4-7-2430 R3-4-24	34)	Т	END ASS III RUCK OUTE		9dP-3012 (102a-36		
	(35)	NOT	USED				
E R3-7-36 T	36)		R	R3-1	-36		
R3-5R-3036	37	<b>N</b>		k	R3-8-543(	0	
R3-5R-2430	(38)		R5-2	2-24			
R3-5R(TXT)-2430	39	DISMO		ECIAL	)-1218		
R10-15-30							
R3-90P-3012							
R5-1102-36							
VD	F.	A.P. RTE.	SECTION		COUNTY	TOTAL SHEETS	SHEET NO.
IS (R)	-		(112 & 113) WR	5-7	DUPACE	1156	590
STA. TO STA.			ILLINOIS	FED, AI	CONTRACT D PROJECT	NO. 60	150

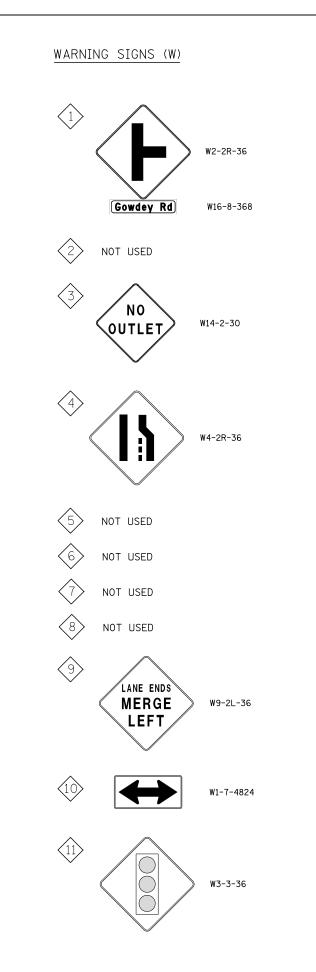


GUIDE SIGNS (M) & (D)




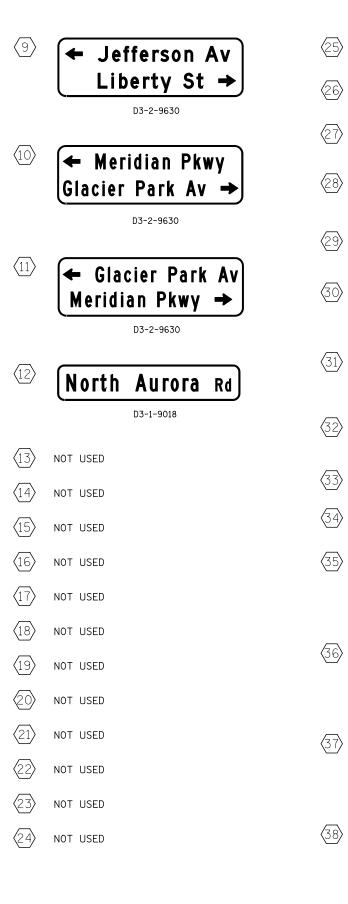

DRAWN     REVISED     REVISED     Contract     STATE OF ILLINUIS       CHECKED     JCM     REVISED     -     DEPARTMENT OF TRANSPORTATION     WARNING (W) AND GUIDE (M) & (D) SIGNS     338     (112 & 113) WRS-7     DUPAGE     1156     5       DEPARTMENT OF TRANSPORTATION     DEPARTMENT OF TRANSPORTATION     WARNING (W) AND GUIDE (M) & (D) SIGNS     CONTRACT NO. 60R3		DESIGNED PJO	REVISED -		-	SIGNING LEGEND	F.A.P. RTE	SECTION	COUNTY	TOTAL SHEET
		DRAWN KES	REVISED -		. v			(112 & 113) WRS-7	DUPAGE	1156 591
		CHECKED JCM	REVISED -	DEPARTMENT OF TRANSPORTATION	WARNING (W) AND GUIDE (W) & (D) SIGNS				CONTRACT	NO. 60R30
DATE 12/14/2012 REVISED - SCALE: NONE SHEET NO. 20 OF 21 SHEETS STA. TO STA. ILLINOIS FED. AID PROJECT		DATE 12/14/2012	REVISED -		SCALE: NONE	SHEET NO. 20 OF 21 SHEETS STA. TO STA.		ILLINOIS FED.	AID PROJECT	

<b>Route 59</b> D3-1-428		39>	NOT USE	D		
Meridian Lakes Dr D3-1-608		(40)	NOT USE	D		
Mmersale Dr D3-1-6012		(41)	NOT USE	D		
		(42)	NOT USE	D		
Railway Dr D3-1-5412						
North Aurora Rd D3-1-428						
Fairway Dr D3-2-6018						
<b>Golden Gate Ln</b>						
High Grove Ln D3-1-6012						
Glacier Park Av D3-1-6612						
NOT USED						
6 0 RELOCATE SIGN PANEL ASSEMBLY - TYPE A 0 D10-SPECIAL-1236 SOUTH						
4 O RELOCATE SIGN PANEL ASSEMBLY - TYPE A O D10-SPECIAL-1236 SOUTH						
3 0 ASSEMBLY - TYPE A 0 DIO-SPECIAL-1236 SOUTH						
1 0 ASSEMBLY - TYPE A D10-SPECIAL-1236 SOUTH						
SIGNING LEGEND	F.A.P. RTE. 338		ECTION 113) WRS-7	COUNTY	TOTAL SHEETS 1156	SHEET NO.

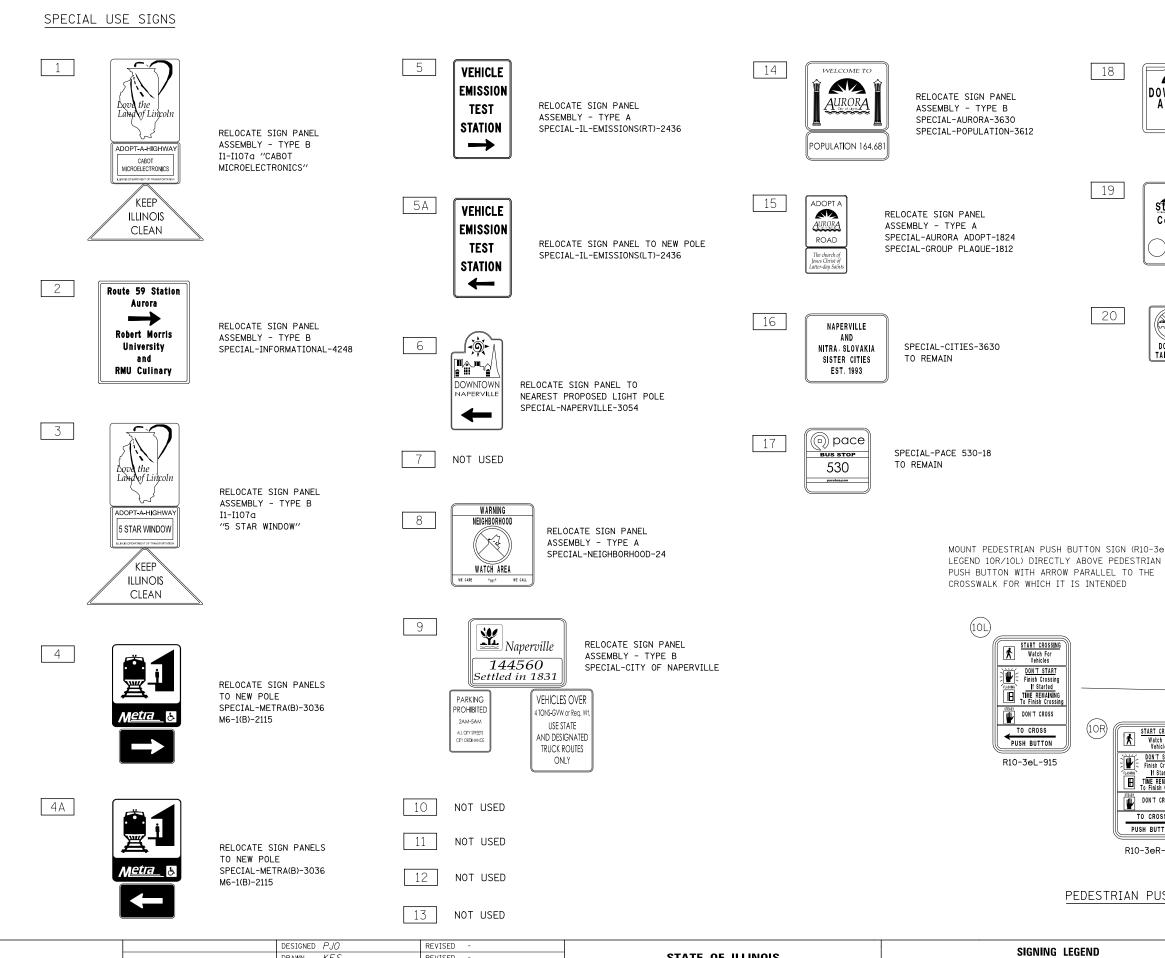

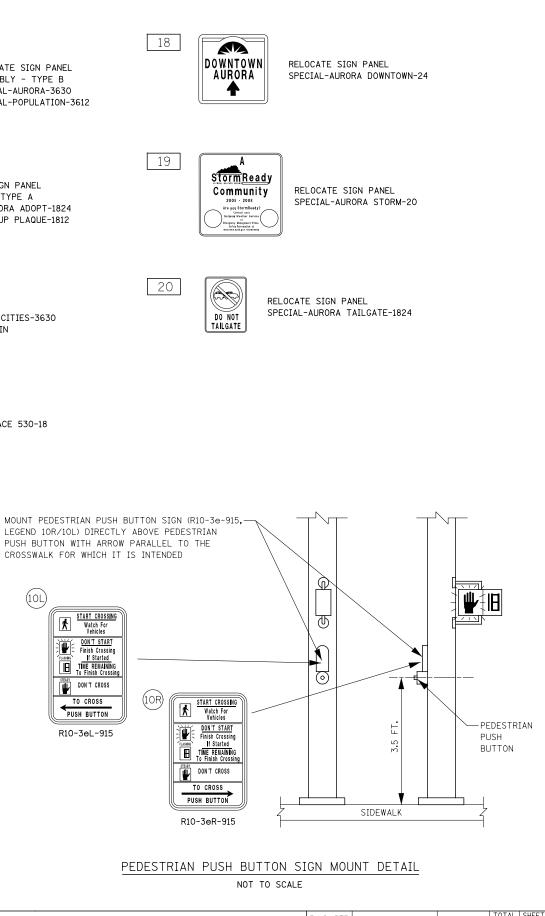

GEN	ND		F.A.P. RTE.	SE	CTION		COUNTY	TOTAL SHEETS	SHEET NO.	
cin	GNS		338	(112 &	113) Wf	RS-7	DUPAGE	1156	592	
310	GING						CONTRACT	NO. 60	DR30	
S	STA.	TO STA.			ILLINOIS	FED. AI	D PROJECT			



			A										
		ng na ng	HL 59 @ HEWYORK ST/ AURORAAVE	AURORA AVE. @ NAPER PLAZA WESTRIDGE CT.	IL 59 @ MEIJERWESTRIDGE COURT ENTR.	IL 59 () LIBERTY ST./ JEFFERSON AVE.	LIBERTY ST. @ COMMERCIAL DRIVEWAY (MEIJER)	IL 59 () MERIDIAN PKWY/ GLACIER PARK DR.	IL 59 () NORTH AURORA RD.	FAIRWAY DR.	PUMP STATION #47	NORTH AURORA INTERCONNECT	IL 59 INTERCONNEC CONTRACT 69R
ITEM	UNIT	TOTAL	1/						1/			1	1
BIGH PANEL - TYPE 3	SOFT	405	.90	[	-30	-90		90	90 /	.15		1	
SIGN PANEL - TYPE 2	SOFT	24	1						/	-24	·-·		[
SERVICE INSTALLATION - GROUND MOUNTED	EACH	5 /	1		.1	i		1	i /		·····		1
UNDERGROUND CONDUIT, GALVANIZED STEEL, 2" DIA.	FOOT	11,850	1406		785	1002		886	2013	351			5227
UNDERGROUND CONDUIT, GALVANIZED STEEL, 2 1/2 DIA.	FOOT	445	59		23		<u> </u>		284	79		· · · · · ·	1
INDERGROUND CONDUIT, GALVANIZED STEEL, T DIA	FOOT	285			.64	67		121		33	······		
INDERGROUND CONDUIT, GALVANIZED STEEL, 3 1/2" DIA	FOOT	133	67						66				<u> </u>
INDERGROUND CONDUIT, GALVANIZED STEEL, 4 DIA	FOOT	5,179	1550		639	640		660	1410	280			1
HANDHOLE	EACH	43	8		5	5		5	12	2			6
1EAVY-DUTY HANDHOLE	EACH	21	4		4	4		4	4			l	+
DOUBLE HANDHOLE	EACH	17	5		2	2		2	s	1			<u> </u>
ELECTRIC CABLE IN CONDUIT, 600V (XLP. TYPE USE) 3-11C NO. 8, 1/C NO. 8 GROUND	FOOT	-257				<u> </u>	<u>}</u>	£		237		·	<u> </u>
UMINAIRE, SODIUM VAPOR, HORIZONTAL MOUNT, 400 WATT	EACH	-231					h			1		[	<u> </u>
MANTENANCE OF EXISTING TRAFFIC SIGNAL INSTALLATION	EACH		<b> </b>				<u> </u>			1			<u> </u>
RANSCEIVER - FIBER OPTIC	EACH	2	<u> </u>									1	1
BER OPTIC CABLE IN CONDUIT, NO. 62.5/125, MM/2F 5M12F	FOOT	7	1		1	11		<u>1</u> `	1	1	1		<u> </u>
LECTRIC CABLE IN CONDUIT, TRACER, NO. 14 10.	FOOT	853	<u> </u>				·····				·····	852.5	
	FOOT	11,614										852.5	10761
ELECTRIC CABLE IN CONDUIT, SIGNAL NO: 142C	- <b></b>	14,381	3865		1681	.1735		1765	3572	1743	,,		<b> </b>
	FOOT	24,352	6977		2539	2902		2973	6448	2513		<del></del>	<b>_</b>
SLECTRIC CABLE IN CONDUIT, SIGNAL NO. 1450	FOOT	23,999	6140		2981	3753		3837	5774	1514		<u> </u>	<u> </u>
ELECTRIC CABLE IN CONDUIT, SIGNAL NO: 147C	FOOT	15,874	4033	· · · · ·	1925	2021	· · · · · · · · · · · · · · · · · · ·	2090	3797	2002			<b> </b>
ELECTRIC CABLE IN CONDUIT, LEAD-IN, NO. 14 1 PAIR	F007	32,599	8637		2235	3793		6148	. 2698	3090		<b>.</b>	<b></b>
ELECTRIC CABLE IN CONDUIT, BERVICE, NO. 4.2 C	FOOT	504	<b></b>							504			
ZLECTRIC CABLE IN CONDUIT, SERVICE, NO. 5 Z C.	FOOT	257	58		- 44	65	·	49	41				<b></b>
LECTRIC CABLE IN CONDUIT, EQUIPMENT GROUNDING CONDUCTOR, NO. 8 1C	FOOT	7,774	1392		851	894		932	2425	1280			
IRAFFIC SIGNAL POST. GALVANIZED STEEL 10 FT.	EACH	12	4		2				4	2		·	<b>_</b>
IRAFFIC SIGNAL POST, GALVANIZED STEEL 16 FT.	EACH	1							1				<u> </u>
STEEL MAST ARM ASSEMBLY AND POLE, 60 FT.	EACH	1								1			
STEEL COMBINATION MAST ARM ASSEMBLY AND POLE 46 FT.	EACH	1								1		·····	
STEEL COMBINATION MAST ARM ASSEMBLY AND FOLE 48 FT.	EACH	2	2				· · · · · · · · · · · · · · · · · · ·						
STEEL COMBINATION MAST ARM ASSEMBLY AND FOLE SO FT.	EACH	1			1						· · · · · · · · · · · · · · · · · · ·		
STEEL COMBINATION MAST ARM ASSEMBLY AND FOLE 56 FT.	EACH	2	2										
STEEL COMBINATION MAST ARM ASSEMBLY AND FOLE 60 FT.	EACH	1			1								Į
STEEL COMBINATION MAST ARM ASSEMBLY AND FOLE WITH DUAL MAST ARMS, 48 FT, AND 22 FT.	EACH	1	<u> </u>						1				
STEEL COMBINATION MAST ARM ASSEMBLY AND FOLE WITH DUAL MAST ARMS, 52 FT. AND 16 FT.	EACH	1			1								
STEEL COMBINATION MAST ARM ASSEMBLY AND FOLE WITH DUAL MAST ARMS, 54 FT, AND 38 FT.	EACH	1				1							1
CONCRETE FOUNDATION, TYPE A	FOOT	118	20		20	-20		20	.24	12			
CONCRETE FOUNDATION, TYPE C	FOOT	.24	4		4	4		4	4	4			
CONCRETE FOUNDATION, TYPE E 36-INCH DIMETER	FOOT	211	26		-47	32		32	-80	14			
CONCRETE FOUNDATION, TYPE E 42-INCH DIMIETER	FOOT	172	42		21	-46		42		-21		L	
DRLL EXISTING HANDHOLE	EACH	5	[							Э	· · · · · · · · · · · · · · · · · · ·	[	2
SIGNAL HEAD, LED, 1-FACE, 3-SECTION, MAST-ARIL MOUNTED	EACH	72	12		10	14		14	16	ĕ			1
SIGNAL HEAD, LED, 1-FACE, 3-SECTION, BRACKET MOUNTED	EACH	1			1								1
SIGNAL HEAD, LED, 1-FACE, 5-SECTION, BRACKET MOUNTED	EACH	11	4		1		1		4	2		**************************************	1

									E CITY OF NAPERVILLE
FILE NAME #	USER NAME * #USER#	DESIGNED -	DW	REVISED Addendum A 02/20/2013			TRAFFIC SIGNALS	50% COST TO TH	E CITY OF NAPERVILLE
K:\Projecta\@90059\Design\Sheet files\&	39+ xo500.dgn	DRAWN -	JOH	REVISED -	STATE OF ILLINOIS		SUMMARY OF QUANTITIES	338 (112 & 113) WRS-7	DUPAGE 1156 593
	PLOT SCALE + #SCALE#	CHECKED -	KAM	REVISED -	DEPARTMENT OF TRANSPORTATION	L			CONTRACT NO. 60R30
L	PLOT DATE + 1/28/2813	DATE -		REVISED -		SCALE:	SHEET NO. 1 OF 2 SHEETS STA. TO STA.	ILLINOIS FED.	



			IL 59 @ NEW YORK ST/	AURORA AVE. @ NAPER PLAZA	IL 59 @ MEJERWESTRIDGE	L 59 @ LIBERTY ST/	LIBERTY ST. @ COMVERCIAL DRIVEWAY	IL 59 @ MERIDIAN PKWY/	IL 59 @ NORTH AURORARD,	NORTH AURORA RD.@ FAIRWAY DR. *	PUMP STATION #47	NORTH AURORA	IL 59 INTERCONNEC
			AURORAAVE.	WESTRIDGE C.T.	COURTENTR.	JEFFERSON AVE.	(MEUER)	GLACIER PARK DR.	<b> </b>	<u> </u>		*	CONTRACT 60R
ITEM SGNAL HEAD, LED, 1-FACE, 5-SECTION, MAST-ARM MOUNTED	EACH	TOTAL		+		-							<b></b>
		39	4	<u> </u>	8	8	ll	8	8	\$			
SIGNAL HEAD, LED, 2-FACE, 5-SECTION, BRACKET MOUNTED	EACH	1								1			ļ
SIGNAL HEAD, LED, 2.FAGE, 1-3 SECTION, 1-5 SECTION, BRACKET MOUNTED	EACH	6	4		11					1			
PEDESTRIAN SIGNAL HEAD, LED, 1-FACE, BRACKET MOUNTED WITH COUNTDOWN TIMER	EACH	18	4		4			***	4	6			
PEDESTRIAN SIGNAL HEAD, LED, 2-FACE, BRACKET MOUNTED WITH COUNTDOWN TIMER	EACH	10	<u> </u>		2	4		4					<b> </b>
PEDESTRIAN SIGNAL HEAD, LED, 3-FACE, BRACKET MOUNTED WITH COUNTDOWN TIMER	EACH	10	4				<u> </u>		4	5.			
TRAFFIC SIGNAL BACKPLATE; LOUVERED, ALWANUM	EACH	111	16	<u> </u>	.16	22		22	. 24	11			
INDUCTIVE LOOP DETECTOR	EACH	100	21		9	16		21	22	11	·	· · · · ·	
DETECTOR LOOP, TYPE I	FOOT	1,511	497			64	204		333	443			
PREFORMED DETECTOR LOOP	FOOT	6,207	654	<b> </b>	1094	1806		1786	837				·
LIGHT DETECTOR	EACH	22	4		3	<u></u>	<b> </b>	4	5	Z	· · · · · · · · · · · · · · · · · · ·	<u> </u>	l
LIGHT DETECTOR AMPLIFIER	EACH	G	11		1	1			1	1			L
PEDESTRIAN PUSH-BUTTON	EACH	- 58	12	<b>.</b>	8	. <del>8</del>		8	12	10			
TEMPORARY TRAFFIC SIGNAL INSTALLATION	EACH	8	1	11	1	-1	1	1.	11	1			
REMOVE ELECTRIC CABLE FROM CONDUIT	FOOT	2,939							L	2939		<b>↓</b>	
REMOVE EXISTING TRAFFIC SIGNAL EQUIPMENT	EACH	6	1		1	·. <b>1</b>		<u>5</u> .	.1	. †			
REMOVE EXISTING HANDHOLE	EACH	<u>\$1</u>	14		11	12		÷ <del>()</del>	.20	:5			10
REMOVE EXISTING CONCRETE FOUNDATION	EACH	50	9		<u>.</u>	9		9	9	5.		<u> </u>	
RE-OPTIMIZE TRAFFIC SIGNAL SYSTEM LEVEL 2	EACH	1	4	<u></u>							۲۰۰۰ «۱۰۰۰»، «۱۰۰۰»، «۱۰۰۰»، «۱۰۰۰»، «۱۰۰۰»، «۱۰۰۰»، «۱۰۰۰»، «۱۰۰۰»، «۱۰۰۰»، «۱۰۰۰»، «۱۰۰۰»، «۱۰۰۰»،	1	Lan
TEMPORARY TRAFFIC SIGNAL TIMING	EACH	8	1.	1	1	1	1	1	.1	1			
CLOSED CIRCUIT TELEVISION DOME CAMERA	EACH	1	L				I		1			l	
EMERGENCY VEHICLE PRIORITY SYSTEM LINE SENSOR CABLE, NO. 20 3/C	FOOT	6.099	1020	<u> </u>	820	1134		1101	2971	385			<b>_</b>
CLOSED CIRCUIT TELEVISION VIDEO CODEC	EACH		<u> </u>	ļ					1			4	L
CLOSED CIRCUIT TELEVISION EQUIPMENT, FIBER OPTIC DISTRIBUTION	EACH		ļ	<b>_</b> ,,,					<u>t</u>		,,,,,,		
MODIFICATION OF EXISTING VIDEO DISTRIBUTION SYSTEM	LSUM	<u>t</u>							1	······································			L
FULL-ACTUATED CONTROLLER AND TYPE V CABINET, SPECIAL	EACH	1							ļ	1			ļ
UNINTERRUPTABLE POWER SUPPLY, SPECIA.	EACH	6	1		1	11		1	1	1			<u> </u>
FIBER OPTIC CABLE IN CONDUIT: NO. 62:5/125, M412F SM24F	FOOT	10,761	L	ļ					ļ				10761
MASTER CONTROLLER (SPECIAL)	EACH	1								1			
FULL-ACTUATED CONTROLLER AND TYPE IV CABINET, SPECIAL	EACH	5	1	L	1	1			1		· · · · · · · · · · · · · · · · · · ·		L
STEEL COMBINATION MAST ARM ASSEMBLY AND POLE WITH DUAL MAST ARMS, 28 FT, AND 4L FT.	EACH	1		Į				·······	1				
STEEL COMBINATION MAST ARM ASSEMBLY AND POLE WITH DUAL MAST ARMS, 22 FT, AND 50 FT.	EACH	1	L						1				
STEEL COMBINATION MAST ARM ASSEMBLY AND POLE WITH DUAL MAST ARMS, 26 FT. AND 50 FT.	EACH	1							1				
STEEL COMBINATION MAST ARM ASSEMBLY AND POLE WITH DUAL MAST ARMS, 28 FT. AND 50 FT.	EACH	1			1			· · · · · ·					
STEEL COMBINATION MAST ARM ASSEMBLY AND POLE WITH DUAL MAST ARMS, 26 FT. AND 52 FT.	EACH	1		I		1						Į	L
STEEL CONDINATION MAST ARM ASSEMBLY AND POLE WITH DUAL MAST ARMS, 26 FT. AND 52 FT.	EACH	1		<b>.</b>				1				l	
STEEL COMBINATION MAST ARM ASSEMBLY AND POLE WITH DUAL MAST ARMS, 26 FT. AND 54 FT.	EACH	1						1					
STEEL COMBINATION MAST ARM ASSEMBLY AND POLE WITH DUAL MAST ARMS, 30 FT, AND 50 FT.	EACH	1						1				Į	L
STEEL COMBINATION MAST ARM ASSEMBLY AND POLE WITH DUAL MAST ARMS, 30 FT, AND 56 FT.	EACH	11	L	ļ		11	I						L
STEEL COMBINATION MAST ARM ASSEMBLY AND POLE WITH DUAL MAST ARMS, 28 FT, AND 60 FT,	EACH	<u>. 1</u>		<b></b>				11					
STEEL CONDINATION MAST ARM ASSEMBLY AND POLE WITH DUAL MAST ARMS, 24 FT, AND 66 FT.	EACH	1		L		1							
ILLUMINATED STREET NAME SIGN	EACH	18	*** 4		** 2	** 4		** 4	**4				
PEDESTRIAN PUSHBUTTON POST, TYPE A	EACH					~~~~~~~~~~~~~~~~~~~~~~~~~~~~~~~~~~~~~~		ممممغمممم				00000000	0000000
OPTIMIZE TRAFFIC SIGNAL SYSTEM	EACH	1	1	1			1					1	1


FIL	E NAME =	USER NAME = BUSERS	DESIGNED ~	DW	REVISED Addendum A 02/20/2013				TRAF	FIC SIGN	2 IAM
K٤N	Projects\@98059\Design\Sheet Files\&	19r va5002.dgn	DRAWN -	JDH	REVISED -	STATE OF ILLINOIS	1				
		PLOT SCALE . #SCALE.	CHECKED -	кин	REVISED -	DEPARTMENT OF TRANSPORTATION	1	SU	IMMAR	y of an	JANTI
		PLOT DATE + 2/14/2013	DATE -		REVISED -		SCALE:	SHEET NO.	2 OF 2	SHEETS	STA.

 $\mathbb{A}$ 


STA.	TO STA.				BLIN	DIS FI	ED, AID	PROJEC			
			1	S 1	2		T	CONT	RAC	T NO.	60R30
NTITIES		338	a	281	13) W	RS-7		DUP	AGE	1156	594
NLS		F.A. RTÉ,		\$EC	TION			COUN	iTY	TOTAL	SHEE
		*								NAPER AUROR	
			* 10	90% C	OST	TO	THE	CITY	OF	NAPER	VILLE

# LOOP DETECTOR NOTES

- 1. EACH PAIR OF LOOP WIRES SHALL BE PLACED IN A SEPARATE EMPTY COILABLE NONMETALLIC CONDUIT FROM THE EDGE OF PAVEMENT TO THE HANDHOLE. SPACING BETWEEN THE HOLES DRILLED IN THE PAVEMENT SHALL NOT BE LESS THAN 6" (150 mm). EMPTY COILABLE NONMETALLIC CONDUIT SHALL BE INCLUDED IN THE COST OF THE LOOP WIRE.
- 2. THE NUMBER OF LOOP TURNS SHALL BE AS RECOMMENDED BY THE AMPLIFIER MANUFACTURER. ALL ADJACENT SIDES OF THE LOOPS SHALL BE INSTALLED IN SUCH A WAY THAT THE CURRENT FLOW IS IN THE SAME DIRECTION TO REINFORCE ITS MAGNETIC FIELDS FOR SMALL VEHICLE DETECTION.
- 3. EACH LOOP LEAD-IN SHALL BE IDENTIFIED AND PERMANENTLY TAGGED IN THE HANDHOLE. EACH LEAD-IN CABLE TAG SHALL INDICATE THE LOCATION OF THE LOOP, LOOP ROTATION (CLOCKWISE/COUNTERCLOCKWISE), LOOP LEAD-IN DIRECTION (IN CR OUT), LOOP CABLE NUMBER AND LOCATION IN CABINET, AND NUMBER OF TURNS IN THE DETECTOR LOOPS IN WATER PROOF INK AS INDICATED ON THE DISTRICT 1 STANDARD TRAFFIC SIGNAL DESIGN DETAIL. THE CONTRACTOR SHALL MARK LOOP LOCATIONS ON RECORD DRAWINGS AND PRESENT TO THE ENGINEER AFTER FINAL INSPECTION. LOOPS SHALL BE WARKED BY LANE AND LOOP NUMBER. SEE DETAIL BELOW.
- 4. ALL LOOP CABLE SHALL BE FASTENED WITH PLASTIC TIE WRAP TO THE HANDHOLE HOOKS.
- 5. IN ASPHALT PAVEMENT, LOOPS SHOULD BE PLACED IN THE BINDER AND DIVEHOLES MARKED AT THE CURB WITH A SAW-CUT. THE SAW-CUT SHALL BE CUT IN ACCORDANCE WITH LOCAL AND E.P.A. DUST CONTROL REQUIREMENTS. DETECTOR LOOP(S) SHALL NOT BE INSTALLED IN WET CONDITIONS AND THE SAW-CUTS MUST BE FREE OF DEBRIS AND RESIDUE SUCH AS DUST AND WATER WHICH IS TO BE ACHIEVED BY THE USE OF COMPRESSED AIR, WIRE BRUSHING AND HEAT DRYING ACCORDING TO SEALANT MANUFACTURER REQUIREMENTS. THE DETECTOR WIRE SHALL BE HELD IN PLACE BY THE USE OF FORM WEDGES. WEDGES SHALL BE SPACED NO MORE THAN 18" (450 mm) APART.
- 6. LOOP SPLICES SHALL BE SOLDERED USING A SOLDERING IRON. BLOW TORCHES OR OTHER DEVICES WHICH OXIDIZE COPPER CABLE SHALL NOT BE ALLOWED FOR SOLDERING OPERATIONS. SEE DETAIL BELOW RIGHT.
- 7. PREFORMED DETECTOR LOOPS SHALL BE USED, AS SHOWN ON THE PLANS, WHERE NEW CONCRETE PAVEMENT IS PROPOSED. THE INSTALLATION OF PREFORMED LOOPS SHALL BE IN ACCORDANCE WITH THE DISTRICT 1 SPECIFICATIONS OR AS DIRECTED BY THE ENGINEER.

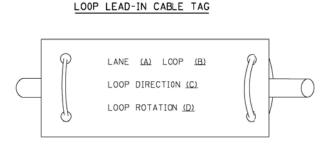


- A. LANE 1 IS THE LANE CLOSEST TO THE CENTERLINE OF THE ROADWAY
- B. LOOP \*1 IS THE LOOP IN THE LANE CLOSEST TO THE INTERSECTION.
- C. LABEL LOOP CABLE "IN" OR LOOP CABLE "OUT".
- D. LABEL LOOP CABLE CLOCKWISE OR LOOP CABLE COUNTERCLOCKWISE.

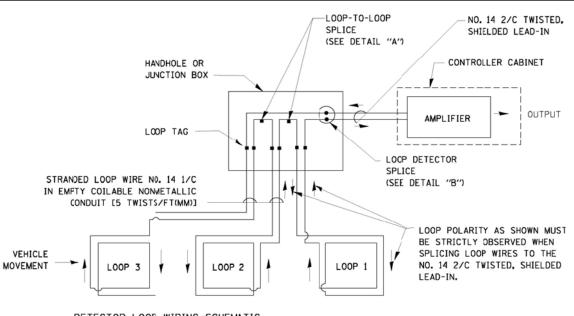


# DETECTOR LOOF WIRING SCHEMATIC

- LOOPS SHALL BE SPLICED IN SERIES.
- SAW-CUTS SHALL BE A MINIMUM WIDTH OF 5/16" (8 mm).
- SAW-CUT DEPTHS SHALL BE 3" (75 mm). IF IN CONCRETE, THE SAW-CUT DEPTH SHALL BE TO THE TOP OF THE REINFORCEMENT.
- LOOP CORNERS SHALL BE DRILLED WITH A 2" (50 mm) DIAMETER CORE.

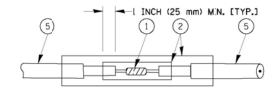

DETAIL "A" LOOP-TO-LOOP SPLICE

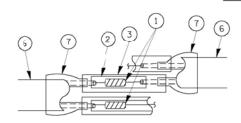

DETAIL "A" LOOP-TO-LOOP SPLICE

LOOP DETECTOR SPLICE


- WESTERN UNION SPLICE SOLDERED WITH ROSIN CORE FLUX. ALL EXPOSED SURFACES 1 OF THE SOLDER SHALL BE SMOOTH.
- (2) WCSMW 30/100 HEAT SHRINK TUBE, MINIMUM LENGTH 3" (75 mm), UNDERWATER GRADE.
- (3) WCS 200/750 HEAT SHRINK TUBE, MINIMUM LENGHT 6" 150 mm), UNDERWATER GRADE.
- (4) NC. 14 2/C TWISTEC, SHIELDED CABLE.
- (5) LCOP CONDUCTOR WITH FLEXIBLE PLASTIC TUBE.
- 6 PRE-FORMED LOOP

XL POLYOLEFIN 2 CONDUCTOR BREAKOUT SEALS. TYCO CBR-2 OR APPROVED EQUAL

FILE NAME =	USER NAME = \$USER\$	DESIGNED -	DW	REVISED -						F.A. RTE	SECTION	COUNTY	TOTAL SHEET
K:\Projects\090059\Design\Sheet Files	IDDT DETAIL_1.dgn	DRAWN -	JDH	REVISED -	STATE OF ILLINOIS					338	(112 & 113) WRS-7	DUPAGE	1156 595
	PLOT SCALE = \$SCALE\$	CHECKED -	КММ	REVISED -	DEPARTMENT OF TRANSPORTATION	DISTRICT	ONE – STANDARD TRAFFI	C SIGNAL D	DESIGN DETAILS		TS- 3		T NO. 60R30
	PLOT DATE = 12/6/2012	DATE -		REVISED -		SCALE: N.T.S.	SHEET NO. 1 OF 6 SHEETS	STA.	TO STA.		ILLINOIS FED. A		


V. Bryn Mawr Ave., Suite 602 , 11 60631-3551 3-2600 Fax: 773-283-2602 8619 W. Chicago, I 773-283-: www.RWA



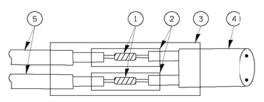


DETAIL "B" LOOP-TO-CONTROLLER SPLICE

TYPE I LOOP

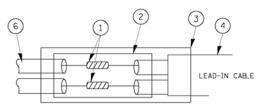


PRE-FORMED LOOP

DETAIL "B" LOOP-TO-CONTROLLER SPLICE

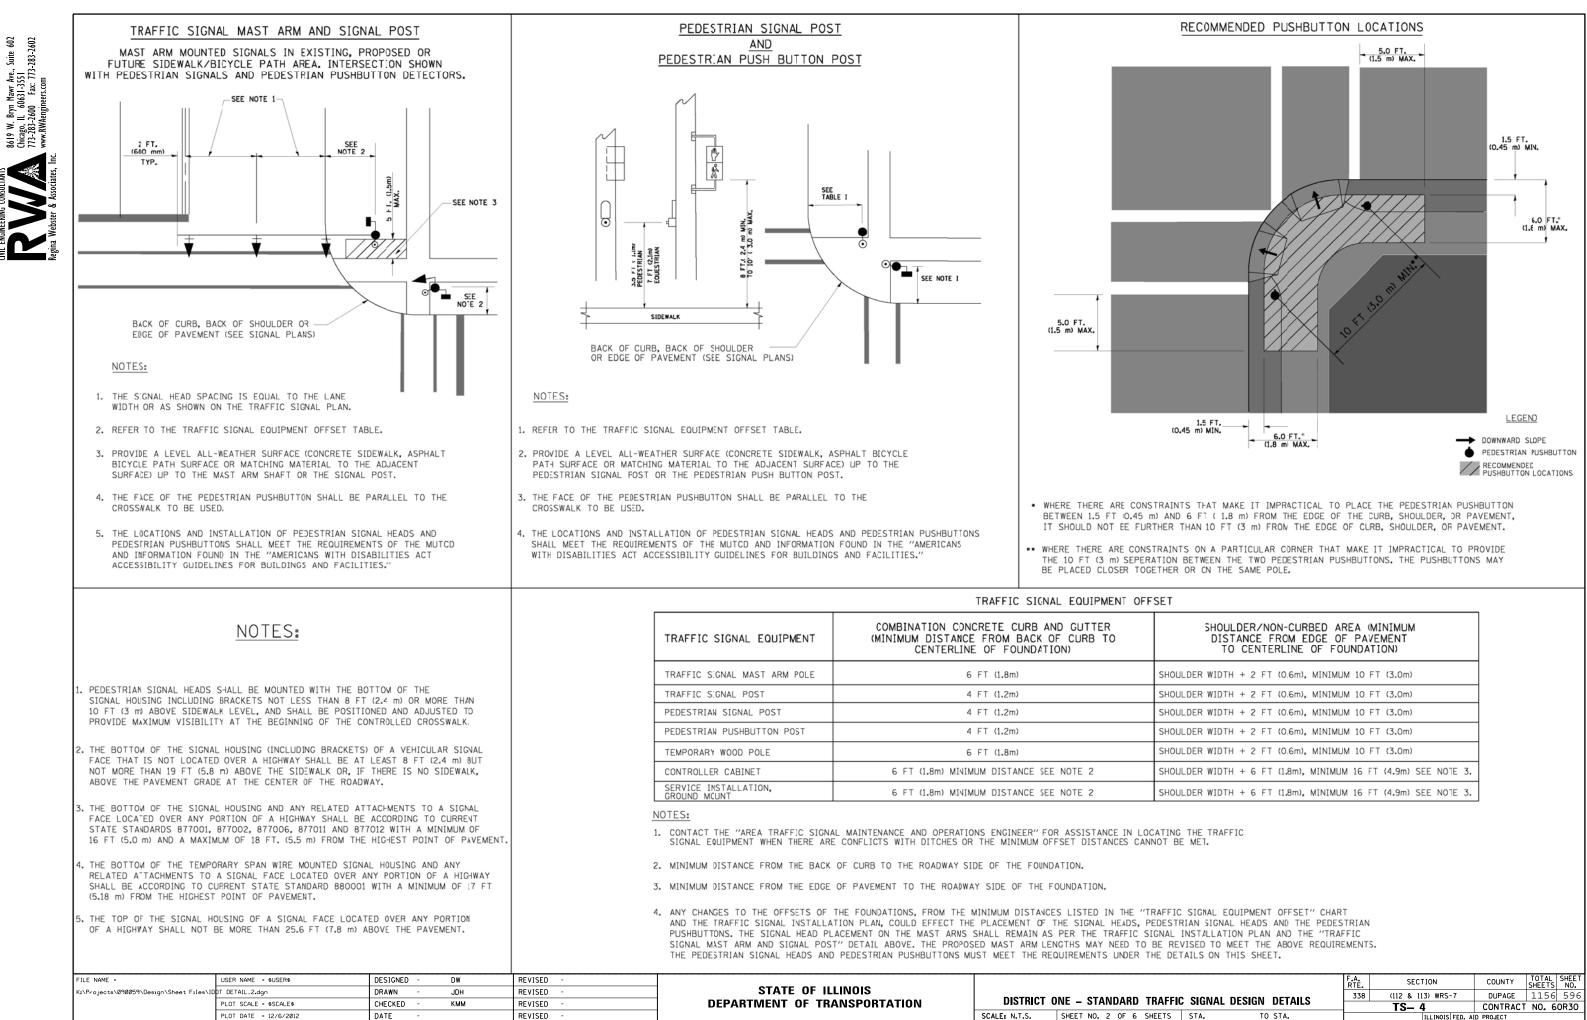


			IN L.				SHELIS	140.
	SIGNAL DESIGI		338	(112 & 113) WRS-	7	DUPAGE	1156	596
IL.	SIGNAL DESIG	V DETAILS		TS- 4		CONTRACT	NO. 6	0R30
	STA.	TO STA.		ILLINOIS	FED. AI	D PROJECT		

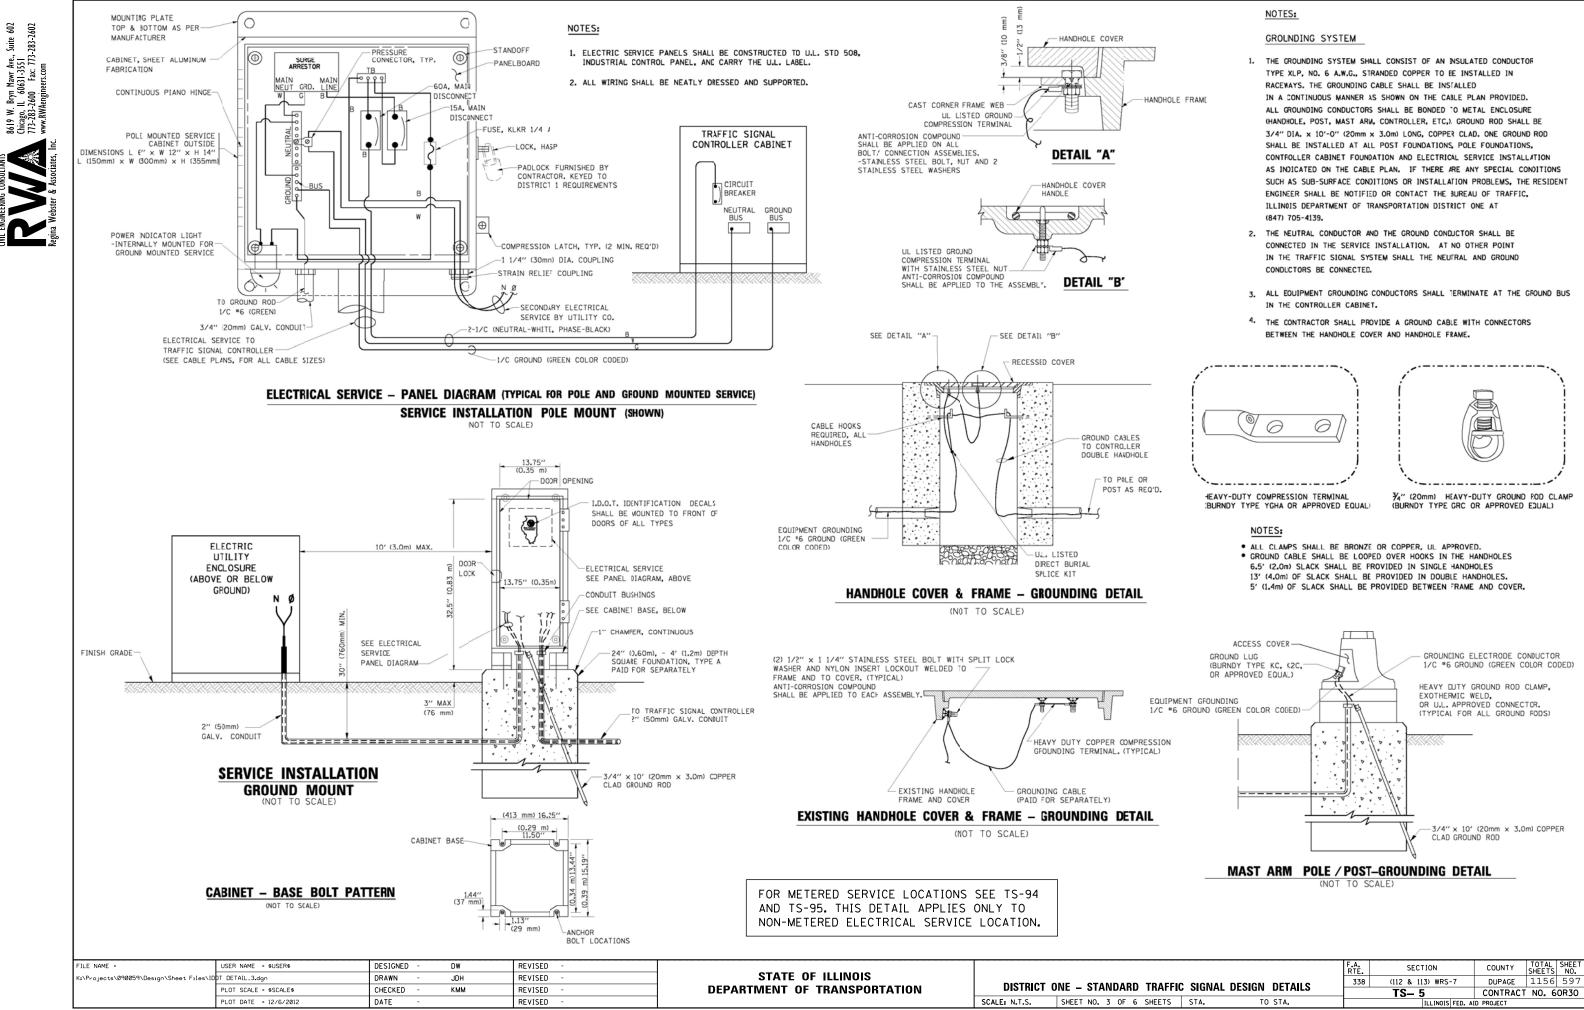

/	
HEAVY-DUTY COMPRESSION TERMINAL	




5	STA.	TO STA.	

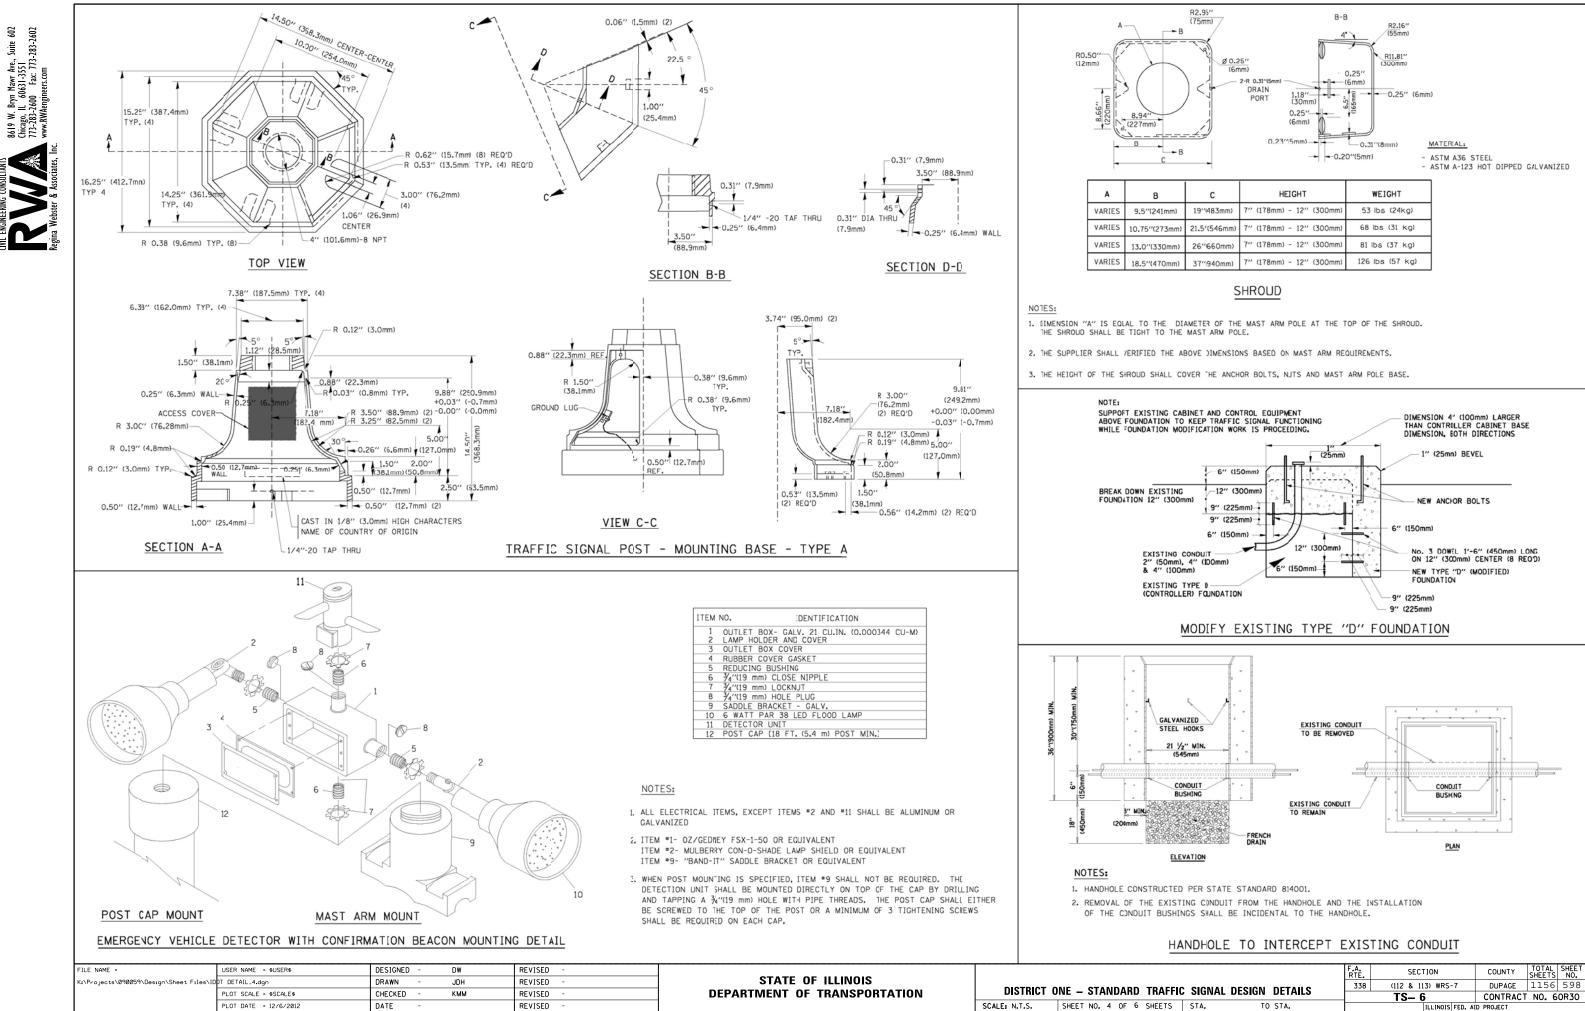

	с	HEIGHT	WEIGHT
)	19''483mm)	7" (178mm) - 12" (300mm)	53 lbs (24kg)
m)	21.5'(546mm)	7" (178mm) - 12" (300mm)	68 lbs (31 kg)
n)	26''660mm)	7" (178mm) - 12" (300mm)	81 lbs (37 kg)
n)	37''940mm)	7" (178mm) - 12" (300mm)	126 lbs (57 kg)

			F.A. RTE.	SECTION		COUNTY	TOTAL SHEETS	SHEET NO.
FIC SIGNAL DESIGN DETAILS		338	(112 & 113) WRS-	-7	DUPAGE	1156	598	
10	SIGNAL DESIGN	DETAILS		TS- 6		CONTRACT	NO. 6	0R30
	STA. TO	) STA.		ILLINOIS	FED. AI	D PROJECT		

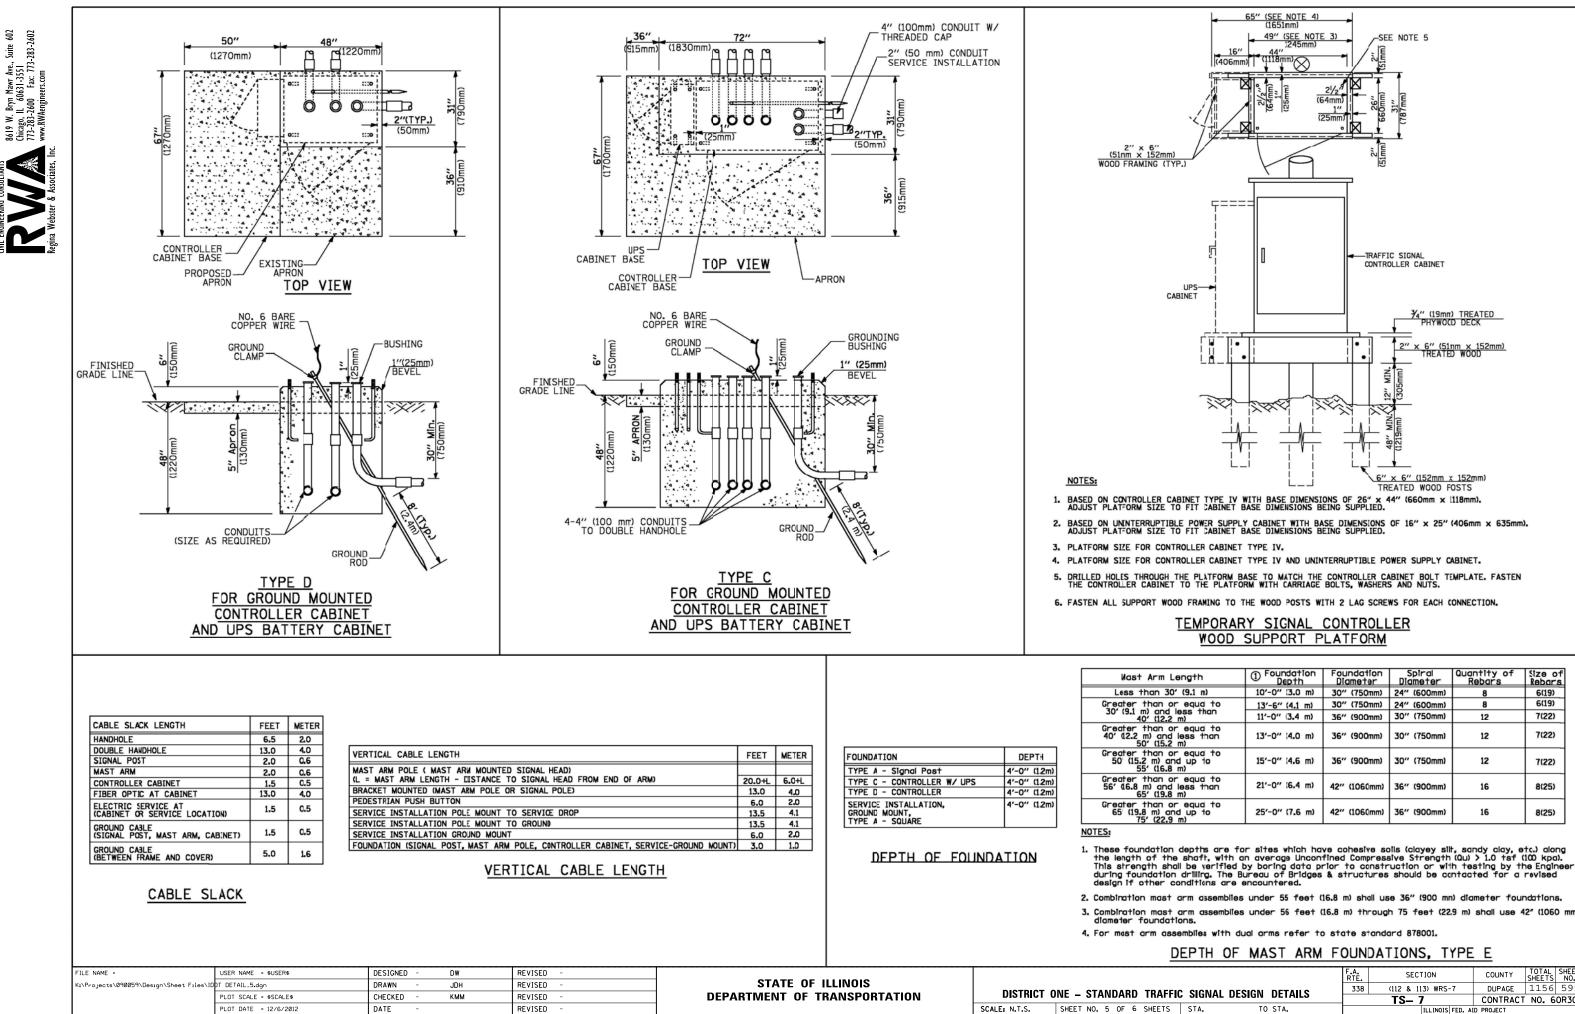

	IN A J	ALVIN I	10014	DATIONS,	
			F.A. RTÉ.	SECTION	COUNTY

				F.A. RTE.	SECTION	COUNTY	TOTAL SHEETS	SHEET NO.
FIC SIGNAL DESIGN DETAILS		338	(112 & 113) WRS-7	DUPAGE	1156	599		
FIC SIGNAL DESIGN DETAILS				TS– 7	CONTRACT	NO. 6	0R30	
	STA.	то	STA.		ILLINOIS FED. AI	D PROJECT		

Length	<ol> <li>Foundation Depth</li> </ol>	Foundation Diameter	Spiral Diameter	Quantity of Rebars	Size of Rebors
Oʻ (9.1 m)	10'-0" (3.0 m)	30" (750mm)	24" (600mm)	8	6(19)
or equa to	13'-6" (4.1 m)	30" (750mm)	24" (600mm)	8	6(19)
less than m)	11'-0" (3.4 m)	36" (900mm)	30" (750mm)	12	7(22)
or equa to I less than ! m)	13'-0" (4.0 m)	36" (900mm)	30" (750mm)	12	7(22)
or equa to nd up to i m)	15'-0" (4.6 m)	36" (900mm)	30" (750mm)	12	7(22)
or equa to I less than i m)	21'-0" (6.4 m)	42" (1060mm)	36" (900mm)	16	8(25)
or equa to nd up to ) m)	25'-0" (7 <b>.</b> 6 m)	42" (1060mm)	36" (900mm)	16	8(25)

# CIVIL ENGINEERING CONSULTANTS 8619 W. Brym Mawr Ave., Suite 602 Chicago, IL. 60631-3551 713-283-2600 Fax: 713-283-2602 kegina Webster & Associates, Inc.

CONTROLLER CABINET			
		$\bowtie$	
RAILROAD CONTROL CABINET			
COMMUNICATIONS CABINET	CCR	ECC	СС
MASTER CONTROLLER		EMC	MC
MASTER MASTER CONTROLLER	D	EMMC	ММС
UNINTERRUPTIBLE POWER SUPPLY	R UPS	EUPS	UPS
SERVICE INSTALLATION, (P) POLE OR (G) GROUND MOUNT	R	-D- <sup>P</sup>	<b>-■</b> <sup>P</sup>
TELEPHONE CONNECTION (P) POLE OR (G) GROUND MOUNT	R	P	P
STEEL MAST ARM ASSEMBLY AND POLE	R	0	•
ALUMINUM MAST ARM ASSEMBLY AND POLE	R	0	
STEEL COMBINATION MAST ARM ASSEMBLY AND POLE WITH LUMINAIRE	<sup>R</sup> O-≭	0-×	• ×
STEEL COMBINATION MAST ARM ASSEMBLY AND POLE WITH PTZ CAMERA	R PTA	् िमोध	₽ <b>Ţ</b>
SIGNAL POST	RO	0	٠
TEMPORARY WOOD POLE (CLASS 5 OR BETTER) 45 FOOT (13.7m) MINIMUM	$\stackrel{R}{\otimes}$	$\otimes$	٢
GUY WIRE	$>^{R}$	$\succ$	$\succ$
SIGNAL HEAD		->	-
SIGNAL HEAD CONSTRUCTION STAGES (NUMBERS INDICATE THE CONSTRUCTION STAGE)			→ <sup>2</sup>
SIGNAL HEAD WITH BACKPLATE	+⊳ R	+>	+►
SIGNAL HEAD OPTICALLY PROGRAMMED		- <b>&gt;</b> ''P''	<b>→</b> "P"
FLASHER INSTALLATION (S DENOTES SOLAR POWER)	0-₩'F''	O-I⊃ <sup>"F</sup> "	• <b>•</b> "F"
PEDESTRIAN SIGNAL HEAD	R -	-0	-1
PEDESTRIAN PUSHBUTTON DETECTOR	®	0	۲
ACCESSIBLE PEDESTRIAN PUSHBUTTON DETECTOR	R © aps	@aps	APS     APS
ILLUMINATED SIGN "NO LEFT TURN"	R	0	
ILLUMINATED SIGN "NO RIGHT TURN"	R	$\bigcirc$	
DETECTOR LOOP, TYPE I			
PREFORMED DETECTOR LOOP		'' [P]	P
MICROWAVE VEHICLE SENSOR	R	۲ M	
VIDEO DETECTION CAMERA	R		V
VIDEO DETECTION ZONE			
PAN, TILT, ZOOM CAMERA	R	PTA	P
WIRELESS DETECTOR SENSOR	RW	Ŵ	W
WIRELESS ACCESS POINT	R		
FILE NAME = USER NAME = \$USER\$		DESIGNED - DW DRAWN - JDH	REVISED REVISED

# TRAFFIC SIGNAL LEGEND

ITEM	REMOVAL	EXISTING	PROPOSED	ITEM
EMERGENCY VEHICLE LIGHT DETECTOR	$\mathbb{R}$	$\bowtie$	•	ELECTRIC CABLE IN CONDUIT, TRA NO. 14 1/C, UNLESS NOTED OTHER
CONFIRMATION BEACON	Ro-J	0O		
HANDHOLE	R			COAXIAL CABLE
HEAVY DUTY HANDHOLE	R. H	Н	Н	VENDOR CABLE FOR CAMERA
DOUBLE HANDHOLE	R			COPPER INTERCONNECT CABLE, NO. 18 3 PAIR TWISTED, SHIELDED
JUNCTION BOX	R	$\bigcirc$	0	FIBER OPTIC CABLE
GALVANIZED STEEL CONDUIT IN TRENCH (T) OR PUSHED (P)				NO. 62.5/125, MM12F FIBER OPTIC CABLE
TEMPORARY SPAN WIRE, TETHER WIRE, AND CABLE	R			NO. 62.5/125, MM12F SM12F
COMMON TRENCH			СТ	FIBER OPTIC CABLE NO. 62.5/125, (NUMBER OF FIBERS & TYPE TO E
COILABLE NONMETALLIC CONDUIT (EMPTY)			CNC	NOTED ON PLANS)
SYSTEM ITEM		S	S	GROUND ROD AT (C) CONTROLLER, (H) HANDHOLE, (P) POST, (M) MAST
INTERSECTION ITEM		Ι	IP	OR (S) SERVICE
REMOVE ITEM	R			CONTROLLER CABINET AND FOUNDATION TO BE REMOVED
RELOCATE ITEM	RL			
ABANDON ITEM	А		_	STEEL MAST ARM POLE AND FOUNDATION TO BE REMOVED
12" (300mm) TRAFFIC SIGNAL SECTION		R	R	ALUMINUM MAST ARM POLE AND FOUNDATION TO BE REMOVED
12'' (300mm) RED WITH 8'' (200mm) YELLOW AND GREEN TRAFFIC SIGNAL FACE		R		STEEL COMBINATION MAST ARM AS
			R	AND POLE WITH LUMINAIRE AND FOUNDATION TO BE REMOVED
		(R) (Y) (G) (V)	YG	SIGNAL POST AND FOUNDATION
SIGNAL FACE		G ( Y	G ◀ Y	TO BE REMOVED
		<b>e</b> C	€G	INTERSECTION & SAMPLING (SYSTEM) DETECTOR
		R	R	SAMPLING (SYSTEM) DETECTOR
SIGNAL FACE WITH BACKPLATE. "P" INDICATES PROGRAMMED HEAD		G	G	EXISTING INTERSECTION LOOP DE
		€ €	<b>4</b> Y <b>4</b> G	PROPOSED INTERSECTION AND SAM
		"P"	<u>لاحمال</u> ۳۳۳	EXISTING PREFORMED INTERSECTION PROPOSED INTERSECTION AND SAM
12" (300mm) PEDESTRIAN SIGNAL HEAD WALK/DON'T WALK SYMBOL		DW W		PREFORMED INTERSECTION AND SA (SYSTEM) DETECTOR
12" (300mm) PEDESTRIAN SIGNAL HEAD INTERNATIONAL SYMBOL, OUTLINED				PREFORMED SAMPLING (SYSTEM) D
12" (300mm) PEDESTRIAN SIGNAL HEAD INTERNATIONAL SYMBOL, SOLID			₽ K	
PEDESTRIAN SIGNAL HEAD, INTERNATIONAL SYMBOL, WITH COUNTDOWN TIMER		C C D	₽ ¢ D	
RADIO INTERCONNECT		- <del>  11+</del> 0		RAILROAD CONTROL CABINET
RADIO REPEATER	RERR	ERR	RR	RAILROAD CANTILEVER MAST ARM
DENOTES NUMBER OF CONDUCTORS, ELECTRIC		 ,		FLASHING SIGNAL
CABLE NO. 14, UNLESS NOTED OTHERWISE, ALL DETECTOR LOOP CABLE TO BE SHIELDED		5	(5)	CROSSING GATE
GROUND CABLE IN CONDUIT NO. 6 SOLID COPPER (GREEN)				CROSSBUCK

- 1		USER NAME = \$USER\$	DESIGNED -	DW	REVISED -	STATE OF ILLINOIS		
	K:\Projects\090059\Design\Sheet Files\ID	PT DETAIL_6.dgn PLOT SCALE = \$SCALE\$	DRAWN - CHECKED -	ЈDН КММ	REVISED - REVISED -	DEPARTMENT OF TRANSPORTATION	DISTRICT	ONE – STANDARD TRAFFIC
l		PLOT DATE = 12/6/2012	DATE -		REVISED -		SCALE: N.T.S.	SHEET NO. 6 OF 6 SHEETS

	REMOVA	<u>L</u>	EXISTING	PROPOSED	
DUIT, TRACER, ED OTHERWISE					
			— <u>c</u>	— <del>_</del>	
RA			—	—	
ABLE, SHIELDED			-6-	-6	
2F			-24F-	-245-	
62.5/125,			$\prec$		
YPE TO BE				-0-	
ROLLER, (M) MAST ARM,			°,∥ <b> </b> ⊸	°,ı⊫⊷	
D VED	RCF				
ND VED	ORMF				
E AND VED	RMF	-			
T ARM ASSEMBLY RE AND VED	RMF O→¤	_			
ATION	RMF				
١G			IS	IS	
CTOR			S	S	
LOOP DETECTOR AND SAMPLING (SYSTEM) DETEC	TOR		P	_	
ERSECTION LOOP DETECTOR AND SAMPLING (SYSTEM) DETEC	TOR		[PP]		
N AND SAMPLING			PIS	PIS	
(STEM) DETECTOR			PS	PS	
RAILROAD	SYN	/IBOL	S		
			XISTING	PROPOSED	
NET		<u>+</u>			
AST ARM		Xož	<del>X X</del> X	Xex X	
			XoX	XoX	
		2	<del>808</del> >>	XOX	
			¥	$\mathbf{F}$	
TRAFFIC SIGNAL DESIGN DET	AILS		SECTION 112 & 113) WRS- <b>TS- 8</b>	CONTRACT NO. 6	600
HEETS STA. TO STA.			ILLINOIS	ED. AID PROJECT	