#### EROSION CONTROL LEGEND TEMPORARY EROSION CONTROL SEEDING TEMPORARY DITCH CHECK TEMPORARY EROSION CONTROL SEEDING TEMPORARY DITCH CHECK INSTALLED AND TEMPORARY EROSION CONTROL BLANKET IN PREVIOUS STAGE PERMANENT SEEDING (SEE NOTE 3) INLET & PIPE PROTECTION TEMPORARY EROSION CONTROL SEEDING OR PERMANENT INLET & PIPE PROTECTION INSTALLED SEEDING INSTALLED IN A PREVIOUS STAGE IN PREVIOUS STAGE TEMPORARY PAVEMENT FLOW DIRECTION (SEE NOTE 4) PERIMETER EROSION BARRIER (SEE NOTE 2) PROPOSED STORM SEWER (SEE NOTE 1) PERIMETER EROSION BARRIER INSTALLED PROPOSED STORM SEWER INSTALLED IN PREVIOUS STAGE IN PREVIOUS STAGE INLET FILTER TEMPORARY PIPE CULVERT PERMANENT DRAINAGE STRUCTURE INLET FILTER INSTALLED IN PREVIOUS STAGE NUMBER (SEE NOTE 1)

CHECKED JCM

DATE

12/14/201

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(\*) - SEE NOTE 5

### NOTES

- 1. SEE PROPOSED DRAINAGE PLANS FOR STORM SEWER INFORMATION.
- 2. PERIMETER EROSION BARRIER SHALL BE ERECTED ADJACENT TO R.O.W., EASEMENT, AND CONSTRUCTION LIMITS AND AS DIRECTED BY THE ENGINEER.
- 3. SEE LANDSCAPING PLANS FOR LANDSCAPING REQUIREMENTS.
- 4. SEE PRE-STAGE CROSS SECTIONS FOR GRADING INFORMATION.
- 5. PROPOSED STRUCTURE SHALL BE BURIED AND TEMPORARILY COVERED/CLOSED WITH STEEL PLATE OF THICKNESS SPECIFIED AND APPROVED BY THE ENGINEER, PAYMENT FOR THIS TEMPORARY COVER INSTALLATION AND REMOVAL SHALL BE CONSIDERED INCLUDED IN THE COST OF THE PROPOSED STRUCTURE.
- 6. REMOVING INLETS/CATCH BASINS/MANHOLES TO MAINTAIN FLOW.

338


**MERIDIAN PARKWAY** 


SCALE: AS SHOWN SHEET NO. 11 OF 70 SHEETS STA. 288+00 TO STA. 298+00

(112 & 113) WRS-7

DUPAGE 1156 701


CONTRACT NO. 60R30

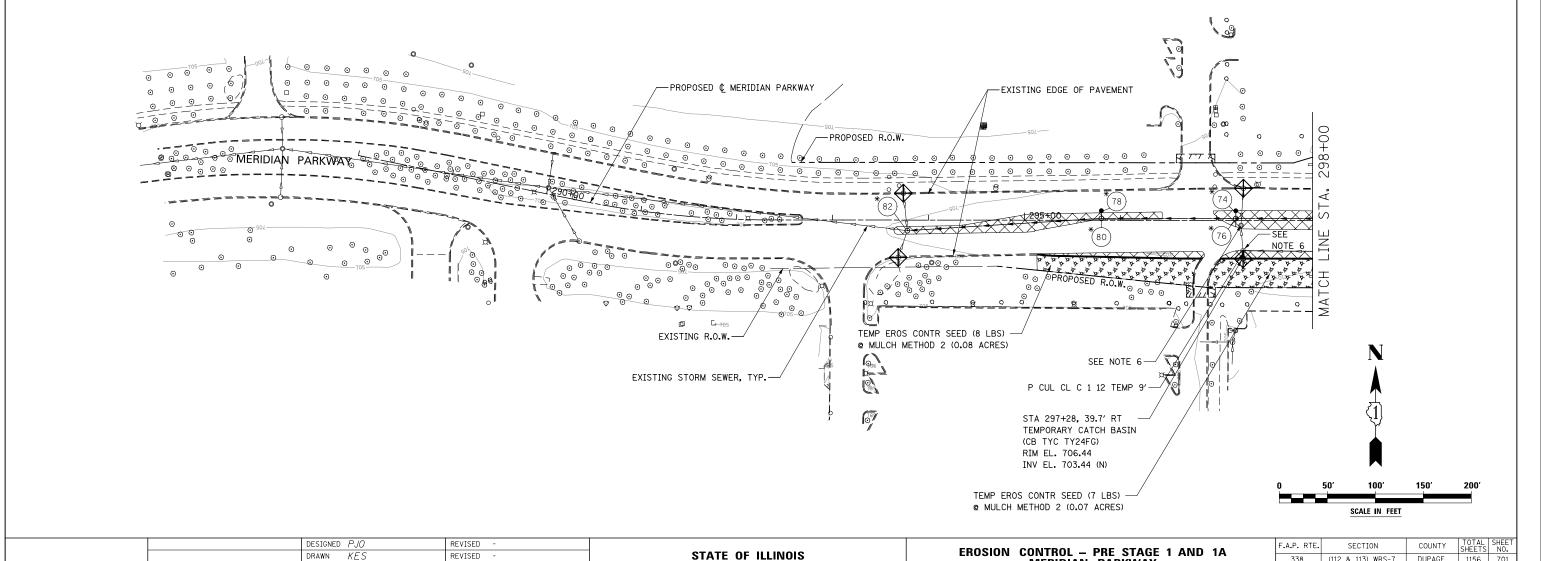


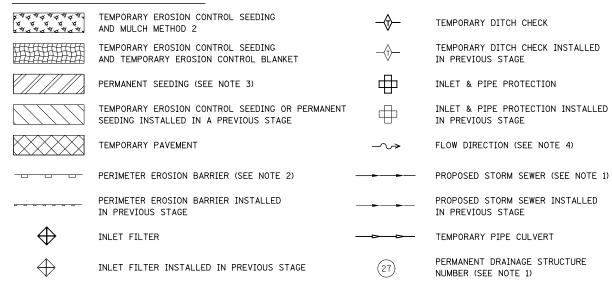

# NOTES

- 1. SEE PROPOSED DRAINAGE PLANS FOR STORM SEWER INFORMATION.
- PERIMETER EROSION BARRIER SHALL BE ERECTED ADJACENT TO R.O.W., EASEMENT, AND CONSTRUCTION LIMITS AND AS DIRECTED BY THE ENGINEER.
- 3. SEE LANDSCAPING PLANS FOR LANDSCAPING REQUIREMENTS.
- 4. SEE PRE-STAGE CROSS SECTIONS FOR GRADING INFORMATION.

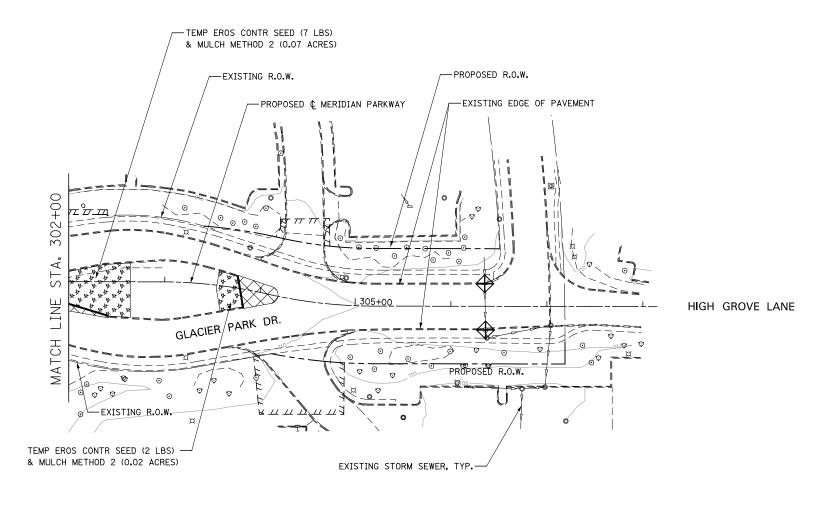

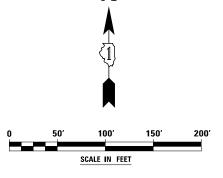


	DESIGNED	PJ0	REVISED	-	
	DRAWN	KES	REVISED	-	
	CHECKED	JCM	REVISED	-	
	DATE	12/14/2012	REVISED	-	

STATE OF ILLINOIS
DEPARTMENT OF TRANSPORTATION

		ERO	SION					– PR PAR		AGE 1 IVE	AND	1 <b>A</b>
ſ	SCALE: A	S SHOWN	SHEET	NO.	12	OF	70	SHEETS	STA.	302+00	TO STA	. 308+00

F.A.P. RTE.	SECTION	COUNTY	TOTAL SHEETS	SHEE NO.
338	(112 & 113) WRS-7	DUPAGE	1156	702
		CONTRACT	NO. 60	DR30
	TILL INOTS FED. A	D PROJECT		

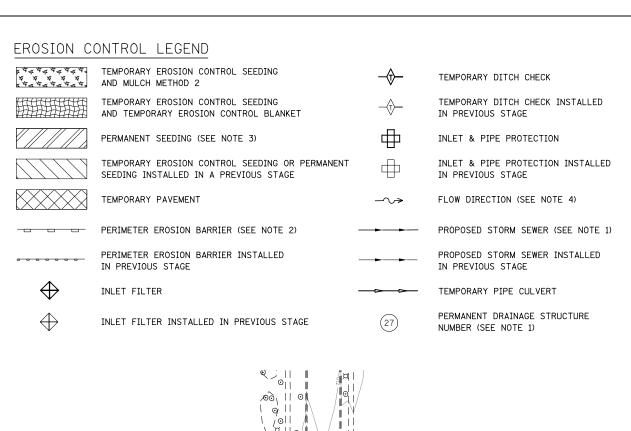

DESIGNED PJO

DRAWN KES

CHECKED JCM

12/14/201

DATE

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# NOTES

- 1. SEE PROPOSED DRAINAGE PLANS FOR STORM SEWER INFORMATION.
- PERIMETER EROSION BARRIER SHALL BE ERECTED ADJACENT TO R.O.W., EASEMENT, AND CONSTRUCTION LIMITS AND AS DIRECTED BY THE ENGINEER.
- 3. SEE LANDSCAPING PLANS FOR LANDSCAPING REQUIREMENTS.
- 4. SEE PRE-STAGE CROSS SECTIONS FOR GRADING INFORMATION.

F.A.P. RTE.

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EROSION CONTROL - PRE STAGE 1 AND 1A NORTH AURORA ROAD

SCALE: AS SHOWN SHEET NO. 13 OF 70 SHEETS STA. 384+00 TO STA. 398+00


SECTION

(112 & 113) WRS-7


COUNTY

DUPAGE 1156 703

CONTRACT NO. 60R30

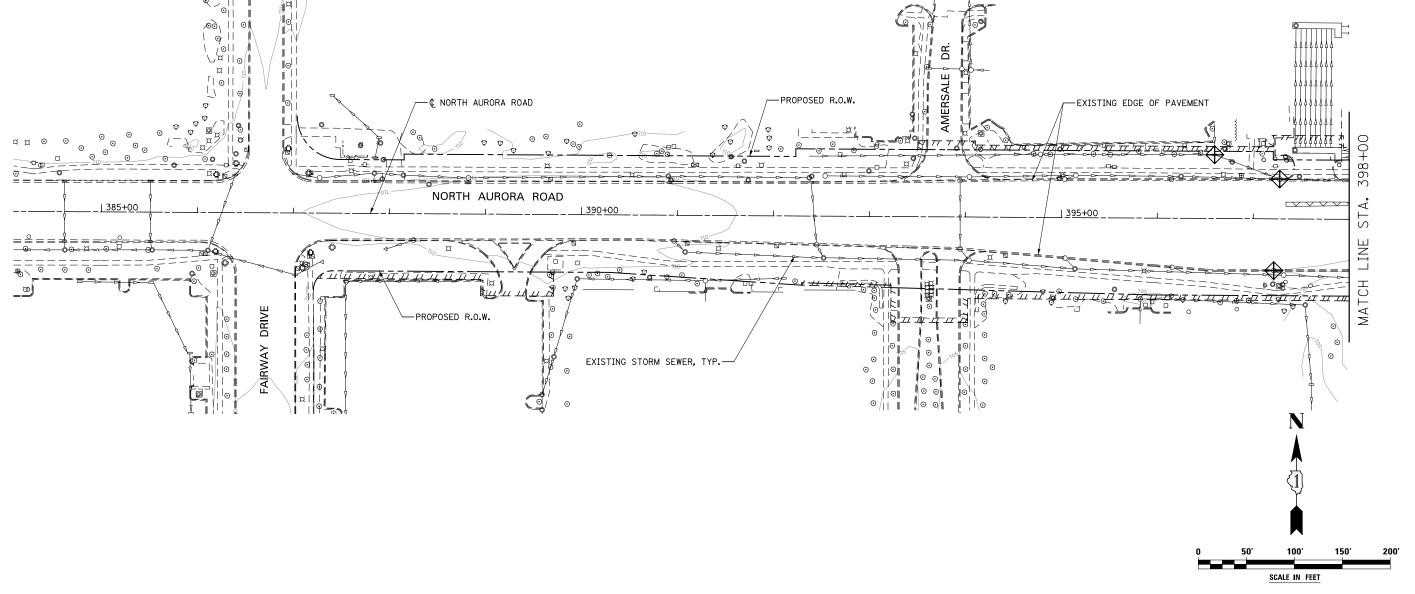

STATE OF ILLINOIS

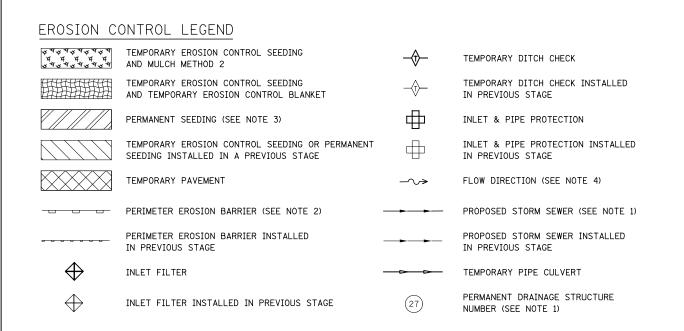

DATE

12/14/201

REVISED

REVISED

### NOTES

- 1. SEE PROPOSED DRAINAGE PLANS FOR STORM SEWER INFORMATION.
- 2, PERIMETER EROSION BARRIER SHALL BE ERECTED ADJACENT TO R.O.W., EASEMENT, AND CONSTRUCTION LIMITS AND AS DIRECTED BY THE ENGINEER.
- 3. SEE LANDSCAPING PLANS FOR LANDSCAPING REQUIREMENTS.
- 4. SEE PRE-STAGE CROSS SECTIONS FOR GRADING INFORMATION.
- 5. REMOVING INLETS/CATCH BASINS/MANHOLES TO MAINTAIN FLOW.

338


**NORTH AURORA ROAD** 


SCALE: AS SHOWN SHEET NO. 14 OF 70 SHEETS STA. 403+00 TO STA. 417+00


(112 & 113) WRS-7


DUPAGE 1156 704

CONTRACT NO. 60R30

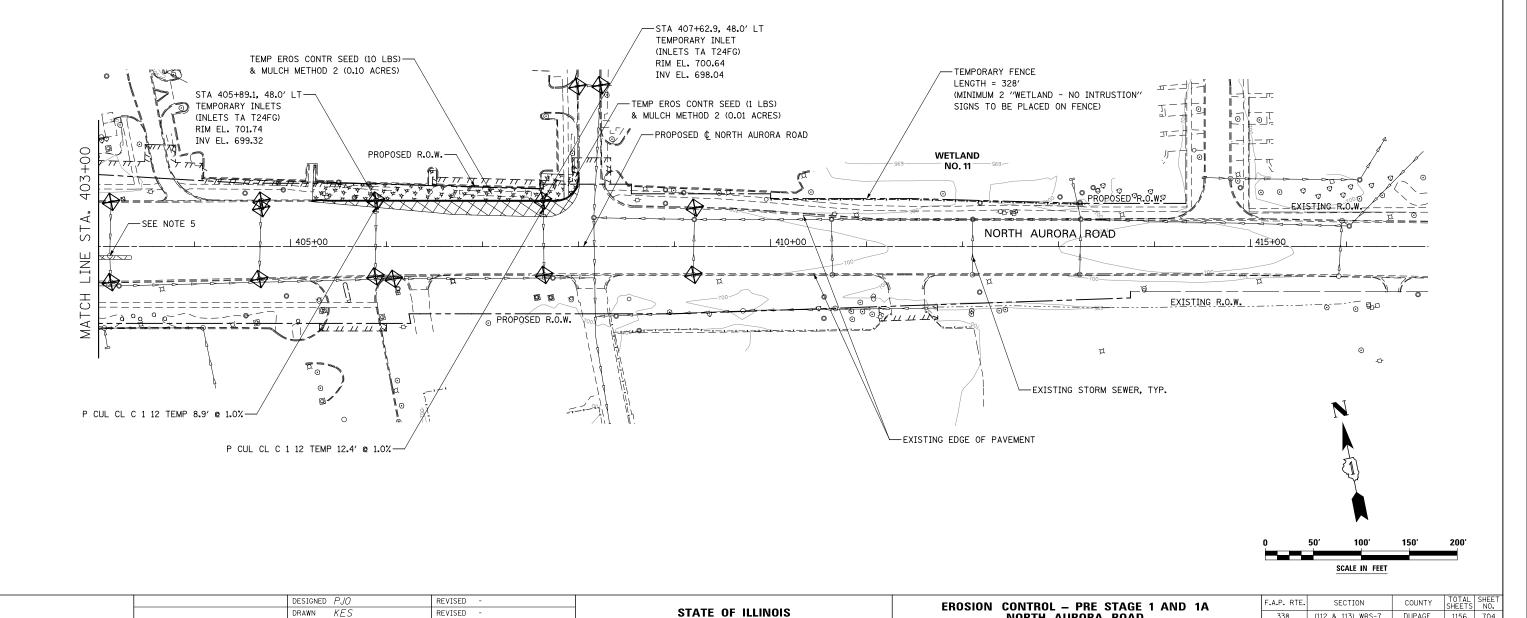

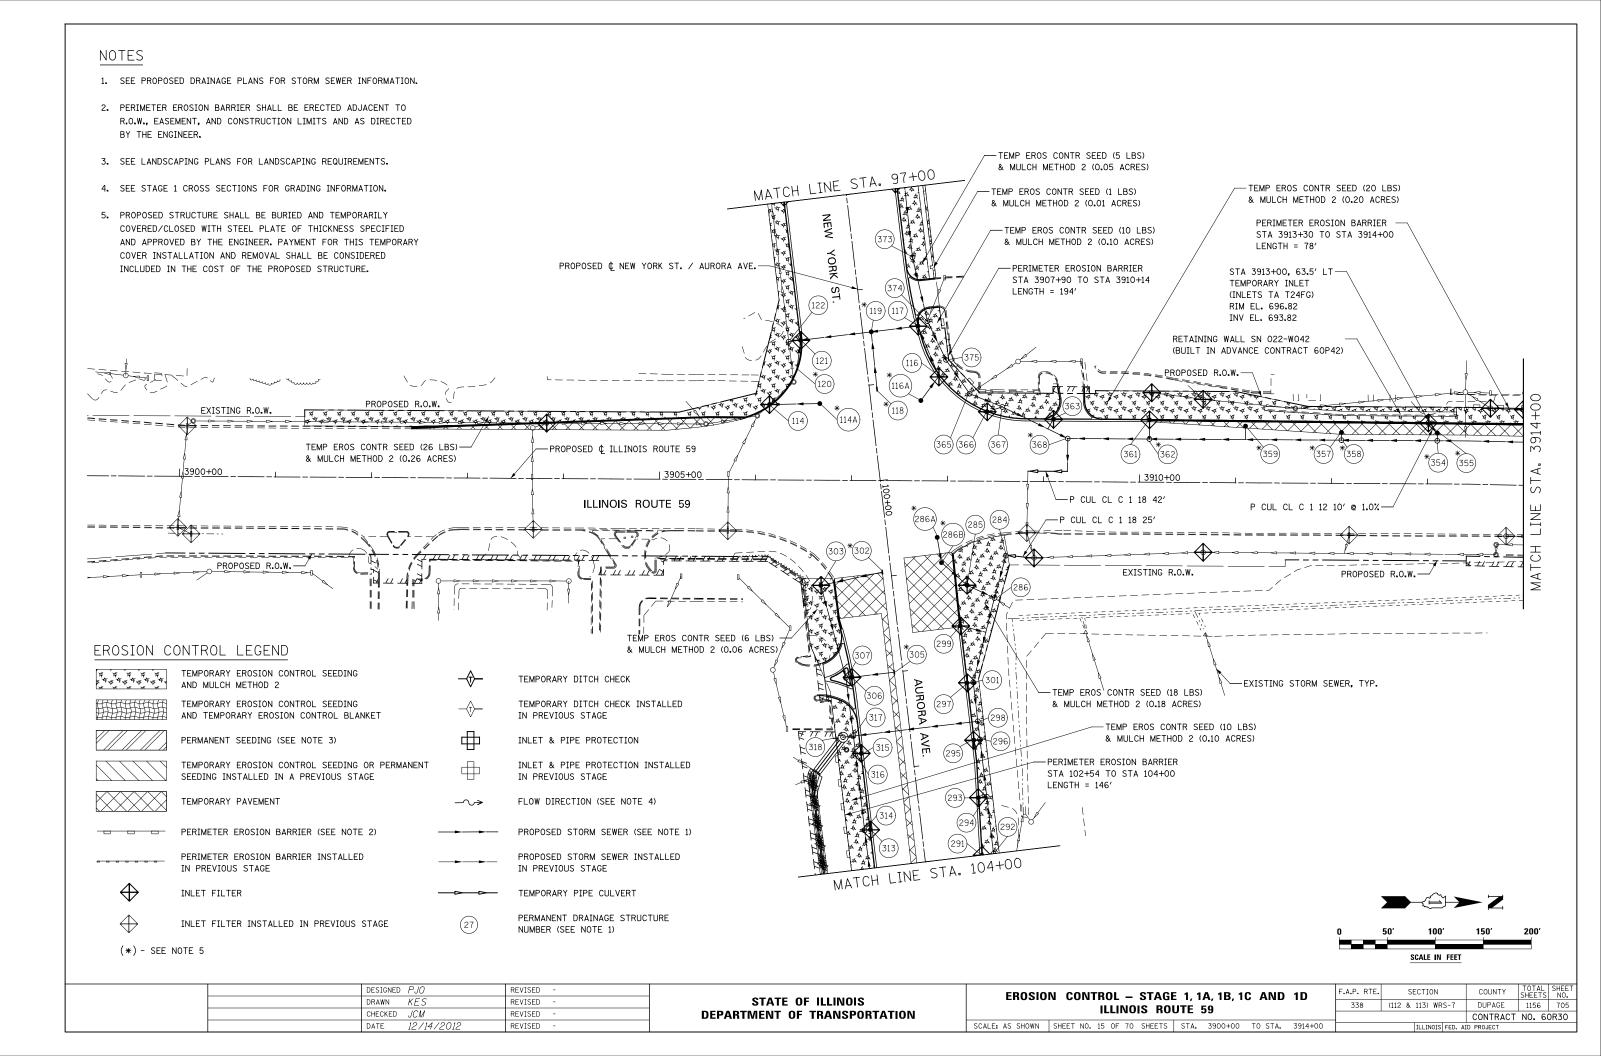

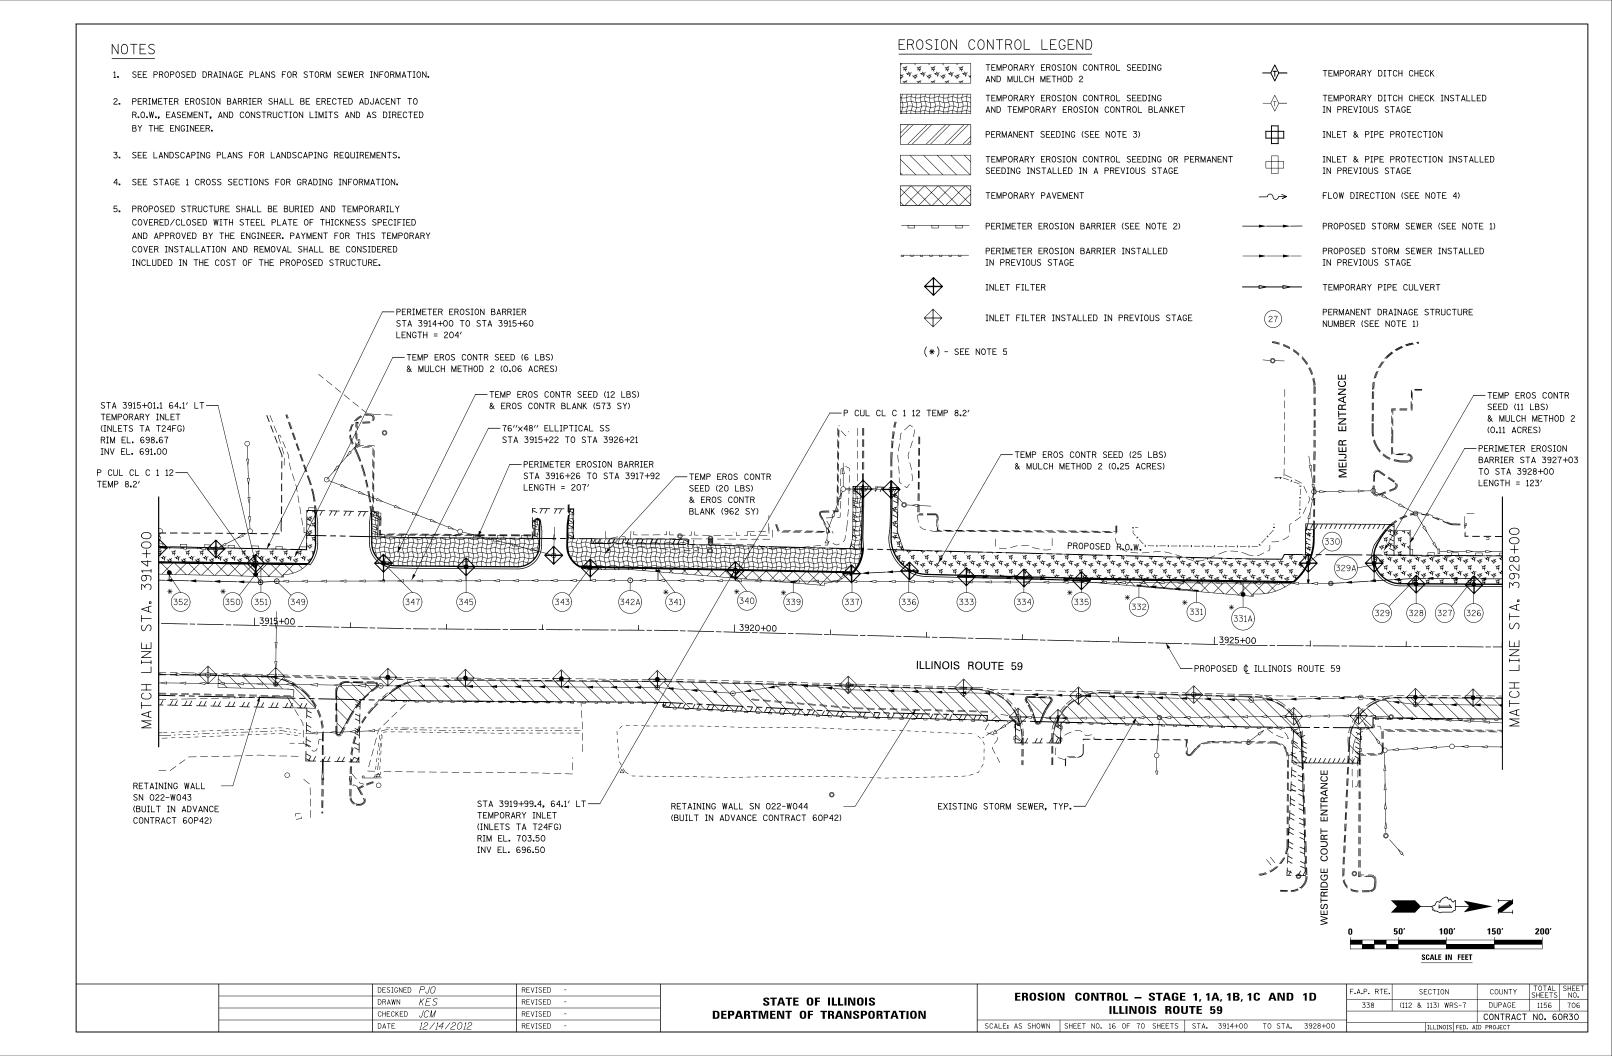

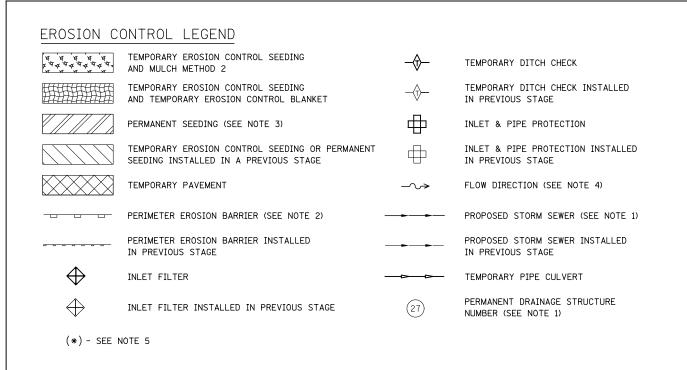

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# NOTES


- 1. SEE PROPOSED DRAINAGE PLANS FOR STORM SEWER INFORMATION.
- PERIMETER EROSION BARRIER SHALL BE ERECTED ADJACENT TO R.O.W., EASEMENT, AND CONSTRUCTION LIMITS AND AS DIRECTED BY THE ENGINEER.
- 3. SEE LANDSCAPING PLANS FOR LANDSCAPING REQUIREMENTS.
- 4. SEE STAGE 1 CROSS SECTIONS FOR GRADING INFORMATION.
- 5. PROPOSED STRUCTURE SHALL BE BURIED AND TEMPORARILY COVERED/CLOSED WITH STEEL PLATE OF THICKNESS SPECIFIED AND APPROVED BY THE ENGINEER. PAYMENT FOR THIS TEMPORARY COVER INSTALLATION AND REMOVAL SHALL BE CONSIDERED INCLUDED IN THE COST OF THE PROPOSED STRUCTURE.

**ILLINOIS ROUTE 59** 


SCALE: AS SHOWN SHEET NO. 17 OF 70 SHEETS STA. 3928+00 TO STA. 3942+00

CONTRACT NO. 60R30

6. STORM SEWERES TO BE FULLY CONSTRUCTED ACROSS ENTIRE ROADWAY, USING A SINGLE LANE NIGHT TIME CLOSURE.

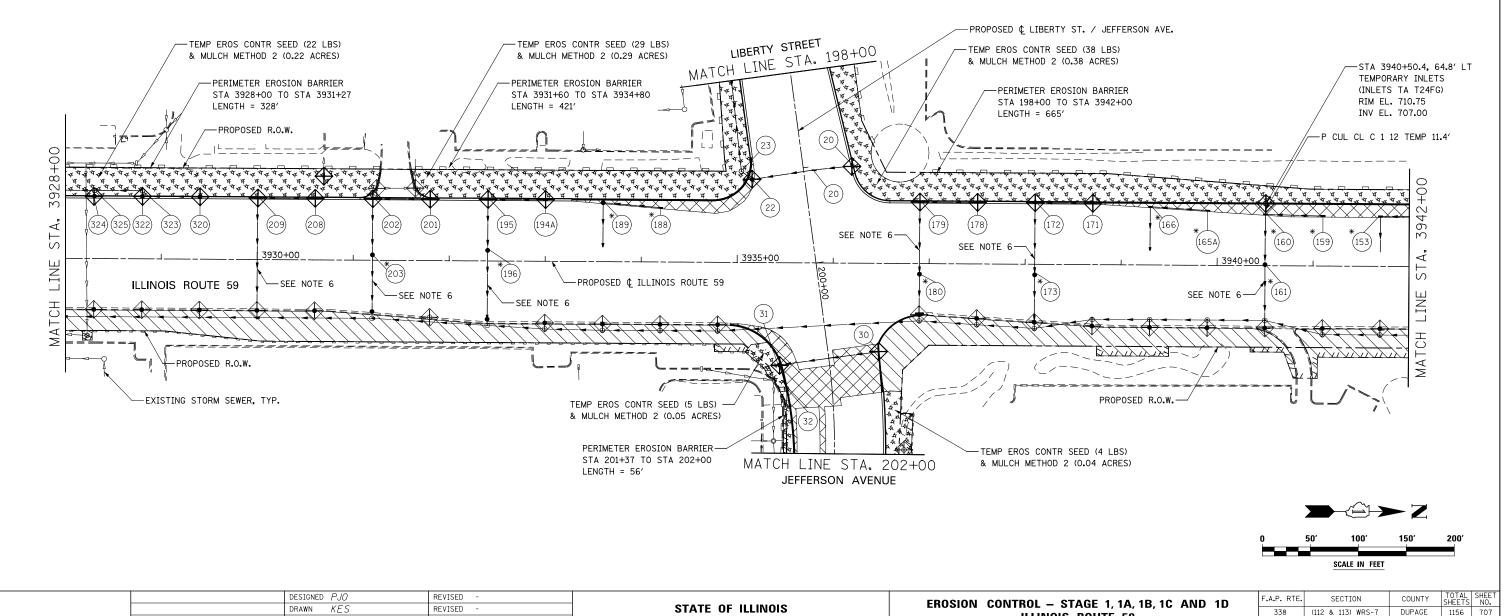

#### NOTES EROSION CONTROL LEGEND TEMPORARY EROSION CONTROL SEEDING 1. SEE PROPOSED DRAINAGE PLANS FOR STORM SEWER INFORMATION. TEMPORARY DITCH CHECK AND MULCH METHOD 2 2. PERIMETER EROSION BARRIER SHALL BE ERECTED ADJACENT TO TEMPORARY EROSION CONTROL SEEDING TEMPORARY DITCH CHECK INSTALLED R.O.W., EASEMENT, AND CONSTRUCTION LIMITS AND AS DIRECTED AND TEMPORARY EROSION CONTROL BLANKET IN PREVIOUS STAGE PERMANENT SEEDING (SEE NOTE 3) INLET & PIPE PROTECTION 3. SEE LANDSCAPING PLANS FOR LANDSCAPING REQUIREMENTS. TEMPORARY EROSION CONTROL SEEDING OR PERMANENT $\oplus$ INLET & PIPE PROTECTION INSTALLED SEEDING INSTALLED IN A PREVIOUS STAGE IN PREVIOUS STAGE 4. SEE STAGE 1 CROSS SECTIONS FOR GRADING INFORMATION. TEMPORARY PAVEMENT FLOW DIRECTION (SEE NOTE 4) 5. PROPOSED STRUCTURE SHALL BE BURIED AND TEMPORARILY COVERED/CLOSED WITH STEEL PLATE OF THICKNESS SPECIFIED PERIMETER EROSION BARRIER (SEE NOTE 2) PROPOSED STORM SEWER (SEE NOTE 1) AND APPROVED BY THE ENGINEER. PAYMENT FOR THIS TEMPORARY COVER INSTALLATION AND REMOVAL SHALL BE CONSIDERED PERIMETER EROSION BARRIER INSTALLED PROPOSED STORM SEWER INSTALLED INCLUDED IN THE COST OF THE PROPOSED STRUCTURE. IN PREVIOUS STAGE IN PREVIOUS STAGE INLET FILTER TEMPORARY PIPE CULVERT PERMANENT DRAINAGE STRUCTURE INLET FILTER INSTALLED IN PREVIOUS STAGE (27) NUMBER (SEE NOTE 1) (\*) - SEE NOTE 5 TEMP EROS CONTR SEED (13 LBS)-& MULCH METHOD 2 (0.13 ACRES) P CUL CL C 1 12 -MERIDIAN PARKWAY TEMP 60.8' @ 1.0% TEMP EROS CONTR SEED (56 LBS) MATCH LINE STA. 298+00 & MULCH METHOD 2 (0.56 ACRES) STA 3942+90.4, 64.6' LT--PROPOSED & MERIDIAN PKWY. / GLACIER PARK DR. TEMP CATCH BASIN -P CUL CL C 1 12 TEMP 77.6' @ 3.5% -PERIMETER EROSION BARRIER (CB TYC TY24FG) STA 3945+64 TO STA 3955+00 RIM EL. 711.58 LENGTH = 936'INV EL. 707.58 (N) -P CUL CL C 1 12 TEMP 57.1' -P CUL CL C 1 12 TEMP 32.6' PERIMETER EROSION P CUL CL C 1 12 BARRIER STA 3942+00 TEMP 51.5' TO STA 3943+93 LENGTH = 207' 3942 (418) (419) \*(440) (413) (446) (415) \*(152) STA. STA. 13945+00 <u> 3950+00</u> **ILLINOIS ROUTE 59** -PROPOSED ¢ ILLINOIS ROUTE 59 $\Leftrightarrow$

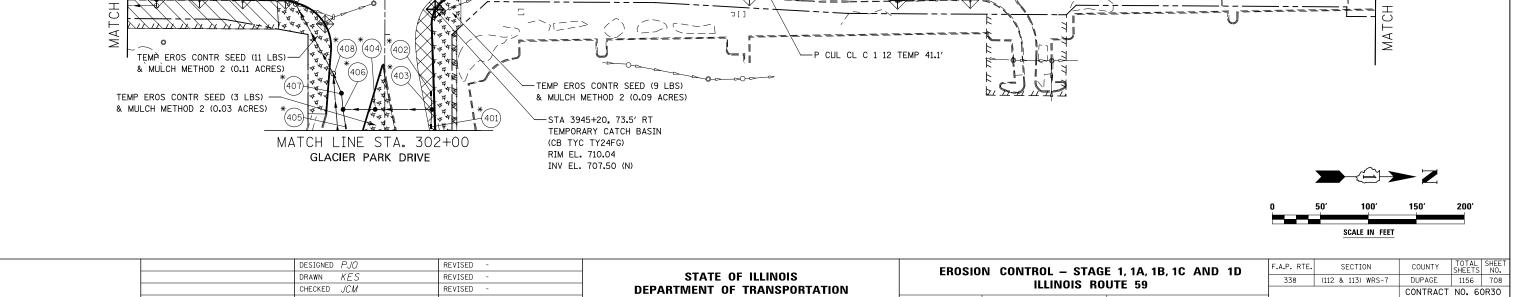



DATE

12/14/201

REVISED

SCALE: AS SHOWN SHEET NO. 18 OF 70 SHEETS STA. 3942+00 TO STA. 3955+00

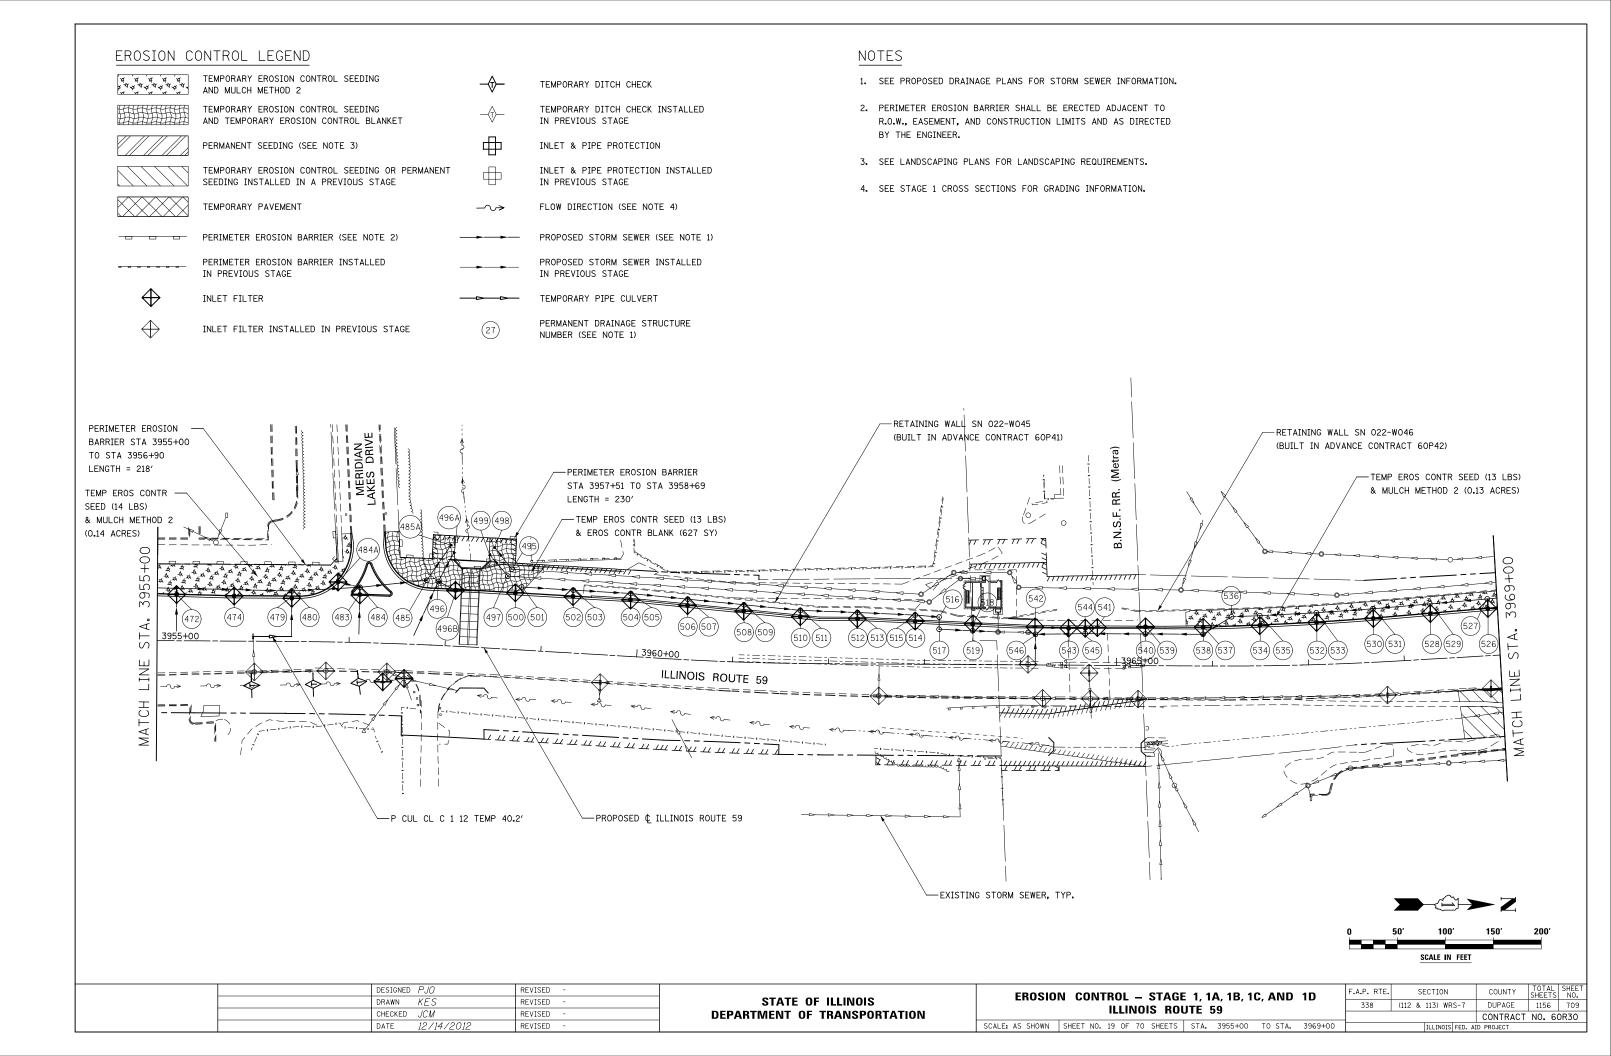

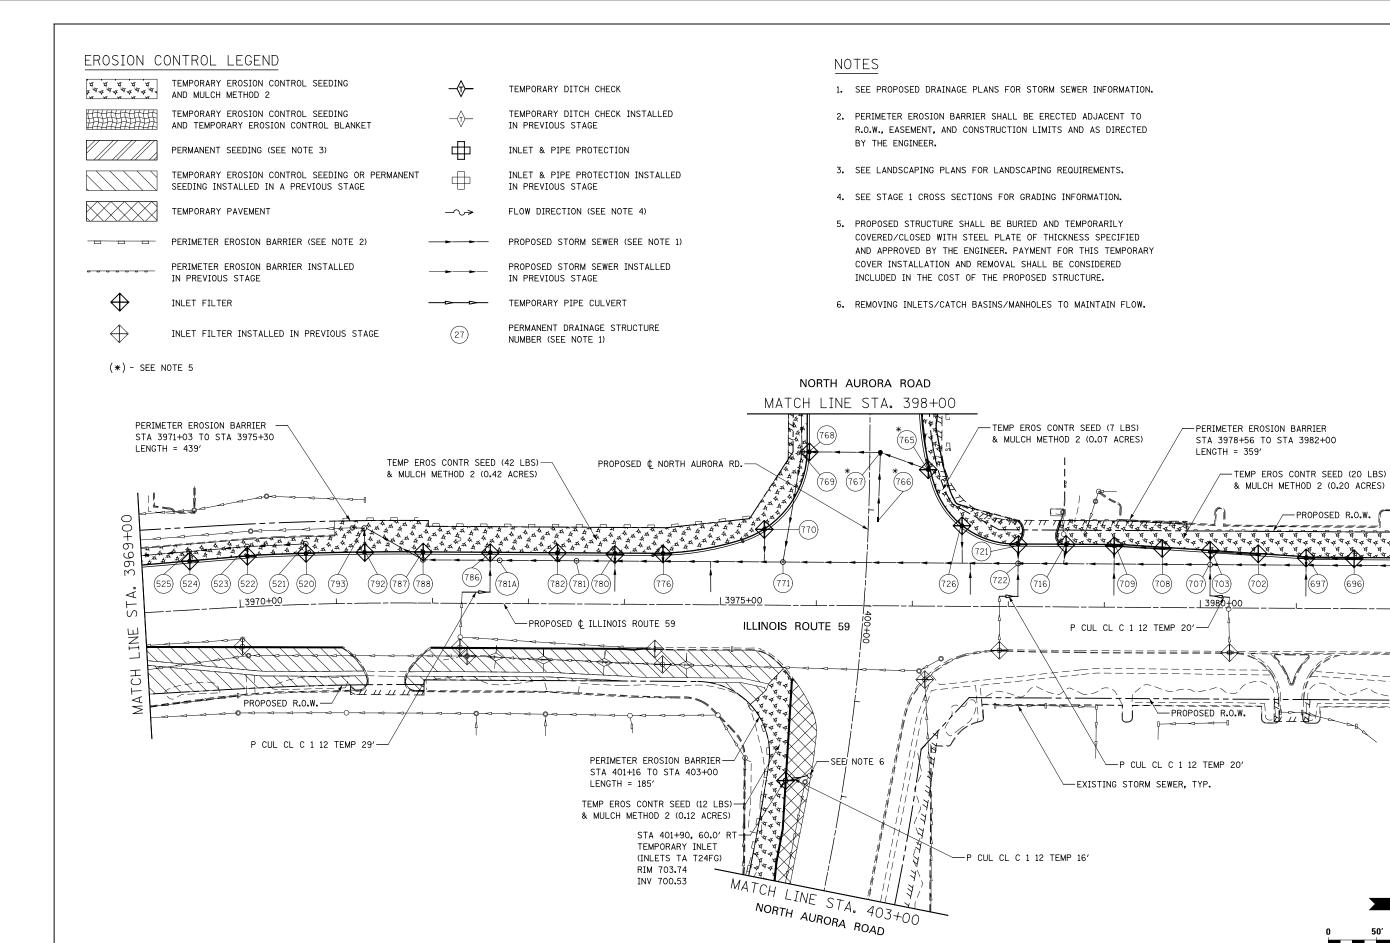

DESIGNED PJO REVISED F.A.P. RTE. SECTION COUNTY EROSION CONTROL - STAGE 1, 1A, 1B, 1C AND 1D STATE OF ILLINOIS DRAWN KES REVISED 338 (112 & 113) WRS-7 DUPAGE 1156 710 **ILLINOIS ROUTE 59** CHECKED JCM REVISED **DEPARTMENT OF TRANSPORTATION** CONTRACT NO. 60R30 SCALE: AS SHOWN SHEET NO. 20 OF 70 SHEETS STA. 3969+00 TO STA. 3982+08 DATE 12/14/201 REVISED


PROPOSED R.O.W.

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SCALE IN FEET



DRAWN KES

CHECKED JCM

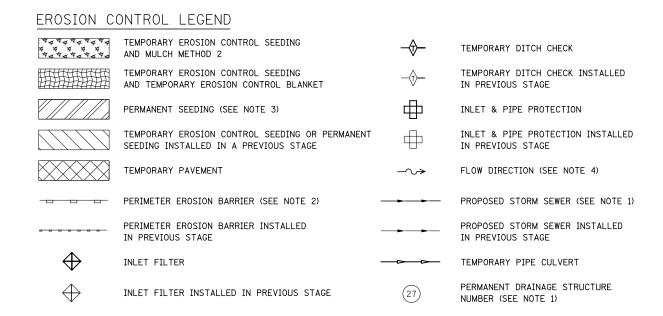DATE

12/14/201

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(\*) - SEE NOTE 5

# NOTES

- 1. SEE PROPOSED DRAINAGE PLANS FOR STORM SEWER INFORMATION.
- 2. PERIMETER EROSION BARRIER SHALL BE ERECTED ADJACENT TO R.O.W., EASEMENT, AND CONSTRUCTION LIMITS AND AS DIRECTED BY THE ENGINEER.
- 3. SEE LANDSCAPING PLANS FOR LANDSCAPING REQUIREMENTS.
- 4. SEE STAGE 1 CROSS SECTIONS FOR GRADING INFORMATION.
- 5. PROPOSED STRUCTURE SHALL BE BURIED AND TEMPORARILY COVERED/CLOSED WITH STEEL PLATE OF THICKNESS SPECIFIED AND APPROVED BY THE ENGINEER. PAYMENT FOR THIS TEMPORARY COVER INSTALLATION AND REMOVAL SHALL BE CONSIDERED INCLUDED IN THE COST OF THE PROPOSED STRUCTURE.

DUPAGE 1156 711


CONTRACT NO. 60R30

338


NEW YORK STREET

SCALE: AS SHOWN SHEET NO. 21 OF 70 SHEETS STA. 86+00 TO STA. 97+00

(112 & 113) WRS-7

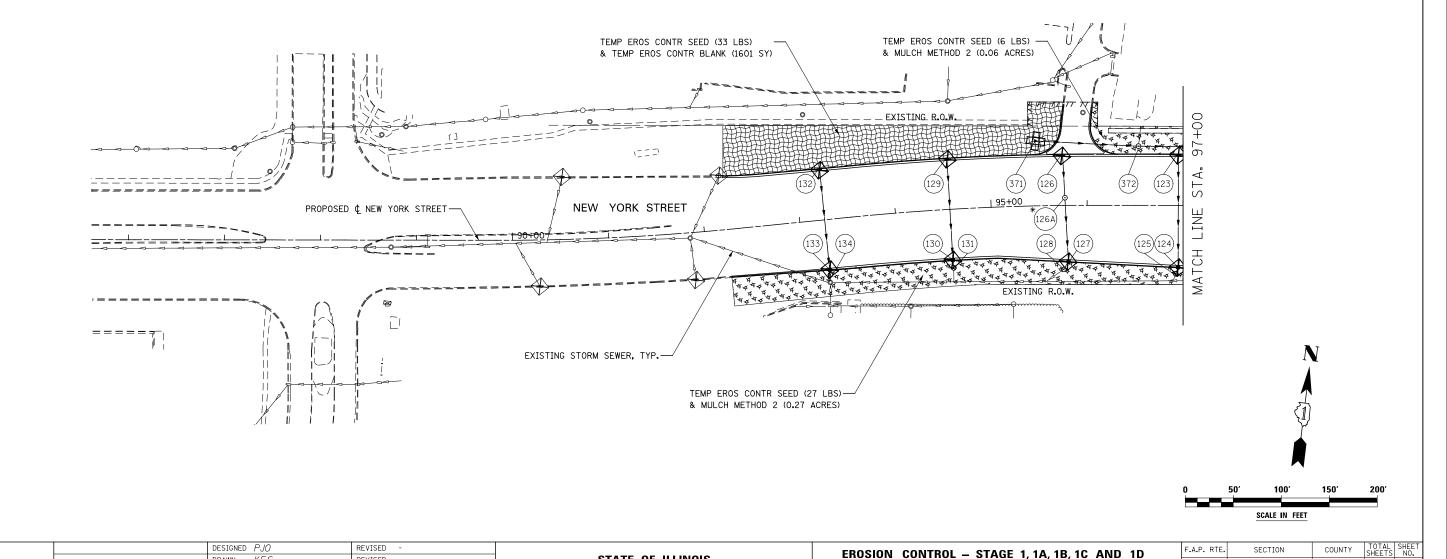

STATE OF ILLINOIS

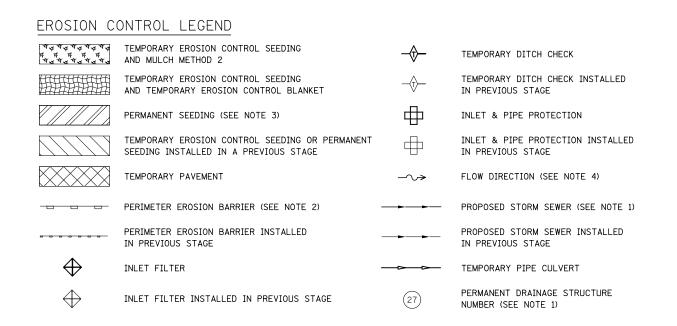

12/14/201

DATE

REVISED

REVISED

# NOTES


- 1. SEE PROPOSED DRAINAGE PLANS FOR STORM SEWER INFORMATION.
- PERIMETER EROSION BARRIER SHALL BE ERECTED ADJACENT TO R.O.W., EASEMENT, AND CONSTRUCTION LIMITS AND AS DIRECTED BY THE ENGINEER.


**AURORA AVENUE** 

SCALE: AS SHOWN SHEET NO. 22 OF 70 SHEETS STA. 104+00 TO STA. 116+00

CONTRACT NO. 60R30

- 3. SEE LANDSCAPING PLANS FOR LANDSCAPING REQUIREMENTS.
- 4. SEE STAGE 1 CROSS SECTIONS FOR GRADING INFORMATION.

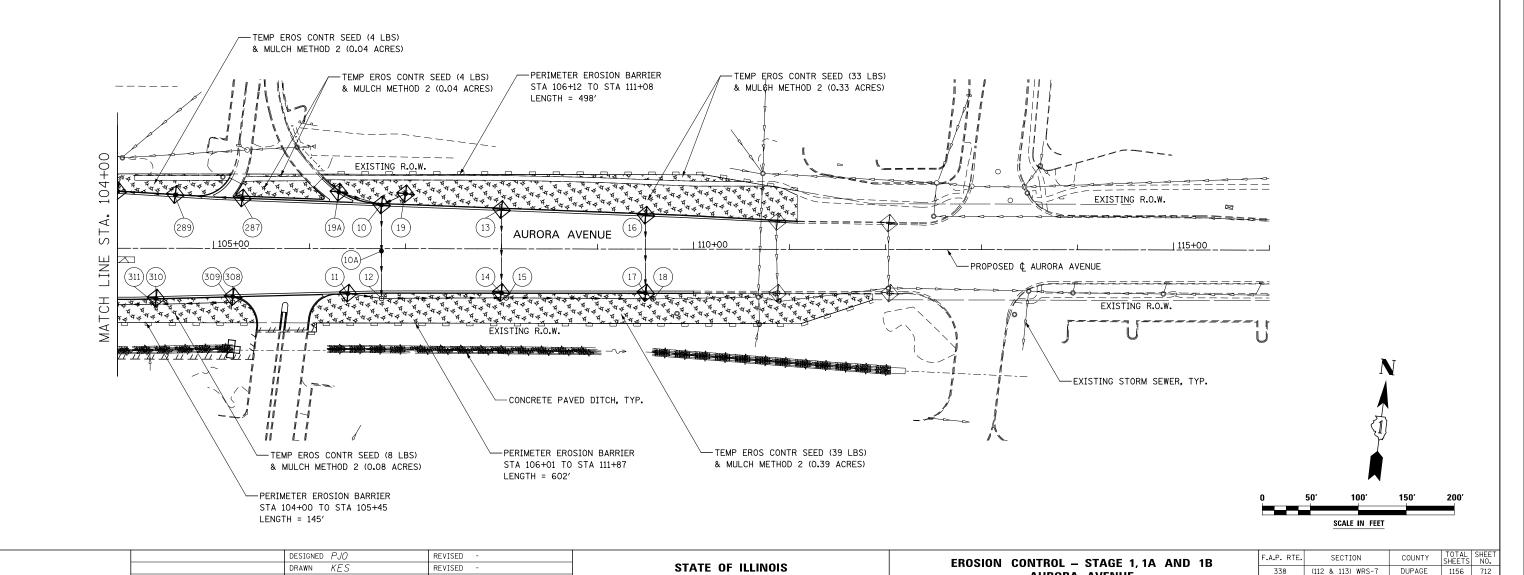

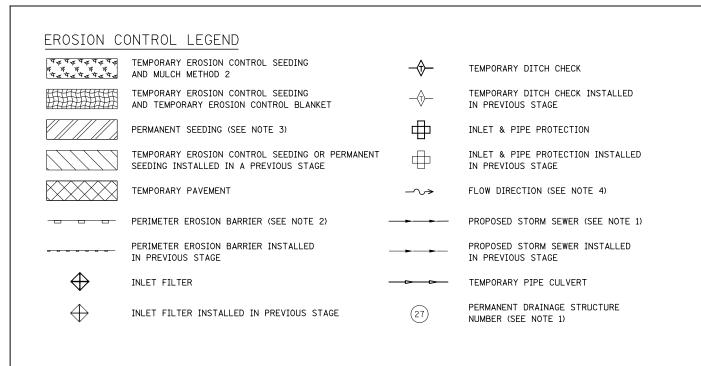

DRAWN KES

CHECKED JCM

12/14/201

DATE

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# NOTES

- 1. SEE PROPOSED DRAINAGE PLANS FOR STORM SEWER INFORMATION.
- 2. PERIMETER EROSION BARRIER SHALL BE ERECTED ADJACENT TO R.O.W., EASEMENT, AND CONSTRUCTION LIMITS AND AS DIRECTED BY THE ENGINEER.
- 3. SEE LANDSCAPING PLANS FOR LANDSCAPING REQUIREMENTS.

338

LIBERTY STREET


SCALE: AS SHOWN SHEET NO. 23 OF 70 SHEETS STA. 185+00 TO STA. 198+00


(112 & 113) WRS-7

DUPAGE 1156 713

CONTRACT NO. 60R30

4. SEE STAGE 1 CROSS SECTIONS FOR GRADING INFORMATION.

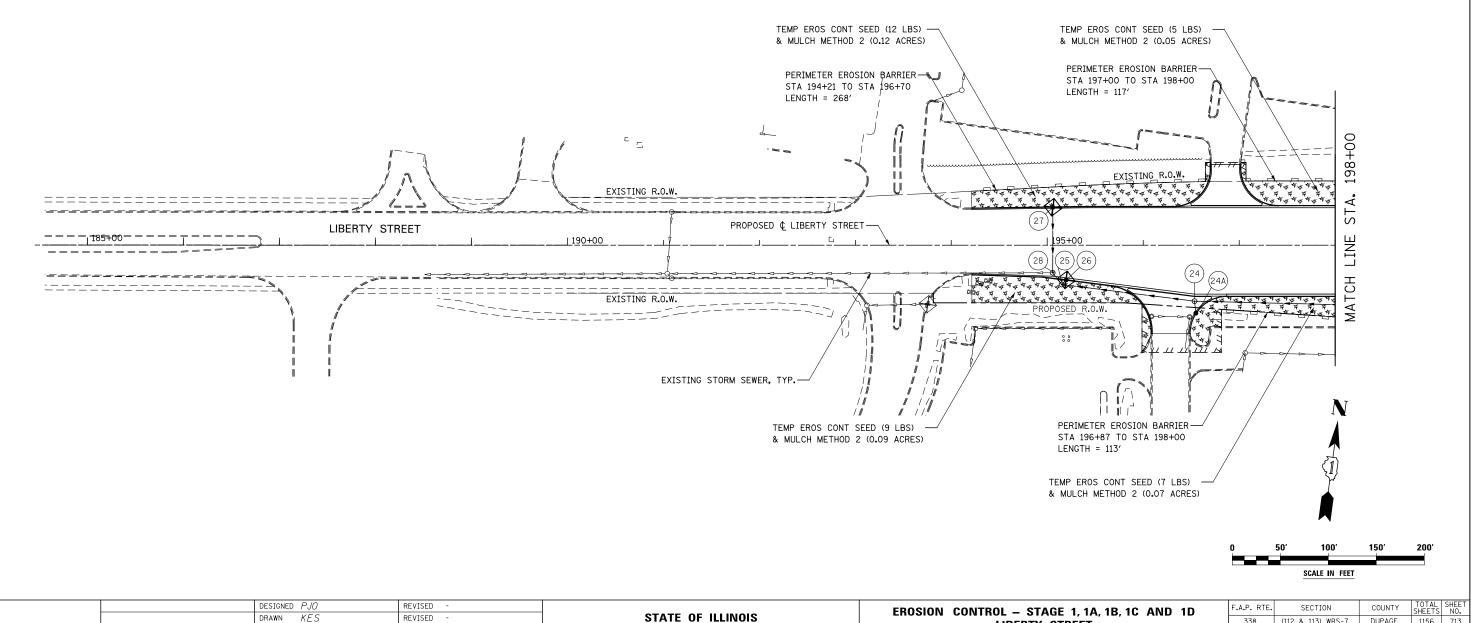

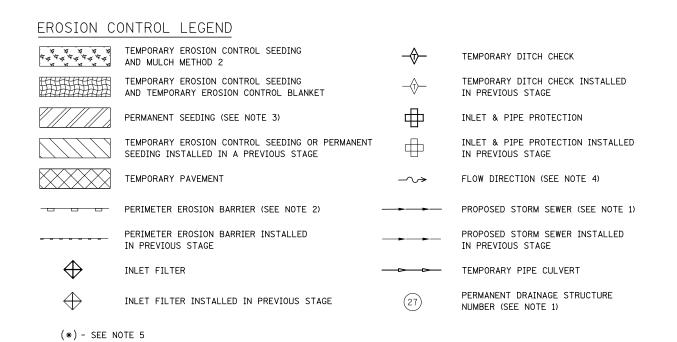

DRAWN KES

CHECKED JCM

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# NOTES

- 1. SEE PROPOSED DRAINAGE PLANS FOR STORM SEWER INFORMATION.
- 2. PERIMETER EROSION BARRIER SHALL BE ERECTED ADJACENT TO R.O.W., EASEMENT, AND CONSTRUCTION LIMITS AND AS DIRECTED BY THE ENGINEER.
- 3. SEE LANDSCAPING PLANS FOR LANDSCAPING REQUIREMENTS.
- 4. SEE STAGE 1 CROSS SECTIONS FOR GRADING INFORMATION.
- 5. PROPOSED STRUCTURE SHALL BE BURIED AND TEMPORARILY COVERED/CLOSED WITH STEEL PLATE OF THICKNESS SPECIFIED AND APPROVED BY THE ENGINEER. PAYMENT FOR THIS TEMPORARY COVER INSTALLATION AND REMOVAL SHALL BE CONSIDERED INCLUDED IN THE COST OF THE PROPOSED STRUCTURE.

338


**JEFFERSON AVENUE** 

SCALE: AS SHOWN SHEET NO. 24 OF 70 SHEETS STA. 202+00 TO STA. 216+00

(112 & 113) WRS-7

DUPAGE 1156 714

CONTRACT NO. 60R30

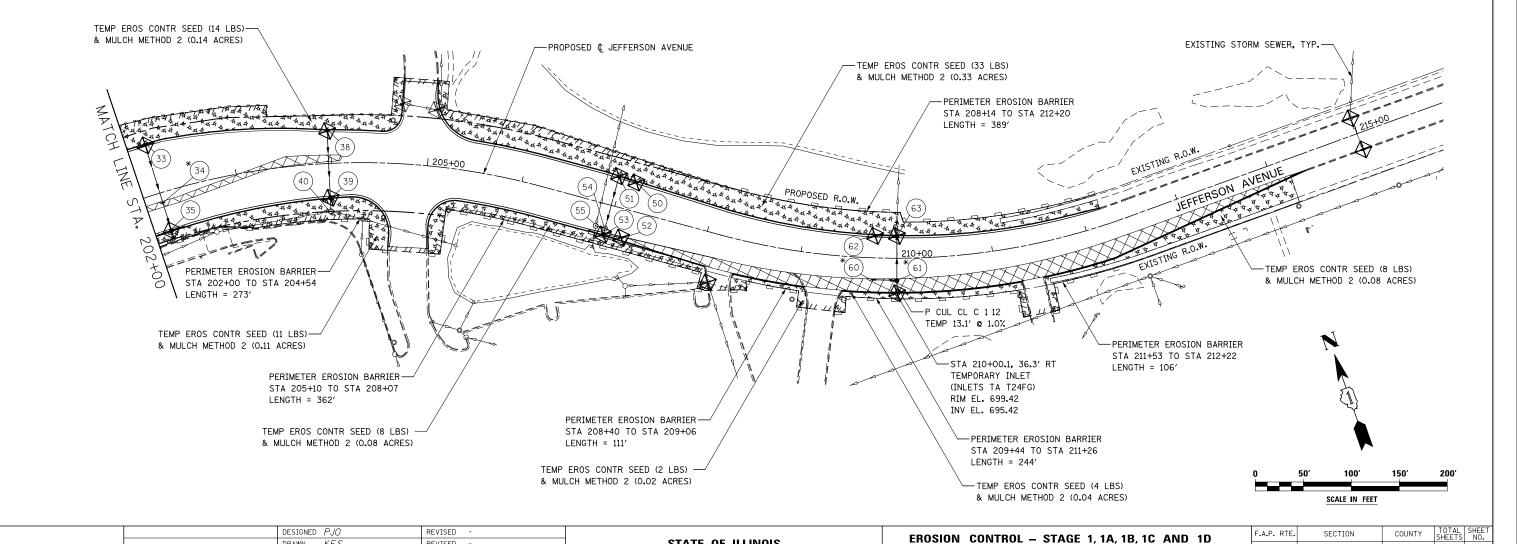

STATE OF ILLINOIS

#### EROSION CONTROL LEGEND TEMPORARY EROSION CONTROL SEEDING TEMPORARY DITCH CHECK TEMPORARY EROSION CONTROL SEEDING TEMPORARY DITCH CHECK INSTALLED AND TEMPORARY EROSION CONTROL BLANKET IN PREVIOUS STAGE PERMANENT SEEDING (SEE NOTE 3) INLET & PIPE PROTECTION TEMPORARY EROSION CONTROL SEEDING OR PERMANENT INLET & PIPE PROTECTION INSTALLED SEEDING INSTALLED IN A PREVIOUS STAGE IN PREVIOUS STAGE TEMPORARY PAVEMENT FLOW DIRECTION (SEE NOTE 4) PERIMETER EROSION BARRIER (SEE NOTE 2) PROPOSED STORM SEWER (SEE NOTE 1) PERIMETER EROSION BARRIER INSTALLED PROPOSED STORM SEWER INSTALLED IN PREVIOUS STAGE IN PREVIOUS STAGE INLET FILTER TEMPORARY PIPE CULVERT PERMANENT DRAINAGE STRUCTURE INLET FILTER INSTALLED IN PREVIOUS STAGE NUMBER (SEE NOTE 1)

DRAWN KES

CHECKED JCM

12/14/201

DATE

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(\*) - SEE NOTE 5

# NOTES

- 1. SEE PROPOSED DRAINAGE PLANS FOR STORM SEWER INFORMATION.
- 2. PERIMETER EROSION BARRIER SHALL BE ERECTED ADJACENT TO R.O.W., EASEMENT, AND CONSTRUCTION LIMITS AND AS DIRECTED BY THE ENGINEER.
- 3. SEE LANDSCAPING PLANS FOR LANDSCAPING REQUIREMENTS.
- 4. SEE STAGE 1 CROSS SECTIONS FOR GRADING INFORMATION.
- 5. PROPOSED STRUCTURE SHALL BE BURIED AND TEMPORARILY COVERED/CLOSED WITH STEEL PLATE OF THICKNESS SPECIFIED AND APPROVED BY THE ENGINEER, PAYMENT FOR THIS TEMPORARY COVER INSTALLATION AND REMOVAL SHALL BE CONSIDERED INCLUDED IN THE COST OF THE PROPOSED STRUCTURE.

-STA 297+20, 46.5′ LT

338


**MERIDIAN PARKWAY** 

SCALE: AS SHOWN SHEET NO. 25 OF 70 SHEETS STA. 288+00 TO STA. 298+00

(112 & 113) WRS-7


DUPAGE 1156 715

CONTRACT NO. 60R30

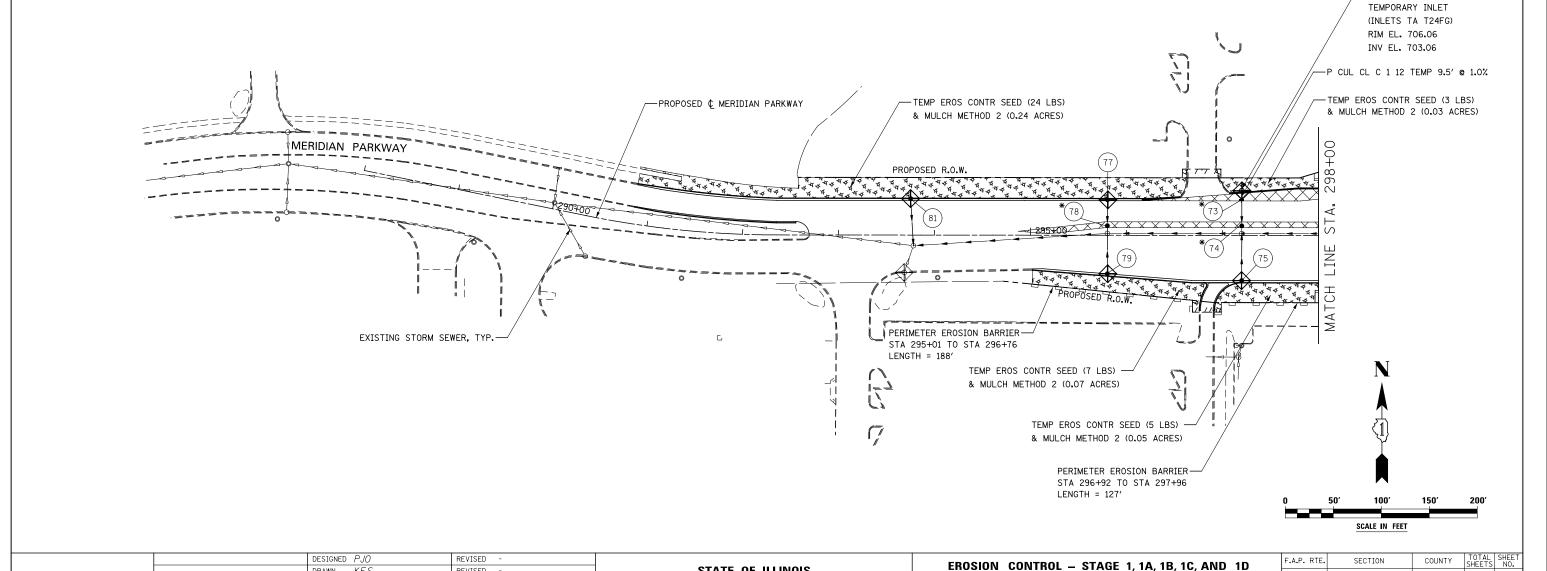


STATE OF ILLINOIS


(\*) - SEE NOTE 5

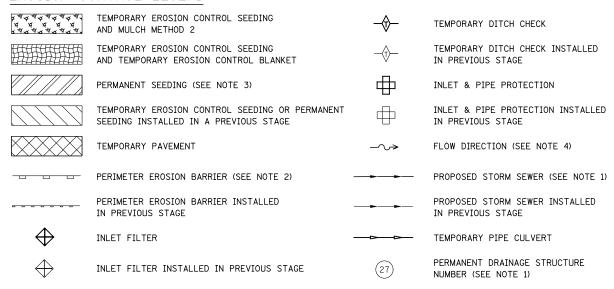


# NOTES


- 1. SEE PROPOSED DRAINAGE PLANS FOR STORM SEWER INFORMATION.
- PERIMETER EROSION BARRIER SHALL BE ERECTED ADJACENT TO R.O.W., EASEMENT, AND CONSTRUCTION LIMITS AND AS DIRECTED BY THE ENGINEER.
- 3. SEE LANDSCAPING PLANS FOR LANDSCAPING REQUIREMENTS.
- 4. SEE STAGE 1 CROSS SECTIONS FOR GRADING INFORMATION.
- 5. PROPOSED STRUCTURE SHALL BE BURIED AND TEMPORARILY COVERED/CLOSED WITH STEEL PLATE OF THICKNESS SPECIFIED AND APPROVED BY THE ENGINEER. PAYMENT FOR THIS TEMPORARY COVER INSTALLATION AND REMOVAL SHALL BE CONSIDERED INCLUDED IN THE COST OF THE PROPOSED STRUCTURE.

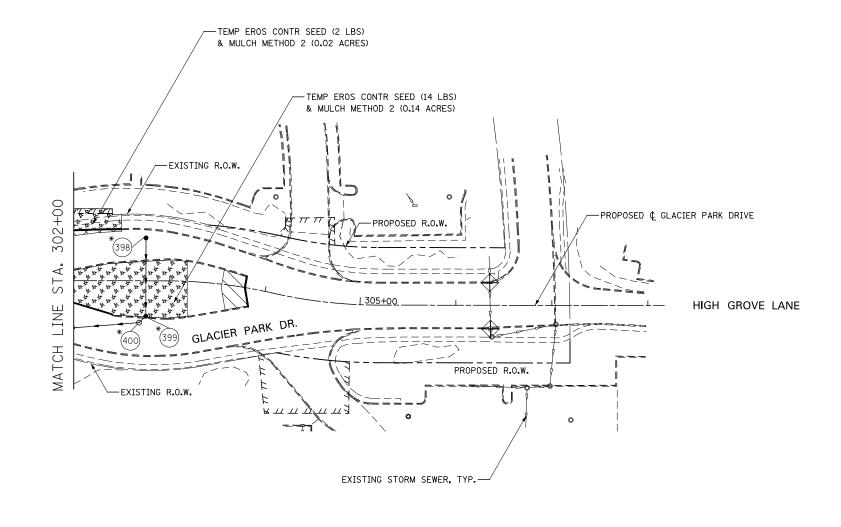

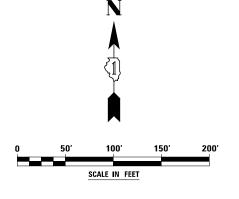

DESIGNED PJO	REVISED -		EROSION CONTROL – STAGE 1, 1A AND 1B	F.A.P. RTE.	SECTION	COUNTY	TOTAL S	SHEET NO.
DRAWN KES	REVISED -	STATE OF ILLINOIS	GLACIER PARK DRIVE	338	(112 & 113) WRS-7	DUPAGE	1156	716
CHECKED JCM	REVISED -	DEPARTMENT OF TRANSPORTATION				CONTRACT	NO. 60F	₹30
DATE 12/14/2012	REVISED -		SCALE: AS SHOWN   SHEET NO. 26 OF 70 SHEETS   STA. 302+00 TO STA. 308+00		ILLINOIS FED. AI	D PROJECT		

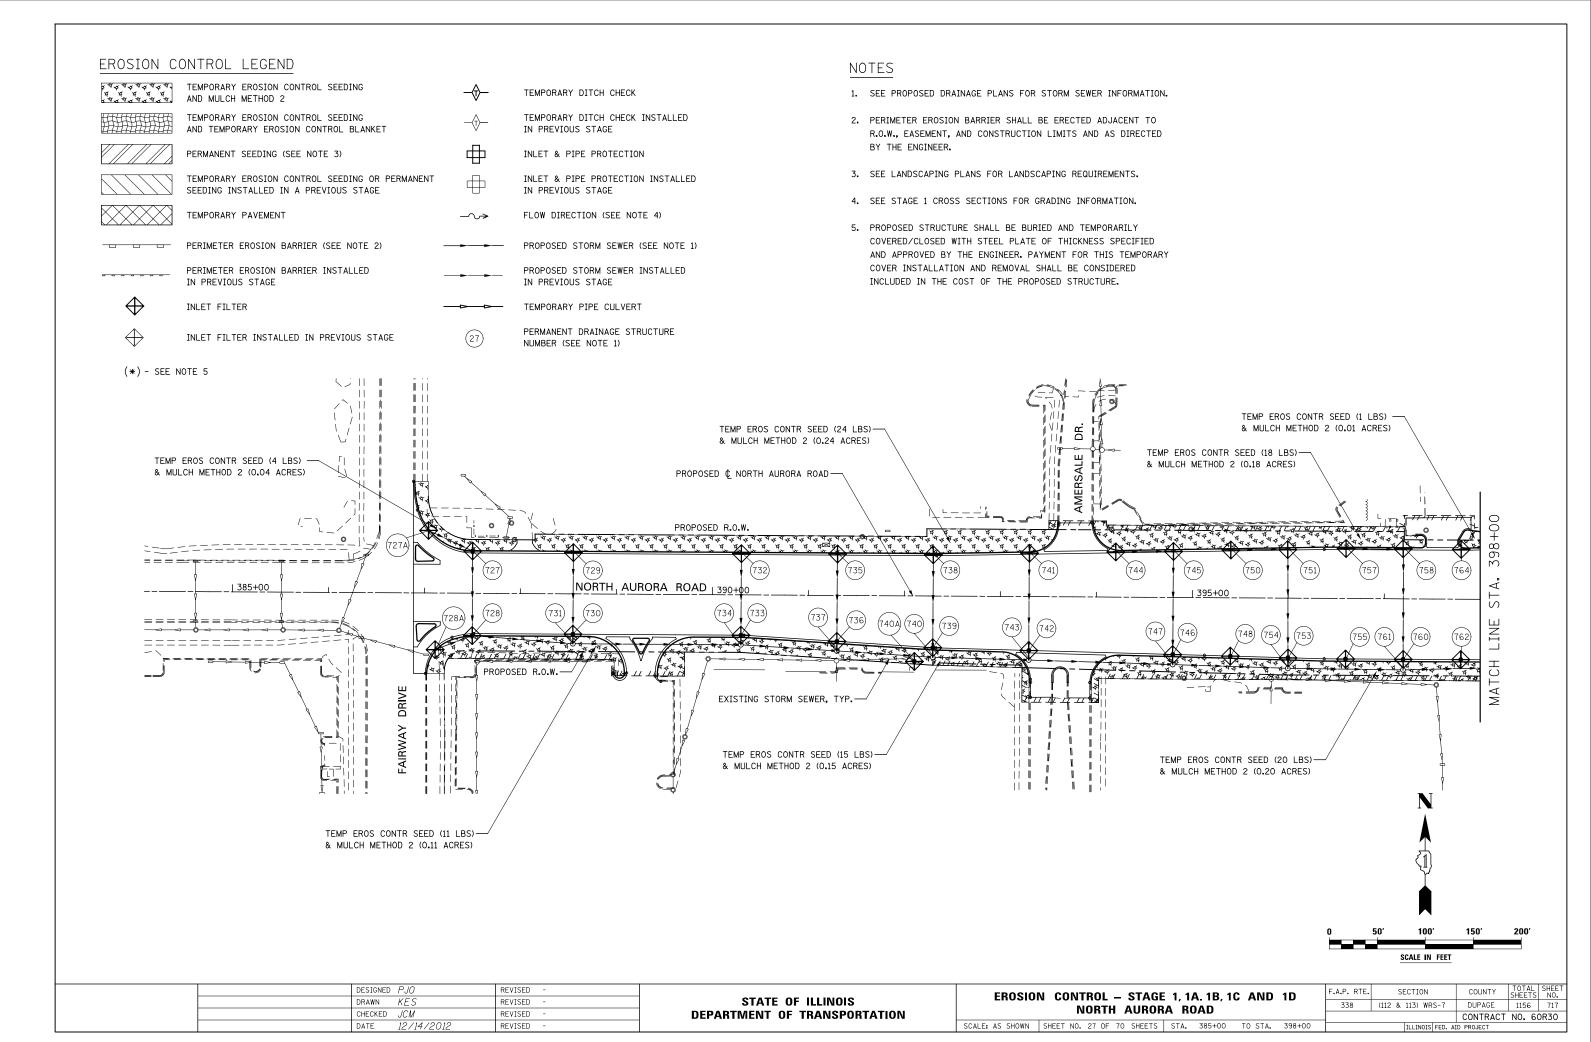

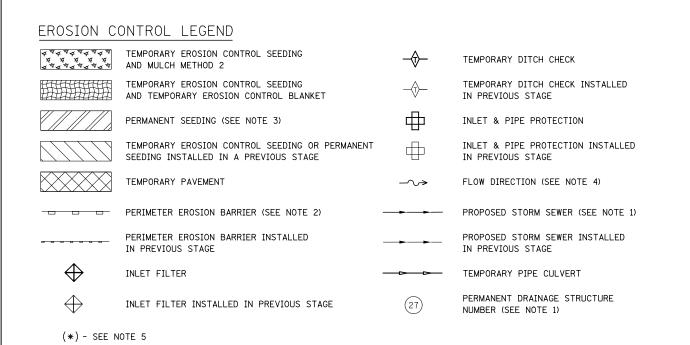

12/14/201

DATE

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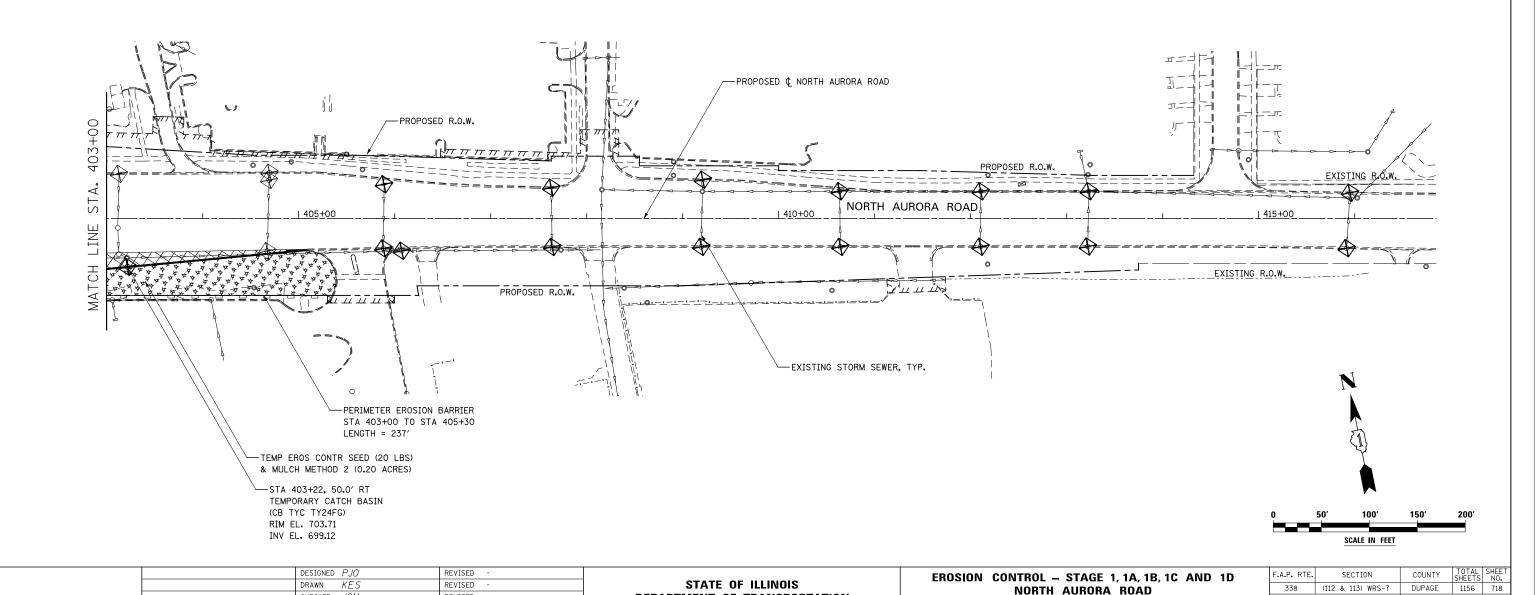
# NOTES


- 1. SEE PROPOSED DRAINAGE PLANS FOR STORM SEWER INFORMATION.
- PERIMETER EROSION BARRIER SHALL BE ERECTED ADJACENT TO R.O.W., EASEMENT, AND CONSTRUCTION LIMITS AND AS DIRECTED BY THE ENGINEER.
- 3. SEE LANDSCAPING PLANS FOR LANDSCAPING REQUIREMENTS.


SCALE: AS SHOWN SHEET NO. 28 OF 70 SHEETS STA. 403+00 TO STA. 416+00

CONTRACT NO. 60R30

4. SEE STAGE 1 CROSS SECTIONS FOR GRADING INFORMATION.



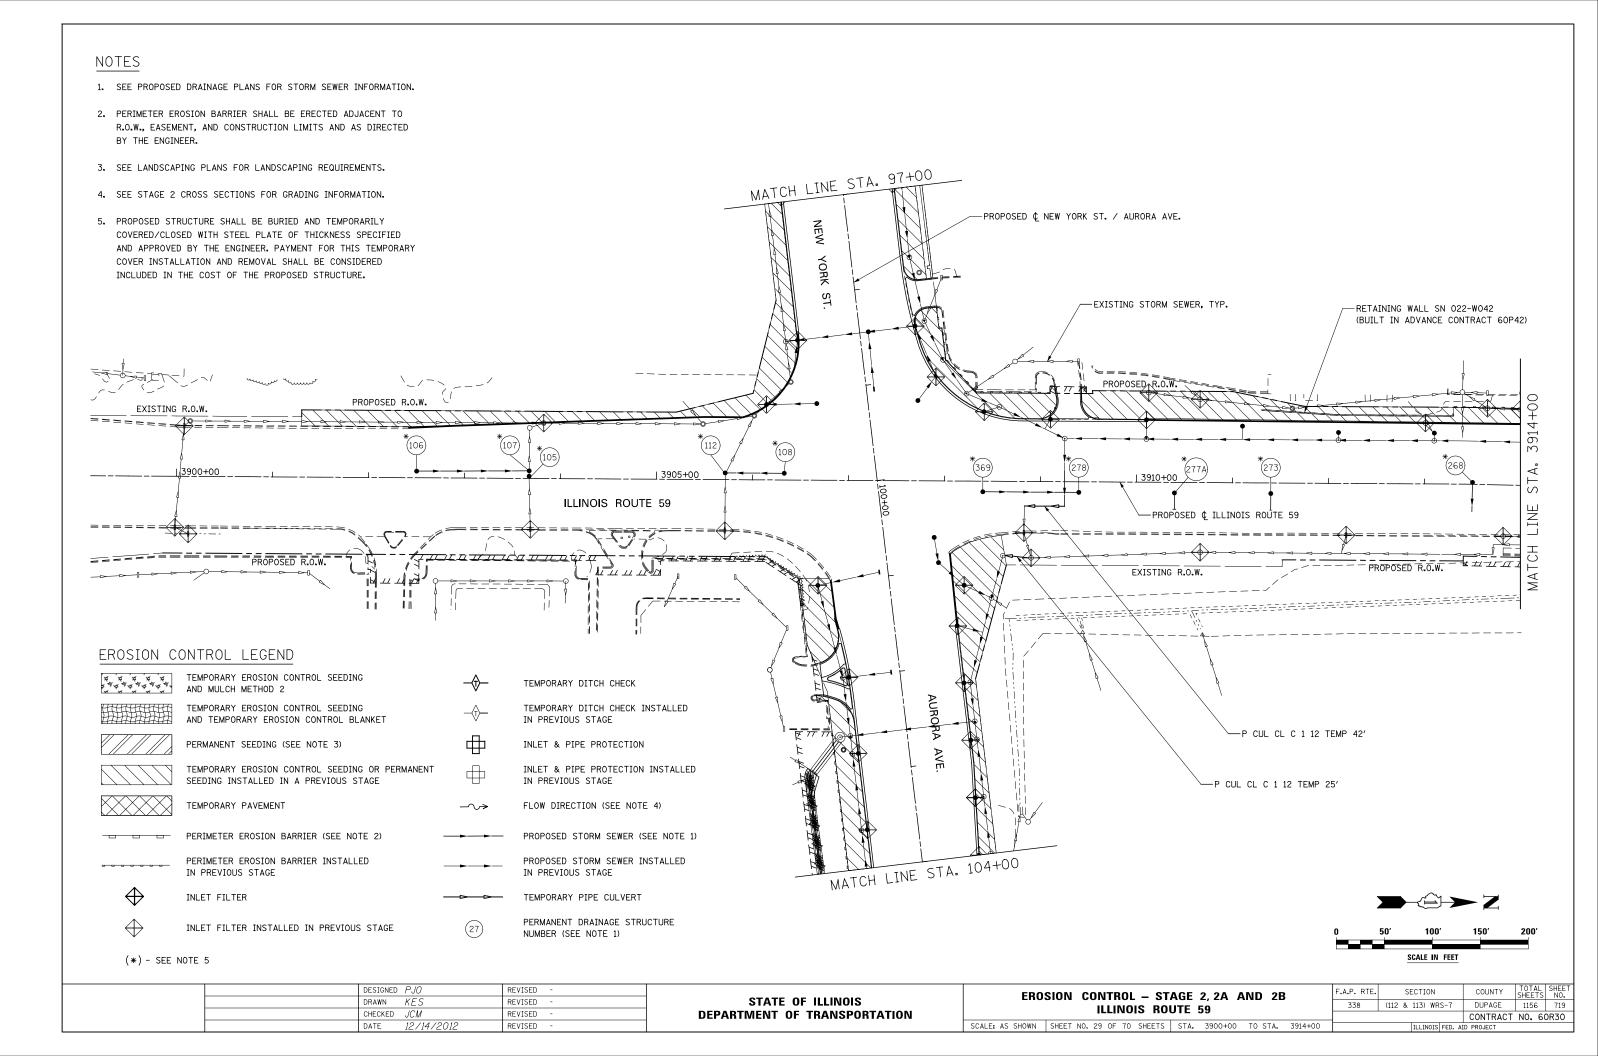

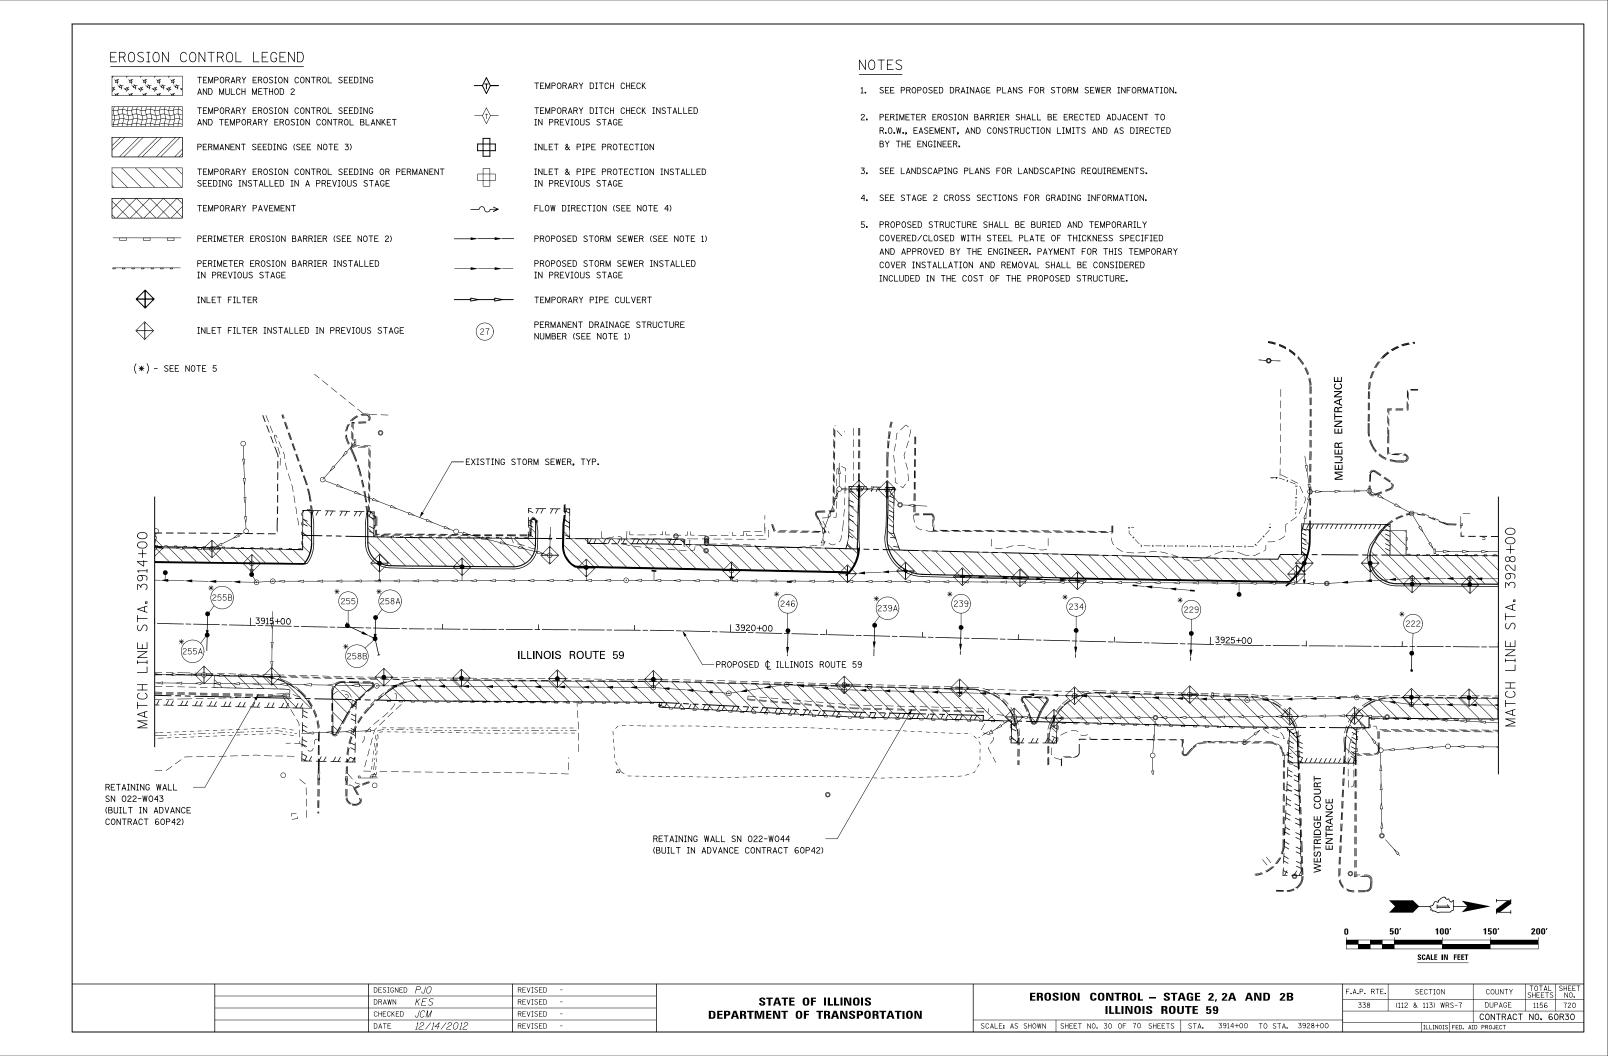


#### EROSION CONTROL LEGEND TEMPORARY EROSION CONTROL SEEDING TEMPORARY DITCH CHECK AND MULCH METHOD 2 TEMPORARY EROSION CONTROL SEEDING TEMPORARY DITCH CHECK INSTALLED AND TEMPORARY EROSION CONTROL BLANKET IN PREVIOUS STAGE PERMANENT SEEDING (SEE NOTE 3) INLET & PIPE PROTECTION TEMPORARY EROSION CONTROL SEEDING OR PERMANENT $\oplus$ INLET & PIPE PROTECTION INSTALLED SEEDING INSTALLED IN A PREVIOUS STAGE IN PREVIOUS STAGE TEMPORARY PAVEMENT FLOW DIRECTION (SEE NOTE 4) **-**^ → PERIMETER EROSION BARRIER (SEE NOTE 2) PROPOSED STORM SEWER (SEE NOTE 1) PERIMETER EROSION BARRIER INSTALLED PROPOSED STORM SEWER INSTALLED IN PREVIOUS STAGE IN PREVIOUS STAGE INLET FILTER TEMPORARY PIPE CULVERT PERMANENT DRAINAGE STRUCTURE INLET FILTER INSTALLED IN PREVIOUS STAGE NUMBER (SEE NOTE 1)

### (\*) - SEE NOTE 5


# NOTES

- 1. SEE PROPOSED DRAINAGE PLANS FOR STORM SEWER INFORMATION.
- PERIMETER EROSION BARRIER SHALL BE ERECTED ADJACENT TO R.O.W., EASEMENT, AND CONSTRUCTION LIMITS AND AS DIRECTED BY THE ENGINEER.
- 3. SEE LANDSCAPING PLANS FOR LANDSCAPING REQUIREMENTS.
- 4. SEE STAGE 2 CROSS SECTIONS FOR GRADING INFORMATION.
- 5. PROPOSED STRUCTURE SHALL BE BURIED AND TEMPORARILY COVERED/CLOSED WITH STEEL PLATE OF THICKNESS SPECIFIED AND APPROVED BY THE ENGINEER, PAYMENT FOR THIS TEMPORARY COVER INSTALLATION AND REMOVAL SHALL BE CONSIDERED INCLUDED IN THE COST OF THE PROPOSED STRUCTURE.

SCALE IN FEET

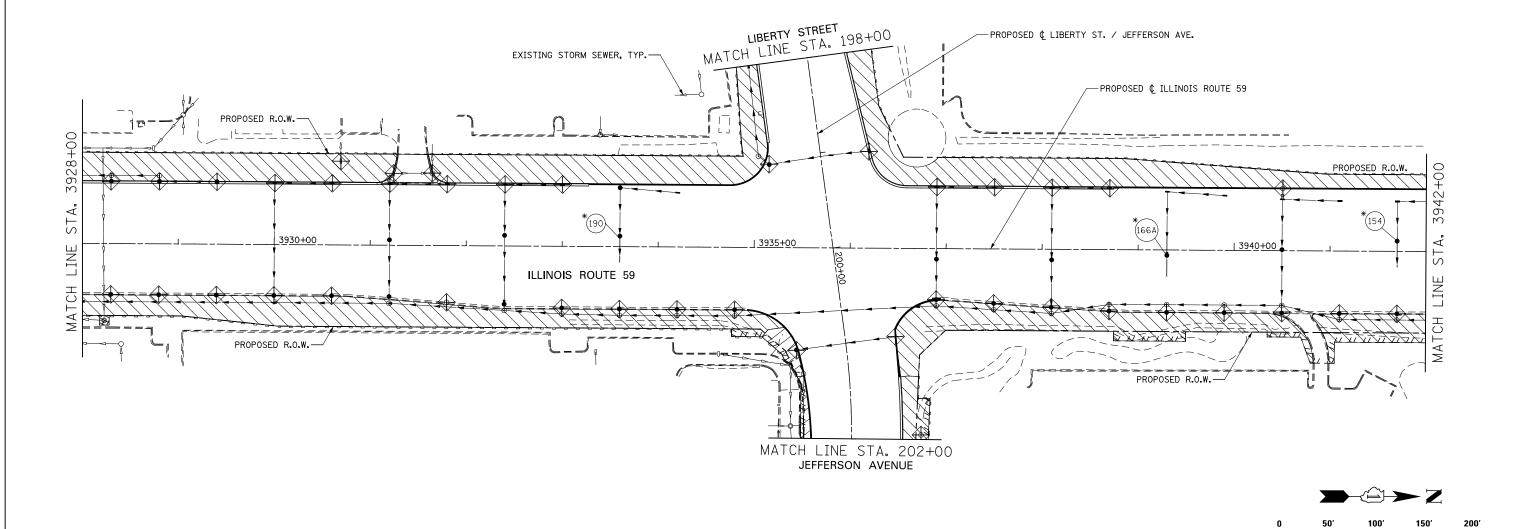

DESIGNED PJO REVISED -	27477 27 111111212	EROSION CONTROL – STAGE 2.2A AND 2B	F.A.P. RTE.	SECTION	COUNTY	TOTAL SHEET SHEETS NO.
DRAWN KES REVISED -	STATE OF ILLINOIS	ILLINOIS ROUTE 59	338	(112 & 113) WRS-7	DUPAGE	1156 721
CHECKED   JCM   REVISED   -	DEPARTMENT OF TRANSPORTATION	SCALE: AS SHOWN SHEET NO. 31 OF 70 SHEETS STA. 3928+00 TO STA. 3942+00	<del> </del>	TILL TNOTS FED. AT	CONTRACT	T NO. 60R30

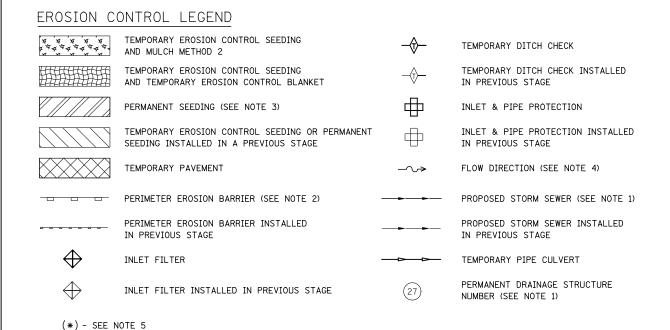


# NOTES


- 1. SEE PROPOSED DRAINAGE PLANS FOR STORM SEWER INFORMATION.
- PERIMETER EROSION BARRIER SHALL BE ERECTED ADJACENT TO R.O.W., EASEMENT, AND CONSTRUCTION LIMITS AND AS DIRECTED BY THE ENGINEER.
- 3. SEE LANDSCAPING PLANS FOR LANDSCAPING REQUIREMENTS.
- 4. SEE STAGE 2 CROSS SECTIONS FOR GRADING INFORMATION.
- 5. PROPOSED STRUCTURE SHALL BE BURIED AND TEMPORARILY COVERED/CLOSED WITH STEEL PLATE OF THICKNESS SPECIFIED AND APPROVED BY THE ENGINEER. PAYMENT FOR THIS TEMPORARY COVER INSTALLATION AND REMOVAL SHALL BE CONSIDERED INCLUDED IN THE COST OF THE PROPOSED STRUCTURE.


SCALE IN FEET

STORM SEWERES TO BE FULLY CONSTRUCTED ACROSS ENTIRE ROADWAY, USING A SINGLE LANE NIGHT TIME CLOSURE.

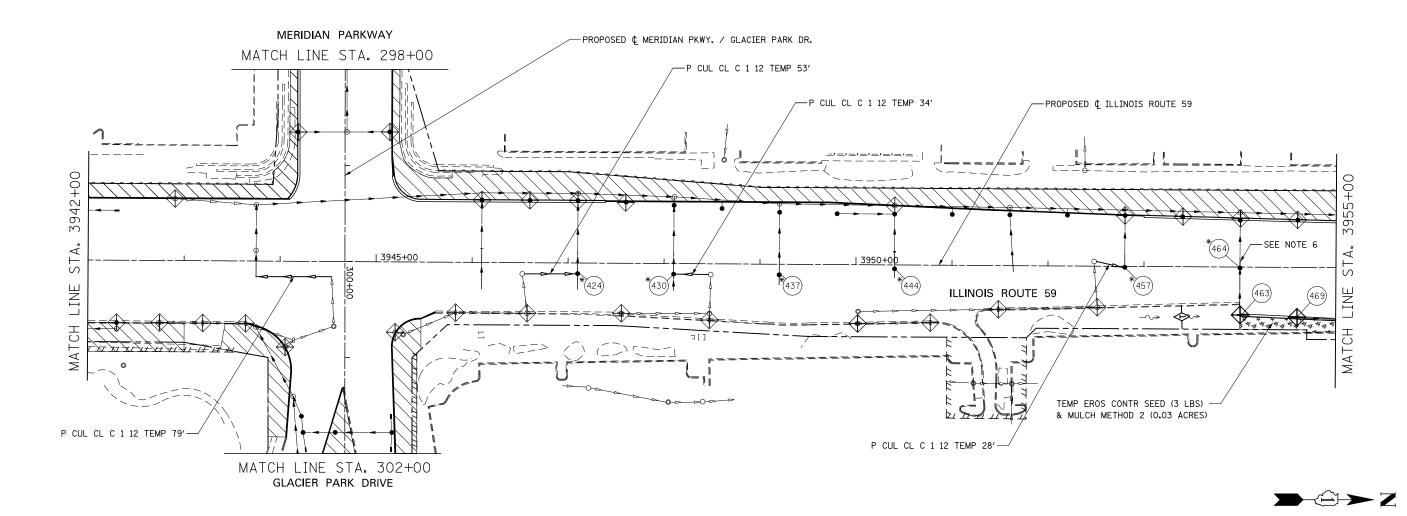

DESIGNED PJO REVISED -		EROSION CONTROL – STAGE 2, 2A AND 2B	F.A.P. RTE.	SECTION	COUNTY	TOTAL SH	HEET NO.
DRAWN KES REVISED -	STATE OF ILLINOIS	ILLINOIS ROUTE 59	338	(112 & 113) WRS-7	DUPAGE	1156	722
CHECKED JCM REVISED -	DEPARTMENT OF TRANSPORTATION			•	CONTRACT	T NO. 60R	30
DATE 12/14/2012 REVISED -		SCALE: AS SHOWN   SHEET NO. 32 OF 70 SHEETS   STA. 3942+00 TO STA. 3955+00		ILLINOIS FED.	AID PROJECT		

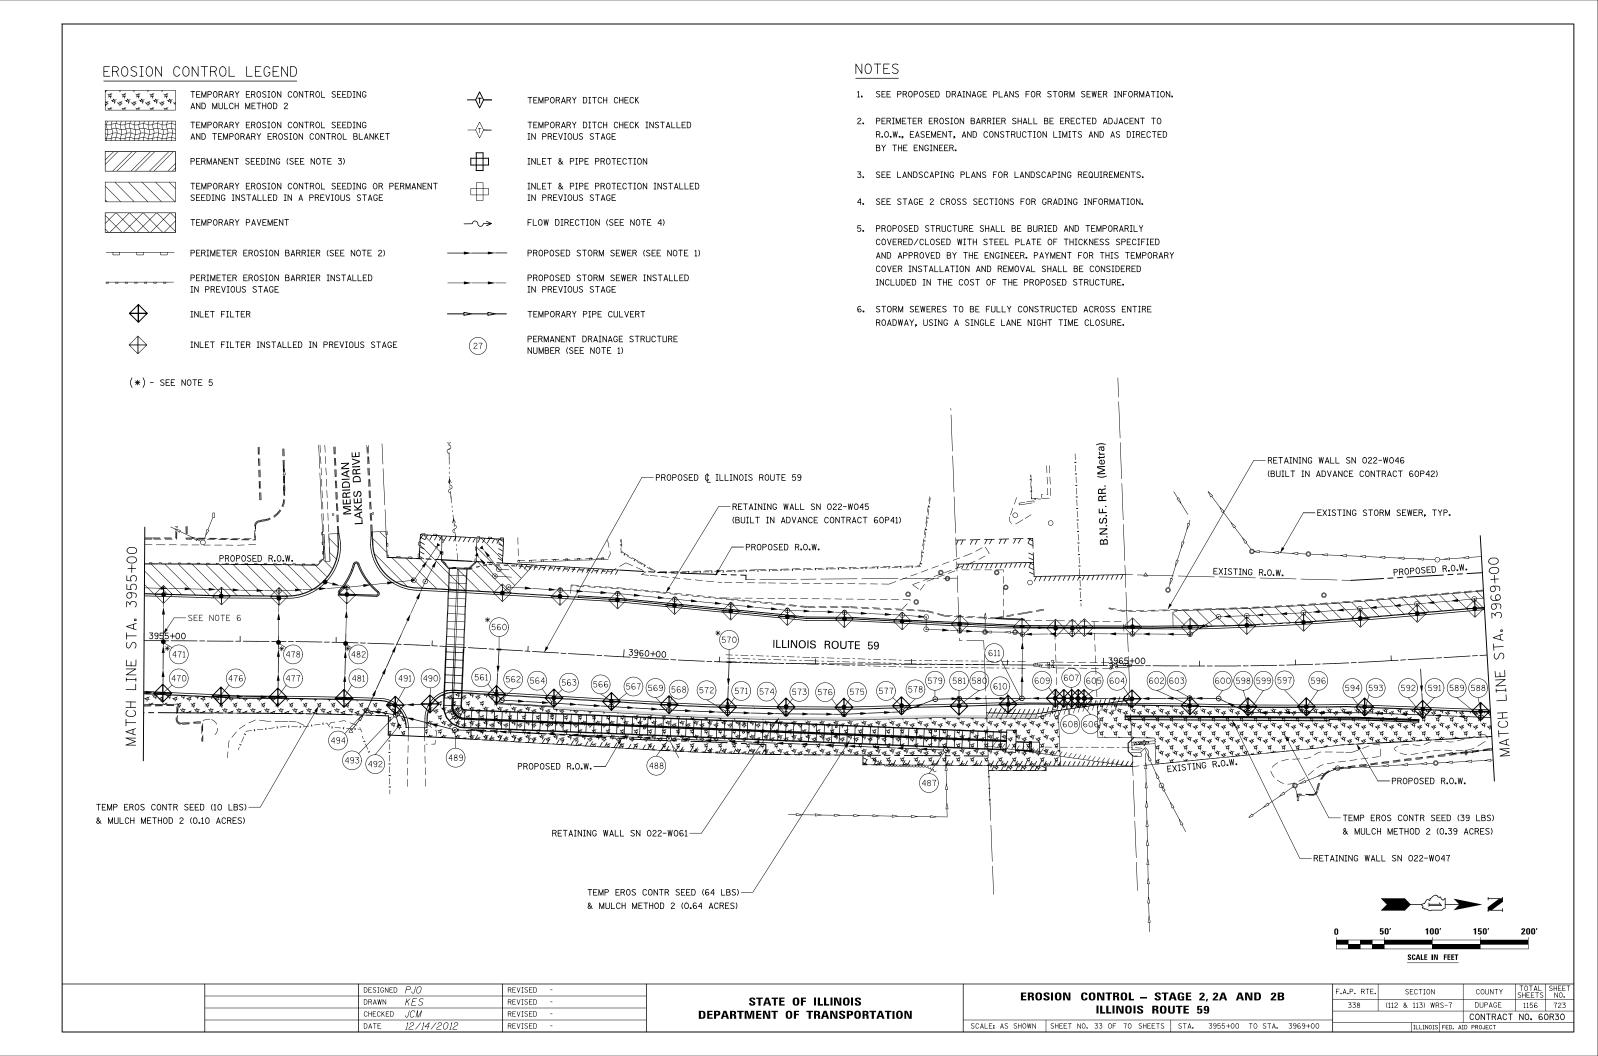

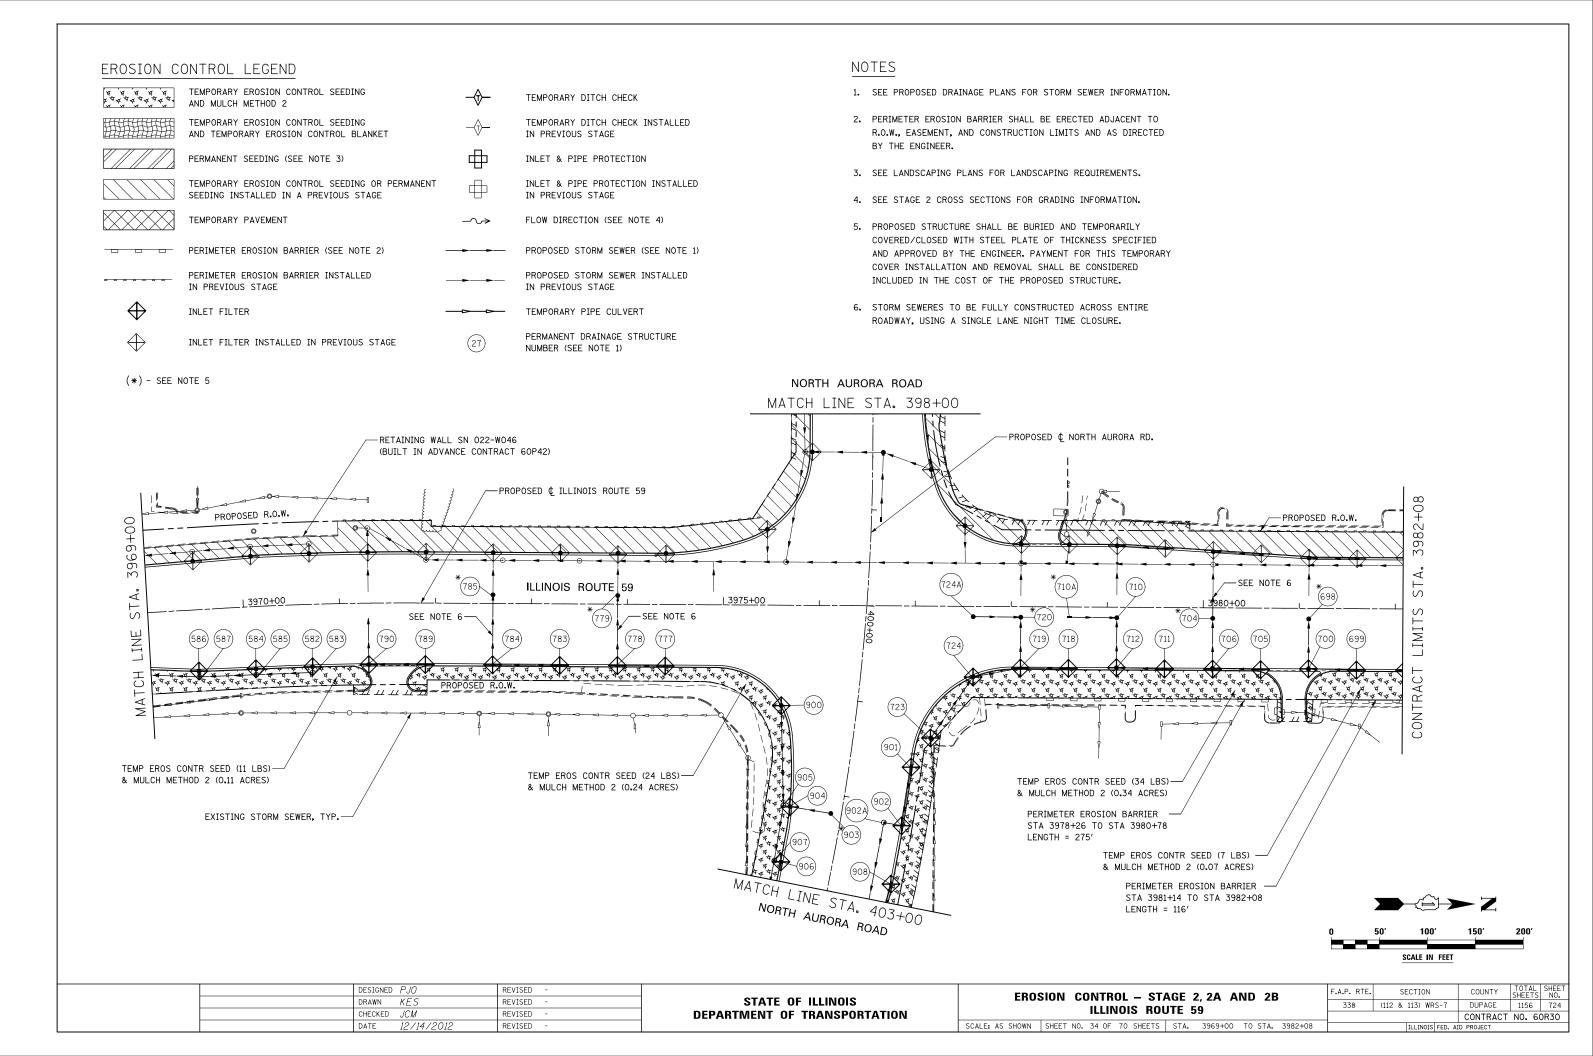

#### EROSION CONTROL LEGEND TEMPORARY EROSION CONTROL SEEDING AND MULCH METHOD 2 TEMPORARY DITCH CHECK TEMPORARY EROSION CONTROL SEEDING TEMPORARY DITCH CHECK INSTALLED AND TEMPORARY EROSION CONTROL BLANKET IN PREVIOUS STAGE PERMANENT SEEDING (SEE NOTE 3) INLET & PIPE PROTECTION TEMPORARY EROSION CONTROL SEEDING OR PERMANENT INLET & PIPE PROTECTION INSTALLED SEEDING INSTALLED IN A PREVIOUS STAGE IN PREVIOUS STAGE TEMPORARY PAVEMENT FLOW DIRECTION (SEE NOTE 4) PERIMETER EROSION BARRIER (SEE NOTE 2) PROPOSED STORM SEWER (SEE NOTE 1) PERIMETER EROSION BARRIER INSTALLED PROPOSED STORM SEWER INSTALLED IN PREVIOUS STAGE IN PREVIOUS STAGE INLET FILTER TEMPORARY PIPE CULVERT

CHECKED JCM

12/14/201

DATE

REVISED

REVISED

INLET FILTER INSTALLED IN PREVIOUS STAGE

PERMANENT DRAINAGE STRUCTURE

NUMBER (SEE NOTE 1)

# NOTES

- 1. SEE PROPOSED DRAINAGE PLANS FOR STORM SEWER INFORMATION.
- 2. PERIMETER EROSION BARRIER SHALL BE ERECTED ADJACENT TO R.O.W., EASEMENT, AND CONSTRUCTION LIMITS AND AS DIRECTED BY THE ENGINEER.
- 3. SEE LANDSCAPING PLANS FOR LANDSCAPING REQUIREMENTS.
- 4. SEE STAGE 2 CROSS SECTIONS FOR GRADING INFORMATION.

(112 & 113) WRS-7


338

NEW YORK STREET

SCALE: AS SHOWN SHEET NO. 35 OF 70 SHEETS STA. 85+00 TO STA. 97+00

DUPAGE 1156 725

CONTRACT NO. 60R30

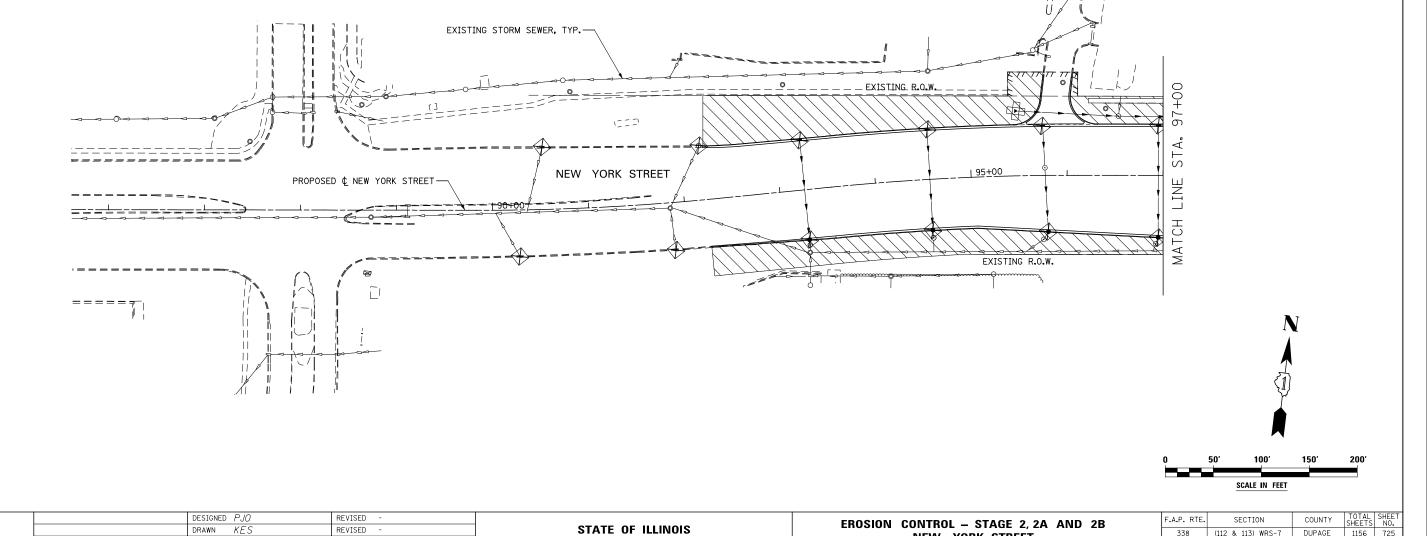

# EROSION CONTROL LEGEND TEMPORARY EROSION CONTROL SEEDING TEMPORARY EROSION CONTROL SEEDING

AND TEMPORARY EROSION CONTROL BLANKET

PERMANENT SEEDING (SEE NOTE 3)

TEMPORARY EROSION CONTROL SEEDING OR PERMANENT SEEDING INSTALLED IN A PREVIOUS STAGE

TEMPORARY PAVEMENT PERIMETER EROSION BARRIER (SEE NOTE 2)

> PERIMETER EROSION BARRIER INSTALLED IN PREVIOUS STAGE

INLET FILTER INLET FILTER INSTALLED IN PREVIOUS STAGE

DRAWN KES

CHECKED JCM

12/14/201

DATE

REVISED

REVISED

REVISED

TEMPORARY DITCH CHECK

TEMPORARY DITCH CHECK INSTALLED IN PREVIOUS STAGE

INLET & PIPE PROTECTION

INLET & PIPE PROTECTION INSTALLED IN PREVIOUS STAGE

FLOW DIRECTION (SEE NOTE 4)

**-∕>** 

PROPOSED STORM SEWER (SEE NOTE 1)

PROPOSED STORM SEWER INSTALLED IN PREVIOUS STAGE

TEMPORARY PIPE CULVERT

PERMANENT DRAINAGE STRUCTURE NUMBER (SEE NOTE 1)

# NOTES

- 1, SEE PROPOSED DRAINAGE PLANS FOR STORM SEWER INFORMATION,
- 2. PERIMETER EROSION BARRIER SHALL BE ERECTED ADJACENT TO R.O.W., EASEMENT, AND CONSTRUCTION LIMITS AND AS DIRECTED BY THE ENGINEER.
- 3. SEE LANDSCAPING PLANS FOR LANDSCAPING REQUIREMENTS.
- 4. SEE STAGE 2 CROSS SECTIONS FOR GRADING INFORMATION.

**EROSION CONTROL - STAGE 2, 2A AND 2B** 

**AURORA AVENUE** 


SCALE: AS SHOWN SHEET NO. 36 OF 70 SHEETS STA. 104+00 TO STA. 116+00

(112 & 113) WRS-7


338

DUPAGE 1156 726

CONTRACT NO. 60R30

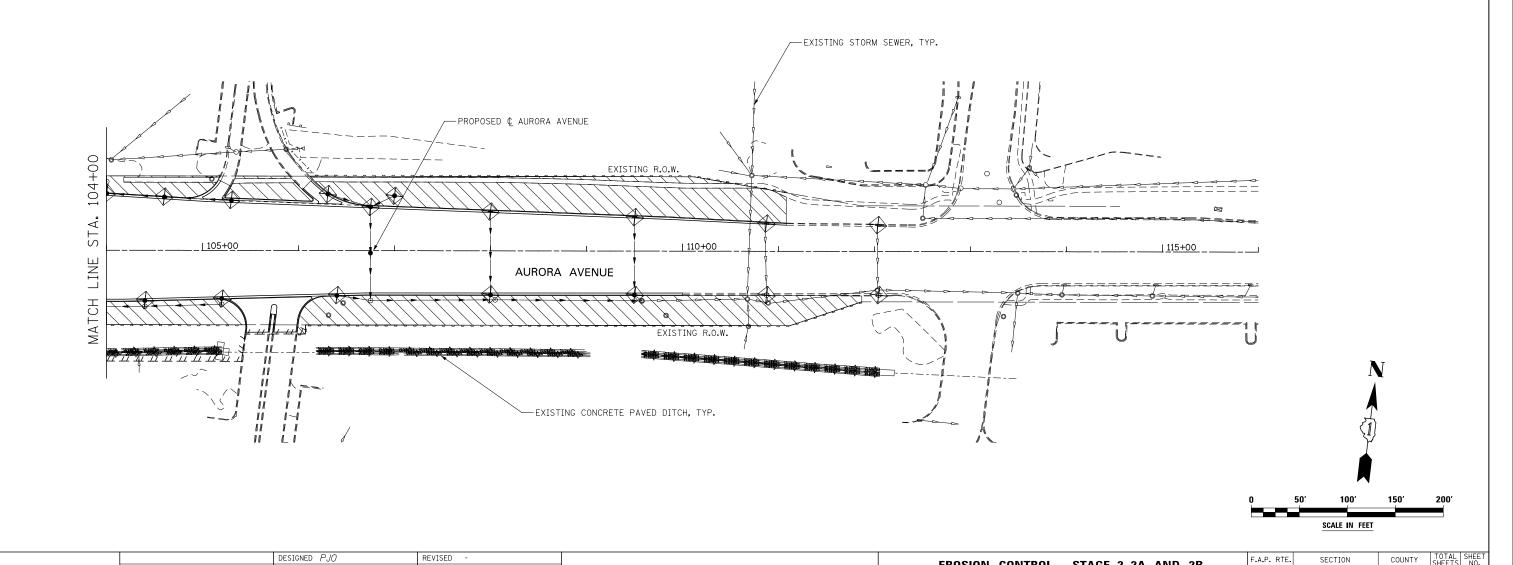

STATE OF ILLINOIS

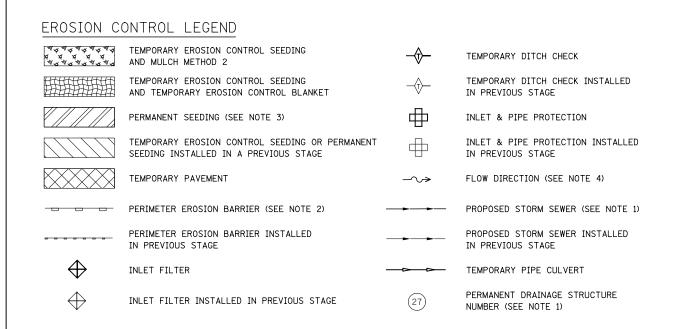

DATE 12/14/201

REVISED

REVISED

### NOTES

- 1. SEE PROPOSED DRAINAGE PLANS FOR STORM SEWER INFORMATION.
- 2. PERIMETER EROSION BARRIER SHALL BE ERECTED ADJACENT TO R.O.W., EASEMENT, AND CONSTRUCTION LIMITS AND AS DIRECTED BY THE ENGINEER.
- 3. SEE LANDSCAPING PLANS FOR LANDSCAPING REQUIREMENTS.
- 4. SEE STAGE 2 CROSS SECTIONS FOR GRADING INFORMATION.


(112 & 113) WRS-7 DUPAGE 1156 727


CONTRACT NO. 60R30

338

LIBERTY STREET

SCALE: AS SHOWN SHEET NO. 37 OF 70 SHEETS STA. 185+00 TO STA. 198+00

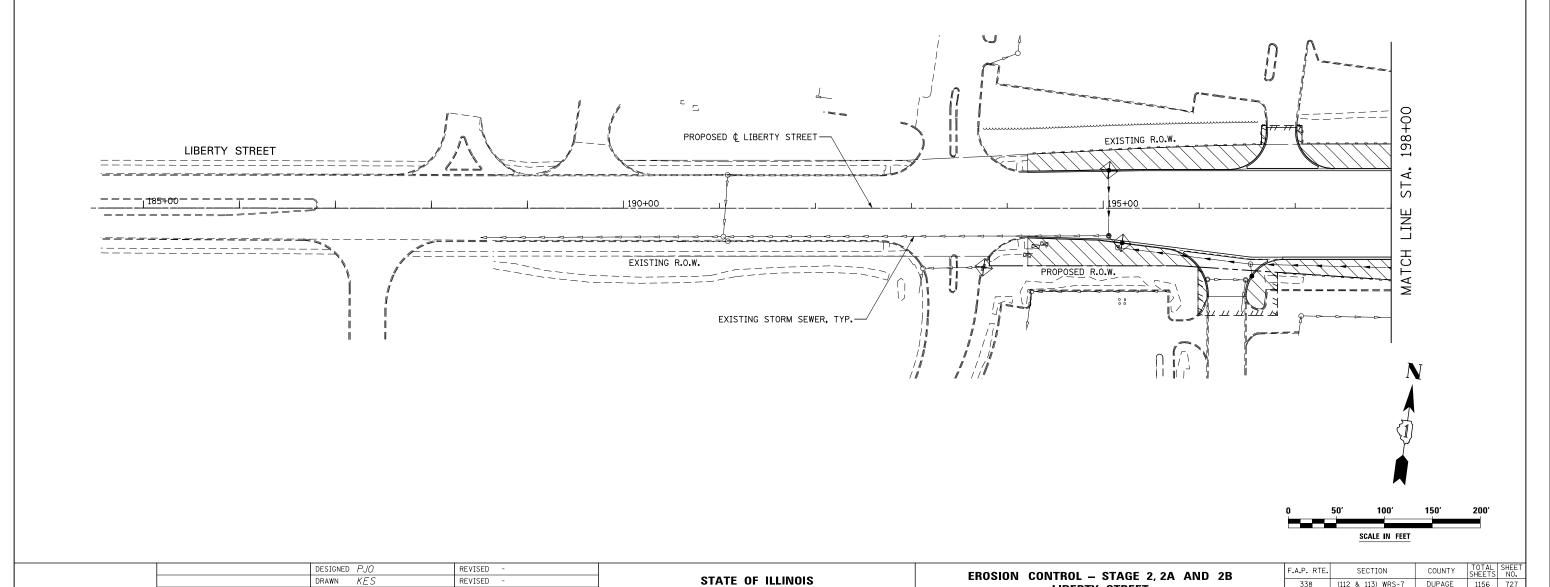

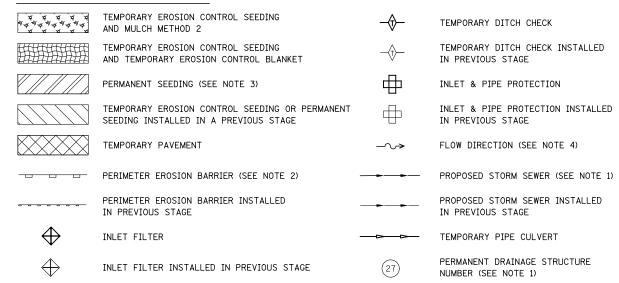

DESIGNED PJO

DRAWN KES

CHECKED JCM

DATE

12/14/201

REVISED

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REVISED

# NOTES

- 1. SEE PROPOSED DRAINAGE PLANS FOR STORM SEWER INFORMATION.
- PERIMETER EROSION BARRIER SHALL BE ERECTED ADJACENT TO R.O.W., EASEMENT, AND CONSTRUCTION LIMITS AND AS DIRECTED BY THE ENGINEER.
- 3. SEE LANDSCAPING PLANS FOR LANDSCAPING REQUIREMENTS.
- 4. SEE STAGE 2 CROSS SECTIONS FOR GRADING INFORMATION.

F.A.P. RTE.

338

**EROSION CONTROL - STAGE 2, 2A AND 2B** 

JEFFERSON AVENUE

SCALE: AS SHOWN SHEET NO. 38 OF 70 SHEETS STA. 202+00 TO STA. 216+00


SECTION

(112 & 113) WRS-7


COUNTY

DUPAGE 1156 728

CONTRACT NO. 60R30

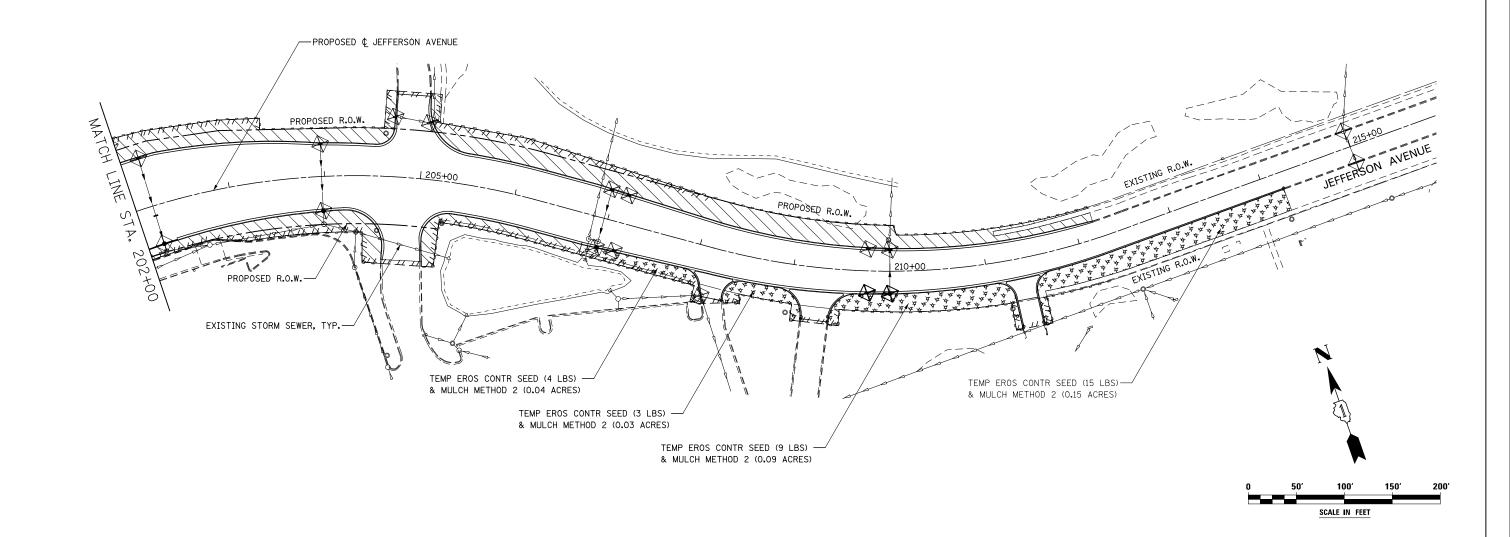

STATE OF ILLINOIS

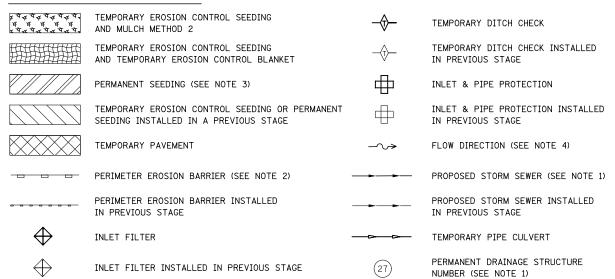

DRAWN KES

CHECKED JCM

12/14/201

DATE

REVISED

REVISED

REVISED

# NOTES

- 1. SEE PROPOSED DRAINAGE PLANS FOR STORM SEWER INFORMATION.
- 2. PERIMETER EROSION BARRIER SHALL BE ERECTED ADJACENT TO R.O.W., EASEMENT, AND CONSTRUCTION LIMITS AND AS DIRECTED BY THE ENGINEER.
- 3. SEE LANDSCAPING PLANS FOR LANDSCAPING REQUIREMENTS.
- 4. SEE STAGE 2 CROSS SECTIONS FOR GRADING INFORMATION.

SECTION

(112 & 113) WRS-7

338

**EROSION CONTROL - STAGE 2, 2A AND 2B** 


**MERIDIAN PARKWAY** 

SCALE: AS SHOWN SHEET NO. 39 OF 70 SHEETS STA. 288+00 TO STA. 298+00

COUNTY

DUPAGE 1156 729

CONTRACT NO. 60R30

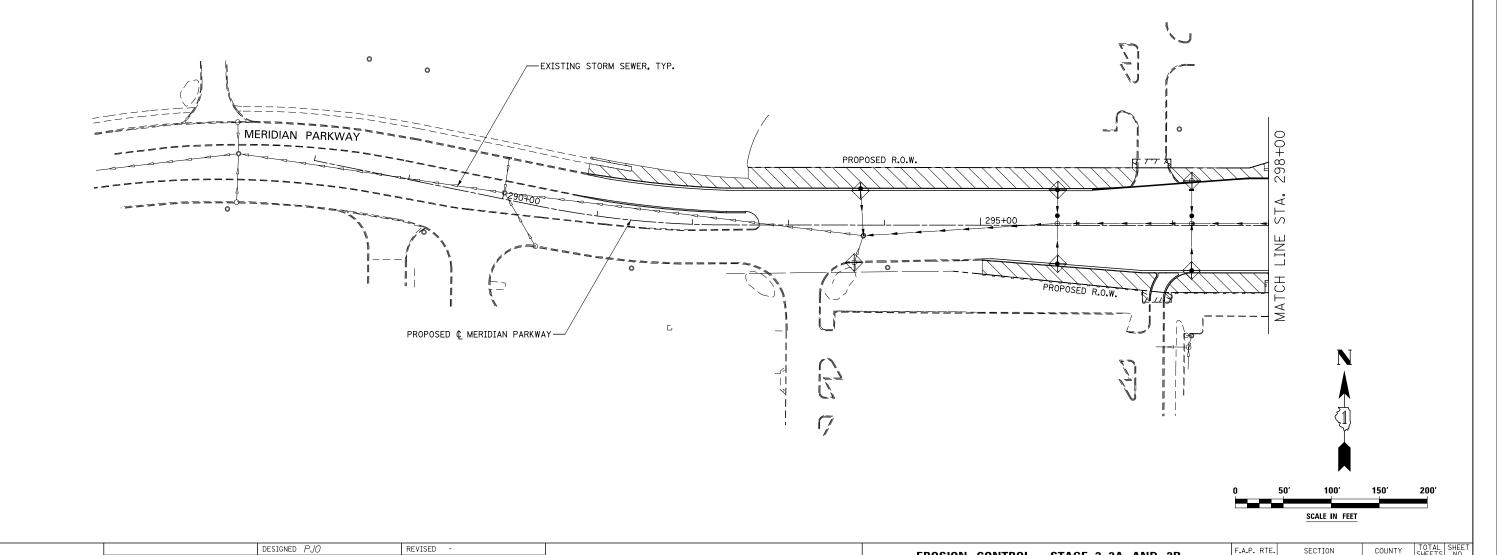



STATE OF ILLINOIS

**************************************	<del></del>		
********	TEMPORARY EROSION CONTROL SEEDING AND MULCH METHOD 2	\$	TEMPORARY DITCH CHECK
	TEMPORARY EROSION CONTROL SEEDING AND TEMPORARY EROSION CONTROL BLANKET	<del>-</del> \$-	TEMPORARY DITCH CHECK INSTALLED IN PREVIOUS STAGE
	PERMANENT SEEDING (SEE NOTE 3)	<b>#</b>	INLET & PIPE PROTECTION
	TEMPORARY EROSION CONTROL SEEDING OR PERMANENT SEEDING INSTALLED IN A PREVIOUS STAGE		INLET & PIPE PROTECTION INSTALLED IN PREVIOUS STAGE
	TEMPORARY PAVEMENT	<b>-</b> ∼>	FLOW DIRECTION (SEE NOTE 4)
- <del></del>	PERIMETER EROSION BARRIER (SEE NOTE 2)		PROPOSED STORM SEWER (SEE NOTE 1)
gar a range arrange se range sa a magnish nga se king garakin	PERIMETER EROSION BARRIER INSTALLED IN PREVIOUS STAGE	AND STREET STREET, STR	PROPOSED STORM SEWER INSTALLED IN PREVIOUS STAGE
$\oplus$	INLET FILTER	<del></del>	TEMPORARY PIPE CULVERT
$\oplus$	INLET FILTER INSTALLED IN PREVIOUS STAGE	(27)	PERMANENT DRAINAGE STRUCTURE NUMBER (SEE NOTE 1)

# NOTES

- 1. SEE PROPOSED DRAINAGE PLANS FOR STORM SEWER INFORMATION.
- PERIMETER EROSION BARRIER SHALL BE ERECTED ADJACENT TO R.O.W., EASEMENT, AND CONSTRUCTION LIMITS AND AS DIRECTED BY THE ENGINEER.
- 3. SEE LANDSCAPING PLANS FOR LANDSCAPING REQUIREMENTS.
- 4. SEE STAGE 2 CROSS SECTIONS FOR GRADING INFORMATION.

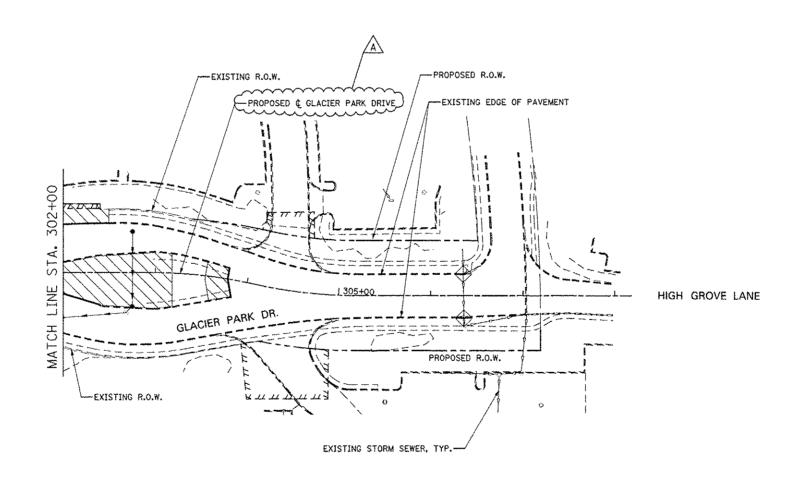


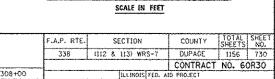

	DESIGNED	PJ0	REVISED - ADDENDUM A 02/20/2013	
	DRAWN	KES	REVISEO -	
	CHECKED	JCM.	REVISED -	
	DATE	12/14/2012	REVISEO -	


STATE OF ILLINOIS
DEPARTMENT OF TRANSPORTATION

ERO	SION		AGE 2, 2A K DRIVE	AND 2	3
SCALE: AS SHOWN	SHEET N	 		O TO STA.	308+00

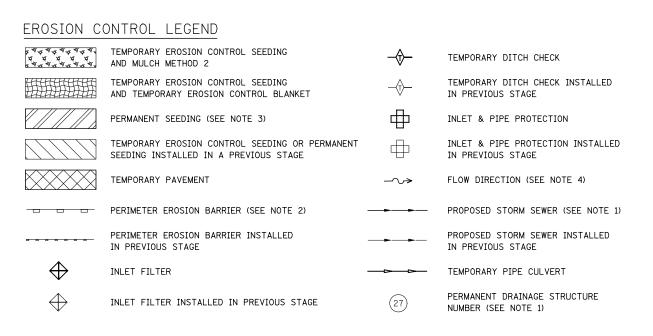

# NOTES

- 1. SEE PROPOSED DRAINAGE PLANS FOR STORM SEWER INFORMATION.
- PERIMETER EROSION BARRIER SHALL BE ERECTED ADJACENT TO R.O.W., EASEMENT, AND CONSTRUCTION LIMITS AND AS DIRECTED BY THE ENGINEER.
- 3. SEE LANDSCAPING PLANS FOR LANDSCAPING REQUIREMENTS.
- 4. SEE STAGE 2 CROSS SECTIONS FOR GRADING INFORMATION.

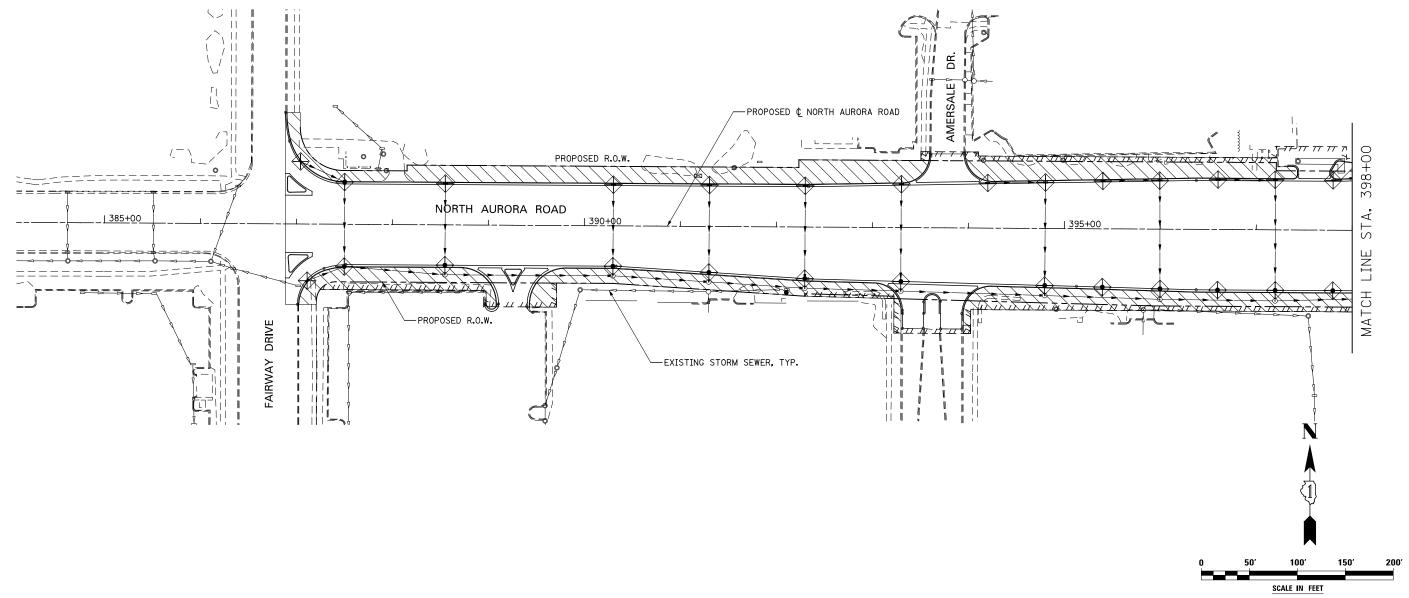

	DESIGNED	PJ0	REVISED	-
	DRAWN	KES	REVISED	-
	CHECKED	JCM	REVISED	-
	DATE	12/14/2012	REVISED	-

STATE OF ILLINOIS
DEPARTMENT OF TRANSPORTATION

EROSION CONTROL - STAGE 2, 2A AND 2B NORTH AURORA ROAD

SCALE: AS SHOWN | SHEET NO. 41 OF 70 SHEETS | STA. 384+00 TO STA. 398+00

F.A.P. RTE. SECTION COUNTY SHEETS NO.

338 (112 & 113) WRS-7 DUPAGE 1156 731

CONTRACT NO. 60R30

#### EROSION CONTROL LEGEND TEMPORARY EROSION CONTROL SEEDING TEMPORARY DITCH CHECK AND MULCH METHOD 2 TEMPORARY EROSION CONTROL SEEDING TEMPORARY DITCH CHECK INSTALLED AND TEMPORARY EROSION CONTROL BLANKET IN PREVIOUS STAGE INLET & PIPE PROTECTION PERMANENT SEEDING (SEE NOTE 3) TEMPORARY EROSION CONTROL SEEDING OR PERMANENT INLET & PIPE PROTECTION INSTALLED SEEDING INSTALLED IN A PREVIOUS STAGE IN PREVIOUS STAGE TEMPORARY PAVEMENT FLOW DIRECTION (SEE NOTE 4) PERIMETER EROSION BARRIER (SEE NOTE 2) PROPOSED STORM SEWER (SEE NOTE 1) PERIMETER EROSION BARRIER INSTALLED PROPOSED STORM SEWER INSTALLED IN PREVIOUS STAGE IN PREVIOUS STAGE INLET FILTER TEMPORARY PIPE CULVERT PERMANENT DRAINAGE STRUCTURE INLET FILTER INSTALLED IN PREVIOUS STAGE NUMBER (SEE NOTE 1)

DRAWN KES

CHECKED JCM

12/14/201

DATE

REVISED

REVISED

REVISED

(\*) - SEE NOTE 5

# NOTES

- 1. SEE PROPOSED DRAINAGE PLANS FOR STORM SEWER INFORMATION.
- PERIMETER EROSION BARRIER SHALL BE ERECTED ADJACENT TO R.O.W., EASEMENT, AND CONSTRUCTION LIMITS AND AS DIRECTED BY THE ENGINEER.
- 3. SEE LANDSCAPING PLANS FOR LANDSCAPING REQUIREMENTS.
- 4. SEE STAGE 2 CROSS SECTIONS FOR GRADING INFORMATION.
- 5. PROPOSED STRUCTURE SHALL BE BURIED AND TEMPORARILY COVERED/CLOSED WITH STEEL PLATE OF THICKNESS SPECIFIED AND APPROVED BY THE ENGINEER. PAYMENT FOR THIS TEMPORARY COVER INSTALLATION AND REMOVAL SHALL BE CONSIDERED INCLUDED IN THE COST OF THE PROPOSED STRUCTURE.

338


**NORTH AURORA ROAD** 

SCALE: AS SHOWN SHEET NO. 42 OF 70 SHEETS STA. 403+00 TO STA. 416+00


(112 & 113) WRS-7


DUPAGE 1156 732

CONTRACT NO. 60R30

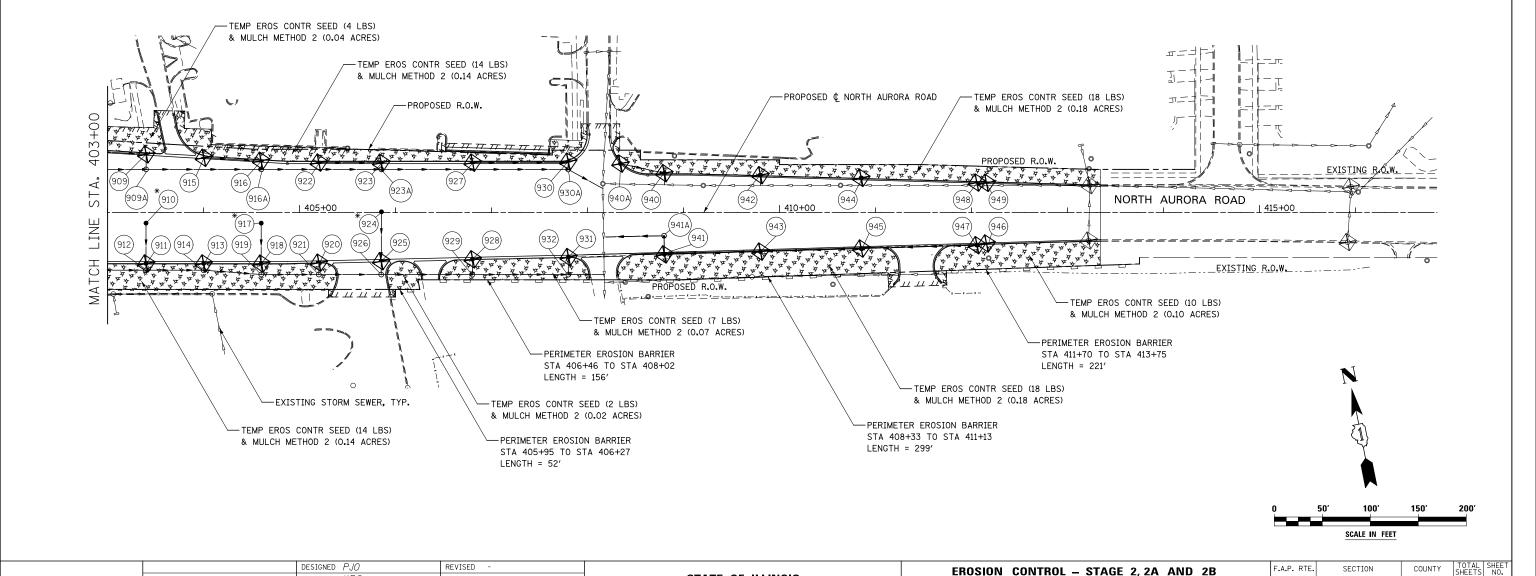

STATE OF ILLINOIS

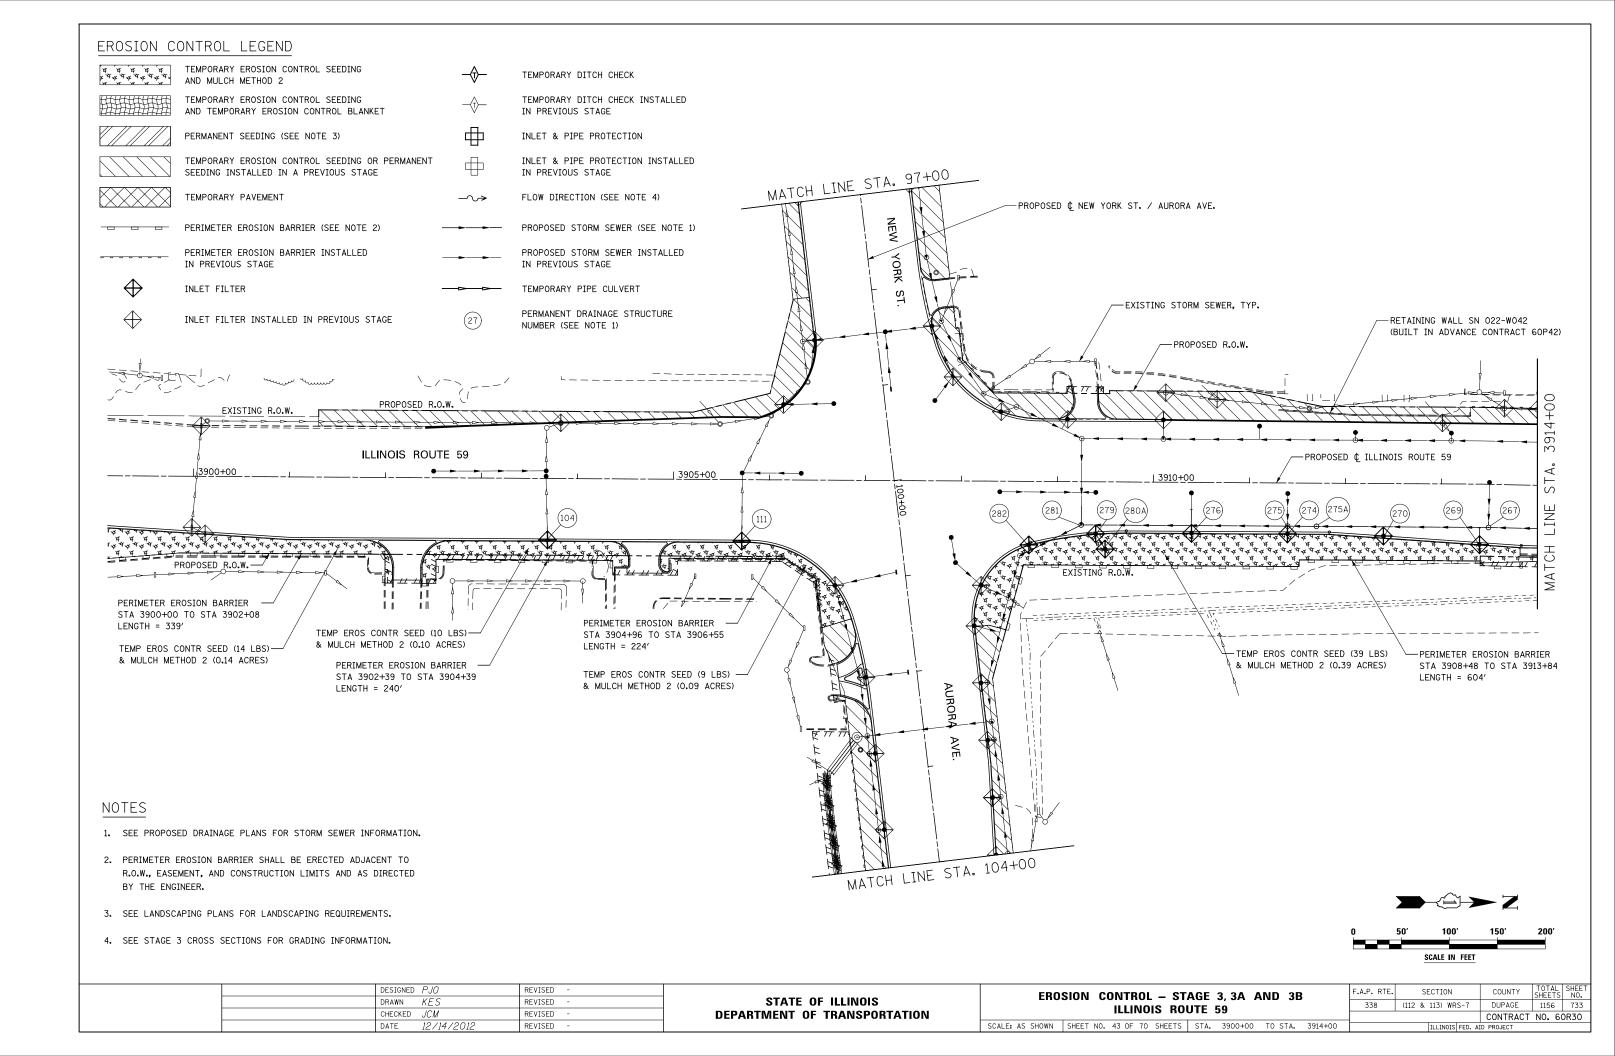

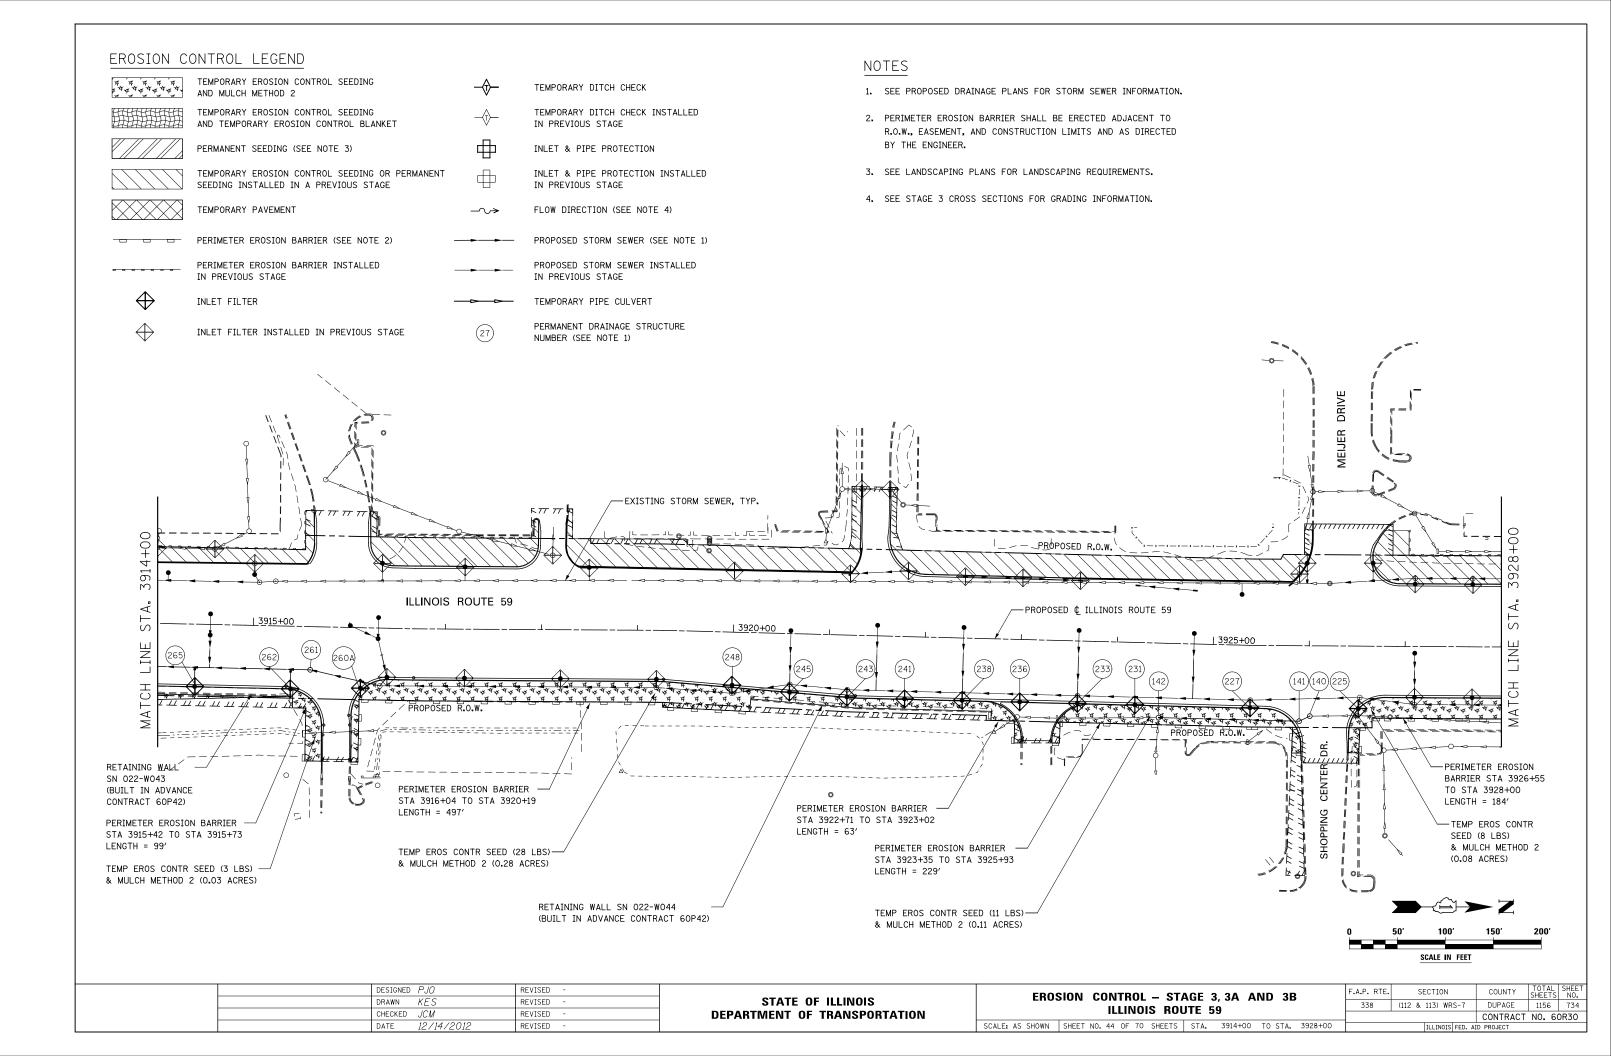

#### EROSION CONTROL LEGEND TEMPORARY EROSION CONTROL SEEDING TEMPORARY DITCH CHECK AND MULCH METHOD 2 TEMPORARY EROSION CONTROL SEEDING TEMPORARY DITCH CHECK INSTALLED AND TEMPORARY EROSION CONTROL BLANKET IN PREVIOUS STAGE PERMANENT SEEDING (SEE NOTE 3) INLET & PIPE PROTECTION TEMPORARY EROSION CONTROL SEEDING OR PERMANENT INLET & PIPE PROTECTION INSTALLED SEEDING INSTALLED IN A PREVIOUS STAGE IN PREVIOUS STAGE TEMPORARY PAVEMENT FLOW DIRECTION (SEE NOTE 4) $-\sim$ PERIMETER EROSION BARRIER (SEE NOTE 2) PROPOSED STORM SEWER (SEE NOTE 1) PERIMETER EROSION BARRIER INSTALLED PROPOSED STORM SEWER INSTALLED IN PREVIOUS STAGE IN PREVIOUS STAGE INLET FILTER TEMPORARY PIPE CULVERT PERMANENT DRAINAGE STRUCTURE INLET FILTER INSTALLED IN PREVIOUS STAGE

CHECKED JCM

DATE

12/14/201

REVISED

REVISED

NUMBER (SEE NOTE 1)

# NOTES

- 1. SEE PROPOSED DRAINAGE PLANS FOR STORM SEWER INFORMATION.
- 2. PERIMETER EROSION BARRIER SHALL BE ERECTED ADJACENT TO R.O.W., EASEMENT, AND CONSTRUCTION LIMITS AND AS DIRECTED BY THE ENGINEER.
- 3. SEE LANDSCAPING PLANS FOR LANDSCAPING REQUIREMENTS.

338

**ILLINOIS ROUTE 59** 


SCALE: AS SHOWN SHEET NO. 45 OF 70 SHEETS STA. 3928+00 TO STA. 3942+00


(112 & 113) WRS-7

DUPAGE 1156 735

CONTRACT NO. 60R30

4. SEE STAGE 3 CROSS SECTIONS FOR GRADING INFORMATION.

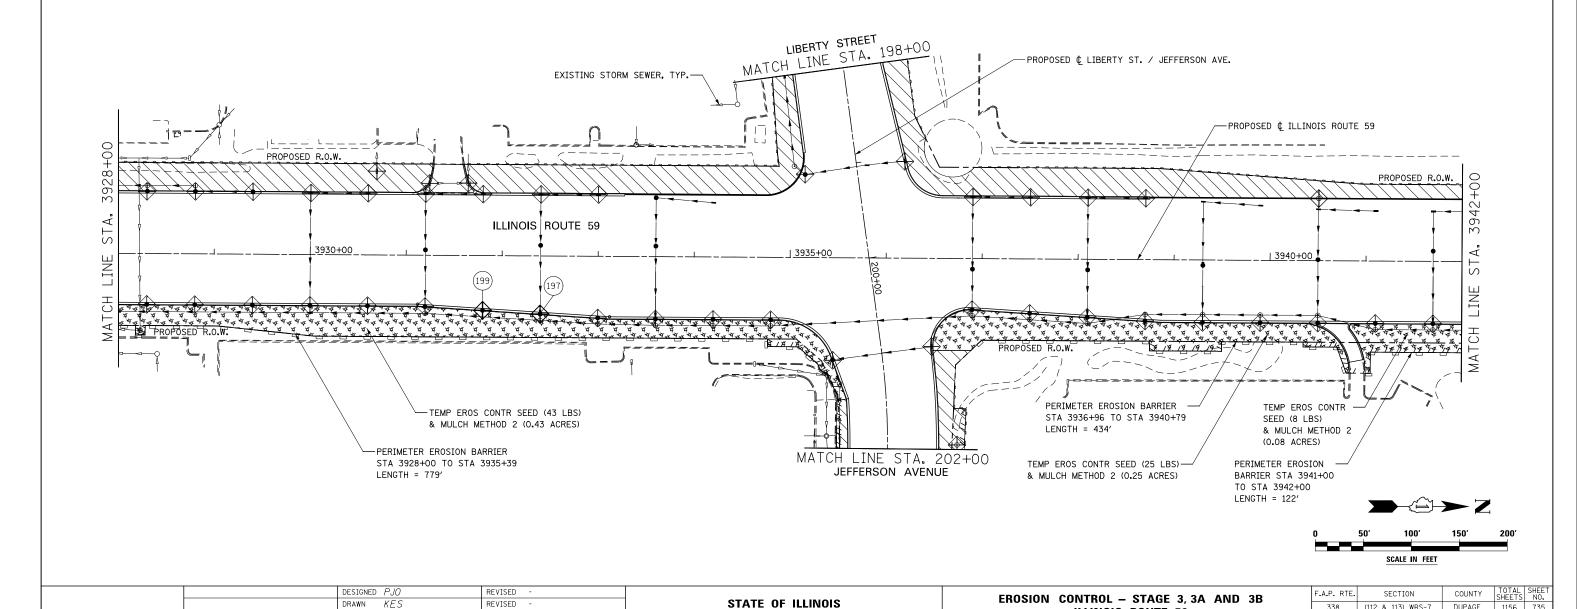

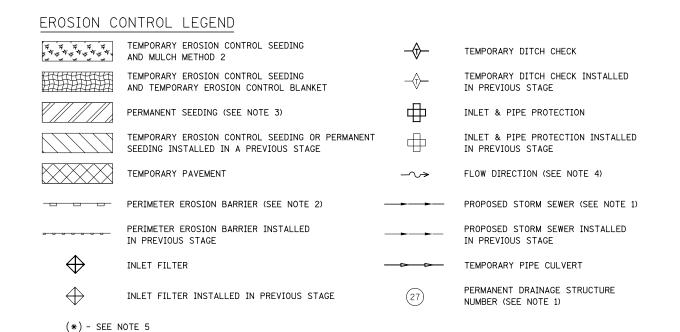

DATE

12/14/201

REVISED

REVISED

### NOTES

- 1. SEE PROPOSED DRAINAGE PLANS FOR STORM SEWER INFORMATION.
- 2. PERIMETER EROSION BARRIER SHALL BE ERECTED ADJACENT TO R.O.W., EASEMENT, AND CONSTRUCTION LIMITS AND AS DIRECTED BY THE ENGINEER.
- 3. SEE LANDSCAPING PLANS FOR LANDSCAPING REQUIREMENTS.

338

**ILLINOIS ROUTE 59** 


SCALE: AS SHOWN SHEET NO. 46 OF 70 SHEETS STA. 3942+00 TO STA. 3955+00


(112 & 113) WRS-7

DUPAGE 1156 736

CONTRACT NO. 60R30

4. SEE STAGE 3 CROSS SECTIONS FOR GRADING INFORMATION.

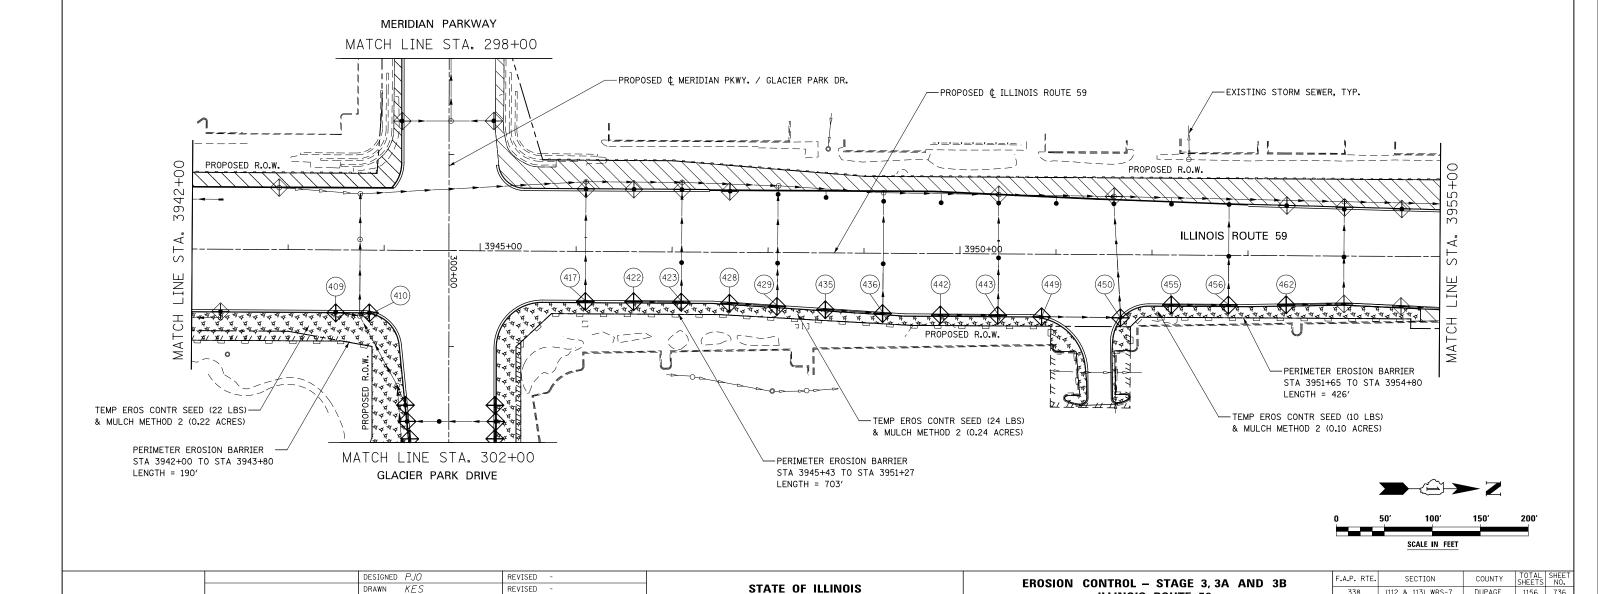


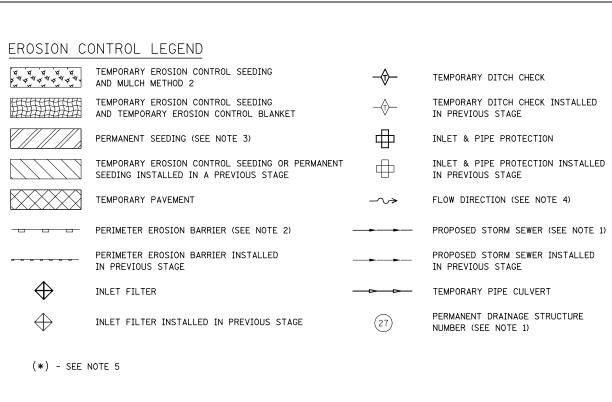

#### NOTES

- 1. SEE PROPOSED DRAINAGE PLANS FOR STORM SEWER INFORMATION.
- PERIMETER EROSION BARRIER SHALL BE ERECTED ADJACENT TO R.O.W., EASEMENT, AND CONSTRUCTION LIMITS AND AS DIRECTED BY THE ENGINEER.
- 3. SEE LANDSCAPING PLANS FOR LANDSCAPING REQUIREMENTS.
- 4. SEE STAGE 3 CROSS SECTIONS FOR GRADING INFORMATION.
- 5. PROPOSED STRUCTURE SHALL BE BURIED AND TEMPORARILY COVERED/CLOSED WITH STEEL PLATE OF THICKNESS SPECIFIED AND APPROVED BY THE ENGINEER. PAYMENT FOR THIS TEMPORARY COVER INSTALLATION AND REMOVAL SHALL BE CONSIDERED INCLUDED IN THE COST OF THE PROPOSED STRUCTURE.

SCALE IN FEET

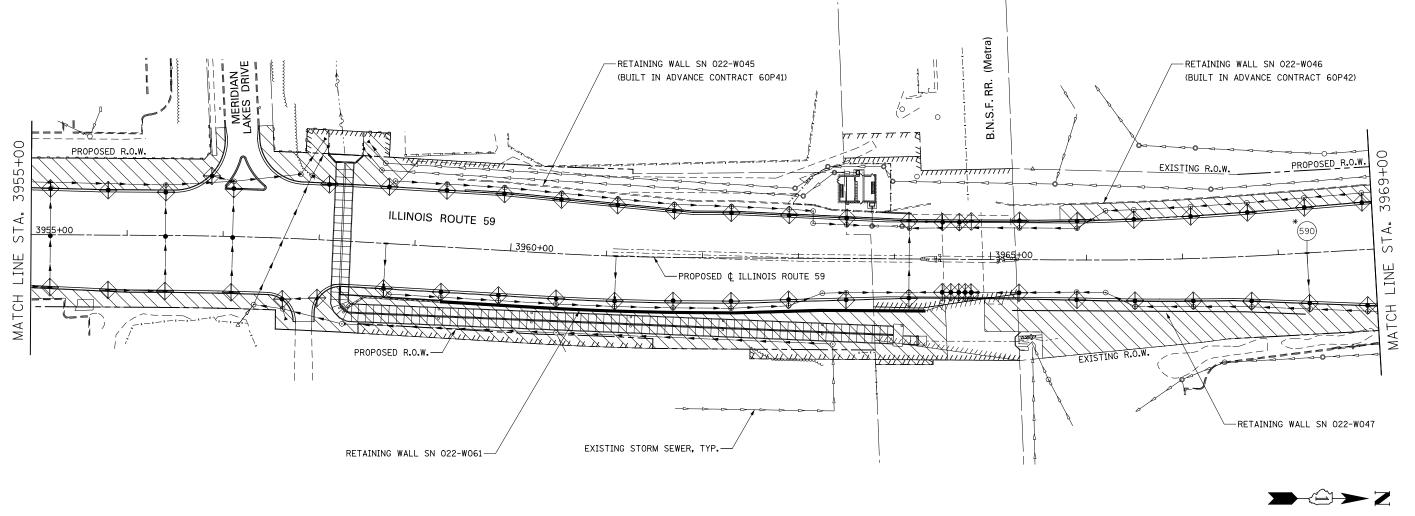

	DESIGNED PJO	REVISED -	OTATE OF HUMOIO	EROSION CONTROL – STAGE 3, 3A AND 3B	F.A.P. RTE.	SECTION	COUNTY	TOTAL SHEET SHEETS NO.
-	DRAWN KES	REVISED - STATE OF ILLINOIS EROSION CONTROL — STAGE 3, SA  REVISED - DEPARTMENT OF TRANSPORTATION ILLINOIS ROUTE 59			338	(112 & 113) WRS-7	DUPAGE	1156 737
-	DATE 12/14/2012	REVISED -	DEPARTMENT OF TRANSPORTATION	SCALE: AS SHOWN   SHEET NO. 47 OF 70 SHEETS   STA. 3955+00 TO STA. 3969+00		ILLINOIS FED. AI	D PROJECT	NO. 60R30

#### EROSION CONTROL LEGEND TEMPORARY EROSION CONTROL SEEDING TEMPORARY DITCH CHECK AND MULCH METHOD 2 TEMPORARY EROSION CONTROL SEEDING TEMPORARY DITCH CHECK INSTALLED AND TEMPORARY EROSION CONTROL BLANKET IN PREVIOUS STAGE PERMANENT SEEDING (SEE NOTE 3) INLET & PIPE PROTECTION TEMPORARY EROSION CONTROL SEEDING OR PERMANENT INLET & PIPE PROTECTION INSTALLED SEEDING INSTALLED IN A PREVIOUS STAGE IN PREVIOUS STAGE TEMPORARY PAVEMENT FLOW DIRECTION (SEE NOTE 4) PERIMETER EROSION BARRIER (SEE NOTE 2) PROPOSED STORM SEWER (SEE NOTE 1) PERIMETER EROSION BARRIER INSTALLED PROPOSED STORM SEWER INSTALLED IN PREVIOUS STAGE IN PREVIOUS STAGE INLET FILTER TEMPORARY PIPE CULVERT PERMANENT DRAINAGE STRUCTURE INLET FILTER INSTALLED IN PREVIOUS STAGE NUMBER (SEE NOTE 1)

DRAWN KES

CHECKED JCM

DATE

12/14/201

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#### NOTES

- 1. SEE PROPOSED DRAINAGE PLANS FOR STORM SEWER INFORMATION.
- 2. PERIMETER EROSION BARRIER SHALL BE ERECTED ADJACENT TO R.O.W., EASEMENT, AND CONSTRUCTION LIMITS AND AS DIRECTED BY THE ENGINEER.
- 3. SEE LANDSCAPING PLANS FOR LANDSCAPING REQUIREMENTS.
- 4. SEE STAGE 3 CROSS SECTIONS FOR GRADING INFORMATION.
- 5. PROPOSED STRUCTURE SHALL BE BURIED AND TEMPORARILY COVERED/CLOSED WITH STEEL PLATE OF THICKNESS SPECIFIED AND APPROVED BY THE ENGINEER. PAYMENT FOR THIS TEMPORARY COVER INSTALLATION AND REMOVAL SHALL BE CONSIDERED INCLUDED IN THE COST OF THE PROPOSED STRUCTURE.

(112 & 113) WRS-7


DUPAGE 1156 738


CONTRACT NO. 60R30

338

**ILLINOIS ROUTE 59** 

SCALE: AS SHOWN SHEET NO. 48 OF 70 SHEETS STA. 3969+00 TO STA. 3982+08

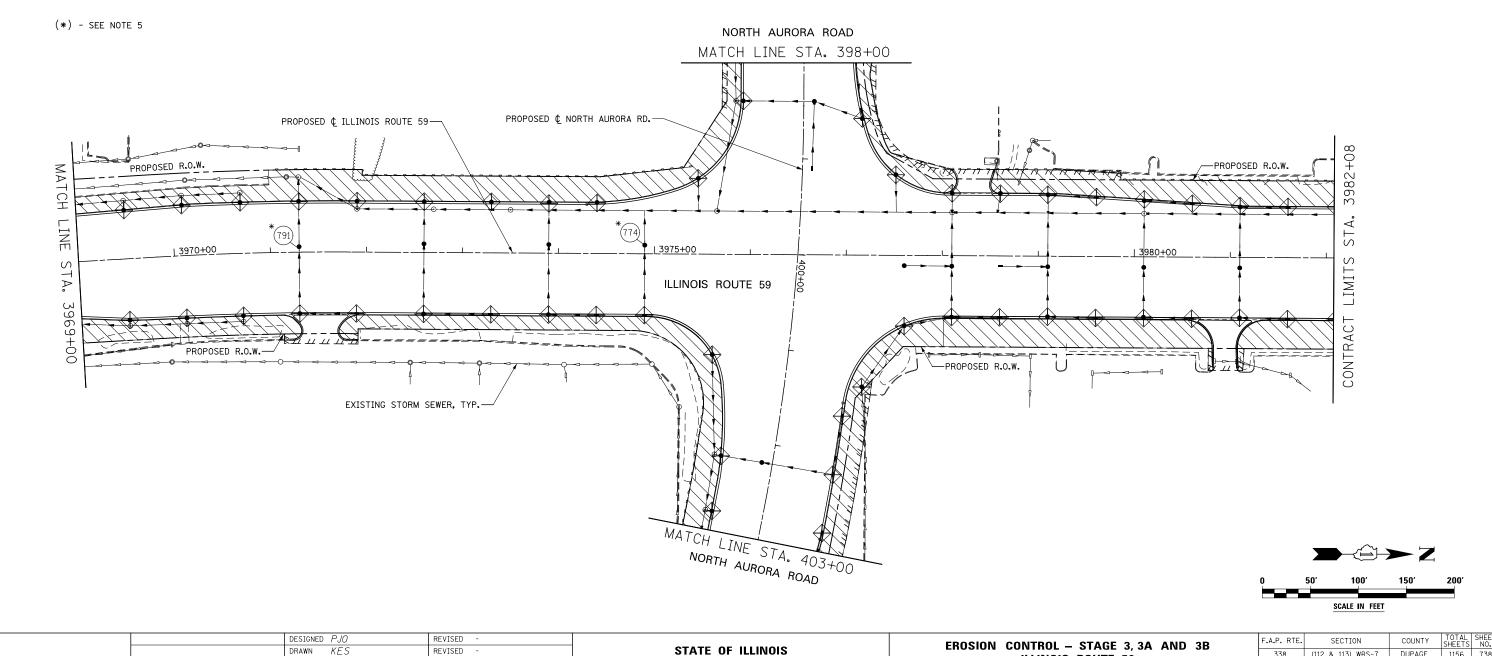

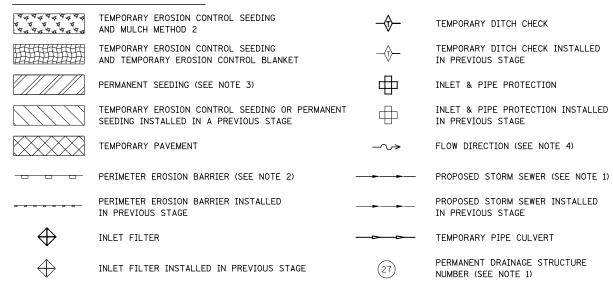

CHECKED JCM

12/14/201

DATE

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#### NOTES


- 1. SEE PROPOSED DRAINAGE PLANS FOR STORM SEWER INFORMATION.
- 2. PERIMETER EROSION BARRIER SHALL BE ERECTED ADJACENT TO R.O.W., EASEMENT, AND CONSTRUCTION LIMITS AND AS DIRECTED BY THE ENGINEER.
- 3. SEE LANDSCAPING PLANS FOR LANDSCAPING REQUIREMENTS.


NEW YORK STREET

SCALE: AS SHOWN SHEET NO. 49 OF 70 SHEETS STA. 85+00 TO STA. 97+00

CONTRACT NO. 60R30

4. SEE STAGE 3 CROSS SECTIONS FOR GRADING INFORMATION.

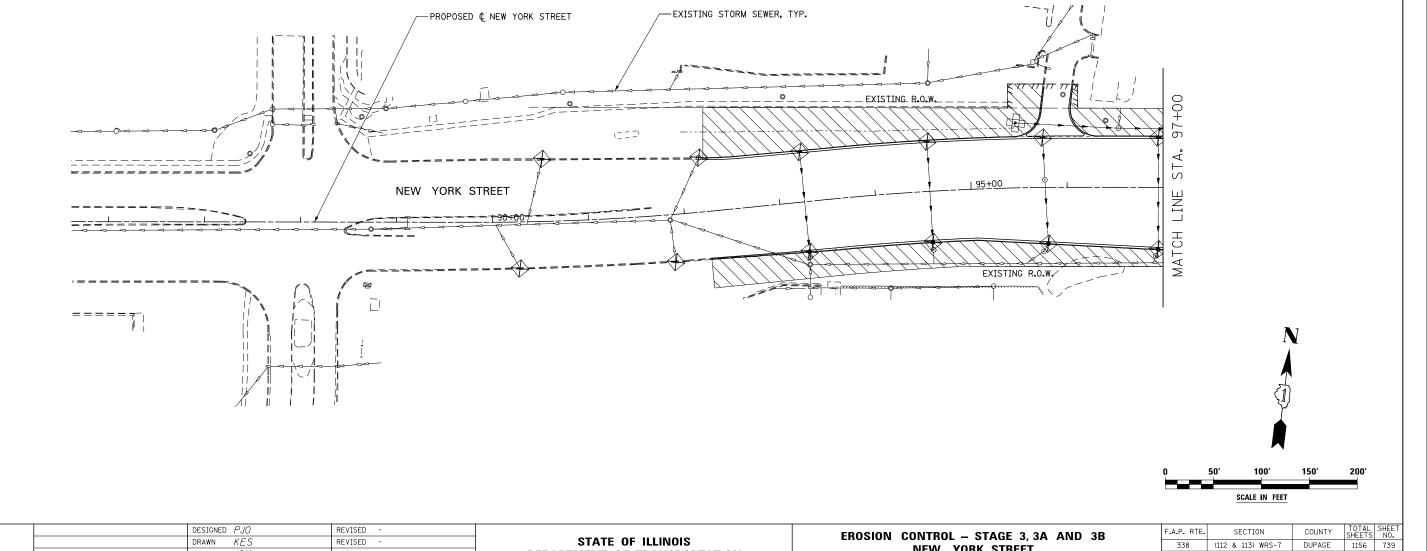

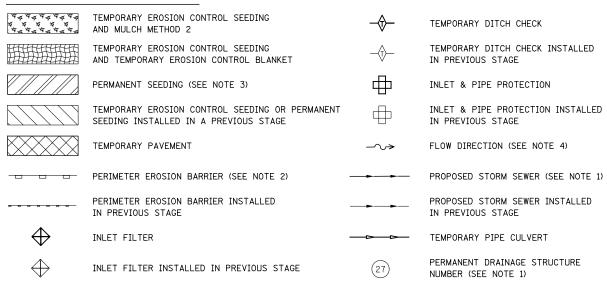

DRAWN KES

CHECKED JCM

DATE

12/14/201

REVISED

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REVISED

### NOTES

- 1. SEE PROPOSED DRAINAGE PLANS FOR STORM SEWER INFORMATION.
- 2. PERIMETER EROSION BARRIER SHALL BE ERECTED ADJACENT TO R.O.W., EASEMENT, AND CONSTRUCTION LIMITS AND AS DIRECTED BY THE ENGINEER.
- 3. SEE LANDSCAPING PLANS FOR LANDSCAPING REQUIREMENTS.

338

**AURORA AVENUE** 


SCALE: AS SHOWN SHEET NO. 50 OF 70 SHEETS STA. 104+00 TO STA. 116+00

(112 & 113) WRS-7


DUPAGE 1156 740

CONTRACT NO. 60R30

4. SEE STAGE 3 CROSS SECTIONS FOR GRADING INFORMATION.

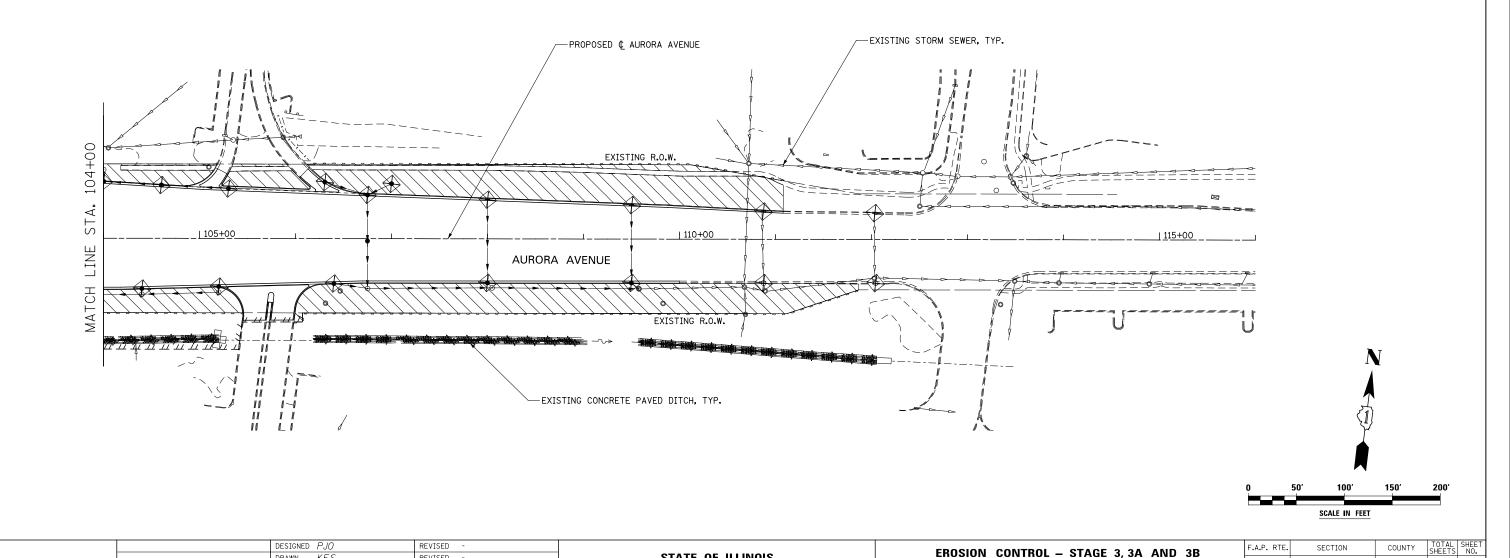

STATE OF ILLINOIS

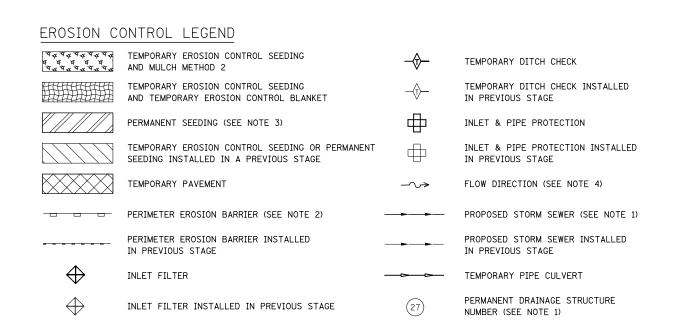

DRAWN KES

CHECKED JCM

DATE 12/14/201

REVISED

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REVISED

#### NOTES

- 1. SEE PROPOSED DRAINAGE PLANS FOR STORM SEWER INFORMATION.
- 2. PERIMETER EROSION BARRIER SHALL BE ERECTED ADJACENT TO R.O.W., EASEMENT, AND CONSTRUCTION LIMITS AND AS DIRECTED BY THE ENGINEER.
- 3. SEE LANDSCAPING PLANS FOR LANDSCAPING REQUIREMENTS.

(112 & 113) WRS-7 DUPAGE 1156 741


CONTRACT NO. 60R30


338

LIBERTY STREET

SCALE: AS SHOWN SHEET NO. 51 OF 70 SHEETS STA. 185+00 TO STA. 198+00


4. SEE STAGE 3 CROSS SECTIONS FOR GRADING INFORMATION.

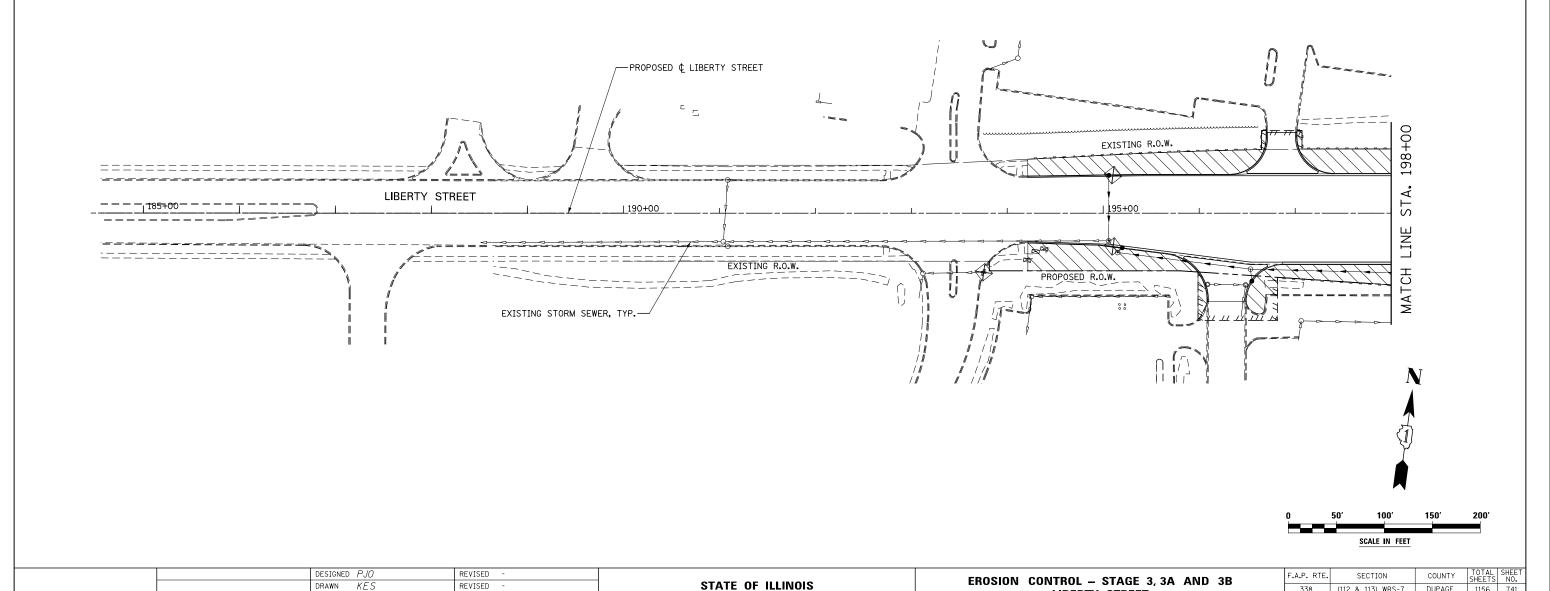

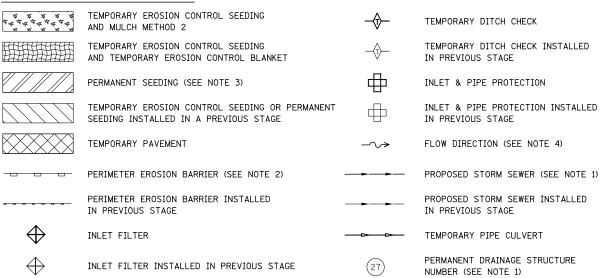

#### NOTES

- 1. SEE PROPOSED DRAINAGE PLANS FOR STORM SEWER INFORMATION.
- PERIMETER EROSION BARRIER SHALL BE ERECTED ADJACENT TO R.O.W., EASEMENT, AND CONSTRUCTION LIMITS AND AS DIRECTED BY THE ENGINEER.
- 3. SEE LANDSCAPING PLANS FOR LANDSCAPING REQUIREMENTS.
- 4. SEE STAGE 3 CROSS SECTIONS FOR GRADING INFORMATION.

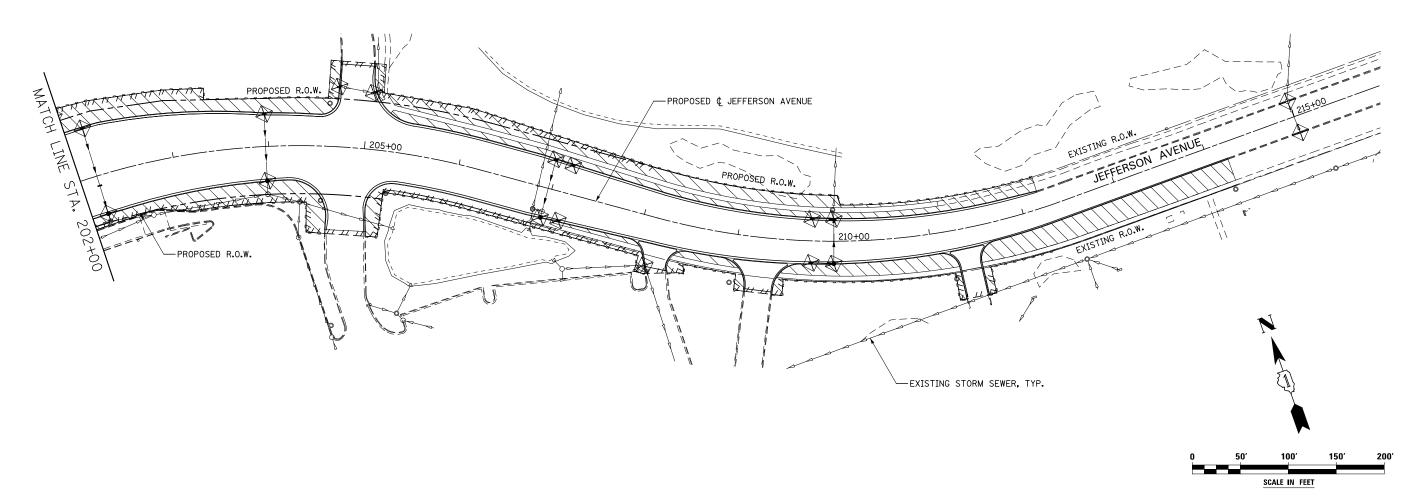


	DESIGNED	PJU	KENIZED	-	
	DRAWN	KES	REVISED	-	
	CHECKED	JCM	REVISED	-	DEPARTI
	DATE	12/14/2012	REVISED	-	

STATE OF ILLINOIS
TMENT OF TRANSPORTATION

EROSION CONTROL – STAGE 3, 3A AND 3B JEFFERSON AVENUE							
SCALE: AS SHOWN	SHEET NO. 52 OF 70 SHEETS	STA. 202+00	TO STA. 216+00				

	F.A.P. RTE.	SECTION	COUNTY	TOTAL SHEETS	SHEET NO.
	338	(112 & 113) WRS-7	DUPAGE	1156	742
_			CONTRACT	NO. 60	DR30
		TILITNOTS FED AT	D PROJECT		

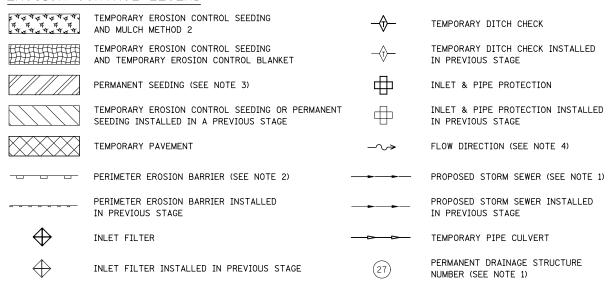

DRAWN KES

CHECKED JCM

DATE

12/14/201

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#### NOTES

- 1. SEE PROPOSED DRAINAGE PLANS FOR STORM SEWER INFORMATION.
- 2. PERIMETER EROSION BARRIER SHALL BE ERECTED ADJACENT TO R.O.W., EASEMENT, AND CONSTRUCTION LIMITS AND AS DIRECTED BY THE ENGINEER.
- 3. SEE LANDSCAPING PLANS FOR LANDSCAPING REQUIREMENTS.

338

**MERIDIAN PARKWAY** 


SCALE: AS SHOWN SHEET NO. 53 OF 70 SHEETS STA. 288+00 TO STA. 298+00

(112 & 113) WRS-7

DUPAGE 1156 743

CONTRACT NO. 60R30

4. SEE STAGE 3 CROSS SECTIONS FOR GRADING INFORMATION.

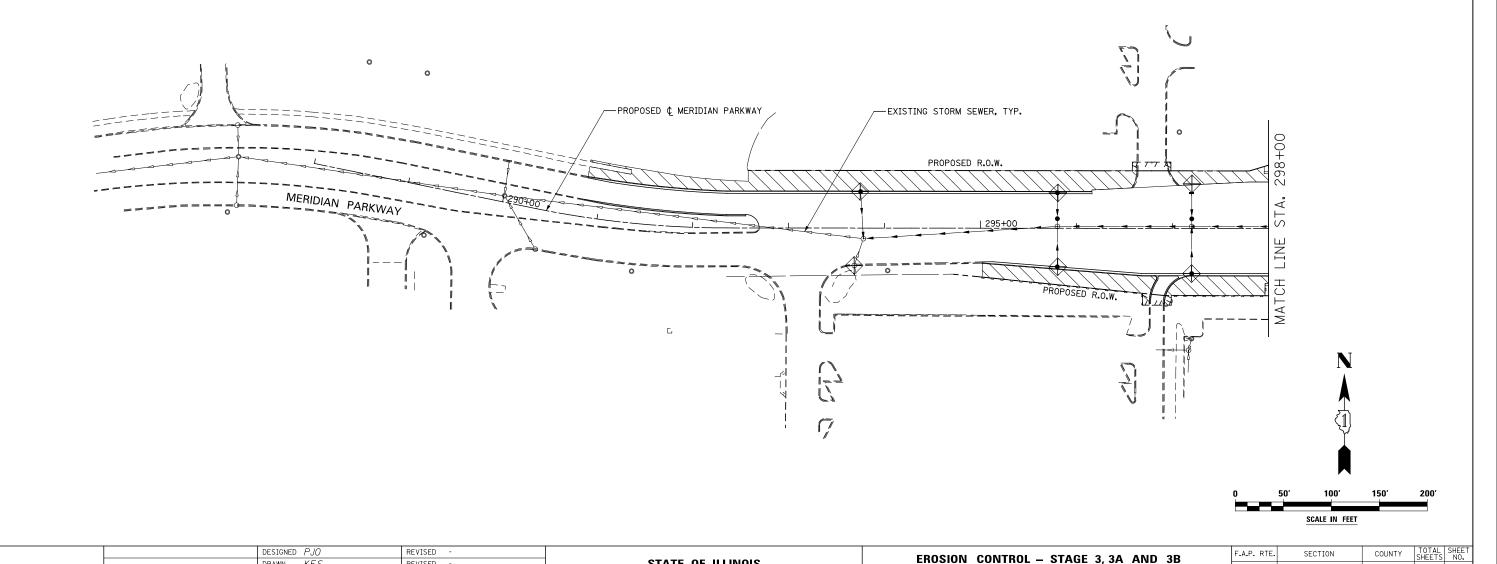

STATE OF ILLINOIS

TEMPORARY EROSION CONTROL SEEDING
AND MULCH METHOD 2

TEMPORARY EROSION CONTROL SEEDING
AND TEMPORARY EROSION CONTROL BLANKET

PERMANENT SEEDING (SEE NOTE 3)

TEMPORARY EROSION CONTROL SEEDING OR PERMANENT
SEEDING INSTALLED IN A PREVIOUS STAGE

TEMPORARY PAVEMENT

PERIMETER EROSION BARRIER (SEE NOTE 2)

PERIMETER EROSION BARRIER INSTALLED
IN PREVIOUS STAGE

INLET FILTER

INLET FILTER INSTALLED IN PREVIOUS STAGE

TEMPORARY DITCH CHECK

TEMPORARY DITCH CHECK INSTALLED IN PREVIOUS STAGE

INLET & PIPE PROTECTION

INLET & PIPE PROTECTION INSTALLED IN PREVIOUS STAGE

---> FLOW DIRECTION (SEE NOTE 4)

PROPOSED STORM SEWER (SEE NOTE 1)


PROPOSED STORM SEWER INSTALLED IN PREVIOUS STAGE


TEMPORARY PIPE CULVERT

PERMANENT DRAINAGE STRUCTURE NUMBER (SEE NOTE 1)

#### NOTES

- 1. SEE PROPOSED DRAINAGE PLANS FOR STORM SEWER INFORMATION.
- PERIMETER EROSION BARRIER SHALL BE ERECTED ADJACENT TO R.O.W., EASEMENT, AND CONSTRUCTION LIMITS AND AS DIRECTED BY THE ENGINEER.
- 3. SEE LANDSCAPING PLANS FOR LANDSCAPING REQUIREMENTS.
- 4. SEE STAGE 3 CROSS SECTIONS FOR GRADING INFORMATION.

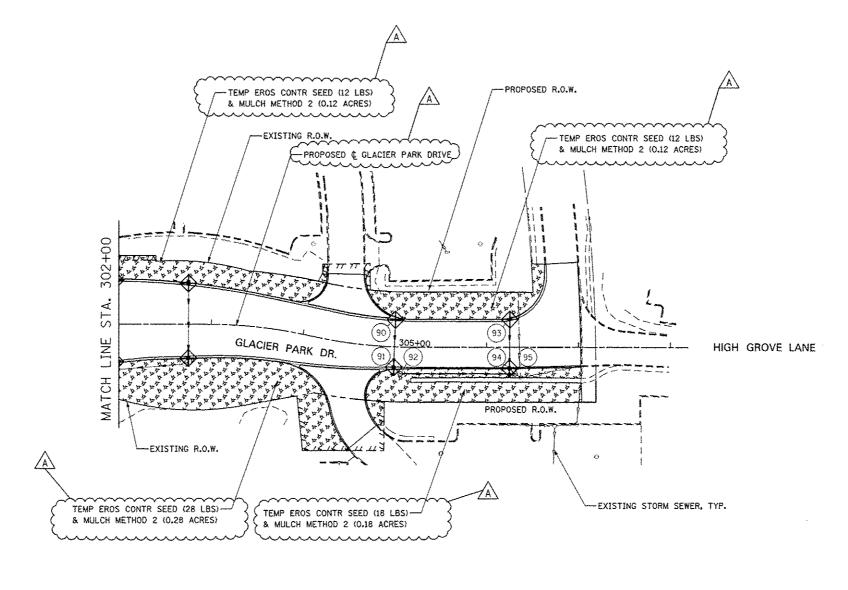

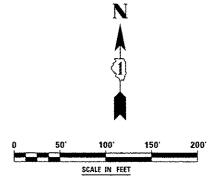

	DESIG	NED PJO	REVISE	D - ADDENDUM A	02/20/2013
	DRAW	KES	REVISE	0 -	
1	CHECK	ED JCM	REVISE	0 -	
	DATE	12/14/	2012 REVISE	0 ~	
1	CHÉCK	ED <i>JCM</i> 12/14/			

STATE OF ILLINOIS
DEPARTMENT OF TRANSPORTATION

EROSION CONTROL - STAGE 3, 3A AND 3B GLACIER PARK DRIVE

SCALE: AS SHOWN | SHEET NO. 54 OF 70 SHEETS | STA, 302+00 TO STA, 308+00

F.A.P. RTE.	SECTION	COUNTY	TOTAL	SHEET NO.
338	(112 & 113) WRS-7	DUPAGE	1156	744
		CONTRACT	NO. 6	OR30
	ILLINOIS FEB. A	ID PROJECT		

#### EROSION CONTROL LEGEND TEMPORARY EROSION CONTROL SEEDING TEMPORARY DITCH CHECK AND MULCH METHOD 2 TEMPORARY EROSION CONTROL SEEDING TEMPORARY DITCH CHECK INSTALLED AND TEMPORARY EROSION CONTROL BLANKET IN PREVIOUS STAGE PERMANENT SEEDING (SEE NOTE 3) INLET & PIPE PROTECTION INLET & PIPE PROTECTION INSTALLED TEMPORARY EROSION CONTROL SEEDING OR PERMANENT SEEDING INSTALLED IN A PREVIOUS STAGE IN PREVIOUS STAGE TEMPORARY PAVEMENT FLOW DIRECTION (SEE NOTE 4) PERIMETER EROSION BARRIER (SEE NOTE 2) PROPOSED STORM SEWER (SEE NOTE 1) PROPOSED STORM SEWER INSTALLED PERIMETER EROSION BARRIER INSTALLED IN PREVIOUS STAGE IN PREVIOUS STAGE INLET FILTER TEMPORARY PIPE CULVERT

CHECKED JCM

DATE

12/14/201

REVISED

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## NOTES

- 1. SEE PROPOSED DRAINAGE PLANS FOR STORM SEWER INFORMATION.
- 2. PERIMETER EROSION BARRIER SHALL BE ERECTED ADJACENT TO R.O.W., EASEMENT, AND CONSTRUCTION LIMITS AND AS DIRECTED BY THE ENGINEER.
- 3. SEE LANDSCAPING PLANS FOR LANDSCAPING REQUIREMENTS.

338

NORTH AURORA ROAD


SCALE: AS SHOWN SHEET NO. 55 OF 70 SHEETS STA. 384+00 TO STA. 398+00


(112 & 113) WRS-7

DUPAGE 1156 745

CONTRACT NO. 60R30

4. SEE STAGE 3 CROSS SECTIONS FOR GRADING INFORMATION.

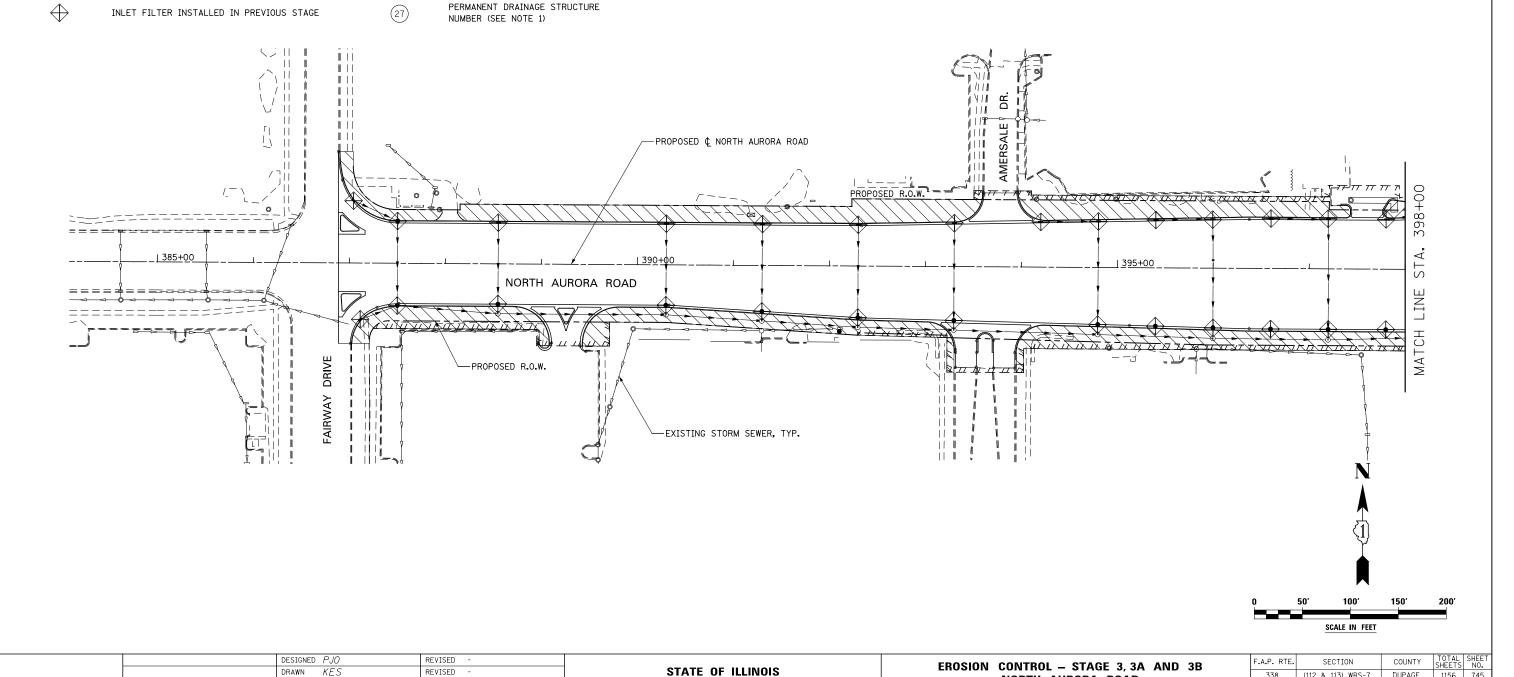

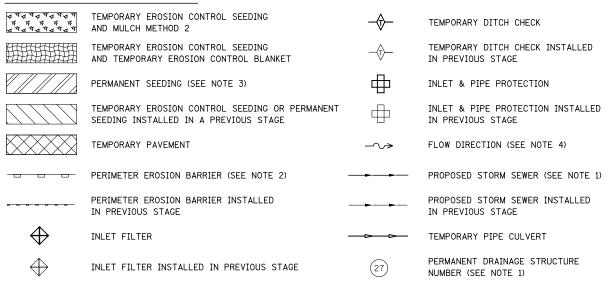

DRAWN KES

CHECKED JCM

12/14/201

DATE

REVISED

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#### NOTES

- 1. SEE PROPOSED DRAINAGE PLANS FOR STORM SEWER INFORMATION.
- 2. PERIMETER EROSION BARRIER SHALL BE ERECTED ADJACENT TO R.O.W., EASEMENT, AND CONSTRUCTION LIMITS AND AS DIRECTED BY THE ENGINEER.
- 3. SEE LANDSCAPING PLANS FOR LANDSCAPING REQUIREMENTS.

338

NORTH AURORA ROAD


SCALE: AS SHOWN SHEET NO. 56 OF 70 SHEETS STA. 403+00 TO STA. 416+00


(112 & 113) WRS-7


DUPAGE 1156 746


CONTRACT NO. 60R30

4. SEE STAGE 3 CROSS SECTIONS FOR GRADING INFORMATION.

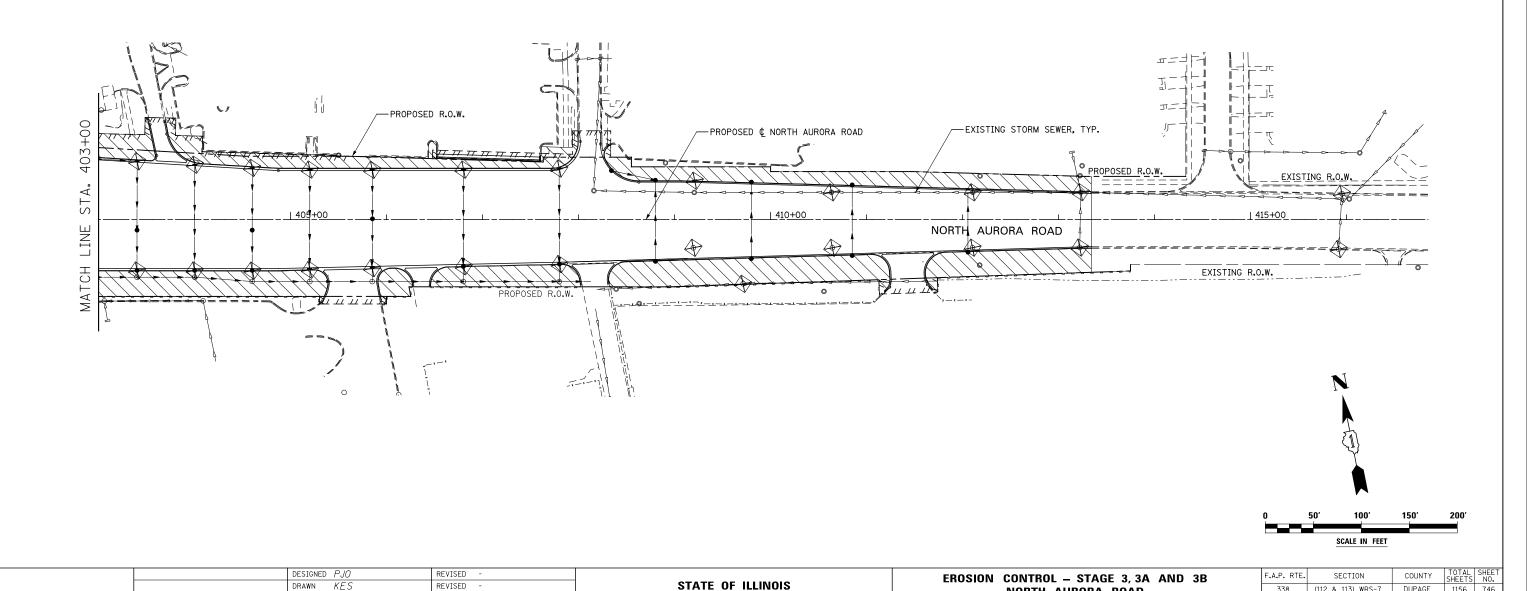

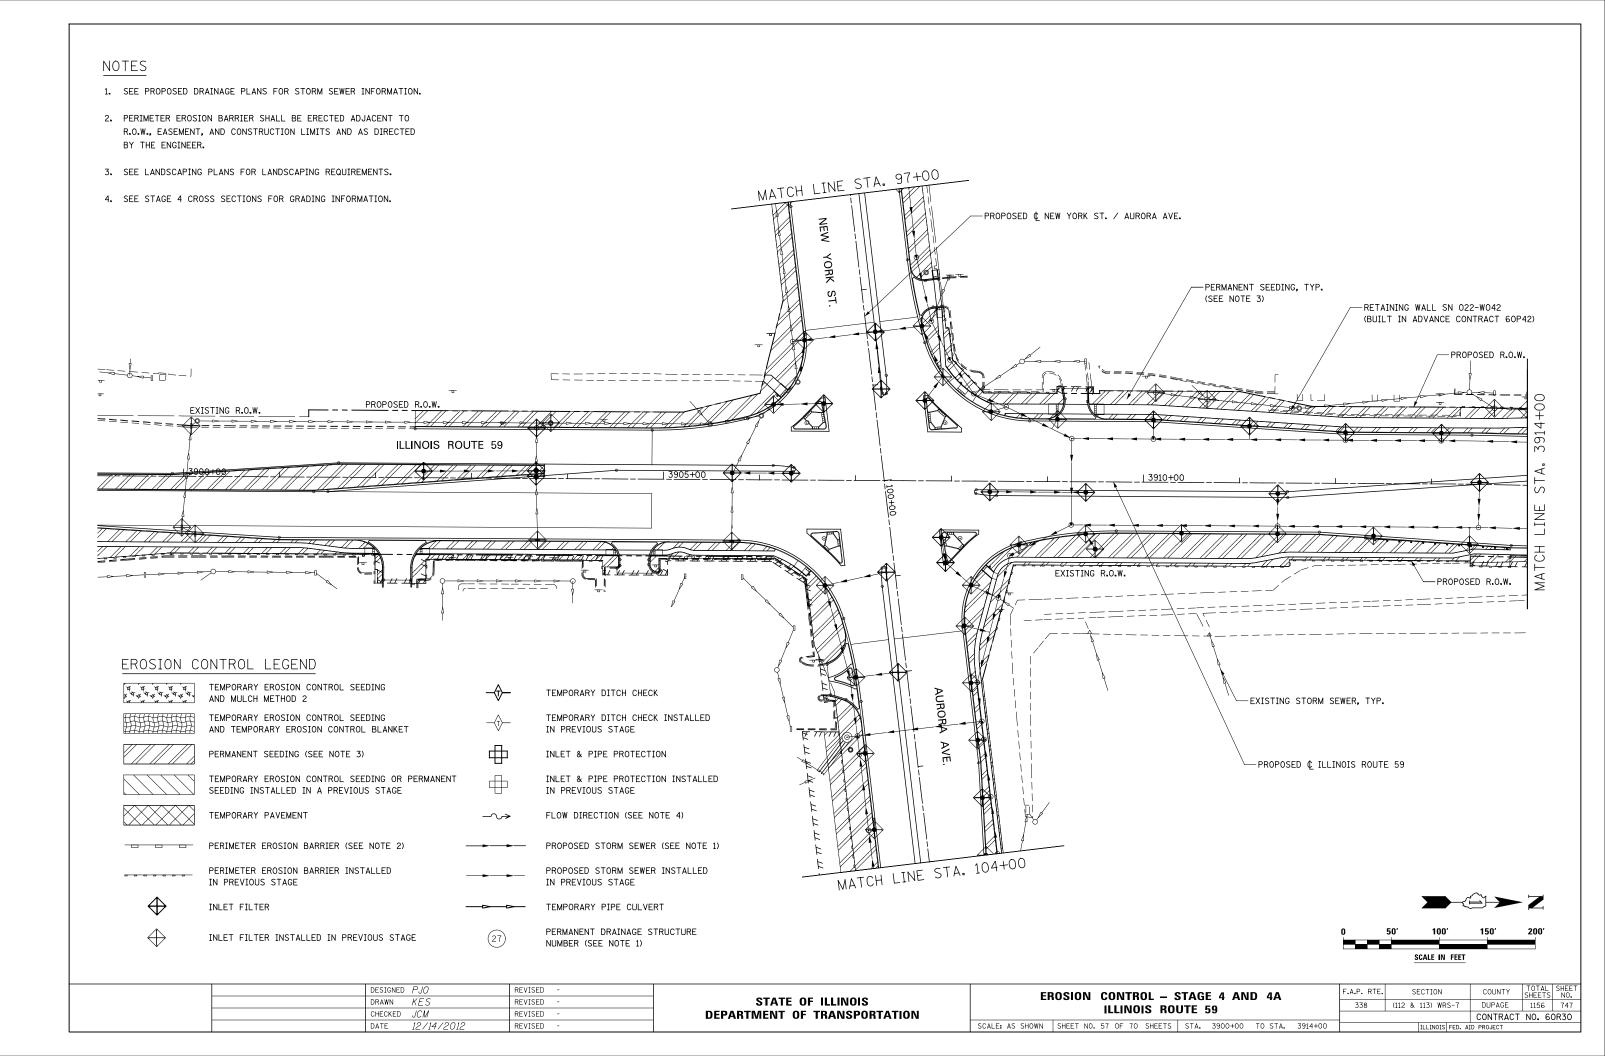


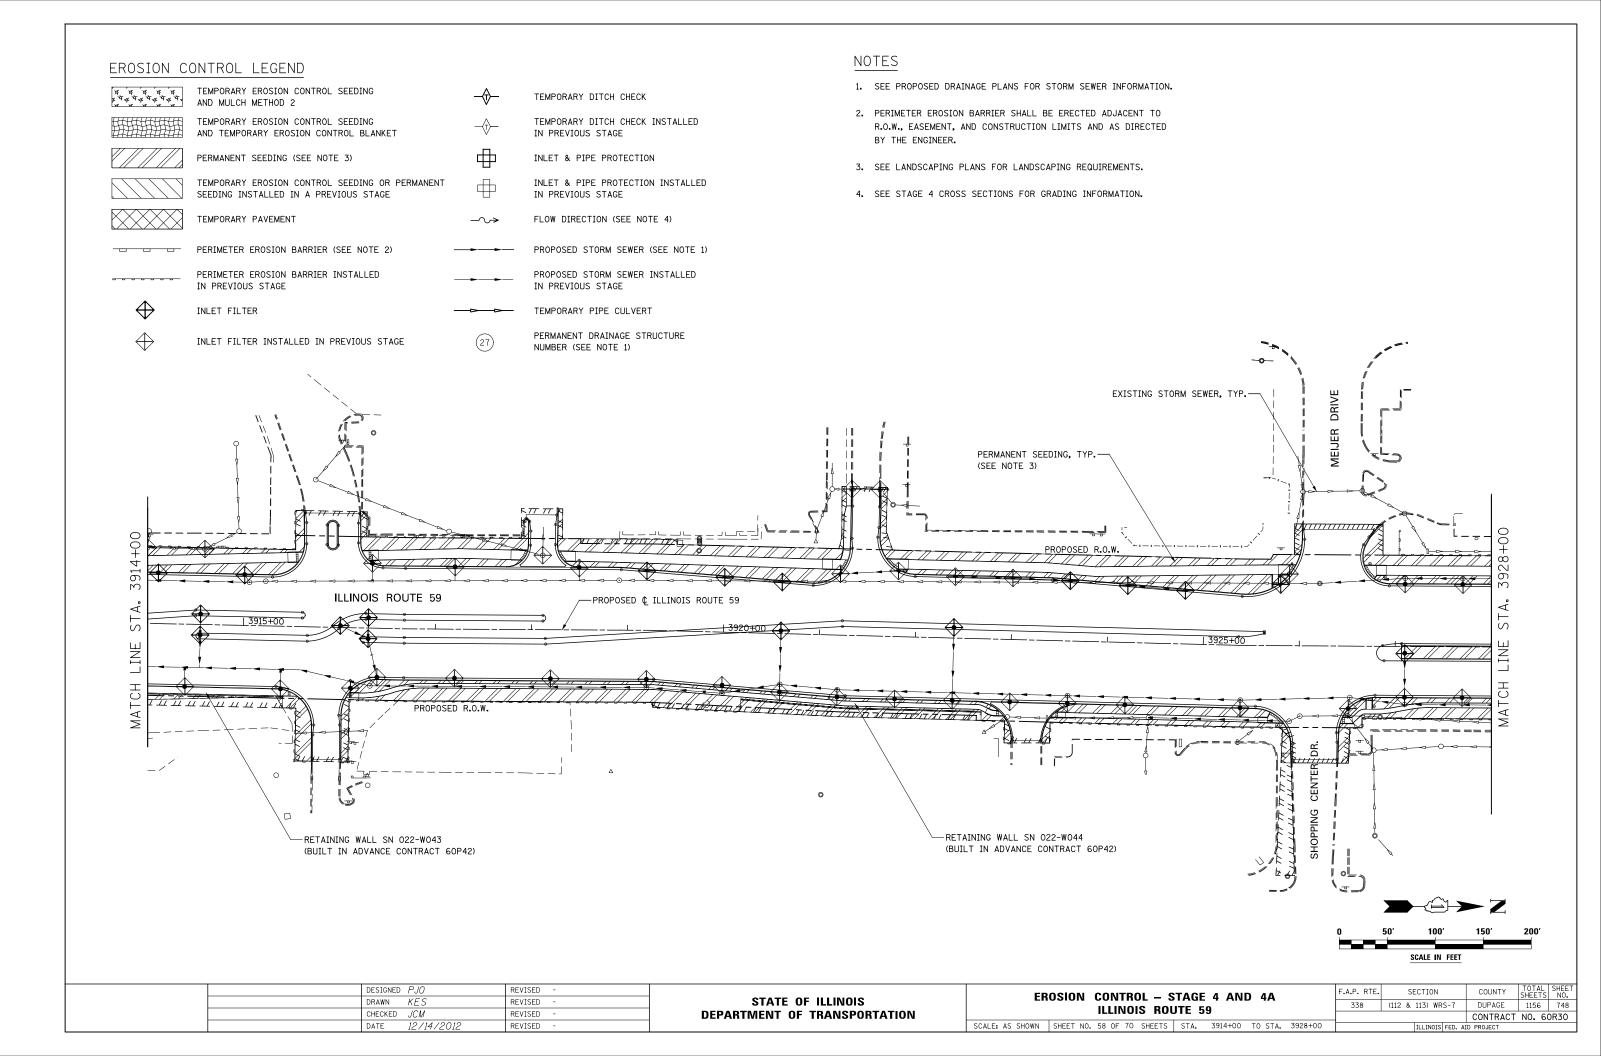

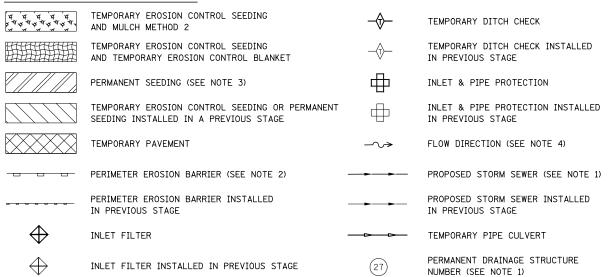

#### NOTES

- 1. SEE PROPOSED DRAINAGE PLANS FOR STORM SEWER INFORMATION.
- PERIMETER EROSION BARRIER SHALL BE ERECTED ADJACENT TO R.O.W., EASEMENT, AND CONSTRUCTION LIMITS AND AS DIRECTED BY THE ENGINEER.
- 3. SEE LANDSCAPING PLANS FOR LANDSCAPING REQUIREMENTS.
- 4. SEE STAGE 4 CROSS SECTIONS FOR GRADING INFORMATION.

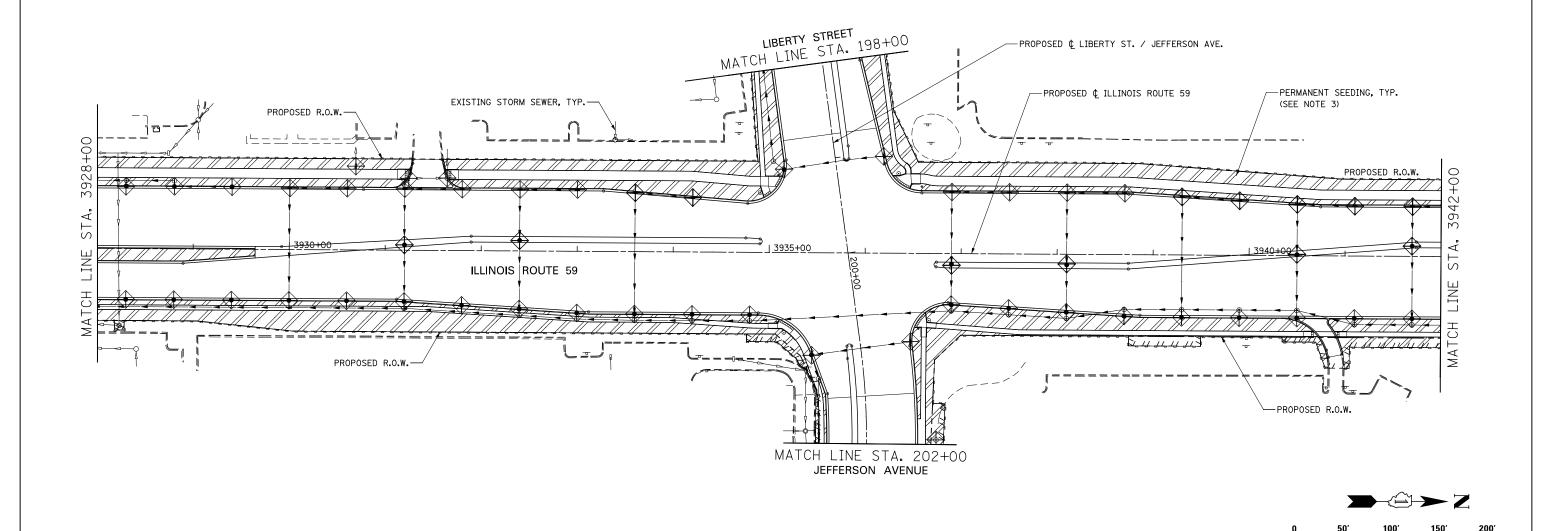


DESIGNED PJO	REVISED -		EROSION CONTROL – STAGE 4 AND 4A	F.A.P. RTE.	SECTION	COUNTY	TOTAL SH SHEETS	ΞΕΤ 10.
DRAWN KES	REVISED -	STATE OF ILLINOIS	ILLINOIS ROUTE 59	338	(112 & 113) WRS-7	DUPAGE	1156	49
CHECKED JCM	REVISED -	DEPARTMENT OF TRANSPORTATION	ILLINOIS NOUTE 39			CONTRAC	T NO. 60R	ō
DATE 12/14/2012	REVISED -		SCALE: AS SHOWN SHEET NO. 59 OF 70 SHEETS STA. 3928+00 TO STA. 3942+00		ILLINOIS FED. AI	D PROJECT		

SCALE IN FEET

#### EROSION CONTROL LEGEND TEMPORARY EROSION CONTROL SEEDING TEMPORARY DITCH CHECK AND MULCH METHOD 2 TEMPORARY EROSION CONTROL SEEDING TEMPORARY DITCH CHECK INSTALLED AND TEMPORARY EROSION CONTROL BLANKET IN PREVIOUS STAGE PERMANENT SEEDING (SEE NOTE 3) INLET & PIPE PROTECTION TEMPORARY EROSION CONTROL SEEDING OR PERMANENT INLET & PIPE PROTECTION INSTALLED SEEDING INSTALLED IN A PREVIOUS STAGE IN PREVIOUS STAGE TEMPORARY PAVEMENT FLOW DIRECTION (SEE NOTE 4) PERIMETER EROSION BARRIER (SEE NOTE 2) PROPOSED STORM SEWER (SEE NOTE 1) PERIMETER EROSION BARRIER INSTALLED PROPOSED STORM SEWER INSTALLED IN PREVIOUS STAGE IN PREVIOUS STAGE INLET FILTER TEMPORARY PIPE CULVERT PERMANENT DRAINAGE STRUCTURE INLET FILTER INSTALLED IN PREVIOUS STAGE NUMBER (SEE NOTE 1)


## NOTES

- 1. SEE PROPOSED DRAINAGE PLANS FOR STORM SEWER INFORMATION.
- PERIMETER EROSION BARRIER SHALL BE ERECTED ADJACENT TO R.O.W., EASEMENT, AND CONSTRUCTION LIMITS AND AS DIRECTED BY THE ENGINEER.
- 3. SEE LANDSCAPING PLANS FOR LANDSCAPING REQUIREMENTS.
- 4. SEE STAGE 4 CROSS SECTIONS FOR GRADING INFORMATION.

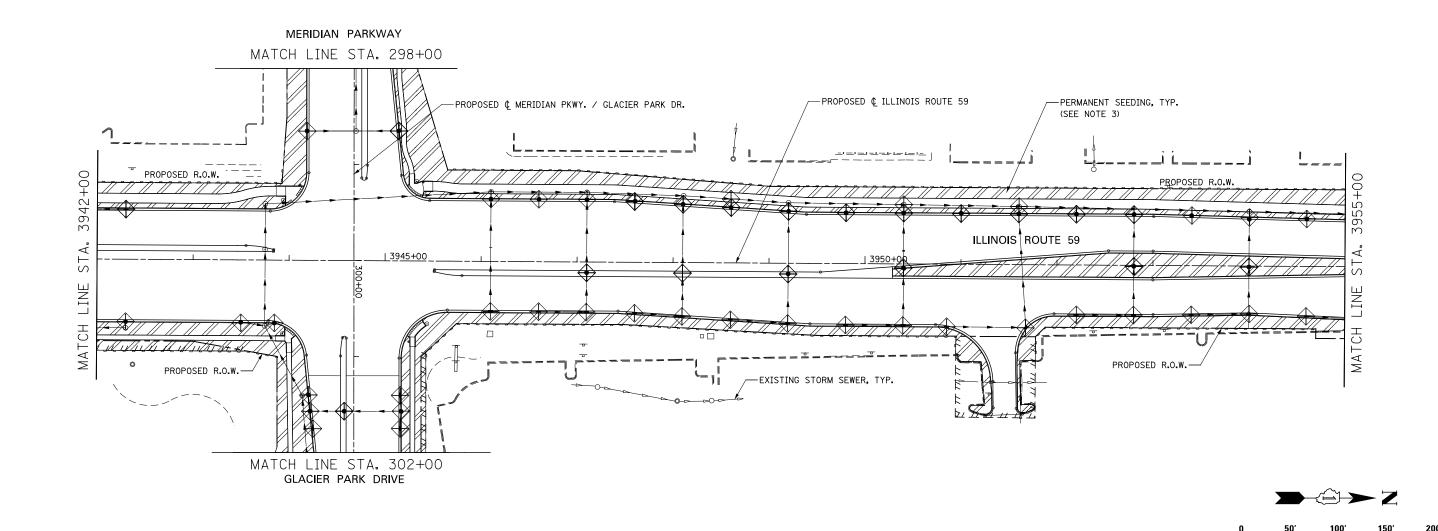

	DESIGNED PJO	REVISED -		EROSION CONTROL – STAGE 4 AND 4A	F.A.P. RTE.	SECTION	COUNTY	TOTAL SHEE	1
_	DRAWN KES	REVISED -	STATE OF ILLINOIS	ILLINOIS ROUTE 59	338	(112 & 113) WRS-7	DUPAGE	1156 750	1
	CHECKED <i>JCM</i>	REVISED -	DEPARTMENT OF TRANSPORTATION	12211313 113312 33			CONTRAC	T NO. 60R30	1
	DATE 12/14/2012	REVISED -		SCALE: AS SHOWN   SHEET NO. 60 OF 70 SHEETS   STA. 3942+00 TO STA. 3955+00		ILLINOIS FED. AI	D PROJECT		1

SCALE IN FEET

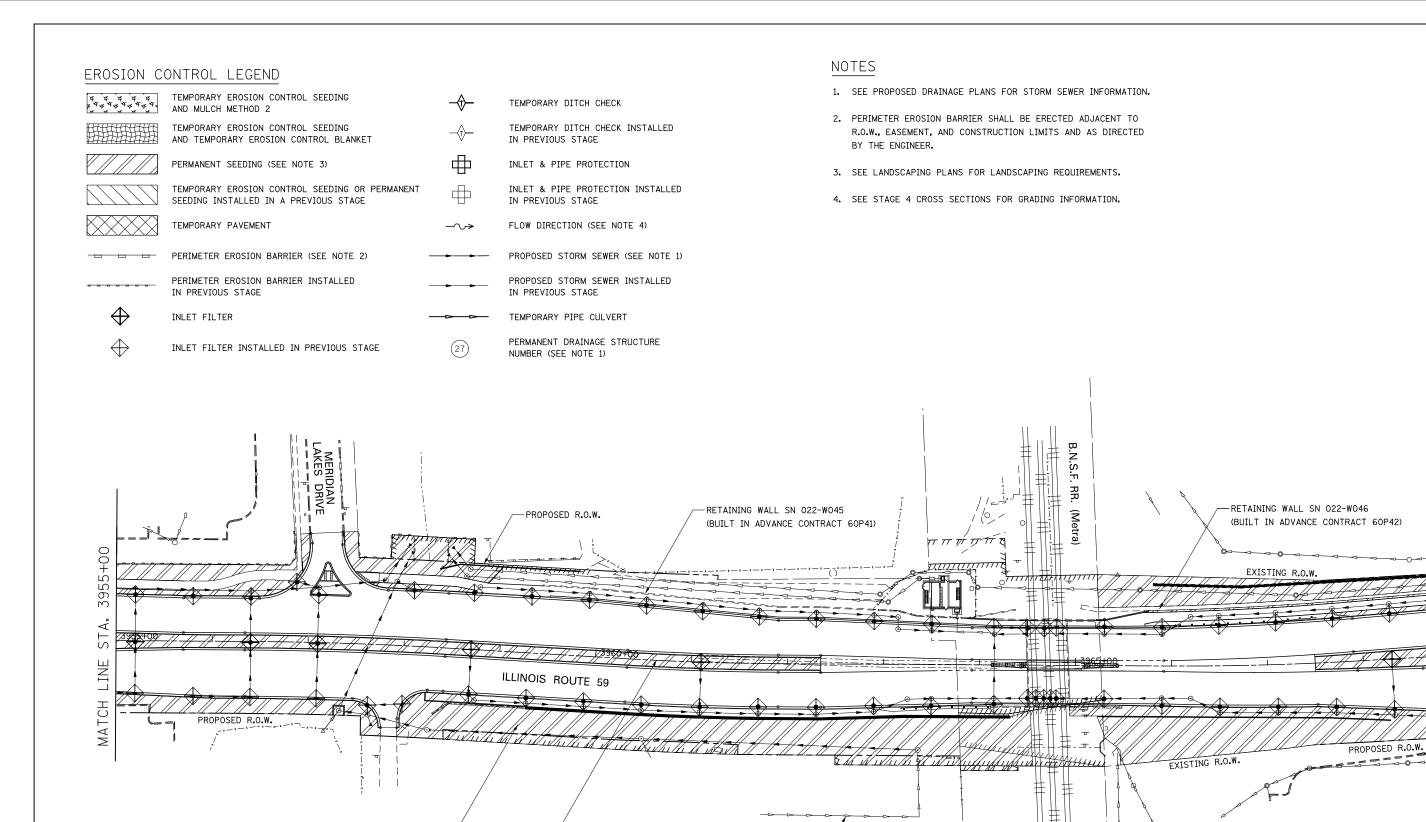

PERMANENT SEEDING, TYP.

PROPOSED & ILLINOIS ROUTE 59-

(SEE NOTE 3)

DESIGNED PJO REVISED F.A.P. RTE. SECTION COUNTY **EROSION CONTROL - STAGE 4 AND 4A** STATE OF ILLINOIS DRAWN KES REVISED 338 (112 & 113) WRS-7 DUPAGE 1156 751 **ILLINOIS ROUTE 59** CHECKED JCM REVISED **DEPARTMENT OF TRANSPORTATION** CONTRACT NO. 60R30 12/14/201 SCALE: AS SHOWN SHEET NO. 61 OF 70 SHEETS STA. 3955+00 TO STA. 3969+00 DATE REVISED

SCALE IN FEET

EXISTING STORM SEWER, TYP.-

#### EROSION CONTROL LEGEND TEMPORARY EROSION CONTROL SEEDING TEMPORARY DITCH CHECK AND MULCH METHOD 2 TEMPORARY EROSION CONTROL SEEDING TEMPORARY DITCH CHECK INSTALLED AND TEMPORARY EROSION CONTROL BLANKET IN PREVIOUS STAGE PERMANENT SEEDING (SEE NOTE 3) INLET & PIPE PROTECTION TEMPORARY EROSION CONTROL SEEDING OR PERMANENT INLET & PIPE PROTECTION INSTALLED SEEDING INSTALLED IN A PREVIOUS STAGE IN PREVIOUS STAGE TEMPORARY PAVEMENT FLOW DIRECTION (SEE NOTE 4) PERIMETER EROSION BARRIER (SEE NOTE 2) PROPOSED STORM SEWER (SEE NOTE 1) PERIMETER EROSION BARRIER INSTALLED PROPOSED STORM SEWER INSTALLED IN PREVIOUS STAGE IN PREVIOUS STAGE

CHECKED JCM

DATE

12/14/201

REVISED

REVISED

TEMPORARY PIPE CULVERT

PERMANENT DRAINAGE STRUCTURE

INLET FILTER

INLET FILTER INSTALLED IN PREVIOUS STAGE

#### NOTES

- 1. SEE PROPOSED DRAINAGE PLANS FOR STORM SEWER INFORMATION.
- 2. PERIMETER EROSION BARRIER SHALL BE ERECTED ADJACENT TO R.O.W., EASEMENT, AND CONSTRUCTION LIMITS AND AS DIRECTED BY THE ENGINEER.
- 3. SEE LANDSCAPING PLANS FOR LANDSCAPING REQUIREMENTS.

338

**ILLINOIS ROUTE 59** 


SCALE: AS SHOWN SHEET NO. 62 OF 70 SHEETS STA. 3969+00 TO STA. 3982+08

(112 & 113) WRS-7

DUPAGE 1156 752

CONTRACT NO. 60R30

4. SEE STAGE 4 CROSS SECTIONS FOR GRADING INFORMATION.

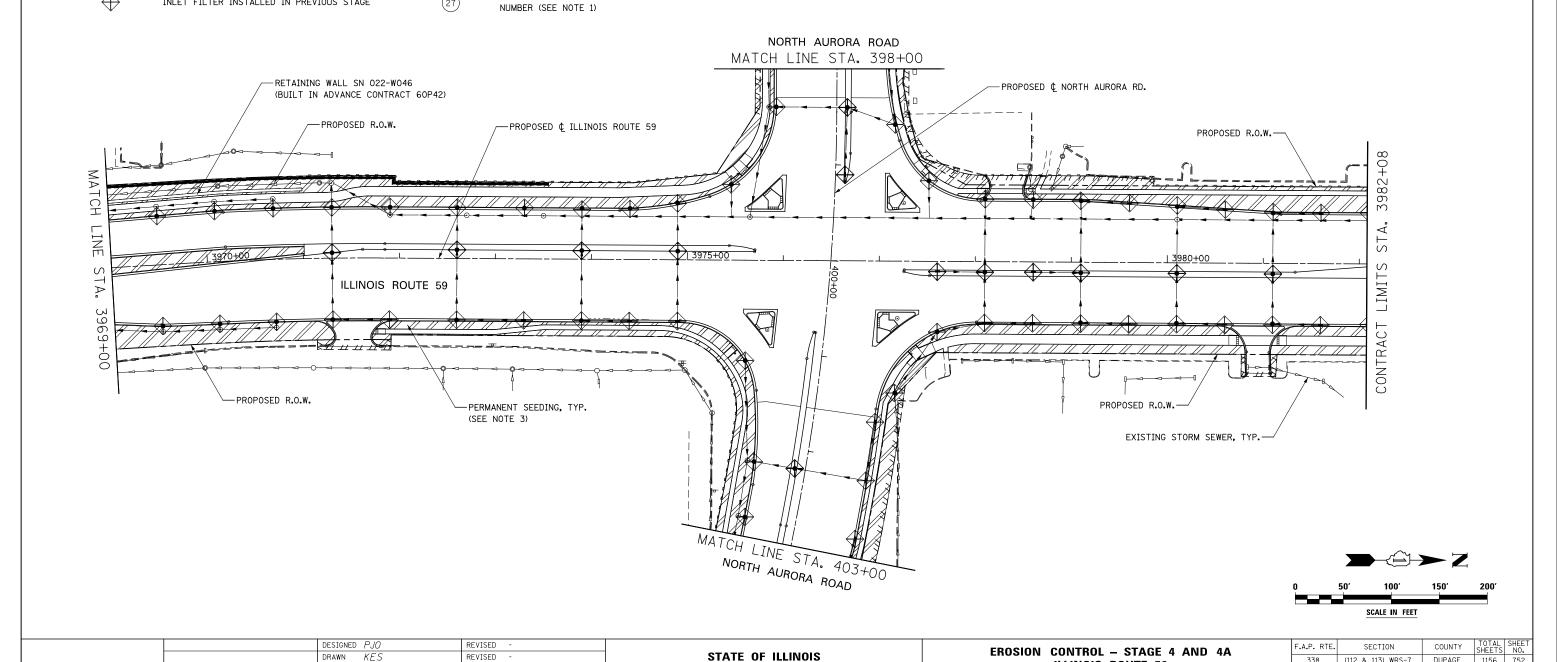

#### EROSION CONTROL LEGEND TEMPORARY EROSION CONTROL SEEDING AND MULCH METHOD 2 TEMPORARY DITCH CHECK TEMPORARY EROSION CONTROL SEEDING TEMPORARY DITCH CHECK INSTALLED AND TEMPORARY EROSION CONTROL BLANKET IN PREVIOUS STAGE PERMANENT SEEDING (SEE NOTE 3) INLET & PIPE PROTECTION TEMPORARY EROSION CONTROL SEEDING OR PERMANENT INLET & PIPE PROTECTION INSTALLED SEEDING INSTALLED IN A PREVIOUS STAGE IN PREVIOUS STAGE TEMPORARY PAVEMENT FLOW DIRECTION (SEE NOTE 4) PERIMETER EROSION BARRIER (SEE NOTE 2) PROPOSED STORM SEWER (SEE NOTE 1) PROPOSED STORM SEWER INSTALLED PERIMETER EROSION BARRIER INSTALLED IN PREVIOUS STAGE IN PREVIOUS STAGE INLET FILTER TEMPORARY PIPE CULVERT

DRAWN KES

CHECKED JCM

12/14/201

DATE

REVISED

REVISED

REVISED

INLET FILTER INSTALLED IN PREVIOUS STAGE

PERMANENT DRAINAGE STRUCTURE

NUMBER (SEE NOTE 1)

#### NOTES

- 1. SEE PROPOSED DRAINAGE PLANS FOR STORM SEWER INFORMATION.
- 2. PERIMETER EROSION BARRIER SHALL BE ERECTED ADJACENT TO R.O.W., EASEMENT, AND CONSTRUCTION LIMITS AND AS DIRECTED BY THE ENGINEER.
- 3. SEE LANDSCAPING PLANS FOR LANDSCAPING REQUIREMENTS.

(112 & 113) WRS-7

338


NEW YORK STREET


SCALE: AS SHOWN SHEET NO. 63 OF 70 SHEETS STA. 85+00 TO STA. 97+00

DUPAGE 1156 753

CONTRACT NO. 60R30

4. SEE STAGE 4 CROSS SECTIONS FOR GRADING INFORMATION.

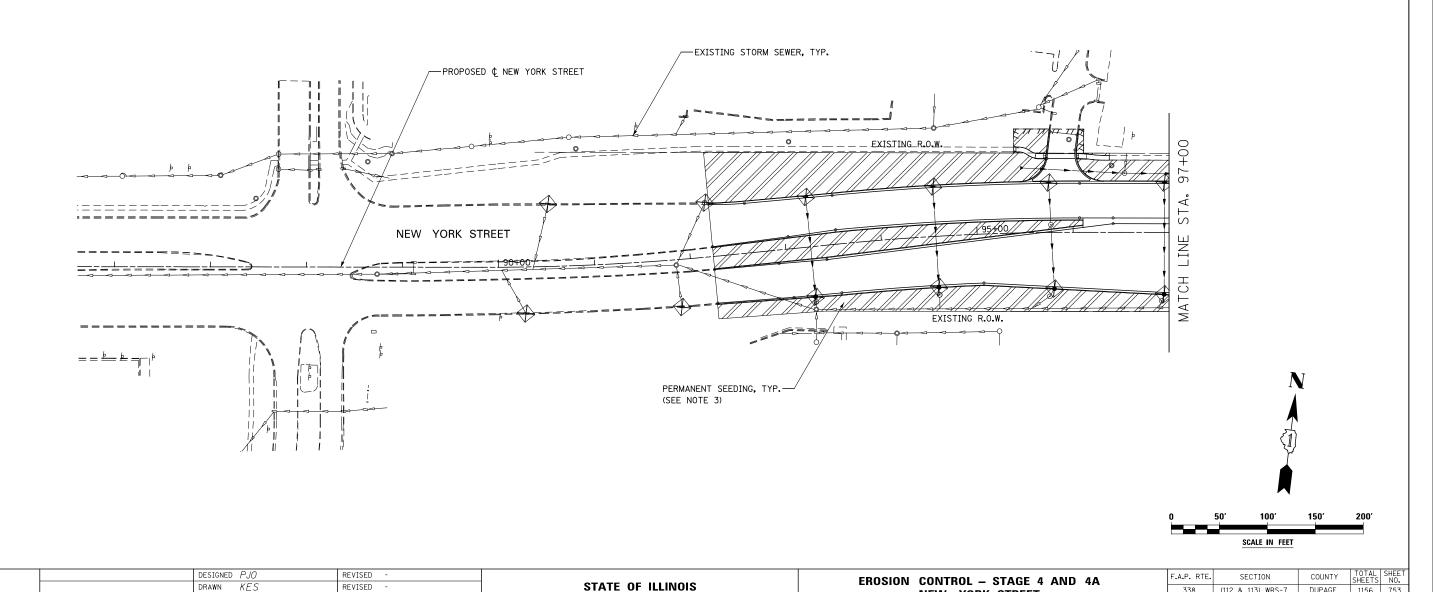

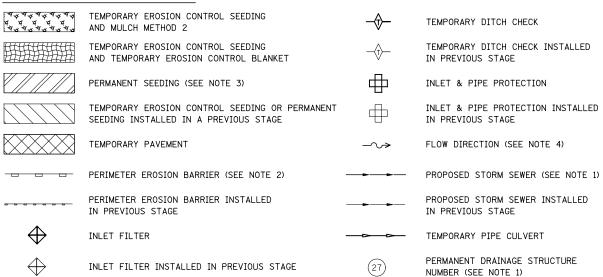

DRAWN KES

CHECKED JCM

DATE

12/14/201

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### NOTES

- 1. SEE PROPOSED DRAINAGE PLANS FOR STORM SEWER INFORMATION.
- 2. PERIMETER EROSION BARRIER SHALL BE ERECTED ADJACENT TO R.O.W., EASEMENT, AND CONSTRUCTION LIMITS AND AS DIRECTED BY THE ENGINEER.
- 3. SEE LANDSCAPING PLANS FOR LANDSCAPING REQUIREMENTS.

DUPAGE 1156 754

CONTRACT NO. 60R30


338


**AURORA AVENUE** 

SCALE: AS SHOWN SHEET NO. 64 OF 70 SHEETS STA. 104+00 TO STA. 116+00

(112 & 113) WRS-7

4. SEE STAGE 4 CROSS SECTIONS FOR GRADING INFORMATION.

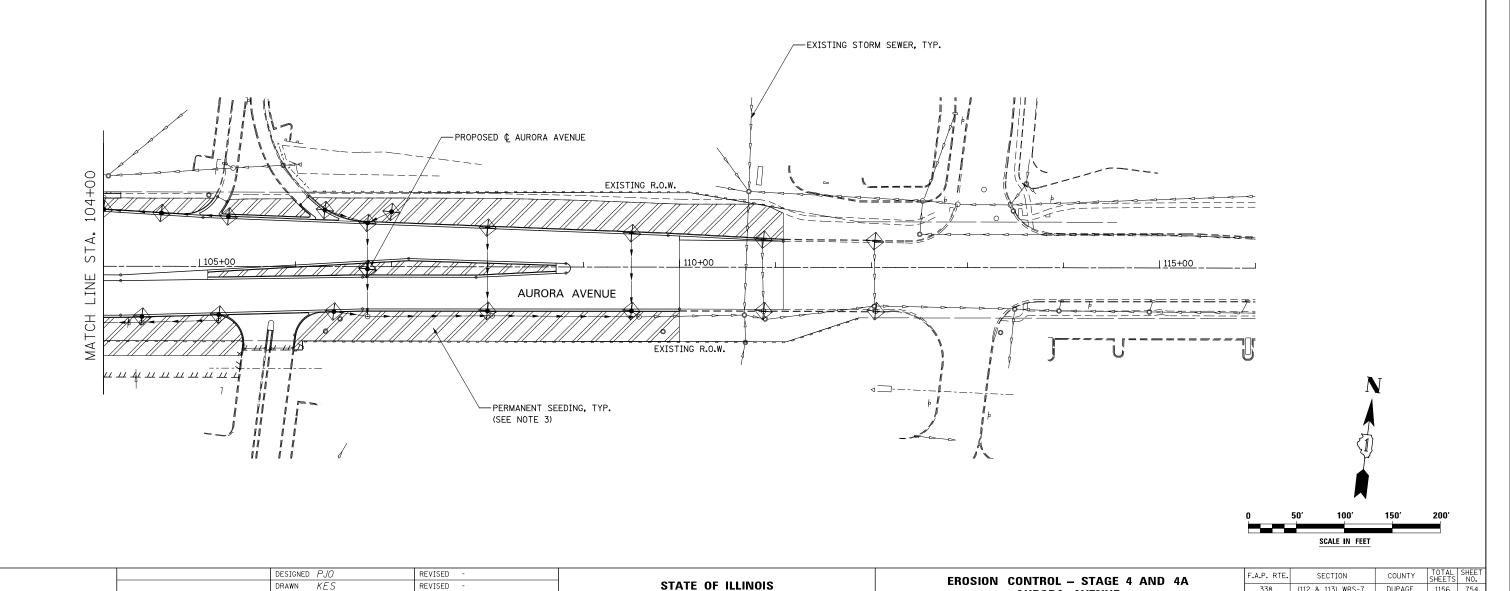

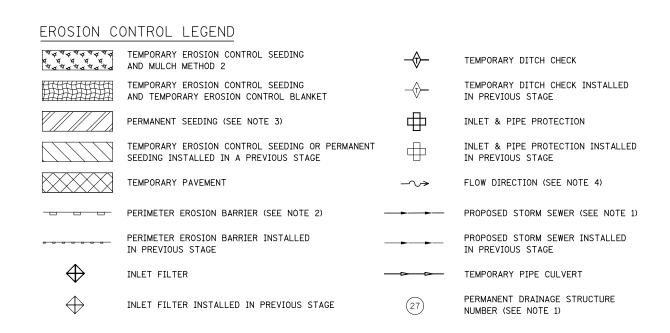

DRAWN KES

CHECKED JCM

DATE 12/14/201

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#### NOTES

- 1. SEE PROPOSED DRAINAGE PLANS FOR STORM SEWER INFORMATION.
- 2. PERIMETER EROSION BARRIER SHALL BE ERECTED ADJACENT TO R.O.W., EASEMENT, AND CONSTRUCTION LIMITS AND AS DIRECTED BY THE ENGINEER.
- 3. SEE LANDSCAPING PLANS FOR LANDSCAPING REQUIREMENTS.

(112 & 113) WRS-7 DUPAGE 1156 755


CONTRACT NO. 60R30

338


LIBERTY STREET

SCALE: AS SHOWN SHEET NO. 65 OF 70 SHEETS STA. 185+00 TO STA. 198+00

4. SEE STAGE 4 CROSS SECTIONS FOR GRADING INFORMATION.

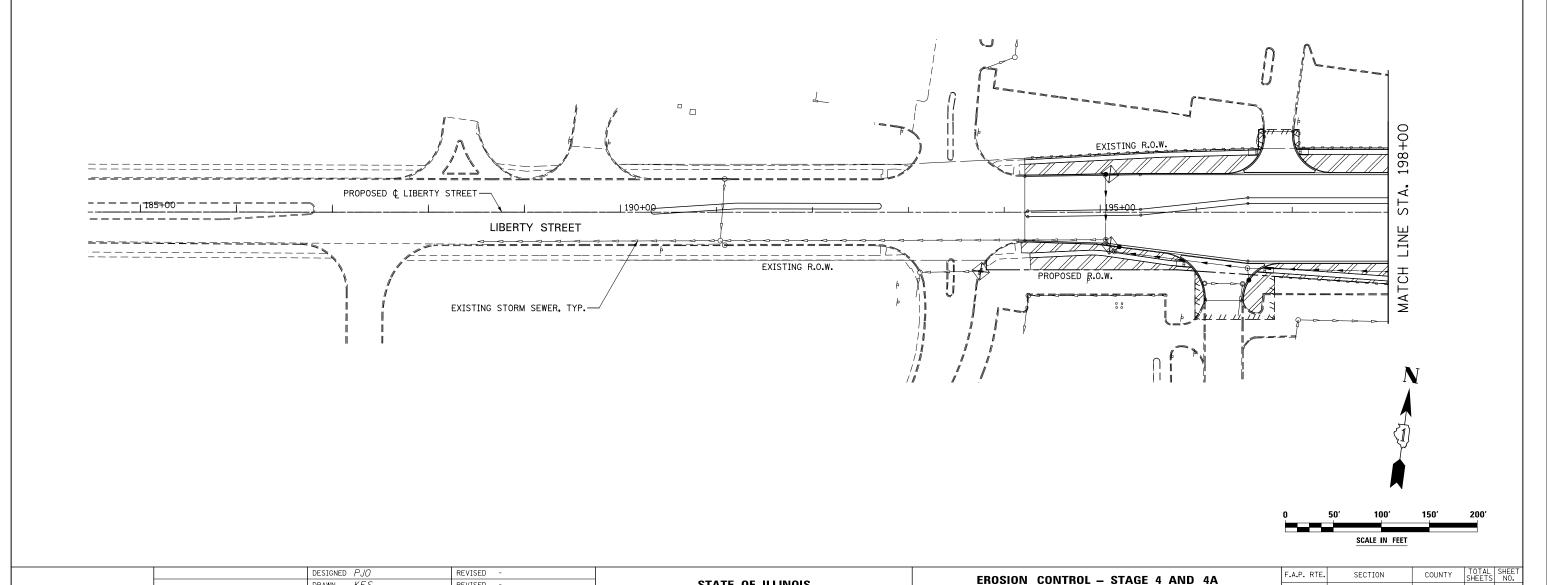


STATE OF ILLINOIS

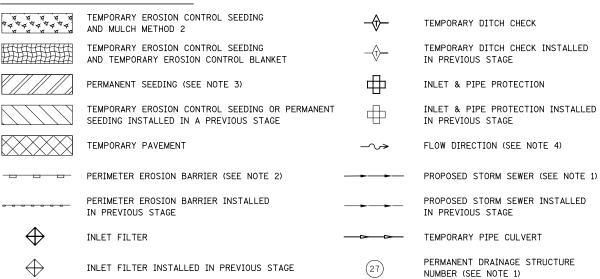


### NOTES

- 1. SEE PROPOSED DRAINAGE PLANS FOR STORM SEWER INFORMATION.
- PERIMETER EROSION BARRIER SHALL BE ERECTED ADJACENT TO R.O.W., EASEMENT, AND CONSTRUCTION LIMITS AND AS DIRECTED BY THE ENGINEER.
- 3. SEE LANDSCAPING PLANS FOR LANDSCAPING REQUIREMENTS.
- 4. SEE STAGE 4 CROSS SECTIONS FOR GRADING INFORMATION.

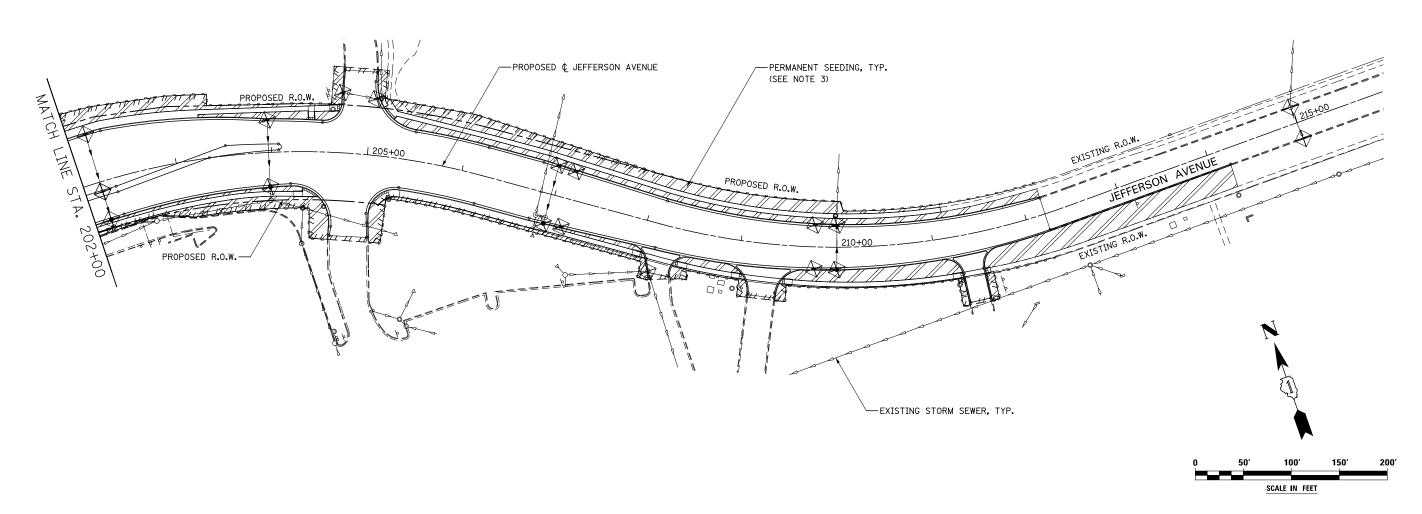

DESIGNED PJO	REVISED -		EROSION CONTROL – STAGE 4 AND 4A	F.A.P. RTE.	SECTION	COUNTY	TOTAL S'	NO.
DRAWN KES	REVISED -	STATE OF ILLINOIS	JEFFERSON AVENUE	338	(112 & 113) WRS-7	DUPAGE	1156	/56
CHECKED JCM	REVISED -	DEPARTMENT OF TRANSPORTATION				CONTRACT	T NO. 60R	
DATE 12/14/2012	REVISED -		SCALE: AS SHOWN   SHEET NO. 66 OF 70 SHEETS   STA. 202+00 TO STA. 216+00		ILLINOIS FED. AI	D PROJECT		

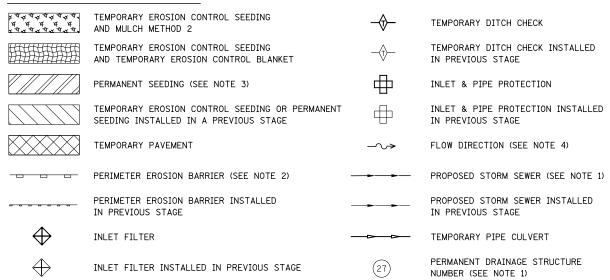

DRAWN KES

CHECKED JCM

DATE

12/14/201

REVISED

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REVISED

### NOTES

- 1. SEE PROPOSED DRAINAGE PLANS FOR STORM SEWER INFORMATION.
- 2. PERIMETER EROSION BARRIER SHALL BE ERECTED ADJACENT TO R.O.W., EASEMENT, AND CONSTRUCTION LIMITS AND AS DIRECTED BY THE ENGINEER.
- 3. SEE LANDSCAPING PLANS FOR LANDSCAPING REQUIREMENTS.
- 4. SEE STAGE 4 CROSS SECTIONS FOR GRADING INFORMATION.

**EROSION CONTROL - STAGE 4 AND 4A** 

**MERIDIAN PARKWAY** 


SCALE: AS SHOWN SHEET NO. 67 OF 70 SHEETS STA. 288+00 TO STA. 298+00

338


(112 & 113) WRS-7

DUPAGE 1156 757

CONTRACT NO. 60R30

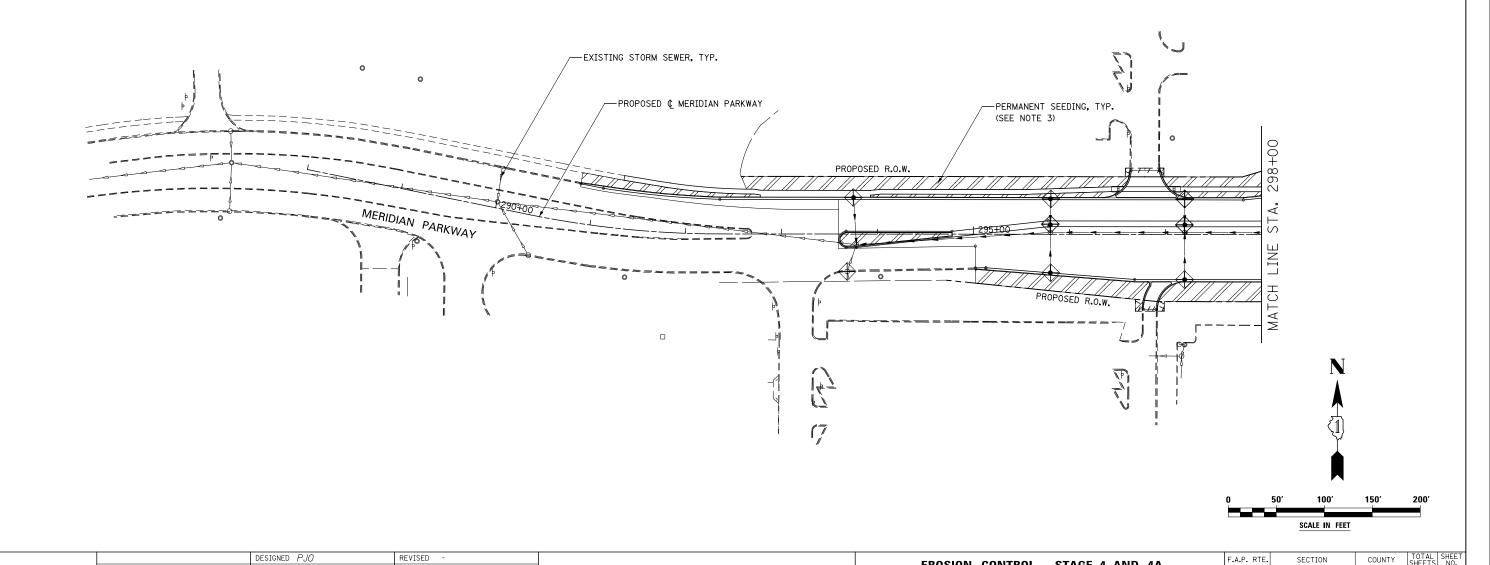



STATE OF ILLINOIS

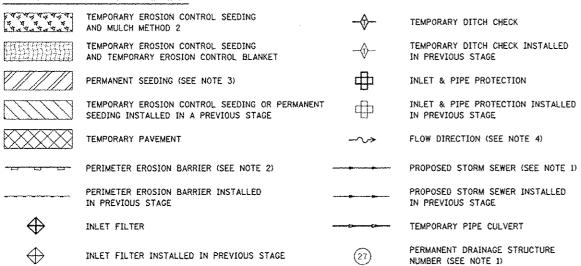


#### NOTES

- 1. SEE PROPOSED DRAINAGE PLANS FOR STORM SEWER INFORMATION.
- PERIMETER EROSION BARRIER SHALL BE ERECTED ADJACENT TO R.O.W., EASEMENT, AND CONSTRUCTION LIMITS AND AS DIRECTED BY THE ENGINEER.
- 3. SEE LANDSCAPING PLANS FOR LANDSCAPING REQUIREMENTS.
- 4. SEE STAGE 4 CROSS SECTIONS FOR GRADING INFORMATION.

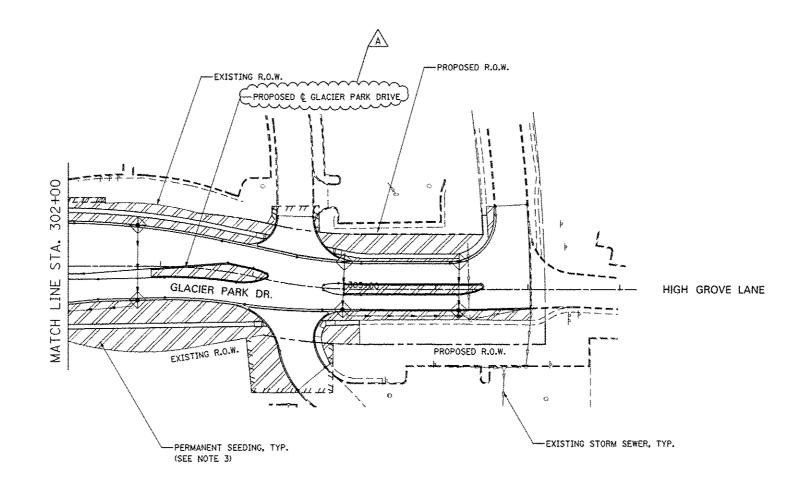

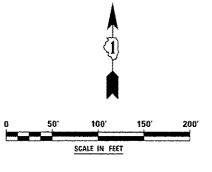

DESIGNED PJO	REVISED - ADDENDUM A 02/20/2013		EROSION CONTROL – STAGE 4 AND 4A	F.A.P. RTE. SECTION	COUNTY TOTAL SHEET
DRAWN KES	REVISED -	STATE OF ILLINOIS	GLACIER PARK DRIVE	338 (112 & 113) WRS-7	DUPAGE 1156 758
CHECKED JCM	REVISED -	DEPARTMENT OF TRANSPORTATION	ULACIEN FARR UNIVE	1	CONTRACT NO. 60R30
DATE 12/14/2012	REVISED -		SCALE: AS SHOWN SHEET NO. 68 OF 70 SHEETS STA. 302+00 TO STA. 308+00	ILLINOIS FEG. A	VID PROJECT

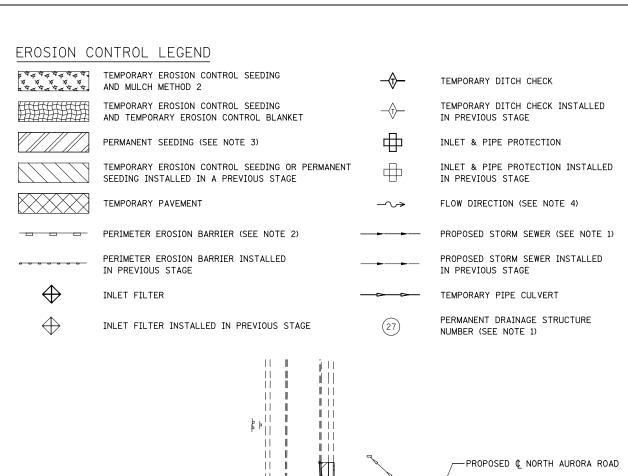

DESIGNED PJO

DRAWN KES

CHECKED JCM

DATE

12/14/201

REVISED

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REVISED

## NOTES

- 1. SEE PROPOSED DRAINAGE PLANS FOR STORM SEWER INFORMATION.
- PERIMETER EROSION BARRIER SHALL BE ERECTED ADJACENT TO R.O.W., EASEMENT, AND CONSTRUCTION LIMITS AND AS DIRECTED BY THE ENGINEER.
- 3. SEE LANDSCAPING PLANS FOR LANDSCAPING REQUIREMENTS.

F.A.P. RTE.

338

**EROSION CONTROL - STAGE 4 AND 4A** 

NORTH AURORA ROAD

SCALE: AS SHOWN SHEET NO. 69 OF 70 SHEETS STA. 384+00 TO STA. 398+00

SECTION


(112 & 113) WRS-7

COUNTY


DUPAGE 1156 759

CONTRACT NO. 60R30

4. SEE STAGE 4 CROSS SECTIONS FOR GRADING INFORMATION.

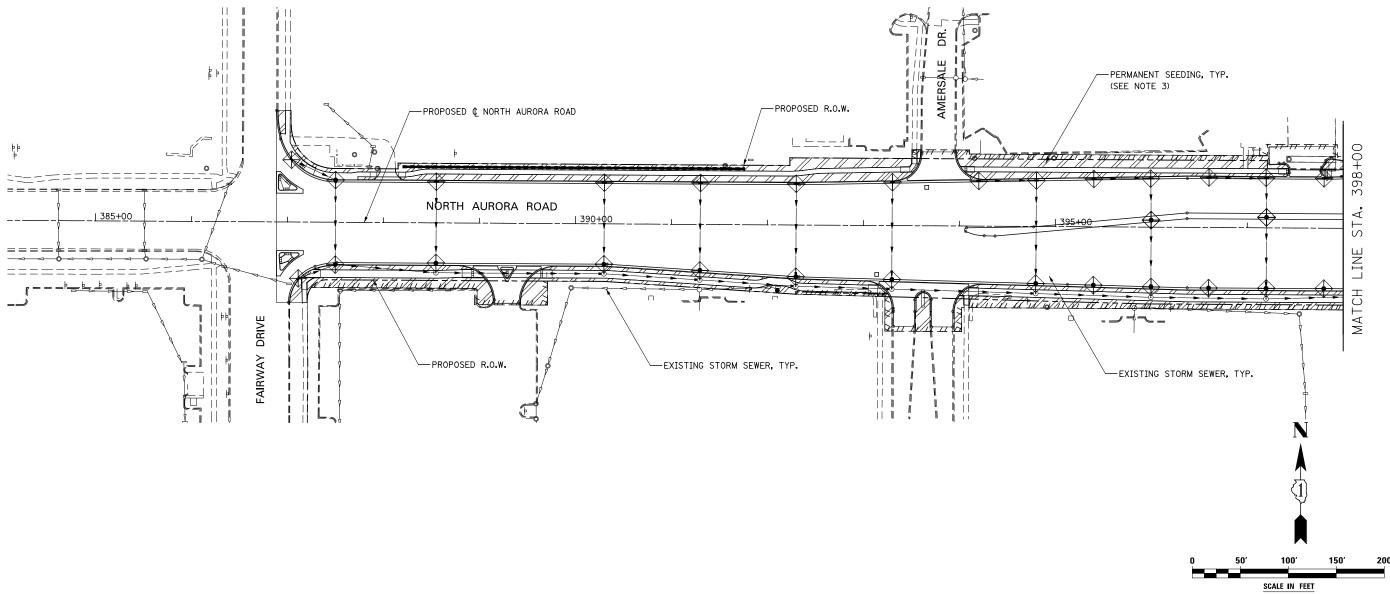

STATE OF ILLINOIS

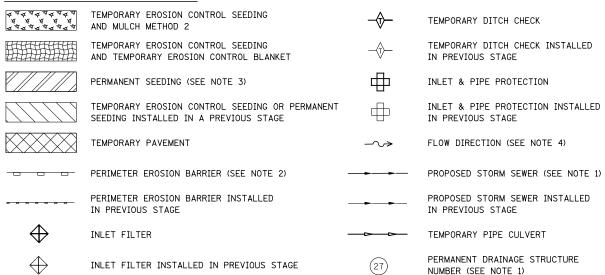

DRAWN KES

CHECKED JCM

12/14/201

DATE

REVISED

REVISED

REVISED

#### NOTES

- 1. SEE PROPOSED DRAINAGE PLANS FOR STORM SEWER INFORMATION.
- PERIMETER EROSION BARRIER SHALL BE ERECTED ADJACENT TO R.O.W., EASEMENT, AND CONSTRUCTION LIMITS AND AS DIRECTED BY THE ENGINEER.
- 3. SEE LANDSCAPING PLANS FOR LANDSCAPING REQUIREMENTS.

DUPAGE 1156 760

CONTRACT NO. 60R30


338

NORTH AURORA ROAD

SCALE: AS SHOWN SHEET NO. 70 OF 70 SHEETS STA. 403+00 TO STA. 416+00

(112 & 113) WRS-7

4. SEE STAGE 4 CROSS SECTIONS FOR GRADING INFORMATION.

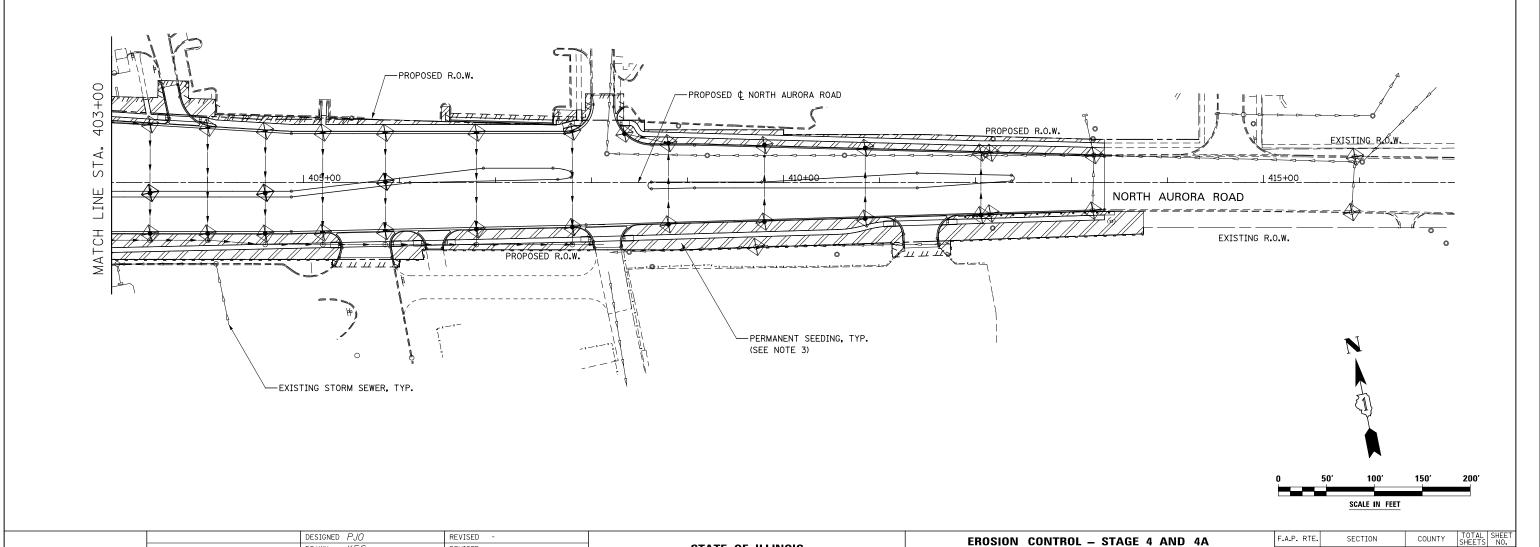


STATE OF ILLINOIS


	IL 59 LANDSCAPE SCH		UNIT OF				ΡΙΔΝ	SHEE	T NUMB	₹FR		
BOTANICAL NAME	COMMON NAME	SIZE	MEASURE	TOTAL	1	2	3	4	5	6	7	8
SHADE TREES												
ACER MIYABEI 'MORTON'	STATE STREET MIYABE MAPLE	2" CAL / B&B	EACH	20		4		4			12	
AESCULUS ARNOLDIANA 'AUTUMN SPLENDOR'	AUTUMN SPLENDOR HORSECHESTNUT	2" CAL / B&B	EACH	7								7
AESCULUS OCTANDRA	YELLOW SWEET BUCKEYE	2" CAL / B&B	EACH	3				3				
CARPINUS CAROLINIANA	AMERICAN HORNBEAM	6' HT / B&B	EACH	4								4
CELTIS OCCIDENTALIS	COMMON HACKBERRY	2" CAL / B&B	EACH	8		5	3					
CLADRASTIS LUTEA	AMERICAN YELLOWWOOD	2" CAL / B&B	EACH	1						1		
GINKGO BILOBA 'AUTUMN GOLD'	AUTUMN GOLD GINKGO	2" CAL / B&B	EACH	24		1			20		3	
GLEDITSIA TRIACANTHOS VAR. INERMIS 'SKYCOLE'	SKYLINE THORNLESS HONEYLOCUST	2" CAL / B&B	EACH	36	19		12				5	
GYMNOCLAUS DIOICUS	KENTUCKY COFFEETREE	2-1/2" CAL / B&B	EACH	27		4	13		5		5	
GYMNOCLAUS DIOICUS	KENTUCKY COFFEETREE (MULTI-STEM)	8' HT / B&B	EACH	16			12	$\vdash$		4	-	
LARIX LARICINA	AMERICAN LARCH	2" CAL / B&B	EACH	6			6	$\vdash$	-		$\rightarrow$	
NYSSA SYLVATICA	BLACK TUPELO	2" CAL / B&B	EACH	2							$\rightarrow$	2
QUERCUS BICOLOR	SWAMP WHITE OAK	2" CAL / B&B	EACH	5		5			+		$\rightarrow$	
QUERCUS BICOLOR (ms)	SWAMP WHITE OAK SWAMP WHITE OAK (MULTI-STEM)	7' HT/ B&B	EACH	9				5	+	1	$\rightarrow$	3
							5		$\overline{}$			
QUERCUS MACROCARPA	BUR OAK	2" CAL / B&B	EACH	15		4	5	<u> </u>	$\vdash$	3	3	
QUERCUS MUEHLENBERGII	CHINKAPIN OAK	2" CAL / B&B	EACH	3		3		<u> </u>				
QUERCUS SCHUETTII	SWAMP BUR OAK	2" CAL / B&B	EACH	16				8	8		$\rightarrow$	
ROBINIA PSEUDOACACIA 'BENJAMIN'	CHICAGO BLUES BLACK LOCUST	2" CAL / B&B	EACH	10			10	<u> </u>				
TAXODIUM DISTICHUM	BALD CYPRESS	2" CAL / B&B	EACH	17			5	5	+-+	$\longrightarrow$	7	
TILIA AMERICANA	AMERICAN LINDEN	2" CAL / B&B	EACH	3					3			
TILIA CORDATA 'GREENSPIRE'	GREENSPIRE LITTLE LEAF LINDEN	2" CAL / B&B	EACH	2							2	
ULMUS AMERICANA 'PRINCETON'	PRINCETON AMERICAN ELM	2" CAL / B&B	EACH	19		16		3	$\longrightarrow$			
ORNAMENTAL TREES									$\sqcup$			
AMELANCHIER GRANDIFLORA 'AUTUMN BRILLIANCE'	AUTUMN BRILLIANCE APPLE SERVICEBERRY (SHRUB FORM)	6' HT / B&B	EACH	4								4
CRATAEGUS CRUSGALLI INERMIS	THORNLESS COCKSPUR HAWTHORN	2" CAL / B&B	EACH	1	1							
CRATAEGUS CRUSGALLI INERMIS	THORNLESS COCKSPUR HAWTHORN (SHRUB FORM)	6' HT / B&B	EACH	23		9			14			
MALUS 'DONALD WYMAN'	DONALD WYMAN CRABAPPLE	2" CAL / B&B	EACH	12	6				i l	6		
MALUS 'INDIAN SUMMER'	INDIAN SUMMER CRABAPPLE (CLUMP FORM)	6' HT / B&B	EACH	16					8		8	
MALUS 'RED JEWEL'	RED JEWEL CRABAPPLE	2" CAL / B&B	EACH	17	7							10
MALUS 'RED PEACOCK'	RED PEACOCK CRABAPPLE	2" CAL / B&B	EACH	9		6						3
SYRINGA PEKINENSIS 'CHINA SNOW'	CHINA SNOW PEKING LILAC	2" CAL / B&B	EACH	8	8							
SYRINGA PEKINENSIS 'ZHING ZHIMING'	BEIJING GOLD PEKING LILAC	2" CAL / B&B	EACH	3	_							3
SYRINGA RETICULATA 'BAILANCE'	FIRST EDITION SNOWDANCE JAPANESE TREE LILAC	2" CAL / B&B	EACH	10							$\rightarrow$	10
SYRINGA RETICULATA 'IVORY SILK'	IVORY SILK JAPANESE TREE LILAC	2" CAL / B&B	EACH	22	8						$\rightarrow$	14
SYRINGA RETICULATA 'SUMMER SNOW'  EVERGREEN TREES	SUMMER SNOW JAPANESE TREE LILAC	2" CAL / B&B	EACH	5	- C	5						
	VANDEDWOLEIC DVDAMID LIMDED DINE	71 LIT / D 0 D	FACIL	F					-		$\rightarrow$	
PINUS FLEXILIS 'VANDERWOLF'S PYRAMID'	VANDERWOLF'S PYRAMID LIMBER PINE	7' HT / B&B	EACH	5								5
PINUS NIGRA	AUSTRIAN PINE	7' HT / B&B	EACH	4						4	$\longrightarrow$	
SHRUBS	ALITHMALMA OLO DI AOK OLIOKERERRY	OLUT / DAD	FAOU	67	07			<u> </u>	$\vdash$	$\longrightarrow$	$\longrightarrow$	
ARONIA MELANOCARPA 'AUTUMN MAGIC'	AUTUMN MAGIC BLACK CHOKEBERRY	2' HT / B&B	EACH	67	67		-	<u> </u>	<del></del>		$\rightarrow$	
ARONIA MELANOCARPA 'IROQUOIS BEAUTY'	IROQUOIS BEAUTY BLACK CHOKEBERRY	2' HT / CONT	EACH	110	30			<u> </u>	$\longrightarrow$		$\longrightarrow$	80
RHUS AROMATICA 'GROW-LOW'	GRO-LOW FRAGRANT SUMAC	18" WIDTH / CONT	EACH	18				<u>                                     </u>	$\vdash$	$\longrightarrow$	$\longrightarrow$	18
RHUS GLABRA	SMOOTH SUMAC	3' HT / CONT	EACH	460			460	<u> </u>	$\longrightarrow$		$\longrightarrow$	
VINES								<u> </u>				
PARTHENOCISSUS QUINQUEFOLIA 'ENGELMANNII'	ENGELMANNII VIRGINIA CREEPER	1 - GAL CONT	EACH	780			262	340	$\longrightarrow$			178
PERENNIAL PLANTS, GALLON POT								<u> </u>				
HEMEROCALLIS 'HAPPY RETURNS'	HAPPY RETURNS DAYLILY	1 - GAL CONT	UNIT	0.8								0.8
PERENNIAL PLANTS, GALLON POT												
NARCISSUS 'CARLTON'	CARLTON DAFFODIL	TOP SIZE	UNIT	2.4				$\perp$				2.4
LAWN												-
SODDING, SALT TOLERANT		N/A	SQ YD	54,076	6.196	11,332	8,947	3,202	9,332	4,243 2	1,484	6,340
SEEDING, CLASS 2A		N/A	ACRE	1.18	0.01	,	0.90		, <del>-</del>		0.01	
SEEDING, CLASS 4A		N/A	ACRE	0.22	5.51		0.22		$\overline{}$	<del></del>		2.52
MULCH PLACEMENT, 4" (MODIFIED)		N/A	SQ YD	62			0.22		$\overline{}$	-+	-+	62
TOPSOIL FURNISH + PLACE, 30"		N/A	SQ YD	6527	1073	2/12	2448	200	1960	-+	415	_02_
I OF SOIL FURINGH + FLACE, 30		IN/A	ן אע זע	0327	10/3	১4১	Z440	200	1900		410	

DES	GNED	PJ0	REVISED	-
DRA	/N	KES	REVISED	-
CHE	KED	JCM	REVISED	-
DAT	: .	12/14/2012	REVISED	-

	F.A.P. RTE.	SECTION			COUNTY TOTAL SH SHEETS N		
LANDSCAPE PLANS - SCHEDULE	338	(112 &	113) WR	S-7	DUPAGE	1156	76:
					CONTRACT	NO. 60	DR30
SCALE: AS SHOWN   SHEET NO. 1 OF 9 SHEETS   STA. TO STA.			ILLINOIS	FED. AII	PROJECT		

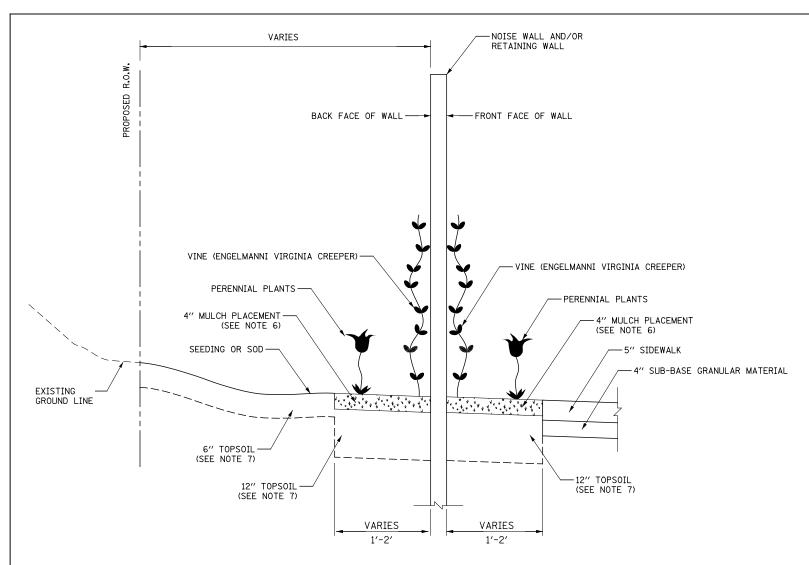

\* NOISE WALL / RETAINING WALL LANSCAPE DETAIL

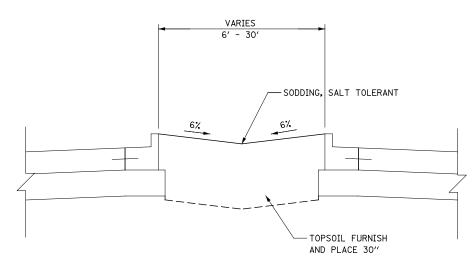

TYPICAL LANDSCAPED MEDIAN DETAIL

	DESIGNED	PJ0	REVISED	-
	DRAWN	KES	REVISED	-
	CHECKED	JCM	REVISED	-
	DATE	12/14/2012	REVISED	-


## STATE OF ILLINOIS DEPARTMENT OF TRANSPORTATION

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#### GENERAL LANDSCAPING NOTES:

- WEED CONTROL, PRE-EMERGENT GRANULAR HERBICIDE SHALL BE USED FOR ALL NEWLY INSTALLED PLANT MATERIAL, INLCUDING: TREES, SHRUBS, VINES, AND PERENNIAL BEDS.
- THE USE OF PHOSPHOROUS FERTILIZER NUTRIENTS SHALL BE OMITTED AS SPECIFIED IN SECTIONS 250 AND 252 OF THE STANDARD SPECIFICATIONS FOR SEEDING, CLASS 2A AND SODDING, SALT TOLERANT AREAS.
- 3. NO FERTILIZER NUTRIENTS SHALL BE USED ON SEEDING, CLASS 4A (MODIFIED) PER THE SPECIAL PROVISION.
- 4. THE ENGINEER WILL CONTACT FABIOLA QUIROZ OF THE ROADSIDE DEVELOPMENT UNIT AT (847) 705-4596, AT LEAST 7 DAYS PRIOR TO PLANTING FOR LAYOUT APPROVAL OF THE SEEDING, SODDING, TREES, SHRUBS, VINES AND PERENNIALS.
- 5. ALL EXISTING DRIVEWAY AND/OR ROADWAY PAVEMENT THAT IS TO BE REMOVED AND REPLACED WITH LANDSCAPING SHALL BE EXCAVATED TO ALLOW FOR THE PLACEMENT OF 30" OF TOPSOIL. THIS WORK SHALL BE PAID FOR AS TOPSOIL EXCAVATION AND PLACEMENT. ANY ADDITIONAL EXCAVATION REQUIRED FOR THE PLACEMENT OF THE 30" OF TOPSOIL SHALL BE CONSIDERED INCLUDED IN THE CONTRACT UNIT PRICE FOR TOPSOIL EXCAVATION AND PLACEMENT.
- 6. THE COST OF FURNISHING AND PLACING THE MULCH ALONG THE NOISEWALL/RETAINING WALL IS INCLUDED WITH THE PLANTINGS BEING INSTALLED.
- 7. TOPSOIL SHALL BE PAID FOR AS TOPSOIL EXCAVATION AND PLACEMENT.
- \*8. THE DETAIL IS NOT TYPICAL FOR ALL WALLS, REFER TO LANDSCAPE PLANS FOR PLACEMENT OF VINES, PERNNIAL PLANTS, AND MULCH ALONG NOISEWALLS AND RETAINING WALLS.




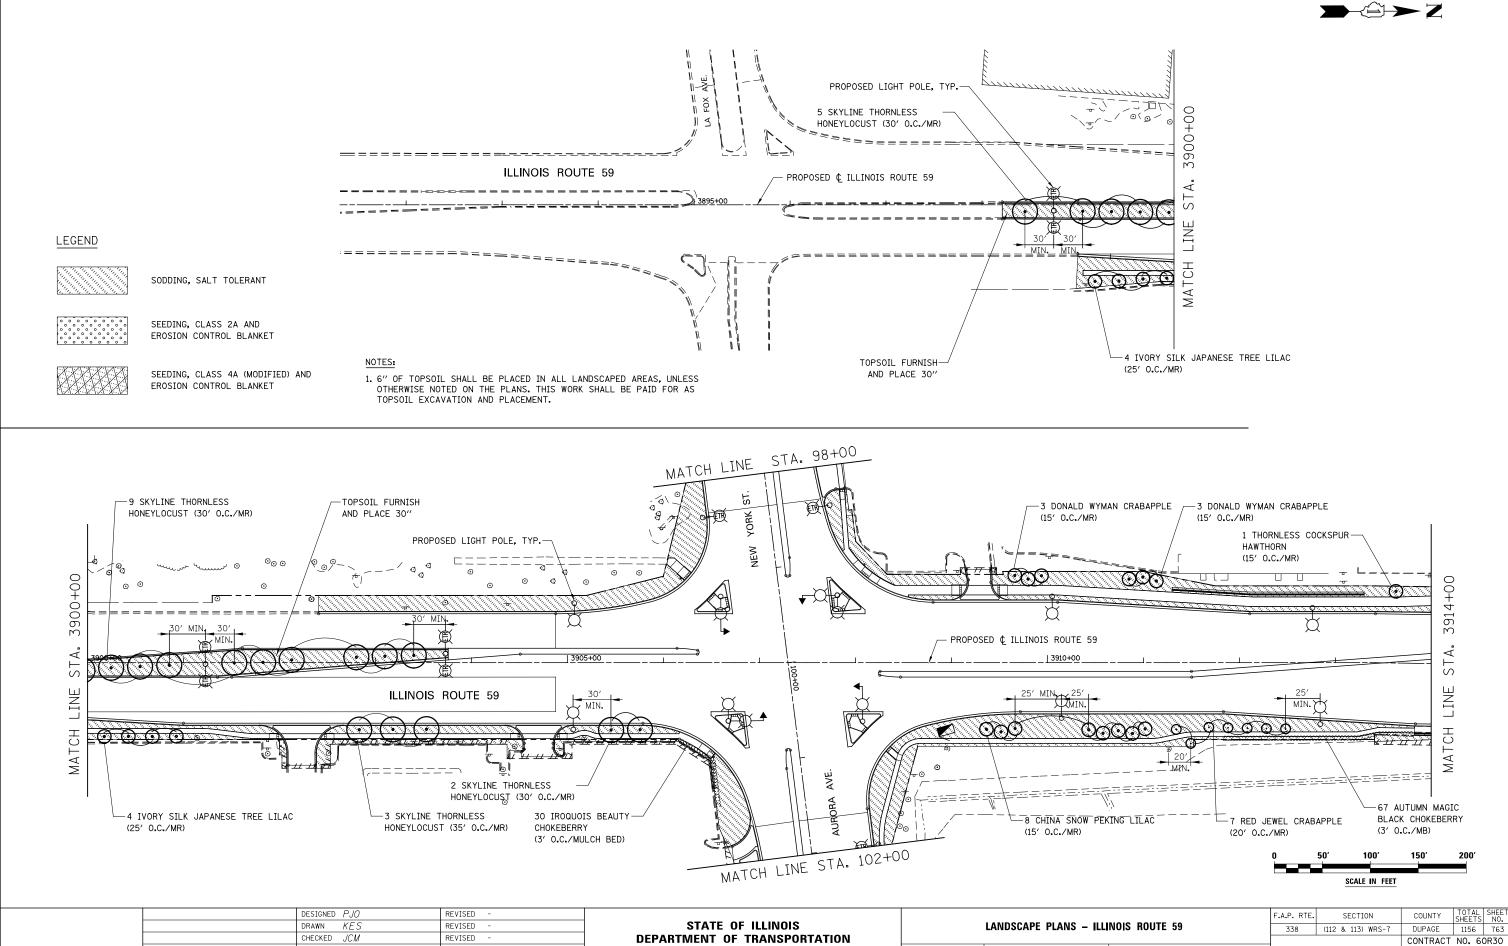



SCALE: AS SHOWN SHEET NO. 1 OF 8 SHEETS STA. 3892+00 TO STA. 3914+00

12/14/20.

REVISED

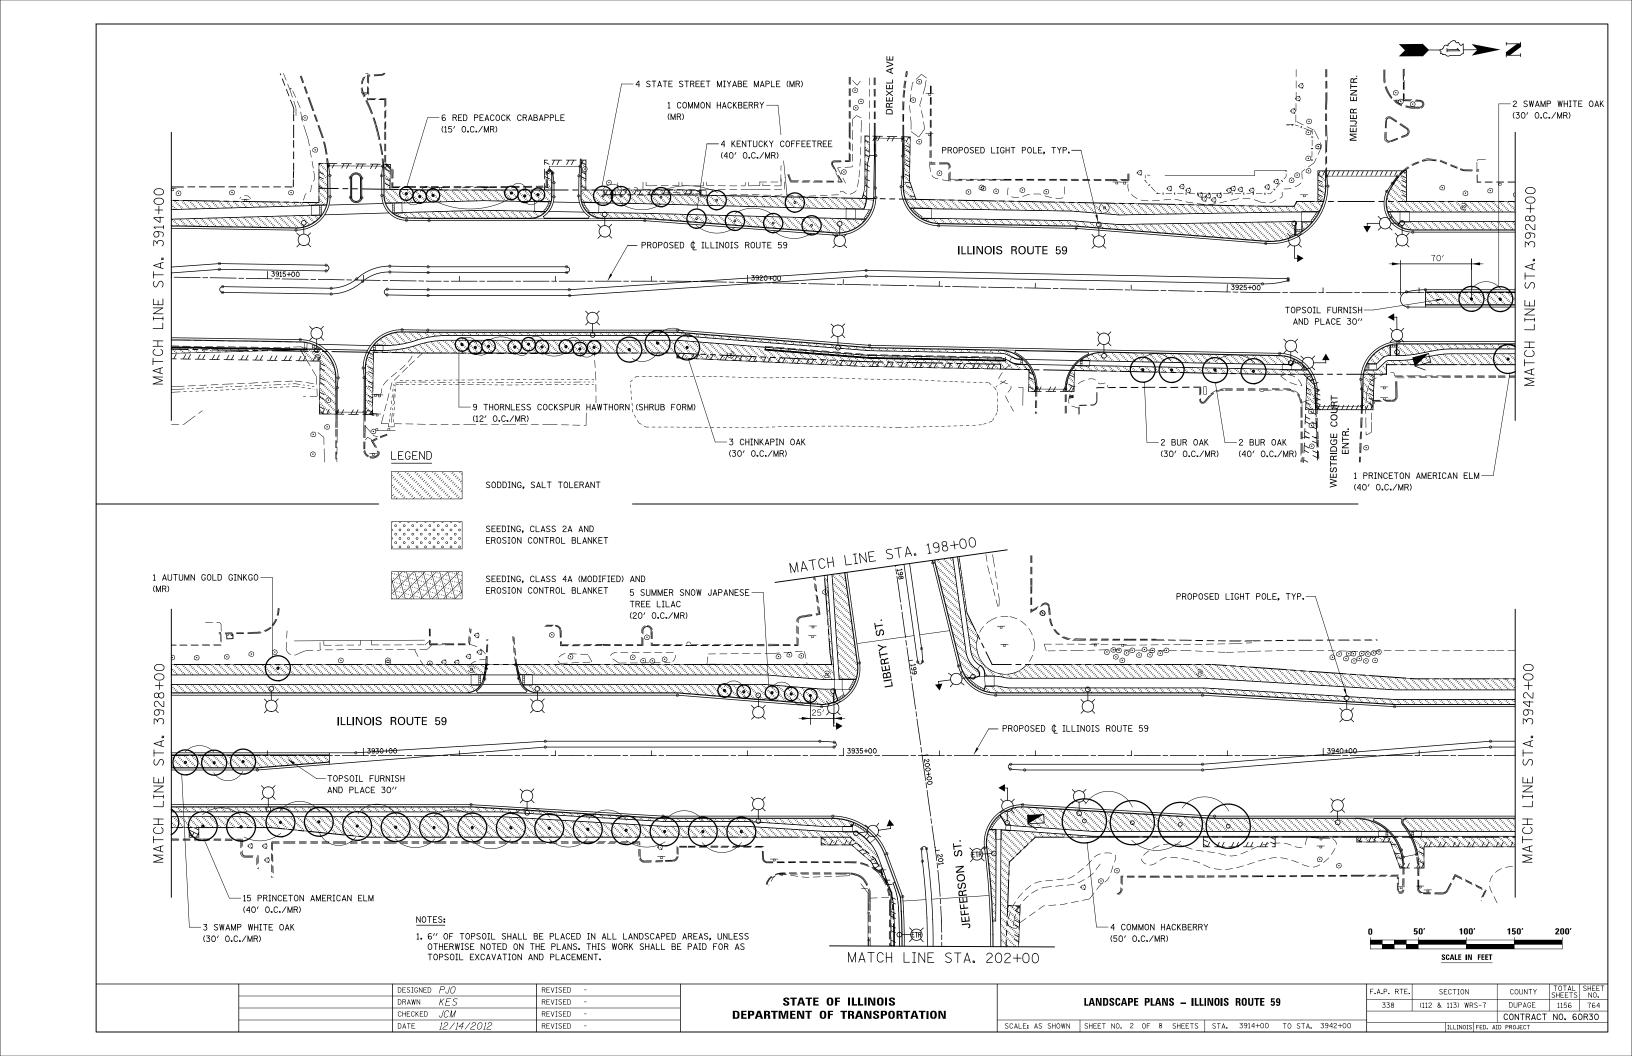

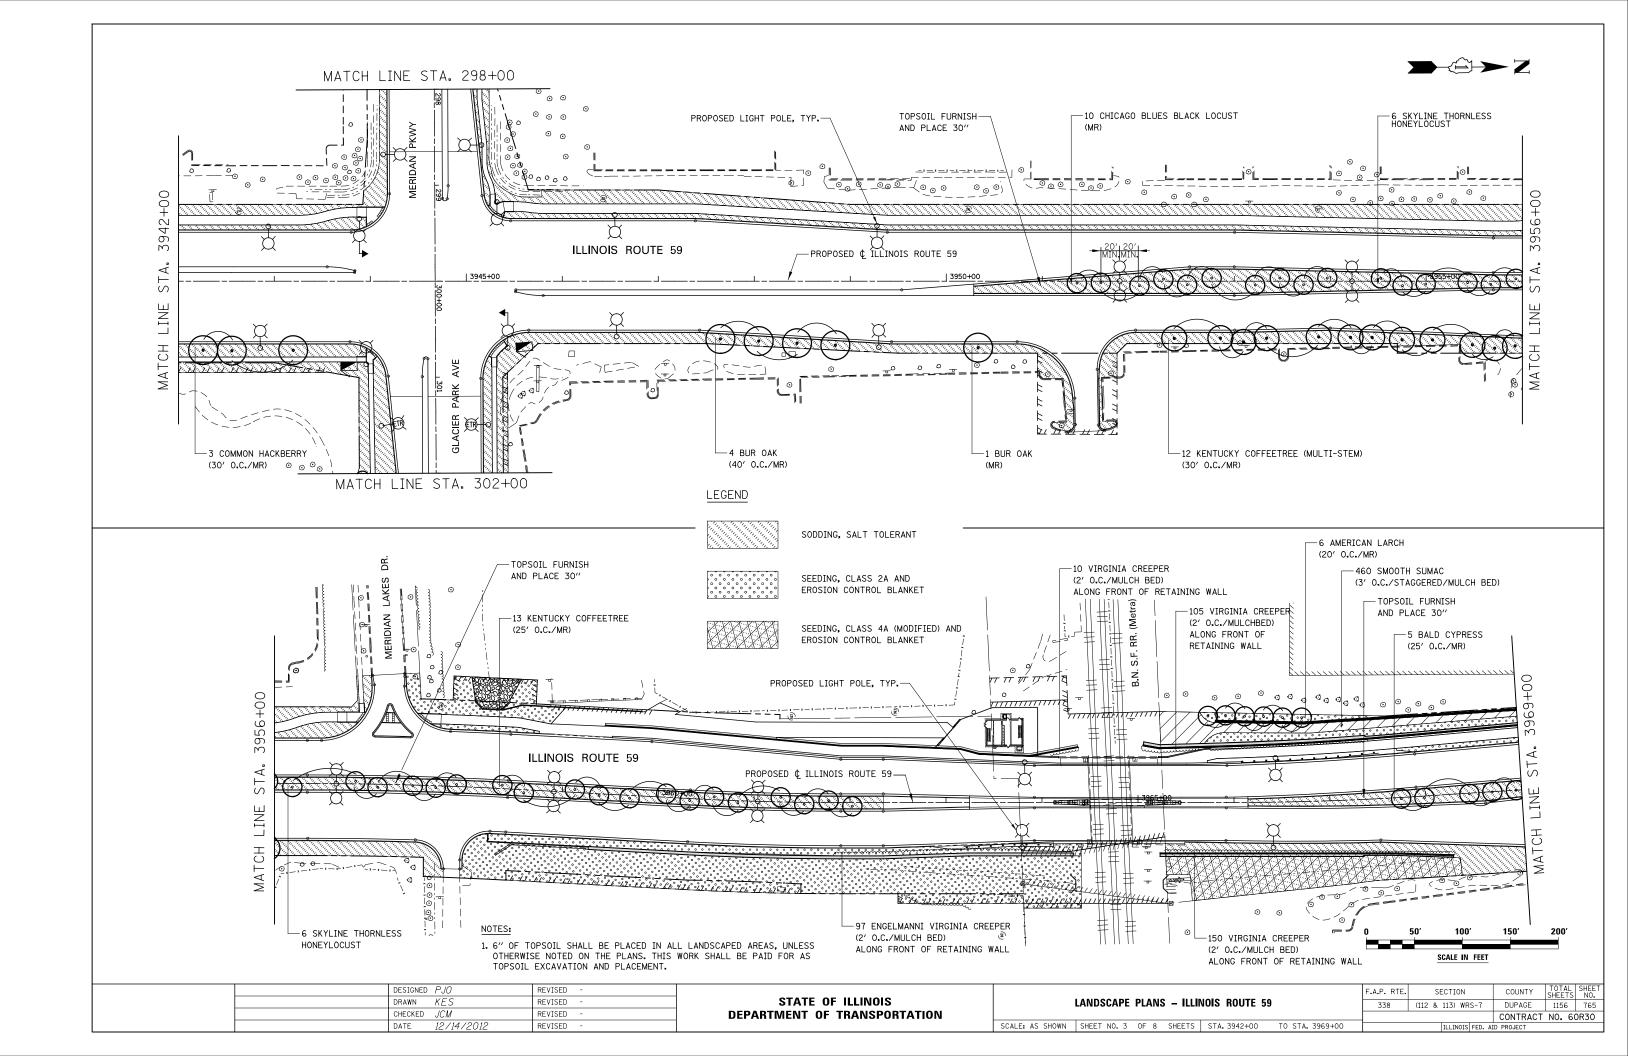

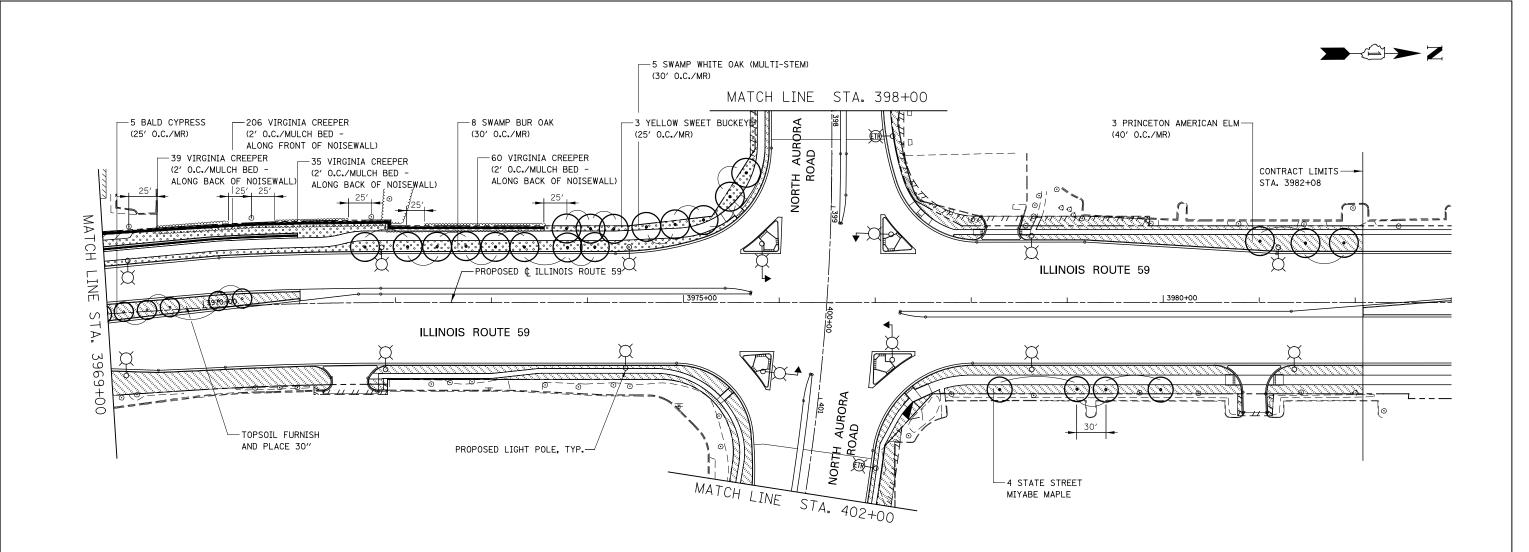

LEGEND

SODDING, SALT TOLERANT




SEEDING, CLASS 2A AND EROSION CONTROL BLANKET




SEEDING, CLASS 4A (MODIFIED) AND EROSION CONTROL BLANKET


#### NOTES:


1. 6" OF TOPSOIL SHALL BE PLACED IN ALL LANDSCAPED AREAS, UNLESS OTHERWISE NOTED ON THE PLANS, THIS WORK SHALL BE PAID FOR AS TOPSOIL EXCAVATION AND PLACEMENT.

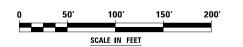


DESIGNED PJU	REVISED -			F.A.P. RTE.	SECTION	COUNTY	SHEETS	NO.
DRAWN KES	REVISED -	STATE OF ILLINOIS	LANDSCAPE PLANS – ILLINOIS ROUTE 59	338	(112 & 113) WRS-7	DUPAGE	1156	766
CHECKED JCM	REVISED -	DEPARTMENT OF TRANSPORTATION				CONTRACT	NO. 60F	
DATE 12/14/2012	REVISED -		SCALE: AS SHOWN SHEET NO. 4 OF 8 SHEETS STA. 3969+00 TO STA. 3982+08		ILLINOIS FED. AI	ID PROJECT		

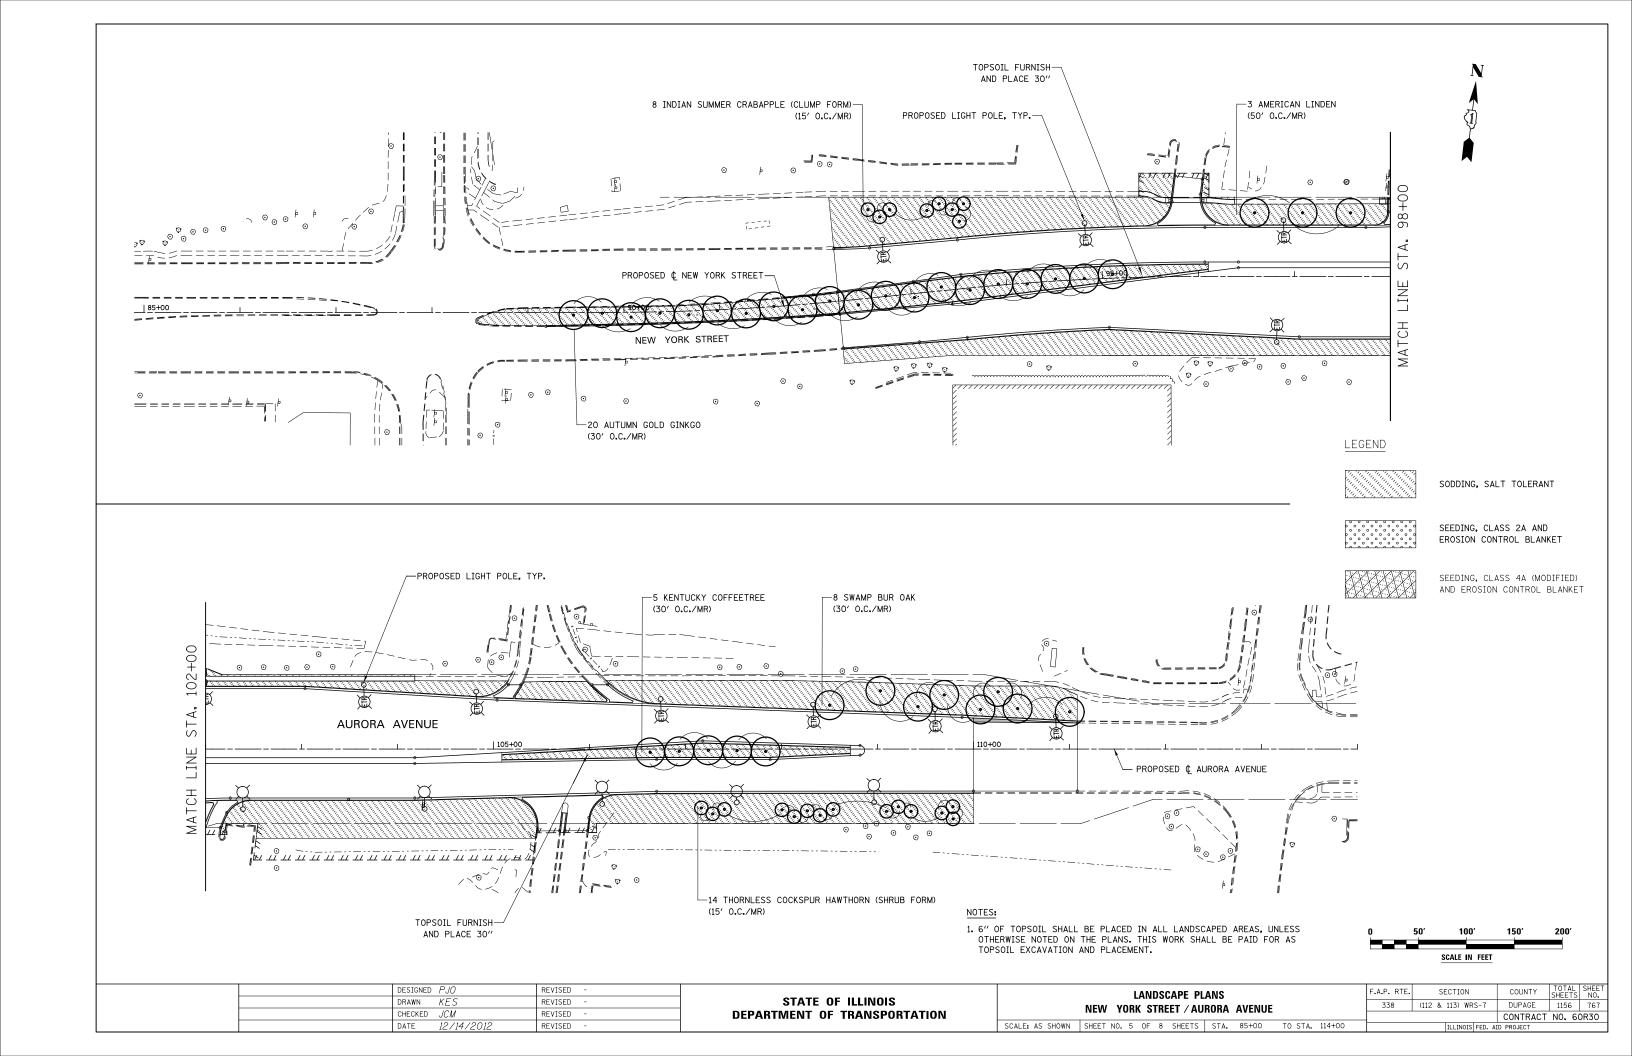

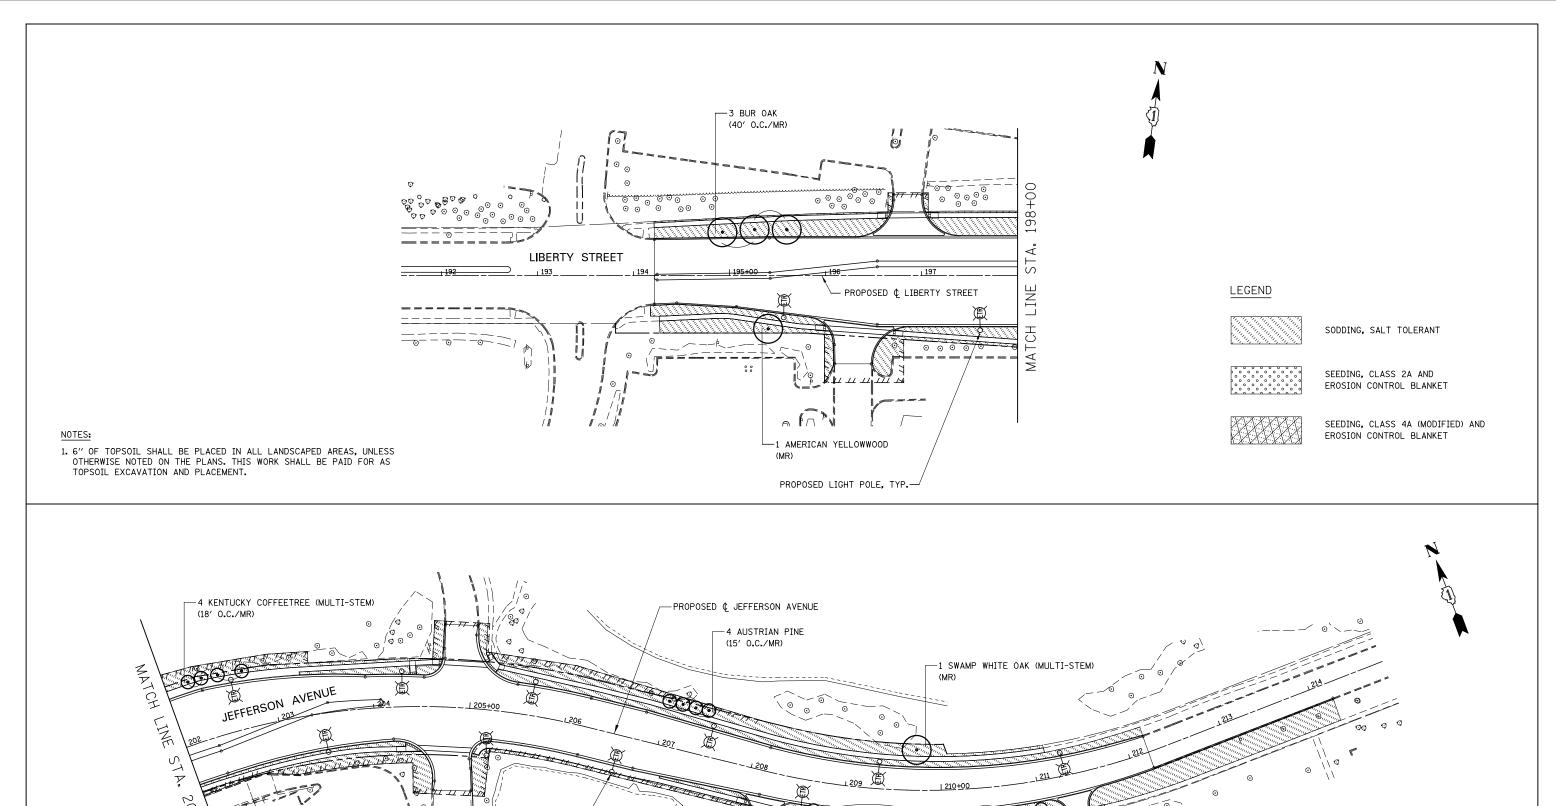

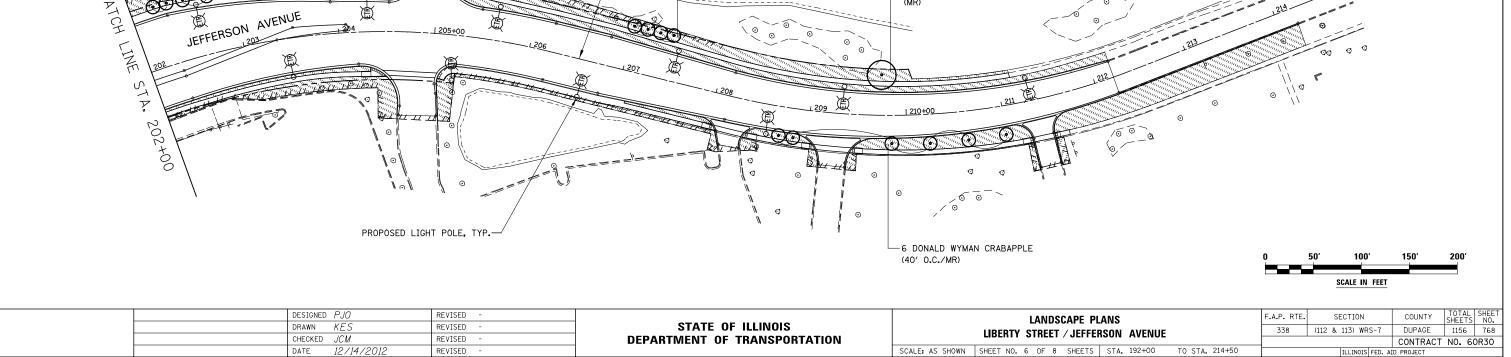

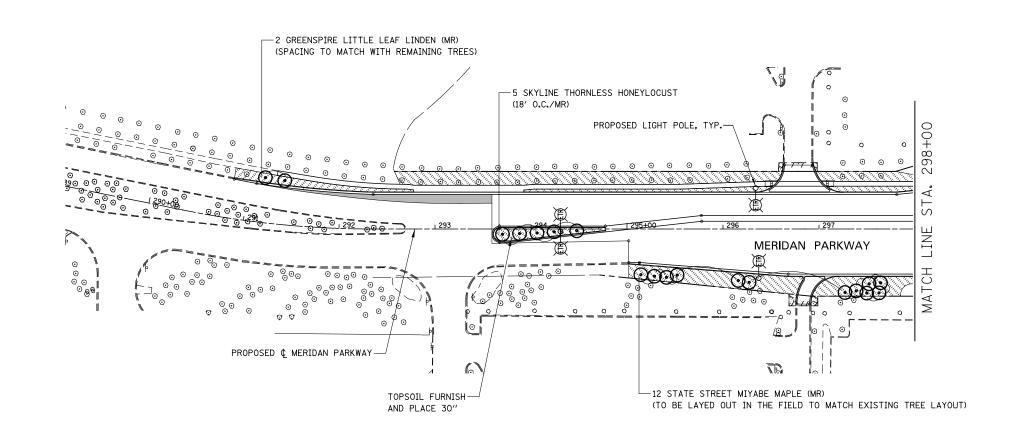

#### LEGEND



SODDING, SALT TOLERANT




SEEDING, CLASS 2A AND EROSION CONTROL BLANKET



SEEDING, CLASS 4A (MODIFIED) AND EROSION CONTROL BLANKET

#### NOTES:

1. 6" OF TOPSOIL SHALL BE PLACED IN ALL LANDSCAPED AREAS, UNLESS OTHERWISE NOTED ON THE PLANS. THIS WORK SHALL BE PAID FOR AS TOPSOIL EXCAVATION AND PLACEMENT.

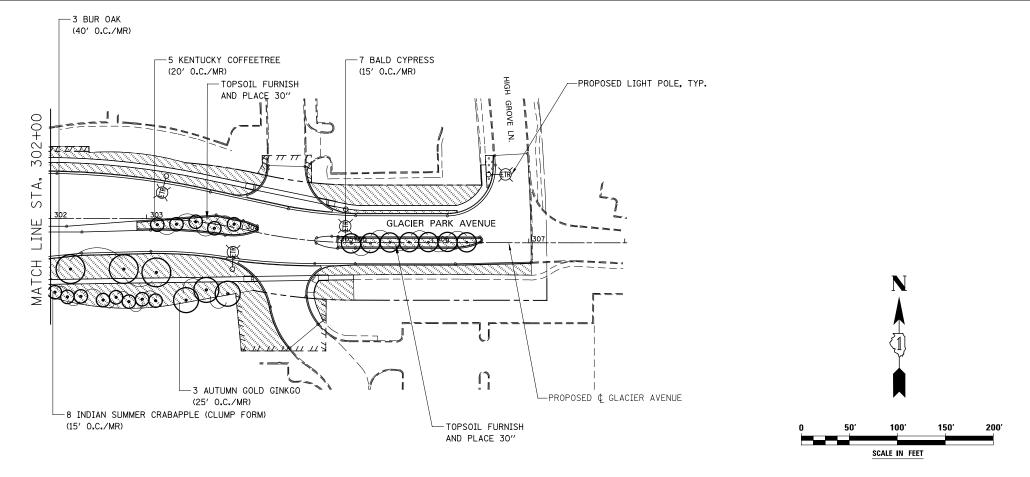

DESIGNED PJO	REVISED -	
DRAWN KES	REVISED -	
CHECKED JCM	REVISED -	
DATE 12/14/2012	REVISED -	


STATE OF ILLINOIS
DEPARTMENT OF TRANSPORTATION

LANDSCAPE PLANS									F.A.P. RTE.	SECTION
	T.	TERIDAN F	ΔΕΚΝ	VAY / GLAC	IFR PA	ARK AVEN	IIIE		338	(112 & 113) WRS-7
	.,	LINDAN	AIIIXV	IAI / GLAC		TILL AVE				
	SCALE: AS SHOWN	SHEET NO.	7 OF	8 SHEETS	STA.	289+00	TO STA.	308+00		ILLINOIS FED.

COUNTY

DUPAGE 1156 769

CONTRACT NO. 60R30

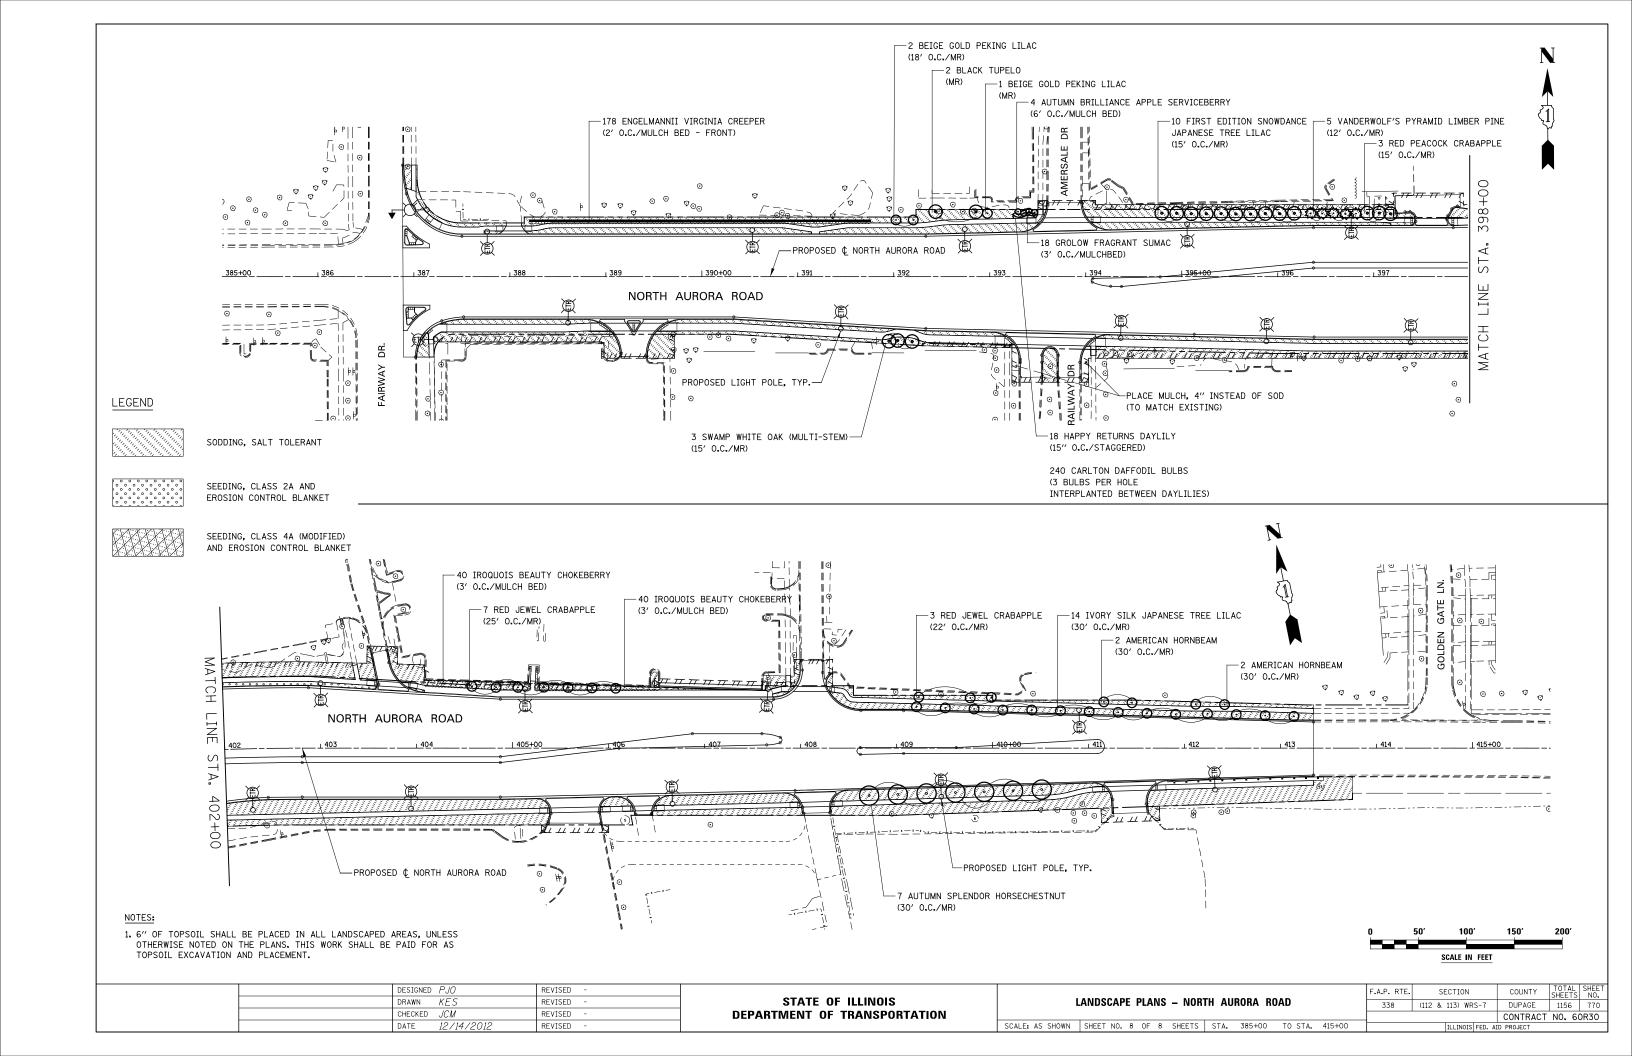

#### SYMBOL LIST

#### **←** NEW COMBINATION LIGHTING - TRAFFIC SIGNAL POLE EXISTING LIGHT POLE TO REMAIN EXISTING LIGHT POLE TO BE REMOVED AND SALVAGED EXISTING LIGHT POLE TO BE REMOVED AND REINSTALLED AT DIFFERENT LOCATION **₩** EXISTING LIGHT POLE REINSTALLED $\sim$ LIGHT POLE, ALUMINUM, 47.5 FT, M.H., 12 FT, MAST ARM AND LUMINAIRE, SODIUM VAPOR, HORIZONTAL MOUNT, 400W. UNLESS OTHERWISE NOTED O. UNDERPASS LUMINAIRE EXISTING LIGHTING CONTROLLER NEW LIGHTING CONTROLLER, PAD MOUNTED, UNLESS OTHERWISE NOTED NEW LIGHTING JUNCTION BOX. TYPE AND SIZE ф EXISTING UTILITY POLE GROUND ROD UTILITY TRANSFORMER POLE MOUNTED \_\_ UNIT DUCT, NO, AND SIZE OF WIRES AS NOTED ON PLANS — — — WIRING IN CONDUIT ATTACHED [ ] CONDUIT CONCEALED -CONTROL CABINET — CIRCUITRY - POLE NUMBER

#### **ABBREVIATIONS**

AMPS

VOLTS

WATTS

DIAMETER


DIA

DIA	DIAMETER
С	CONDUIT
GND	GROUND
FT	FEET
HPS	HIGH PRESSURE SODIUM
IDOT	ILLINOIS DEPARTMENT OF TRASPORTATION
LT	LEFT
MC	MEDIUM CUTOFF
Р	PUSHED
PC	PHOTO CONTROL
PH	PHASE
PVC	POLYVINYL CHLORIDE
RGSC	RIGID GALVANIZED STEEL CONDUIT
RT	RIGHT
STA	STATION
UNO	UNLESS NOTED OTHERWISE

#### GENERAL NOTES


- SPLICING OF CONDUCTORS SHALL BE IN POLE BASES OR WEATHER TIGHT JUNCTION BOXES ONLY, SPLICES BELOW GRADE WILL NOT BE PERMITTED.
- LIGHTING CIRCUITS SHALL BE WIRED IN ACCORDANCE WITH THE PLANS. DEVIATIONS WILL NOT BE PERMITTED WITHOUT PRIOR APPROVAL OF THE ENGINEER.
- 3. THE CONTRACTOR SHALL REQUEST A FORMAL MAINTENANCE TRANSFER FOR STATE MAINTAINED LIGHTING BEFORE ANY WORK BEGINS. THE CONTRACTOR SHALL CONTACT THE ILLINOIS DEPARTMENT OF TRANSPORTATION NEIL THAKKAR AT (708) 524-2145.
- 4. THE CONTRACTOR SHALL TAKE ALL NECESSARY MEASURES TO RESTORE ANY SPECIALIZED LADSCAPING (DECORATIVE ROCKS, PLANTS, ETC.).
- 5. ALL WORK SHALL CONFORM TO THE LATEST IDOT DISTRICT ONE STANDARDS, SPECIAL PROVISIONS, SUPPLEMENTAL SPECIFICATIONS, THE NATIONAL ELECTRICAL CODE, AND THE NATIONAL ELECTRICAL SAFETY CODE.
- 6. ALL ELECTRICAL EQUIPMENT SHALL BE UL LISTED AND LABELED.
- 7. ALL CONDUITS SHALL BE SEALED.
- 8. ALL CIRCUIT WIRES SHALL BE LABELED WITH CIRCUIT IDENTIFICATION.
- 9. ALL LAMPS SHALL BE FURNISHED AS PART OF THE CONTRACT.
- 10. CIRCUITS SHALL BE TESTED PER SPECIFICATIONS.
- 11. THE LOCATIONS OF ALL PROPOSED EQUIPMENT ARE ILLUSTRATED DIAGRAMMATICALLY. THE ACTUAL LOCATION IN THE FIELD SHALL MEET THE APPROVAL OF THE ENGINEER.
- 12. ALL MEASUREMENTS ARE APPROXIMATE, THE CONTRACTOR SHALL VERIFY MEASUREMENTS IN THE FIELD.
- 13. IT SHALL BE THE RESPONSIBILITY OF THE CONTRACTOR TO VERIFY THE EXISTING INSTALLATIONS AND DATA PRIOR TO BIDDING.
- 14. THE CONTRACTOR MUST MAINTAIN SAFE EQUIPMENT AND WORKING CLEARENCES FROM THE EXISTING COMED OVERHEAD ELECTRIC LINES. THE CONTRACTOR SHALL PLAN HIS WORK CONSIDERING COMED'S LINES TO BE IN SERVICE AND ENERGIZED THROUGHOUT THE CONSTRUCTION PERIOD.
- 15. THE CONTRACTOR SHALL REMOVE CABLES FROM ALL EXISTING UNIT DUCTS. EXISTING UNIT DUCTS SHALL BE ABANDONED IN PLACE.
- 16. THE COST OF SPLICING TEMPORARY CONDUCTORS TO EXISTING CONDUCTORS IN EXISTING POLES SHALL BE INCIDENTAL TO THE PAY ITEM FOR AERIAL CABLE.
- 17. GROUNDING CONDUCTORS SHALL BE CONTINUOUS.
- 18. ALL NEW UNIT DUCTS AND CONDUITS SHALL BE PLACED A MINIMUM OF 30" BENEATH THE GROUND SURFACE (FINAL GRADE).


DESIGNED MCP	REVISED -	07477 OF WWW.010	ELECTRICAL SYMBOLS, ABBREVIATIONS	F.A.P. RTE.	SECTION	COUNTY	TOTAL SHEET SHEETS NO.
DRAWN MLB	REVISED -	STATE OF ILLINOIS	AND GENERAL NOTES	338	(112 & 113) WRS-7	DUPAGE	1156 771
CHECKED MCP	REVISED -	DEPARTMENT OF TRANSPORTATION	AND GENERAL NOTES		LT-01	CONTRAC	T NO. 60R30
DATE 12/14/2012	REVISED -		SCALE: AS SHOWN SHEET NO. 1 OF 1 SHEETS STA. TO STA.		ILLINOIS FED.	AID PROJECT	

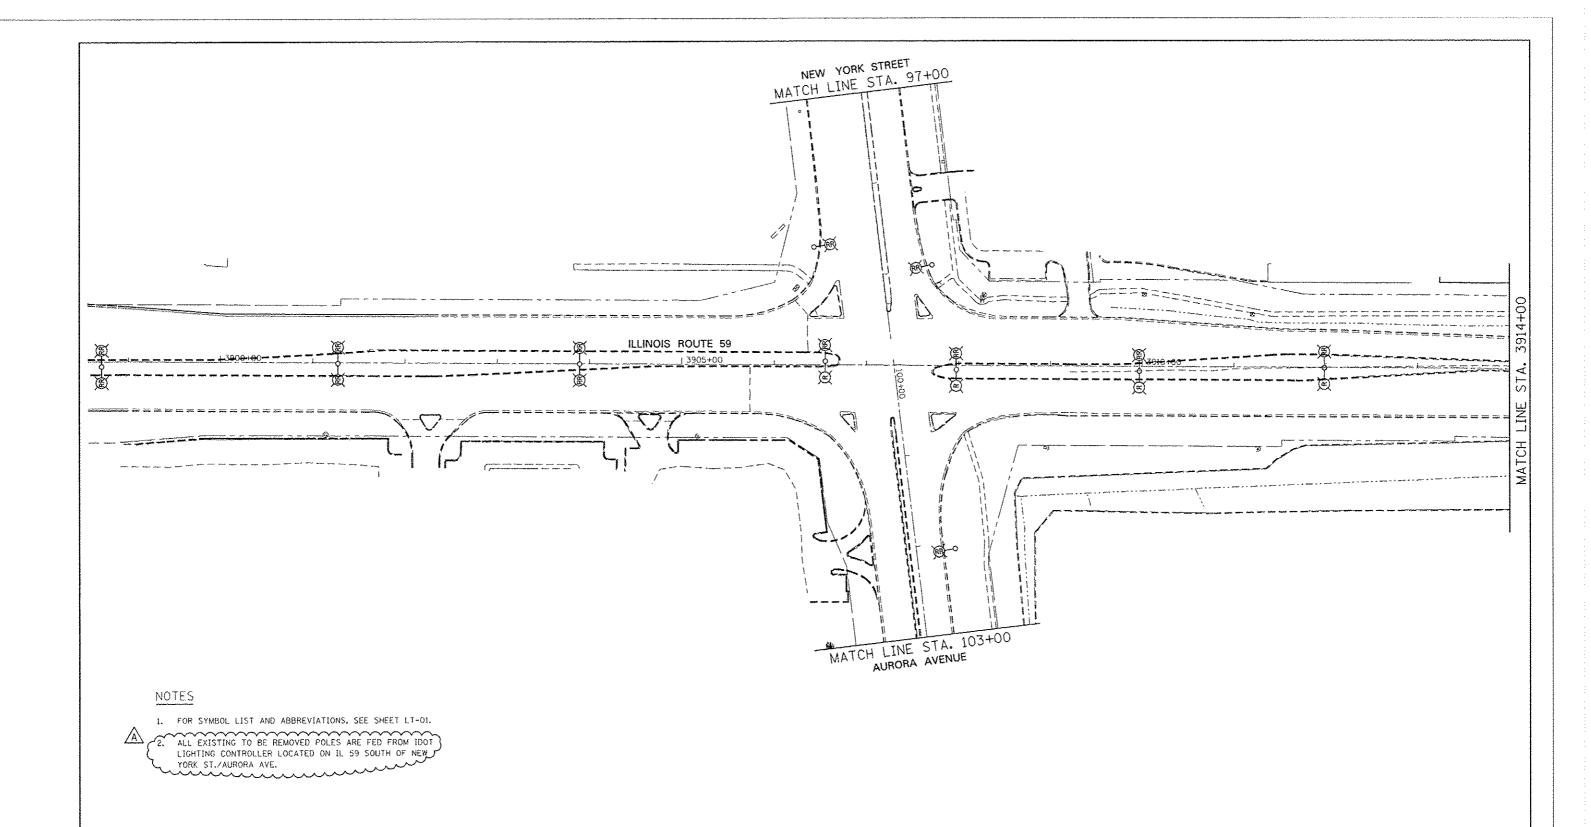

)	50	100'	150'	200'				
		SCALE IN FEET						

	DESIGNED MCP	REVISED - ADDENOUM A 02/20/2013	STATE OF ILLINOIS DEPARTMENT OF TRANSPORTATION		F.A.P. RTE.	SECTION	COUNTY SHEE	TAL SHEET
	DRAWN MLB	REVISED -		LIGHTING REMOVAL PLAN - ILLINOIS ROUTE 59	338	(112 & 113) WRS-7	DUPAGE 115	56 772
	CHECKED MCP	REVISED -				LT02	CONTRACT NO.	. 60R30
	DATE 12/14/2012	REVISED -		SCALE: AS SHOWN SHEET NO. 1 OF 10 SHEETS STA. TO STA.		ILLINOIS FED. A	ID PROJECT	

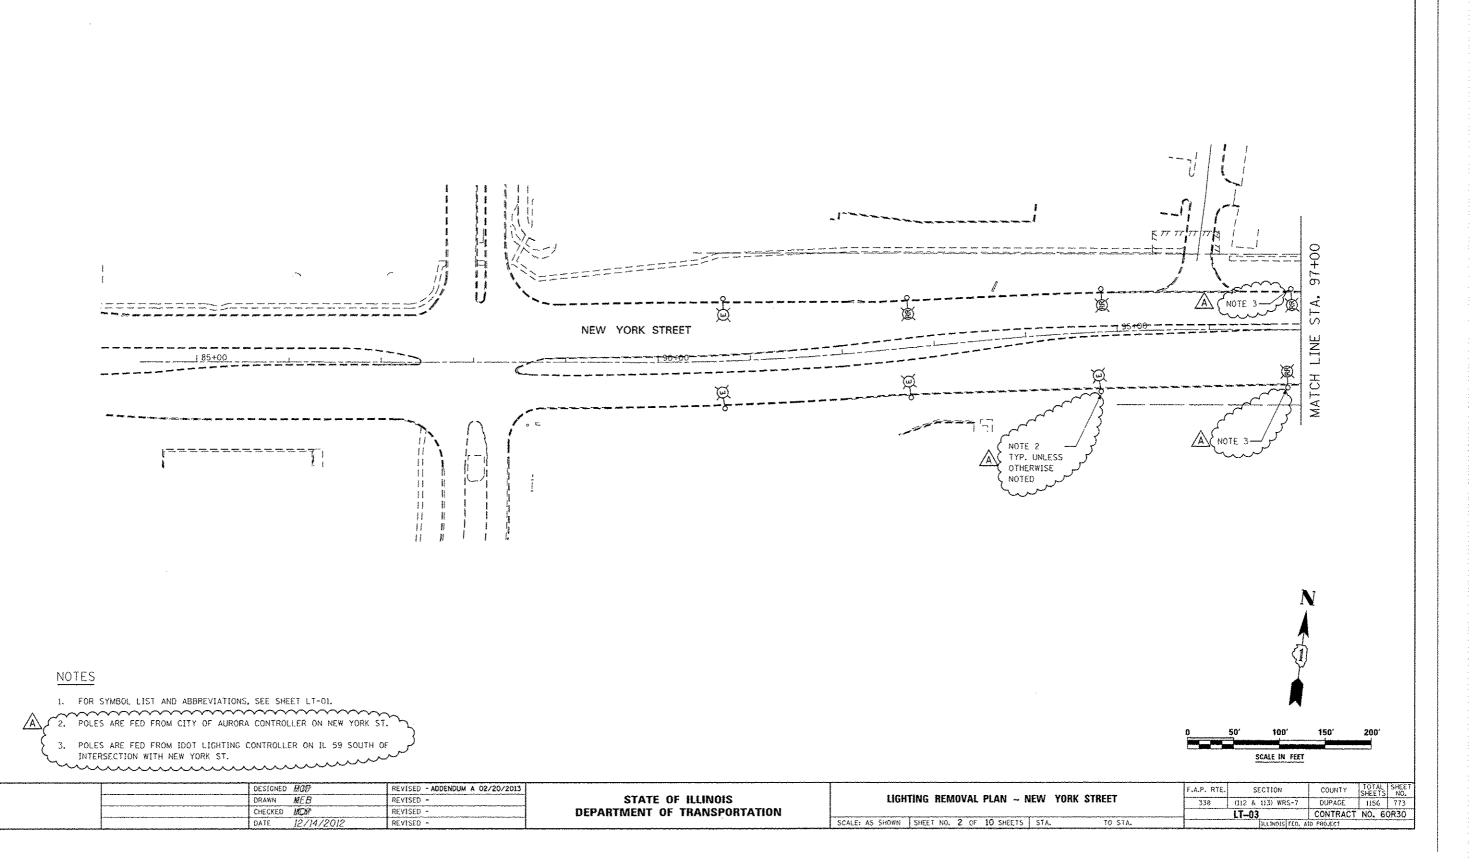

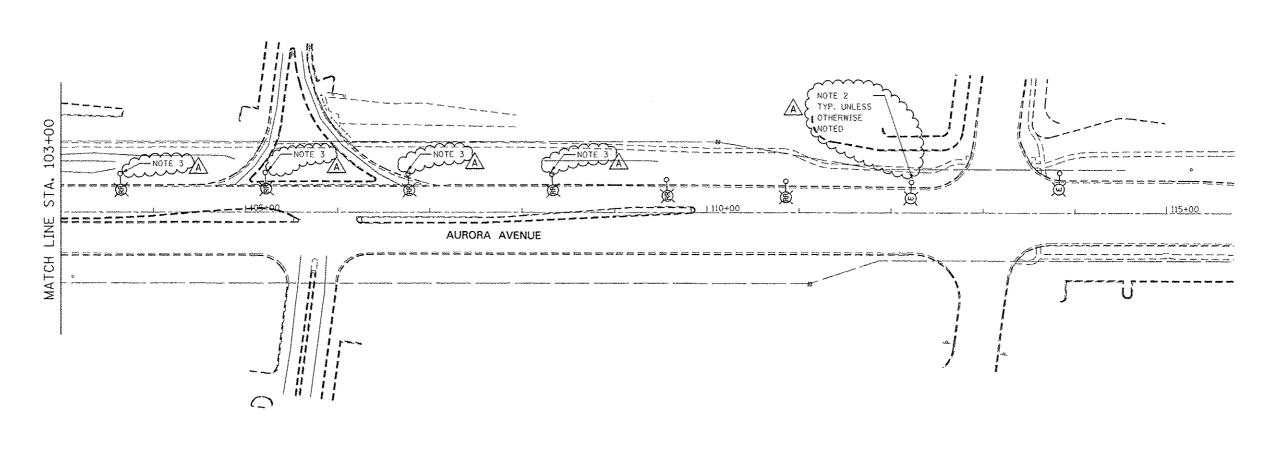

1. FOR SYMBOL LIST AND ABBREVIATIONS, SEE SHEET LT-01.

2. POLES ARE FED FROM CITY OF NAPERVILLE CONTROLLER.

3. POLES ARE FED FROM IDOT LIGHTING CONTROLLER ON IL 59
SOUTH OF INTERSECTION WITH AURORA AVE.


		N		
Ç.	50'	100	150	200
		SCALE IN FEET	<u></u>	

	DESIGNED	MCP	REVISED - ADDENDUM A 02/20/201
	DRAWN	MLB	RÉVISED -
	CHECKED	MCP	REVISED -
·	DATE	12/14/2012	REVISED -

STATE OF ILLINOIS
DEPARTMENT OF TRANSPORTATION

LIG	HTING REMOV	/AL PLAN - AUROR	A AVENUE
SCALE: AS SHOWN	SHEET NO. 3	OF 10 SHEETS STA.	TO STA.

-	THE TRANSPORT AND DROVERT									
_[		LT-04	CONTRACT	NO. 60	0R30					
	338	(112 & 113) WRS-7	DUPAGE	1156	774					
F	.A.P. RTE.	SECTION	COUNTY	TOTAL SHEETS	SHEET NO.					

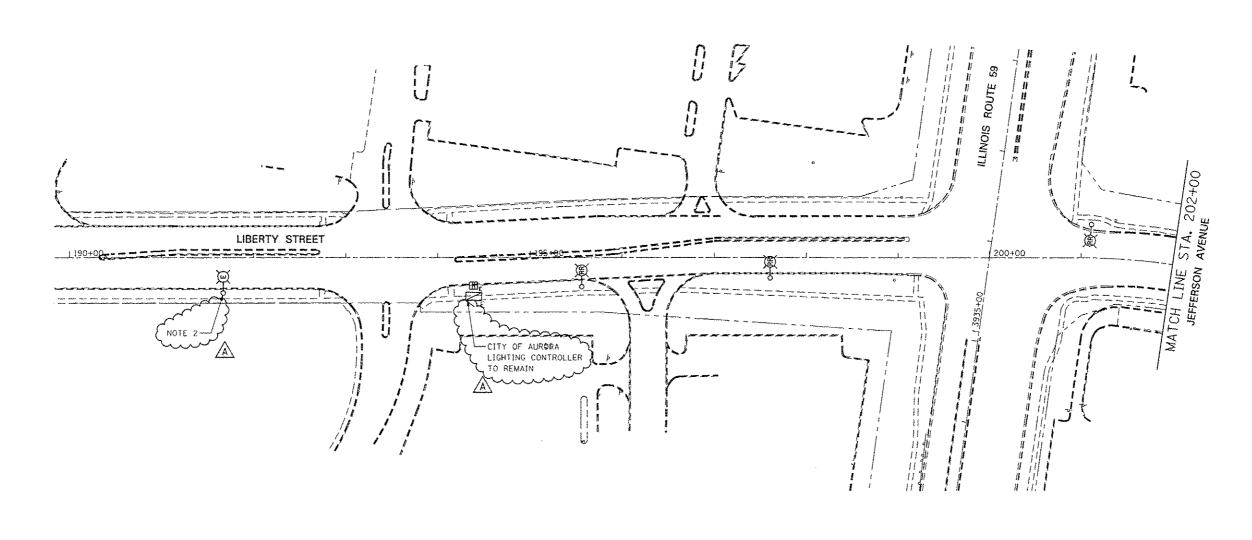



1. FOR SYMBOU

2. POLE IS FE

MBOL LIST AND ABBREVIATIONS, SEE SHEET LT-01.				
S FED FROM CITY OF AURORA CONTROLLER.	0	 100'	150'	200′

DESIGNED MCP	REVISED - ADDENDUM A 02/20/2013	STATE OF ILLINOIS	LIGHTING REMOVAL PLAN – LIBERTY STREET/JEFFERSON AVENUE	F.A.P. RTE, SECTION COUNTY SHEETS NO.
CHECKED MCP	REVISED -	STATE OF ILLINOIS DEPARTMENT OF TRANSPORTATION	LIGHTING REMICANT FLAM - CIDENTI STREEDSEFFERSON AVENUE	338 (112 & 113) WRS-7 DUPAGE 1156 775 TT-05 CONTRACT NO. 60R30
DATE 12/14/2012	REVISED -		SCALE: AS SHOWN SHEET NO. 4 OF 10 SHEETS STA. TO STA.	ILLINOIS FEO. AJO PROJECT

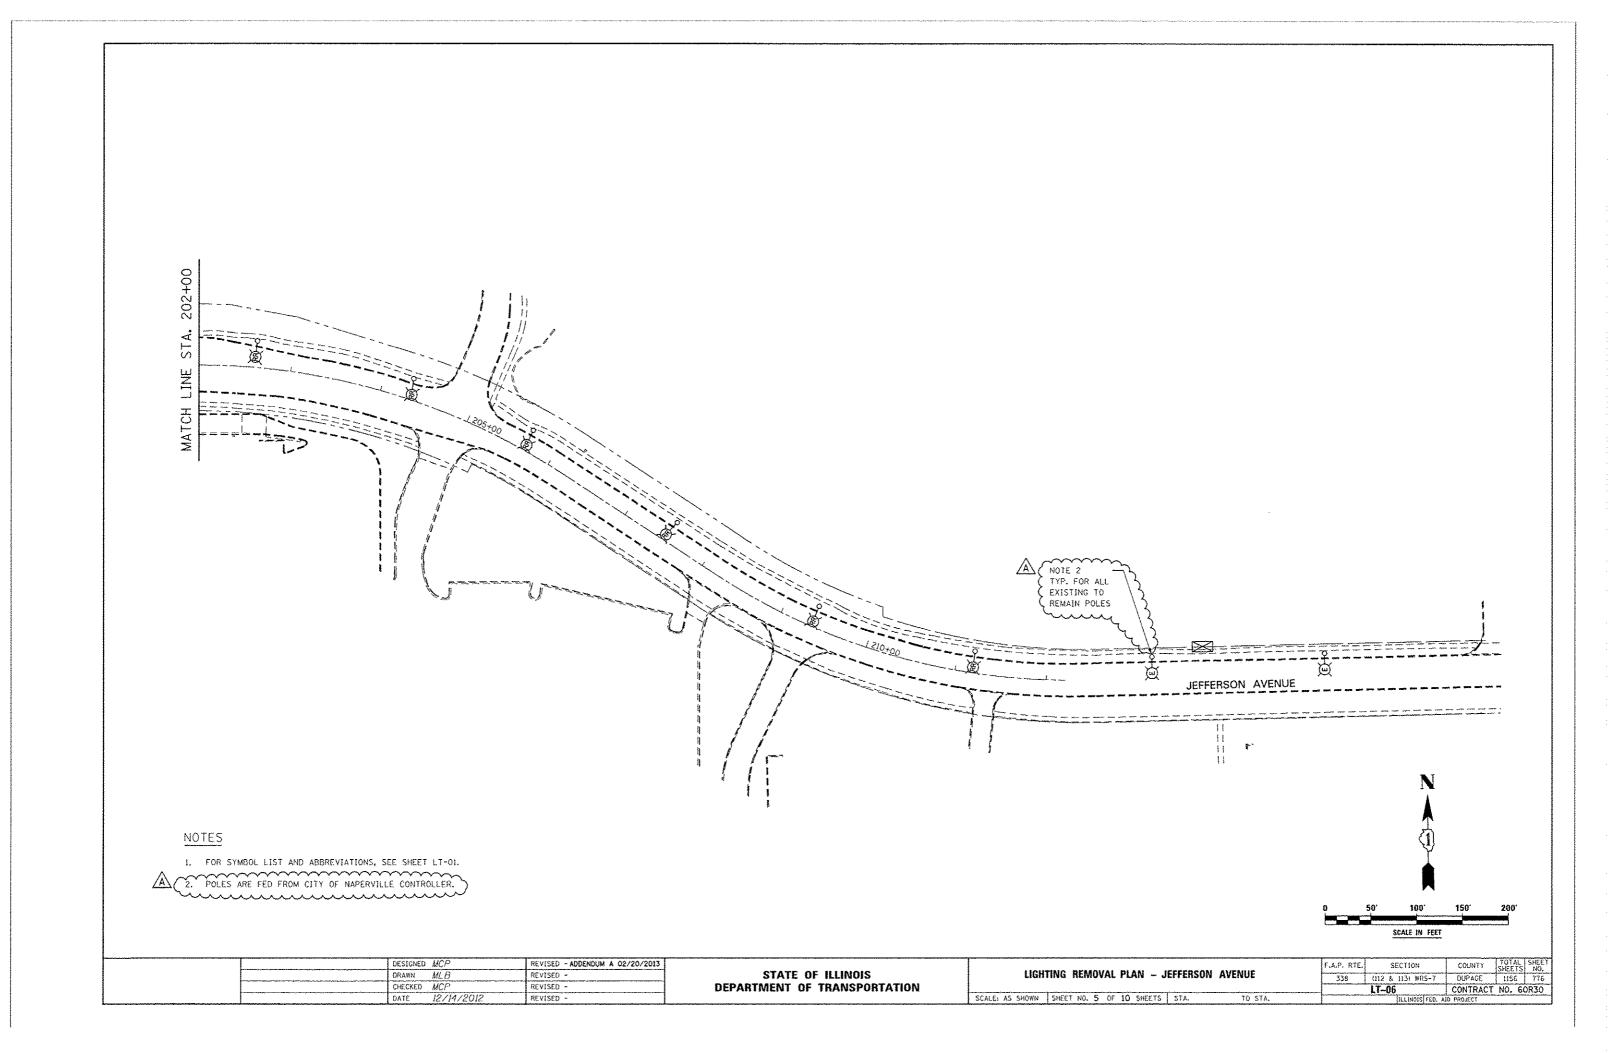

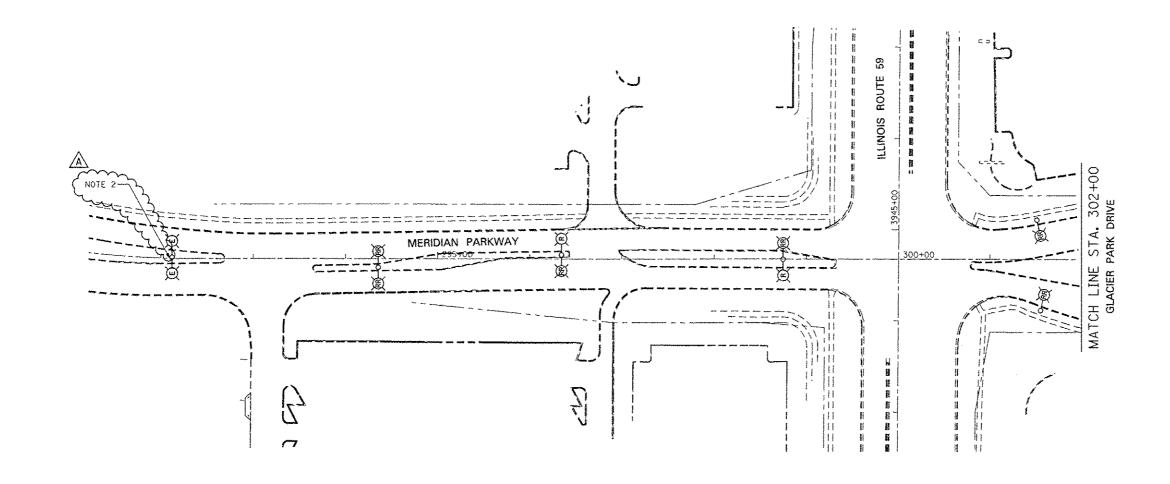


1. FOR SYMBOL LIST AND ABBREVIATIONS, SEE SHEET LT-01.

2. POLE IS FED FROM CITY OF AURORA CONTROLLER.


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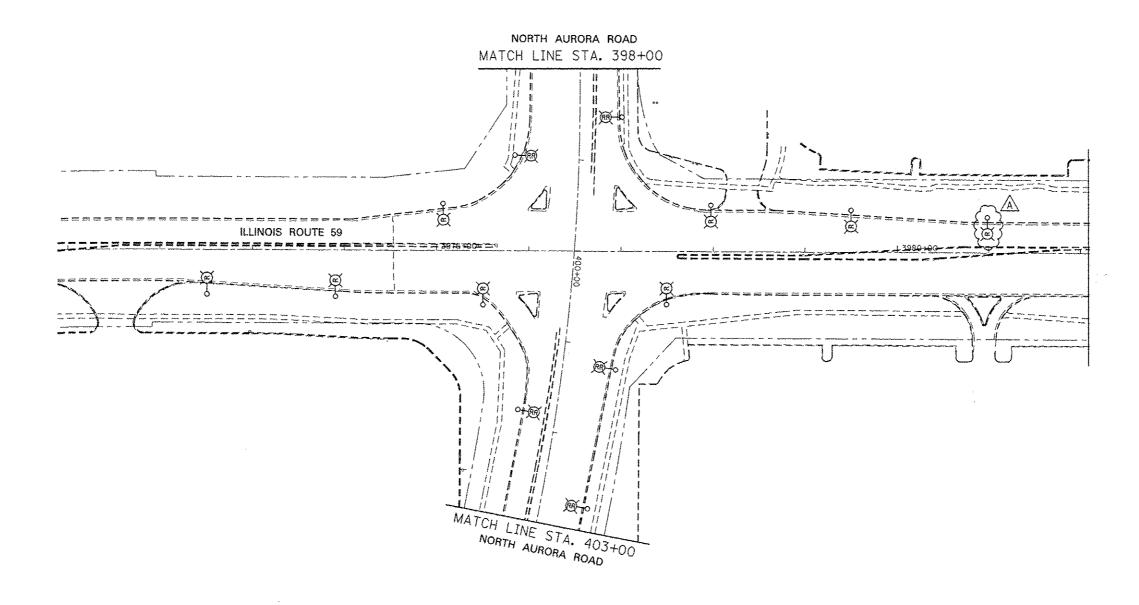
	DESIGNED MCP	REVISED - ADDENDUM A 02/20/2013			F.A.P. RTE. SECTION	COUNTY SHEETS NO.
1	DRAWN MLB	REVISED -	STATE OF ILLINOIS	LIGHTING REMOVAL PLAN – MERIDIAN PARKWAYGLACIER PARK DRIVE	338 (112 & 113) WRS-7	DUPAGE 1156 777
	CHECKED MCP	REVISED -	DEPARTMENT OF TRANSPORTATION		LT-07	CONTRACT NO. 60R30
	DATE 12/14/2012	REVISED -		SCALE: AS SHOWN SHEET NO. 6 OF 10 SHEETS STA. TO STA.	ILLINOIS FED. A	AID PROJECT




1. FOR SYMBOL LIST AND ABBREVIATIONS, SEE SHEET LT-01.

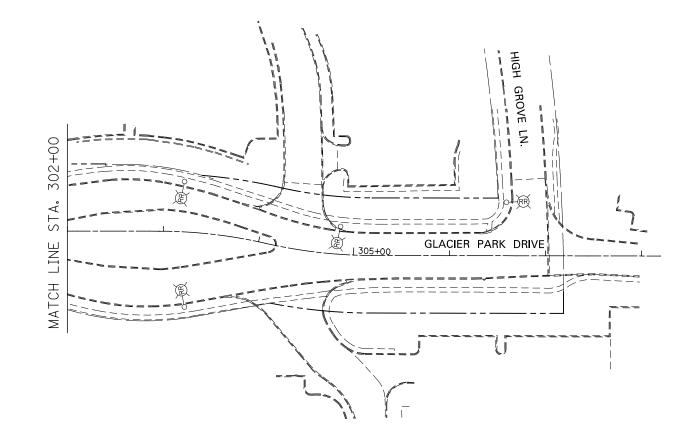


DESIGNED MCP		REVISED -			F.A.P. RTE.	SECTION	COUNTY TOTAL SHEET	ı
DRAWN <i>MLB</i>		REVISED -	STATE OF ILLINOIS	LIGHTING REMOVAL PLAN – GLACIER PARK DRIVE	338	(112 & 113) WRS-7	DUPAGE 1156 778	ı
CHECKED MCP		REVISED -	DEPARTMENT OF TRANSPORTATION			LT-08	CONTRACT NO. 60R30	
DATE 12/14	4/2012	REVISED -		SCALE: AS SHOWN   SHEET NO. 7 OF 10 SHEETS   STA. TO STA.		ILLINOIS FED.	AID PROJECT	

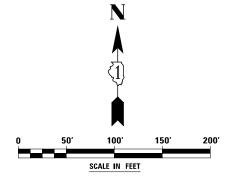


1. FOR SYMBOL LIST AND ABBREVIATIONS, SEE SHEET LT-01.

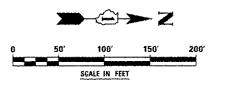

	DESIGNED	MCP	REVISED - ADDENDUM A 02/20/2013	·						F.A.P. RTE.	SECTION	COUNTY	SHEETS NO.
Į.	 DRAWN	MLB	REVISED -	STATE OF ILLINOIS	LIGH	TING REMOV	VAL PLAN -	ILLINOIS RO	DUTE 59	338	(112 & 113) WR5-7	DUPAGE	1156 779
Ĺ	CHECKED	MCP	REVISED -	DEPARTMENT OF TRANSPORTATION							LT09	CONTRACT	NO. 60R30
	DATE	12/14/2012	REVISED -		SCALE: AS SHOWN	SHEET NO. 8	OF 10 SHEETS	S STA.	TO STA.		HLINOIS FED. A	ID PROJECT	

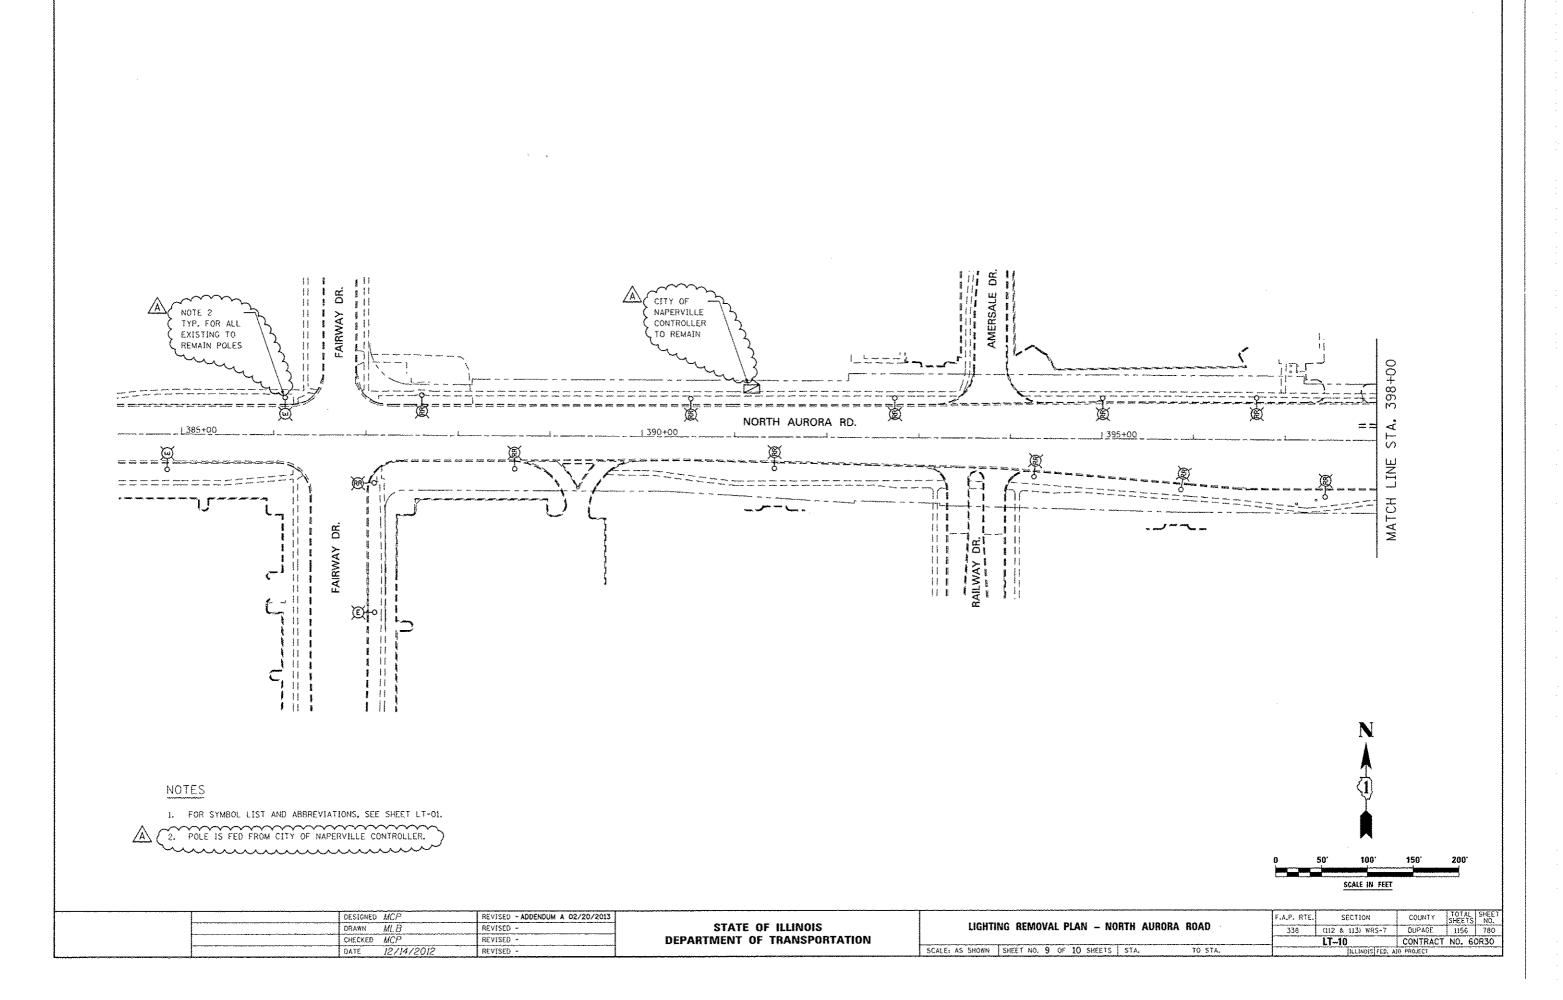

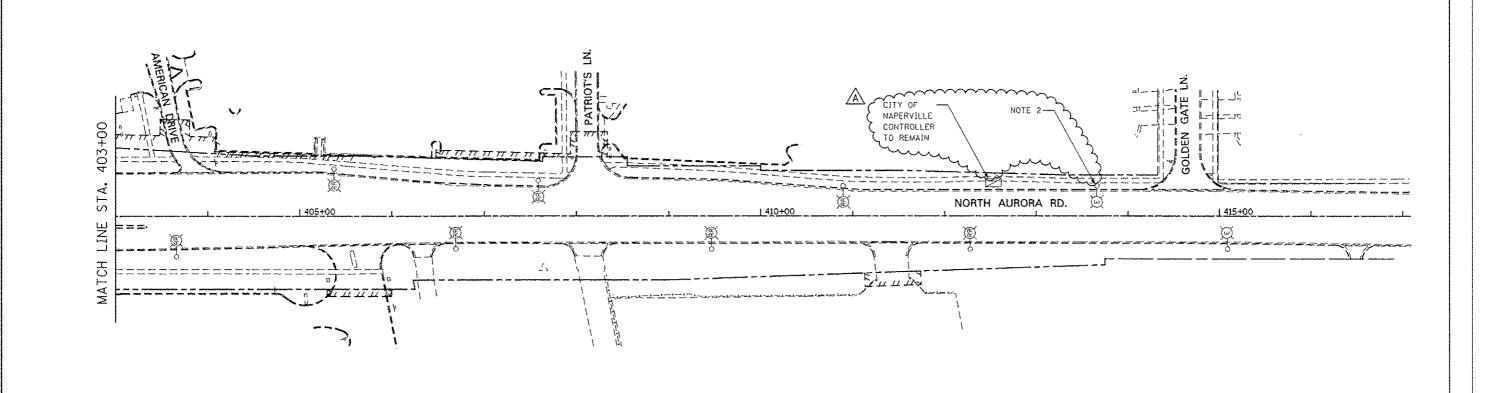



1. FOR SYMBOL LIST AND ABBREVIATIONS, SEE SHEET LT-OI.

2. POLE IS FED FROM CITY OF NAPERVILLE CONTROLLER.

0	50'	100'	150'	200'						
		SCALE IN FEE	Ţ.							

······	DESIGNED	MCP	REVISED - ADDENDUM A 02/20/2013	OTATE OF HUMOIO	LIGHTING REMOVAL PLAN - NORTH AURORA ROAD			SECTION	COUNTY	TOTAL SHEET SHEETS NO.
	DRAWN CHECKED	MLB MCP	REVISED -	STATE OF ILLINOIS DEPARTMENT OF TRANSPORTATION	LIGHTING REMOVAL PLA	IN - NURTH AURUKA KUAD	338	(112 & 113) WRS-7	DUPAGE	1156 781
	 DATE	12/14/2012	REVISED -		SCALE: AS SHOWN SHEET NO. 10 OF 10	SHEETS STA. TO STA.		ILLINOIS FED. A	D PROJECT	140, 40/130

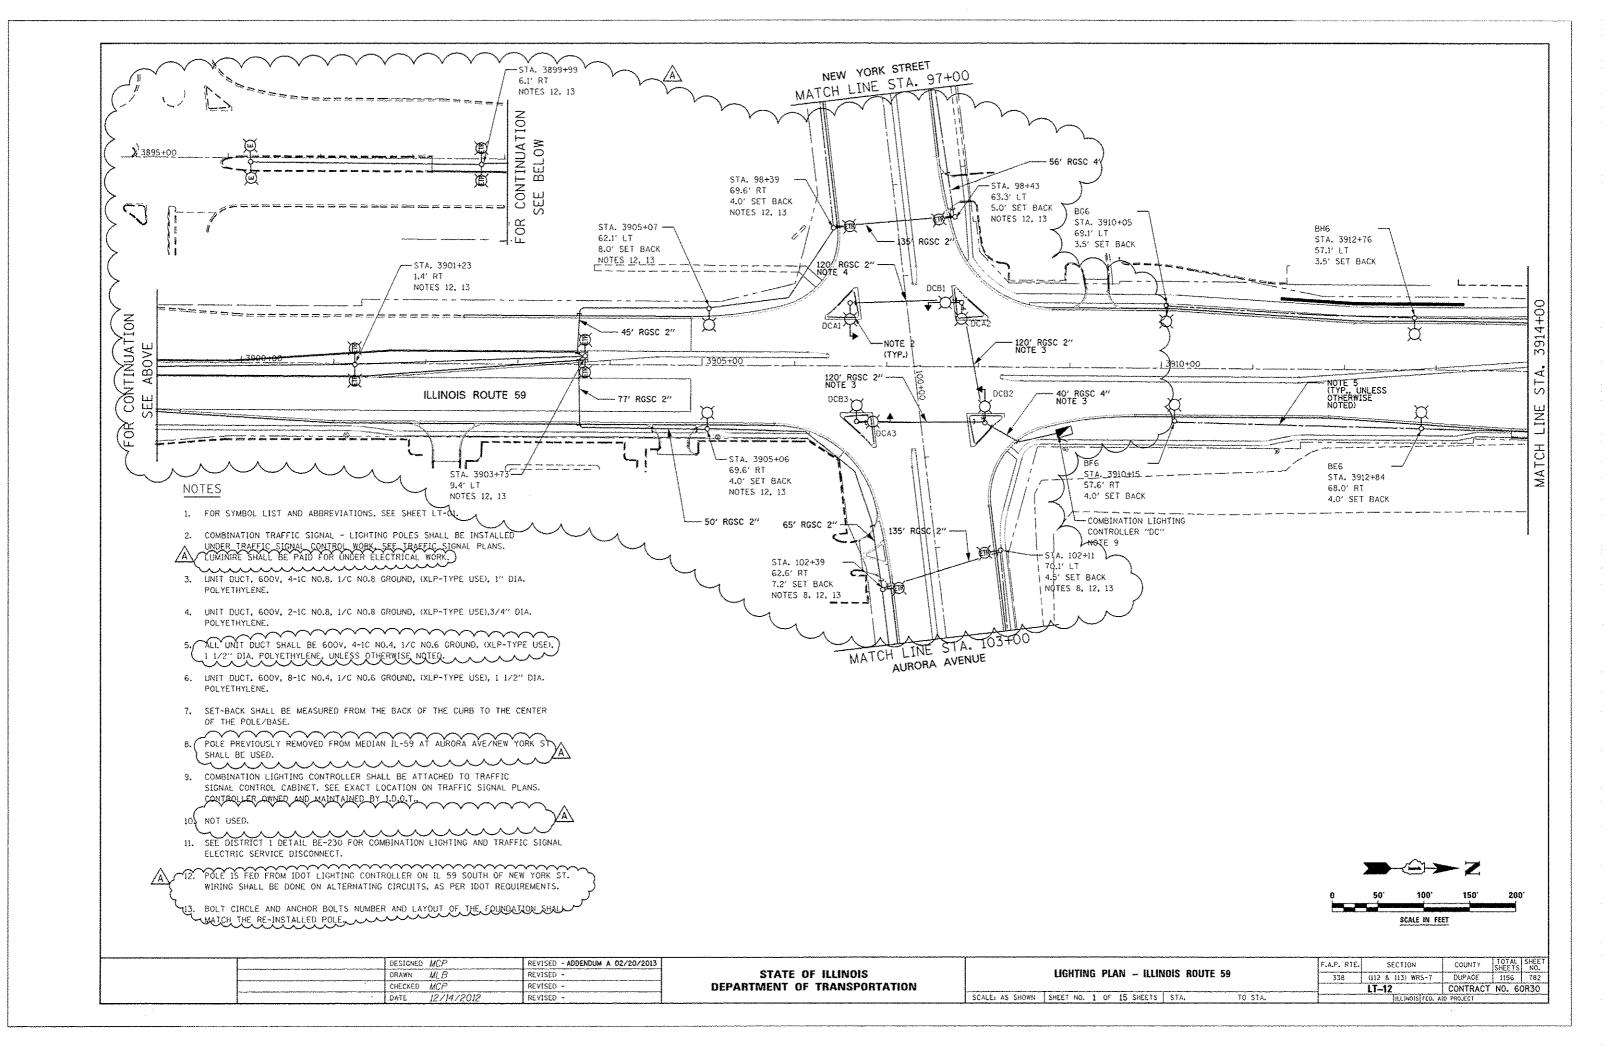


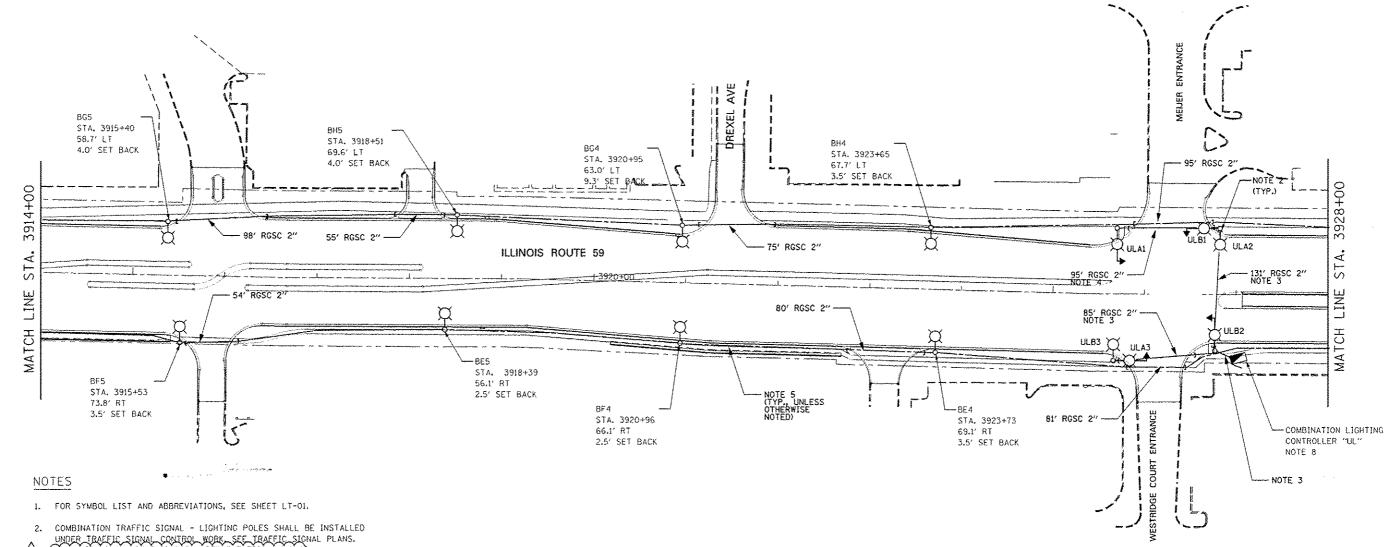


- UNDER TRAFFIC SIGNAL CONTROL WORK SEE TRAFFIC SIGNAL PLANS.


  LUMINAIRE SHALL BE PAID FOR UNDER ELECTRICAL WORK.

  3. UNIT DUCT, 600V, 4-IC NO.8, 1/C NO.8 GROUND, (XLP-TYPE USE), 1" DIA.
- POLYETHYLENE.
- 4. UNIT DUCT, 600V, 2-10 NO.8, 1/C NO.8 GROUND, (XLP-TYPE USE), 3/4" DIA. POLYETHYLENE,
- 5. UNIT DUCT, 600V. 4-1C NO.4, 1/C NO.6 GROUND, (XLP-TYPE USE), 1 1/2" DIA. POLYETHYLENE.
- 6. POLE SET-BACK SHALL BE MEASURED FROM THE BACK OF THE CURB TO THE CENTER OF THE POLE/BASE.
- 7. COMBINATION LIGHTING CONTROLLER SHALL BE ATTACHED TO TRAFFIC SIGNAL CONTROL CABINET. SEE EXACT LOCATION ON TRAFFIC SIGNAL PLANS. CONTROLLER OWNED AND MAINTAINED BY IDOT.
- 8. SEE DISTRICT 1 DETAIL 8E-230 FOR COMBINATION LIGHTING AND TRAFFIC SIGNAL ELECTRIC SERVICE DISCONNECT.

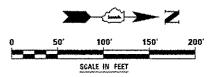

	DESIGNED M	ICP .	REVISED - ADDENDUM A 02/20/2013					F.A.P. RTE.	SECTION	COUNTY	SHEETS NO.
	DRAWN M	LB	REVISED -	STATE OF ILLINOIS		LIGHTING PLAN - ILLINOIS ROUTE 59		335	(1)2 & 1)3) WRS-7	DUPAGE	1156 783
1	CHECKED M	ICP .	REVISED -	DEPARTMENT OF TRANSPORTATION					LT-13	CONTRACT	NO. 60R30
	DATE 12	2/14/2012	REVISED -		SCALE: AS SHOWN	SHEET NO. 2 OF 15 SHEETS STA.	TO STA.		JLLINOIS FED. A	ID PROJECT	

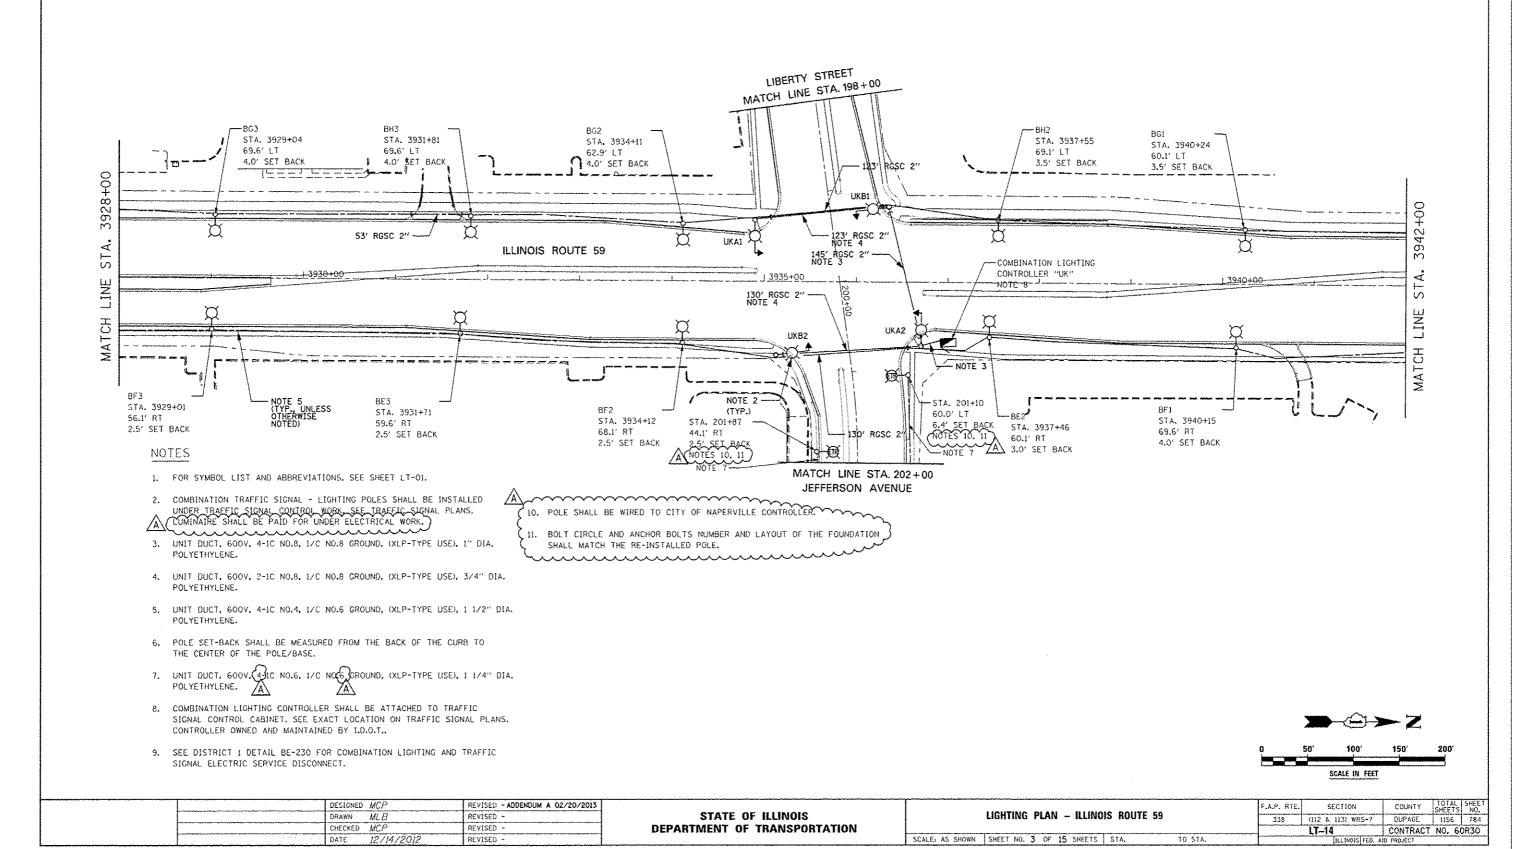

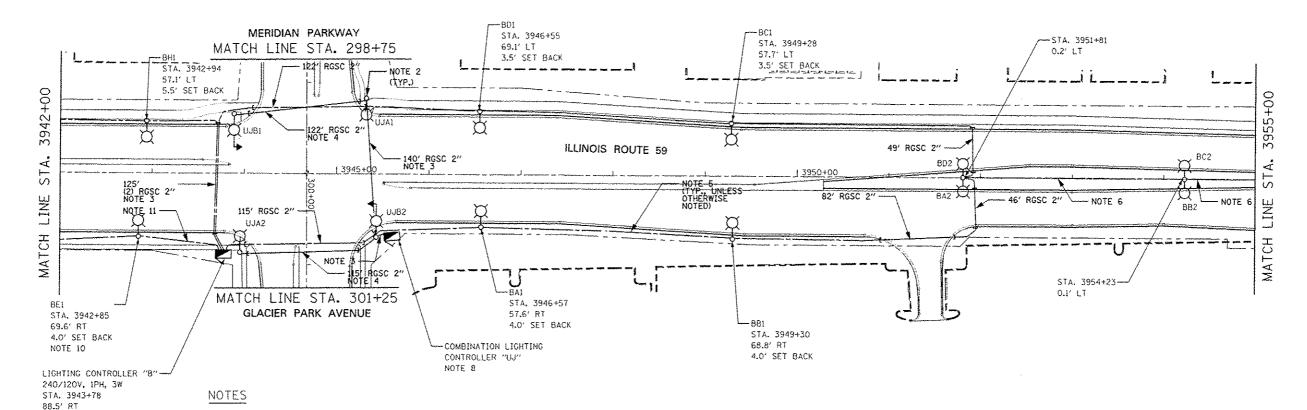


1. FOR SYMBOL LIST AND ABBREVIATIONS, SEE SHEET LT-OI.


NOTE 9

- 2. COMBINATION TRAFFIC SIGNAL LIGHTING POLES SHALL BE INSTALLED UNDER IRAFFIC SIGNAL CONTROL WORK. SEE IRAFFIC SIGNAL PLANS.


  LUMINAIRE SHALL BE PAID FOR UNDER ELECTRICAL WORK.
- UNIT DUCT, 600V. 4-1C NO.8, 1/C NO.8 GROUND, (XLP-TYPE USE), 1" DIA. POLYETHYLENE.
- UNIT DUCT, 600V, 2-1C NO.8, 1/C NO.8 GROUND, (XLP-TYPE USE), 3/4" DIA, POLYETHYLENE,
- 5. UNIT DUCT, 600V. TIC NO.4, 1/C NO.6 GROUND. (XLP-TYPE USE), 1 1/4" DIA. POLYETHYLENE.
- 6. UNIT DUCT, 600V. (B)1C NO.4, 1/C NO.6 GROUND. (XLP-TYPE USE), 1 1/2" DIA. POLYETHYLENE.
- POLE SET-BACK SHALL BE MEASURED FROM THE BACK OF THE CURB TO THE CENTER OF THE POLE/BASE.
- 8. COMBINATION LIGHTING CONTROLLER SHALL BE ATTACHED TO TRAFFIC SIGNAL CONTROL CABINET. SEE EXACT LOCATION ON TRAFFIC SIGNAL PLANS. CONTROLLER OWNED AND MAINTAINED BY 1.D.O.T..
- CONTROLLER OWNED AND MAINTAINED BY CITY OF NAPERVILLE. POWER SHALL BE SUPPLIED BY NAPERVILLE ELECTRIC DEPARTMENT (NED) AND NED REQUIREMENTS FOR INSTALLATION SHALL BE MET.
- 10. PROVIDE A LOCKING-TYPE RECEPTACLE ON THE FIXTURE. INSTALL LOCKING-TYPE PHOTOELECTRIC CONTROL ON TOP OF LUMINAIRE AND WIRE IT TO THE LIGHTING CONTROLLER FOLLOWING THE CITY OF NAPERVILLE STANDARDS, PARTS AND WORK SHALL BE INCLUDED IN THE "PHOTOCELL" PAY ITEM.
- UNIT DUCT, 600V, 4-1C NO.4, 3-1C NO.10, 1/C NO.6 GROUND, (XLP-TYPE USE), 1 1/2" DIA. POLYETHYLENE.
- SEE DISTRICT 1 DETAIL BE-230 FOR COMBINATION LIGHTING AND TRAFFIC SIGNAL ELECTRIC SERVICE DISCONNECT.

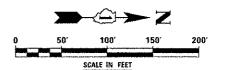


DESIGNED MC/P	REVISED - ADDENDUM A 02/20/2013			F.A.P. RTE. SECTION COUNTY SHEETS NO.
ORAWN MLB	REVISED ~	STATE OF ILLINOIS	LIGHTING PLAN — ILLINOIS ROUTE 59	338 (112 & 113) WRS-7 OUPAGE 1156 785
CHECKED MCP	REVISED -	DEPARTMENT OF TRANSPORTATION		LT-15 CONTRACT NO. 60R30
DATE 12/14/2012	REVISED -		SCALE: AS SHOWN SHEET NO. 4 OF 15 SHEETS STA. TO STA.	ILLINOIS FEO. AND PROJECT

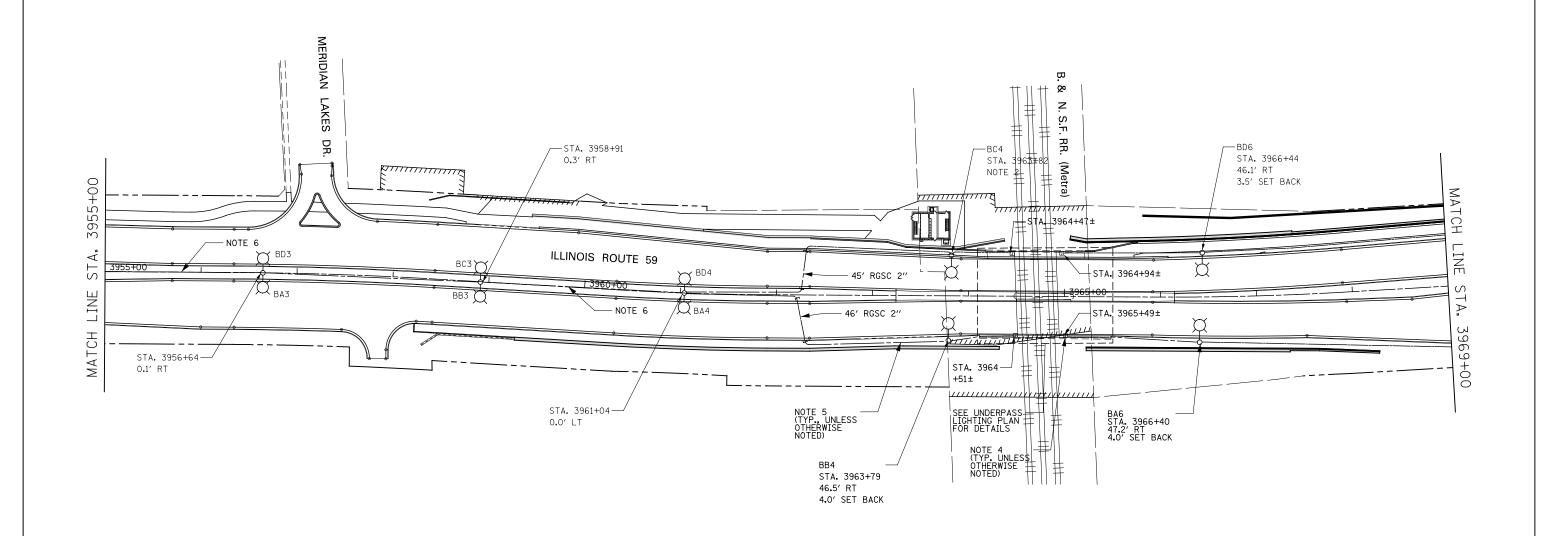



- 1. FOR SYMBOL LIST AND ABBREVIATIONS, SEE SHEET LT-01.
- LIGHTING UNIT INSTALLED ON LIGHT POLE FOUNDATION, SPECIAL. SEE ROADWAY DETAILS AND SCHEDULE OF QUANTITIES.
- 3. POLE SET-BACK SHALL BE MEASURED FROM THE BACK OF THE CURB TO THE CENTER OF THE POLE/BASE.
- 4. JUNCTION BOX, STAINLESS STEEL, ATTACHED TO STRUCTURE, 12" X 12" X 6".
- 5. UNIT DUCT, 600V, 4-1C NO.4, 1/C NO.6 GROUND, (XLP-TYPE USE), 1 1/2" DIA. POLYETHYLENE.
- 6. UNIT DUCT, 600V, 8-1C NO.4, 1/C NO.6 GROUND, (XLP-TYPE USE), 1 1/2" DIA, POLYETHYLENE.

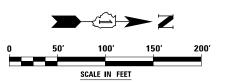


	DESIGNED MCP	REVISED -			F.A.P. RTE.	SECTION	COUNTY TOTAL SHEETS NO.	1
	DRAWN MLB	REVISED -	STATE OF ILLINOIS	LIGHTING PLAN — ILLINOIS ROUTE 59	338	(112 & 113) WRS-7	DUPAGE 1156 786	1
	CHECKED MCP	REVISED -	DEPARTMENT OF TRANSPORTATION			LT-16	CONTRACT NO. 60R30	1
	DATE 12/14/2012	REVISED -		SCALE: AS SHOWN   SHEET NO. 5 OF 15 SHEETS   STA. TO STA.		ILLINOIS FED. AI	ID PROJECT	7

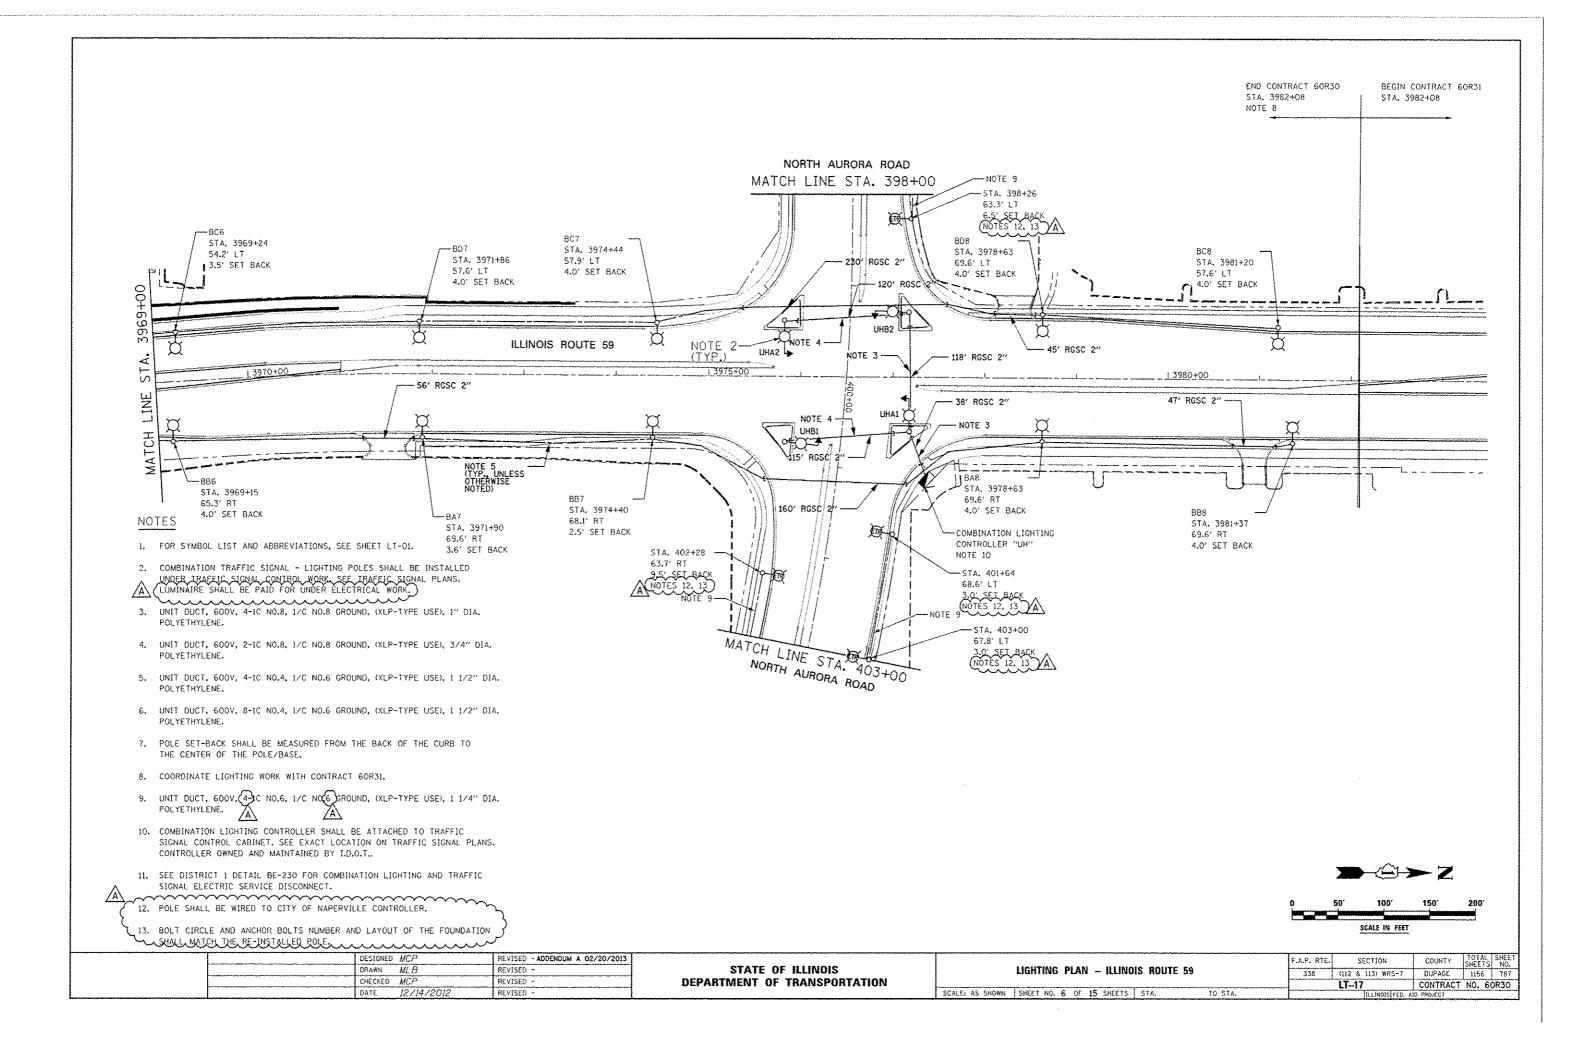

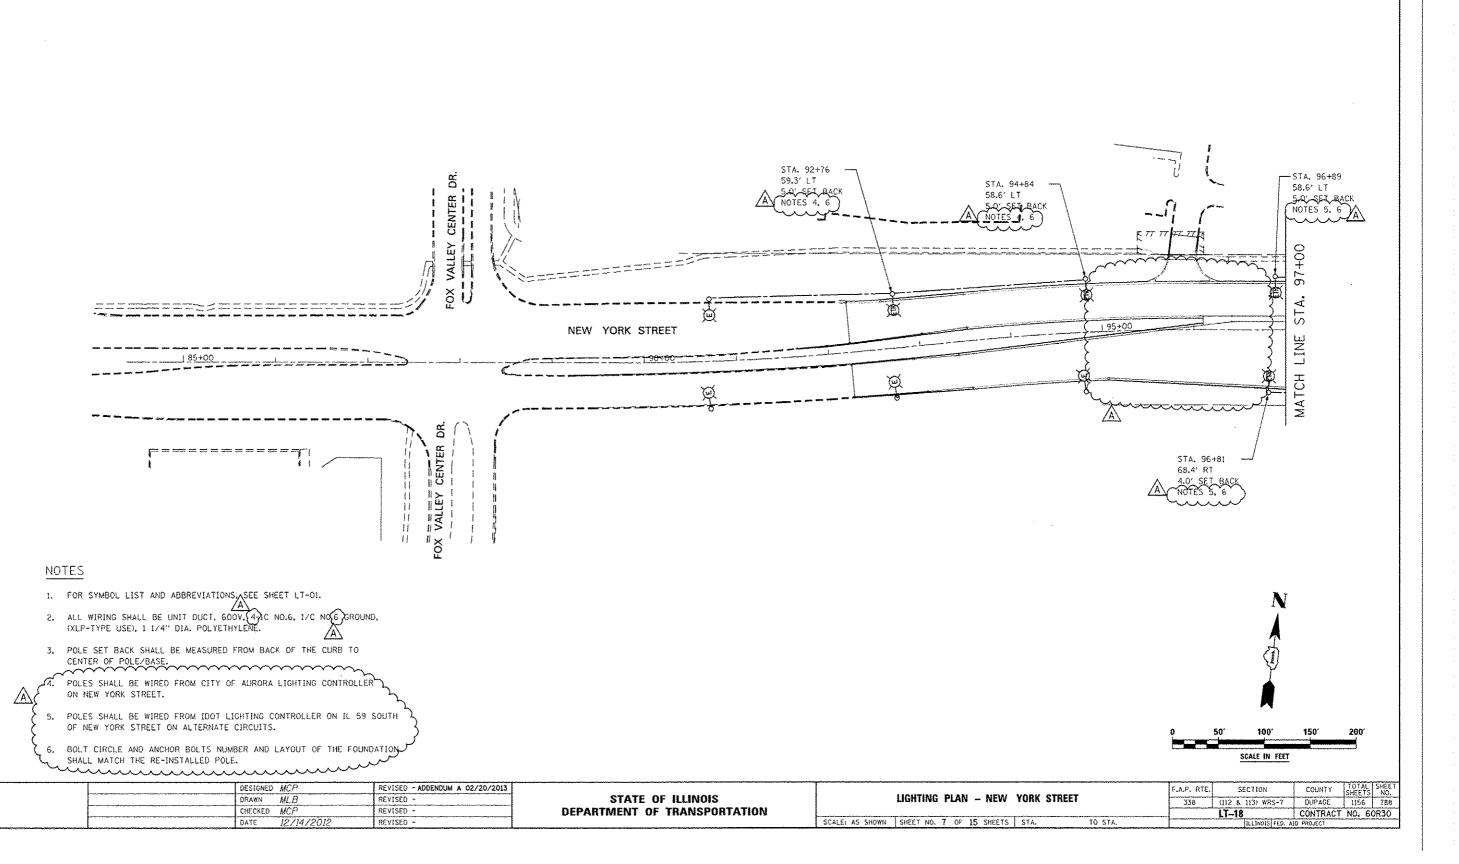

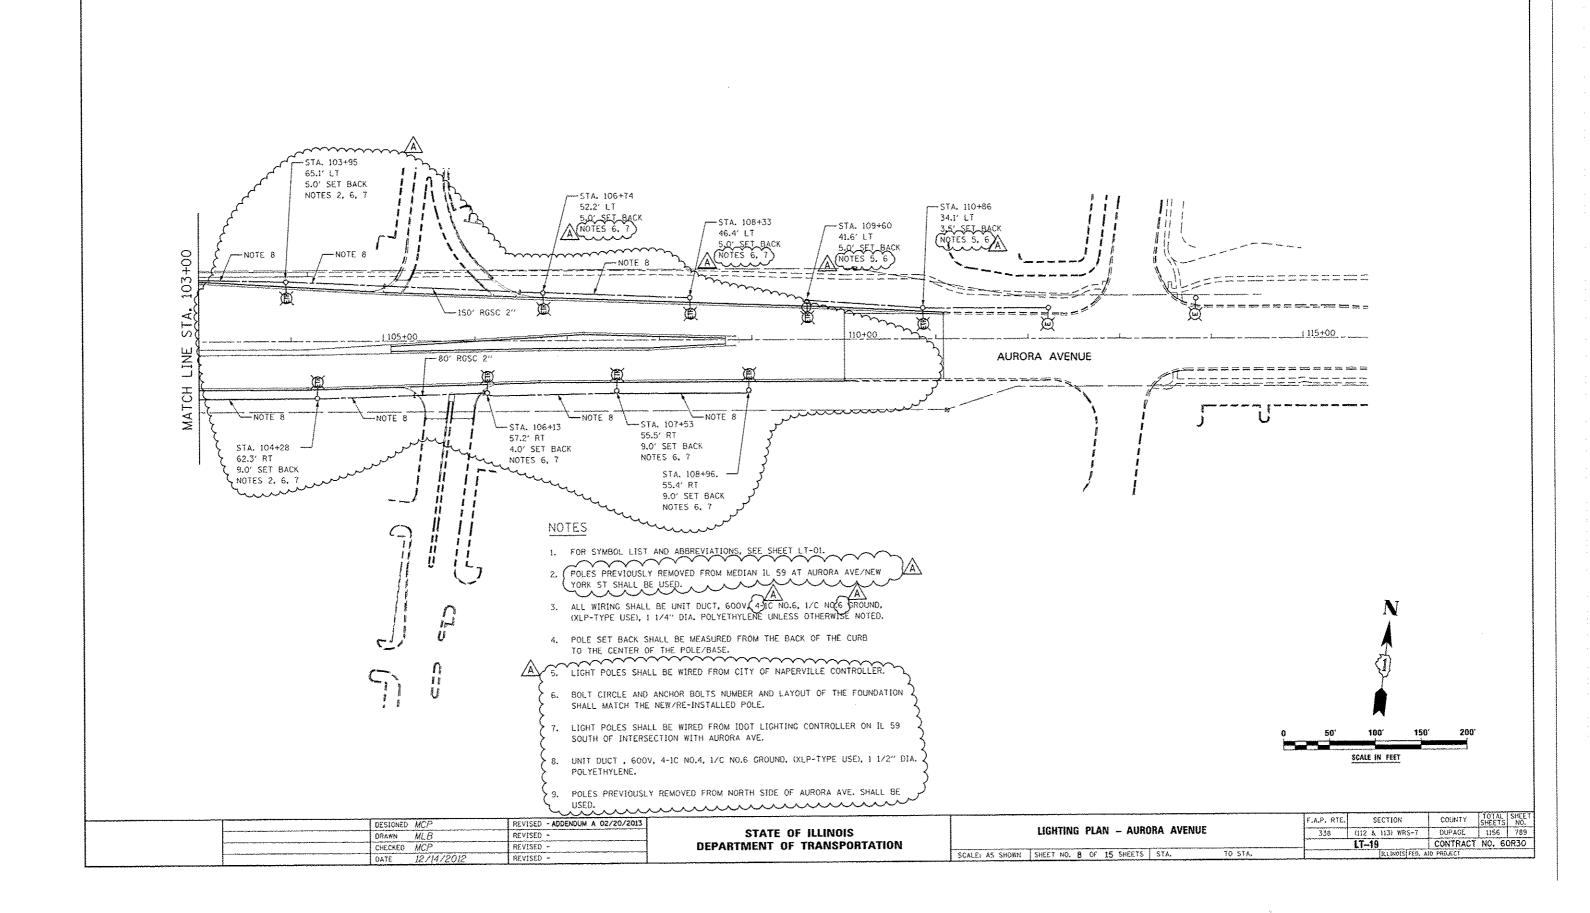

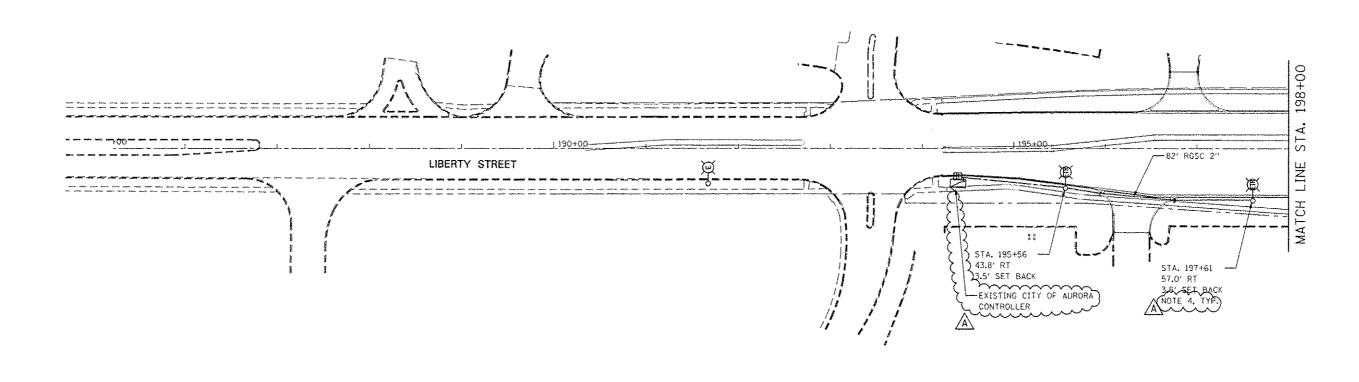

- 1. FOR SYMBOL LIST AND ABBREVIATIONS, SEE SHEET LT-01.

  2. ALL WIRING SHALL BE UNIT DUCT, 600V, 41C NO.6, 1/C NO.6 GROUND, (XLP-TYPE USE), 1 1/4" DIA. POLYETHYLENE.
- 3. POLE SET BACK SHALL BE MEASURED FROM BACK OF THE CURB TO CENTER OF THE POLE/BASE.
- 4. BOILT CIRCLE AND ANCHOR BOLTS NUMBER AND LAYOUT OF THE FOUNDATION SHALL MATCH THE RE-INSTALLED POLE.


	N	•		
	7			
50'	100'	150'	200	
	SCALE IN FEE	[		


	DESIGNED	MCP	REVISED	- ADDENDUM A 02/20/2013
	DRAWN	MLB	REVISED	•
	CHECKED	MCP	REVISEO	-
	DATE	12/14/2012	REVISED	*

STATE OF ILLINOIS									
DEPARTMENT	0F	TRANSPORTATION							

	LIGHTING	PLAN	- LIBERTY STREET	г
SCALE: AS SHOWN	SHEET NO. 9	OF 15	SHEETS STA.	TO STA.

F.A.P. RTE.	SECTION	COUNTY	TOTAL SHEETS	SHEET NO.						
338	(112 & 113) WRS-7	DUPAGE	1156	790						
	LT-20	CONTRACT	NO. 6	0R30						
	THE BROTELEGY AND PROJECT									

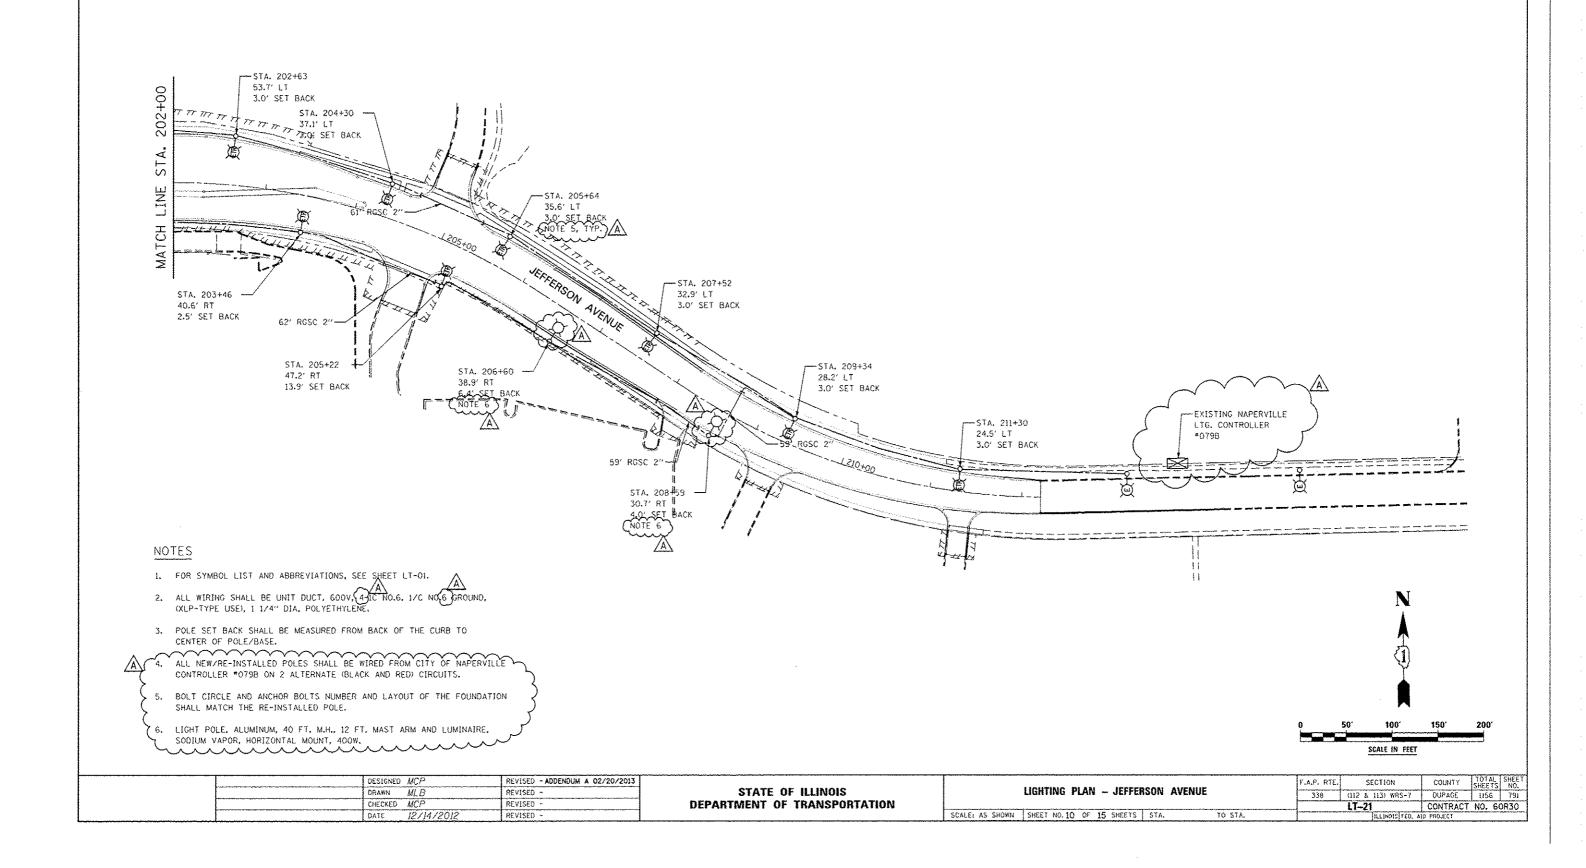

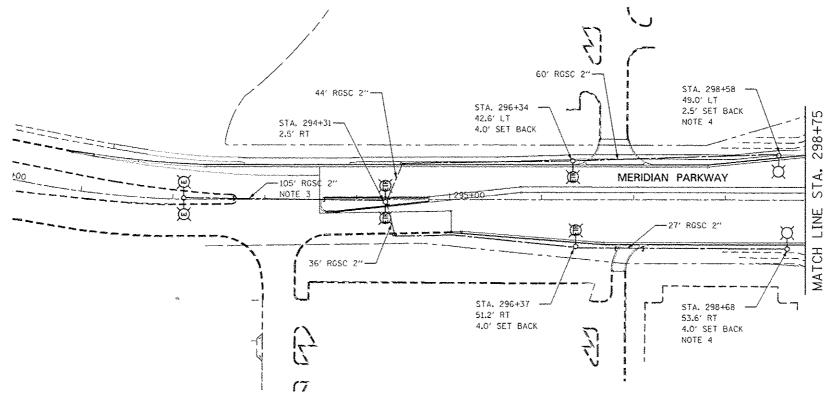

1. FOR SYMBOL LIST AND ABBREVIATIONS, SEE SHEET LT-01.

2. ALL WIRING SHALL BE UNIT DUCT, 600V 47C NO.6, 1/C NO.6 DROUND, (XLP-TYPE USE), 1 1/4" DIA. POLYETHYLENE.


- INSTALL NEW UNIT DUCT FROM THE EXISTING TO REMAIN LIGHT POLE TO NEW POLE LOCATION AS SHOWN,
- LIGHTING UNITS (POLE, BREAKAWAY DEVICE, MASTARM AND LUMINAIRE) SHALL BE PROVIDED BY CITY OF AURORA.
- POLE SET BACK SHALL BE MEASURED FROM BACK OF THE CURB TO CENTER OF THE POLE/BASE.

6. ALL RELOCATED POLES SHALL BE WIRED FROM CITY OF AURORA CONTROLLER.

7. BOLT CIRCLE AND ANCHOR BOLTS NUMBER AND LAYOUT OF THE FOUNDATION SHALL MATCH THE NE/RE-INSTALLED POLE.

		N A		
0	50′	100'	150'	200
		SCALE IN FEE		

 DESIG	NED MC	P	REVISED - ADDENDUM A 02/20/2013			f.	.A.P. RTE.	SECTION	COUNTY	TOTAL SHEET SHEETS NO.
DRAWN	N ML	В	REVISED -	STATE OF ILLINOIS	LIGHTING PLAN – MERIDIAN PARKWAY	-	338	(112 & 113) WRS-7	DUPAGE	1156 792
CHECK	KED MC	P	REVISED -	DEPARTMENT OF TRANSPORTATION				LT-22	CONTRAC	T NO. 60R30
 DATE	12.	/14/2012	REVISED -		SCALE: AS SHOWN SHEET NO. 11 OF 15 SHEETS STA.	TO STA.		ILLINOIS FED	AID PROJECT	

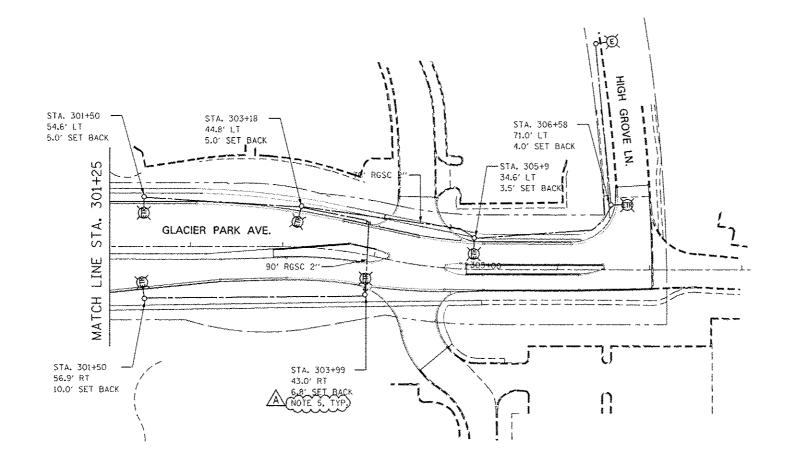

1. FOR SYMBOL LIST AND ABBREVIATIONS, SEE SHEET LT-01.

2. ALL WIRING SHALL BE UNIT DUCT, 600V. 41C NO.6, 1/C NO.6 GROUND. (XLP-TYPE USE), 1 1/4" DIA. POLYETHYLENE.


3. POLE SET BACK SHALL BE MEASURED FROM BACK OF THE CURB TO CENTER OF THE POLE/BASE.


ALL RELOCATED POLES SHALL BE WIRED FROM CITY OF NAPERVILLE CONTROLLER.

5. BOLT CIRCLE AND ANCHOR BOLTS NUMBER AND LAYOUT OF THE FOUNDATION SHALL MATCH THE RE-INSTALLED POLE.

		N A		
Ç	50'	100′	150	2001
		SCALE IN FEE		

	DESIGNED	MCP	REVISED - ADDENDUM A 02/20/2013			F.A.P. RTE.	SECTION	COUNTY	TOTAL S	HEET NO.
	DRAWN	MLB	REVISED -	STATE OF ILLINOIS	LIGHTING PLAN – GLACIER PARK DRIVE	338	(112 & 113) WRS-7	DUPAGE	1156	793
	CHECKED	MCP	REVISED -	DEPARTMENT OF TRANSPORTATION			LT-23	CONTRACT	NO. 60F	30
	DATE	12/14/2012	REVISED ~		SCALE: AS SHOWN SHEET NO. 12 OF 15 SHEETS STA. TO STA.		JELINOIS FED.	AID PROJECT		

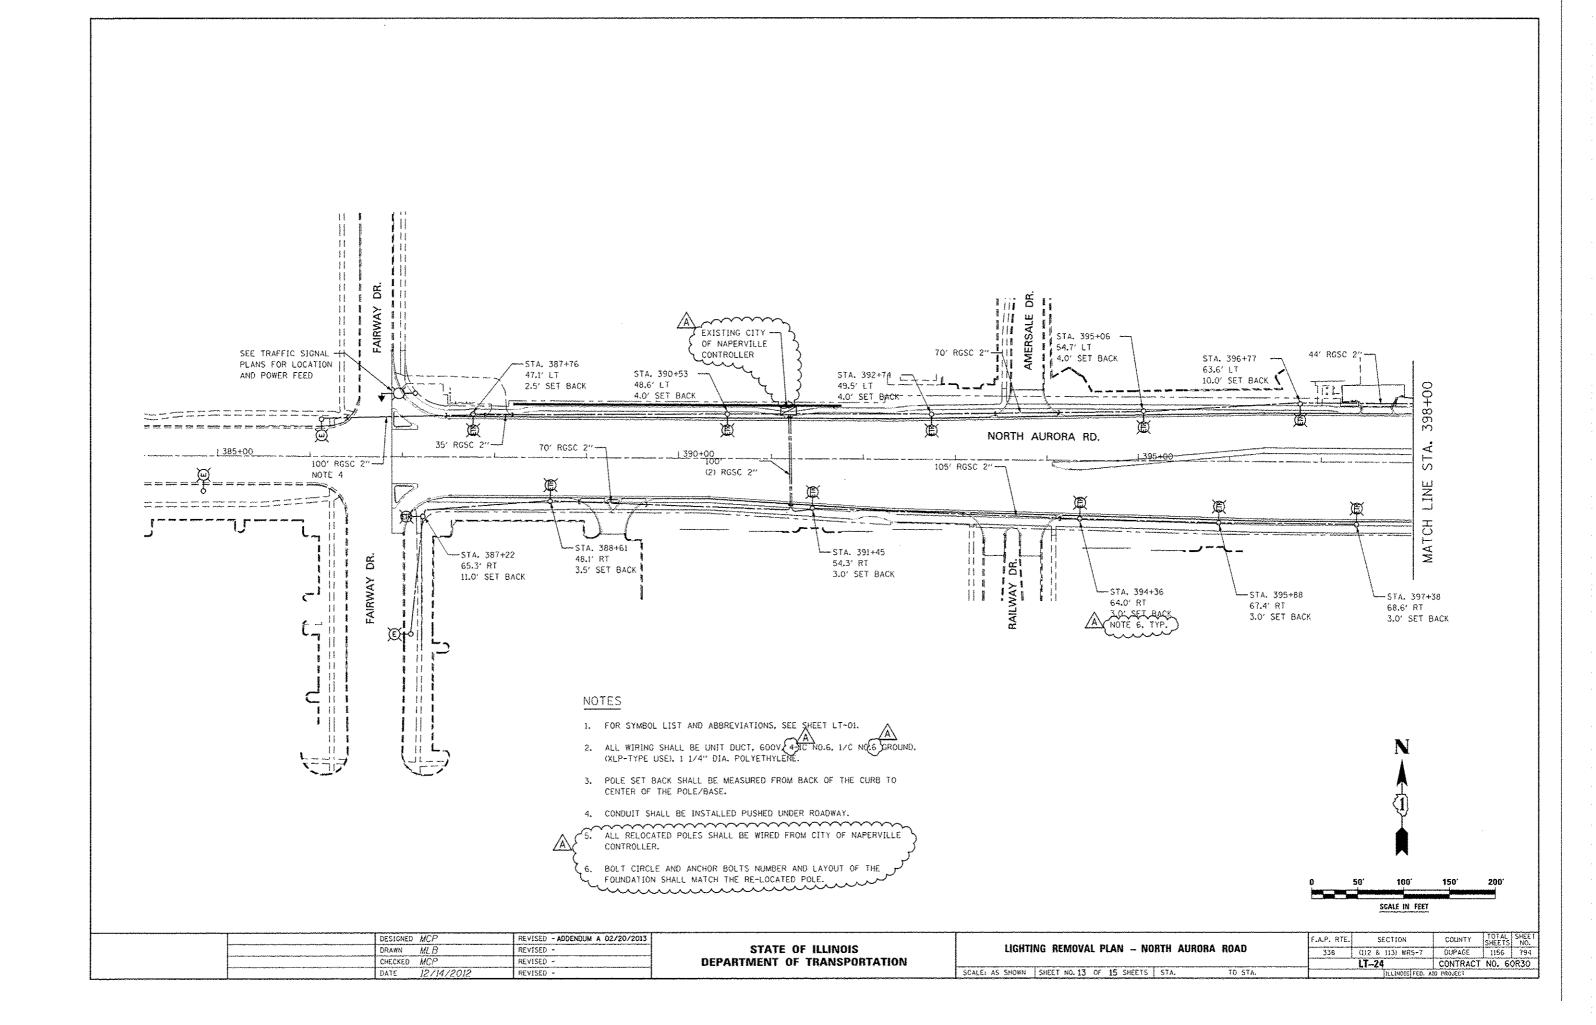


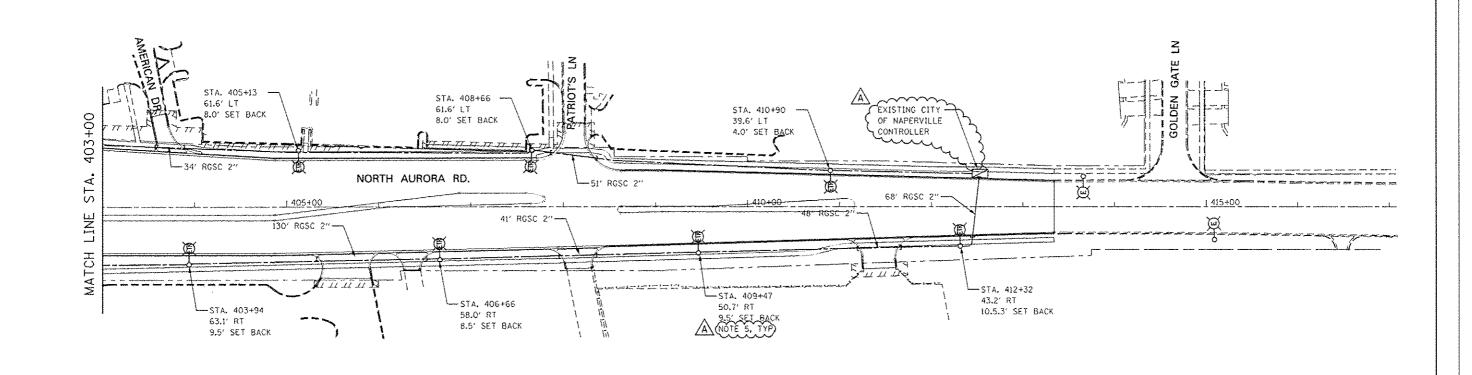

- 1. FOR SYMBOL LIST AND ABBREVIATIONS, SEE SHEET LT-OL.
- 2. ALL WIRING SHALL BE UNIT DUCT, 600V, 41C NO.6, 1/C NO.6 GROUND, (XLP-TYPE USE), 1 1/4" DIA. POLYETHYLENE.
- 3, POLE SET BACK SHALL BE MEASURED FROM BACK OF THE CURB TO CENTER OF THE POLE/BASE.

4. ALL RELOCATED POLES SHALL BE WIRED FROM CITY OF NAPERVILLE CONTROLLER.

5. BOLT CIRCLE AND ANCHOR BOLTS NUMBER AND LAYOUT OF THE FOUNDATION SHALL MATCH THE RE-INSTALLED POLE.

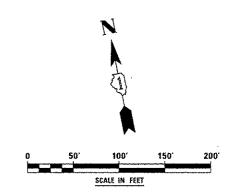



<u>-</u>	DESIGNED	MCP	REVISED	- ADDENDUM A 02/20/2013
	DRAWN	MLB	REVISED	-
	CHECKED	MCP	REVISED	•
- 1	DATE	12/14/2012	REVISED	•

STATE OF ILLINOIS
DEPARTMENT OF TRANSPORTATION

LIGHTING PLAN - NORTH AURORA ROAD

SCALE: AS SHOWN | SHEET NO. 14 OF 15 SHEETS | STA. TO

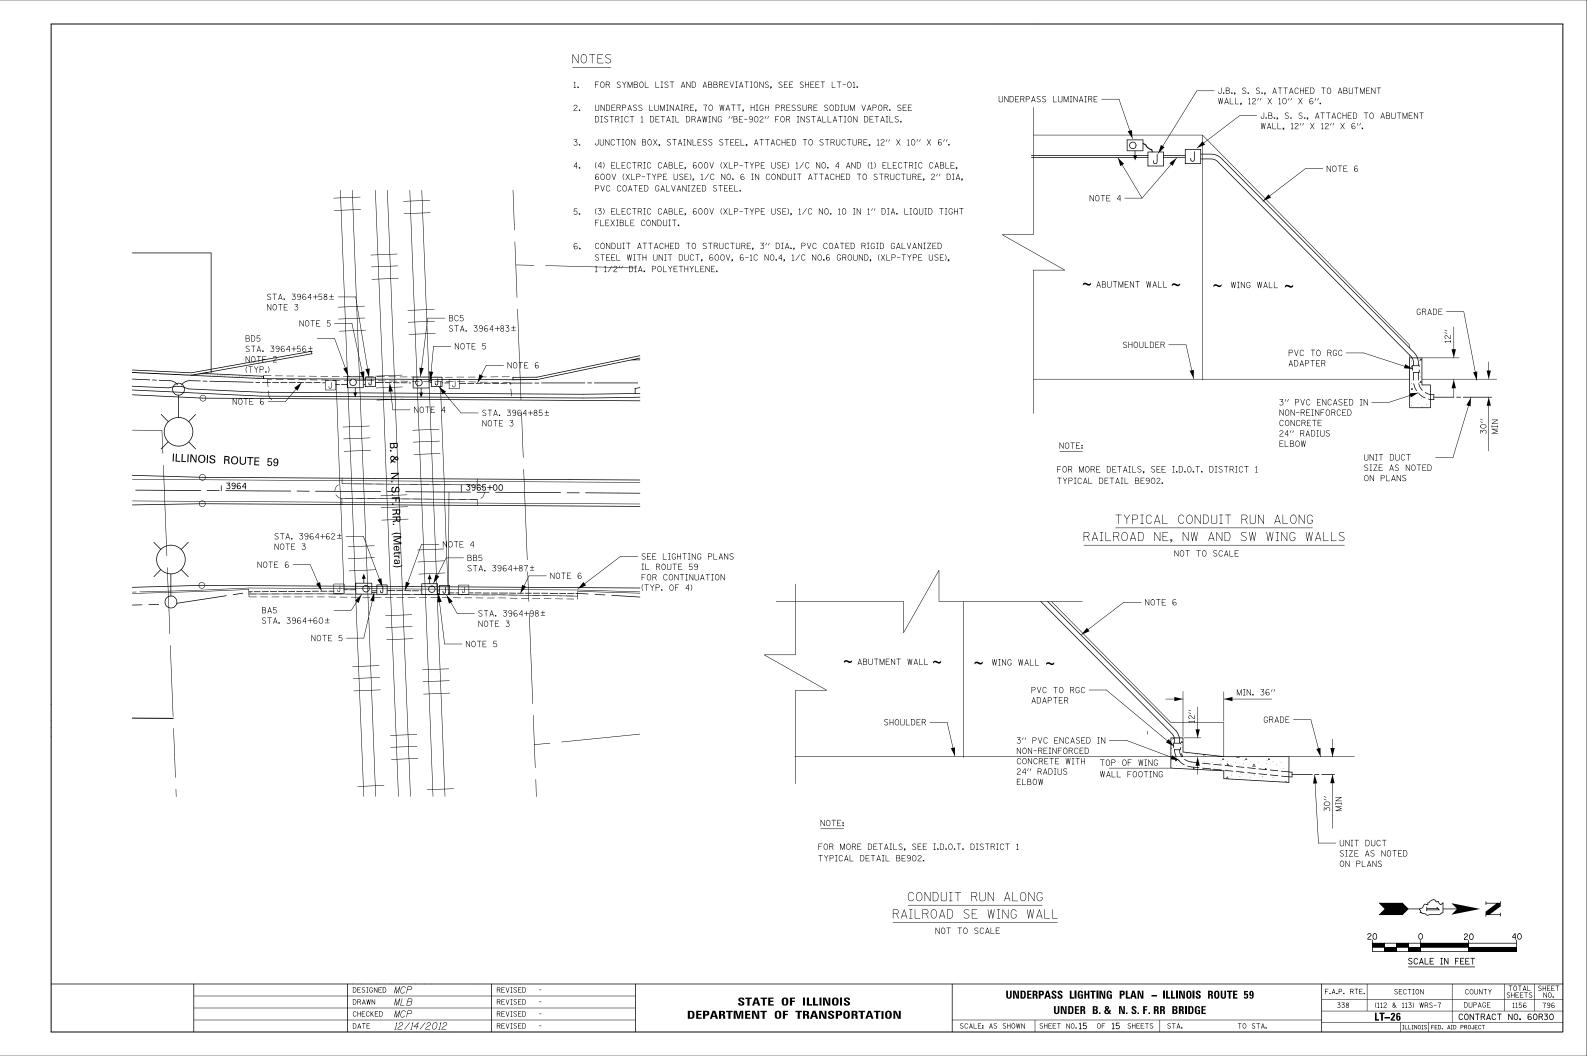

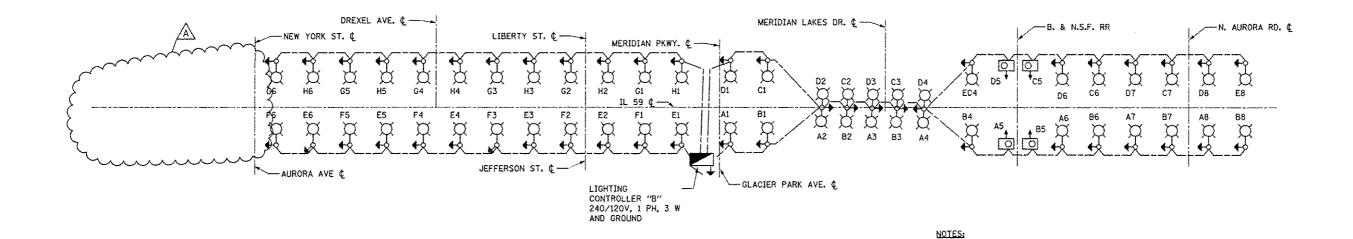

LIGHTING CONTROLLER "B" SINGLE LINE DIAGRAM NOT TO SCALE


PANEL SCHEDULE AND LOAD TABULATION LIGHTING CONTROLLER "B" 120/240VAC, 1-PHASE, 3-WIRE MAIN BREAKER: 200A BREAKER CIRCUIT TRIP AMPS RED BLACK 40-2P 6,72 6.72 6,72 6,72 40-2P 6,72 6,72 6.72 5.5 Đ 40-2P 40-2P 40-2P 5,5 5.5 5.5 5.5 40-2P 5.5 5.5 40-2P 93.8

1. FOR SYMBOL LIST AND GENERAL ELECTRICAL NOTES, SEE SHEET LT-01.

		DESIGNED	ROT	REVISED - ADDENDUM A 02/20/2013	STATE OF ILLINOIS DEPARTMENT OF TRANSPORTATION	CHICLE THE DIACOAR			F.A.P. RTE.	SECTION	COUNTY	TOTAL SHEET		
		DRAWN	MEB	REVISED -			SHARE CUME DIAGRAM			338	(112 & 113) WRS-7	DUPAGE	1156 797	
		CHECKED	MORP	REVISED -		Littling outstocker a				LT-27	CONTRACT	NO. 60R30		
		DATE	12/14/2012	REVISED -		SCALE: AS SHOWN	SHEET NO. 1 OF	1 SHEETS	STA.	TO STA.		H.LINOIS FED. A	D PROJECT	

#### IL 59 LIGHTING BILL OF MATERIAL UNIT OF QTY. DESIGNATION JEFFERSON AVE INTERSECTIONS LIGHTING BILL OF MATERIAL MEASURE NEW YORK ST/AURORA AVE @ IL 59 DESIGNATION UNIT OF QTY. FLECTRIC SERVICE INSTALLATION FACH 2309 FOOT MEASURE UNDERGROUND CONDUIT, GALVANIZED STEEL, 2" DIA. DESIGNATION CONDUIT ATTACHED TO STRUCTURE, 2" DIA., PVC COATED GALVANIZED STEEL CONDUIT ATTACHED TO STRUCTURE, 3" DIA., PVC COATED GALVANIZED STEEL JUNCTION BOX, STAINLESS STEEL, ATTACHED TO STRUCTURE, 12"X10"X6" FOOT 145 LINIT OF QTY. LINDERGROUND-COMDITY GALVANIZED STEEL 2" DIA FOOT **↓**80 MEASURE 169 FOOT BREAKAWAY DEVICE, TRANSFORMER BASE, 15 INCH BOLT CIRCLE EACH 2 UNIT DUCT, 600V, 491C NO.6, 1/C NO.6 GROUND, (XLP-TYPE USE), 1 1/4" DIA. FOOT 840 ROLYEUHYLENE UNIT DUCT, 600V, 2-10 NO.8, 1/C NO.8 GROUND, (XLP-TYPE USE), 3/4" DIA. 132 F001 FACH POLYETHYLENE JUNCTION BOX, STAINLESS STEEL, ATTACHED TO STRUCTURE, 12"X12"X6 EACH UNIT DUCT, 600V, 4-1C NO.8, 1/C NO.8 GROUND, (XLP-TYPE USE), 3/4" DIA. F001 403 FOOT 14032 UNIT DUCT, 600V, 4-IC NO.4, 1/C NO.6 GROUND, (XLP-TYPE USE)(1 1/2")DIA. LIGHT POLE, ALUMINUM, 40 FT. M.H., 12 FT. MAST ARM LUMINAIRE, SODIUM VAPOR, HORIZONTAL MOUNT, 400 WATT EACH POLYETHYLENE POLYETHYLENE 967 A 2 1298 EACH COMBINATION LIGHTING CONTROLLER EACH UNIT DUCT, 600V, 8-1C NO.4, 1/C NO.6 GROUND, (XLP-TYPE USE), 1 1/2" DIA. FOOT UNIT DUCT, GOOV, 410 NO.6, 170 NO.6 GROUND, (XLP-TYPE USE), 1 174" DIA UNDERGROUND CONDUIT, GALVANIZED STEEL, 2" DIA FOOT 400 POLYETHYLENE POLYFTHYLENE ELECTRIC SERVICE DISCONNECT, LIGHTING AND TRAFFIC SIGNAL EACH UNIT DUCT, 600V, 4-10 NO.4, 3-10 NO.10, 1/0 NO.6 GROUND, (XLP-TYPE USE), FOOT 165 108 IGHT POLE FOUNDATION, 24" DIAMETER FOOT 1 1/2" DIA, POLYETHYLENE RELOC REMOVAL OF LIGHTING UNIT, SALVAGE EACH ELECTRIC CABLE IN CONDUIT, 600V (XLP-TYPE USE) 1/C NO. 10 (10) 81 MEIJER ENTRANCE/WESTRIDGE CT @ IL 59 ELECTRIC CABLE IN CONDUIT, 600V (XLP-TYPE USE) 1/C NO. 6 FOOT REMOVAL OF POLE FOUNDATION EACH ELECTRIC CABLE IN CONDUIT, GOOV (XLP-TYPE USE) I/C NO. 4 LUMINAIRE, SODIUM VAPOR, HORIZONTAL MOUNT, 400 WATT UNDERPASS LUMINAIRE, 70 WATT, HIGH PRESSURE SODIUM VAPOR FOOT LIGHTING UNIT. INSTALL ONLY EACH FACH UNDERGROUND CONDUIT, GALVANIZED STEEL, 2" DIA FOOT DESIGNATION QTY. UNIT OF EACH MEASURE EACH LIGHTING CONTROLLER, SPECIAL 123 UNIT DUCT, 600V, 2-1C NO.8, 1/C NO.8 GROUND, (XLP-TYPE USE), 3/4" DIA FOOT 44 LIGHT POLE, ALUMINUM, 47.5 FT. M.H., 12 FT. MAST ARM EACH POLYETHYLENE EACH 5 FOOT (432) LIGHT POLE, ALUMINUM, 47.5 FT. M.H., 2-12 FT. MAST ARM FOOT 308 UNIT DUCT, 600V, 4-1C NO.8, 1/C NO.8 GROUND, (XLP-TYPE USE), 3/4" DIA, LIGHT POLE FOUNDATION, 24" DIAMETER POLYETHYLENE MERIDIAN PARKWAY BREAKAWAY DEVICE, TRANSFORMER BASE, 15 INCH BOLT CIRCLE EACH COMBINATION LIGHTING CONTROLLER EACH REMOVAL OF LIGHTING UNIT, SALVAGE EACH 311 REMOVAL OF POLE FOUNDATION PHOTOCELL UNDERGROUND CONDUIT, GALVANIZED STEEL, 2" DIA FOOT EAGU 15 DESIGNATION UNIT OF QTY. ELECTRIC SERVICE DISCONNECT, LIGHTING AND TRAFFIC SIGNAL MEASURE FACH 446HANG-1NAS-4NG-1AH-6NAS-4NG-4 **MEACH** NEW FOOT (78) LUMINAIRE SAFETY CABLE ASSEMBLY LIBERTY ST/JEFFERSON AVE @ IL 59 UNIT DUCT, 600Y, (4)1C NO.6, 1/C NO.6)GROUND, (XLP-TYPE USE), 1 1/4" DIA. FOOT 1098 CAL MO 12 MAINTENANCE OF LIGHTING SYSTEM POLYETHYLENE LIGHT POLE FOUNDATION, 24" DIAMETER FOOT 45 DESIGNATION QTY. UNIT OF SIDE STREETS LIGHTING BILL OF MATERIAL RELOC REMOVAL OF LIGHTING UNIT, SALVAGE EACH MEASURE REMOVAL OF POLE FOUNDATION EACH 3 UNIT DUCT, 600V, 2-1C NO.8, 1/C NO.8 GROUND, (XLP-TYPE USE), 3/4" DIA. F001 325 LIGHTING UNIT, INSTALL ONLY EACH NEW YORK ST. 272 UNDERGROUND CONDUIT, GALVANIZED STEEL, 2" DIA. FOOT UNIT DUCT, 600V, 4-10 NO.8, 1/C NO.8 GROUND, (XLP-TYPE USE), 3/4" DIA. FOOT 210 POLYETHYLENE DESIGNATION UNIT OF QTY. COMBINATION LIGHTING CONTROLLER MEASURE GLACIER PARK AVE UNDERGROUND CONDUIT, GALVANIZED STEEL, 2" DIA FOOT 398 NEW ELECTRIC SERVICE DISCONNECT, LIGHTING AND TRAFFIC SIGNAL UNIT DUCT, 600V,(4)IC NO.6, 1/C NO.6 GROUND, (XLP-TYPE USE), 1 1/4" DIA. POL VETHYLENE UNIT DUCT, 600V. 4-10 OTY. DESIGNATION UNIT OF **€**65 FOOT MEASURE MERIDIAN PKWY/GLACIER PARK AVE @ IL 59 POLYETHYLENE NEW IGHT POLE FOUNDATION, ZA" DIAMETER UNIT DUCT, 600V.(4)1C NO.6, 1/C NO.6)CROUND, (XLP-TYPE USE), 1 1/4" DIA. FOOT 1200 DESIGNATION QTY. LINIT OF REMOVAL OF LIGHTING UNIT, SALVAGE EACH POLYETHYLENE MEASURE REMOVAL OF POLE FOUNDATION EACH 6 UNIT DUCT, 600V, 2-10 NO.8, 1/C NO.8 GROUND, (XLP-TYPE USE), 3/4" DIA. FOOT 218 IGHT POLE FOUNDATION, 24" DIAMETER FOOT 54 EACH 6 RELO IGHTING UNIT, INSTALL ONLY POLYETHYLENE REMOVAL OF LIGHTING UNIT, SALVAGE EACH 200 A FOOT 191 FOOT INDERGROUND CONDUIT, GALVANIZED STEEL, 2" DIA. UNIT DUCT, 600V, 4-1C NO.8, 1/C NO.8 GROUND, (XLP-TYPE USE), 3/4" DIA. REMOVAL OF POLE FOUNDATION EACH POLYETHYLENE IGHTING UNIT, INSTALL ONLY EACH AURORA AVE COMBINATION LIGHTING CONTROLLER 160 UNDERGROUND CONDUIT, GALVANIZED STEEL, 2" DIA. FOOT 377 UNDERGROUND CONDUIT, GALVANIZED STEEL, 2" DIA. FOOT DESIGNATION UNIT OF QTY. ELECTRIC SERVICE DISCONNECT, LIGHTING AND TRAFFIC SIGNAL EACH NORTH AURORA RD UNIT OF QTY. NORTH AURORA AVE @ IL 59 DESIGNATION MEASURE DESIGNATION UNIT OF OTY. NEW /a\ MEASURE UNIT DUCT, 600V. 4)1C NO.6, 1/C NO.6)GROUND. (XLP-TYPE USE). 1 1/4" DIA 5060 FOOT UNIT DUCT. 600V. 2-1C NO.8. 1/C NO.8 GROUND. (XLP-TYPE USE). 3/4" DIA FOOT 290 POLYETHYLENE ÛNIT DOCT, 600V, (471C NO.S. 17C NO.S) OROUND, (XLP-TYPE ÛSE), Y 174" DIÂ. POLYETHYLENE 198 LIGHT POLE FOUNDATION, 24" DIAMETER FOOT $\widehat{217}$ POLYETHYLENE UNIT DUCT, 600V, 4-1C NO.4, 1/C NO.6 GROUND, (XLP-TYPE USE), 1 1/2" DIA. UNIT DUCT, 600V, 4-1C NO.8, 1/C NO.8 GROUND, (XLP-TYPE USE), 3/4" DIA. F001 23 REMOVAL OF LIGHTING UNIT, SALVAGE EACH FOOT POLYETHYLENE 23 POLYETHYLENE LIGHT POLE FOUNDATION, 24" DIAMETER REMOVAL OF POLE FOUNDATION EACH COMBINATION LIGHTING CONTROLLER FACH 22 961 LIGHTING UNIT, INSTALL ONLY EACH 391 .99 / UNDERGROUND CONDUIT, GALVANIZED STEEL, 2" DIA. FOOT FOOT UNDERGROUND CONDUIT, GALVANIZED STEEL, 2" DIA. EDOT REMOVAL OF LIGHTING UNIT, SALVAGE EACH ELECTRIC SERVICE DISCONNECT, LIGHTING AND TRAFFIC SIGNAL FACH EACH REMOVAL OF POLE FOUNDATION LIGHTING UNIT, INSTALL ONLY EACH 430 FOOT UNDERGROUND CONDUIT, GALVANIZED STEEL, 2" DIA. LIBERTY ST DESIGNATION UNIT OF QTY. MEASURE NEW JNIT DUCT, 600V, 431C NO.6, 1/C NO.6) GROUND, (XLP-TYPE USE), 1 1/4" DIA. FOOT 353 POLYETHYLENE LIGHT POLE FOUNDATION, 24" DIAMETER FOOT RELOC REMOVAL OF LIGHTING UNIT, SALVAGE EACH 2 REMOVAL OF POLE FOUNDATION EACH LIGHTING UNIT, INSTALL ONLY EACH UNDERGROUND CONDUIT, GALVANIZED STEEL, 2" DIA 82 DESIGNED MCP REVISED - ADDENDUM A 02/20/2013 F.A.P. RTF. SECTION COUNTY STATE OF ILLINOIS DRAWN MLE REVISED -**BILL OF MATERIALS** DUPAGE 1156 798 (112 & 113) WRS-7 CHECKED MCP REVISED . DEPARTMENT OF TRANSPORTATION LT-28 CONTRACT NO. 60R30 12/14/2012 REVISEO SCALE: AS SHOWN SHEET NO. 1 OF 1 SHEETS STA. TO STA. DATE

#### PANEL EQUIPMENT

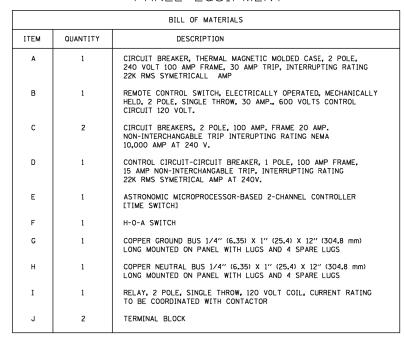

-SEE TRAFFIC SIGNAL CABINET DETAIL

TO SERVICE DISCONNECT

SERVICE CONDUCTORS

# TYPICAL LIGHTING LAYOUT

(NOT TO SCALE)

# POLE WIRING DETAIL (NOT TO SCALE)

STANDARD-TYPE SMALL DIMENSION DOUBLE POLE FUSEHOLDER WITH INSULATED BOOTS, FUSING AND (SEE SPECS)

- CABLE SPLICE (TYP.)

PHASE CONDUCTORS, 600 V TYPE RHW,

SOLID COLOR, SIZE AS SPECIFIED (TYP.)

2-1/C #10 AWG, 600 V TYPE RHW, SOLID COLOR CODED CABLES

SPLICE GROUND WIRE AND PIGTAIL SAME SIZE EXTENSION TO POLE GROUNDING LUG

FROM


CABINET

INSULATED GROUND WIRE, 600 V TYPE RHW,

SOLID COLOR GREEN, SIZE AS SPECIFIED


UNIT DUCT (TYP)

GROUNDING LUG -

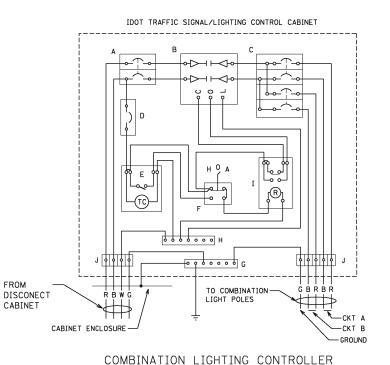

WIRING DIAGRAM

(NOT TO SCALE)

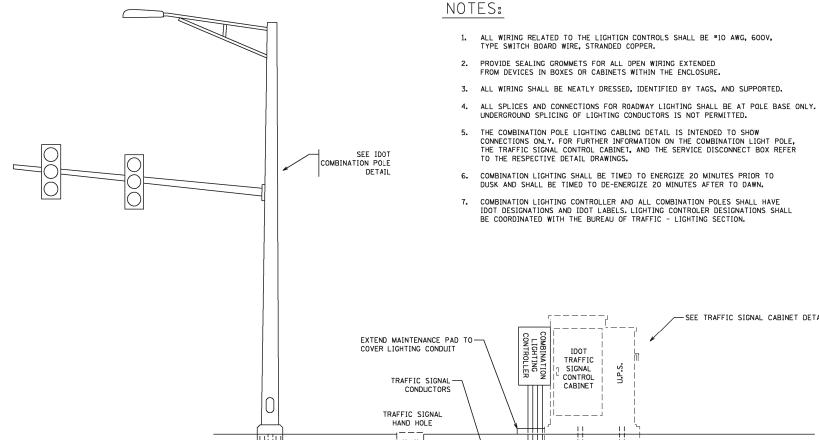

# COMBINATION POLE LIGHTING CABLING - TYPICAL

LIGHTING

CONDUCTORS

(NOT TO SCALE)

DESIGNED MCP	REVISED -			F.A.P. RTE. SECTION	COUNTY TOTAL SHEET
DRAWN <i>MLB</i>	REVISED -	STATE OF ILLINOIS	LIGHTING DETAILS	338 (112 & 113) WRS-7	DUPAGE 1156 799
CHECKED MCP	REVISED -	DEPARTMENT OF TRANSPORTATION		LT-29	CONTRACT NO. 60R30
DATE 12/14/2012	REVISED -		SCALE: AS SHOWN SHEET NO. 1 OF 3 SHEETS STA. TO STA.	ILLINOIS FED.	AID PROJECT

LIGHTING CONDUCTORS OUT TO

NEXT IDOT COMBINATION POLE

