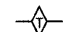

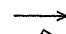
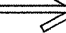
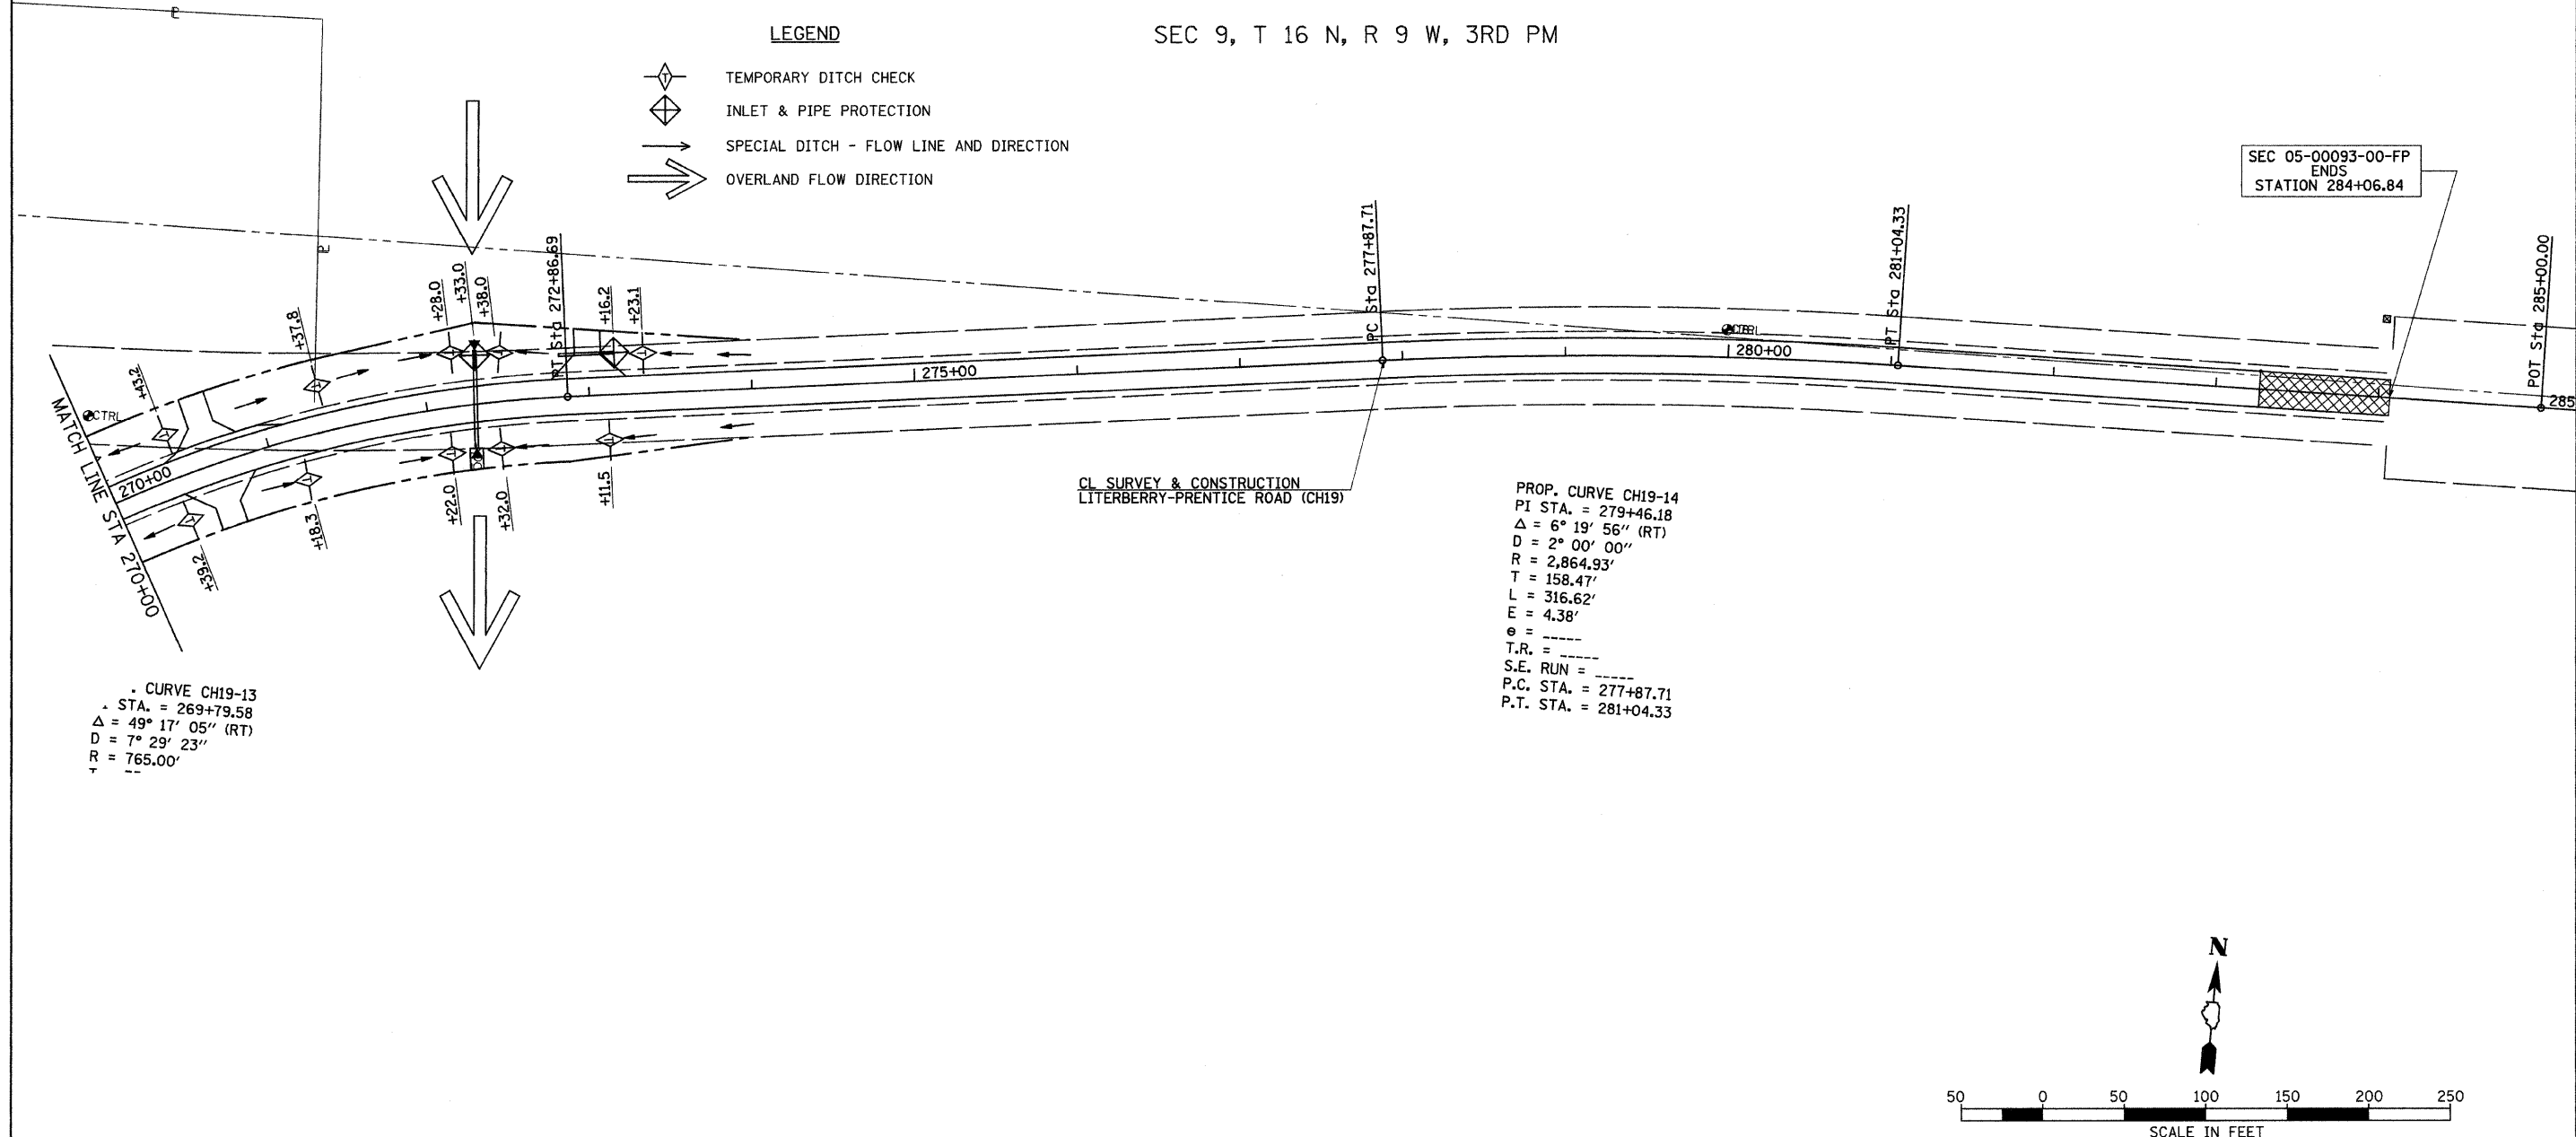


SEC 9, T 16 N, R 9 W, 3RD PM

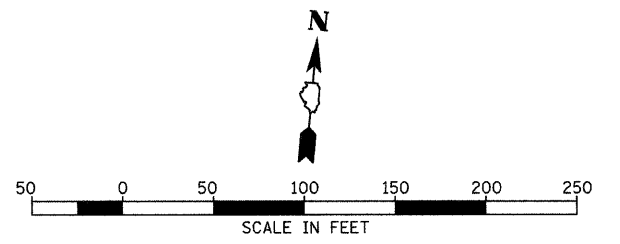
- LEGEND**
-  TEMPORARY DITCH CHECK
 -  INLET & PIPE PROTECTION
 -  SPECIAL DITCH - FLOW LINE AND DIRECTION
 -  OVERLAND FLOW DIRECTION



CL SURVEY & CONSTRUCTION
LITERBERRY-PRENTICE ROAD (CH19)

PROP. CURVE CH19-14
PI STA. = 279+46.18
Δ = 6° 19' 56'' (RT)
D = 2° 00' 00''
R = 2,864.93'
T = 158.47'
L = 316.62'
E = 4.38'
e = ---
T.R. = ---
S.E. RUN = ---
P.C. STA. = 277+87.71
P.T. STA. = 281+04.33

CURVE CH19-13
STA. = 269+79.58
Δ = 49° 17' 05'' (RT)
D = 7° 29' 23''
R = 765.00'



FILE NAME = v:\transportation\2839\2839E002.dgn	USER NAME = jolson	DESIGNED -	REVISED -
		DRAWN -	REVISED -
		CHECKED -	REVISED -
		DATE -	REVISED -

STATE OF ILLINOIS
DEPARTMENT OF TRANSPORTATION

LITERBERRY-PRENTICE ROAD (CH 19)
EROSION CONTROL

SCALE: 1" = 50'-0" SHEET NO. 2 OF 2 SHEETS STA. 270+00.00 TO STA. 284+06.84

F.A.S. RTE.	SECTION	COUNTY	TOTAL SHEETS	SHEET NO.
611	05-00093-03-FP	MORGAN	31	13
CONTRACT NO. 9 3 5 3 5				
ILLINOIS FED. AID PROJECT				