


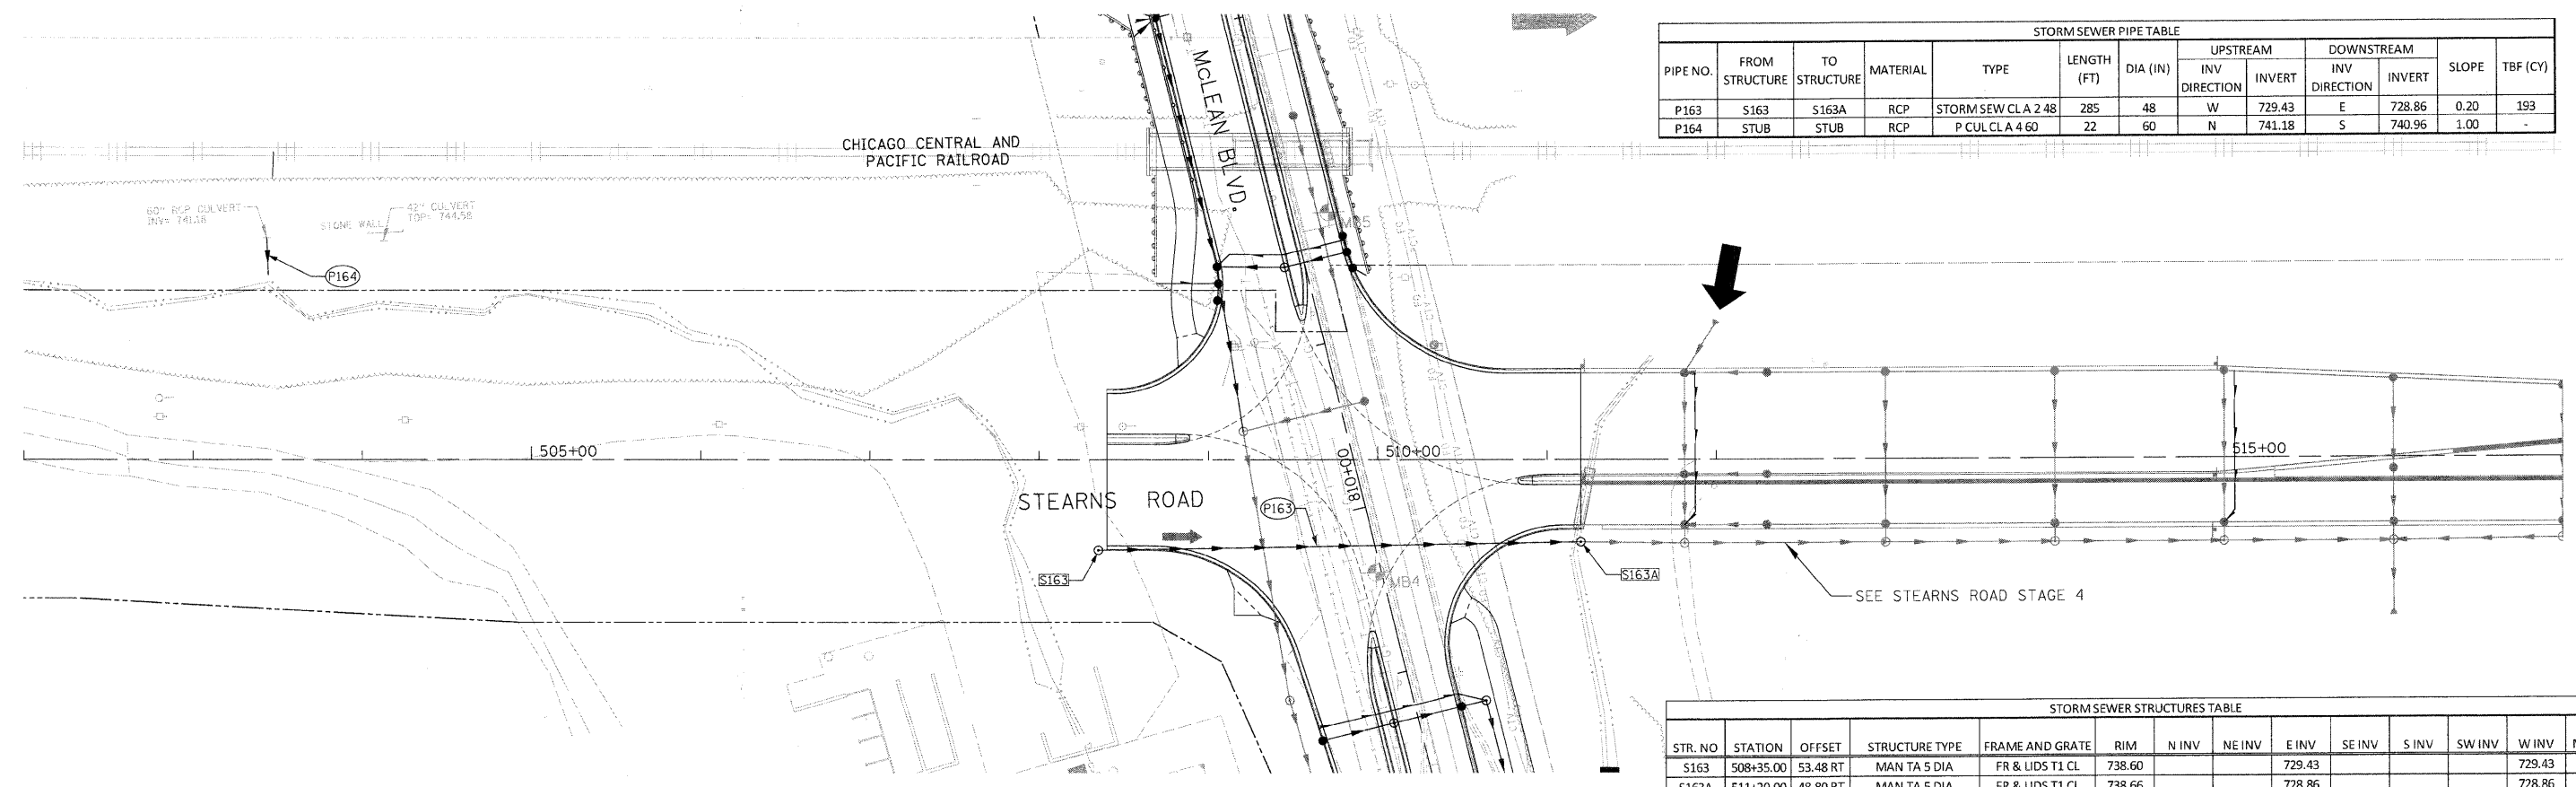


STORM SEWER PIPE TABLE												
PIPE NO.	FROM STRUCTURE	TO STRUCTURE	MATERIAL	TYPE	LENGTH (FT)	DIA (IN)	UPSTREAM		DOWNSTREAM		SLOPE	TBF (CY)
							INV DIRECTION	INVERT	INV DIRECTION	INVERT		
P163	S163	S163A	RCP	STORM SEW CL A 2 48	285	48	W	729.43	E	728.86	0.20	193
P164	STUB	STUB	RCP	P.CUL CL A 4 60	22	60	N	741.18	S	740.96	1.00	-

PLAN	SURVEYED	DATE
	BY	
	NOTED	
	BY	
	DATE	



STORM SEWER STRUCTURES TABLE													
STR. NO.	STATION	OFFSET	STRUCTURE TYPE	FRAME AND GRATE	RIM	N INV	NE INV	E INV	SE INV	S INV	SW INV	W INV	NW INV
S163	508+35.00	53.48 RT	MAN TA 5 DIA	FR & LIDS T1 CL	738.60			729.43					729.43
S163A	511+20.00	48.80 RT	MAN TA 5 DIA	FR & LIDS T1 CL	738.66			728.86					728.86

PROFILE	SURVEYED	DATE
	BY	
	NOTED	
	BY	
	DATE	

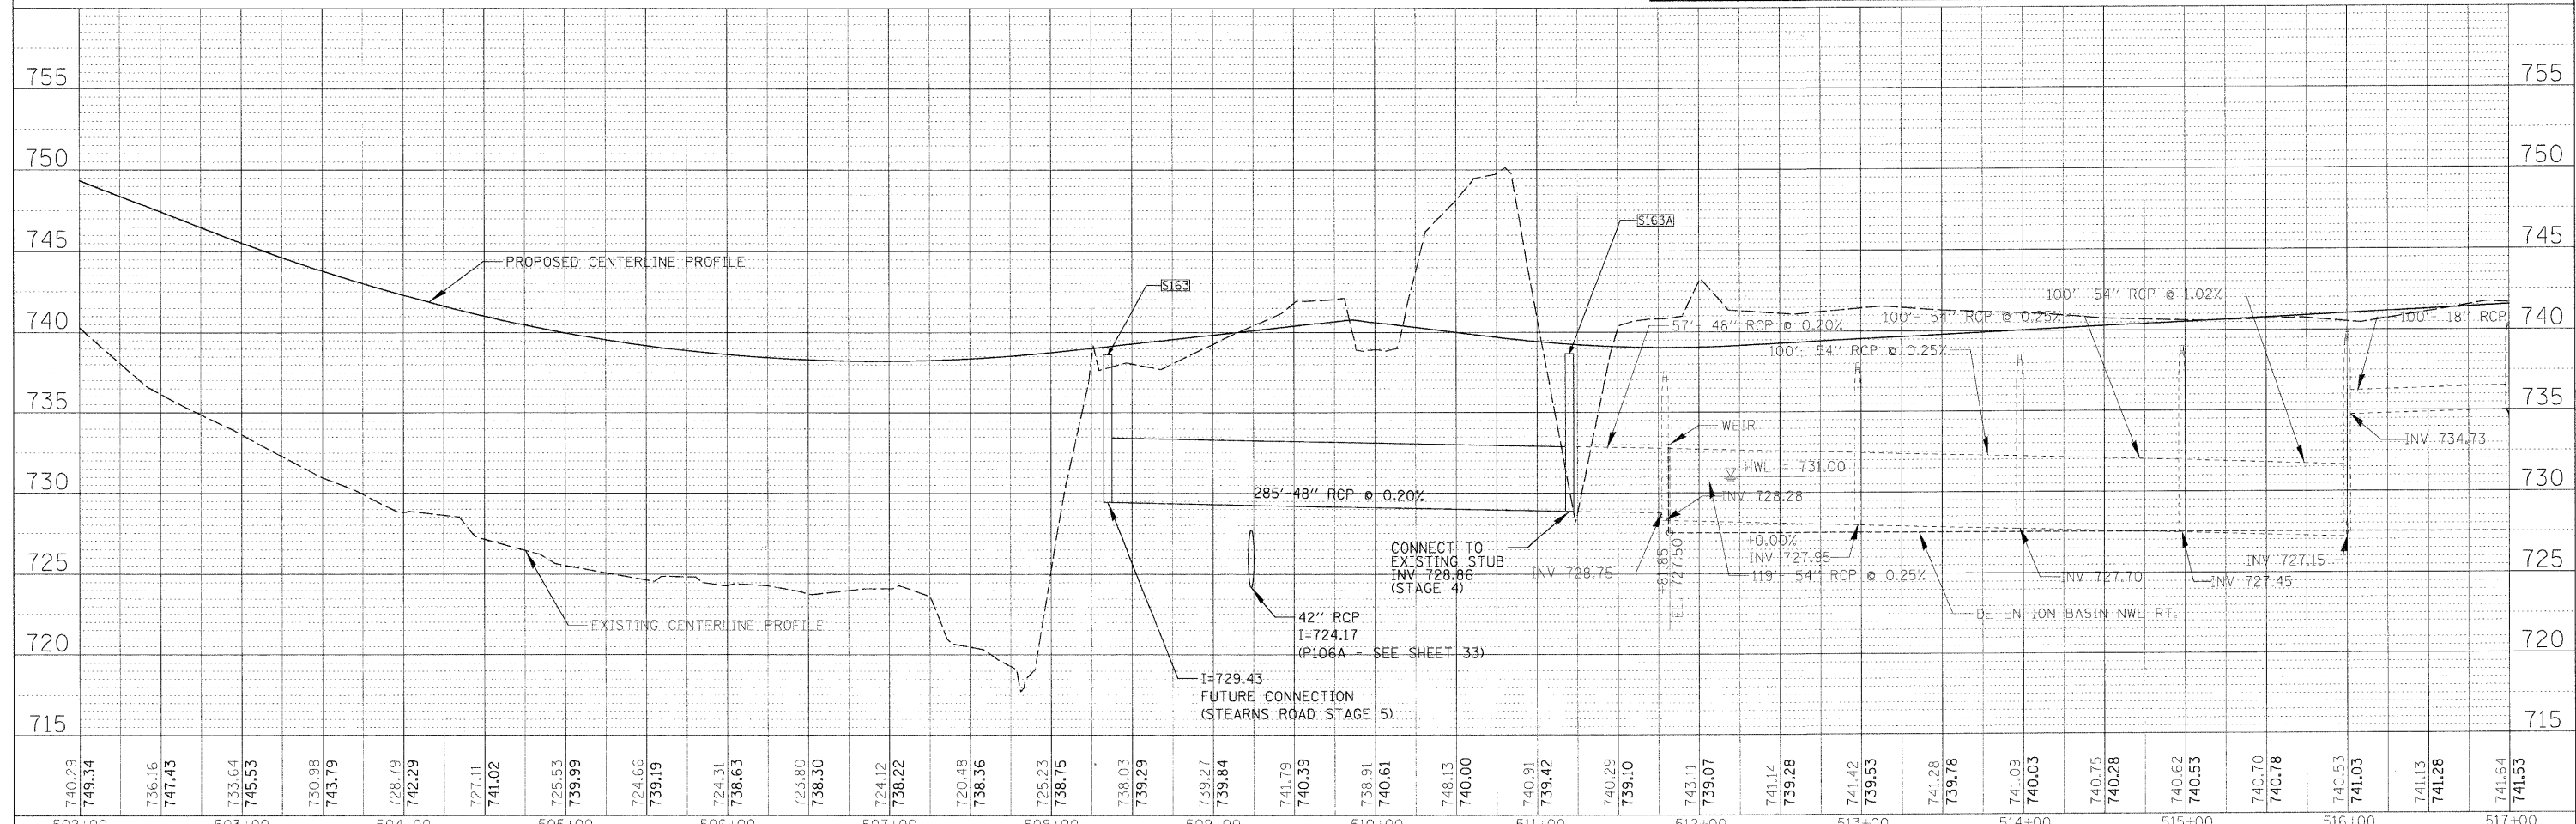

FILE NAME =	USER NAME =	DESIGNED =	REVISED =	<b>STATE OF ILLINOIS DEPARTMENT OF TRANSPORTATION</b>	<b>NEW STEARNS ROAD - STAGE 2 STEARNS ROAD - DRAINAGE PLAN &amp; PROFILE</b>	F.A.I. RTE.	SECTION	COUNTY	TOTAL SHEETS	SHEET NO.	
OPP_07996_03.SH	diamond	JWW	-			361	06-00214-10-BR	KANE	219	36	
	PLOT SCALE = 50'	DRAWN =	REVISED =			CONTRACT NO.					
	PLOT DATE = 3/27/2009	CHECKED =	REVISED =			SCALE: 1"=50'		SHEET NO. 4 OF 6 SHEETS		STA. 508+40 TO STA. 511+20	