

PROP. CURVE CL-DRV-1
 PI STA. = 151+27.58
 Δ = 32° 20' 56" (LT)
 D = 60° 18' 41"
 R = 95.00'
 T = 27.55'
 L = 53.64'
 E = 3.92'
 P.C. STA. = 151+00.02
 P.T. STA. = 151+53.66



PROP. CURVE CL-DRV-2
 PI STA. = 151+80.10
 Δ = 31° 06' 27" (RT)
 D = 60° 18' 41"
 R = 95.00'
 T = 26.44'
 L = 51.58'
 E = 3.61'
 P.C. STA. = 151+53.66
 P.T. STA. = 152+05.24

PROP CURVE CLHAL2-3
 PI STA. = 41+07.98
 Δ = 90° 32' 31" (LT)
 D = 114° 35' 30"
 R = 50.00'
 T = 50.48'
 L = 79.01'
 E = 21.05'
 P.C. STA. = 40+57.50
 P.T. STA. = 41+36.51

DATE	
BY	
SURVEYED	
ALIGNED	
CHECKED	
DATE	
BY	
PROF. FILE	
DATE	
BY	
SURVEYED	
ALIGNED	
CHECKED	
DATE	
BY	

DATE	
BY	
SURVEYED	
ALIGNED	
CHECKED	
DATE	
BY	
PROF. FILE	
DATE	
BY	
SURVEYED	
ALIGNED	
CHECKED	
DATE	
BY	

Scale: 1"=40'
 COMPANY NAME: SEC Group, Inc.
 CONTACT: 412.776.1000
 CLIENT: VILLAGE OF LAKE IN THE HILLS
 DATE PLOTTED: 4/1/2009 4:46:33 PM
 FILE NAME: 07070-pnd-02.dgn
 PLOT DRIVER: pefpbf
 PLOT TABLE: standard-frans.tbl

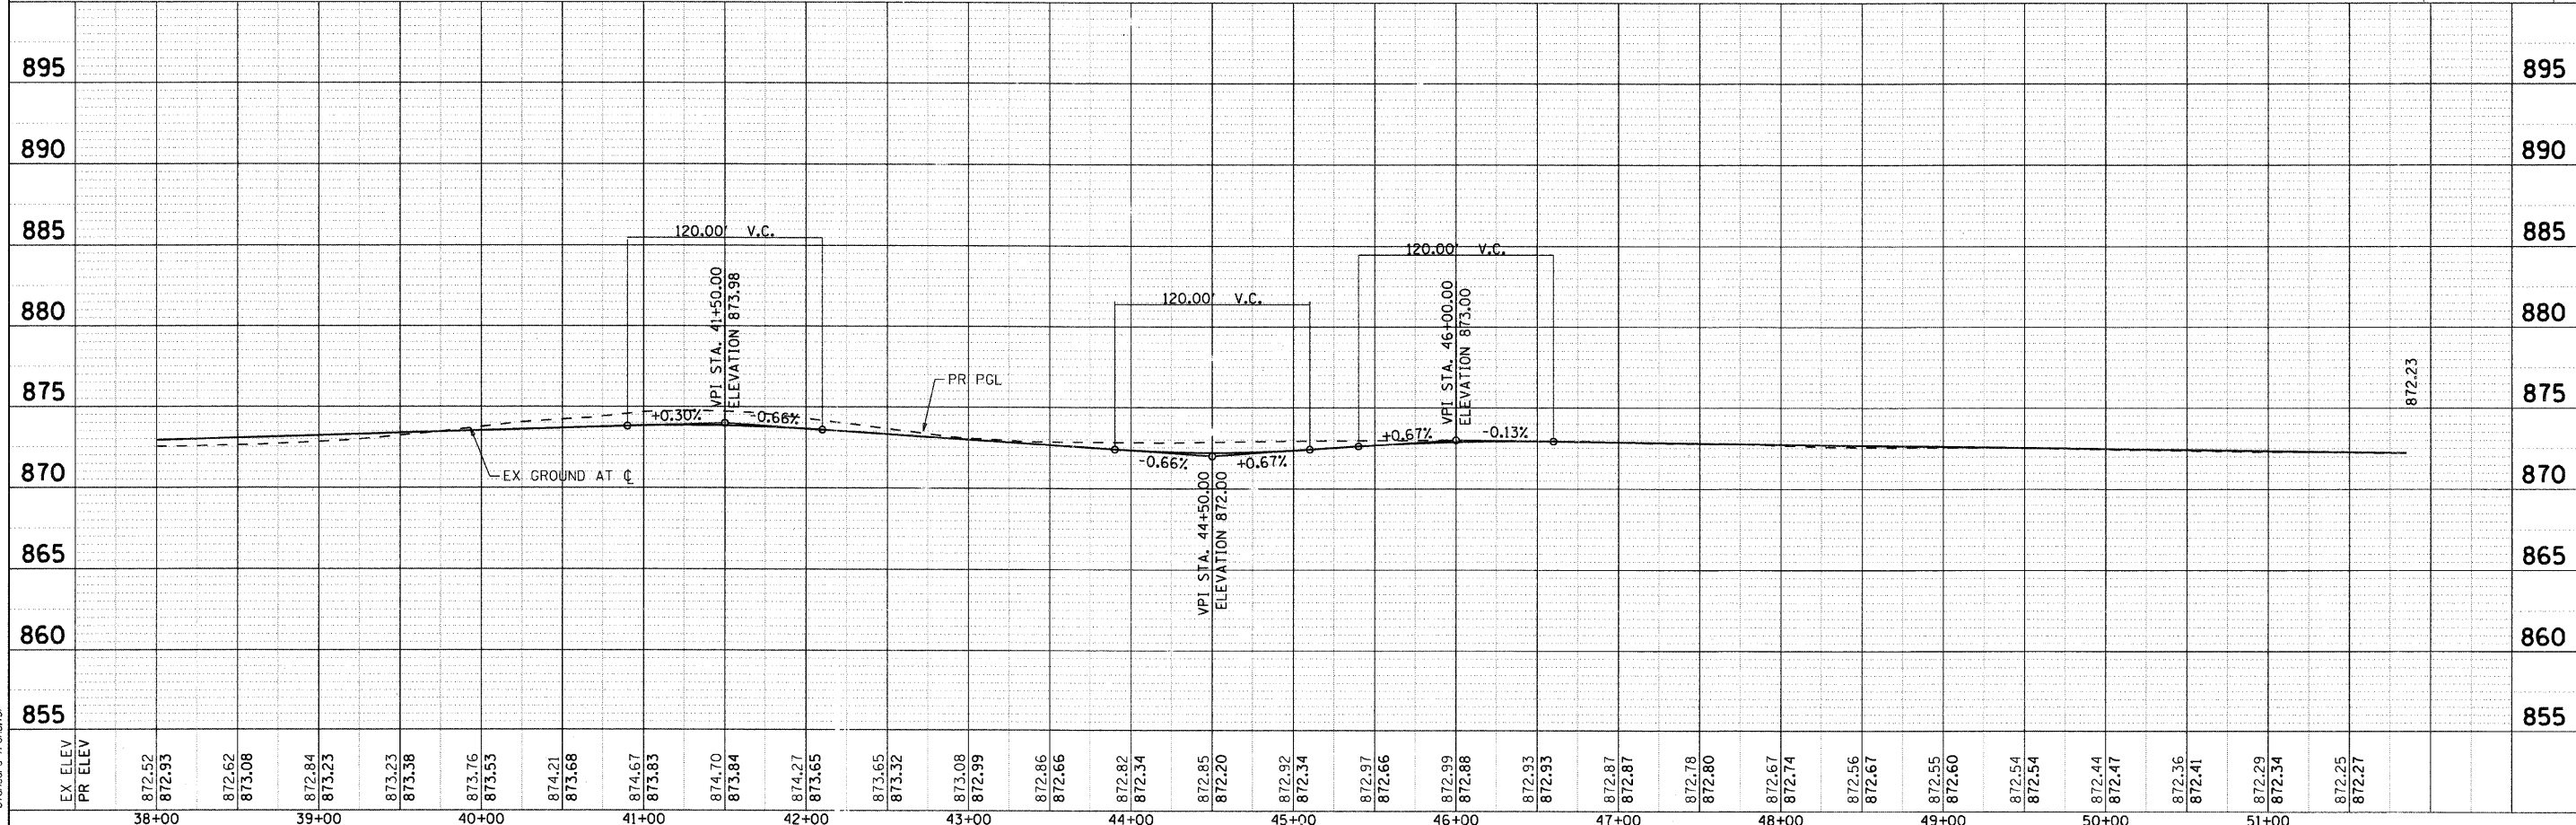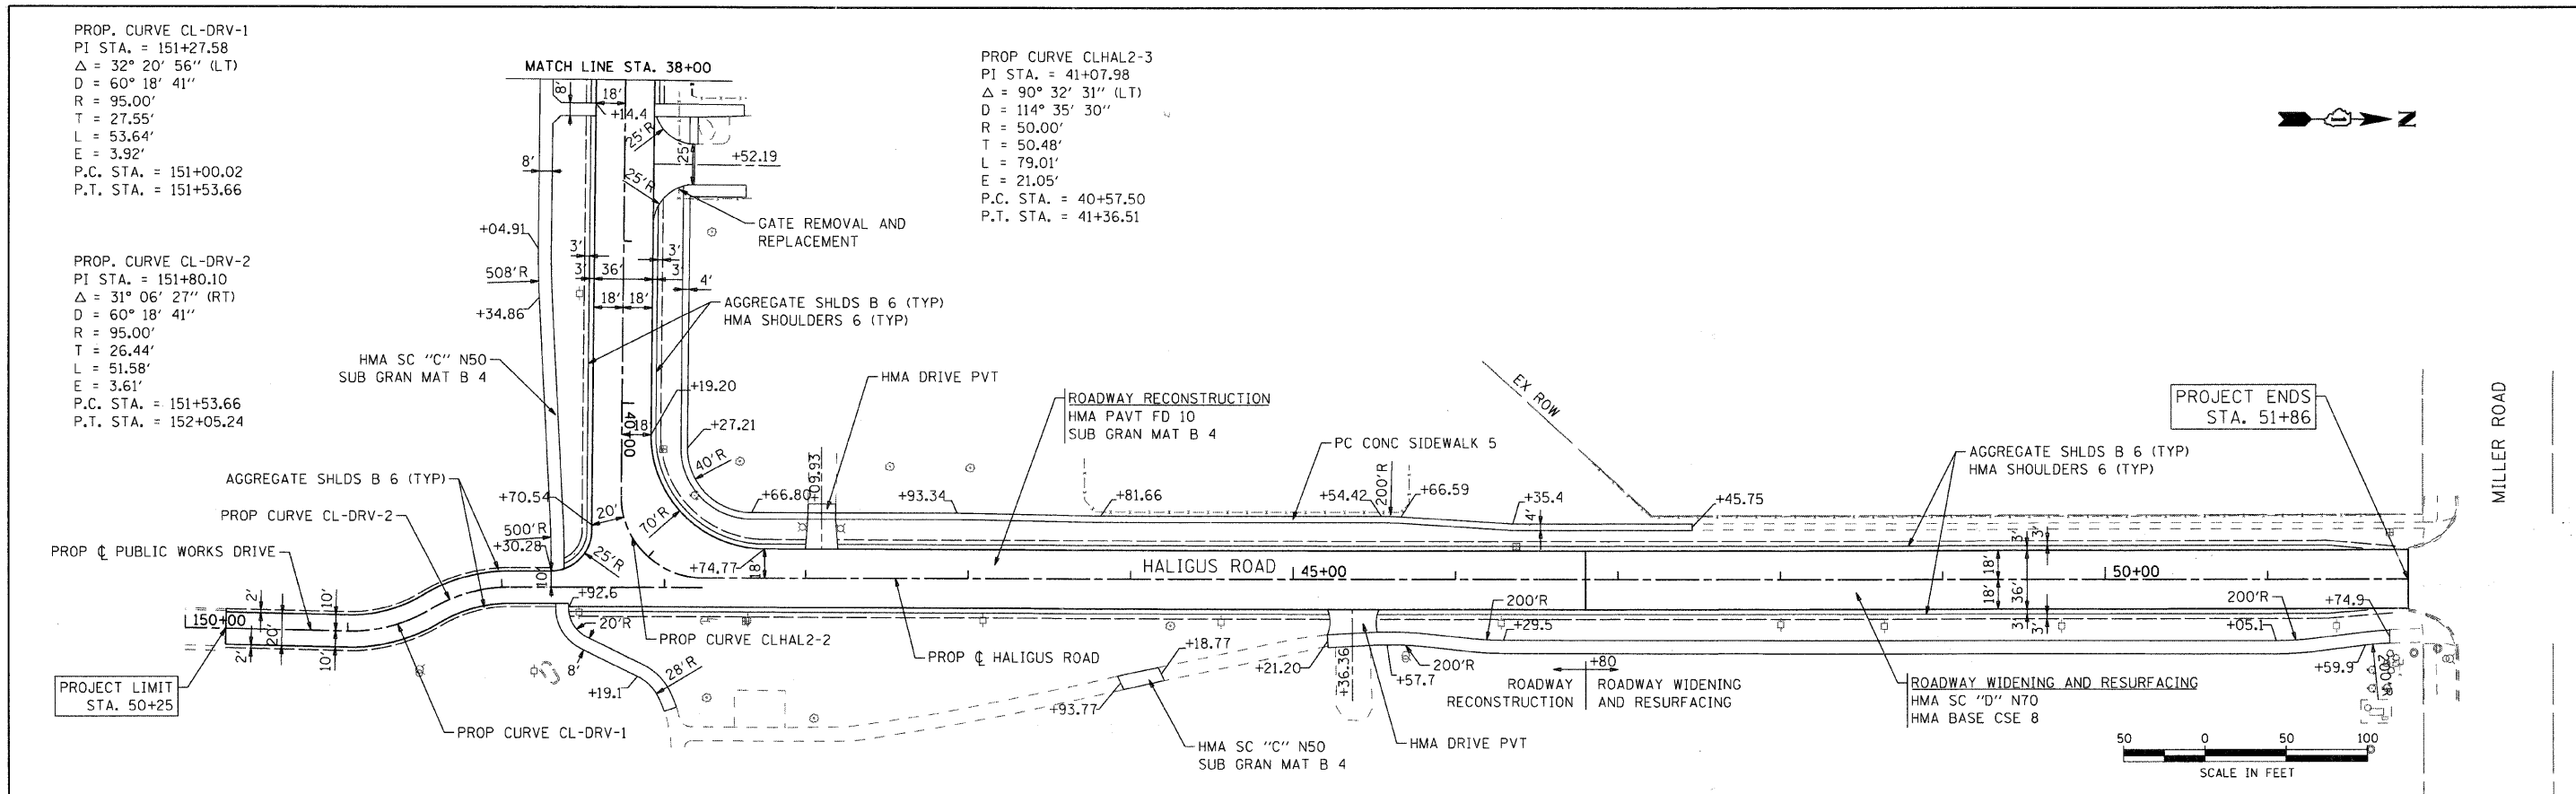

EX ELEV	PR ELEV	872.52	872.93	872.62	873.08	872.84	873.23	873.23	873.38	873.76	873.53	874.21	873.68	874.67	873.83	874.70	873.84	874.27	873.65	873.65	873.32	873.08	872.99	872.86	872.66	872.82	872.34	872.92	872.34	872.97	872.66	872.99	872.88	872.93	872.93	872.87	872.87	872.78	872.80	872.67	872.74	872.56	872.67	872.55	872.60	872.54	872.54	872.44	872.47	872.36	872.41	872.29	872.34	872.25	872.27	
		38+00		39+00		40+00		41+00		42+00		43+00		44+00		45+00		46+00		47+00		48+00		49+00		50+00		51+00																												

DESIGNED - JLP
 DRAWN - BDH
 CHECKED - DVC
 DATE - 4/1/09

USER NAME = char-tnk
 PLOT SCALE = 50
 PLOT DATE = 4/1/2009

REVISOR
 REVISION
 REVISION
 REVISION

VILLAGE OF LAKE IN THE HILLS
 PROPOSED PLAN AND PROFILE
 HALIGUS ROAD
 SCALE: 50
 SHEET NO. 2 OF 2 SHEETS
 STA. 38+00 TO STA. END

F.A. RTE.	SECTION	COUNTY	TOTAL SHEETS	SHEET NO.
3869	08-00030-00-FP	MCHENRY	32	9
CONTRACT NO. 63146				
ILLINOIS FED. AID PROJECT				