





REVISION	DATE

PREPARED BY:	RJR
DRAWN BY:	BS
CHECKED BY:	
DATE:	


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BENCHMARK INFORMATION

B.M. "A" - SET CHISELED "C" TOP OF N.E. ABUTMENT OF EXISTING STRUCTURE. ELEV=782.67 - STA. 10+67.66, 13.9' RT.
B.M. "B" - SET RAILROAD SPIKE IN SECOND POWER POLE SOUTH OF BRIDGE, EAST SIDE OF ROAD. ELEV=777.08 - STA. 8+61.9, RT. 39.4'
B.M. "C" - SET RAILROAD SPIKE IN TELEPHONE POLE ON NORTH SIDE OF CREEK AND WEST SIDE OF BRIDGE. ELEV=777.18 - STA. 10+94.36, LT. 39.2'

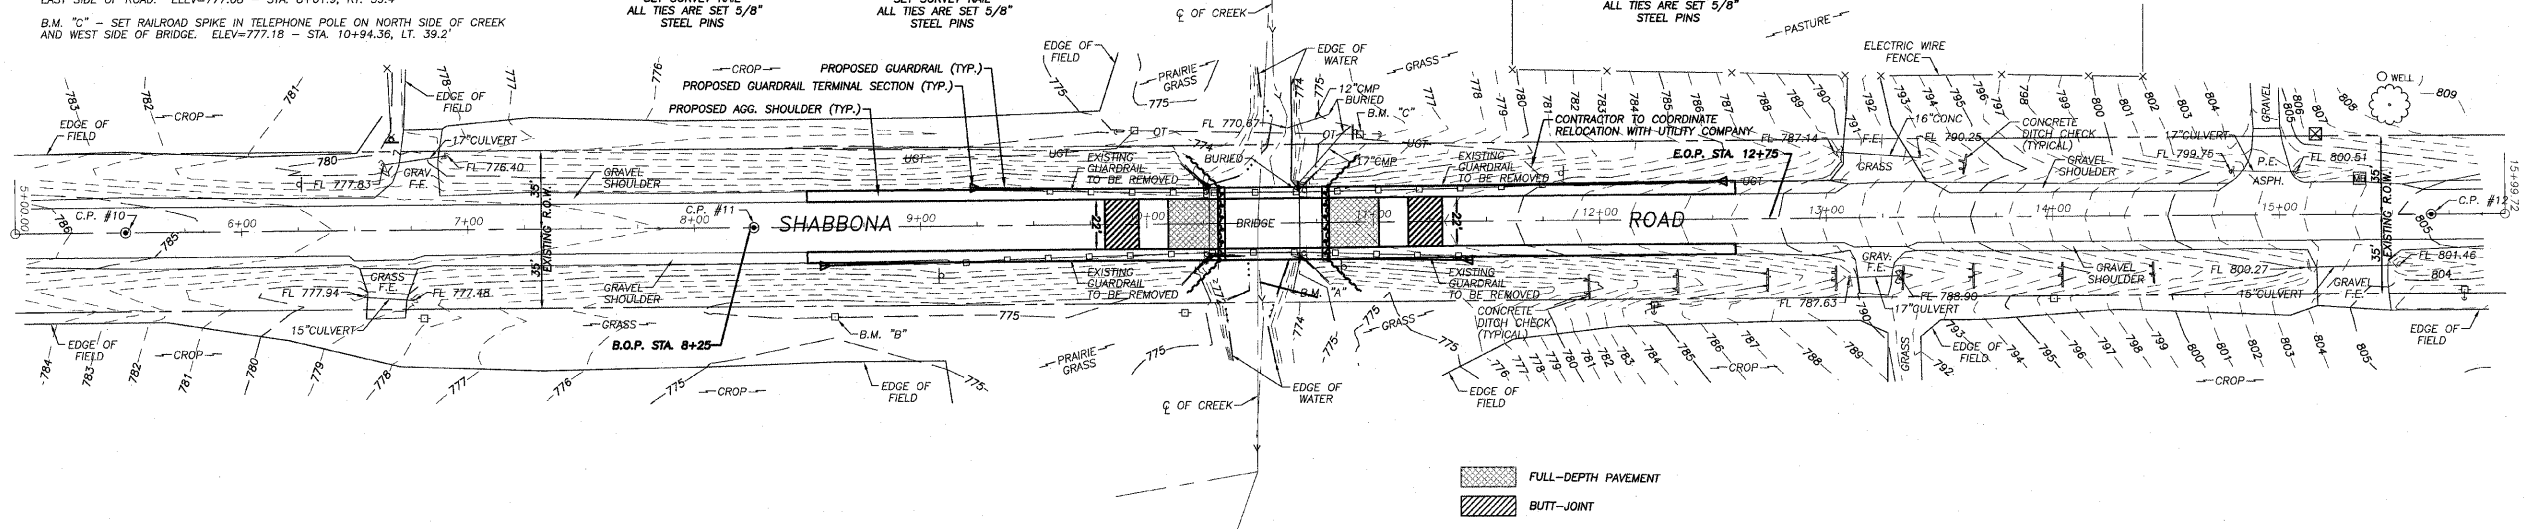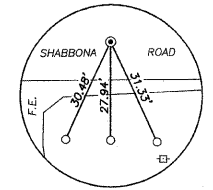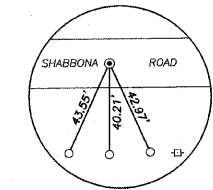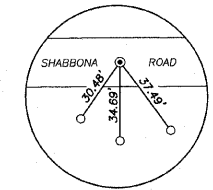

SCALES:
1" = 40' HOR
1" = 5' VER

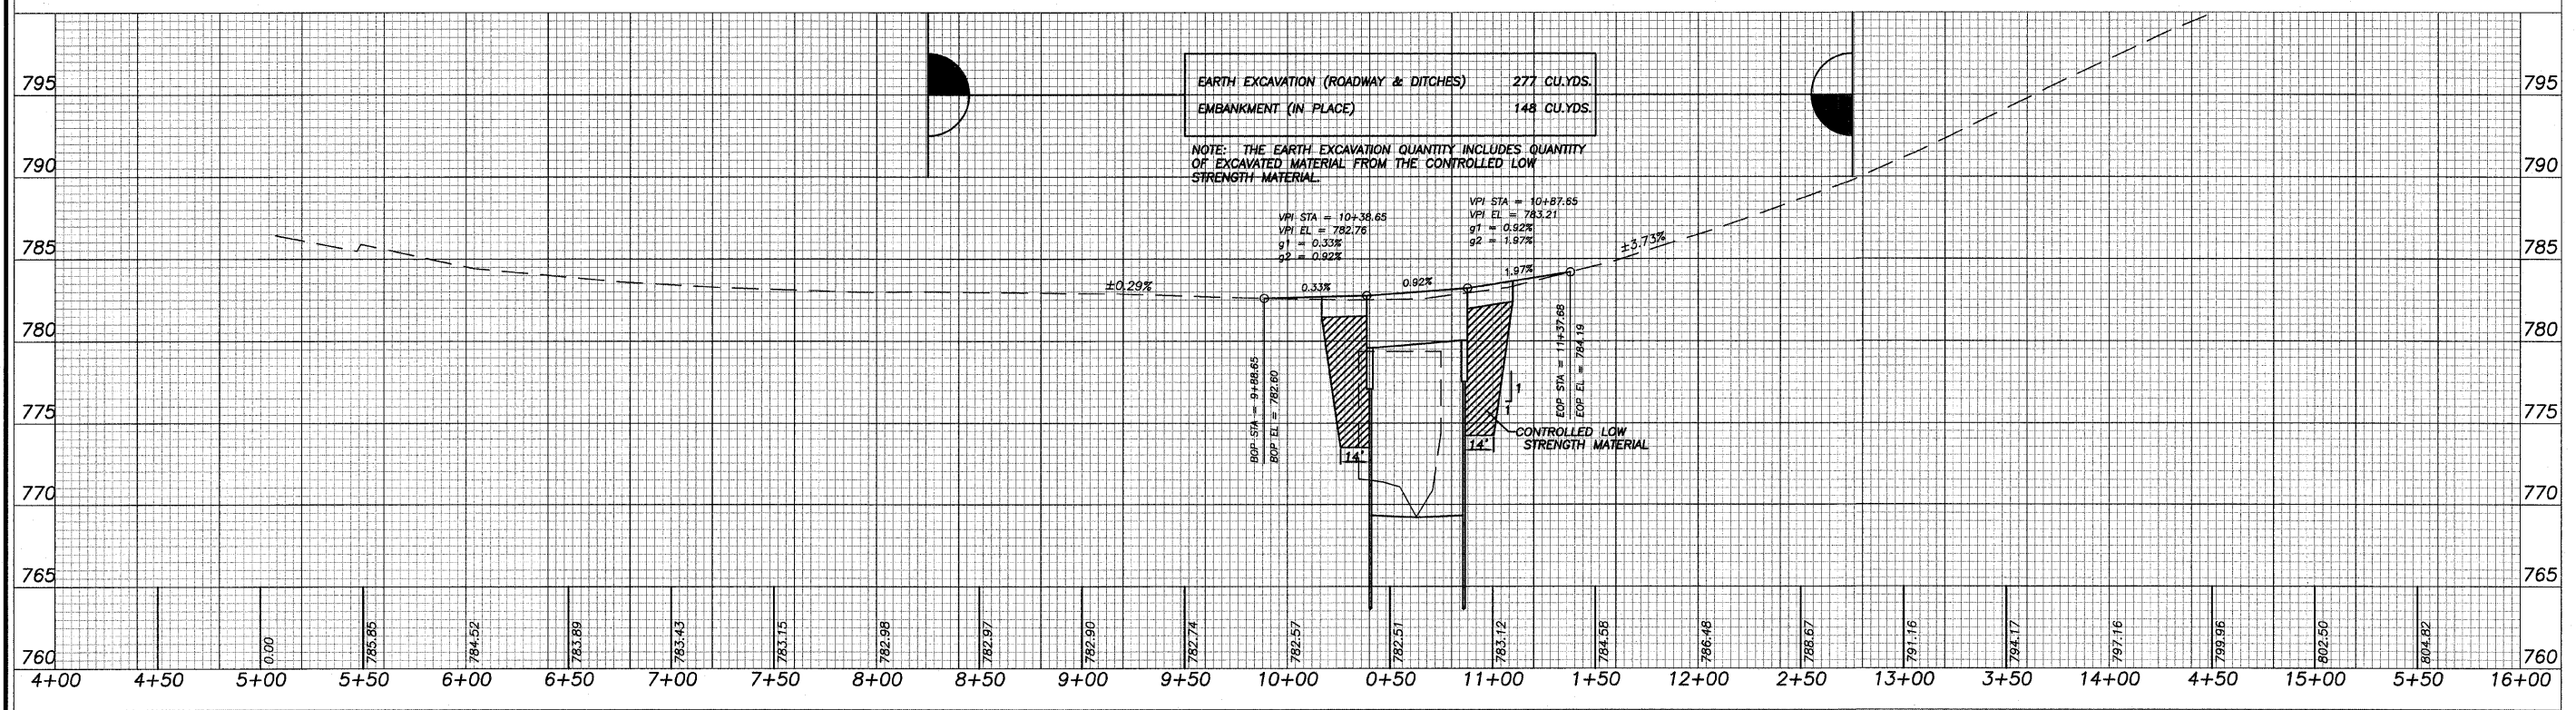

PLAN AND PROFILE
OF
SHABBONA ROAD BRIDGE REPLACEMENT
FOR
DEKALB COUNTY HIGHWAY

SHEET TITLE	PLAN & PROFILE
JOB NUMBER	2080381
DATE	2/23/2009
SHEET NO.	3 of 17