



S:\Land Projects\AAC-405229\dwg\Phase 1\Bike Trail P-P.dwg, 11/12/2008 11:35:34 AM, jman, 1:20

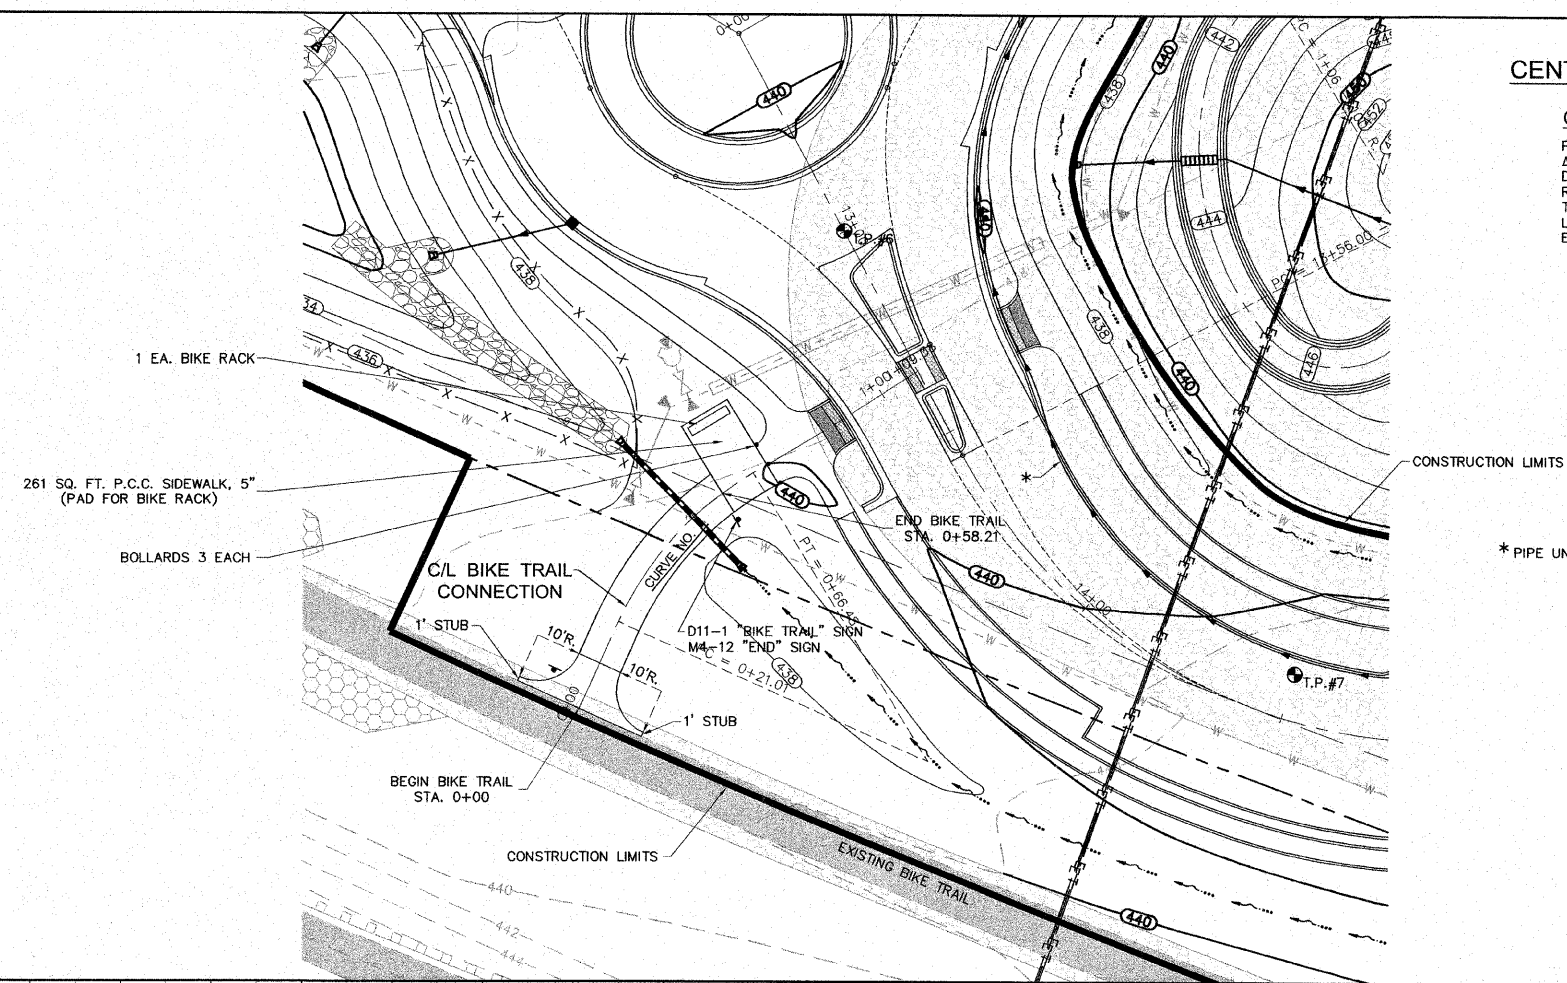


CENTERLINE CURVE DATA

CURVE NO. 1
 P.I. STA. = 0+44.47
 Δ = 34°44'19"
 D = 76°23'40"
 R = 75.00'
 T = 23.46'
 L = 45.47'
 E = 3.58'

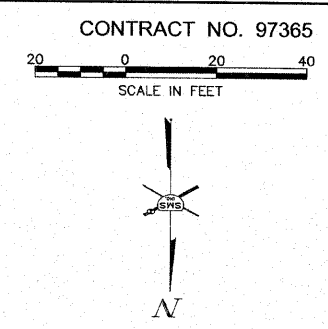

BENCHMARKS: SEE SHEET NO. 2

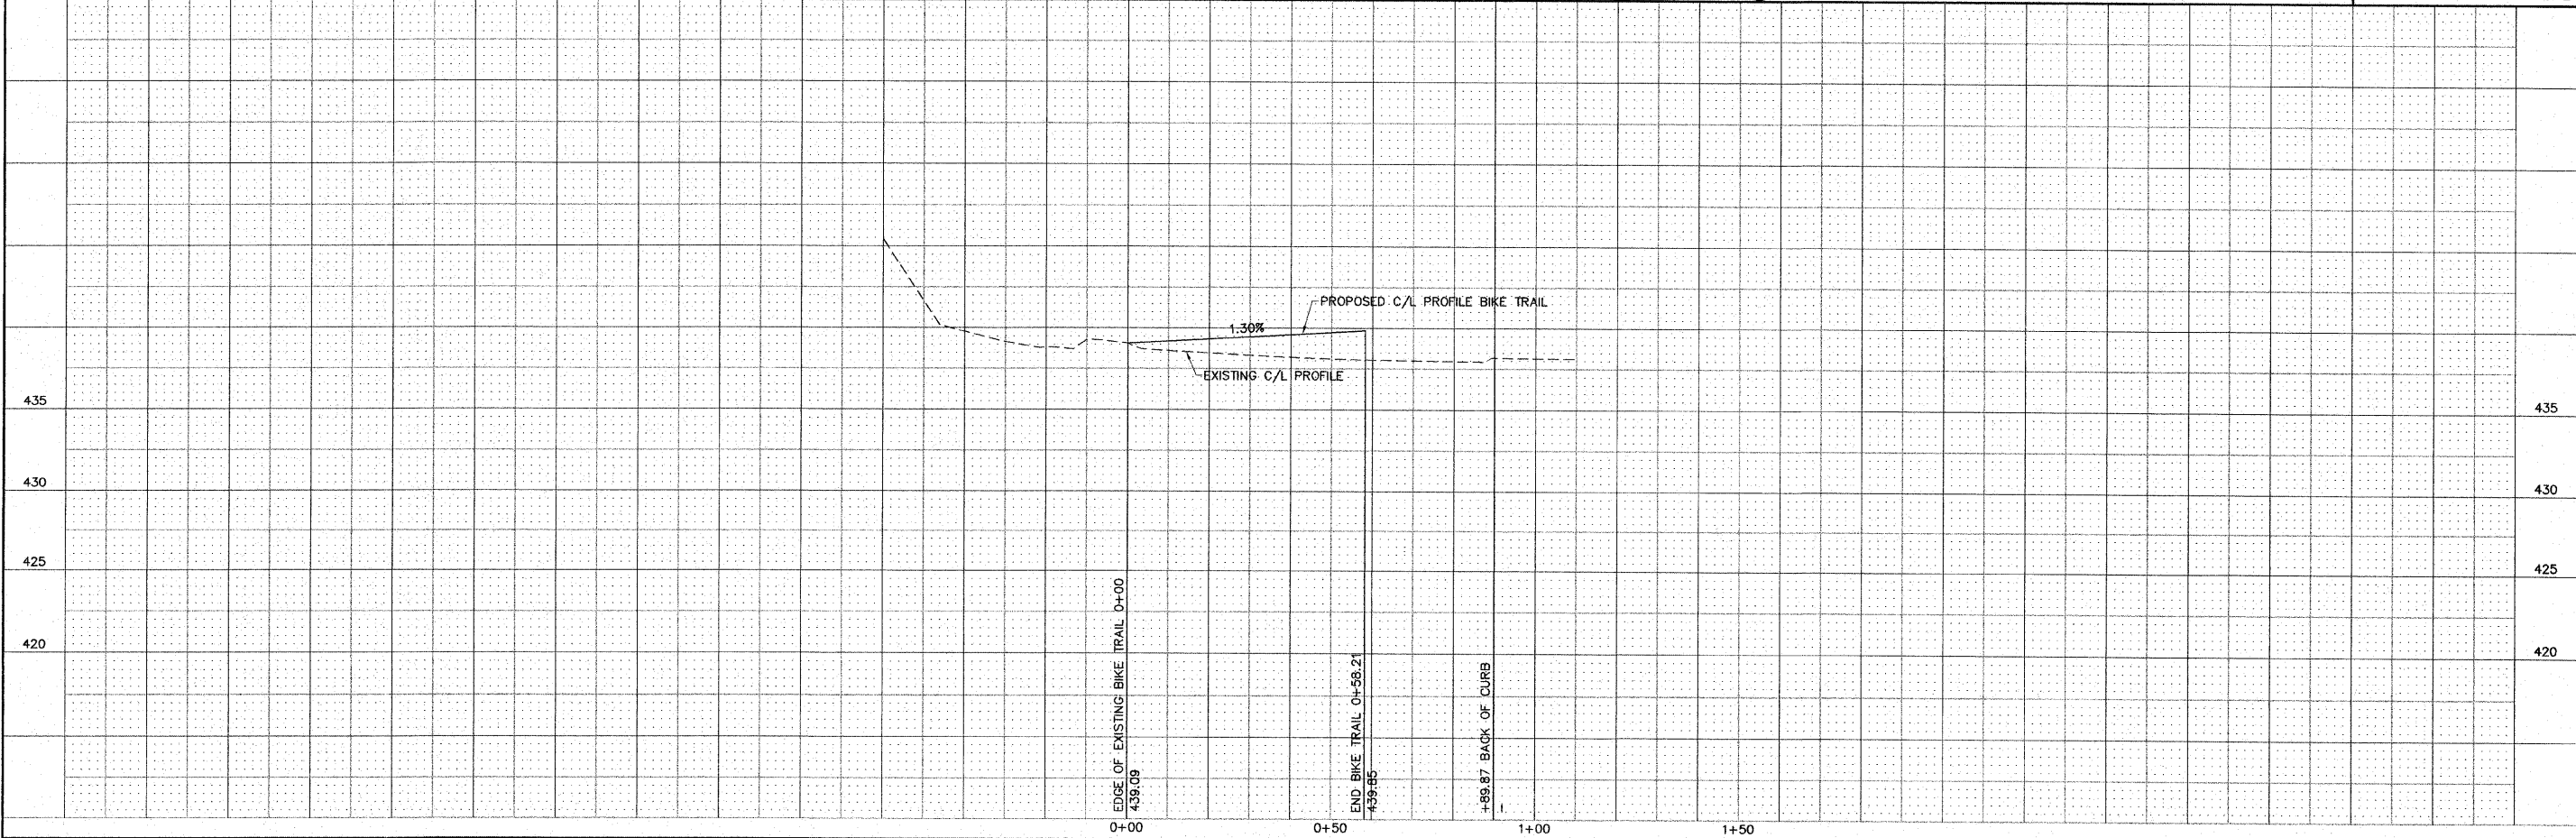

REVISIONS

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LEWIS & CLARK COMMUNITY COLLEGE
 SECTION 05 - 00001 - 00 - PK
 ACCESS ROADS FOR THE
 NATIONAL GREAT RIVERS RESEARCH AND EDUCATION CENTER
 PLAN AND PROFILE - BIKE TRAIL CONNECTION

DWG. NO.	PHASE I BIKE TRAIL P-P.DWG
REF. BK.	PG.
JOB NO.	457111.1
DSN. BY:	DEG
DWN. BY:	CAD
CHK. BY:	DEG
DATE:	SEPT. 8, 2008
SCALE:	1" = 20' H. 1" = 5' V.
SHEET	15 OF 36