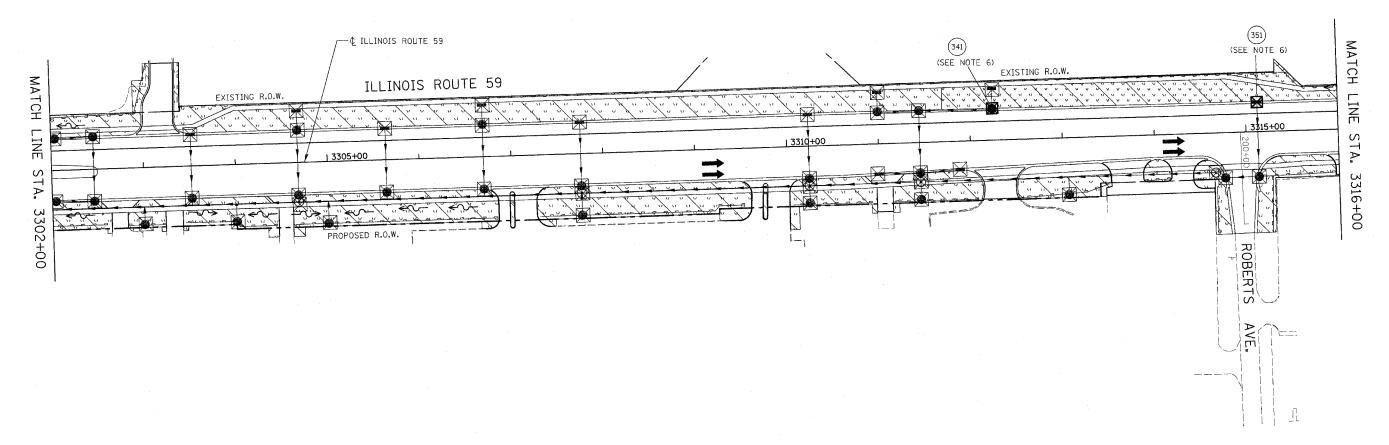
CONTRACT NO. 624

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## EROSION CONTROL LEGEND

V V V

TEMPORARY EROSION CONTROL SEEDING AND EROSION CONTROL BLANKET

TEMPORARY EROSION CONTROL SEEDING AND EROSION CONTROL BLANKET INSTALLED

PERMANENT LANDSCAPING (SEE NOTE 3)

PERMANENT LANDSCAPING INSTALLED IN PREVIOUS STAGE

С

DRAINAGE STRUCTURE TO BE CLEANED

SEDIMENT CONTROL, SILT FENCE (SEE NOTE 2)

SEDIMENT CONTROL SILT FENCE INSTALLED

IN PREVIOUS STAGE INLET FILTER



INLET FILTER INSTALLED IN PREVIOUS STAGE



TEMPORARY DITCH CHECK

TEMPORARY DITCH CHECK INSTALLED IN PREVIOUS STAGE

FLOW DIRECTION (SEE NOTE 4)

PERMANENT DRAINAGE STRUCTURE NUMBER (SEE SEE NOTE 5)

PROPOSED STORM SEWER (SEE NOTE 5) PROPOSED STORM SEWER INSTALLED

IN PREVIOUS STAGE

TEMPORARY PIPE CULVERT TEMPORARY PIPE CULVERT INSTALLED IN PREVIOUS STAGE

## NOTES

- THE CONSTRUCTION LIMITS WILL BE STAKED BY THE ENGINEER PRIOR TO COMMENCING CONSTRUCTION. THE CONSTRUCTION LIMITS MAY BE ADJUSTED BY THE ENGINEER TO PRESERVE TREES AND NO ADDITIONAL COMPENSATION WILL BE PAID TO THE CONTRACTOR FOR CHANGED CONSTRUCTION LIMITS.
- 2. SEDIMENT CONTROL, SILT FENCE SHALL BE ERECTED ADJACENT TO R.O.W., EASEMENT AND CONTRUCTION LIMITS AND AS DIRECTED BY THE ENGINEER.
- 3. SEE LANDSCAPING PLANS FOR SEEDING INFORMATION.
- 4. SEE STAGE 4 OF FINAL CROSS SECTIONS FOR GRADING INFORMATION.
- 5. SEE PROPOSED DRAINAGE PLANS FOR STORM SEWER INFORMATION.

6. ANY REQUIRED ADJUSTMENT AND/OR RECONSTRUCTION OF THE PROPOSED STRUCTURE TO FINAL RIM ELEVATION SHALL NOT BE PAID FOR SEPERATELY. THE COST FOR THIS WORK SHALL BE INCLUDED IN THE COST OF THE PROPOSED STRUCTURE.



ILLINOIS DEPARTMENT OF TRANSPORTATION DISTRICT NO. 1 SCHAUMBURG EROSION CONTROL PLAN STAGES 4, & 4A ILLINOIS ROUTE 59

SCALE AS SHOWN DATE MARCH 18, 2008

DRAWN BY CHECKED BY JCM