


EROSION CONTROL BLANKET
SEEDING, CLASS 2

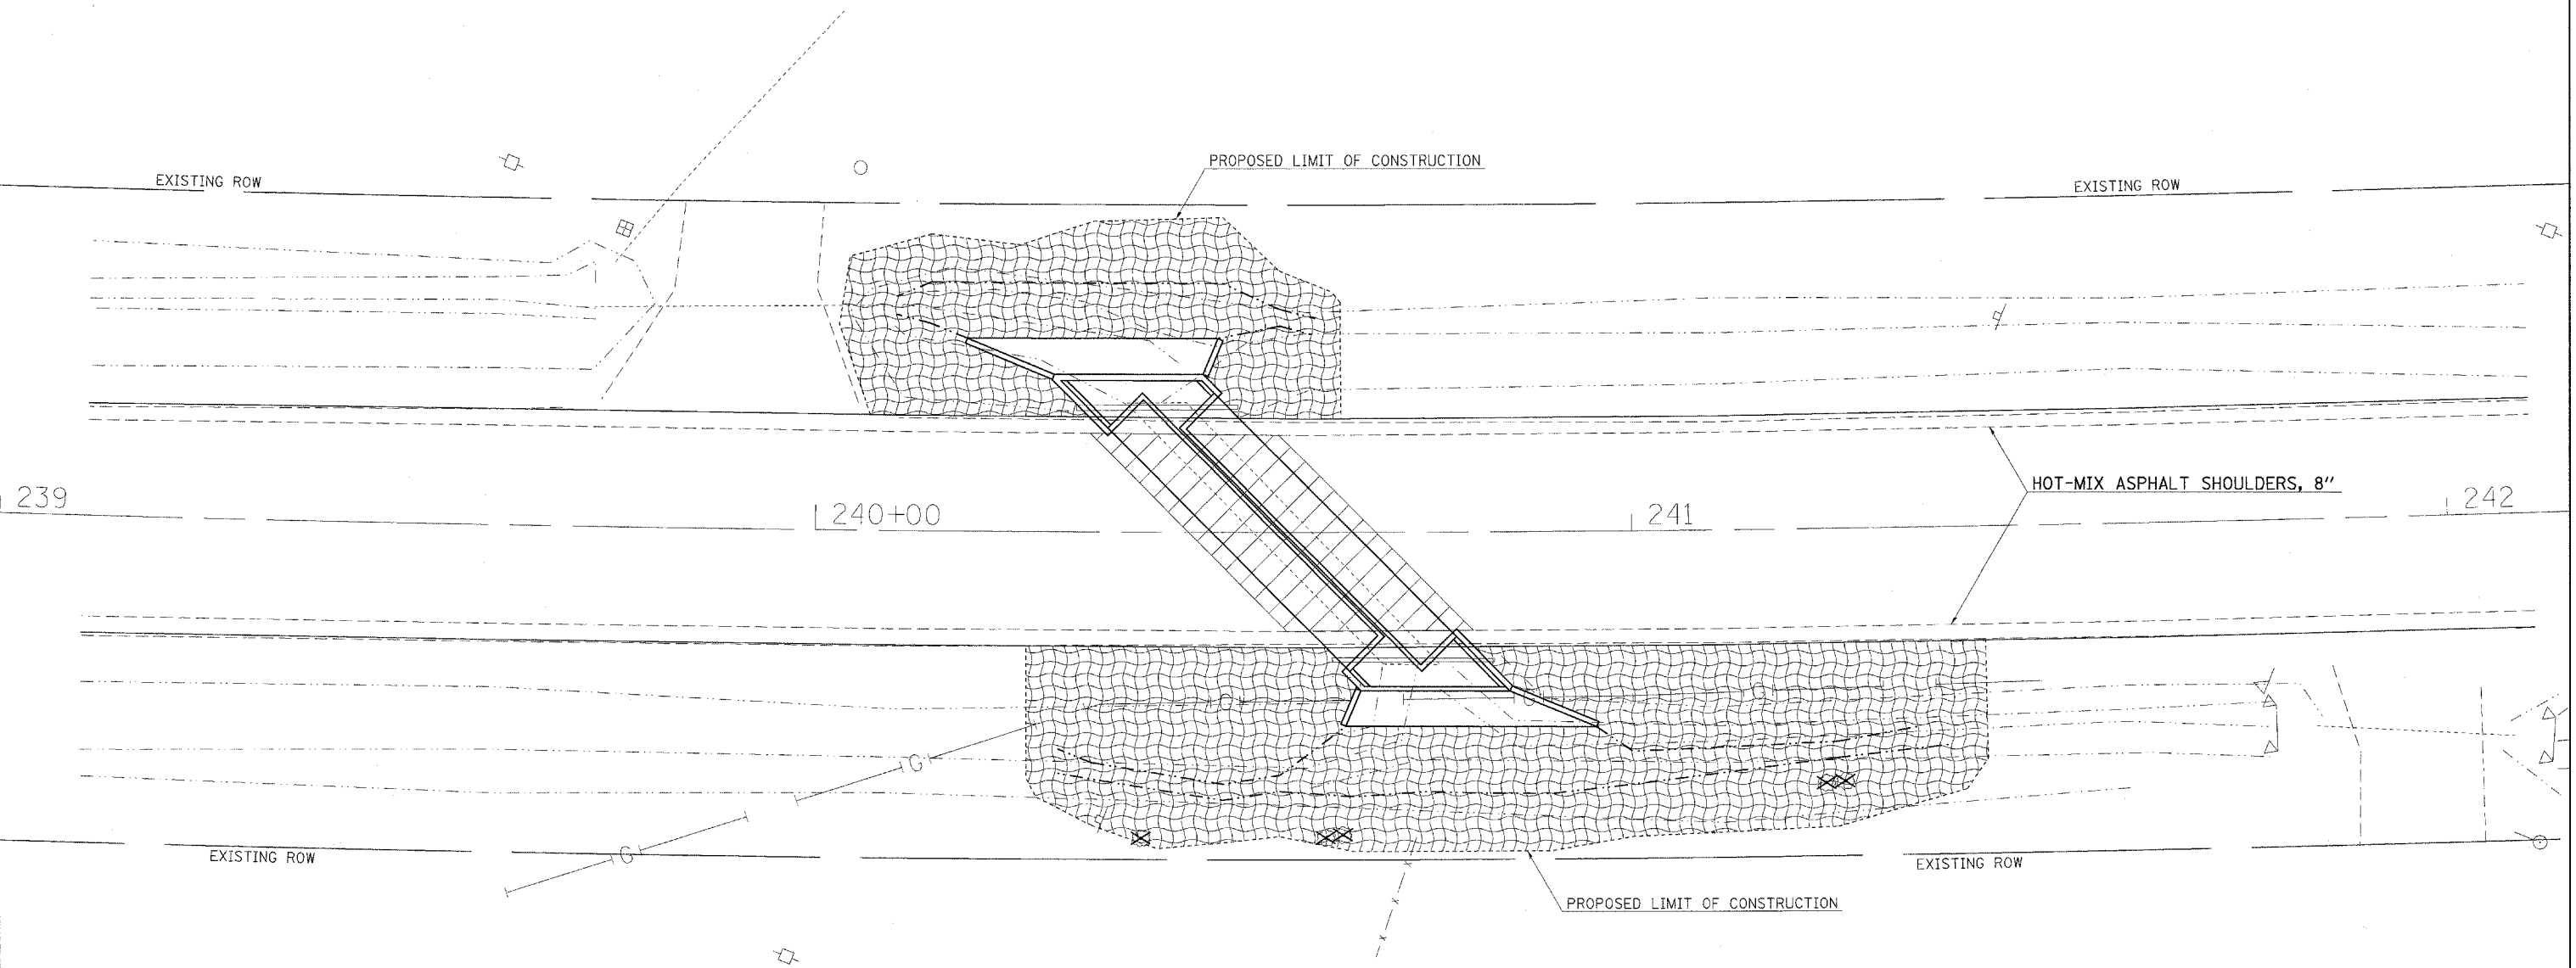

EXIST. CURVE LOC3-4-1
 P.I. STA. = 242+68.49
 $\Delta = 19^\circ 14' 56''$ (LT)
 $D = 1^\circ 12' 00''$
 $R = 4,774.74'$
 $T = 809.68'$
 $L = 1,604.10'$
 $E = 68.16'$
 $e = \text{-----}$
 $T.R. = \text{-----}$
 $S.E. \text{ RUN} = \text{-----}$
 P.C. STA. = 234+58.81
 P.T. STA. = 250+62.91

FILE NAME = c:\projects\491907\491907plm32	USER NAME = thomashf	DESIGNED - ---	REVISED - ---	STATE OF ILLINOIS DEPARTMENT OF TRANSPORTATION	EROSION CONTROL - LOCATION 5		F.A.P. RTE. 881	SECTION D9 SAFETY FY08-1	COUNTY VARIOUS	TOTAL SHEETS 64	SHEET NO. 21	
	PLOT SCALE = 10.0000' / IN.	DRAWN - ---	REVISED - ---		SCALE: 1" = 10'	SHEET NO. ___ OF ___ SHEETS	STA. 239+00 TO STA. 242+00	CONTRACT NO. 78038				
	PLOT DATE = 3/18/2008	CHECKED - ---	REVISED - ---		FED. ROAD DIST. NO. _ ILLINOIS FED. AID PROJECT							
		DATE - -----	REVISED - ---									