FOR INDEX OF SHEETS SEE SHEET NO. 2

STATE OF ILLINOIS **DEPARTMENT OF TRANSPORTATION DIVISION OF HIGHWAYS**

PLANS FOR PROPOSED

FEDERAL AID HIGHWAY

FAU 3537 (LAKE STREET)

9th AVENUE TO DES PLAINES RIVER

SECTION 06-00122-00-SW

PROJECT TE-00D1(753)


JOB C-91-120-07

VILLAGE OF MAYWOOD COOK COUNTY

TRAFFIC DATA

2030 ADT = 14,260 POSTED SPEED LIMIT: 30 MPH DESIGN SPEED LIMIT: 30 MPH


PROJECT LOCATED IN THE VILLAGE OF MAYWOOD

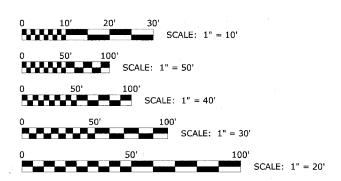

FULL SIZE PLANS HAVE BEEN PREPARED USING STANDARD ENGINEERING SCALES. REDUCED SIZED PLANS WILL NOT CONFORM TO STANDARD SCALES. IN MAKING MEASUREMENTS ON REDUCED PLANS, THE ABOVE SCALES MAY BE USED.

> **PROJECT BEGINS** STATION 4+30 LAKE STREET

LOCATION MAP

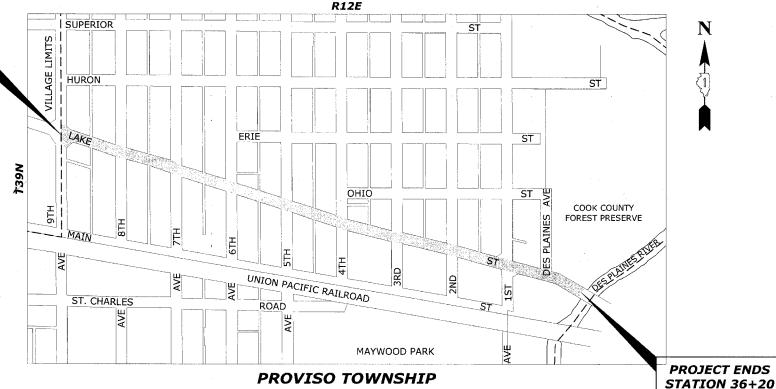



VILLAGE SECTION

CONTRACT NO. 83938

06-00122-00-SW

ILLINOIS DEPARTMENT OF TRANSPORTATION Diene M. O'Kele



LAKE STREET

CONTRACT NO.

83938

Know what's below.

Call before you dig.

- AREA OF IMPROVEMENT

GROSS AND NET LENGTH OF PROJECT = 3,190 FT. = 0.604 MI.

E.H.E. NO. 565-06-15302

| ILLINOIS PROJECT | TE-00D1(753) | VILLAGE SECTION | 06-00122-00-SW | CONTRACT NO. 83938

INDEX OF SHEETS

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. 1	TITLE SHEET, LOCATION MAP
2	INDEX OF SHEETS, LEGEND, BENCHMARKS, I.D.O.T. STANDARD DRAWINGS
3	GENERAL NOTES
4	SUMMARY OF QUANTITIES
5	TYPICAL CROSS SECTIONS
6-9	STREETSCAPING PLANS
10-11	ROADWAY DETAILS
12-15	LIGHTING PLANS
16	LIGHTING WIRING DIAGRAM
17-18	LIGHTING DETAILS
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21	TRAFFIC CONTROL AND PROTECTION FOR SIDE ROADS, INTERSECTIONS AND DRIVEWAYS
22	ARTERIAL ROAD INFORMATION SIGN

BENCHMARKS

TBM	NORTHWEST FLANGE BOLT ON FIRE HYDRANT AT NORTHEAST CORNER OF LAKE STREET AND 8TH AVENUE	630.86
BM-61	NORTHWEST FLANGE BOLT ON FIRE HYDRANT AT NORTHEAST CORNER OF LAKE STREET AND 6TH AVENUE.	629.53
ТВМ	NORTHEAST FLANGE BOLT ON FIRE HYDRANT AT NORTHWEST CORNER OF LAKE STREET AND 3RD AVENUE.	629.03
BM-59	NORTHWEST FLANGE BOLT ON FIRE HYDRANT AT NORTH WEST CORNER OF LAKE STREET AND 5TH AVENUE.	630.10
ТВМ	NORTHWEST FLANGE BOLT ON FIRE HYDRANT AT NORTHWEST CORNER OF LAKE STREET AND 4TH AVENUE.	628.27
BM-58	NORTHEAST FLANGE BOLT ON FIRE HYDRANT AT NORTHEAST CORNER OF LAKE STREET AND 3RD AVENUE.	627.69
ТВМ	NORTHEAST CORNER HANDHOLE AT SOUTHEAST CORNER OF LAKE STREET AND 2ND AVENUE.	626.72
BM-57	NORTHWEST FLANGE BOLT ON FIRE HYDRANT AT SOUTHWEST CORNER OF LAKE STREET AND 1ST AVENUE.	629.10

LEGEND OF SYMBOLS

EXISTING	PROPOSED	DESCRIPTION
——(——		COMBINATION SEWER
(COMBINED RELIEF SEWER
		STORM SEWER
		WATER MAIN
0		MANHOLE, TYPE A, 4' DIAMETER
		INLET, TYPE A
\circ		CATCH BASIN
Я		FIRE HYDRANT
\otimes		WATER MAIN VALVE BOX
Ø		WATER SERVICE BOX
		HANDHOLE
		CURB & GUTTER TO BE REMOVED & REPLACED
		DRIVEWAY PAVEMENT REMOVAL
		PORTLAND CEMENT CONCRETE SIDEWALK
		PORTLAND CEMENT CONCRETE DRIVEWAY
		BRICK SIDEWALK
		SIDEWALK REMOVAL
	*	STREET LIGHT
		TREE WITH CAST IRON GRATE
627.60 620.35		RIM ELEVATION (COMBINED SEWER) INVERT ELEVATION
627.60 620.35		RIM ELEVATION (STORM) INVERT ELEVATION
627.60 620.35		RIM ELEVATION (WATER MAIN) TOP OF WATER MAIN

I.D.O.T. STANDARD DRAWINGS

STANDARD NO.	TITLE OR DESCRIPTION
000001-05	STANDARD SYMBOLS, ABBREVIATIONS AND PATTERNS
424001-05	CURB RAMPS FOR SIDEWALKS
701301-02	LANE CLOSURE, 2L, 2W, SHORT TIME OPERATIONS
701501-04	URBAN LANE CLOSURE, 2L, 2W UNDIVIDED
701701-05	. URBAN LANE CLOSURE, MULTILANE INTERSECTION
701801-03	LANE CLOSURE MULTILANE 1W OR 2W CROSSWALK OR SIDEWALK CLOSURE
701901	TRAFFIC CONTROL DEVICES



Westchester, Illinois 60154-2780 Phone: 708/865-0300 Fax: 708/865-1212

LAKE STREET STREETSCAPE **VILLAGE OF MAYWOOD, ILLINOIS**

INDEX OF SHEETS, LEGEND OF SYMBOLS, BENCHMARKS, & I.D.O.T. STANDARD DRAWINGS

	SCALE:	NONE	s
	DRAWN BY:	LEV ECW	1
	BOOK NO.:S	DR33/1480/1484/LS	1
	DATE:	02/20/2008	1
SION:	E.H.E. NO.:	565-06-15302	0

CONTRACT NO. 83938

ACCESS

THE CONTRACTOR WILL BE REQUIRED TO MAINTAIN ACCESS FOR EMERGENCY VEHICLES TO INGRESS AND EGRESS ONTO PRIVATE & COMMERCIAL PROPERTY DURING THE CONSTRUCTION PERIOD. ALSO DURING CONSTRUCTION, GARBAGE TRUCKS MUST BE PERMITTED ACCESS TO THE WORK ZONE IN ORDER TO PICK UP RESIDENTIAL AND COMMERCIAL GARBAGE FOR THOSE PROPERTIES FRONTING THE WORK ZONE.

STANDARDS

ANY REFERENCE TO STANDARDS THROUGHOUT THE PLANS OR SPECIAL PROVISIONS SHALL BE INTERPRETED TO BE THE LATEST STANDARD OF THE DEPARTMENT AS SHOWN ON THE INDEX OF SHEETS IN THE PLANS.

UNDERGROUND UTILITIES

THE LOCATIONS OF THE UNDERGROUND UTILITIES AS SHOWN ON THE PLANS HAVE BEEN OBTAINED BY FIELD SURVEYS AND SEARCHES OF AVAILABLE RECORDS. IT IS BELIEVED THAT THE DATA IS ESSENTIALLY CORRECT. BUT THE VILLAGE OF MAYWOOD, THE ILLINOIS DEPARTMENT OF TRANSPORTATION AND/OR OTHER OFFICES AND AGENCIES ASSOCIATED WITH THE DEVELOPMENT OF THESE PLANS DO NOT GUARANTEE THEIR ACCURACY OR COMPLETENESS. THE CONTRACTOR WILL BE REQUIRED TO VERIFY THE EXACT LOCATION OF EACH FACILITY WITH THE UTILITY COMPANY, AND SHALL TAKE DUE CARE IN ALL PHASES OF THE CONSTRUCTION TO PROTECT ANY SUCH FACILITIES WHICH MAY BE AFFECTED BY THE WORK. ANY DAMAGE TO EXISTING UTILITIES SHALL BE REPAIRED AT THE CONTRACTOR'S EXPENSE.

ADJUSTMENTS REQUIRED BY UTILITY COMPANIES WILL BE PERFORMED BY THE COMPANY INVOLVED OR ITS

COORDINATION OF ALL UTILITY WORK INVOLVED IN THE CONSTRUCTION AREA WILL BE DISCUSSED AT A PRE-CONSTRUCTION CONFERENCE

THE CONTRACTOR SHALL USE EXTREME CAUTION IN THE REMOVAL OF ABANDONED EXISTING GAS LINES SINCE RESIDUAL MATERIALS CONTAINED THEREIN ARE HIGHLY EXPLOSIVE, FLAMMABLE, AND TOXIC. ONCE THE MAINS ARE ABANDONED BY THE OWNER. THE CONTRACTOR SHALL ASSUME ALL RESPONSIBILITY FOR ANY DAMAGE AND/OR INJURY OCCURRING ON THE PROJECT DUE TO HIS OPERATIONS NEXT TO THE MAINS AND/OR THE METHOD OF REMOVAL OF THE ABANDONED MAINS. UNDER NO CIRCUMSTANCE SHALL THE UTILITY COMPANIES BE HELD LIABLE FOR ANY DAMAGE AND/OR INJURY ONCE THEIR MAINS HAVE BEEN RELOCATED AND THE EXISTING

EXISTING STRUCTURE MODIFICATIONS

ALL KNOWN EXISTING STRUCTURES IN THE PAVEMENT OR ADJACENT AREAS WHICH ARE INVOLVED IN THE CONSTRUCTION HAVE BEEN SHOWN ON THE PLANS AND NOTED AS TO BE REMOVED, FILLED, RECONSTRUCTED, OR ADJUSTED BY THE CONTRACTOR EXCEPT THOSE OF AMERITECH, COMED, AND THE NICOR GAS COMPANY, WHICH ARE TO BE ADJUSTED BY THE APPROPRIATE UTILITY FORCE. WHERE EXISTING STRUCTURES ARE TO REMOVED OR FILLED, OR THE EXISTING CASTING REPLACED, THE CASTINGS REMOVED FROM THE STRUCTURE BECOME THE PROPERTY OF THE VILLAGE OF MAYWOOD.

MAINTENANCE OF EXISTING DRAINAGE STRUCTURES

WHEN DURING THE CONSTRUCTION OPERATIONS, ANY LOOSE MATERIAL IS DEPOSITED IN THE FLOW LINE OF ANY GUTTERS OR DRAINAGE STRUCTURE SO THAT THE NATURAL FLOW OF WATER IS OBSTRUCTED, IT SHALL BE REMOVED AT THE CLOSE OF EACH WORKING DAY. AT THE CONCLUSION OF THE CONSTRUCTION OPERATIONS, ALL DRAINAGE FACILITIES SHALL BE CLEAN AND FREE OF ALL OBSTRUCTIONS. THE COST OF THIS WORK SHALL BE INCLUDED IN THE CONTRACT.

MAINTENANCE OF SEWER FLOWS

THE CONTRACTOR SHALL CONDUCT HIS OPERATIONS SO AS TO MAINTAIN AT ALL TIMES FLOWS THROUGH EXISTING STORM AND SANITARY SEWER SYSTEMS. HE SHALL ALSO PROVIDE AND MAINTAIN AN EFFICIENT PLIMPING PLANT IF NECESSARY AND A TEMPORARY OUTLIET AND BE PREPARED AT ALL TIMES TO DISPOSE OF THE WATER COLLECTED IN A SAFE MANNER WITHOUT DAMAGE OF ANY KIND TO ADJACENT PROPERTIES. THE ENDS OF EXISTING DRAINAGE LINES WHICH ARE NOT TO BE INCORPORATED INTO THE PROJECT ARE TO BE SEALED AS SPECIFIED IN THE SPECIAL PROVISIONS. THE COST OF ALL THE PREVIOUSLY MENTIONED WORK SHALL BE INCLUDED IN THE CONTRACT. ALL ACCUMULATION OF MATERIAL IN THE STRUCTURE DUE TO CONSTRUCTION OPERATIONS AS WELL AS MATERIAL EXISTING BEFORE CONSTRUCTION, SHALL BE REMOVED BY THE CONTRACTOR

AGGREGATE BEDDING FOR CONCRETE WORK

NEW COMBINATION CURB AND GUTTER, SIDEWALK AND DRIVEWAY PAVEMENT SHALL BE PLACED ON A MINIMUM OF TWO INCHES (2") OF COMPACTED CA-6 STONE BEDDING, NEW CONCRETE PAVEMENT, WHICH WILL BE INSTALLED WITHIN PROPOSED ALLEY RETURNS, SHALL BE PLACED ON A MINIMUM OF FOUR INCHES (4") OF COMPACTED CA-6 STONE BEDDING. ADDITIONAL AGGREGATE REQUIRED TO ADJUST THE EXISTING ELEVATION OF THE SUBGRADE TO THE PROPOSED ELEVATION WILL BE INCLUDED AS PART OF THIS WORK.

PAYMENT WILL NOT BE MADE SEPARATELY BUT WILL BE INCLUDED IN THE UNIT PRICE FOR THE RESPECTIVE CONCRETE ITEMS IN THE CONTRACT.

TRAFFIC PROTECTION

CONTRACTOR'S ATTENTION IS DIRECTED TO THE FACT THAT WHEN WORK COMMENCES, THE CONTRACTOR SHALL ASSUME THE MAINTENANCE OF ANY PAVEMENT, SHOULDERS, DRAINAGE FACILITIES, TRAFFIC CONTROL SIGNS, PAVEMENT MARKINGS, AND OTHER APPURTENANCES ON ROADWAYS WITHIN THE LIMITS OF THE CONTRACT WHICH ARE TO BE USED BY THE PUBLIC DURING CONSTRUCTION AND TO RETAIN THIS MAINTENANCE RESPONSIBILITY UNTIL THE VILLAGE ASSUMES THE MAINTENANCE. NEED FOR SNOW AND ICE CONTROL DURING THE CONSTRUCTION PERIOD SHALL BE ACCOMMODATED FOR BY OTHERS. ALL UNBALLASTED TYPE I & TYPE II BARRICADES SHALL HAVE TWO SANDBAGS ONE ACROSS EACH BOTTOM RAIL.

EXISTING ROADWAY SIGNS

ALL EXISTING ROADWAY SIGNS, MARKERS, ETC., LOCATED WITHIN THE ROADWAY RIGHT-OF-WAY WHICH ARE INVOLVED IN THIS CONSTRUCTION SHALL BE REMOVED AND DELIVERED TO THE VILLAGE PUBLIC WORKS YARD. ALL WORK ASSOCIATED WITH THIS ITEM SHALL BE CONSIDERED INCLUDED IN THE CONTRACT AND NO EXTRA COMPENSATION FCR REINSTALLATION WILL BE ALLOWED.

SAW CUTTING

THE CONTRACTOR SHALL SAW CUT ASPHALT PAVEMENT AND DRIVEWAY PAVEMENT AS INDICATED ON THE PLANS OR AS DIRECTED BY THE ENGINEER, TO SEPARATE THE EXISTING PAVEMENT TO BE REMOVED BY MEANS OF AN APPROVED CONCRETE SAW TO A DEPTH AS DIRECTED BY THE ENGINEER. SUITABLE GUIDELINES OR DEVICES SHALL BE USED TO ASSURE CUTTING A NEAT, STRAIGHTLINE AS SHOWN ON THE PLANS, CARE SHALL BE TAKEN BY THE CONTRACTOR SO AS NOT TO DAMAGE THE REMAINING PAVEMENT DIRECTLY ADJACENT TO THE PAVEMENT TO BE REMOVED. ANY DAMAGE TO THE EXISTING PAVEMENT, RESULTING FROM PAVEMENT REMOVAL OPERATIONS SHALL BE REPAIRED AT THE CONTRACTOR'S EXPENSE. THE PRICE OF SAW CUTTING, AS NOTED ABOVE, SHALL BE INCLUDED IN THE PARTICULAR PAY ITEMS.

TEMPORARY TRAFFIC CONTROL

THE RESIDENT ENGINEER SHALL CONTACT THE TRAFFIC CONTROL SUPERVISOR AT (847) 705-4470 A MINIMUM OF 72 HOURS PRIOR TO THE PLACEMENT OF TEMPORARY TRAFFIC CONTROL DEVICES.

♦ Municipal Consultants

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Fax: 708/865-1212

LAKE STREET STREETSCAPE **VILLAGE OF MAYWOOD, ILLINOIS**

GENERAL NOTES


RAWN BY: LEV ECW 3 BOOK NO.:SDR33/1480/1484/L 02/20/2008 565-06-1530

	SUMMARY OF QUANTIT	IES		H22	070
CODE	PAY ITEM	UNIT	TOTAL QUANTITY	Y003 80% FEDERAL 20% LOCAL	Y003 100% LOCA
20200100	EARTH EXCAVATION	CUYD	45	45	0
21101615	TOPSOIL FURNISH AND PLACE, 4"	SQYD	200	200	0
25000400	NITROGEN FERTILIZER NUTRIENT	LBS	3	3	0
25000500	PHOSPHORUS FERTILIZER NUTRIENT	LBS	3	3	0
25000600	POTASSIUM FERTILIZER NUTRIENT	LBS	3	3	· - f 0
25200100	SODDING	SQYD	200	200	0
25300500	TOPSOIL FOR PLANTING	CUYD	45	45	0
42101300	PROTECTIVE COAT	SQYD	3730	3730	0
42300300	PORTLAND CEMENT CONCRETE DRIVEWAY PAVEMENT, 7"	SQYD	525	525	0
42300400	PORTLAND CEMENT CONCRETE DRIVEWAY PAVEMENT, 8"	SQYD	200	200	0
42400200	PORTLAND CEMENT CONCRETE SIDEWALK, 5"	SQFT	27500	27500	0
42400800	DETECTABLE WARNINGS	SQFT	1100	1100	0
44000200	DRIVEWAY PAVEMENT REMOVAL	SQYD	525	525	0
44000500	COMBINATION CURB AND GUTTER REMOVAL	FOOT	520	520	0
44000600	SIDEWALK REMOVAL	SQFT	39500	39500	0
56500600	DOMESTIC WATER SERVICE BOXES TO BE ADJUSTED	EACH	7	7	0
60266600	VALVE BOXES TO BE ADJUSTED	EACH	1	1	0
60300305	FRAMES AND LIDS TO BE ADJUSTED	EACH	2	2	0
60604100	COMBINATION CONCRETE CURB AND GUTTER,				
	TYPE B-6.12 (MODIFIED)	FOOT	520	520	0
67100100	MOBILIZATION	LSUM	1	1	0
70101800	TRAFFIC CONTROL AND PROTECTION (SPECIAL)	LSUM	1	1 '	0
80400100	ELECTRIC SERVICE INSTALLATION	EACH	1	1 '	0
81018500	CONDUIT PUSHED, 2" DIA., GALVANIZED STEEL	FOOT	1350	1350	0
81019000	CONDUIT PUSHED, 5" DIA., GALVANIZED STEEL	FOOT	60	60	0
81400115	HANDHOLE TO BE ADJUSTED	EACH	8	8	0
81603090	UNIT DUCT, 600V, 3-1C NO. 4, 1/C NO. 6				
	GROUND, (XLP-TYPE USE), 1 1/4" DIA., POLYETHYLENE	FOOT	7520	7520	0
81702440	ELECTRIC CABLE IN CONDUIT, 600V, (XLP-TYPE USE)				
	3-1/C NO. 1/0	FOOT	75	75	0
81900200	TRENCH AND BACKFILL FOR ELECTRICAL WORK	FOOT	5700	5700	0
82500505	LIGHTING CONTROLLER, SPECIAL	EACH	1	1	0
84200600	REMOVAL OF EXISTING LIGHTING UNIT, NO SALVAGE	EACH	37	0	37
84200700	LIGHTING FOUNDATION REMOVAL	EACH	37	0	37

PAY ITEM	UNIT	TOTAL	Y003	Y003
PAY ITEM	LINDT		80% FEDERAL	100%
	UNIT	QUANTITY	20% LOCAL	LOCAL
DEMOVAL OF LIGHTING CONTROLLED	FAOL			
REMOVAL OF LIGHTING CONTROLLER	EACH	1	0	1
	EACH	1	0	1
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	EACH	9	9	0
		_		
	EACH	8	8	0
•				
•				
				0
TEMPORARY INFORMATION SIGNING		103	103	0
MAINTENANCE OF LIGHTING SYSTEM		6	0	6
				0
CAST IRON TREE GRATES	EACH	26	26	0
GROUND ROD, 5/8" X 10 FT	EACH	60	60	0
PORTLAND CEMENT CONCRETE BASE COURSE, 3"	SQFT	11800	11800	00
DECORATIVE LIGHT POLE, CONCRETE, 30' MOUNTING				
HEIGHT WITH 1-6' MAST ARM AND 1-3' MAST ARM	EACH	60	0	60
DECORATIVE LUMINAIRE, METAL HALIDE, HORIZONTAL				
MOUNT 150 WATT	EACH	46	0	46
LUMINAIRE, METAL HALIDE, SPECIAL,				
TYPE III, 175 WATT	EACH	8	0	8
LUMINAIRE, METAL HALIDE, SPECIAL,				
YPE III, 400 WATT	EACH	6	0	6
LUMINAIRE, METAL HALIDE, SPECIAL,				
YPE III, 70 WATT	EACH	60	60	0
	REMOVAL OF LIGHTING CONTROLLER FOUNDATION REE, ACER PLATANOIDES COLUMNARE (COLUMNAR IORWAY MAPLE), 3" CALIPER, BALLED AND RURLAPPED REE, GLEDITSIA TRIACANTHOS INTERMIS RHADEMASTER (SHADEMASTER THORNLESS COMMON RONEY LOCUST) 3" CALIPER, BALLED AND BURLAPPED REE, TILIA CORDATA GREENSPIRE (GREENSPIRE ITTLE LEAF LINDEN), 3" CALIPER, BALLED AND RURLAPPED REMPORARY INFORMATION SIGNING MAINTENANCE OF LIGHTING SYSTEM RECORATIVE BRICK SIDEWALK RAST IRON TREE GRATES ROUND ROD, 5/8" X 10 FT RORTLAND CEMENT CONCRETE BASE COURSE, 3" RECORATIVE LIGHT POLE, CONCRETE, 30' MOUNTING REIGHT WITH 1-6' MAST ARM AND 1-3' MAST ARM RECORATIVE LUMINAIRE, METAL HALIDE, HORIZONTAL MOUNT 150 WATT LUMINAIRE, METAL HALIDE, SPECIAL, RYPE III, 175 WATT LUMINAIRE, METAL HALIDE, SPECIAL, RYPE III, 400 WATT LUMINAIRE, METAL HALIDE, SPECIAL, RYPE III, 400 WATT	REMOVAL OF LIGHTING CONTROLLER FOUNDATION REE, ACER PLATANOIDES COLUMNARE (COLUMNAR RIORWAY MAPLE), 3" CALIPER, BALLED AND BURLAPPED REE, GLEDITSIA TRIACANTHOS INTERMIS SHADEMASTER (SHADEMASTER THORNLESS COMMON RIONEY LOCUST) 3" CALIPER, BALLED AND BURLAPPED REE, TILIA CORDATA GREENSPIRE (GREENSPIRE RITTLE LEAF LINDEN), 3" CALIPER, BALLED AND BURLAPPED REMPORARY INFORMATION SIGNING REMPORARY INFORMATION SIGNING RECORATIVE BRICK SIDEWALK RAST IRON TREE GRATES ROUND ROD, 5/8" X 10 FT RORTLAND CEMENT CONCRETE BASE COURSE, 3" RECORATIVE LIGHT POLE, CONCRETE, 30' MOUNTING REIGHT WITH 1-6' MAST ARM AND 1-3' MAST ARM RECORATIVE LUMINAIRE, METAL HALIDE, HORIZONTAL ROUNT 150 WATT LUMINAIRE, METAL HALIDE, SPECIAL, RYPEIIL, 175 WATT LUMINAIRE, METAL HALIDE, SPECIAL, RYPEIIL, 400 WATT LUMINAIRE, METAL HALIDE, SPECIAL, RYPEIIL, 70 WATT LUMINAIRE, METAL HALIDE, SPECIAL, RYPEILL, 70 WATT	REMOVAL OF LIGHTING CONTROLLER FOUNDATION REE, ACER PLATANOIDES COLUMNARE (COLUMNAR RORWAY MAPLE), 3" CALIPER, BALLED AND RURLAPPED REE, GLEDITSIA TRIACANTHOS INTERMIS RHADEMASTER (SHADEMASTER THORNLESS COMMON RONEY LOCUST) 3" CALIPER, BALLED AND BURLAPPED REE, TILIA CORDATA GREENSPIRE (GREENSPIRE RITTLE LEAF LINDEN), 3" CALIPER, BALLED AND RURLAPPED REMPORARY INFORMATION SIGNING RAINTENANCE OF LIGHTING SYSTEM REACH REACH RECORATIVE BRICK SIDEWALK RAST IRON TREE GRATES ROUND ROD, 5/8" X 10 FT RORTLAND CEMENT CONCRETE BASE COURSE, 3" RECORATIVE LIGHT POLE, CONCRETE, 30' MOUNTING REIGHT WITH 1-6' MAST ARM AND 1-3' MAST ARM RECORATIVE LUMINAIRE, METAL HALIDE, HORIZONTAL ROUNT 150 WATT ROUND ROD, 5/8" WATT REACH RE	REMOVAL OF LIGHTING CONTROLLER FOUNDATION REE, ACER PLATANOIDES COLUMNARE (COLUMNAR IORWAY MAPLE), 3" CALIPER, BALLED AND BURLAPPED REE, GLEDITSIA TRIACANTHOS INTERMIS REACH 9 9 REE, GLEDITSIA TRIACANTHOS INTERMIS REACH 9 9 REE, GLEDITSIA TRIACANTHOS INTERMIS REACH 9 9 REE, TILIA CORDATA GREENSPIRE (GREENSPIRE REE, TILIA CORDATA GREENSPIRE (GREENSPIRE RETTLE LEAF LINDEN), 3" CALIPER, BALLED AND REACH 9 9 REMPORARY INFORMATION SIGNING SQFT 103 103 RAINTENANCE OF LIGHTING SYSTEM CAL MO 6 0 RECORATIVE BRICK SIDEWALK SQFT 11800 11800 RECORATIVE BRICK SIDEWALK SQFT 11800 11800 RECORATIVE LIGHT POLE, CONCRETE, 30' MOUNTING REIGHT WITH 1-6' MAST ARM AND 1-3' MAST ARM EACH 60 0 RECORATIVE LIGHT POLE, CONCRETE, 30' MOUNTING REIGHT WITH 1-6' MAST ARM AND 1-3' MAST ARM EACH 60 0 RECORATIVE LUMINAIRE, METAL HALIDE, HORIZONTAL MOUNT 150 WATT EACH 46 0 LUMINAIRE, METAL HALIDE, SPECIAL, REPEBLIT, 75 WATT EACH 6 0 LUMINAIRE, METAL HALIDE, SPECIAL, RECH 6 0 LUMINAIRE, METAL HALIDE, SPECIAL, REACH 6 0


* DENOTES SPECIALTY ITEM

LAKE STREET STREETSCAPE VILLAGE OF MAYWOOD, ILLINOIS DRAWN BY: LEV ECW BOOK NO.:SDR33/1480/1484/LS DATE: .02/20/2008 E.H.E. NO.: 565-06-15302

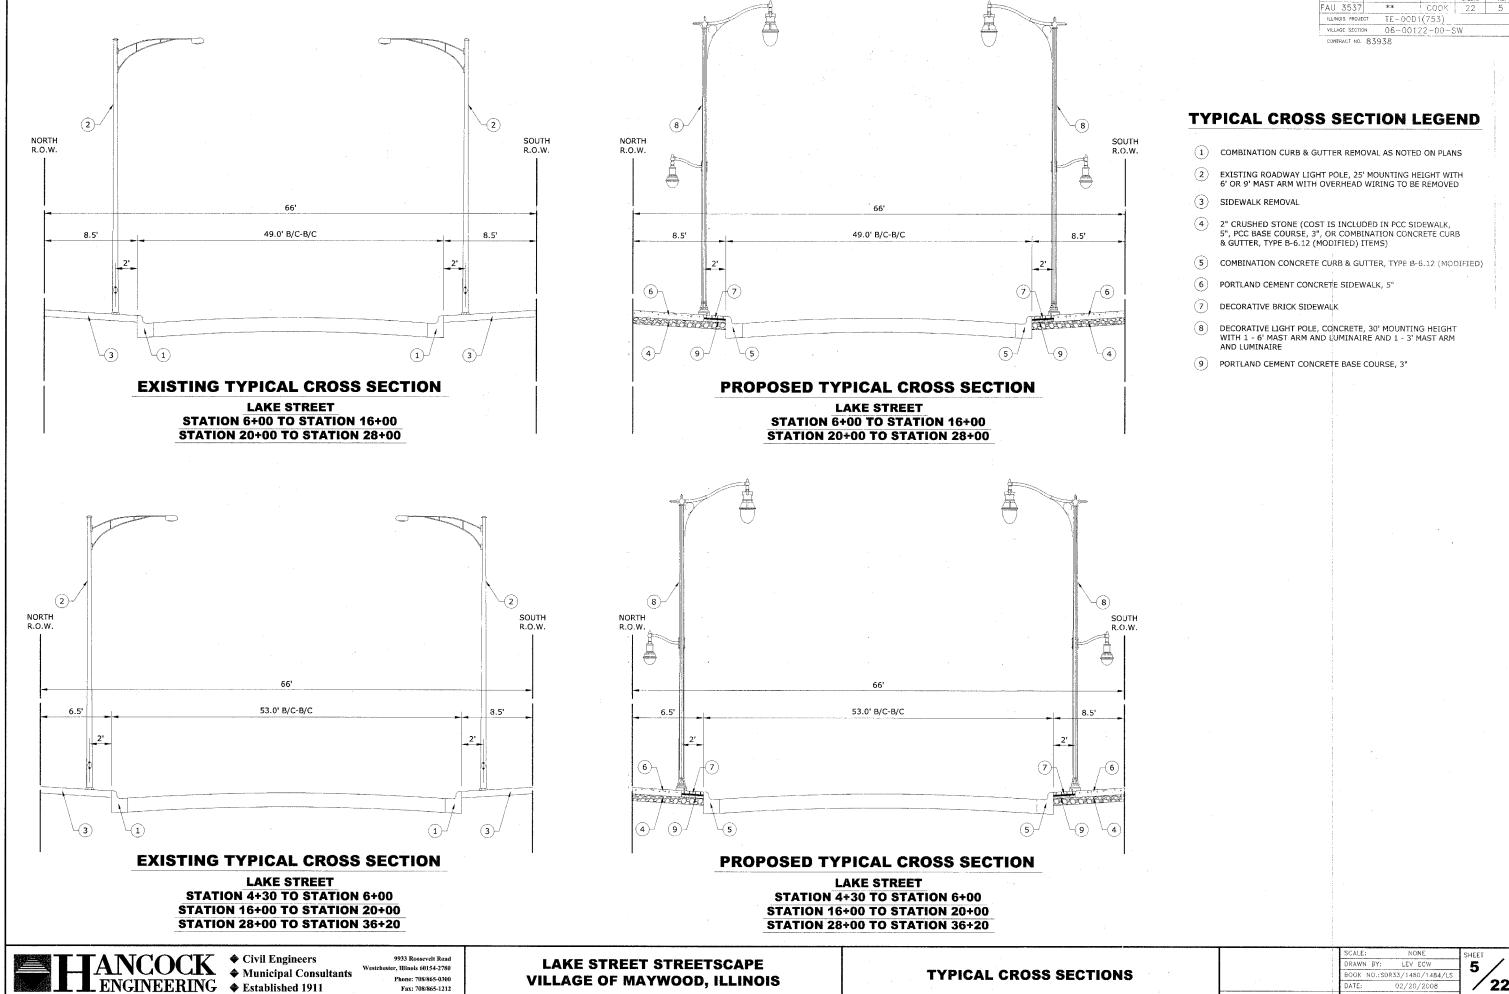



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02/20/2008



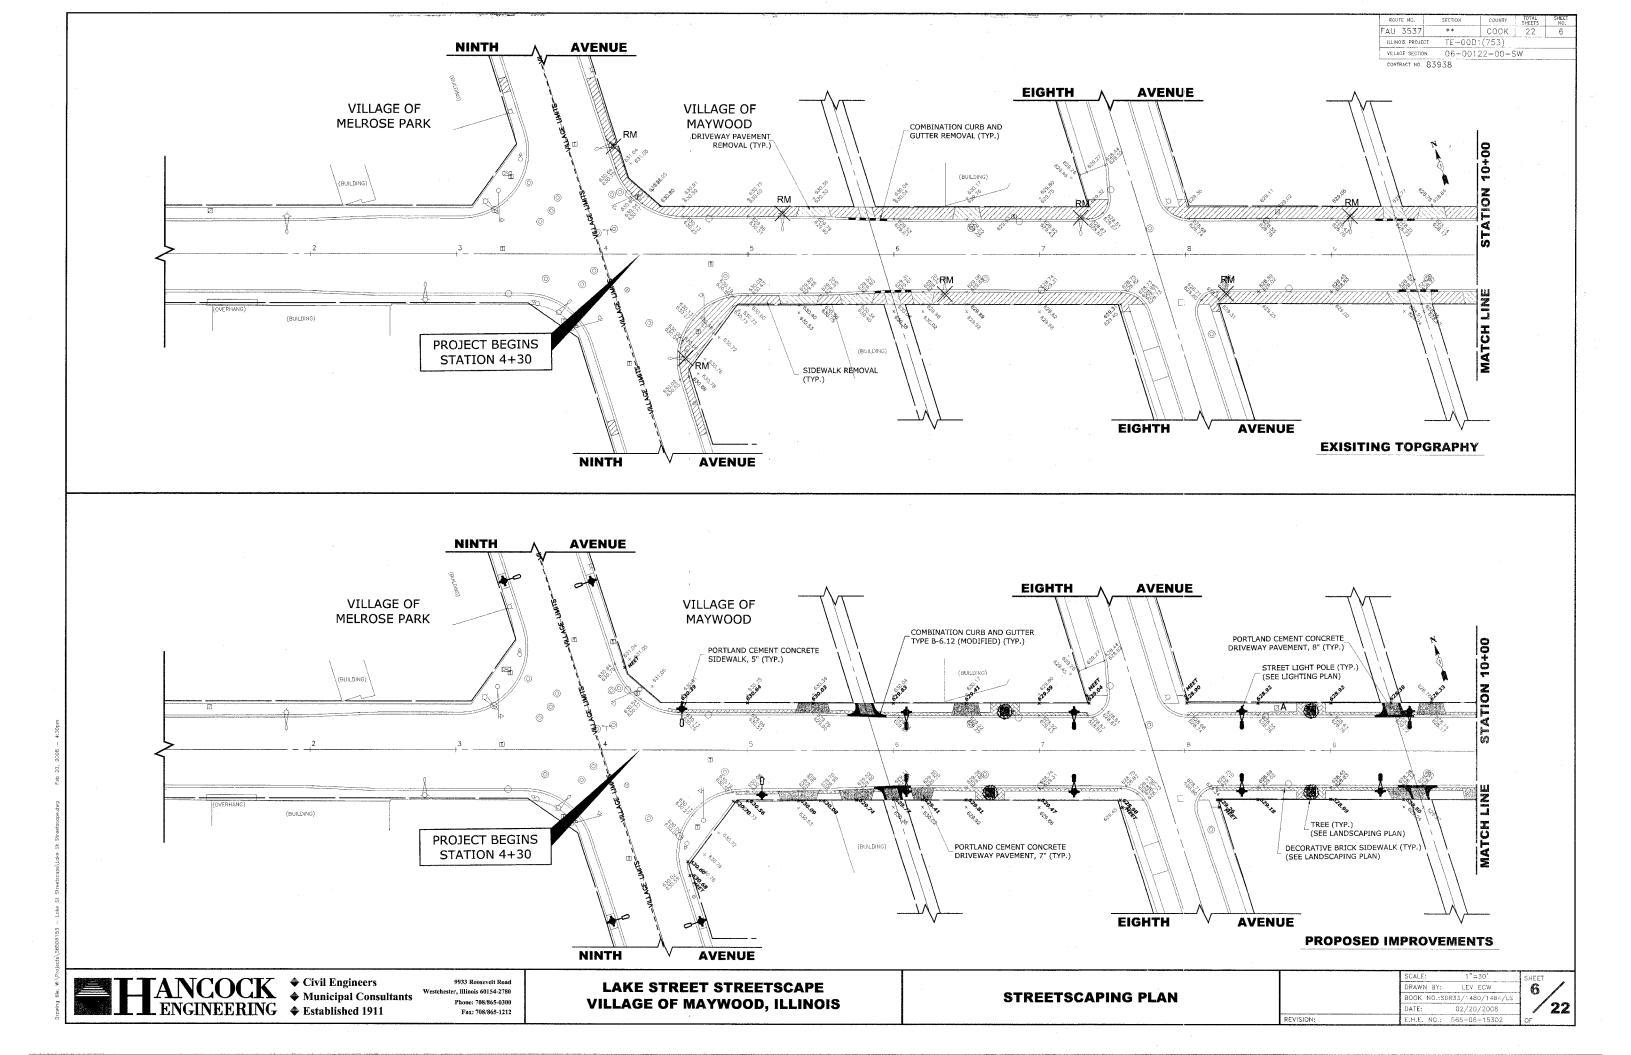



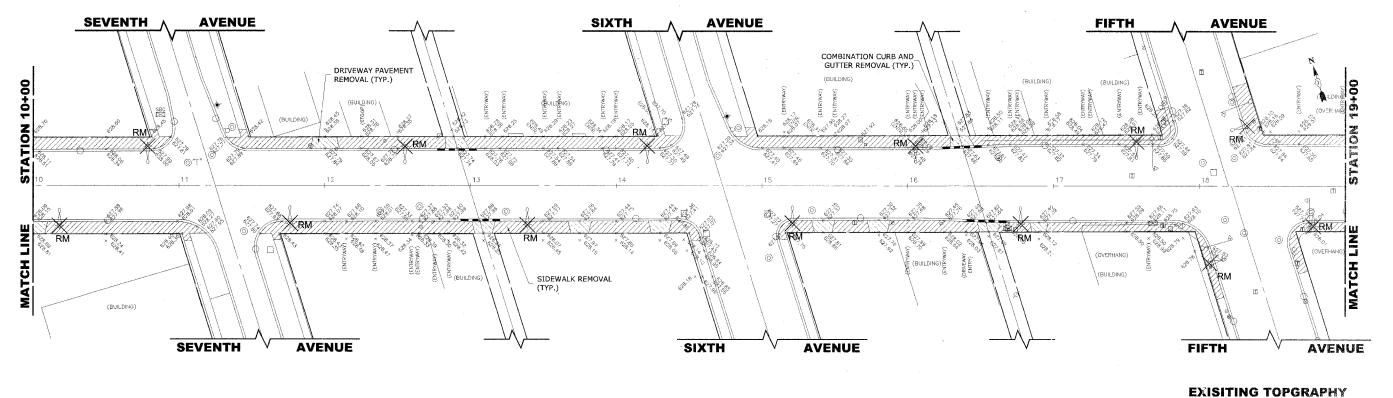
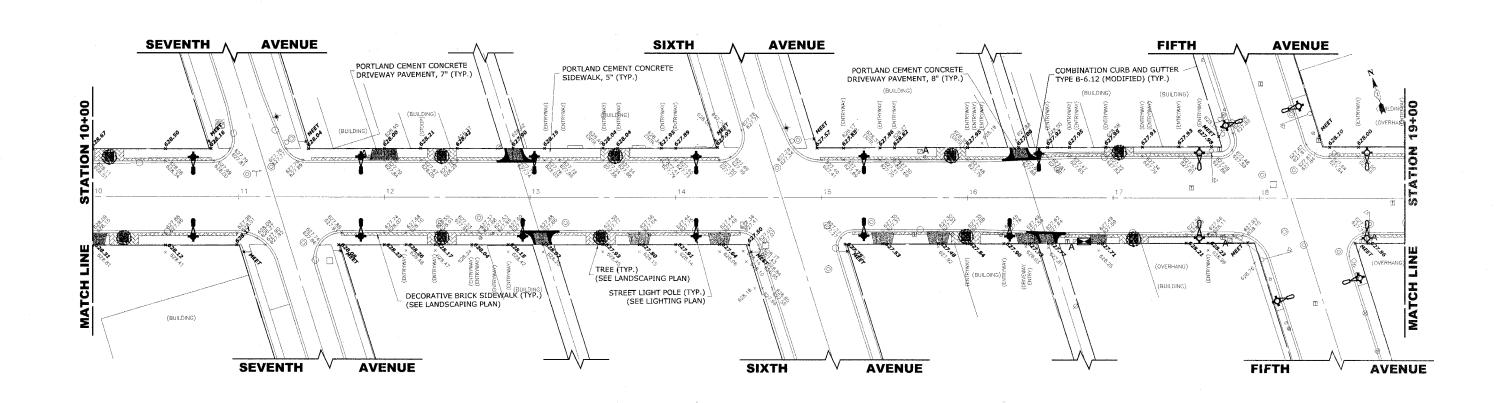
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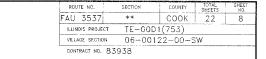
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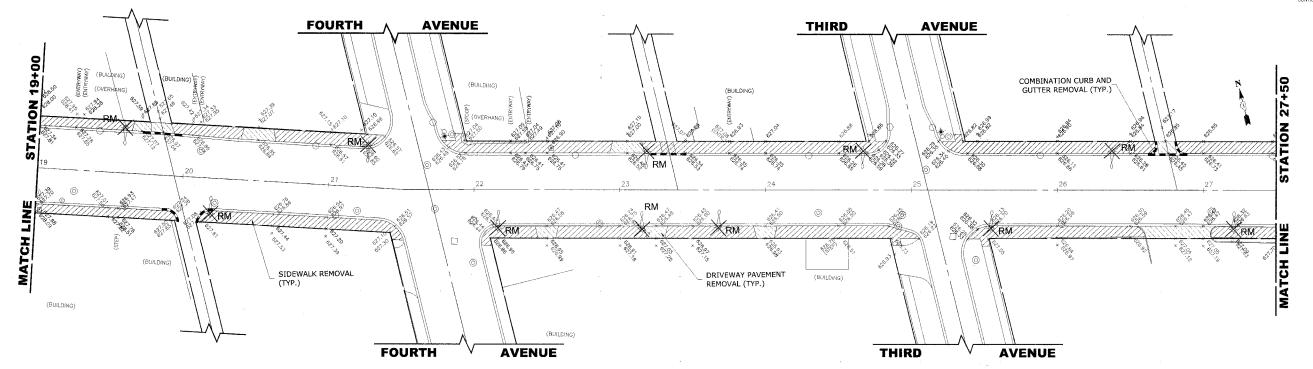
LAKE STREET STREETSCAPE **VILLAGE OF MAYWOOD, ILLINOIS**

STREETSCAPING PLAN


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	DATE:	02/20/2008	1.
VISION:	E.H.E. NO.:	565-06-15302	OF

PROPOSED IMPROVEMENTS







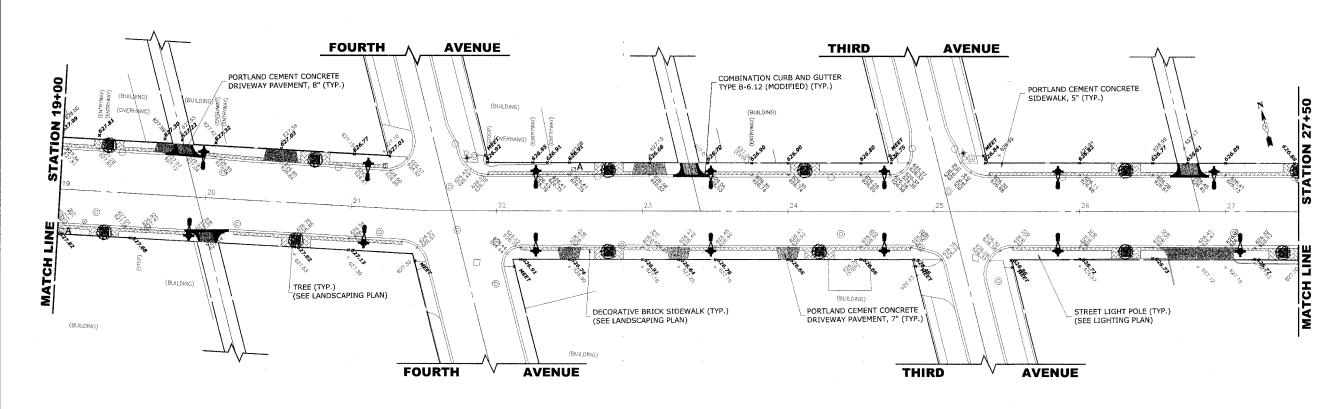

PROPOSED IMPROVEMENTS

Civil Engineers


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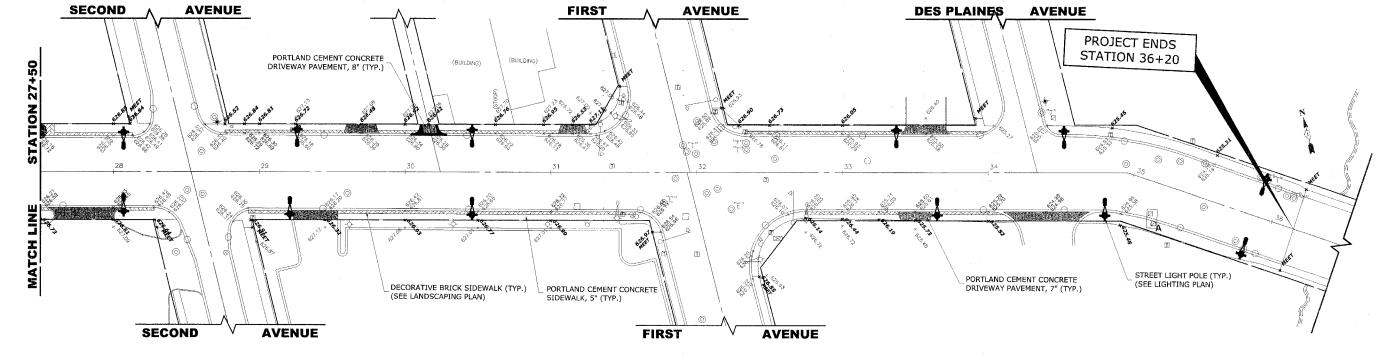
LAKE STREET STREETSCAPE **VILLAGE OF MAYWOOD, ILLINOIS**

STREETSCAPING PLAN

	SCALE:	1"=30'	SHEET
	DRAWN BY:	LEV ECW	8 /
	BOOK NO.:SI	DR33/1480/1484/LS	/_
	DATÉ:	02/20/2008	/ 2
SION:	E.H.E. NO.:	565-06-15302	OF

/22



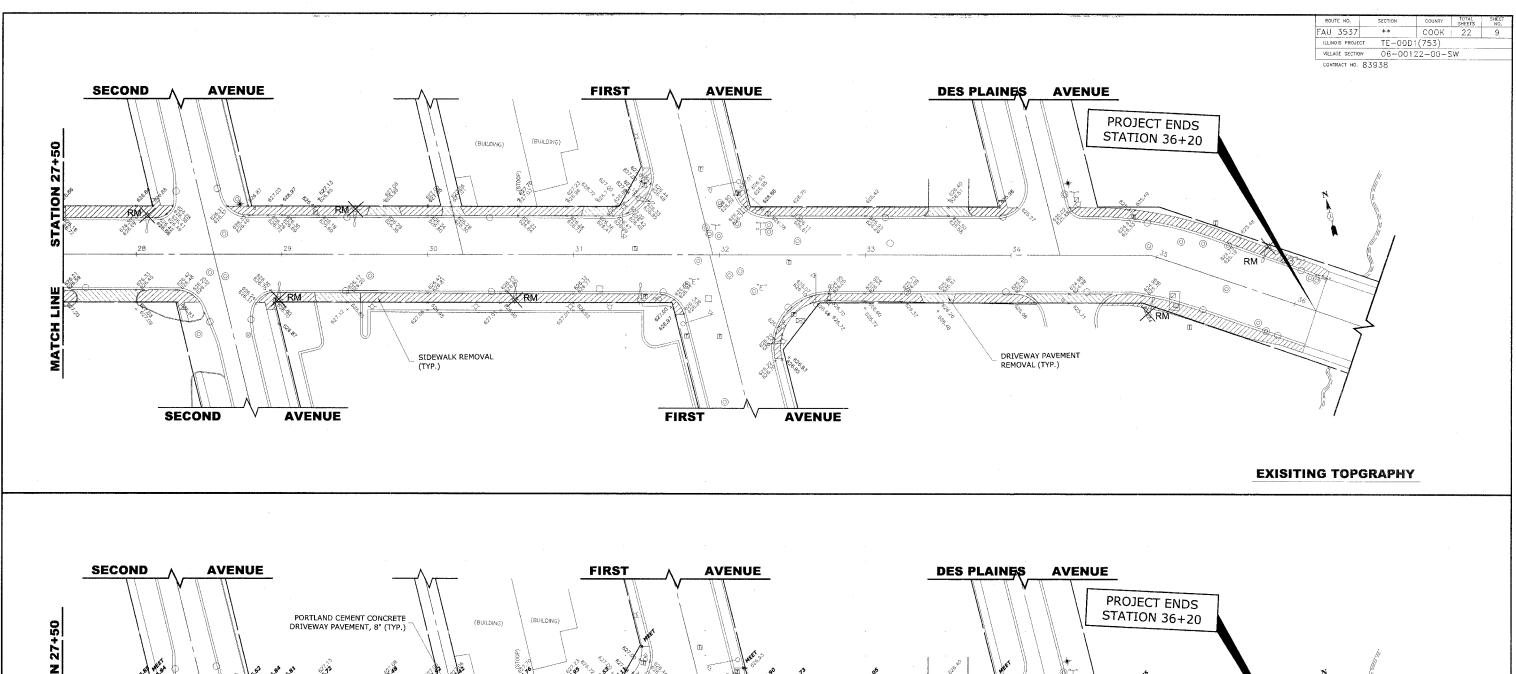

ANCOCK

† Civil Engineers

† Municipal Consultants

† Established 1911

Phone: 708/865-0300 Fax: 708/865-1212

LAKE STREET STREETSCAPE **VILLAGE OF MAYWOOD, ILLINOIS**

STREETSCAPING PLAN

9 E.H.E. NO.: 565-06-15302

PROPOSED IMPROVEMENTS

CONTRACT NO. 83938

GENERAL NOTES

2. THE CONTRACTOR SHALL SAW CUT ALL BUTT JOINTS TO ADJOINING PAVEMENTS NOT MORE THAN 24 HOURS PRIOR TO

3. THE CONTRACTOR SHALL SAW CUT THE PAVEMENT FULL DEPTH SIX INCHES (6") IN FRONT OF ALL CURB & GUTTER TO

4. IT SHALL BE THE CONTRACTOR'S RESPONSIBILITY TO TAKE PRECAUTIONS SO AS NOT TO DAMAGE PARKWAYS AND CURB OUTSIDE THE PRESCRIBED LIMITS OF RESTORATION. NO PARKWAY OR CURB RESTORATION IS INCLUDED FOR PAYMENT


5. STOCKPILING OF MATERIALS ON THE PARKWAYS OR CURB WILL NOT BE ALLOWED, INCLUDING EXCAVATED MATERIAL

OR TRENCH BACKFILL MATERIAL. THE CONTRACTOR SHALL BE RESPONSIBLE FOR RESTORING ANY DAMAGE TO THE PARKWAY OR SOD OUTSIDE OF THE PRESCRIBED LIMITS TO THE SATISFACTION OF THE ENGINEER AND THE VILLAGE AT

1. THE CONTRACTOR SHALL SAW CUT ALL PCC SIDEWALKS WHERE PARTIAL REMOVAL IS SHOWN (INCLUDED IN


BE REMOVED PRIOR TO REMOVAL. NO ADDITIONAL COMPENSATION WILL BE ALLOWED.


EXCEPT AS NECESSARY FOR REPLACEMENT, OR AS DIRECTED BY ENGINEER.

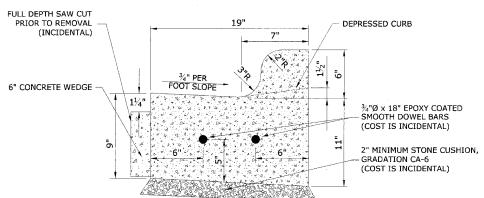

- PROVIDE 2 34° 0 EPOXY COATED SMOOTH BARS WITH PLASTIC EXPANSION CAPS AT EACH EXPANSION JOINT WHICH SHALL BE LOCATED ON EACH SIDE OF EXISTING DRAINAGE STRUCTURES, AT PCS AND WHERE DIRECTED BY ENGINEER.
- 2. CONTRACTION JOINTS SHALL BE PLACED AT EQUAL SPACES (EVERY FIFTEEN FEET) IN THE UPPER $\frac{1}{2}$ of curb and gutters within 24 hours of placement.
- 6° Concrete wedge to be poured in the space between the new curb and the existing pavement, after the curb has reached its initial set.
- 4. THE NEW CURB AND GUTTER SHALL BE BACKFILLED FOR THE FULL-DEPTH OF THE CURB WITH CA-7 OR OTHER STONE APPROVED BY ENGINEER.
- THE COST OF THE ABOVE SHALL BE CONSIDERED INCIDENTAL TO THE COMBINATION CONCRETE CURB AND GUTTER ITEM.

COMBINATION CONCRETE CURB & GUTTER TYPE B-6.12 (MODIFIED)

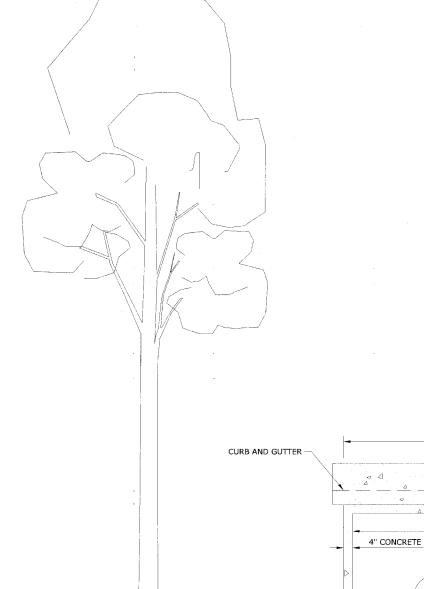

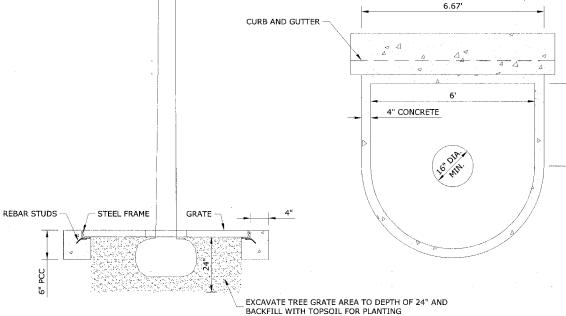

- 1. EAST JORDAN NUMBER: 8677 & 8678 AND FRAME COMBINATION
- 2. NEENAH R-8939 AND FRAME
- 3. OR EQUAL

CAST IRON TREE GRATES

ANCOCK

† Civil Engineers

† Municipal Consultants

ENGINEERING

† Established 1911

Phone: 708/865-0300 Fax: 708/865-1212


LAKE STREET STREETSCAPE **VILLAGE OF MAYWOOD, ILLINOIS**

ROADWAY DETAILS


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	BOOK NO.:SD	R33/1480/1484/LS	1 •
	DATE:	02/20/2008	1,
VISION:	E.H.E. NO.:	565-06-15302	OF.

- 1. THE CONTRACTOR SHALL PROVIDE ALL LABOR/MATERIALS REQUIRED TO EXCAVATE, INSTALL BASE, SAND SETTING BED, EDGE RESTRAINT, AND PAVERS AT LOCATIONS SHOWN ON PLANS AND AS DIRECTED BY ENGINEER.
- 2. PAVERS SHALL MEET THE REQUIREMENTS OF ASTM C-936.
- 3. BASE COURSE MATERIAL SHALL CONSIST OF PORTLAND CEMENT CONCRETE BASE.
- 4. THE PAVERS SHALL BE INSTALLED IN A HERRINGBONE 45° OR 90° STYLE.

DECORTIVE BRICK SIDEWALK

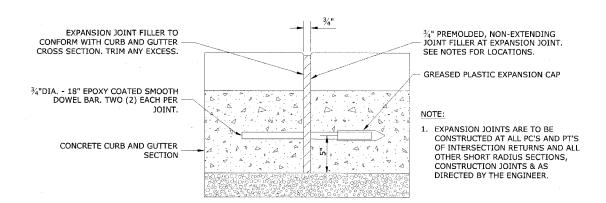


TYPICAL CURB AND GUTTER EXPANSION JOINT

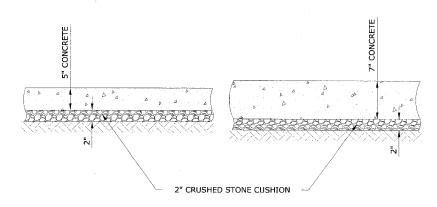


SIDEWALK & DRIVEWAY CROSS SECTION

COOK 22 11 ILLINOIS PROJECT TE-00D1(753) 06-00122-00-SW CONTRACT NO. 83938

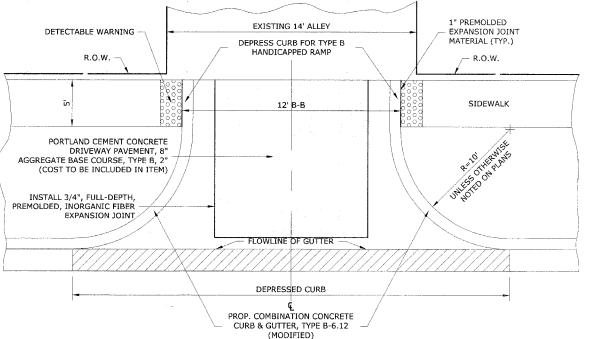

CONCRETE ALLEY RETURN

NOTE: UNLESS OTHERWISE NOTED ON PLAN USE RADII AS MARKED ABOVE.

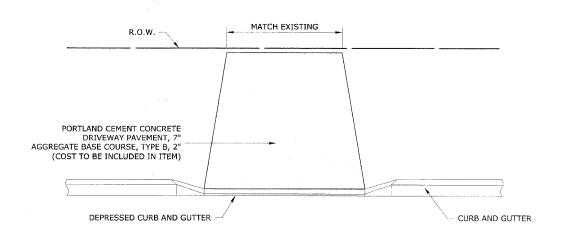

PORTLAND CEMENT CONCRETE DRIVEWAY PAVEMENT, 7"

ENGINEERING \$\(\phi\) Established 1911

Civil Engineers

♦ Municipal Consultants


Westchester, Illinois 60154-2780 Phone: 708/865-0300


Fax: 708/865-1212


LAKE STREET STREETSCAPE **VILLAGE OF MAYWOOD, ILLINOIS**


ROADWAY DETAILS


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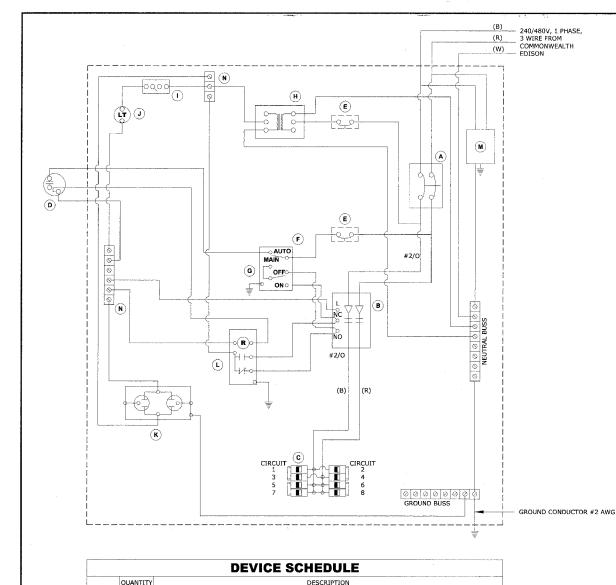


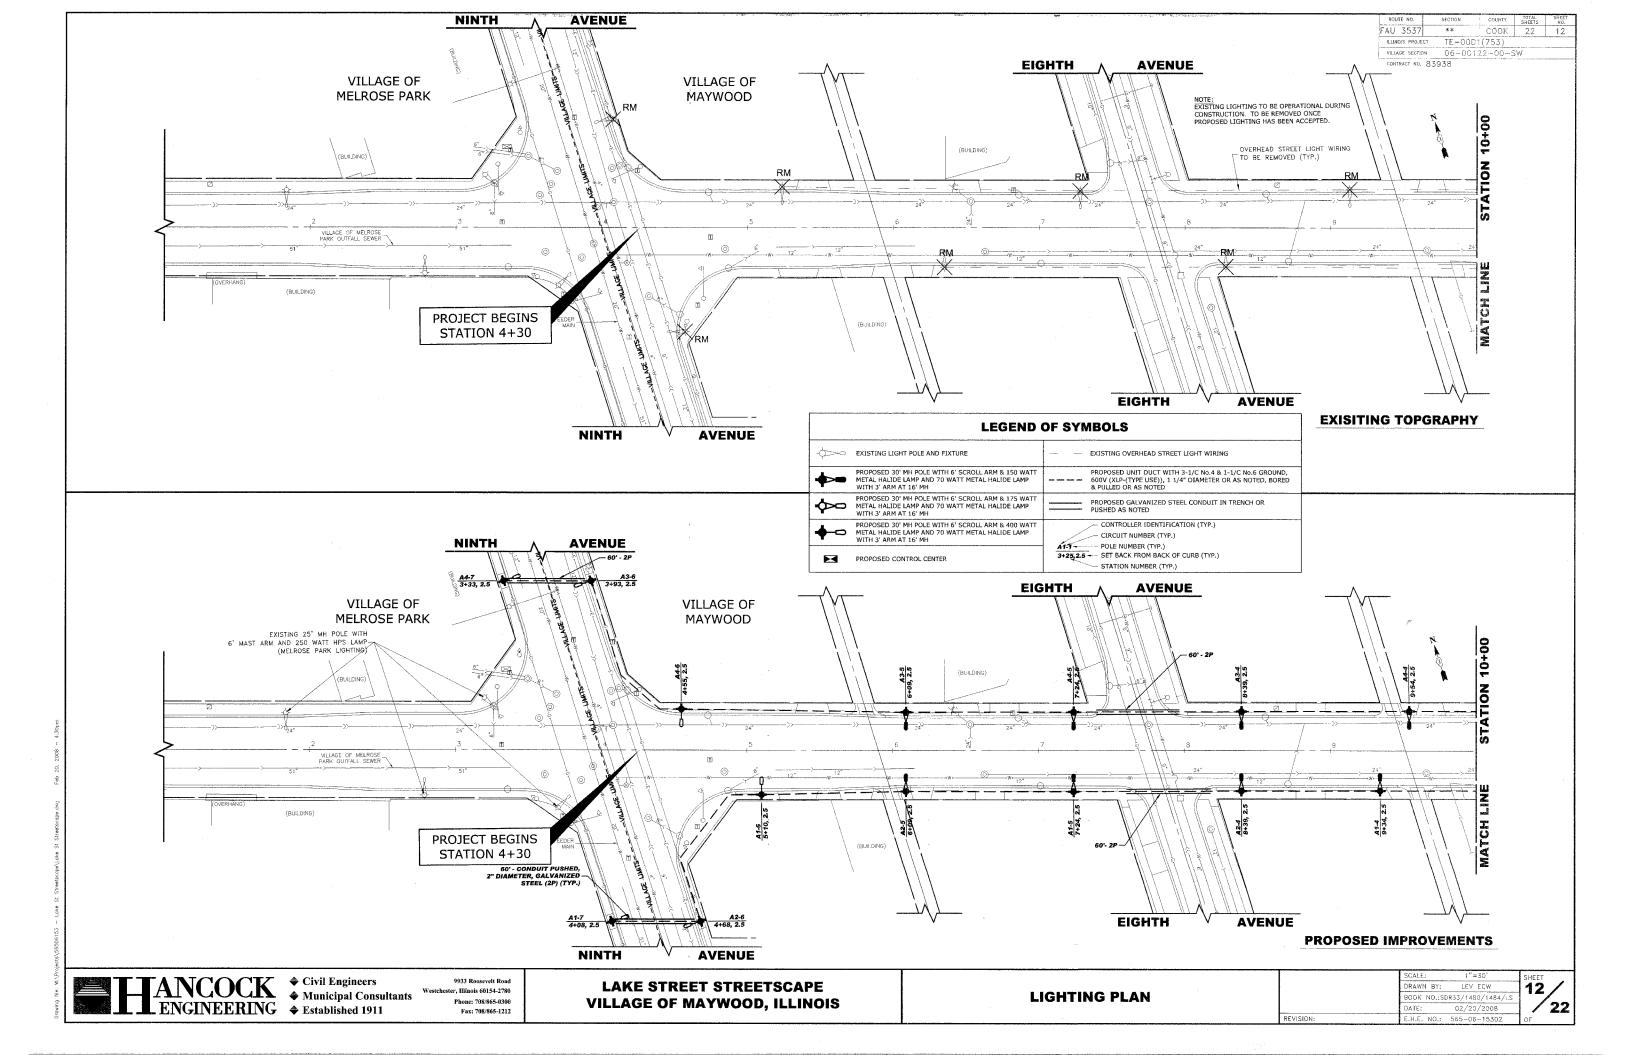


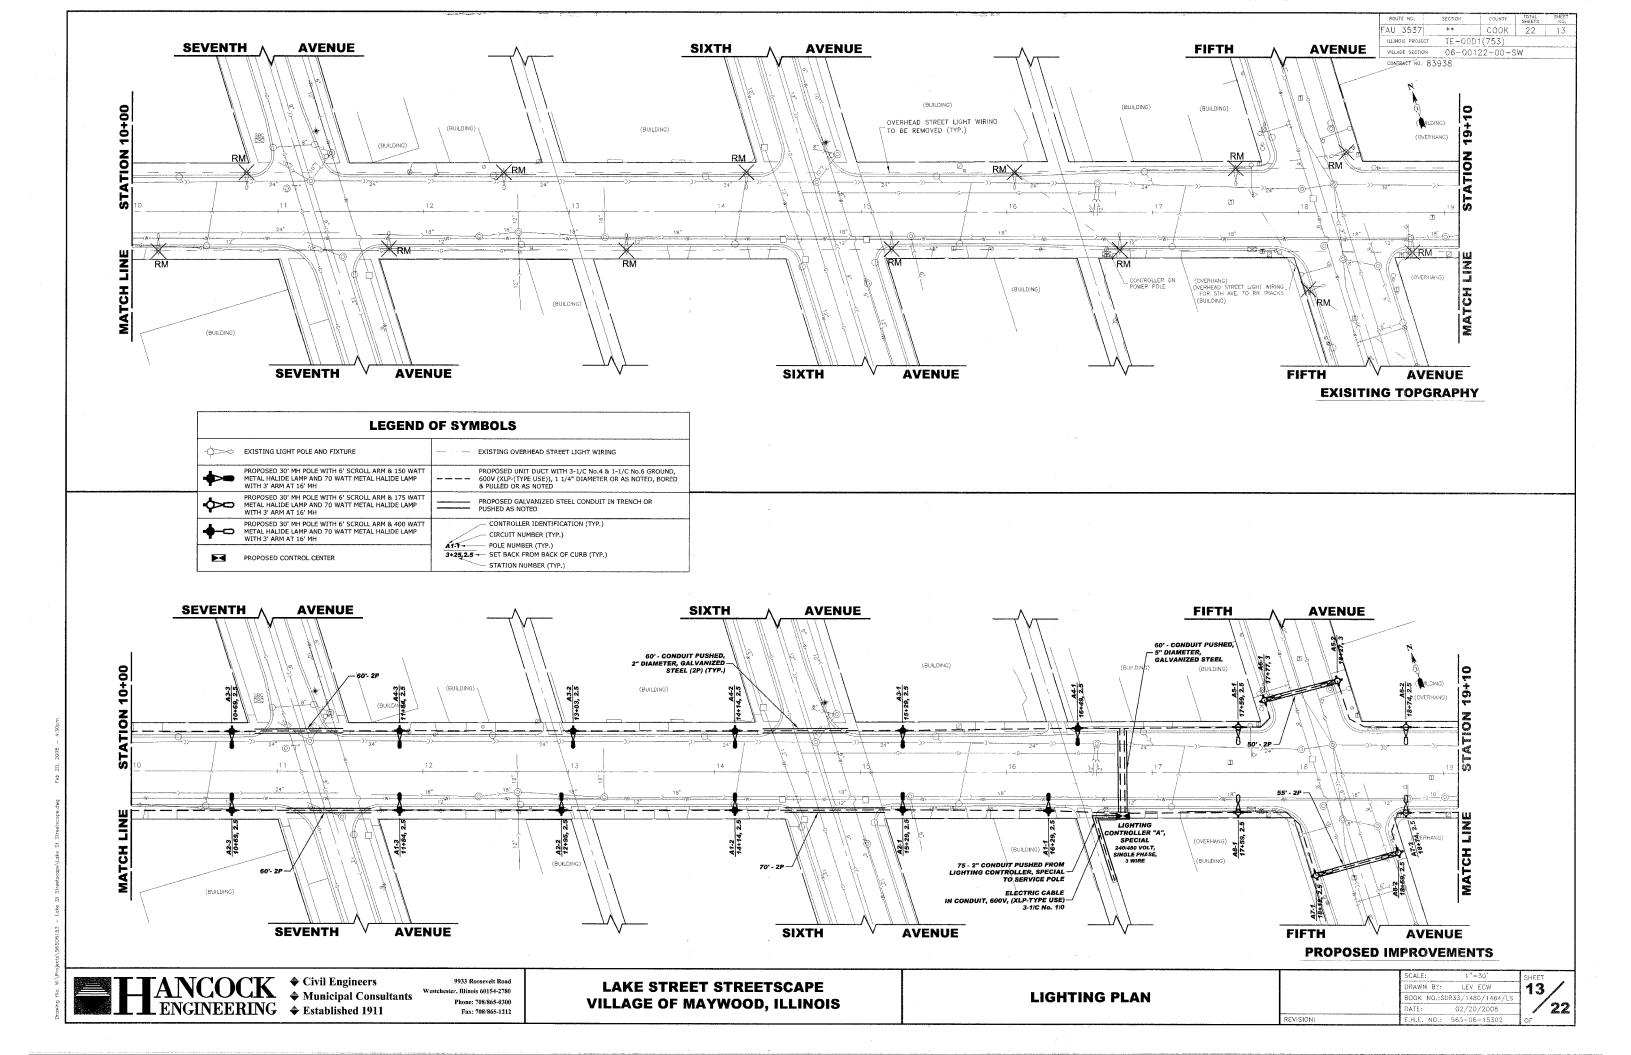

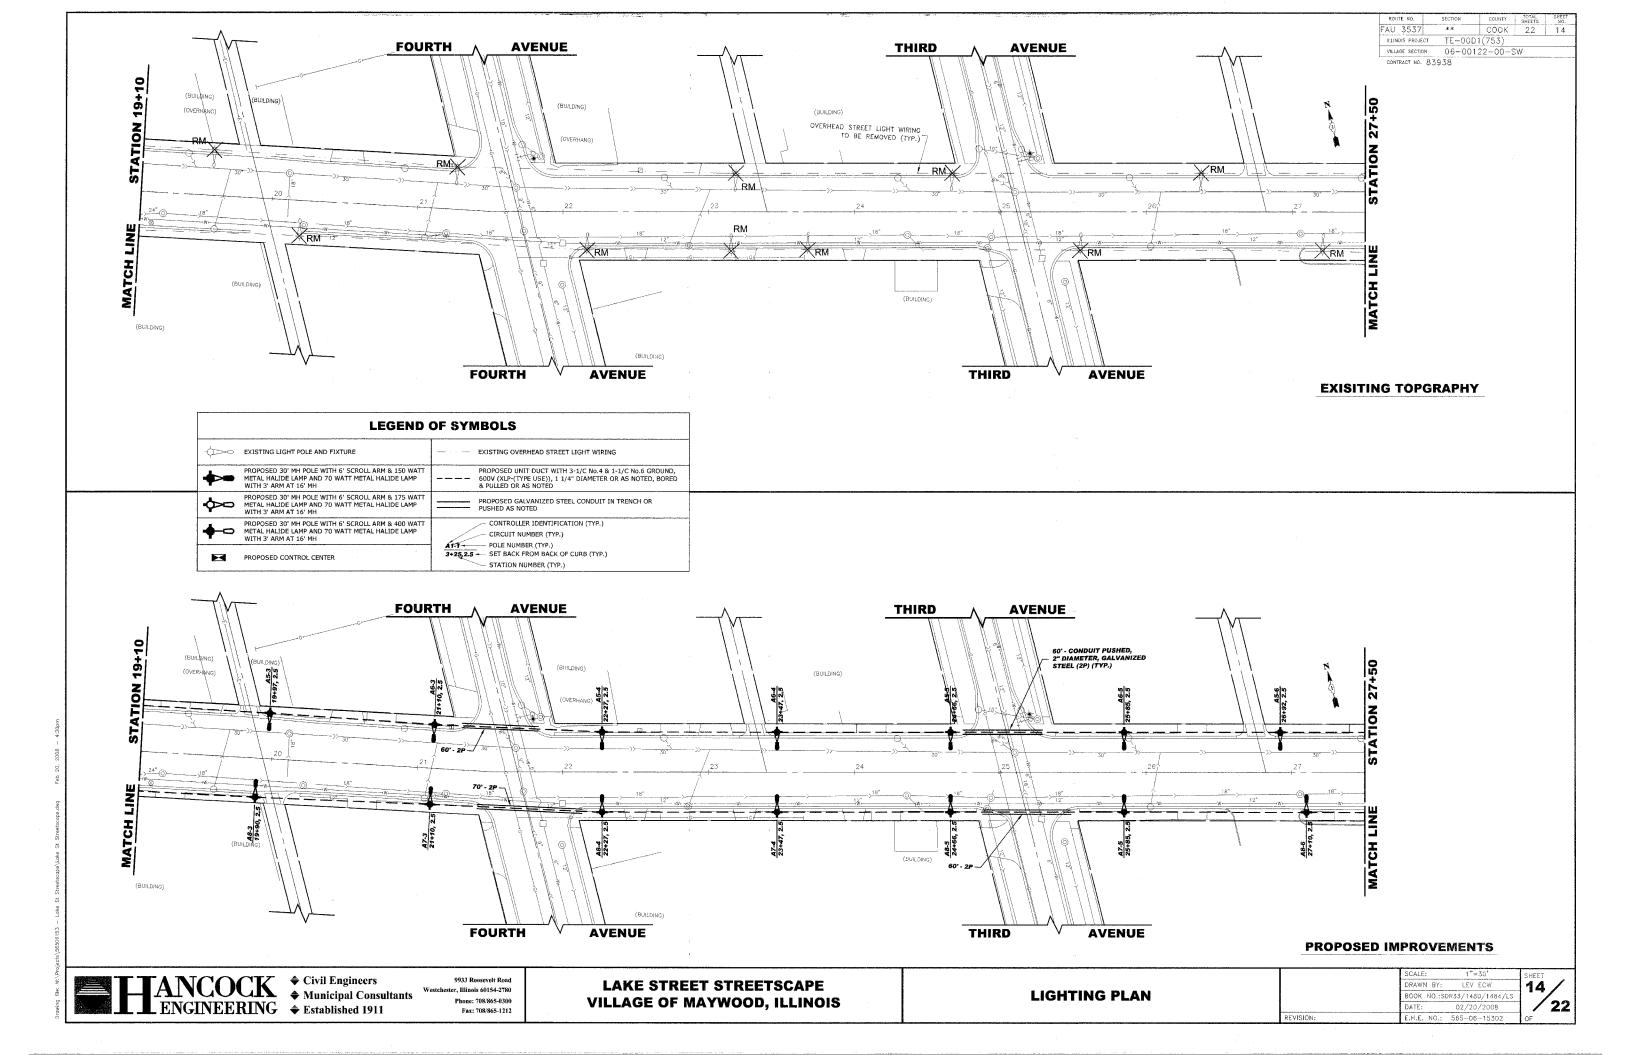

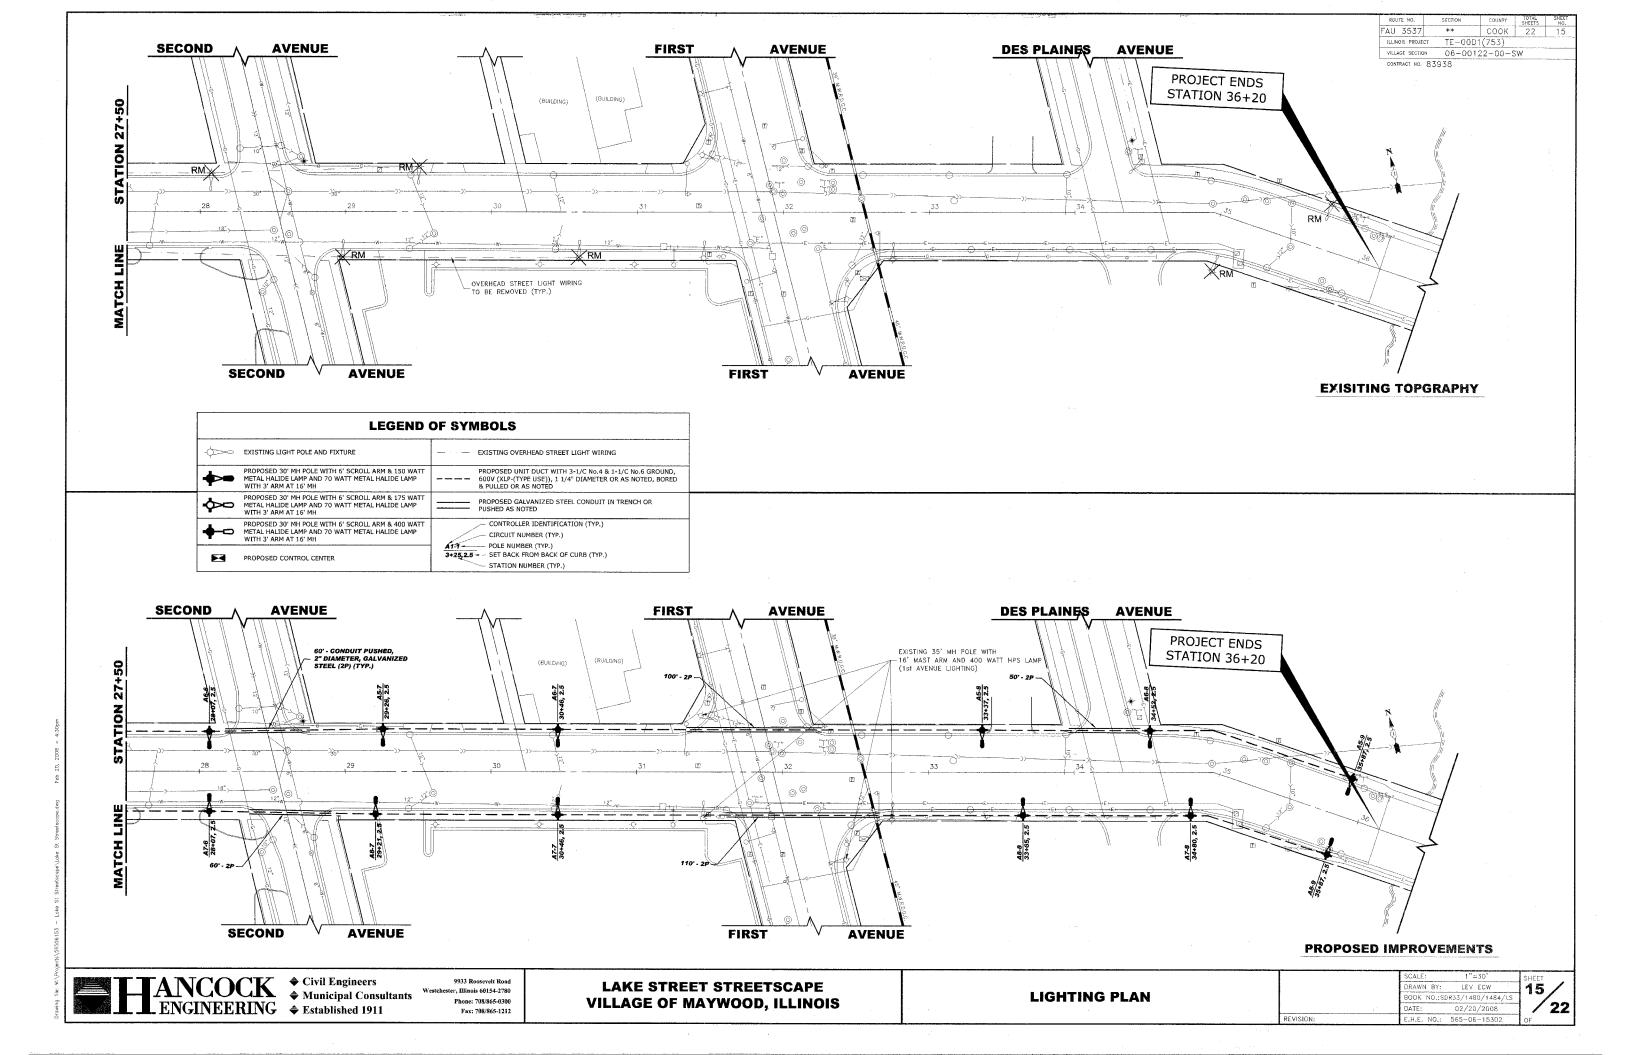

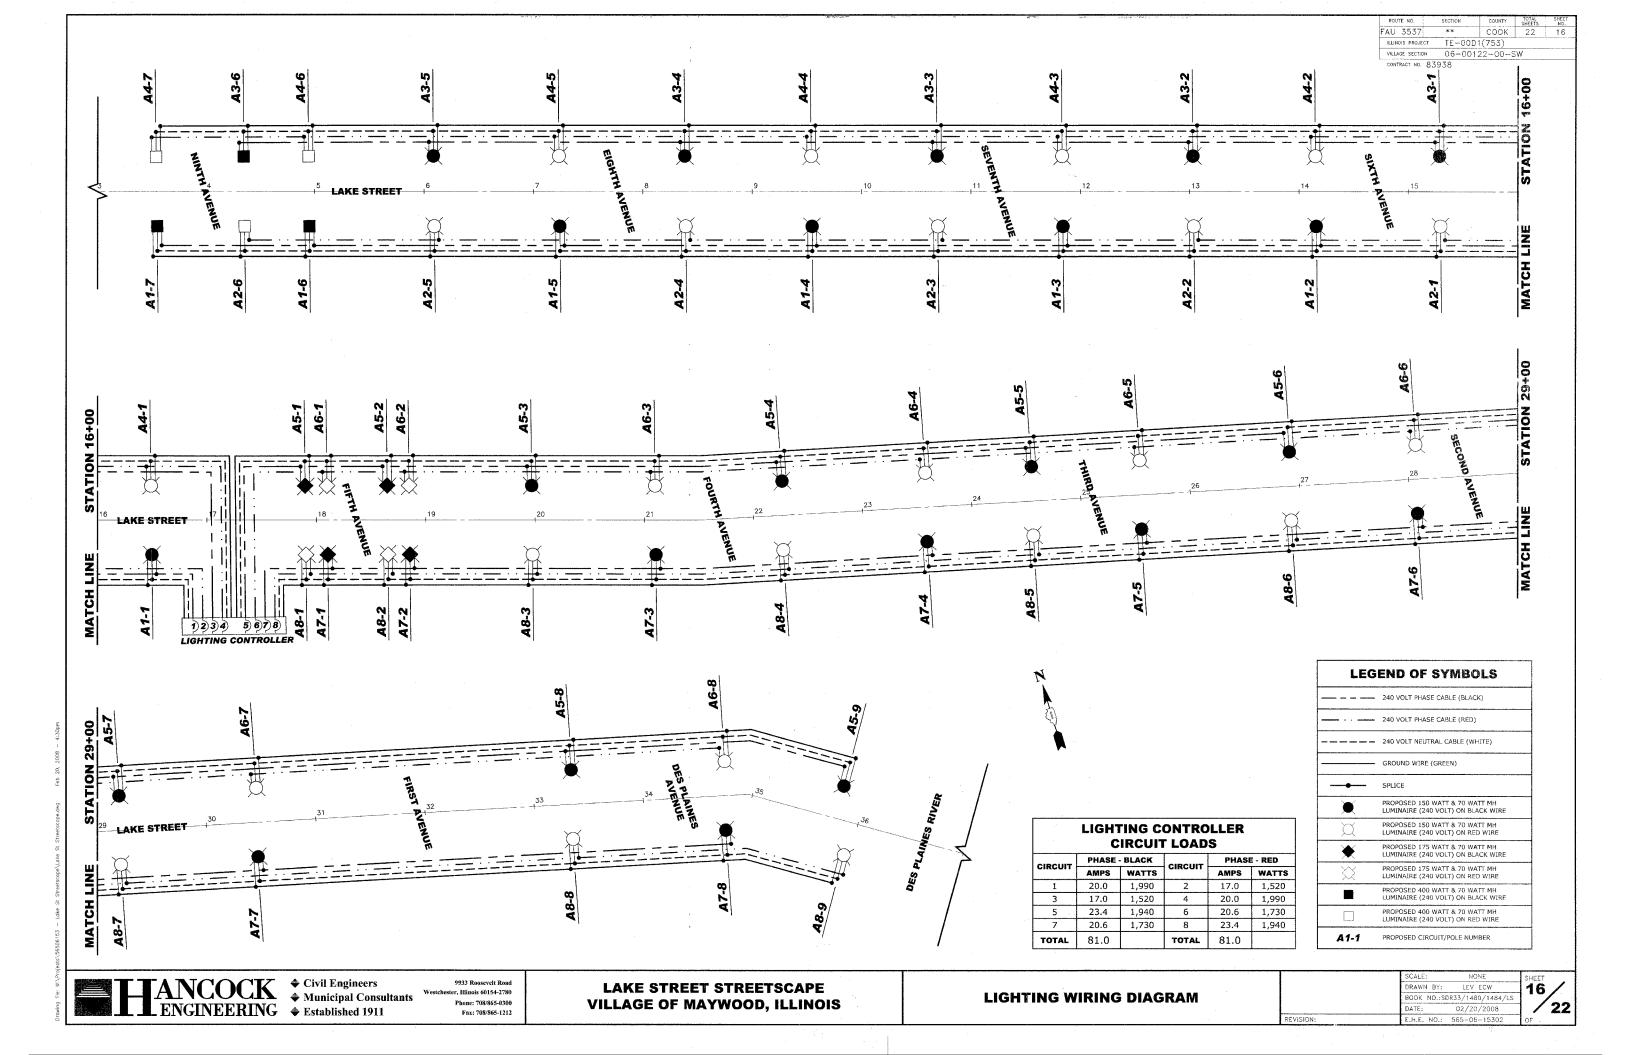

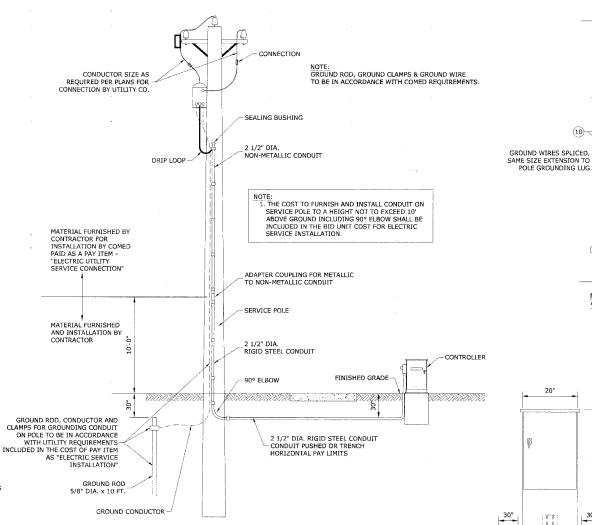

PROPOSED SERVICE INSTALLATION

POLE TOP MOUNTED TRANSFORMER

(4)-6 STAINLESS STEEL PIANO HINGE (5)-(12)-22" 22"

/-(8)-

1 METERING SIDE OF CABINET

**

VILLAGE SECTION 06-00122-00-SW

(1) STANDARD-TYPE SMALL DIMENSION DOUBLE POLE FUSEHOLDER WITH INSULATED BOOTS, FUSING AND SOLID NUETRAL (SEE SPECS)

 $\ensuremath{\%^{\text{H}}}$ - 16 Tapped hole be provided for Ground Lug

INSULATED GROUND WIRE, 600V TYPE RHW, SOLID COLOR GREN, SIZE AS SPECIFIED

NEUTRAL CONDUCTOR, 600V TYPE RHW, SOLID COLOR WHITE, SIZE AS SPECIFIED

PHASE CONDUCTORS, 600V TYPE RHW,

SOLID COLOR, SIZE AS SPECIFIED

2-1/C #10 AWG, 600V TYPE RHW, SOLID COLOR CODED CABLES

3" P.V.C. CONDUIT RACEWAYS

ILLINOIS PROJECT

CONTRACT NO. 83938

3 SPLICE AS SPECIFIED

6 UNIT DUCT

NOTE: ALLOW 30" LOOP OF CABLES TO INSURE SUFFICIENT SLACK FOR WITHDRAWAL OF THE CONNECTORS OUTSIDE OF THE POLE HANDHOLE.

POLE HANDHOLE WIRING DIAGRAM

TE-00D1(753)

COOK 22

(2) RINGLESS TYPE METER SOCKET, SUPPLIED BY OTHERS 3 CONTROL CENTER SIDE OF CABINET

4 "V"-HANDLE LATCH & SHOOT BOLTS

5 RUBBER GASKET BETWEEN DOOR & BOX FLANGE

FORMED DOOR

CONTROL CENTER BOX TO BE


1" CHAMFER

POURED IN PLACE CLASS SI CONCRETE


GROUND ROD CONNECTED TO GROUND WIRE WITH EXOTHERMIC WELD (14) P.C.C. SIDEWALK, 5 INCH

(15) VENTING TO BE ALONG ROOF LINE

CONTROL CENTER CABINET & FOUNDATION

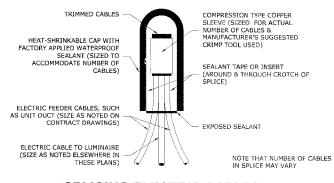

SPLICING ELECTRIC CABLES BASIC MATERIALS AND METHODS

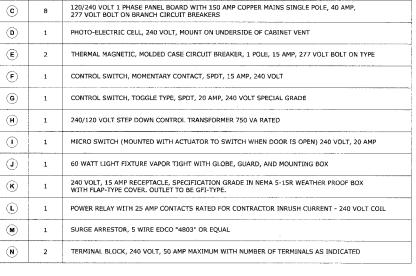

150 AMP CIRCUIT BREAKER, MOLDED CASE, THERMAL MAGNETIC, 2-POLE, SINGLE THROW,

150 AMP, ELECTRICALLY OPERATED AND MECHANICALLY HELD LIGHTING CONTRACTOR, 2-POLE, $600\,\text{VOLT}$ WITH 240 VOLT COIL

600V FRAME, NON-INTERCHANGABLE TRIP, BOLT ON TYPE.

240/480 VOLT CONTROLLER PANEL WIRING DIAGRAM

(A)

B

Fax: 708/865-1212

LAKE STREET STREETSCAPE **VILLAGE OF MAYWOOD, ILLINOIS**

ALL CIRCUIT BREAKERS SHALL HAVE AN INTERRUPT RATING OF 18,000 AMPS

POWER WIRE SHALL BE RATED RHH/RHW 600 VOLTS OF SIZE INDICATED


LIGHTING CONTROLLER SHALL BE SERVICE ENTRANCE RATED

UL LISTED DEVICES/COMPONENTS SHALL BE USED

DRAWN BY: LEV ECW 17 BOOK NO.:SDR33/1480/1484/

1.

LIGHTING DETAILS

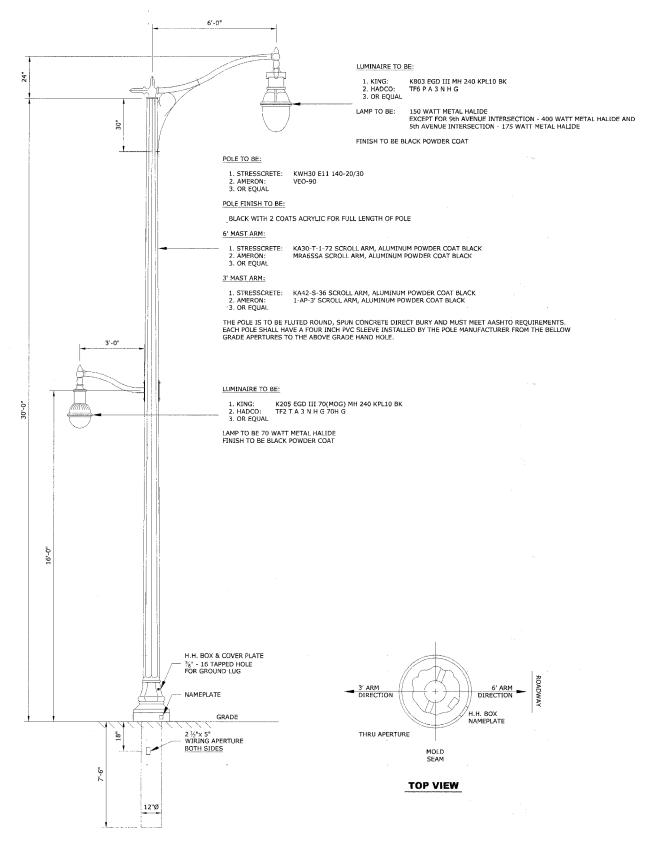

DECORATIVE LIGHT POLE, CONCRETE, 30' MOUNTING HEIGHT WITH 1 - 6' MAST ARM AND 1 - 3' MAST ARM

Westchester, Illinois 60154-2780 Phone: 708/865-0300


Fax: 708/865-1212

LAKE STREET STREETSCAPE **VILLAGE OF MAYWOOD, ILLINOIS**

LIGHTING DETAILS

DRAWN BY: LEV ECW BOOK NO.:SDR33/1480/1484/LS 02/20/2008 E.H.E. NO.: 565-06-15302

18

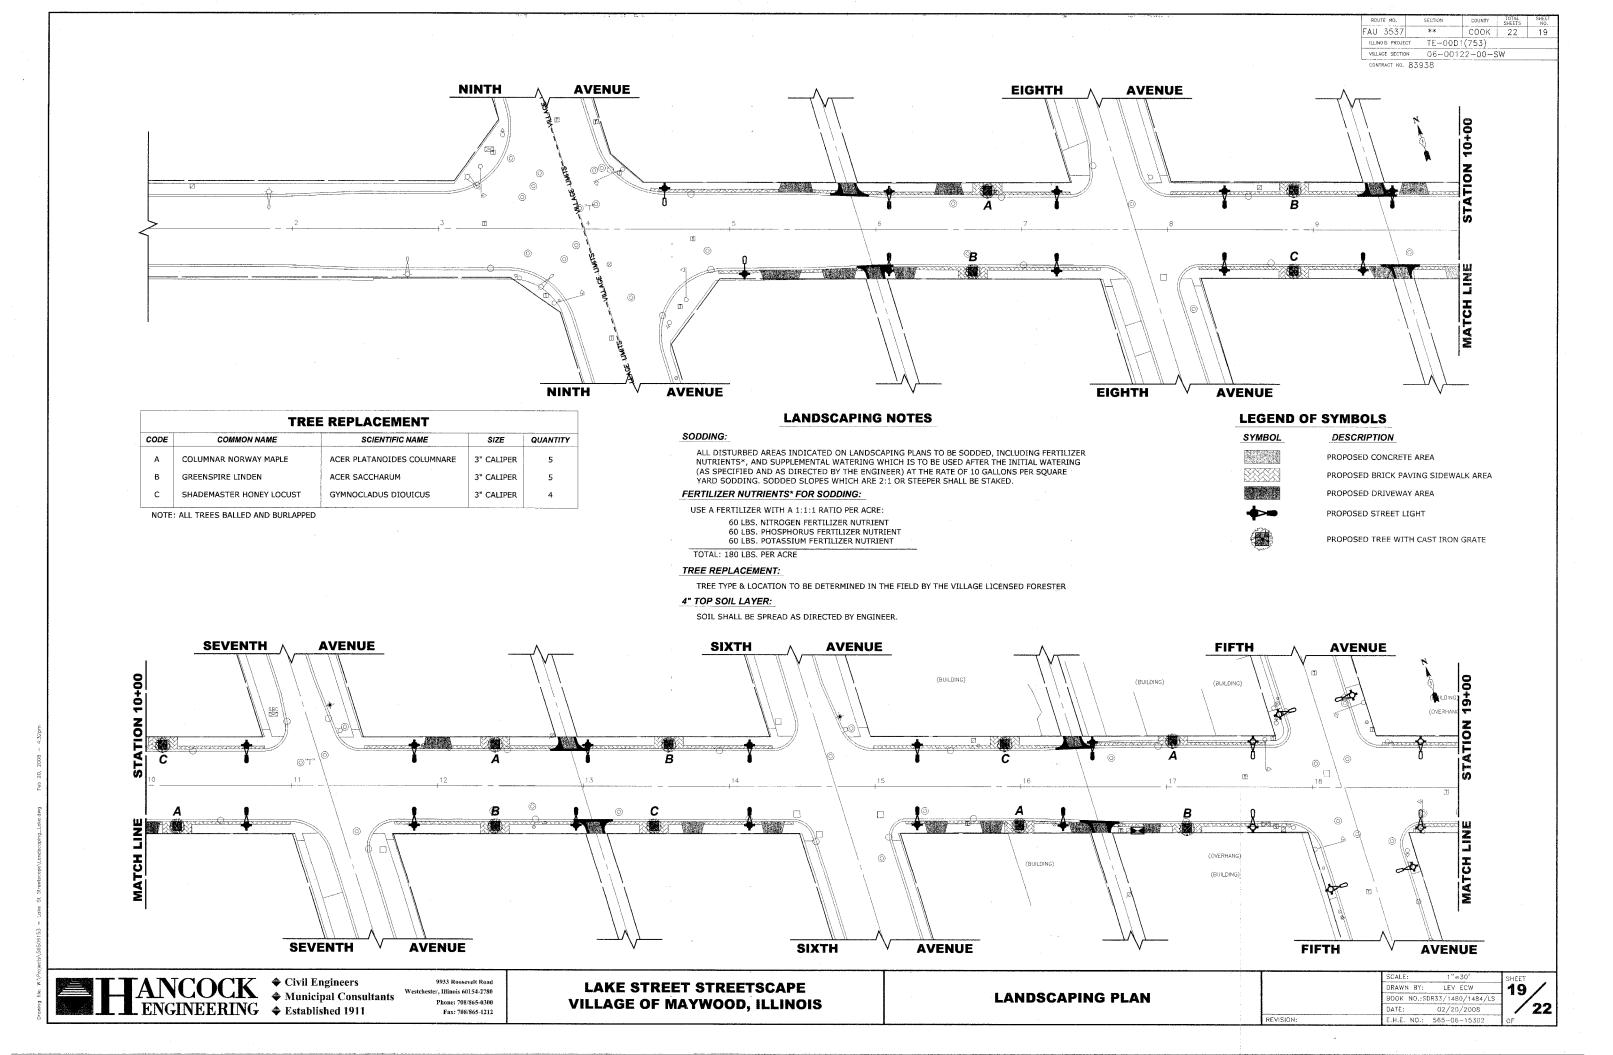

FAU 3537 ILLINOIS PROJECT TE-00D1(753) VILLAGE SECTION 06-00122-00-SW

CONTRACT NO. 83938

LEGEND OF SYMBOLS

DESCRIPTION

PROPOSED CONCRETE AREA


PROPOSED DRIVEWAY AREA

PROPOSED STREET LIGHT

PROPOSED BRICK PAVING SIDEWALK AREA

PROPOSED TREE WITH CAST IRON GRATE

SYMBOL

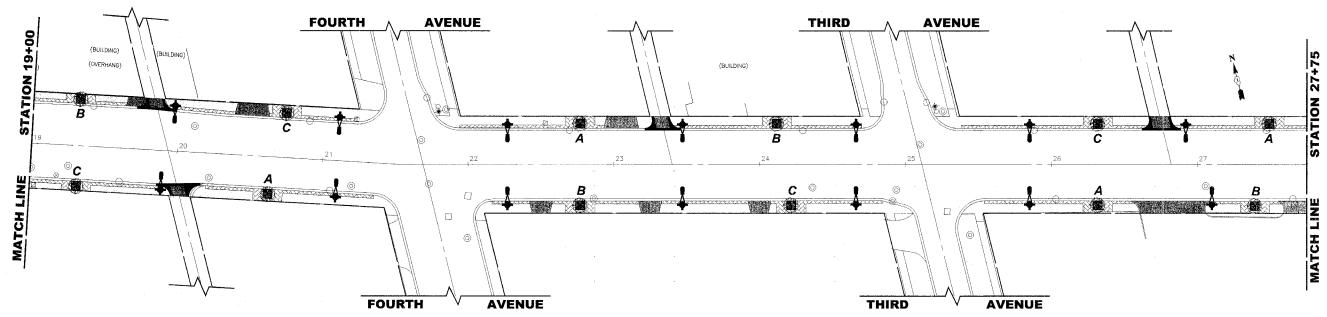

TREE REPLACEMENT							
CODE	COMMON NAME	SIZE	QUANTITY				
Α	COLUMNAR NORWAY MAPLE	ACER PLATANOIDES COLUMNARE	3" CALIPER	4			
В	GREENSPIRE LINDEN	ACER SACCHARUM	3" CALIPER	4			
С	SHADEMASTER HONEY LOCUST	GYMNOCLADUS DIOUICUS	3" CALIPER	4			

NOTE: ALL TREES BALLED AND BURLAPPED

LANDSCAPING NOTES

SODDING:

ALL DISTURBED AREAS INDICATED ON LANDSCAPING PLANS TO BE SODDED, INCLUDING FERTILIZER NUTRIENTS*, AND SUPPLEMENTAL WATERING WHICH IS TO BE USED AFTER THE INITIAL WATERING (AS SPECIFIED AND AS DIRECTED BY THE ENGINEER) AT THE RATE OF 10 GALLONS PER SQUARE YARD SODDING. SODDED SLOPES WHICH ARE 2:1 OR STEEPER SHALL BE STAKED.

FERTILIZER NUTRIENTS* FOR SODDING:

USE A FERTILIZER WITH A 1:1:1 RATIO PER ACRE:

60 LBS. NITROGEN FERTILIZER NUTRIENT 60 LBS. PHOSPHORUS FERTILIZER NUTRIENT 60 LBS. POTASSIUM FERTILIZER NUTRIENT


TOTAL: 180 LBS. PER ACRE

TREE REPLACEMENT:

TREE TYPE & LOCATION TO BE DETERMINED IN THE FIELD BY THE VILLAGE LICENSED FORESTER

4" TOP SOIL LAYER:

SOIL SHALL BE SPREAD AS DIRECTED BY ENGINEER.

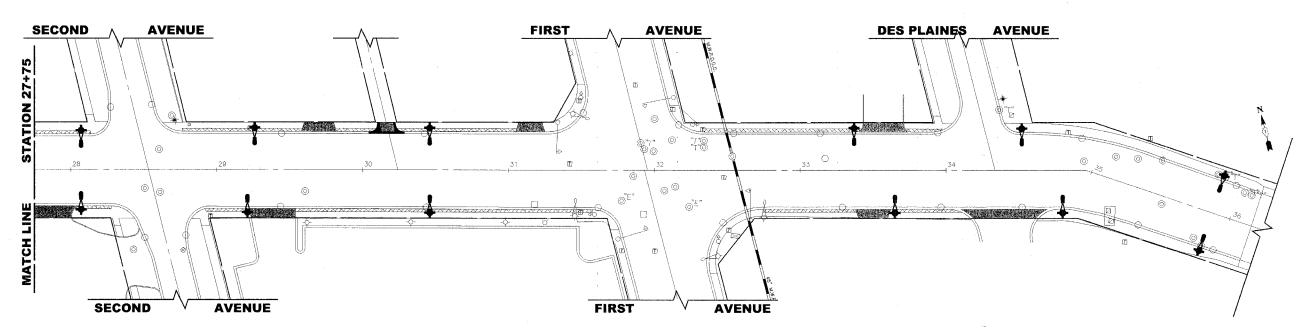

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♦ Municipal Consultants


Westchester, Illinois 60154-2780 Phone: 708/865-0300 Fax: 708/865-1212

LAKE STREET STREETSCAPE **VILLAGE OF MAYWOOD, ILLINOIS**

LANDSCAPING PLAN

	SCALE:	1"=30'	S
	DRAWN BY:	LEV ECW	14
	BOOK NO.:SDR33/1480/1484		S
	DATE:	02/20/2008	1
SION:	E.H.E. NO.:	565-06-15302	0



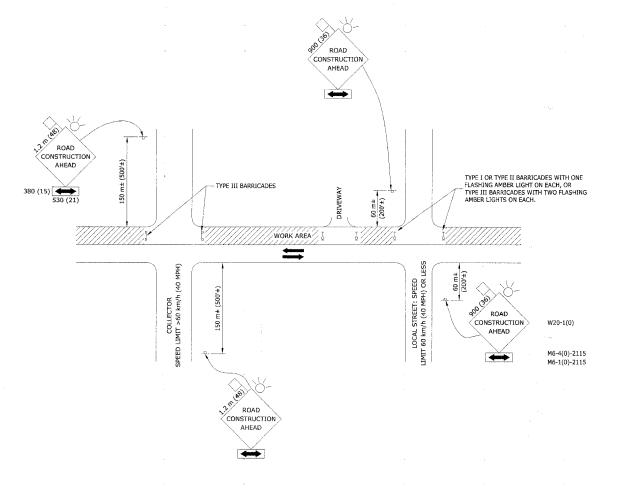

TRAFFIC CONTROL AND PROTECTION FOR SIDE ROADS, INTERSECTIONS, AND DRIVEWAYS

NOTES:

- A. FOR NO LANE RESTRICTION ON THE SIDE ROAD OR DRIVEWAYS
- 1. SIDE ROAD WITH A SPEED LIMIT OF 60 km/h (40 MPH) OR LESS AS SHOWN ON THE DRAWING AND AS DIRECTED BY THE ENGINEER:
 - A) ONE "ROAD CONSTRUCTION AHEAD" SIGN 900 X 900 (36 X 36) WITH A FLASHER AND FLAG MOUNTED ON IT APPROXIMATELY 60 m (200') IN ADVANCE OF THE MAIN ROUTE.
 - B) THE CLOSED PORTION OF THE MAIN ROUTE SHALL BE PROTECTED BY BLOCKING WITH TYPE I, TYPE II, OR TYPE III BARRICADES, 1/3 OF THE CROSS SECTION OF THE CLOSED PORTION.
- 2. SIDE ROAD WITH A SPEED LIMIT GREATER THAN 60 km/h (40 MPH) AS SHOWN ON THE DRAWING AND AS DIRECTED BY THE ENGINEER:
 - A) ONE "ROAD CONSTRUCTION AHEAD" SIGN 1.2m X 1.2m (48" BY 48") WITH A FLASHER AND FLAG MOUNTED ON IT APPROXIMATELY 150m (500 FT.) IN ADVANCE OF THE MAIN ROUTE.
 - B) THE CLOSED PORTION OF THE MAIN ROUTE SHALL BE PROTECTED BY BLOCKING WITH TYPE II BARRICADES, 1/2 OF THE CROSS SECTION OF THE CLOSED PORTION.
- 3. WHEN THE SIDE ROAD LIES BETWEEN THE BEGINNING OF THE MAINLINE SIGNING AND THE WORK ZONE, A SINGLE HEADED ARROW (M6-1) SHALL BE USED IN LIEU OF THE DOUBLE HEADED ARROW (M6-4).

- B. FOR LANE CLOSURE ON A SIDE ROAD OR DRIVEWAY:
- USE APPLICABLE PORTIONS OF THE TYPICAL APPLICATION OF TRAFFIC CONTROL DEVICES (STD. 701501, STD. 701606, OR THE APPROPRIATE STANDARD).
 THE SPACING OF SIGNS AND BARRICADES SHALL BE ADJUSTED FOR FIELD CONDITIONS AS DIRECTED BY THE ENGINEER. THE DIRECTIONAL ARROW SHALL BE COVERED OR REMOVED WHEN NO LONGER CONSISTENT WITH THE SIDE ROAD LANE CLOSURE.
- C. ADVANCE WARNING SIGNS ARE TO BE OMITTED ON DRIVEWAY UNLESS OTHERWISE NOTED.
- D. THE TRAFFIC CONTROL AND PROTECTION FOR SIDE ROADS, INTERSECTIONS, AND DRIVEWAYS SHALL BE INCLUDED IN THE COST OF SPECIFIC TRAFFIC CONTROL STANDARDS OR ITEMS.

ALL DIMENSIONS ARE IN MILLIMETERS (INCHES) UNLESS OTHERWISE SHOWN.

HANCOCK

Civil Engineers

♦ Municipal Consultants
 ♦ Established 1911


| J. OBERLE | J. OBERLE | A. HOUSER | T. RAMMACHER | T. RAMMACH

ACHER 09/08/94
RIE 10/18/95
SSER 03/06/96
ISER 10/15/96

TRAFFIC CONTROL AND PROTECTION FOR SIDE ROADS, INTERSECTIONS, AND DRIVEWAYS

CKED BY:

ROJECT NO. 565-06-15302

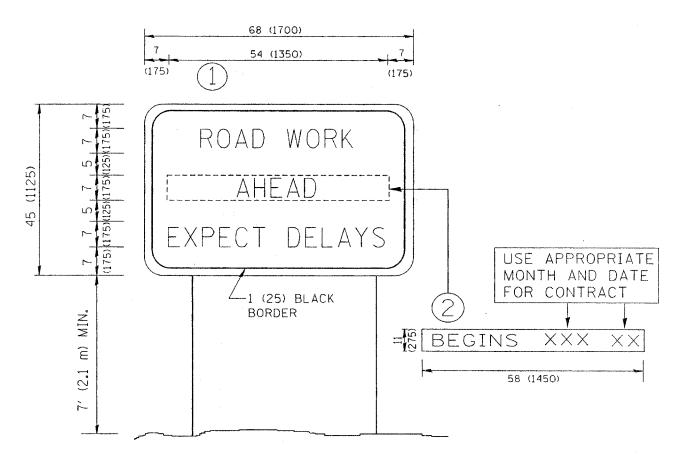

NOTES:

- 1. USE BLACK LETTERING ON ORANGE BACKGROUND.
- 2. ERECT SIGNS IN ADVANCE OF THE LOCATION FOR THE "ROAD CONSTRUCTION AHEAD" SIGN AT LOCATIONS AS DIRECTED BY THE ENGINEER.
- 3. ERECT SIGN (1) WITH INSTALLED PANEL (2) ONE WEEK PRIOR TO THE START OF CONSTRUCTION.
- 4. REMOVE PANEL 2) SOON AFTER THE START OF CONSTRUCTION.
- 5. SEE SPECIAL PROVISION FOR "TEMPORARY INFORMATION SIGNING" FOR ADDITIONAL INFORMATION.
- 6. ONE SIGN ASSEMBLY EQUALS 25.70 SQ. FT. (2.3 SQ. M.)
- 7. SHALL BE PAID FOR AS TEMPORARY INFORMATION SIGNING.

ALL DIMENSIONS IN INCHES (MILLIMETERS) UNLESS OTHERWISE SHOWN.

REVISIONS
NAME DATE
R. MIRS 9/15/97
R. MIRS 12/11/97
T. RAMMACHER 2/2/99
C. JUCIUS 1/31/07

O Civil Engineers
O Municipal Consultants
O Municipal Cons

E.H.E. PROJECT NO. 565-06-15302