

INDEX OF SHEETS

GENERAL NOTES

COVER

1

- 2 INDEX OF SHEETS, HIGHWAY STANDARDS, AND GENERAL NOTES
- 3 4 SUMMARY OF QUANTITIES
- TYPICAL SECTIONS AND HOT-MIX ASPHALT REQUIREMENTS 5
- 6 13 ROADWAY PLAN
- 14 BC-32 BUTT JOINT AND HMA TAPER DETAILS
- TC-10 TRAFFIC CONTROL AND PROTECTION FOR SIDE ROADS, 15 INTERSECTIONS, AND DRIVEWAYS
- 16 TC-13 DISTRICT ONE TYPICAL PAVEMENT MARKINGS
- 17 TC-22 ARTERIAL ROAD INFORMATION SIGN

- 1. ALL CONSTRUCTION SHALL BE DONE IN ACCORDANCE WITH THE DETAILS IN THE PLANS, THE SPECIAL PROVISIONS INCLUDED IN THE CONTRACT DOCUMENTS, AND THE FOLLOWING STATE OF ILLINOIS SPECIFICATIONS: "THE STANDARD SPECIFICATIONS FOR ROAD AND BRIDGE CONSTRUCTION" (REFERRED TO AS THE "STANDARD SPECIFICATIONS"), THE "SUPPLEMENTAL SPECIFICATIONS AND RECURRING SPECIAL PROVISIONS", THE "MANUAL ON UNIFORM TRAFFIC CONTROL DEVICES FOR STREETS AND HIGHWAYS", THE "MANUAL OF TEST PROCEDURES FOR MATERIALS" AND THE "STANDARD SPECIFICATIONS FOR WATER AND SEWER MAIN CONSTRUCTION IN ILLINOIS"
- 2. UTILITY LOCATIONS HAVE NOT BEEN SHOWN ON THESE PLANS. THE CONTRACTOR SHALL BE RESPONSIBLE FOR THE PROTECTION OF ALL UNDERGROUND OR SURFACE UTILITIES, INCLUDING SPRINKLER SYSTEMS, EVEN THOUGH THEY MAY NOT BE SHOWN ON THE PLANS
- 3. ACCESS TO PRIVATE DRIVEWAYS SHALL BE PROVIDED AT ALL TIMES EXCEPT DURING ACTUAL CONSTRUCTION ADJACENT THERE TO.
- 4. IT WILL BE THE CONTRACTOR'S RESPONSIBILITY TO NOTIFY THE ENGINEER, RESIDENTS AND THE VILLAGE WHEN ACCESS TO DRIVEWAYS WILL BE TEMPORARILY CLOSED DUE TO DRIVEWAY REPLACEMENT. THE CONTRACTOR SHALL DISTRIBUTE NOTICES PROVIDED BY THE VILLAGE TO RESIDENTS AT LEAST 24 HOURS PRIOR TO PLANNED CLOSURE. EVERY EFFORT SHALL BE MADE TO ACCOMMODATE ACCESS TO THESE PROPERTIES INCLUDING KNOCKING ON DOORS WHEN DRIVEWAYS ARE ABOUT TO BE CLOSED.
- THE DAYS PAVING OPERATION SHOULD RESULT IN A SINGLE TRANSVERSE JOINT. ANY COLD 5 LONGITUDINAL JOINTS WILL NOT BE ACCEPTED. PROVIDING A SINGLE TRANSVERSE JOINT SHALL BE ACCOMPLISHED BY PAVING ONE LANE OF SUFFICIENT LENGTH THAT WILL ALLOW FOR THE PAVING OF THE ADJACENT LANE IN THE SAME DAY.
- 6. CONTRACTOR SHALL TAKE PRECAUTION BY PRESERVING EXISTING TREES WITHIN THE RIGHT OF WAY. IF ANY DAMAGE OCCURS, TREES SHALL BE REPLACED IN KIND PER ARTICLE 201.07 REPAIR OR REPLACEMENT OF EXISTING PLANT MATERIAL REQUIREMENTS STATED HEREIN.
- 7. THE PROPOSED EDGE OF PAVEMENT AND CENTERLINE SHALL MATCH EXISTING.
- 8. THE CONTRACTOR SHALL PROTECT ALL EXISTING DECORATIVE CONCRETE AND BRICK PAVERS TO REMAIN. ANY DAMAGE TO DECORATIVE CONCRETE OR BRICK PAVERS SHALL BE REPAIRED.
- 9. ALL STREETS SHALL BE OPEN TO TWO-WAY TRAFFIC AT THE END OF EACH DAY.
- 10. BEFORE BEGINNING ANY WORK, THE CONTRACTOR SHALL RETAIN AND RECORD FOR FUTURE REFERENCE, ALL EXISTING PAVEMENT MARKING LINES IN ORDER THAT THESE LOCATIONS CAN BE RE-ESTABLISHED FOR STRIPING. EXACT LOCATIONS OF ALL PAVEMENT MARKINGS SHALL BE SHOWN ON THE PLANS, PER DISTRICT 1 DETAILS, OR AS DIRECTED BY THE RESIDENT ENGINEER

ILLINOIS - PROFESSIONAL DESIGN FIRM NO. - 184-001121 - EXPIRES 4/30/2026 3/3/2025 9:24:42 AM BAXT

	USER NAME = jmiller	DESIGNED - JDM	REVISED -		INDEX OF SHEETS, HIGHWAY STANDARDS, AND		SECTION	COUNTY TOTAL SHEET SHEETS NO.
	PLOT SCALE = 20.000 ' / in.	DRAWN - MVV CHECKED - JJF	REVISED - REVISED -	STATE OF ILLINOIS DEPARTMENT OF TRANSPORTATION	GENERAL NOTES	0017	24-00012-00-RS	MCHENRY 17 2 CONTRACT NO. 61L51
	PLOT DATE = 3/3/2025	DATE -	FILE - 2326014_ORD_SHT-GenNotes.dgn		SCALE: N.T.S. SHEET 1 OF 1 SHEETS STA. TO STA.	1	ILLINOIS FED. AI	ID PROJECT 06HH(261)

6.5

HIGHWAY STANDARDS

000001-08

442201-03

701006-05

701011-04

701301-04

701311-03

701501-06

701901-10

B.L.R. 24-2

STANDARD SYMBOLS, ABBREVIATIONS AND PATTERNS CLASS C AND D PATCHES OFF-RD OPERATIONS, 2L, 2W, 15' (4.5 m) TO 24" (600 mm) FROM PAVEMENT EDGE OFF-RD MOVING OPERATIONS, 2L, 2W, DAY ONLY LANE CLOSURE, 2L, 2W, SHORT TIME OPERATIONS LANE CLOSURE 2L, 2W MOVING OPERATIONS - DAY ONLY URBAN LANE CLOSURE, 2L, 2W, UNDIVIDED TRAFFIC CONTROL DEVICES MAILBOX TURNOUT FOR LOCAL ROADS

COMMITMENTS

NONE

				CONSTRUCT	ION CODE
				NISH ROAD VILLAGE OF PRAIRIE GROVE 80% FED 20% LOCAL	NISH ROAI NUNDA TOWNSHIF 80% FED 20% LOCA
CODE NO.	ITEM	UNIT	TOTAL QUANTITY	ROADWAY 0005 URBAN	ROADWAY 0005 URBAN
20201200	REMOVAL AND DISPOSAL OF UNSUITABLE MATERIAL	CU YĐ	202	158	44
21003000	GEOTECHNICAL FABRIC FOR GROUND STABILIZATION	SQ YD	605	473	132
21101615	TOPSOIL FURNISH AND PLACE, 4"	SQ YD	340	270	70
25000210	SEEDING, CLASS 2A	ACRE	0.25	0.125	0.125
25000400	NITROGEN FERTILIZER NUTRIENT	POUND	24	12	12
25000500	PHOSPHORUS FERTILIZER NUTRIENT	POUND	24	12	12
25000600	POTASSIUM FERTILIZER NUTRIENT	POUND	24	12	12
25100630	EROSION CONTROL BLANKET	SQ YD	340	270	70
25200200	SUPPLEMENTAL WATERING	UNIT	7	5	2
30300001	AGGREGATE SUBGRADE IMPROVEMENT	CU YD	202	158	44
40600290	BITUMINOUS MATERIALS (TACK COAT)	POUND	16,790	13,140	3,650
40600370	LONGITUDINAL JOINT SEALANT	FOOT	8,580	6,860	1,720
40600400	MIXTURE FOR CRACKS, JOINTS, AND FLANGEWAYS	TON	34	26	8
40600982	HOT-MIX ASPHALT SURFACE REMOVAL - BUTT JOINT	SQ YD	437	296	141
	POLYMERIZED HOT-MIX ASPHALT BINDER COURSE, IL-4.75, N50	TON	1,045	818	227

				NISH ROAD VILLAGE OF PRAIRIE GROVE 80% FED 20% LOCAL	NISH ROAE NUNDA TOWNSHIF 80% FED 20% LOCA	
CODE			TOTAL	ROADWAY	ROADWAY	
NO.	ITEM	TINU	QUANTITY	0005	0005	
40604060	HOT-MIX ASPHALT SURFACE COURSE, IL-9.5, MIX "D", N50	TON	2,089	URBAN 1,635	URBAN 454	
			· · · · · · · · · · · · · · · · · · ·			
42300200	PORTLAND CEMENT CONCRETE DRIVEWAY PAVEMENT, 6 INCH	SQ YD	70	70		
44000158	HOT-MIX ASPHALT SURFACE REMOVAL, 2 1/4"	SQ YD	24,860	19,460	5,400	
44000200	DRIVEWAY PAVEMENT REMOVAL	SQ YD	416	290	126	
44000200		3010	+10	290	120	
44201717	CLASS D PATCHES, TYPE II, 6 INCH	SQ YD	473	370	103	
44201721	CLASS D PATCHES, TYPE III, 6 INCH	SQ YD	672	526	146	
44201723	CLASS D PATCHES, TYPE IV, 6 INCH	SQ YD	1,269	993	276	
48102100	AGGREGATE WEDGE SHOULDER, TYPE B	TON	235	185	50	
66900200	NON-SPECIAL WASTE DISPOSAL	CU YD	38	30	8	
66900530	SOIL DISPOSAL ANALYSIS	EACH	2	1	1	
66901001	REGULATED SUBSTANCES PRE-CONSTRUCTION PLAN	L SUM	1	0.78	0.22	
65901003	REGULATED SUBSTANCES FINAL CONSTRUCTION REPORT		1	0.78	0.22	
00301005			-	0.74	0.22	
66901006	REGULATED SUBSTANCES MONITORING	CAL DA	20	16	4	
67100100	MOBILIZATION	L SUM	1	0.78	0.22	
70102620	TRAFFIC CONTROL AND PROTECTION, STANDARD 701501	L SUM	1	0.78	0.22	

USER NAME = jmiller DESIGNED - IDM REVISED + BAXTER STATE OF ILLINOIS DEPARTMENT OF TRANSPORTATION DRAWN - MVV REVISED -SUMMARY OF QUAN PLOT SCALE = 20.000 * / in CHECKED - JJF REVISED -PLOT DATE - 4/8/2025 DATE -FILE - 2326014_ORD_SHT-SOQ.dgn SCALE N.T.S. SHEET 1 OF 2 SHEETS ST

...NIDOT. PDF. NoLayers. BW.pltcfgNIots\Z3326014_Planset.tbl P:\PRAGV\Z326014_Planset.tbl

STATE OF ILLINOIS - PROFESSIONAL DESIGN FIRM LICENSE NO. - 184-001121 - EXPIRES 4/30/2026 Miniler - 4/8/2025 9:47:42 AM MODEL: PAPAGENE 2014 MEA IMPROVEMENTADIDE 01

NTITIES		F.A.U. RTE.	SECTION	COUNTY	TOTAL SHEETS	SHEET NO.					
		0017	24-00012-00-R5	McHENRY	17	3					
				CONTRACT	NO. 6	IL51					
TA.	TO STA.		ILLINOIS FED, AID PROJECT 06HH(261)								


				CONSTRUCT	ION CODE
				NISH ROAD VILLAGE OF PRAIRIE GROVE 80% FED 20% LOCAL	NISH ROA NUNDA TOWNSHI 80% FEE 20% LOCA
CODE NO.	ITEM	UNIT	TOTAL QUANTITY	ROADWAY 0005 URBAN	ROADWA 0005 URBAN
70300100	SHORT TERM PAVEMENT MARKING	FOOT	18,880	15,090	3,790
70300150	SHORT TERM PAVEMENT MARKING REMOVAL	SQ FT	6,300	5.030	1,270
78000200	THERMOPLASTIC PAVEMENT MARKING - LINE 4"	FOOT	36,800	27,600	9,200
78000650	THERMOPLASTIC PAVEMENT MARKING - LINE 24"	FOOT	15	15	
X4060280	HOT-MIX ASPHALT DRIVEWAY PAVEMENT, 3"	SQ YD	346	220	126
X7200061	TEMPORARY INFORMATION SIGNING	SQ FT	52	26	26
			- 		


N. 19	· · · · · · · · · · · · · · · · · · ·								
STATE OF ILL LICENSE NO, miller mother permi- file name: Par	BAXTER	USER NAME = jmiller	DESIGNED - JDM	REVISED -				F.A.U. SECTION	COUNTY TOTAL SHEET
			DRAWN - MVV	REVISED -	STATE OF ILLINOIS	SUMMARY OF QUANTITIES	-	0017 24-00012-00-RS	MCHENRY 17 4
		PLOT SCALE = 20,000 ' / in,	CHECKED - JIF	REVISED -	DEPARTMENT OF TRANSPORTATION				CONTRACT NO. 61L51
		PLOT DATE = 3/3/2025	DATE -	FILE - 2326014_ORD_SHT-SOQ.dgn		SCALE: N.T.S. SHEET 2 OF 2 SHEETS STA.	to sta.	ILLINQIS FED,	AID PROJECT 06HH(261)

STATE OF ILLINCIS - PROFESSIONAL DESIGN FIRM\IDOT_PDF_NoLayers_BW.pltcfg LLCENSE NO. - 184-001121 - EXPIRES 4730/2026\Priots\2326014 Planset.tbl miller 3/3/2025 9:25:00 AM P:\PPAGV\2326014-Nish Road Improvemen\CAD\06_ORD\Sheets-ORD\2226014_ORD_SHT-SOQ.dgn MORT: Prior File MME: Prior

fg\IDOT_PDF_NoLayers_BW.pltc ...\Plots\2326014_Planset.tbl P.\PRAGV\232601<u>4</u>-Nish Road

A N N N N N N N N N N N N N N N N N N N										
	USER NAME = jmiller	DESIGNED - JDM	REVISED -		TYPICAL SECTIONS AND HOT-MIX			F.A.U. BTE	SECTION	COUNTY TOTAL SHEET
		DRAWN - MVV	REVISED -	STATE OF ILLINOIS DEPARTMENT OF TRANSPORTATION					24-00012-00-RS	MCHENRY 17 5
	PLOT SCALE = 20.000 ' / in.	CHECKED - JJF	REVISED -			ASPHALT REQUIREMENTS				CONTRACT NO. 61L51
	PLOT DATE = 3/3/2025	DATE -	FILE - 2326014_ORD_SHT-TypSec.dgn		SCALE: N.T.S.	SHEET 1 OF 1 SHEETS STA.	TO STA.		ILLINOIS FED.	AID PROJECT 06HH(261)

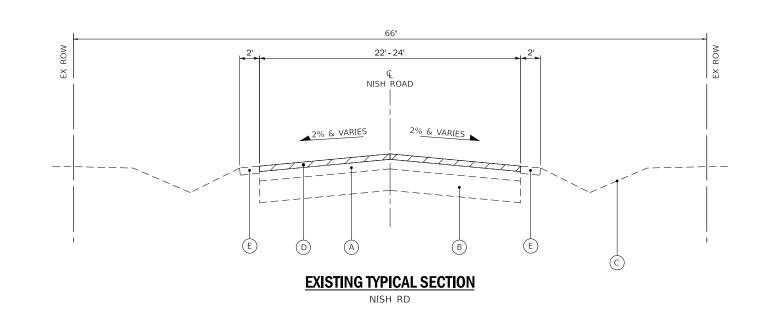

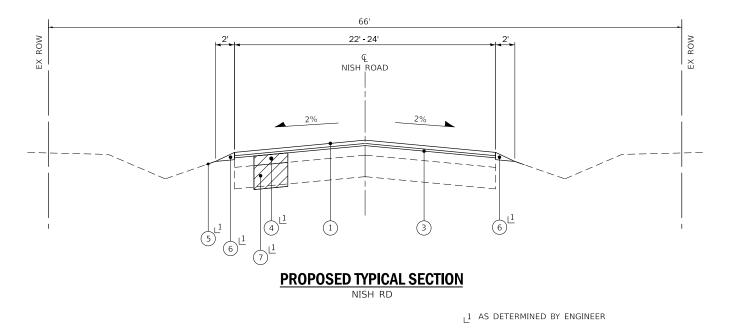

LONGITUE N50.	DINAL JOINT	SEALANT	SHA

CONTRACTOR SHALL MILL BEFORE PATCHING.

NOTE CONTRACTOR.

ANY AGGREGATE SUBGRADE IMPROVEMENT CONTAMINATED AND/OR DAMAGED BY THE CONTRACTOR'S VEHICLES AND/OR EQUIPMENT IS TO BE REMOVED AND REPLACED AS DIRECTED BY THE ENGINEER AT CONTRACTOR EXPENSE.

(A)EXISTING HMA BINDER & SURFACE COURSE, 6" - 11.5" **B** EXISITNG AGGREGATE BASE COURSE, 6.5" - 16.5" (C) GROUND SURFACE **D** HOT-MIX ASPHALT SURFACE REMOVAL, 2.25"

(E)

 \square

REMOVAL ITEM

(1)2 NOT USED

3 POLYMERIZED HOT-MIX ASPHALT BINDER COURSE, IL-4.75, N50 - 0.75"

(4) CLASS D PATCHES 6"

SEEDING, CLASS 2A TOPSOIL FURNISH AND PLACE, 4" 5

6

(7)

MIXTURE PAVEMENT RESURFACING

HOT-MIX ASPHALT SURFACE COURSE, IL-9.5, POLYMERIZED HOT-MIX ASPHALT BINDER CO HOT-MIX ASPHALT DRIVEWAY PAVEMENT, 3" HOT-MIX ASPHALT SURFACE COURSE, IL-9.5, PATCHING CLASS D PATCHES (HMA BINDER IL-19.0mm)

QMP designation: Quality Control/Quality Assura

NOTES:

2. THE "AC TYPE" FOR POLYMERIZED HMA MIXES SHALL BE "SBS/SBR PG 76 -22" AND FOR NON-POLYMERIZED HMA THE "AC TYPE" SHALL BE "PG 64 -22" UNLESS MODIFIED BY RECLAIMED MATERIALS SPECIFICATIONS.

ALL BE PLACED OVER THE POLYMERIZED HOT-MIX ASPHALT BINDER COURSE, IL-4.75,

NOTE: GEOTECHNICAL FABRIC FOR GROUND STABILIZATION AND/OR AGGREGATE SUBGRADE IMPROVEMENT (CU YD) HAVE BEEN PROVIDED FOR USE AT THE LOCATIONS INDICATED FOR SOILS THAT TEND TO BE UNSTABLE AND/OR UNSUITABLE. THE ACTUAL NEED FOR REMOVAL AND REPLACEMENT WITH ABOVE ITEM WILL BE DETERMINED IN THE FIELD AT THE TIME OF CONSTRUCTION BY THE GEOTECHNICAL ENGINEER. ALL POTENTIALLY UNSTABLE SOILS SHOULD BE TESTED WITH A STATIC OR DYNAMIC CONE PENETRONMETER AND TREATED IN ACCORDANCE WITH ARTICLE 301.04 OF THE STANDARD SPECIFICATIONS AND IDOT SUBGRADE STABILITY MANUAL. IF UNSTABLE AND/OR UNSUITABLE SOILS ARE NOT ENCOUNTERED, THEN THE QUANTITY SHALL BE DEDUCTED AND NO ADDITIONAL COMPENSATION WILL BE DUE TO THE CONTRACTOR

EXISTING LEGEND

EXISTING AGGREGATE SHOULDER

PROPOSED LEGEND

HOT-MIX ASPHALT SURFACE COURSE, MIX "D", IL-9.5, N50 - 1.5"


AGGREGATE WEDGE SHOULDER, TYPE B

AGGREGATE SUBGRADE IMPROVEMENT REMOVAL AND DISPOSAL OF UNSUITABLE MATERIAL

HOT-MIX ASPHALT MIXTURE REQUIREMENTS

E TYPE	AIR VOIDS @ Ndes	QMP
, MIX "D", N50; 1.5"	4% @ 50 Gyr.	LR 1030-2
DURSE, IL-4.75, N50: 0.75"	3.5% @ 50 Gyr.	LR 1030-2
1		
, MIX "D", N50: 3" (IN 2 LIFTS)	4% @ 50 Gyr.	LR 1030-2
); 6"	4% @ 70 Gyr.	LR 1030-2
ance (QC/QA) PER LR1030-2		


1. THE UNIT WEIGHT USED TO CALCULATE ALL HMA SURFACE MIXTURE QUANTITIES IS 112 LBS/SQ YD/IN.

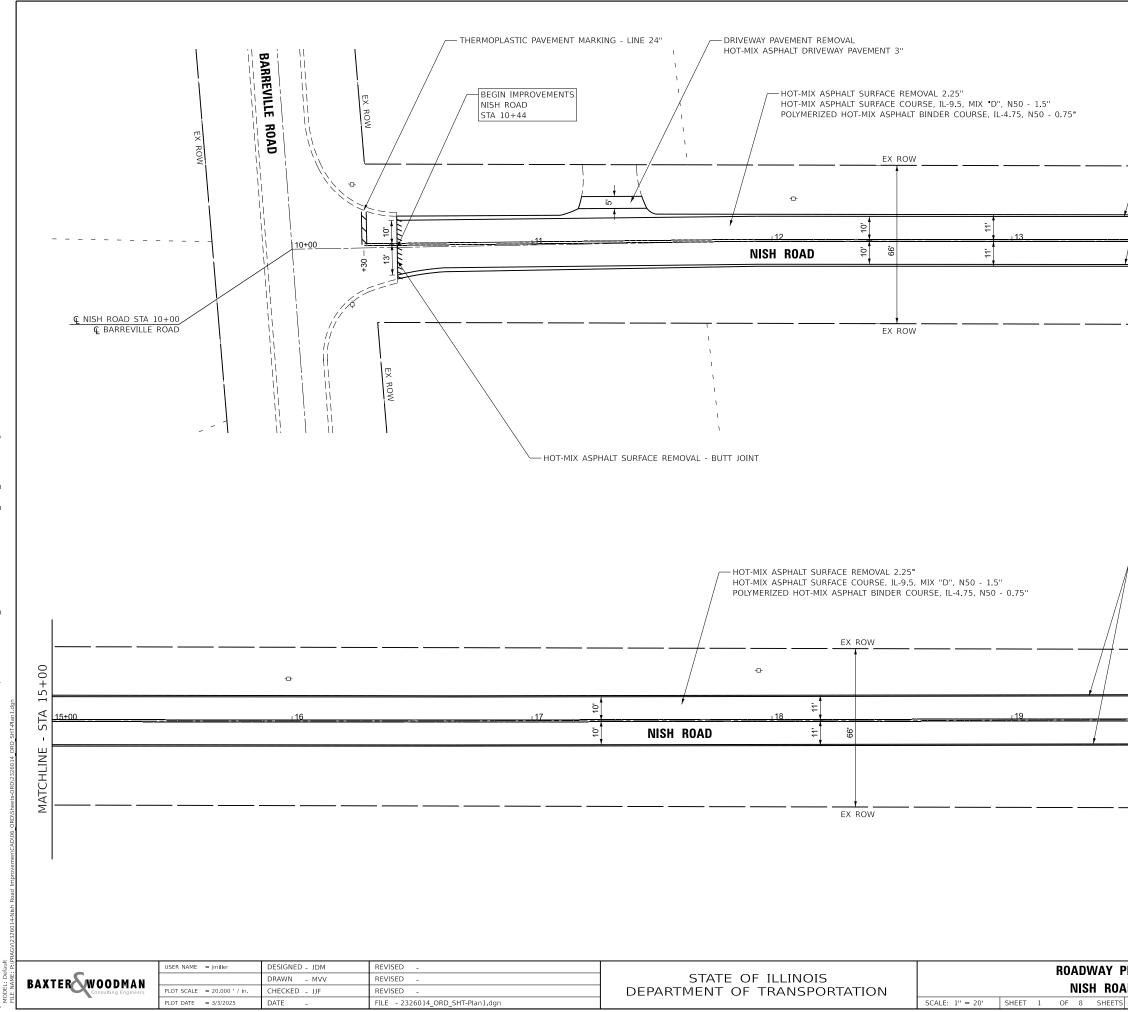

FIRM ...\IDOT_PDF_NoLayers_BW.pltcfg 2026 ...\Plots\72326014 Planset.tbl 3 AM P:\PRAGV\2326014-Nish Road Improvemen\CAD\06_ORD\5heets-ORD\2326014_ORD_SHT-Plan1.dgr


STATE OF ILLINOIS - PROFESSIONAL DESIGN FIRM LICENSE NO. - 184-001121 - EXPIRES 4/30/2026 jinilie: 3/3/2025 9:25:13 AM

THERMOPLASTIC PAVEM		NG -	Ĭ	
		VEMENT MARKING - ELLOW 11" C-C)		`
/				
-0-	<u> </u>			MATCHLINE - STA 15+00
			<u> </u>	STA
				ATCHL
·				— ⊻
			•1	
	RKING -		, k	
LINE 4" (WHITE EDGE LINE)			Ø	
THERMOPLASTIC PAVE				`
/				_ {
-0-				MATCHLINE - STA 21+00
20+00)			TA 2.1
				HLINE
				IATCH
				2
PLAN	F.A.U. RTE	SECTION	COUNTY	TOTAL SHEET SHEETS NO.
AD	0017	24-00012-00-RS	MCHENRY CONTRACT	17 6 NO. 61L51
S STA. 10+44 TO STA. 21+00		ILLINOIS FED.	AID PROJECT 06HH(2	(10

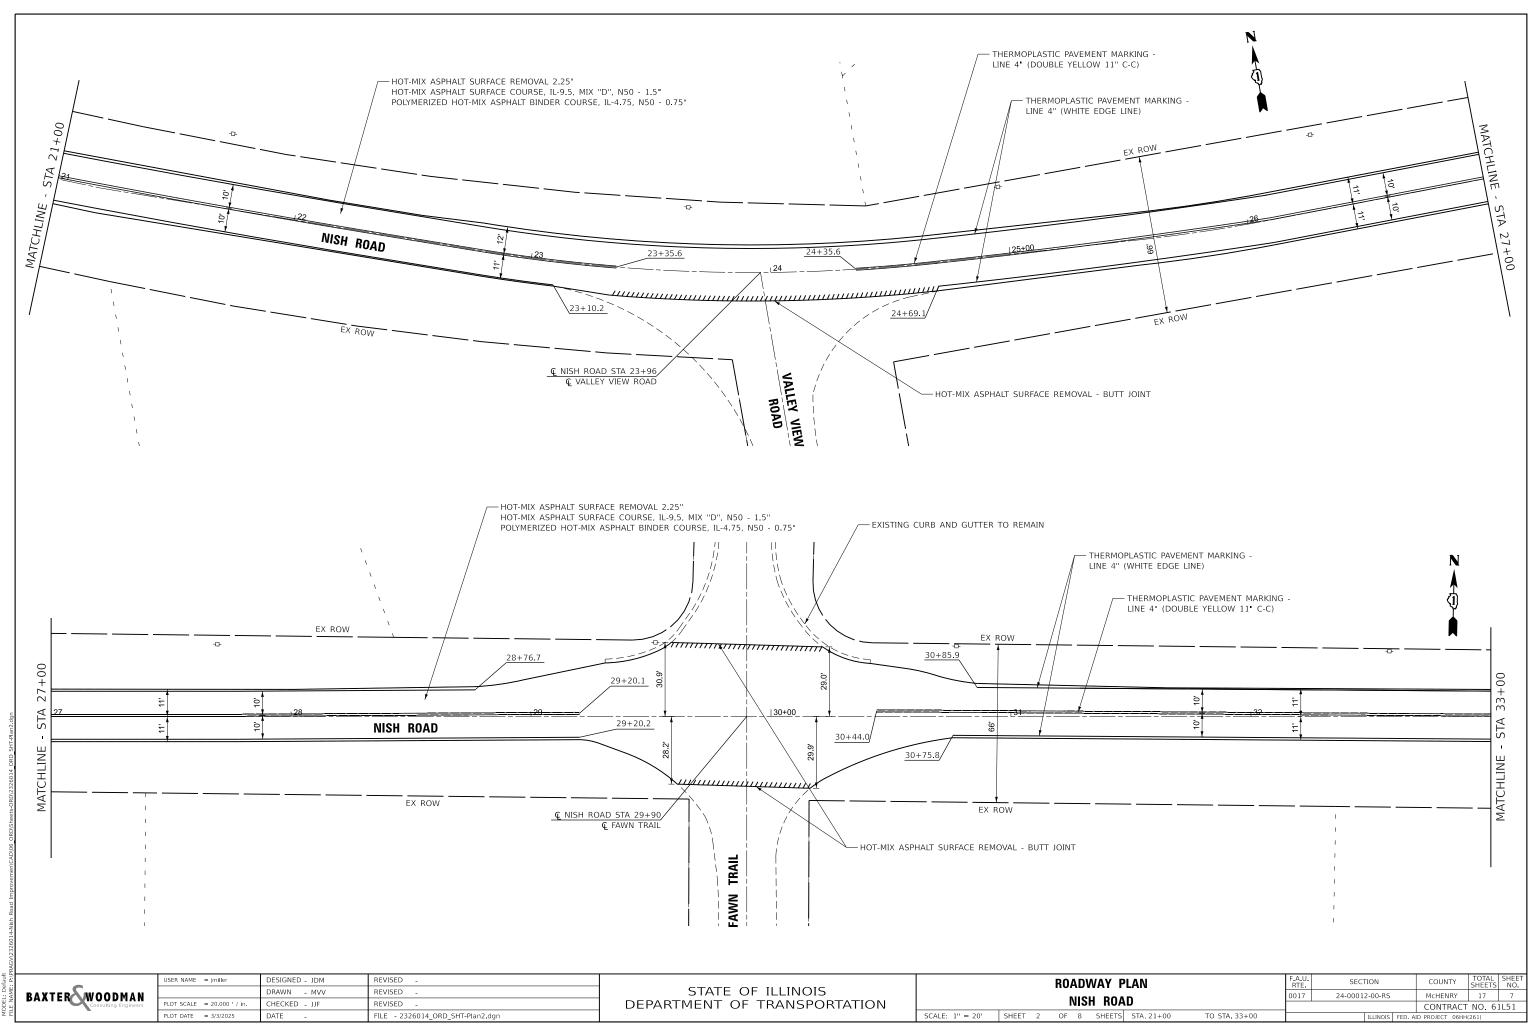


...VIDOT PDF NoLayers_BW.pltcfg
Notsi2326014 Planset.tbl
 P:\PRAGVi2326014-Nish Road Improvemen\CAD\06_ORD\Sheets-ORD\2326014_ORD_SHT-Pl

STATE OF ILLINOIS - PROFESSIONAL DESIGN FIRM LICENSE NO. - 184-001121 - EXPIRES 4/30/2026 minile 3/3/2025 9:25:16 AM I MODEL DEAME

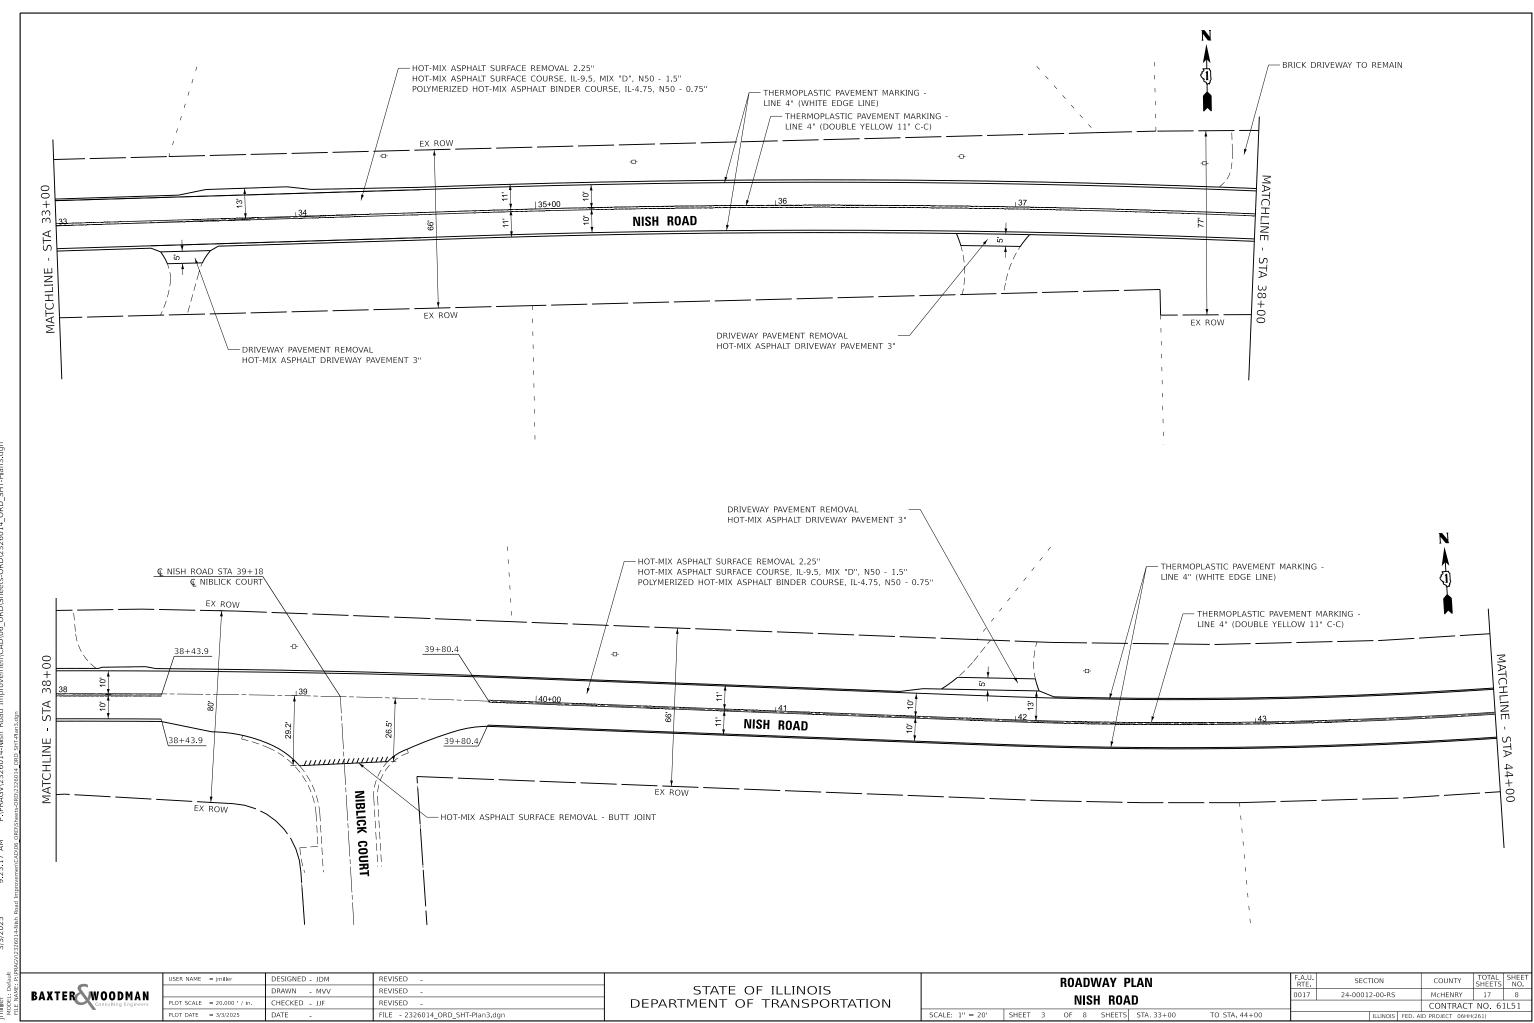


STATE OF ILLINOIS - PROFESSIONAL DESIGN FIRM LLCENSE NO. - 184-001121 - EXPIRES 4/30/2026 miller 3/3/2025

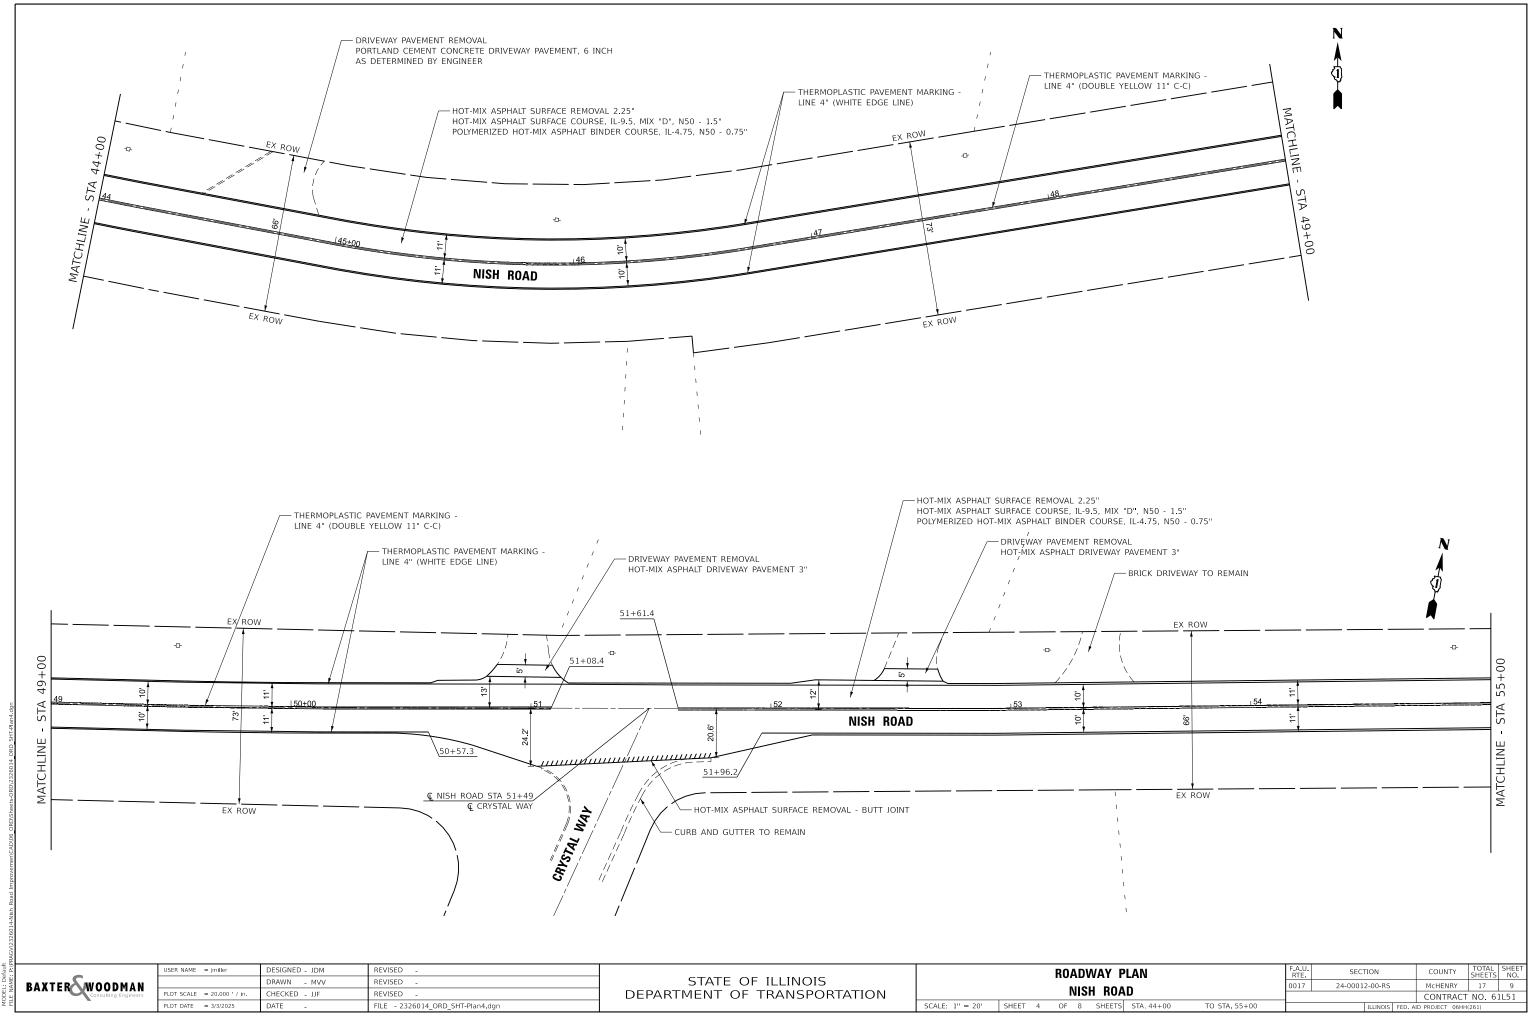


fg T_PDF_NoLayers_BW.pltcfg s\2326014_Planset.tbl GV\2326014-Nish Road In ...\IDOT ...\Plots\.

ILLINOIS - PROFESSIONAL DESIGN FIRM VO. - 184-001121 - EXPIRES 4/30/2026 3/3/2025 STATE OF LICENSE N

١Λ	AD			24-00012-00-	RS		McHENRY	17		9
Л							CONTRACT	NO.	61	L5 1
TS	STA.44+00	TO STA. 55+00		ILLIN	OIS FED	Al	D PROJECT 06HH	(261)		

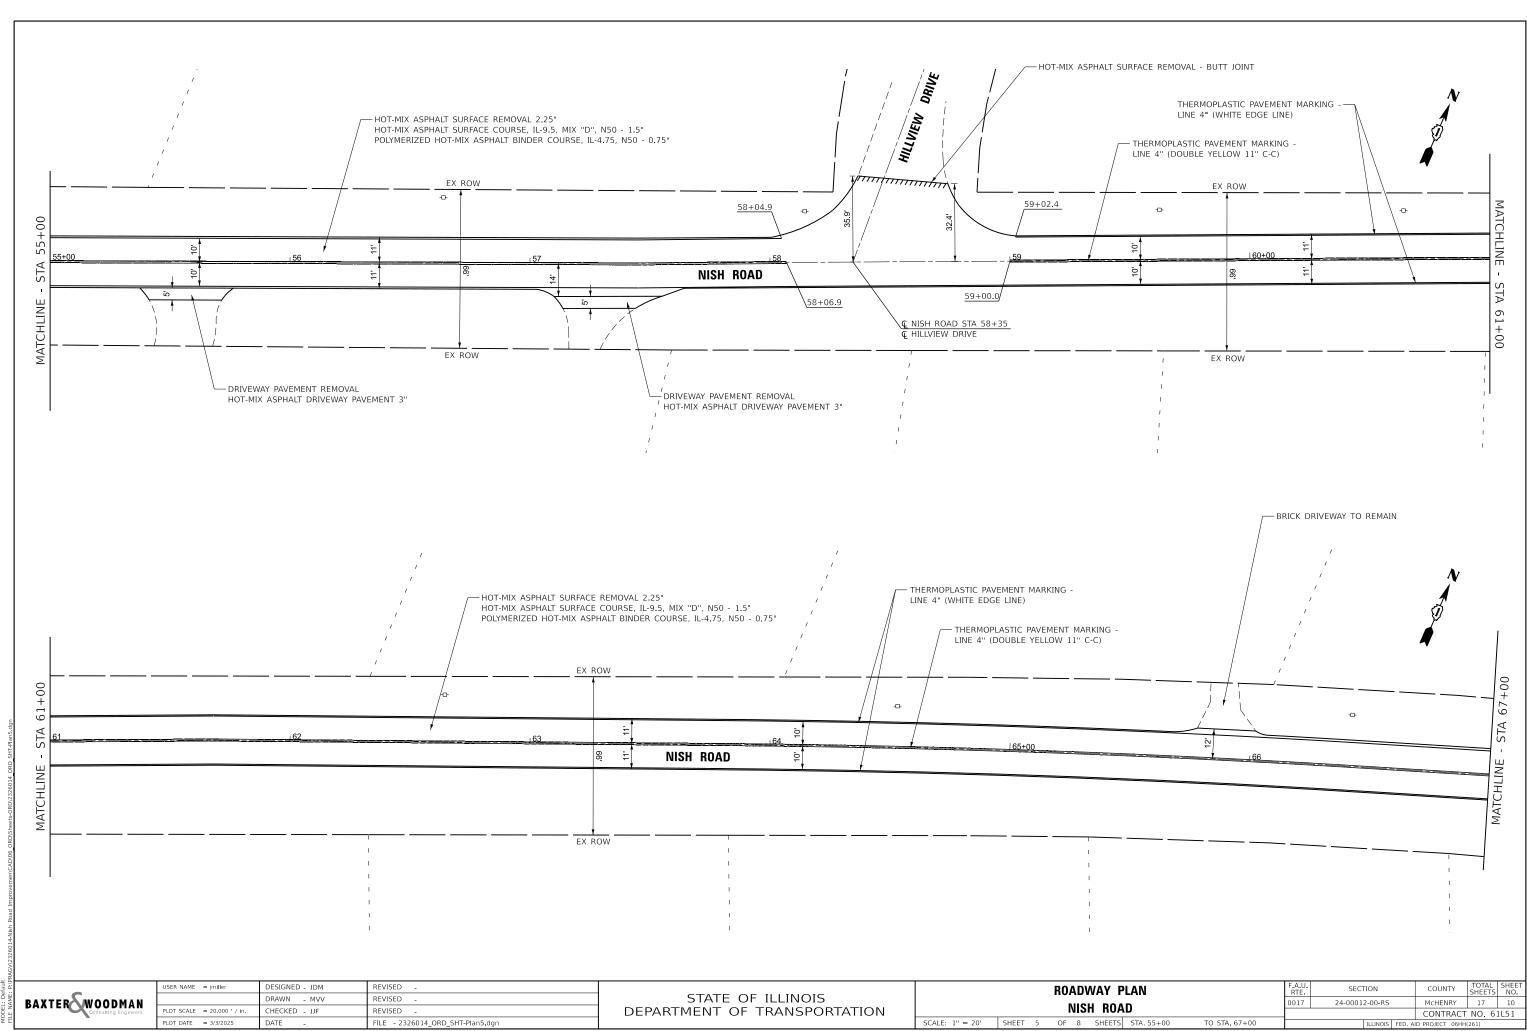


STATE OF ILLINOIS - PROFESSIONAL DESIGN FIRM LICENSE NO. - 184-001121 - EXPIRES 4/30/2026 imiller 3/3/2025

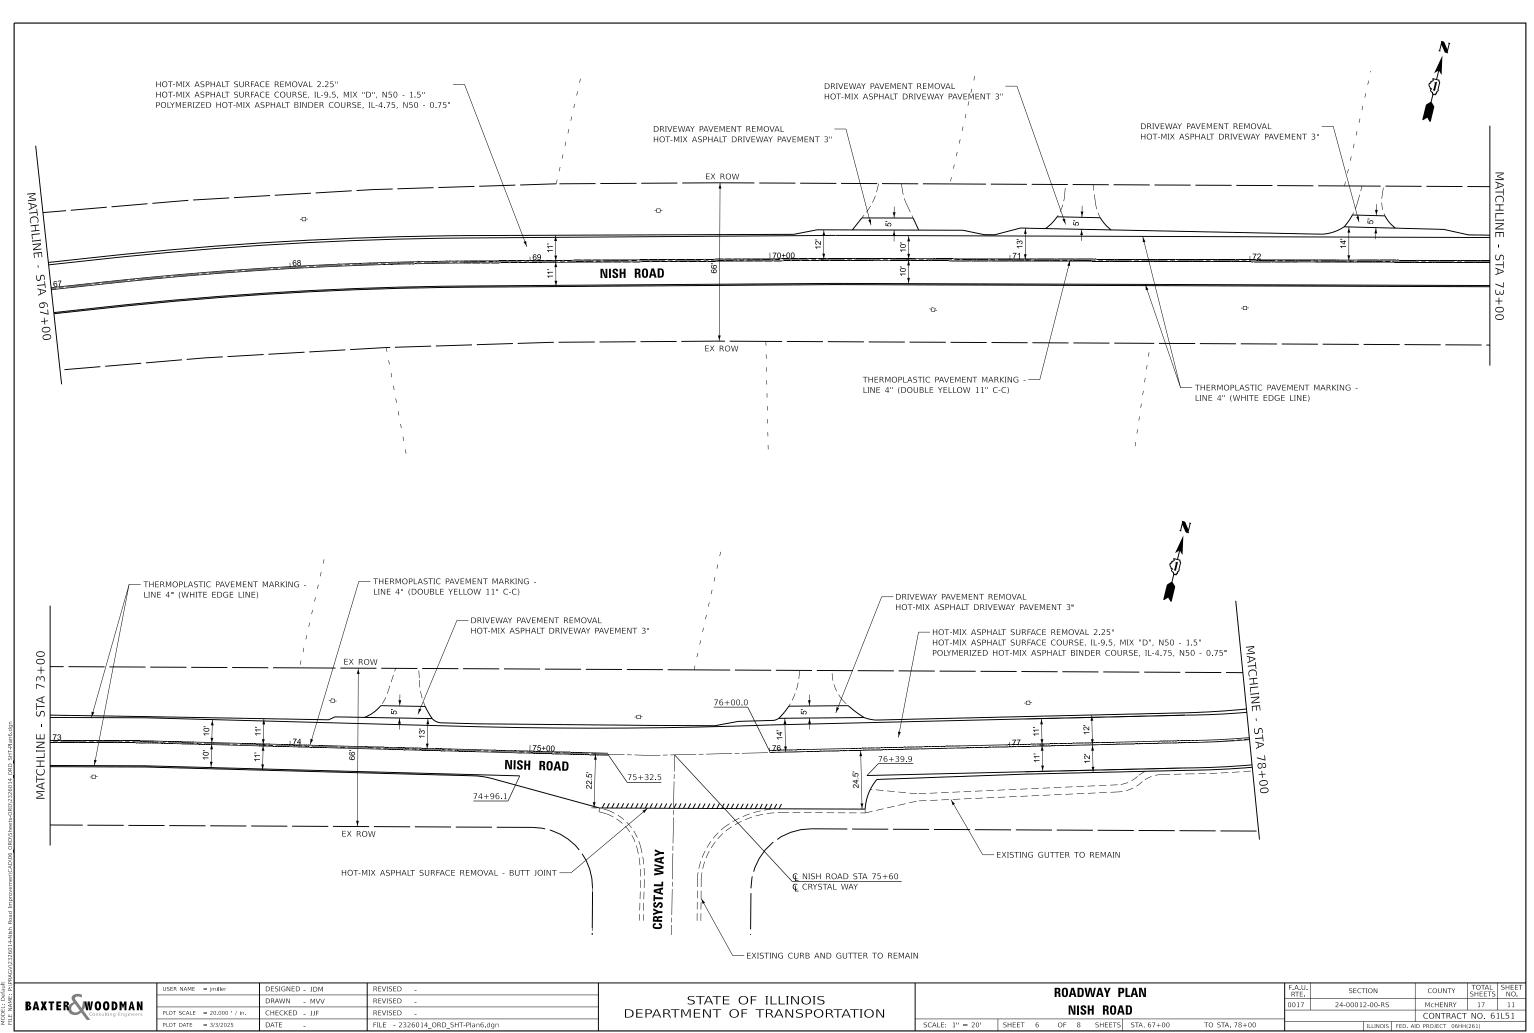

SN FIRM\IDOT_PDF_NoLayers_BW.pltcfg 0/2026\Plots\2326014_Planset.tbl 3:23 AM P:\PRaGV\2326014_Nish_Road Improvemen\CAD\06_ORD\Sheets-ORD\2326014_ORD_SHT-Pla

STATE OF ILLINOIS - PROFESSIONAL DESIGN FIRM LICENSE NO. - 184-001121 - EXPIRES 4/30/2026 jimiler 3/3/2025 9:25:23 AM

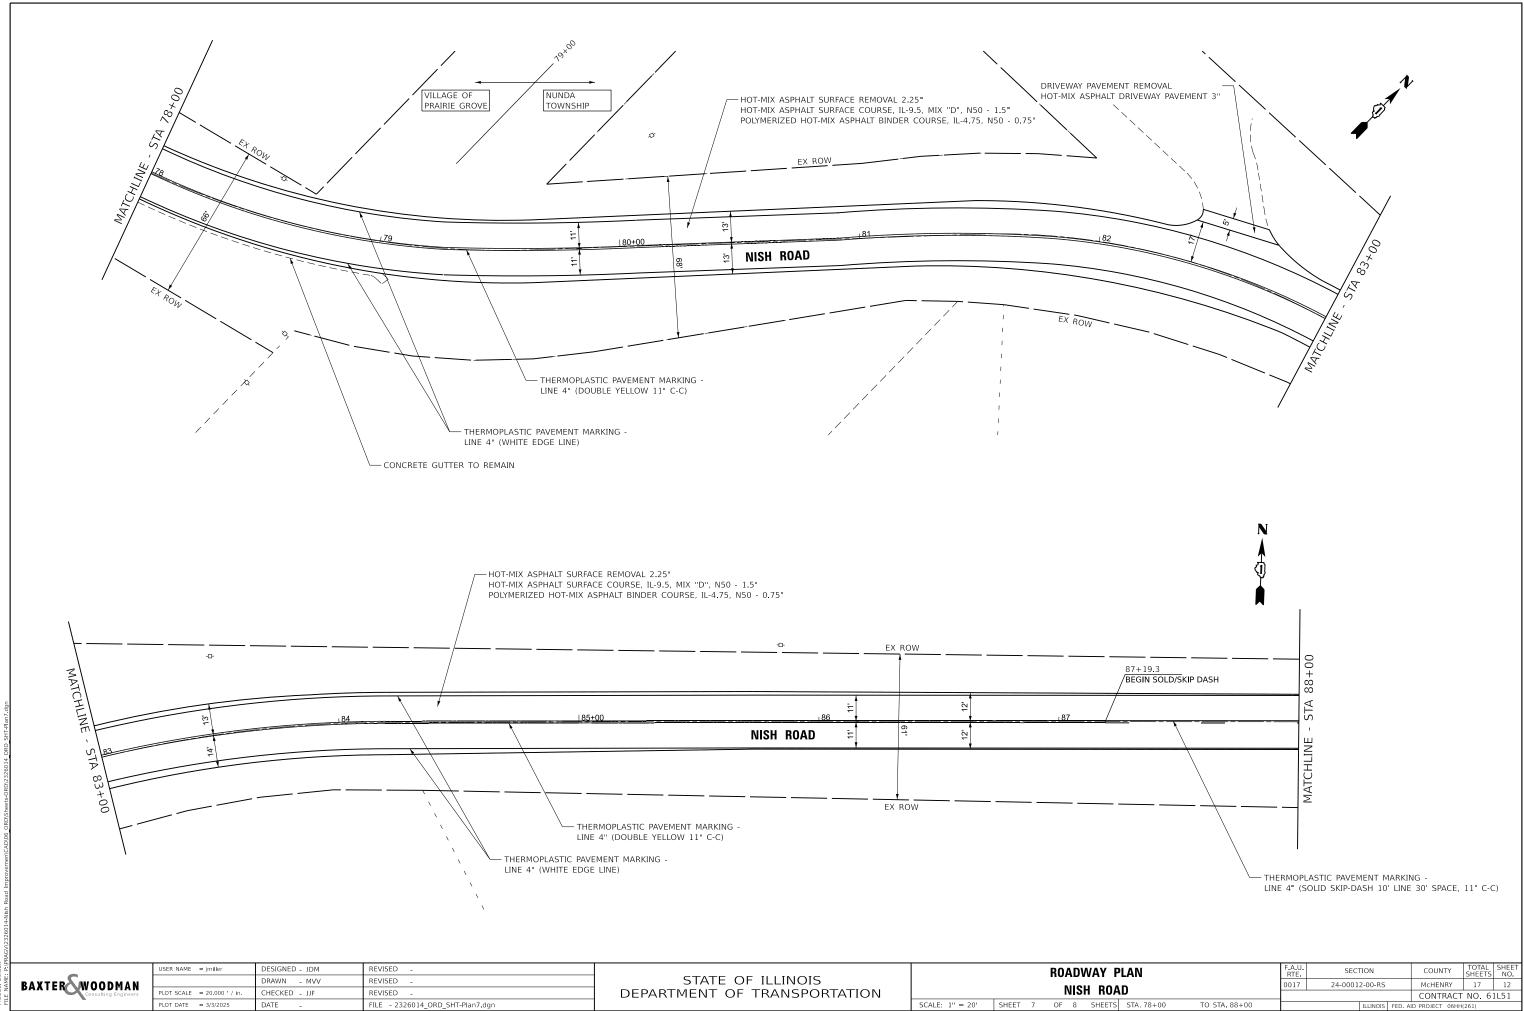


fg

...\IDOT_PDF_NoLayers_BW.pltc ...\Plots\2326014_Planset.tbl P:\PRAGV\2326014_Nish_Road

STATE OF ILLINOIS - PROFESSIONAL DESIGN FIRM LICENSE NO. - 184-001121 - EXPIRES 4/30/2026 imiller 3/3/2025 AM

AD		0017	24-0001	2-00-RS		McHENRY	17		12	
AU							CONTRACT	NO.	61L5	51
S	STA.78+00	TO STA.88+00			ILLINOIS	FED. A	D PROJECT 06HH(261)		_
										_

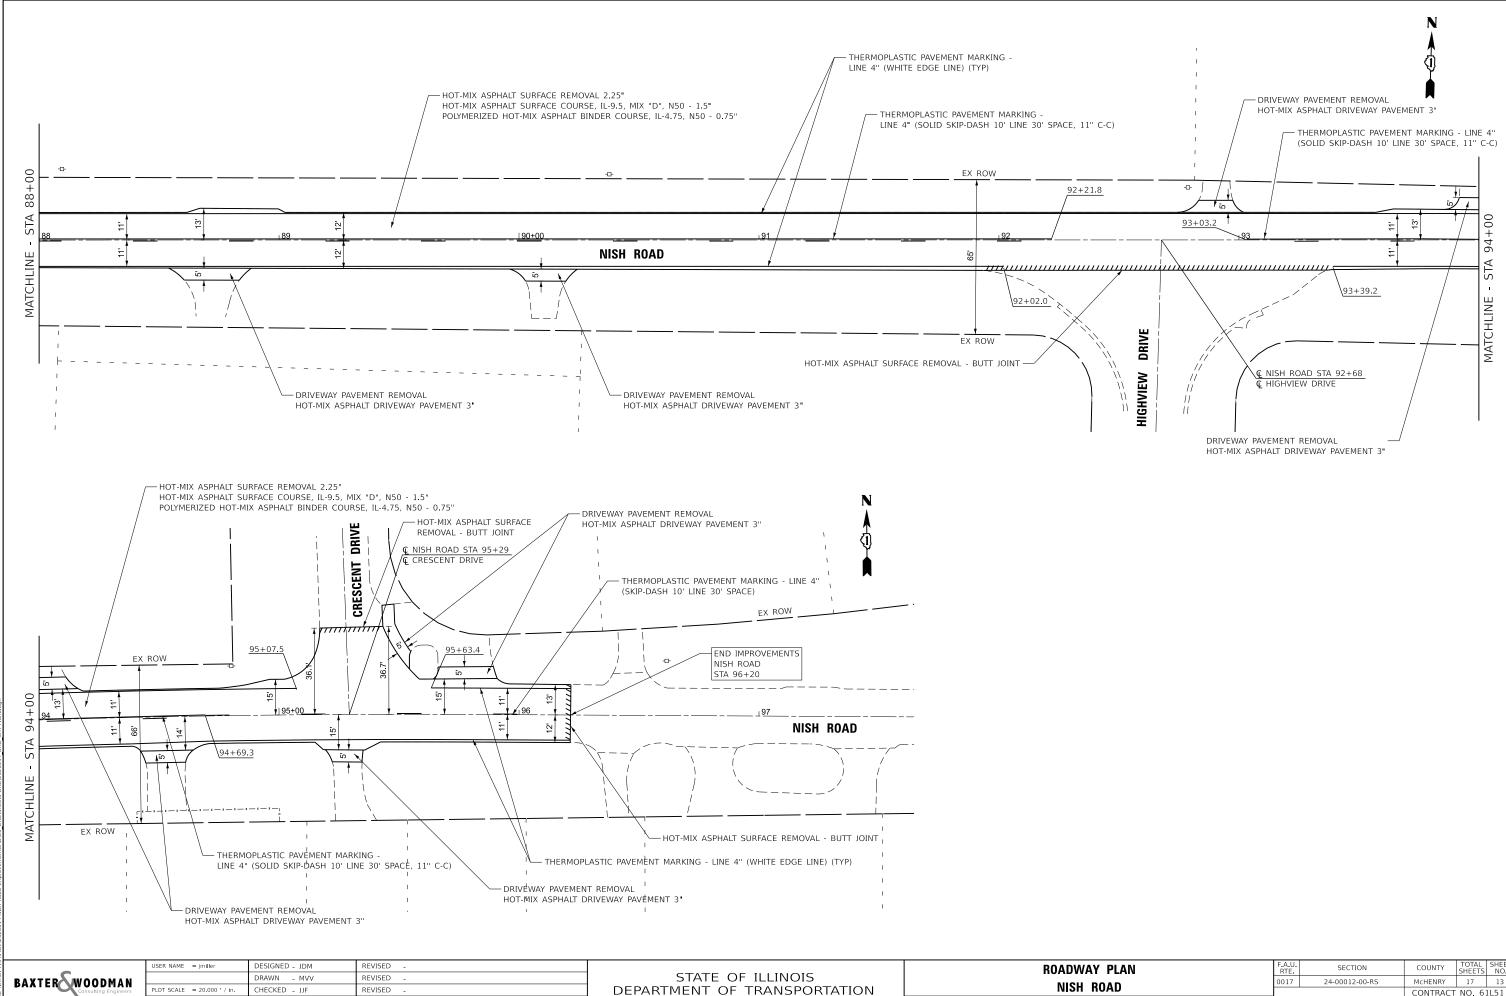


FILE - 2326014 ORD SHT-Plan8.don

LOT DATE = 3/3/2025

DATE

			RO/	ADV	VAY P	LAN		F.A.U. RTE	SECTION	COUNTY	TOTAL SHEETS	SHEET NO.
			P	VISH	I ROA	n		0017	24-00012-00-RS	McHENRY	17	13
			I	ліэг	I NUA	ע				CONTRACT	F NO. 6	1L51
SCALE: 1" = 20'	SCALE: 1" = 20' SHEET 8 OF 8 SHEETS STA. 88+00 TO STA. 96+20								ILLINOIS FED.	AID PROJECT 06HH	H(261)	

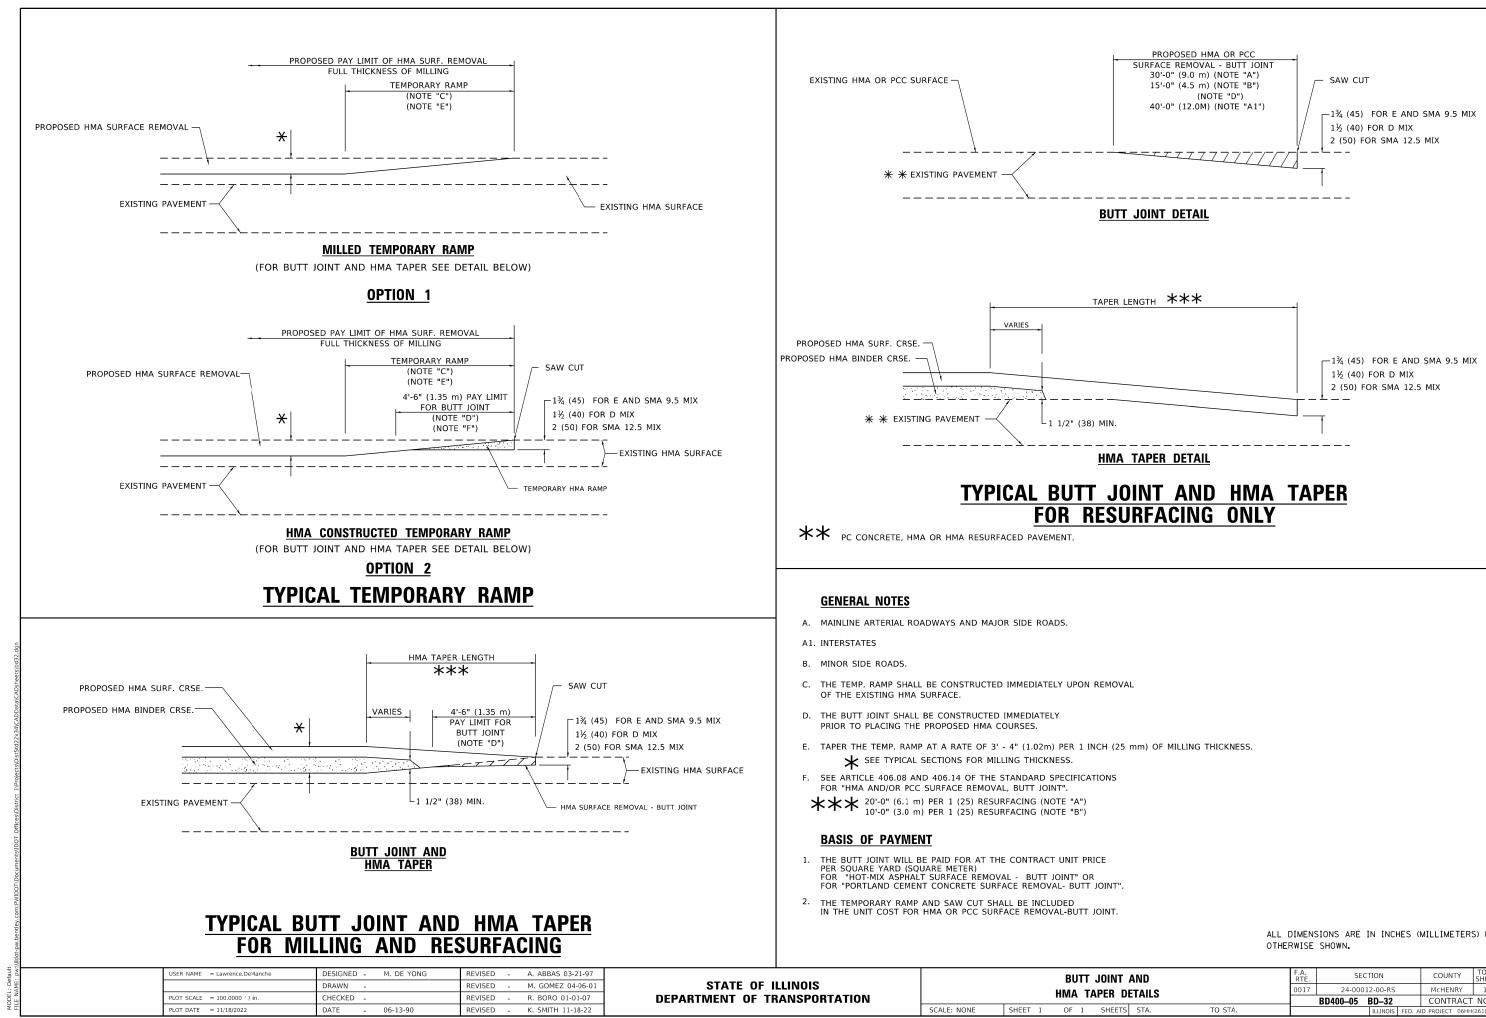


ALL DIMENSIONS ARE IN INCHES (MILLIMETERS) UNLESS

	F.A. RTE.			-	CHIEFT
T AND Details		SECTION	COUNTY	TOTAL SHEETS	SHEET NO.
		24-00012-00-RS	McHENRY	17	14
DETAILS		BD400–05 BD–32	CONTRACT	NO. 61	1L51
IS STA. TO STA.		ILLINOIS FED. A	D PROJECT 06HH	(261)	

		WI	PE III BARRICADES TH TWO FLASHING AI SHTS ON EACH. (SEE 200' WORK AREA J WORK AREA J
	NOTES:		
	1. SIDE ROAD WITH A SPEED L SHOWN ON THE DRAWING A		
		FION AHEAD" SIGN 36 x 36 (XIMATELY 200' (60 m) IN AD	
	BLOCKING WITH TYPE I,	DF THE MAIN ROUTE SHALL F TYPE II OR TYPE III BARRICA THE CLOSED PORTION.	
	2. SIDE ROAD WITH A SPEED L AS SHOWN ON THE DRAWIN		
		FION AHEAD" SIGN 48 x 48 (IT APPROXIMATELY 500' (15	
		DF THE MAIN ROUTE SHALL I I BARRICADES, 1/2 OF THE C DN.	
	 CONES MAY BE SUBSTITUTED SPACING DURING DAY OPER. IN HEIGHT. 		
	WHEN THE SIDE ROAD LIES 4. SIGNING AND THE WORK ZO BE USED IN LIEU OF THE DO	NE, A SINGLE HEADED ARRO	DW (M6-1) SHALL
STATE OF ILL	INOIS		CONTROL AND PI

USER NAME = Lawrence.DeManche	DESIGNED - L.H.A.	REVISED - T. RAMMACHER 01-06-00				TRAFFIC (ONTROL		OTECTION	FOR	F.A. BTE	SECTION	COUNTY	TOTAL SHEET SHEETS NO
	DRAWN -	REVISED - A. SCHUETZE 07-01-13	STATE OF IL	LLINOIS		TRAFFIC CONTROL AND PROTECTION FOR RTE. SECTION CONTROL SIDE ROADS, INTERSECTIONS, AND DRIVEWAYS 0017 24-00012-00-RS MCHENR TC-10 CONTROL		McHENRY	17 15					
PLOT SCALE = 100.0000 ' / in.	CHECKED -	REVISED - A. SCHUETZE 09-15-16	DEPARTMENT OF TR	ANSPORTATION	3	TRAFFIC CONTROL AND PROTECTION FOR RTE. Section CONTY SIDE ROADS, INTERSECTIONS, AND DRIVEWAYS 0017 24-00012-00-RS MCHENRY	NO. 61L51							
PLOT DATE = 5/3/2024	DATE - 06-89	REVISED - D. SENDERAK 05-03-24	S		SCALE: NONE	SHEET 1	OF 1	SHEETS	STA.	TO STA.	ILLINOIS FED. AID PROJE		AID PROJECT 06HP	(261)

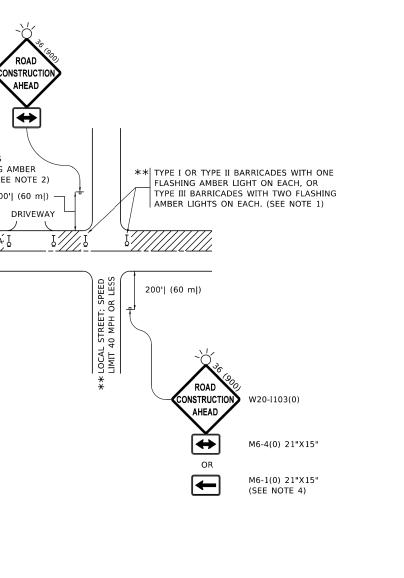


5. WHEN WORK IS BEING PERFORMED ON A SIDE ROAD OR DRIVEWAY, FOLLOW THE APPLICABLE STANDARD(S). THE DIRECTIONAL ARROW (M6-1 OR M6-4) SHALL BE COVERED OR REMOVED WHEN NO LONGER CONSISTENT WITH THE TRAFFIC CONTROL SET-UP. IN ROUTE.


- ADVANCE WARNING SIGNS ARE TO BE OMITTED ON DRIVEWAYS UNLESS OTHERWISE SPECIFIED IN THE PLANS OR BY THE ENGINEER.
- 7. THE TRAFFIC CONTROL AND PROTECTION FOR SIDE ROADS, INTERSECTIONS, AND DRIVEWAYS SHALL BE INCLUDED IN THE COST OF SPECIFIED TRAFFIC CONTROL STANDARDS OR ITEMS.

TH A

10)

All dimensions are in inches (millimeters) unless otherwise shown.

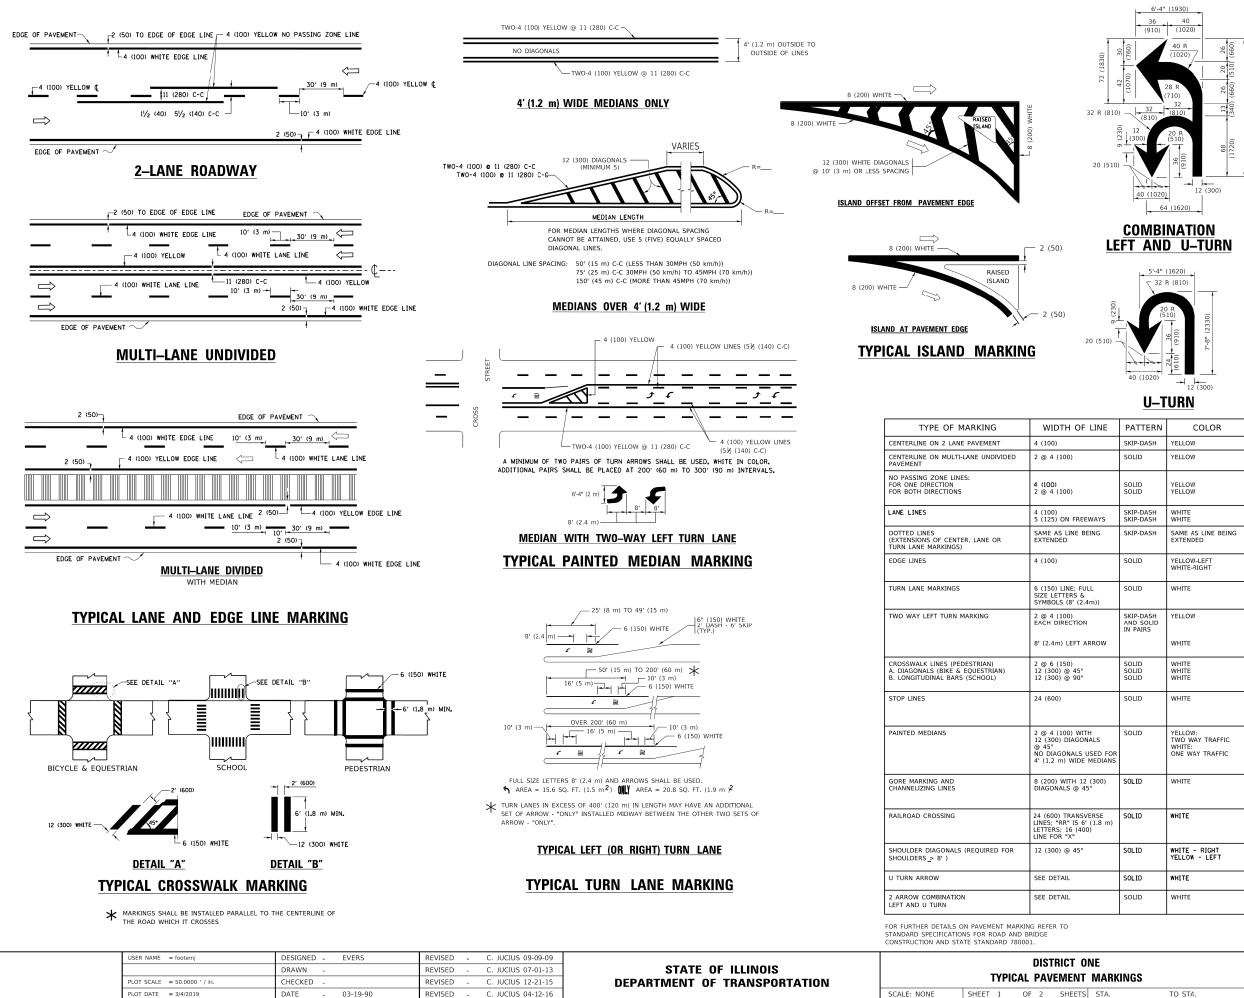

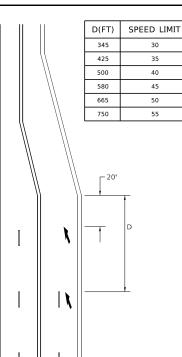


LANE REDUCTION TRANSITION

★ LANE REDUCTION ARROWS REQUIRED AT SPEEDS OF 45 MPH OR GREATER OR WHEN SPECIFIED IN PLANS.

F LINE	PATTERN	COLOR	SPACING / REMARKS
	SKIP-DASH	YELLOW	10' (3 m) LINE WITH 30' (9 m) SPACE
	SOLID	YELLOW	11 (280) C-C
	SOLID SOLID	YELLOW YELLOW	5½ (140) C-C FROM SKIP-DASH CENTERLINE 11 (280) C-C OMIT SKIP-DASH CENTERLINE BETWEEN
EEWAYS	SKIP-DASH SKIP-DASH	WHITE WHITE	10' (3 m) LINE WITH 30' (9 m) SPACE
BEING	SKIP-DASH	SAME AS LINE BEING EXTENDED	2' (600) LINE WITH 6' (1.8 m) SPACE
	SOLID	YELLOW-LEFT WHITE-RIGHT	OUTLINE MEDIANS IN YELLOW
FULL & 2.4m))	SOLID	WHITE	SEE TYPICAL TURN LANE MARKING DETAIL
ARROW	SKIP-DASH AND SOLID IN PAIRS	YELLOW	10' (3 m) LINE WITH 30' (9 m) SPACE FOR SKIP-DASH; 5½ (140) C-C BETWEEN SOLID LINE AND SKIP-DASH LINE SEE TYPICAL TWO-WAY LEFT TURN MARKING DETAIL
0	SOLID SOLID SOLID	WHITE WHITE WHITE	NOT LESS THAN 6' (1.8 m) APART 2' (600) APART 2' (600) APART SEE TYPICAL CROSSWALK MARKING DETAILS.
	SOLID	WHITE	PLACE 4' (1.2 m) IN ADVANCE OF AND PARALLEL TO CROSWALK, IF PRESENT. OTHERWISE, PLACE AT DESIRED STOPPING POINT. PARALLEL TO CROSSROAD CENTERLINE, WHERE POSSIBLE
VITH ONALS 5 USED FOR E MEDIANS	SOLID	YELLOW: TWO WAY TRAFFIC WHITE: ONE WAY TRAFFIC	11 (280) C-C FOR THE DOUBLE LINE SEE TYPICAL PAINTED MEDIAN MARKING.
12 (300) 45°	SOLID	WHITE	DIAGONALS: 15' (4.5 m) C-C (LESS THAN 30MPH (50 km/h)) 20' (6 m) C-C 30MPH (50 km/h) TO 45MPH (70 km/h)) 30' (9 m) C-C (OVER 45MPH (70 km/h))
SVERSE 6' (1.8 m) 000)	SOLID	WHITE	SEE STATE STANDARD 780001 AREA OF: "R"=3.6 SQ. FT. (0.33 m 2EACH "X"=54.0 SQ. FT. (5.0 m 2
0	SOLID	WHITE - RIGHT Yellow - Left	50' (15 m) C-C (LESS THAN 30MPH (50 km/h)) 75' (25 m) C-C (30 MPH (50 km/h) TO 45MPH (70 km/h)) 150' (45 m) C-C (OVER 45MPH (70 km/h))
	SOLID	WHITE	16.3 SF
	SOLID	WHITE	30.4 SF

All dimensions are in inches (millimeters) unless otherwise shown.

ONE IT MARKINGS		F.A. RTE.	RTE. SECTION			COUNTY	TOTAL SHEETS	SHEET NO.	
		0017				McHENRY	17	16	
II WARKINGS				TC-13			CONTRACT	NO. 6	1L51
TS	STA.	TO STA.		ILLINOIS			ID PROJECT 06HH	(261)	

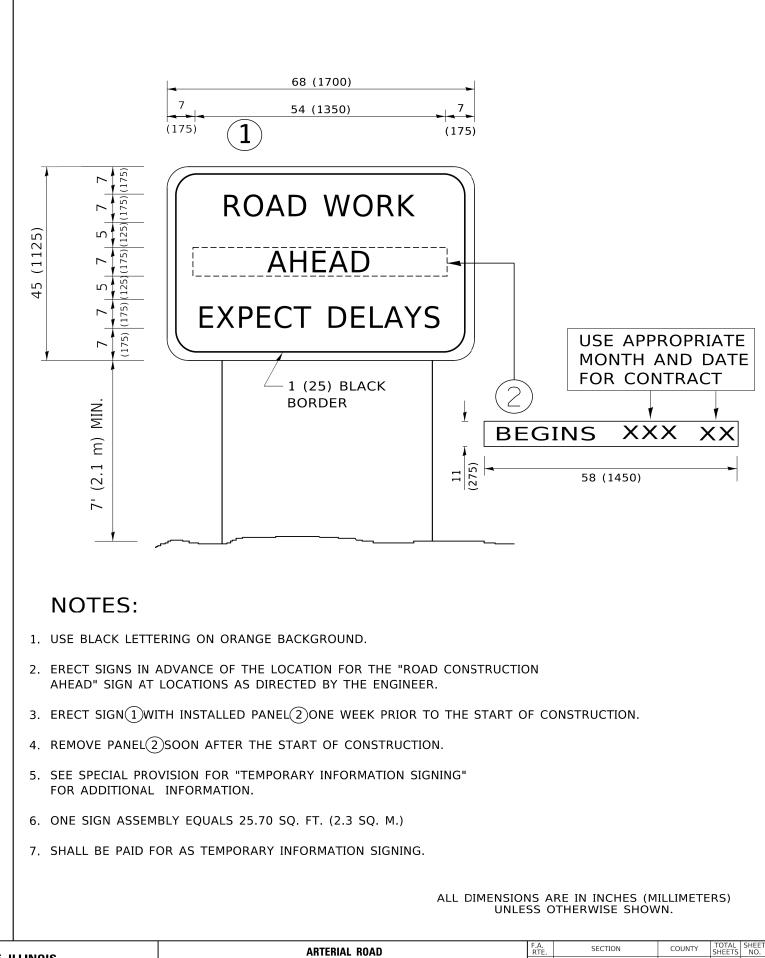

otemj DE	ESIGNED -	REVISED	- R. MIRS 09-15-97					ARTER	
DR	RAWN -	REVISED	- R. MIRS 12-11-97	STATE OF II	LINOIS				
0.0000 ' / in. CH	HECKED -	REVISED	- T. RAMMACHER 02-02-99	DEPARTMENT OF TR	ANSPORTATION			INFORM	ATION
4/2019 DA	ATE -	REVISED	- C. JUCIUS 01-31-07			SCALE: NONE	SHEET 1	OF 1	SHEETS
	DI 0.0000 ' / in. Cł	DRAWN	DRAWN REVISED 0.0000 ' / in. CHECKED REVISED	DRAWN REVISED R. MIRS 12-11-97 D.0000 ' / in. CHECKED REVISED - T. RAMMACHER 02-02-99	DRAWN REVISED R. MIRS 12-11-97 STATE OF II D.0000 ' / in. CHECKED REVISED - T. RAMMACHER 02-02-99 DEPARTMENT OF TR	DRAWN - REVISED - R. MIRS 12-11-97 STATE OF ILLINOIS D.0000 ' / in. CHECKED - REVISED -T. RAMMACHER 02-02-99 DEPARTMENT OF TRANSPORTATION	DRAWN - REVISED - R. MIRS 12-11-97 STATE OF ILLINOIS D.0000 ' / in. CHECKED - REVISED -T. RAMMACHER 02-02-99 DEPARTMENT OF TRANSPORTATION	DRAWN REVISED R. MIRS 12-11-97 STATE OF ILLINOIS D.0000 ' / in. CHECKED REVISED -T. RAMMACHER 02-02-99 DEPARTMENT OF TRANSPORTATION	DRAWN REVISED R. MIRS 12-11-97 STATE OF ILLINOIS ARTER D.0000 ' / in. CHECKED REVISED -T. RAMMACHER 02-02-99 DEPARTMENT OF TRANSPORTATION INFORMAL

ALL	DIMENSIONS	ARE	IN	INCHES	(MILLIMETERS)
	UNLESS	OTHE	ER	WISE SH	OWN.

ROAD				F.A. SECTION			COUNTY	TOTAL	SHEET NO.
		0017	24-00012-00-RS			McHENRY	17	17	
N SIGN				TC-22			CONTRAC	T NO. 6	1L51
TS STA. TO STA.					ILLINOIS	FED. AI	D PROJECT 06H	H(261)	