06-13-2025 LETTING ITEM 214

STATE OF ILLINOIS **DEPARTMENT OF TRANSPORTATION**

(2, 3, 4)RS-7 & 115SW OGLE BURNIS CONTRACT NO. 64P13


D-92-016-20

PROPOSED HIGHWAY PLANS

FAP ROUTE 316 & 549 (IL 26 & IL 72) **SECTION** (2, 3, 4)RS-7 & 115SW

MILLING, RESURFACING & ADA IMPROVEMENTS **OGLE COUNTY**

C-92-001-23

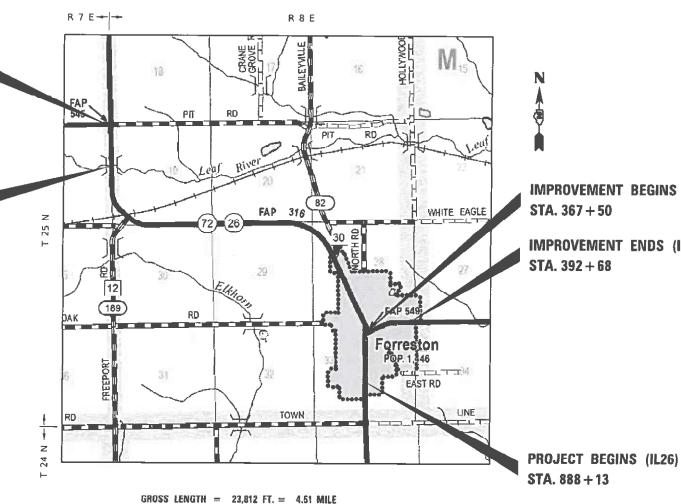

NET LENGTH = 23,608 FT. = 4,47 MILE

IMPROVEMENT BEGINS (IL72) STA. 367 + 50

IMPROVEMENT ENDS (IL72) STA.392 + 68

STATE OF ILLINOIS DEPARTMENT OF TRANSPORTATION

LOCATION OF SECTION INDICATED THUS: -

PRINTED BY THE AUTHORITY OF THE STATE OF ILLINOIS

SEE SHEET NO. 2

FOR INDEX OF SHEETS & HIGHWAY STANDARDS,

HIGHWAY CLASSIFICATION

FAP ROUTE 316 & 549 (IL 26 & IL 72) CLASSIFICATION: OTHER PRINCIPLE ARTERIAL (IL26) & MINOR ARTERIAL (IL72)

P.V. = 3705

0

0

0


M.U. = 275

S.U. = 245

PROJECT ENDS (IL26/IL72) STA. 1127 + 64

FORRESTON TOWNSHIP SECTIONS (19,20,24,28,29,30,33)

BRIDGE OMISSION STA. 1105 + 57 - 1107 + 61

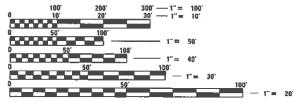

ENGINEERING SCALES. REDUCED SIZED PLANS WILL NOT CONFORM TO STANDARD SCALES. IN MAKING MEASUREMENTS ON REDUCED PLANS, THE ABOVE SCALES MAY BE USED.

JOINT UTILITY LOCATION INFORMATION FOR EXCAVATORS 1-800-892-0123 OR 811

PROJECT ENGINEER: MICHAEL KUEHN (815)-2814-5503 PROJECT MANAGER: ANDREW DEWEY (815)-284-5358 EMAIL: Andrew.P.Dewey@illinois.gov

CONTRACT NO. 64P13

REV. 4/22/25

INDEX OF SHEETS

HIGHWAY STANDARDS

1	COVER SHEET	000001 - 08	STANDARD SYMBOLS ABBREVIATIONS & PATTERNS
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5 - 10	SUMMARY OF QUANTITIES	424006 - 06	DIAGONAL CURB RAMPS FOR SIDEWALKS
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14 - 20	SCHEDULE OF QUANTITIES	424016 - 06	MID-BLOCK CURB RAMPS FOR SIDEWALKS
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82 - 104	ADA RAMP DETAILS - IL-26	701306 - 04	LANE CLOSURE, 2L, 2W, SLOW MOVING OPERATIONS DAY ONLY, FOR SPEEDS > 45 MPH
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128	GUARDRAIL REFLECTORS, TYPE C (SPECIAL) (DS 55.1)	720001 - 01	SIGN PANEL MOUNTING DETAILS
129	HOT-MIX ASPHALT APPROACHES AND MAILBOX RETURNS FOR TWO LIFTS (3P) RESURFACING PROJECTS (DS 47.2)	720006 - 04	SIGN PAEL ERECTION DETAILS
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130	PIPE HANDRAIL FOR STEPS (DS 63.2)	728001 - 01	TELESCOPING STEEL SIGN SUPPORT
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131	PAVEMENT PATCHING FOR HOT-MIX ASPHALT SURFACED PAVEMENT (DS 32.4)	782006 - 01	GUARDRAIL AND BARRIER WALL REFLECTOR MOUNTING DETAILS
132	SUBGRADE REPLACEMENT (DS 97.4)	780001 - 05	TYPICAL PAVEMENT MARKINGS

USER NAME = Andrew.p.dewey	DESIGNED -	REVISED -
	DRAWN -	REVISED -
PLOT SCALE = \$SCALE\$	CHECKED -	REVISED -
PLOT DATE = 1/24/2025	DATE -	REVISED -

STATE OF ILLINOIS DEPARTMENT OF TRANSPORTATION | F.A.P. | SECTION | COUNTY | SHEETS |

GENERAL NOTES

The contractor shall notify Traffic Operations a minimum of 5 working days prior to placing permanent pavement marking or signing.

Fertilizer shall be applied to all disturbed areas and incorporated into the seedbed prior to seeding or placement of sod at the rate specified in Sections 250 and 252 of the Standard Specifications. This work shall be included in the cost of EARTH EXCAVATION.

When laying out for patching, the minimum distance between new patches (saw cut to saw cut) shall be 15 feet. When patch spacing is less than 15 feet, the pavement between patches shall also be removed and replaced.

The minimum patch dimension for full-depth patches will be 4 feet and half-lane width. Half-lane patches shall be confined to the outside edges of the pavement.

The existing hot-mix asphalt on private and commercial entrances shall be bladed off or milled and disposed of outside the project limits. This could be the entire entrance or tapered at the end depending on if the mainline is resurfaced or milled and resurfaced. The cost of the blading, milling, rolling, and disposal is included in the contract unit price for INCIDENTAL HOT-MIX ASPHALT SURFACING.

The drop off that occurs at entrance edges as a result of resurfacing of the entrance shall be corrected using aggregate shoulder material. This work shall be paid for by the TON for Aggregate Shoulders of the type specified in the plans.

The following Mixture Requirements are applicable for this project:

		Resurfacing	
Location and Mixture Uses(s):	Surface	Binder	Shoulders
PG:	PG 58-28	PG 58-28	PG 58-28
Design Air Voids	4.0 @ N50	4.0 @ N50	4.0 @ N50
Mixture Composition	IL 9.5	IL 9.5FG	IL 9.5FG
Friction Aggregate	С	N/A	С
Mix Weight	112 lb/sy/in	N/A	112 lb/sy/in
Quality Management Program	QCP	QCP	QC/QA
Sublot Size	1000	1000	N/A
Material Transfer Device	YES	YES	N/A

Polymerized Bituminous Materials (Tack Coat) - Application Rates *								
Surface Type	Residual Rate							
Milled (HMA or PCC)	0.05 lb / sq ft							
Existing Pavement	0.05 lb / sq ft							
Fog Coat (between lifts)	0.05 lb / sq ft							

^{*} polymer tack shall be SS-1hP, CSS-1hP, or NTEA listed material

The Contractor will be required to furnish 5 1/2" high brass stencils as approved by the Engineer and install stationing at 250' intervals. Stationing shall be placed on both lanes of 2-lane highways and on the outside lanes in both directions on 4-lane highways. The stations shall be placed 6" inside the pavement marking edge so they can be read from the shoulder. This work will be included in the cost of the final pavement surface.

The area to be tacked or primed shall be limited to that which can be covered with HMA on the next day's production, but no more than five days in advance of the placement of the HMA, unless approved by the Engineer.

The Contractor shall be responsible for collecting and maintaining an electronic log of all stakeout survey that is performed on the job, either by him/her or any sub-contractor performing the stakeout. Upon request, all logs shall be submitted to the Department. No additional compensation will be allowed for this work, but shall be considered included in the cost for CONSTRUCTION LAYOUT.

Pavement Marking shall be done according to Standard 780001, except as follows:

- 1. All words, such as ONLY, shall be 8 feet high.
- 2. All non-freeway arrows shall be the large size.
- 3. The distance between yellow no-passing lines shall be 8 inches, not 7 inches, as shown in the detail of Typical Lane and Edge Lines.
- 4. Centerline Skip Dash Pavement Marking on multi-lane divided, multi-lane undivided, and one-way roadway shall be according to District Standard 41.1.

PERMANENT SURVEY MARKERS, TYPE II, shall be set at intervals of 1 mile or as directed by the Engineer. Bridge or culvert projects shall have one survey marker placed near the structure. Estimated: 2 Each.

Permanent Survey Markers, Type II placed in urban areas should be placed in sidewalk areas. The marker shall be placed as shown on District Standard 66.2. The sidewalk shall be placed around the marker and flush with the top.

The Permanent Survey Markers, if possible, shall be installed at the beginning of the job and protected throughout.

The Contractor shall submit to the Engineer a description of location, elevation, and coordinates for each permanent survey marker. The horizontal coordinates must be derived by GPS and the elevation derived using an electronic level. The meta data, such as the Geoid used, (NGS adjustment ie: 97 HARN, 03, 07), and the base point(s) name or number shall be submitted along with a complete collection log. If collected using RTK method, it will require either 3 collections (averaged) from 2 different bases, or a minimum of 3 collections (averaged), at least 2 hours apart, from the same base. If using a CORS type network, the collection procedure shall include localizing with check shots on at least 2 different HARN monuments both before and after collection. The level circuit shall be run from furnished mark to furnished mark and then adjusted. The error of closure shall be submitted with the electronic level notes in a recognized format approved by the Engineer and/or the Chief of Surveys. The Engineer shall submit this information to the District Chief of Surveys.

This project contains survey monuments that may be disturbed. The contractor must notify the Resident Engineer, Roger Inboden, Chief of Surveys, at Roger.Inboden@illinois.gov, a minimum of 21 days before any activity that may disturb a monument in the pavement. This would include section corners, quarter corners, witness corners, or anything else that could pertain to a property corner that would be in violation of 765ILCS 205/11.

Work on this project will be in progress at the same time as contract 64U19, work on IL 72 from IL 26 in Forreston to 0.3 Mi E of Mt Morris Rd E of Leaf River & Contract 64U22, on IL 26 S of Willow St in Forreston to Hillside Dr N of Polo

FILE NAME = 64P13 GN DOCX	USER NAME =	DESIGNED - Engineering Systems	REVISED -			_	ROUTE	SECTION	COUNTY	TOTAL SHEETS	SHEET NO.		
		DRAWN -	REVISED -	STATE OF ILLINOIS		GENERAL N	FAP 316 & 549	(2, 3, 4)RS-7 & 115SW	Ogle	132	3		
	PLOT SCALE =	CHECKED -	REVISED -	DEPARTMENT OF TRANSPORTATION							CONTRACT NO. 64P13		
	PLOT DATE = 3/14/2025 1:04 PM	DATE - 1/22/2025 11:10 AM	REVISED -		SCALE:	SHEET NO. OF SHEETS	STA. TO STA.			ILLINOIS	FED. AID PROJE	:CT	

GENERAL NOTES

The following listed utilities located within the project limits or immediately adjacent to the project construction limits are members of JULIE:

BP Pipelines North America, Inc	(312) 594-0165
Leaf River Telephone Co.	(815) 738-2211
NICOR Gas Co.	(630) 388-3019
Comcast Cable	(815) 509-8653
iFiber	(815) 753-5798
Village of Forreston	(815) 238-0767
Frontier (North)	(309) 853-6297
Commonwealth Edison Company	(779) 231-1027
Midwest Fiber Networks LLC	(866) 831-1661
Dekalb Fiber Optic	(574) 536-7660
Bluebird Network	(847) 650-1348

IDOT is not a member of JULIE. If you are near any overhead lighting, intersection lighting or traffic signals, contact the IDOT Traffic Office at 815/284-5469 at least 48 hours prior to work.

It shall be the Contractor's responsibility to contact the municipality to determine approved methods of utility structure adjustment. Utility structures may include, but are not limited to, manholes, water valves, handholes, etc. All materials and work necessary to complete adjustments per municipality requirements shall be considered included in the cost of the associated adjustment pay item.

Based on our structural analysis, the following structure(s) can be crossed with an empty MTD with the following maximum gross weight restrictions: 071-1040 (40 tons), 071-0080 (40 tons)

COMMITMENTS

Trees three (3) inches or greater in diameter at breast height will not be cleared from April 1 through September 30.

	USER NAME =	DESIGNED - Engineering Systems	REVISED -
FILE NAME = 64P13.GN.DOCX		DRAWN -	REVISED -
FILE NAME = 64P13.GN.DOCX	PLOT SCALE =	CHECKED -	REVISED -
	PLOT DATE = 3/14/2025 1:04 PM	DATE - 1/22/2025 11:10 AM	REVISED -

STATE OF ILLINOIS
STATE OF ILLINOIS
DEPARTMENT OF TRANSPORTATION

					ROUTE	SECT	ION	COUNTY	TOTAL SHEETS	SHEET NO.
GENERAL NOTES					FAP 316 & 549	(2, 3, 4)RS-7	' & 115SW	Ogle	4	
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USER NAME = Andrew.p.dewey	DESIGNED	REVISED _								F.A.P. RTE.	SECTION	COUNTY	TOTAL SH	IEET NO.
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PLOT DATE = 1/24/2025	DATE	REVISED		SCALE:	SHEET	OF	SHEETS	STA.	TO STA.	1	ILLINOIS FED. A	PROJECT		

^{*} SPECIALTY ITEM

* SPECIALTY ITEM

USER NAME = Andrew.p.dewey	DESIGNED ==	REVISED =								F.A.P.	SECTION	COUNTY	TOTAL SHEET
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PLOT SCALE = \$SCALE\$	CHECKED	REVISED -	DEPARTMENT OF TRANSPORTATION							*316 & 549	CONTRAC	T NO. 64P13	
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^{*} SPECIALTY ITEM

* SPECIALTY ITEM

USER NAME = Andrew.p.dewey	DESIGNED	REVISED =	
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PLOT DATE = 1/24/2025	DATE	REVISED +	

					F.A.P. RTE.	SEC	TION		COUNTY
	SUMMARY	r of au	*	(2, 3, 4)RS-	7 & 115	SW	OGLE		
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SHEET	OF	SHEETS	STA.	TO STA.			ILLINOIS	FED. A	D PROJECT


	CHRARADY OF CHARITITES			NHPP	STP	NHPP	NHPP
CODE	SUMMARY OF QUANTITIES		TOTAL	IL 26 100% STATE ROADWAY 0005	IL 72 100% STATE SAFETY 00021	100% CITY UTILITIES 0043	50% STATE / 50% CITY UTILITIES 0043
NO.	ITEM	UNIT	QUANTITY	RURAL	RURAL	RURAL	RURAL
72000100	SIGN PANEL - TYPE 1	SQ FT	447.7	411.7	36.0		
72000100		30 11	777.7	711.7	30.0		
72000200	SIGN PANEL - TYPE 2	SQ FT	145.6	145.6			
72400310	REMOVE SIGN PANEL = TYPE 1	SQ FT	351.1	323.2	27.9		
72400320	REMOVE SIGN PANEL - TYPE 2	SQ FT	167.0	167.0			
72400710	RELOCATE SIGN PANEL TYPE 1	SQ FT	269.2	260.2	9.0		
72400720	RELOCATE SIGN PANEL TYPE 2	SQ FT	21.4	21.4			
72800100	TELESCOPING STEEL SIGN SUPPORT	FOOT	728	666	62.0		
73000100	WOOD SIGN SUPPORT	FOOT	508	508			
78009000	MODIFIED URETHANE PAVEMENT MARKING - LETTERS AND SYMBOLS	SQ FT	240	240			
78009004	MODIFIED URETHANE PAVEMENT MARKING & LINE 4"	FOOT	63,493	62,917			576
78009006	MODIFIED URETHANE PAVEMENT MARKING - LINE 6"	FOOT	2,098	454	1,644		
78009008	MODIFIED URETHANE PAVEMENT MARKING - LINE 8"	FOOT	825	825			
78009012	MODIFIED URETHANE PAVEMENT MARKING = LINE 12"	FOOT	376	376			
78009024	MODIFIED URETHANE PAVEMENT MARKING = LINE 24"	FOOT	132	132			

^{*} SPECIALTY ITEM

USER NAME = Andrew.p.dewey	DESIGNED	REVISED =								F.A.P.	SECTION	COUNTY	TOTAL S
	DRAWN -	REVISED -	STATE OF ILLINOIS		S	UMMARY				*	(2, 3, 4)RS-7 & 115SW	OGLE	132
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PLOT DATE = 1/24/2025	DATE	REVISED +		SCALE:	SHEET	OF	SHEETS	STA.	TO STA.		ILLINOIS FED. AI	D PROJECT	

USER NAME = Andrew.p.dewey	DESIGNED	REVISED =
	DRAWN	REVISED -
PLOT SCALE = \$SCALE\$	CHECKED	REVISED -
PLOT DATE = 1/24/2025	DATE	REVISED +

^{*} SPECIALTY ITEM

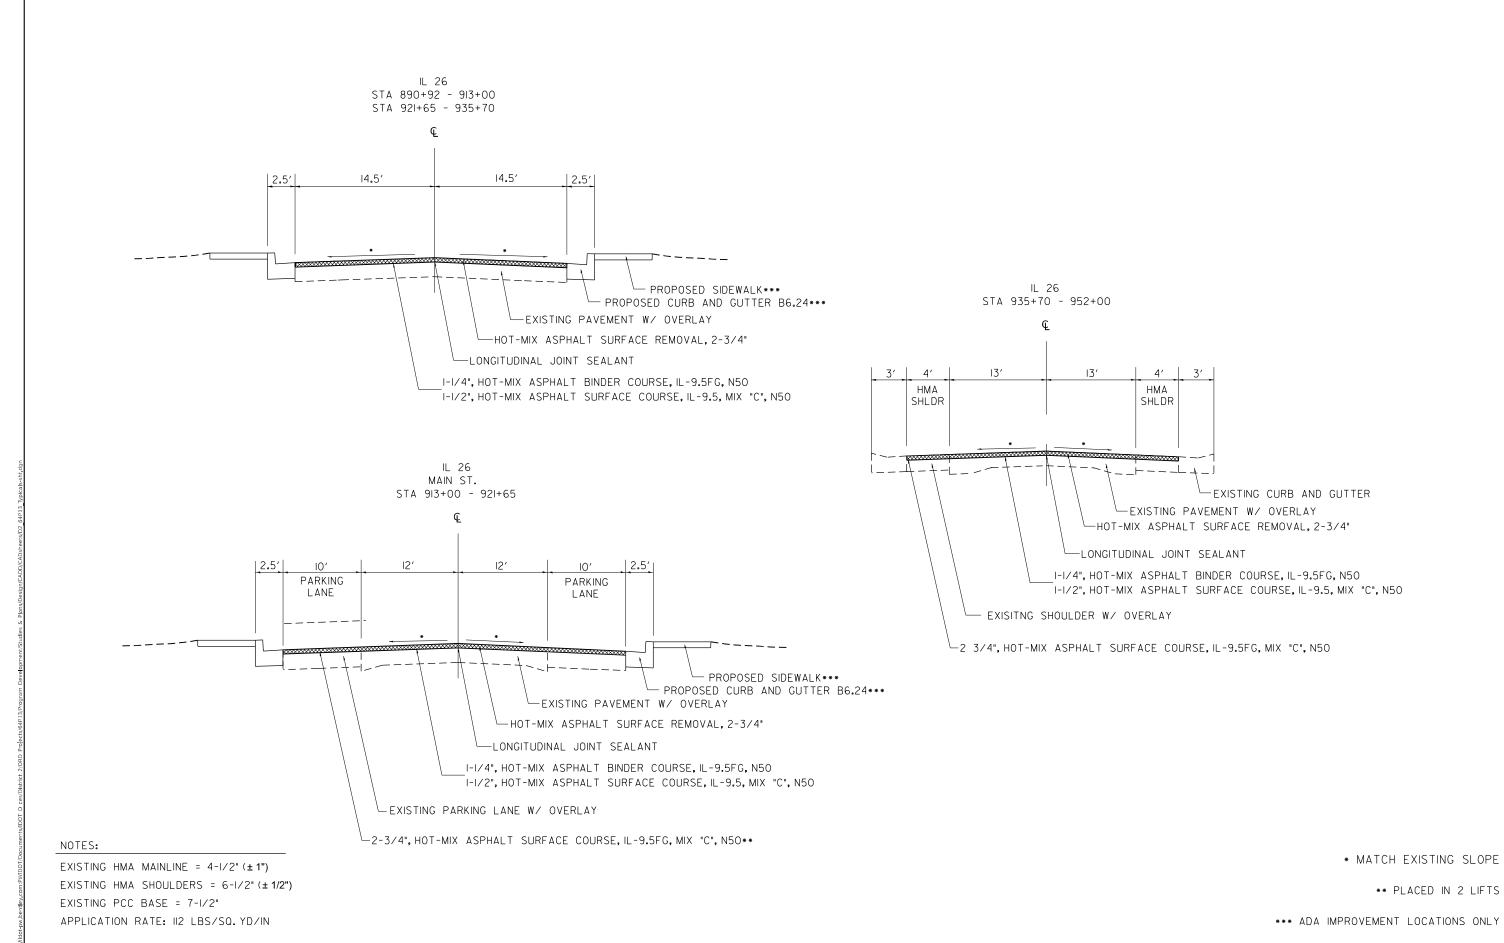

STATE OF ILLINOIS

DEPARTMENT OF TRANSPORTATION

TYPICAL SECTIONS

OF 3 SHEETS STA.

SHEET 1

(2, 3, 4)RS-7 & 115SW

*316 & 549

CONTRACT NO. 64P13

JSER NAME = Andrew.p.dewey

PLOT SCALE = \$SCALE\$

DESIGNED -


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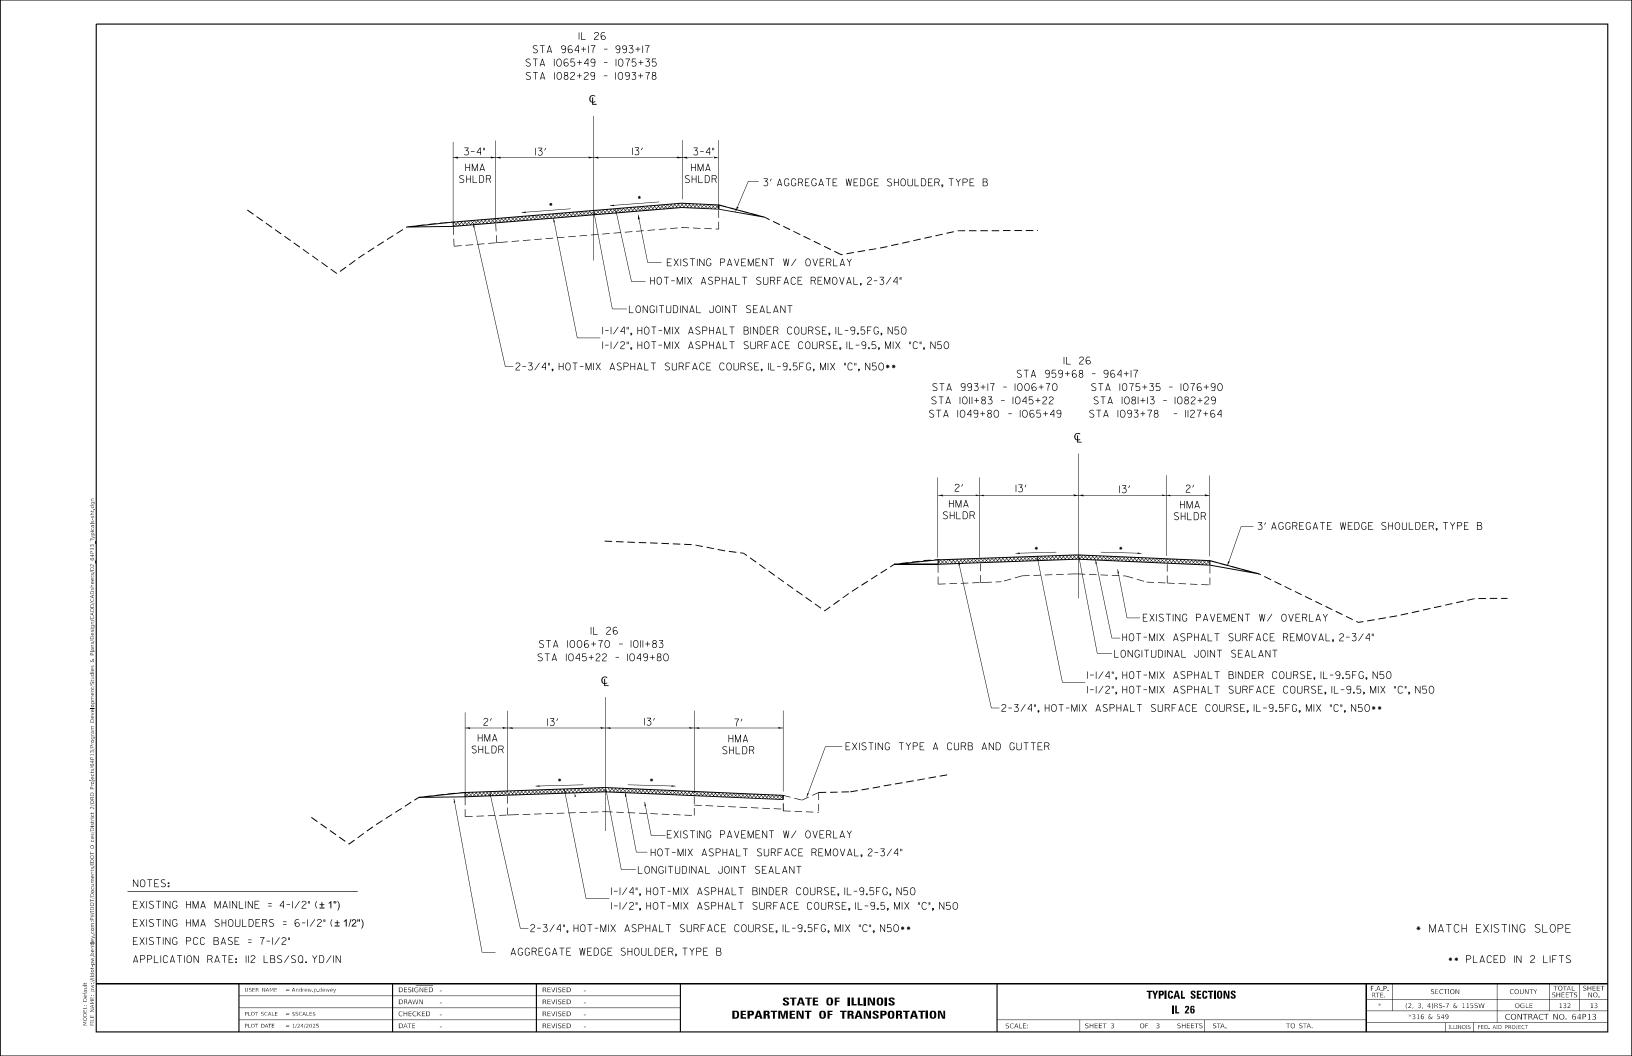


* MATCH EXISTING SLOPE

** PLACED IN 2 LIFTS

USER NAME = Andrew, p.dewey

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20200100	EARTH EXCAVATI	<u>ON</u>			25200110	SODDING, SALT	<u>FOLERANT</u>		
	CU YD	LOCATION	<u>OFFSET</u>	<u>REMARKS</u>		<u>SQ_YD</u>	LOCATION	OFFSET	REMARKS
20100210	1 4 40 18 14 27 11 9 2 21 15 35 1 197 7 2 9 11 5 9 11 5 9 1 44 241 TREE REMOVAL (IL-26 Meadow St Willow St Pine St Elm St Birch St Cherry St Walnut Ave E State St White Oak St Avon St Green St Logan St Magnolia St IL-72 Walnut Ave Ash Ave Chestnut Ave Oak Ave Plum Ave Locust Ave Masterson Ave	OFFSET	ADA	28000510	1 23 88 52 32 34 16 13 31 1 57 36 125 9 518 1 4 28 23 24 44 5 129 647	Meadow St Willow St Pine St Elm St Birch St Cherry St E Main St (IL-72) Balsam St Walnut Ave E State St White Oak St Avon St Green St Logan St Magnolia St IL-72 Walnut Ave Ash Ave Chestnut Ave Oak Ave Plum Ave Locust Ave Masterson Ave		*Pay for Fertilizer included ADA ADA ADA ADA ADA ADA ADA ADA ADA AD
	<u>UNIT</u>	LOCATION IL - 26	OFFSET	<u>REMARKS</u>	28000510	INLET FILTERS <u>EACH</u>	LOCATION	OFFSET	REMARKS
-	40	Sta 899+40	24' LT	Pine St		<u> </u>	<u>IL-26</u>	<u>011321</u>	ner autre
21101615		LOCATION IL-26 Meadow St Willow St Pine St Elm St Birch St Cherry St E Main St (IL-72) Balsam St Walnut Ave E State St White Oak St Avon St Green St Logan St Magnolia St IL-72 Walnut Ave Ash Ave Chestnut Ave Oak Ave Plum Ave Locust Ave Masterson Ave	OFFSET	REMARKS ADA ADA ADA ADA ADA ADA ADA ADA ADA A		1 1 1 1 1 1 1 1 1 1 1 1 1 1 1 1 1 1 1	Sta 903+43 Sta 903+46 Sta 903+90 Sta 903+96 Sta 913+20 Sta 913+18 Sta 920+08 Sta 926+06 Sta 926+06 Sta 926+57 Sta 931+42 Sta 931+53 IL-72 Sta 366+72 Sta 370+64 Sta 371+27 Sta 371+68 Sta 373+65 Sta 373+72 Sta 373+72 Sta 374+12 Sta 375+77 Sta 376+16 Sta 376+18 Sta 376+52 Sta 377+90 Sta 378+26	25' RT 25' RT 26' LT 26' RT 21' RT 21' LT	Cherry St IL-26/72 Avon St Green St N Walnut Ave (IL-72 N) Ash Ave Chestnut Ave

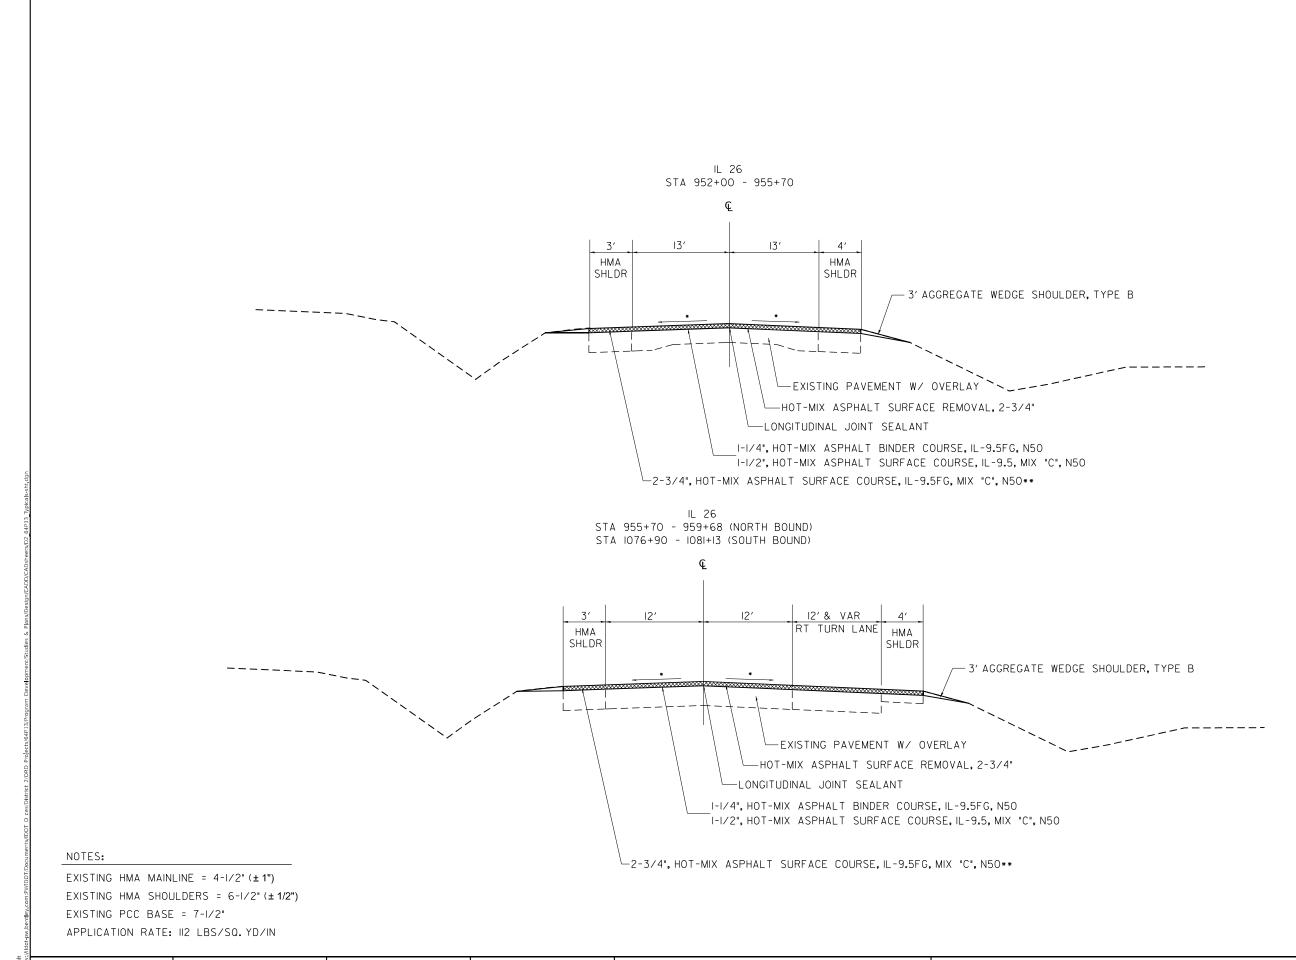STATE OF ILLINOIS

DEPARTMENT OF TRANSPORTATION

SECTION

*316 & 549

(2,3,4,)RS-7 & 115SW

OGLE 132 14

CONTRACT NO. 64P13

SCHEDULE OF QUANTITIES

TO STA.

SHEET OF SHEETS STA.

SCALE:

JSER NAME = Andrew.p.dewey

PLOT DATE = 1/24/2025

DESIGNED -

DRAWN

DATE

CHECKED

REVISED

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REVISED

28000510	INLET FILTERS	(CONTINUED)			40800050	INCIDENTAL	HOT-MIX ASPHALT SURFACING		
	<u>EACH</u>	LOCATION	<u>OFFSET</u>	<u>REMARKS</u>		TON	LOCATION	OFFSET	REMARKS
	1 1	<u>IL-72</u> Sta 379+02 Sta 380+02	24' RT 24' RT	Locust Ave		1 !			ADA ADA
	1	Sta 380+30	43' LT			40			ADA
	1	Sta 380+50 Sta 380+88	46' RT 44' RT			51 28			ADA ADA
	1	Sta 381+44	23' RT			34			ADA
	1	Sta 381+46	23' LT				9 E Main St (IL-72)		ADA
	32					30			ADA
	61					20			ADA
2020001	ACCRECATE SURC	DADE IMPROVEMENT				10	5 E State St 0 White Oak St		ADA ADA
30300001	AGGREGATE SUBG	RADE IMPROVEMENT				13			ADA
	CU YD	LOCATION	OFFSET	REMARKS		3			ADA
				*Urban		24			ADA
		<u>IL-26</u>				0.2			ADA
	2	Sta 897+22 -	898+05 SB Lane			31.			
	36	Sta 888+13 -	952+00 LT & RT	Per direction of RE		71.0	<u>IL - 72</u>		٨٦٨
	38					40			ADA ADA
40600295	POLYMERIZED RI	TUMINOUS MATERIALS (TACK	K COAT)			4.			ADA
.000233	. JETTILITIED DI					30			ADA
	POUND	LOCATION	OFFSET	<u>REMARKS</u>		28			ADA
						22			ADA
		<u>IL-26</u>		454			5 Masterson Ave		ADA
	3 41	Meadow St Willow St		ADA ADA		21 536			
	108	Pine St		ADA		23(j		
	142	Elm St		ADA	42300300	PORTLAND C	EMENT CONCRETE DRIVEWAY PAVEME	NT, 7 INCH	
	75	Birch St		ADA					
	90	Cherry St		ADA		SQ YD	LOCATION	OFFSET	<u>REMARKS</u>
	24	E Main St (IL-72)		ADA			11 26		
	97 54	Balsam St Walnut Ave		ADA ADA		20	<u>IL-26</u> 6		ADA
	14	E State St		ADA		28			ADA
	27	White Oak St		ADA			7 White Oak St		ADA
	32	Avon St		ADA		6	1		
	82	Green St		ADA		2.	<u>IL-72</u>		10.
	64	Logan St		ADA		1 ! 1 4			ADA ADA
	1 855	Magnolia St		ADA		2.			ADA
	055	<u>IL-72</u>				90			
	124	Walnut Ave		ADA					
	113	Ash Ave		ADA	42400200	PORTLAND C	EMENT CONCRETE SIDEWALK 5 INCH		
	119	Chestnut Ave		ADA		60 FT		0.5505.7	D FILL DIV.C
	81 74	Oak Ave Plum Ave		ADA ADA		SQ FT	LOCATION	OFFSET	<u>REMARKS</u>
	7.4 58	Locust Ave		ADA ADA			IL-26		
	13	Masterson Ave		ADA		75.			ADA
	582					447.0	0 Willow St		ADA
	1,437					999.			ADA
40666666	HOT MIN ACRUS	T DINDER COURSE (HANN)	ETHOD) NEO			796.0			ADA
40600900	HOI-MIX ASPHAL	T BINDER COURSE (HAND MI	<u> </u>			864.0 1,034.0			ADA ADA
	TON	LOCATION	OFFSET	REMARKS		1,207.0			ADA
		<u></u>	<u> </u>			269.0			ADA
	200	<u>IL-26</u>				1,440.			ADA
:	68	Sta 890+92 -	1127+64	(as needed)		504.			ADA
	68					364.0 994.!			ADA ADA
40600990	TEMPORARY RAMP					746.0			ADA
-0000330	TEN SKAKT KAME					884.0			ADA
	SQ YD	LOCATION	OFFSET	REMARKS		98.0	O Magnolia St		ADA
						10,723			
		<u>IL-26</u>	1127.64	/					
		Sta 890+92 -	1127+64	(as needed)					
	/5								
	USER NAME = Andrew.p.dew	vey DESIGNED -	REVISED -			Т			F.A.P.
	OSEN NAME = Allurew.p.dev	DRAWN -	REVISED -		STATE OF ILLINOIS		SCHEDULE OF QUANTITIES		F.A.P. SECTION

STATE OF ILLINOIS

DEPARTMENT OF TRANSPORTATION

SCHEDULE OF QUANTITIES

TO STA.

SHEET OF SHEETS STA.

SCALE:

(2,3,4,)RS-7 & 115SW

*316 & 549

OGLE 132 15

CONTRACT NO. 64P13

MODEL: Default

DRAWN

DATE

PLOT DATE = 1/24/2025

CHECKED -

REVISED -

REVISED

REVISED

42400200	PORTLAND CEMEN	T CONCRETE SIDEWALK 5 INCH			44000161	HOT-MIX ASPHAL	T SURFACE REMOVAL, 3"		
	<u>SQ FT</u>	LOCATION	<u>OFFSET</u>	<u>REMARKS</u>		SQ YD	LOCATION	OFFSET	<u>REMARKS</u>
	1,892.5 749.0 408.0 779.0 495.0 996.5 121.0 5,441.0 16,164.5	IL-72 Walnut Ave Ash Ave Chestnut Ave Oak Ave Plum Ave Locust Ave Masterson Ave		ADA ADA ADA ADA ADA ADA		6 92 240 316 167 200 53 215 120 32	IL-26 Meadow St Willow St Pine St Elm St Birch St Cherry St E Main St (IL-72) Balsam St Walnut Ave E State St		ADA
42400800	DETECTABLE WAR					59 72	White Oak St Avon St		ADA ADA
	<u>SQ_FT</u> 10	LOCATION IL-26 Meadow St	OFFSET	REMARKS ADA		183 143 1 1.899	Green St Logan St Magnolia St		ADA ADA ADA
	50 80 80 60 60 100 46 40 30 40 80	Willow St Pine St Elm St Birch St Cherry St E Main St (IL-72) Balsam St Walnut Ave E State St White Oak St Avon St Green St		ADA	44000200	275 252 265 179 164 129 29 1,293 3,192 DRIVEWAY PAVEM	IL-72 Walnut Ave Ash Ave Chestnut Ave Oak Ave Plum Ave Locust Ave Masterson Ave		ADA ADA ADA ADA ADA ADA ADA
	80 10 846	Logan St Magnolia St		ADA ADA		SQ YD	LOCATION	OFFSET	<u>REMARKS</u>
44000100	100 80 64 60 40 80 10 434 1,280	IL-72 Walnut Ave Ash Ave Chestnut Ave Oak Ave Plum Ave Locust Ave Masterson Ave		ADA		26 20 18 6 18 88 12 14 26	IL-26 Cherry St E Main St (IL-72) Walnut Ave White Oak St Avon St IL-72 Ash Ave Chestnut Ave		ADA ADA ADA ADA ADA ADA
	<u>SQ YD</u>	LOCATION	<u>OFFSET</u>	<u>REMARKS</u>	44000500		RB AND GUTTER REMOVAL		
	28 24 / / 5 64 6 70	IL-26 E Main St (IL-72) Balsam St Walnut Ave E State St IL-72 Ash Ave		ADA ADA ADA ADA		FOOT 100 236 210 146 211 176 192 172 85 90 237 205 239 2,299	LOCATION IL-26 Willow St Pine St Elm St Birch St Cherry St E Main St (IL-72) Balsam St Walnut Ave E State St White Oak St Avon St Green St Logan St	OFFSET	ADA

MODEL: Default

 USER NAME
 = Andrew,p,dewey
 DESIGNED
 REVISED

 PLOT SCALE
 = \$5CALE\$
 CHECKED
 REVISED

 PLOT DATE
 = 1/24/2025
 DATE
 REVISED

STATE OF ILLINOIS DEPARTMENT OF TRANSPORTATION

SCALE:

44000500	COMBINATION CU			(C) 100000 (A0000 of 2000 A0000		44201741							
	<u>FOOT</u>	LOCATION		<u>OFFSET</u>	<u>REMARKS</u>		<u>SQ YD</u>	LOCATION				OFFSET	<u>REMARKS</u>
	220	<u>IL-72</u> Walnut Ave			ADA		2 024	<u>IL-26</u> Sta	052100	_	1127.64	IT C DT	Dor direction of DE
	229 191	Ash Ave			ADA		3,824	Sta	952+00	-	1127+64	LIARI	Per direction of RE
	150	Chestnut Ave			ADA		3,024						
	119	Oak Ave			ADA	44201745	CLASS D PATCH	S. TYPE II	I. 8 INCH	l			
	301	Plum Ave			ADA					-,			
	557	Locust Ave			ADA		SQ YD	LOCATION				OFFSET	REMARKS
_	24	Masterson Ave			ADA								
_	1,571							<u>IL-26</u>					
	3,870						95 95	Sta	952+00	-	1127+64	LT & RT	Per direction of RE
1000600	SIDEWALK REMOV	/AL				44201747	CLASS D PATCH	EC TYDE IV	A INCH				
	SQ FT	LOCATION		OFFSET	<u>REMARKS</u>	44201747	(1		, o INCH				
		<u>IL-26</u>					<u>SQ_YD</u>	LOCATION				<u>OFFSET</u>	<u>REMARKS</u>
	42.5	Meadow St			ADA			IL-26					
	260.0	Willow St			ADA		1,593	Sta	952+00	-	1127+64	LT & RT	Per direction of RE
	792.0	Pine St			ADA		1,593						
	621.0	Elm St			ADA								
	818.5	Birch St			ADA	50901760	PIPE HANDRAIL						
	989.5	Cherry St			ADA		500 T						8544846
	668.0	E Main St (IL-72)			ADA		<u>FOOT</u>	LOCATION				<u>OFFSET</u>	<u>REMARKS</u>
	1,032.5	Balsam St			ADA			11 20					
	1,263.5 342.5	Walnut Ave E State St			ADA ADA		30	<u>IL-26</u> Sta	915+98	_	916+21		E Main St (IL-72)
	342.5	White Oak St			ADA		36	Sta	915+98	_	918+21		Balsam st
	613.0	Avon St			ADA		66	Sta	917-00	-	910+00		Daisaii St
	580.0	Green St			ADA		00						
	749.0	Logan St			ADA	52200800	SEGMENTAL CON	RETE BLOCK	WALL				
	82.5	Magnolia St			ADA	3220000	SECHENTIAL CON	SKETE BEGEN	WALL				
-	9,184.5	riagilo i i a se			, 157		SQ FT	LOCATION				OFFSET	REMARKS
	-,,	IL-72					·						* Cost for removal of exis
	1,885.5	Walnut Ave			ADA								to be included.
	679.0	Ash Ave			ADA			IL-72					
	574.5	Chestnut Ave			ADA		125	Sta	376+65			41' LT	Oak Ave - NE
	689.0	Oak Ave			ADA		125						
	495.5	Plum Ave			ADA								
	999.0	Locust Ave			ADA	56109210	WATER VALVES	<u> TO BE ADJUS</u>	TED				
<u>=</u>	136.5	Masterson Ave			ADA								
_	5,459.0						EACH	LOCATION				OFFSET	REMARKS
	14,643.5												
								<u>IL-26</u>				201 1 =	Margarithman Co.
201389	CLASS C PATCHE	S, TYPE II, 13 INC	<u>.H</u>				1	Sta	890+92				Meadow Ct
	CO VD	LOCATION		OFFCET	DEMARKS		1	Sta	890+94			18' LT 44' LT	
	<u>SQ_YD</u>	LOCATION		OFFSET	REMARKS		1	Sta Sta	899+15			14' LT	W Pine St W Cherry St
		11 26			*Urban		∠ 1	Sta	912+60 913+42			26' RT	w Cherry St E Cherry St
	1,379	<u>IL-26</u> Sta 888+13	- 9	152+00 IT £ DT	Per direction of RE		1	Sta	913+42			39' RT	E Cherry St E Main St (IL-72)
-	1,379	3 ta 000+13	- 9	JZTUU LI W KI	TEL ULLECTION OF NE		1	Sta	916+26				E Main St (IL-72)
	1,3/3						ı T	Sta	916+63			34' RT	E Main St (IL-72)
201394	CLASS C PATCHE	S, TYPE III, 13 IN	ICH				2	Sta	916+57				E Main St (IL-72)
201334	SENSS C INTCHE	1112 1111, 13 11					1	Sta	917+78			34' LT	W Balsam St
	SQ YD	LOCATION		<u>OFFSET</u>	REMARKS		1	Sta	918+00				W Balsam St
					*Urban		1	Sta	918+12			26' LT	W Balsam St
		<u>IL-26</u>					1	Sta	919+98			26' LT	Walnut St (median)
	345_	Sta 888+13	- 9	52+00 LT & RT	Per direction of RE		3	Sta	922+10			10' RT	E State St
_	345						1	Sta	926+08			27' RT	E Avon St
							1	Sta	926+15			18' RT	E Avon St
1201396	CLASS C PATCHE	S, TYPE IV, 13 INC	<u>:H</u>				3	Sta	926+42			33' RT	E Avon St
							1	Sta	930+81			30' RT	E Green St
	SQ YD	LOCATION		<u>OFFSET</u>	<u>REMARKS</u>		2	Sta	931+17			20' RT	E Green St
					*Urban		1	Sta	935+46			16' RT	E Logan St
	2.2	IL-26	~	000.05 65 1	Day Day in Al		1	Sta	935+89			18' RT	E Logan St
	33	Sta 897+22		898+05 SB Lane			28						
_	541 574	Sta 888+13	- 9	132+UU LI & RT	Per Direction of RE								
	5/4												
	USER NAME = Andrew.p.dr	ewey DESIGNED -		REVISED -			1						FΔP
	OSER NAME = Andrew.p.di	DESIGNED - DRAWN -		REVISED -		TE OF ILLINOIS	1	_	CHEDULE OF				F.A.P. SECTION COUN

STATE OF ILLINOIS

DEPARTMENT OF TRANSPORTATION

DRAWN

DATE

PLOT DATE = 1/24/2025

CHECKED -

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SCHEDULE OF QUANTITIES

TO STA.

SHEET OF SHEETS STA.

SCALE:

* (2,3,4,)RS-7 & 115SW OGLE 132 17

CONTRACT NO. 64P13

*316 & 549

56109210	WATER VALVES T	TO BE ADJUS	TED (Continued)			60255500	MANHOLES TO BE	ADJUSTED			
	<u>EACH</u>	LOCATION		OFFSET	<u>REMARKS</u>		<u>UNIT</u>	LOCATION		OFFSET	<u>REMARKS</u>
	1 1 2 1 1 1 2 3 3 3	Sta	369+16 369+20 369+40 369+93 371+87 373+33 373+87 376+28 380+52	28' RT	N Walnut Ave S Walnut Ave S Walnut Ave S Walnut Ave S Ash Ave N Chestnut Ave S Chestnut Ave S Oak Ave S Locust Ave		1 1 1 1 1 1 1 1 1 1	IL-26 Sta	890+78 894+47 899+05 899+05 903+68 903+67 908+31 913+00 913+00 913+32 919+76 921+31	18' LT 19' RT 18' LT 18' LT 19' LT 17' RT 18' RT 51' RT 32' RT	Meadow Ct - Sanitary E Willow St - Sanitary E Pine St - Sanitary W Pine St - Sanitary E Elm St - Sanitary W Elm St - Sanitary W Birch St - Sanitary W Cherry St - Sanitary E Cherry St - Sanitary W Cherry St - Sanitary W Cherry St - Storm Walnut St (median) - Unknown E State St - Storm
60252800	CATCH BASINS T	TO BE RECON	STRUCTED				1	Sta Sta	922+71 922+76	22' LT 19' LT	White Oak St - Unknown White Oak St - Sanitary
	EACH	LOCATION IL - 72		OFFSET	REMARKS		1 1 1	Sta Sta Sta	922+76 926+08 926+09 926+29	21' RT 19' LT 16' RT	E Avon St - Unknown W Avon St - Unknown E Avon St - Sanitary
	1	Sta	371+68	40' LT	NW Quandrant - Ash Ave		1 1	Sta Sta Sta	926+28 930+99 930+99	19' LT 19' RT	W Avon St - Sanitary E Green St - Sanitary W Green St - Sanitary
60260100	INLETS TO BE A	ADJUSTED					1	Sta	936+35	16' RT	E Logan St
	<u>EACH</u>	LOCATION IL - 26		OFFSET	REMARKS		2 2 2	Sta Sta Sta Sta	936+70 939+15 940+52 945+14		
	1 1 1	Sta Sta Sta Sta	903+43 903+46 903+90 903+96	24' LT 24' RT 24' LT 20' RT	Elm St		1 	Sta Sta Sta	947+81 950+00	14' LT	Pil Pkway - Sanitary Sanitary
	1 1 1 1 1 1 1 1 1	Sta Sta Sta Sta Sta Sta Sta	913+20 913+18 920+08 926+06 926+06 926+58 926+57	25' LT 25' RT 25' RT 26' LT 26' RT 21' RT 21' LT	Cherry St Walnut Ave (median) Avon St		1 1 1 1 1 1 1 1 1 1 8	Sta Sta Sta Sta Sta Sta Sta Sta	371+69 371+82 373+63 374+13 376+19 376+23 378+62 380+40	24' LT 30' LT 23' RT 29' LT 22' RT 25' LT 24' LT 26' LT	N Ash Ave - Storm N Ash Ave - Sanitary S Chestnut Ave - Storm N Chestnut Ave - Storm S Oak Ave - Storm N Oak Ave - Storm N Plum Ave - Storm N Locust Ave - Storm
	1 1 1	Sta Sta Sta Sta	371+68 373+72 378+22 380+30	40' LT 45' RT 44' RT 43' LT	Ash Ave Chestnut Ave Plum Ave Locust Ave		38				

USER NAME = Andrew.p.dewey	DESIGNED -	REVISED -
	DRAWN -	REVISED -
PLOT SCALE = \$SCALE\$	CHECKED -	REVISED -
PLOT DATE = 1/24/2025	DATE -	REVISED -

STATE OF ILLINOIS	
DEPARTMENT OF TRANSPORTAT	ΠOΝ

					F.A.P. RTE	SECTION	COUNTY	TOTAL SHEETS	SHEET NO.
	SCHEDULE	OF QUA	ANTITLES		*	(2,3,4,)RS-7 & 115SW	OGLE	132	18
						*316 & 549	CONTRAC	T NO. 64	₽13
SHEET	OF	SHEETS	STA.	TO STA.		ILLINOIS FED.	AID PROJECT		

	<u>FOOT</u>	LOCATION			<u>OFFSET</u>	REMARKS		<u>FOOT</u>	LOCATION			9	OFFSET	REMARKS
		<u>IL-26</u>							<u>IL-26</u>					*Recessed in 5" wide groo Refer to SOQ for quantit
	100	Willow S	t			ADA			<u>1L-20</u>					Yellow
	236	Pine St				ADA		662	Sta	893+53 -	920-	H00		Skip Dash
	210	Elm St				ADA		279	Sta	920+00 -				Skip Dash
	146	Birch St				ADA		298	Sta	931+17 -				Skip Dash/CL RT
	211	Cherry S				ADA		414	Sta	933+55 -				DBL CL
	176 192	E Main S Balsam S				ADA ADA		716 128	Sta	935+62 - 941+35 -	5 . 1			Skip Dash/CL LT
	172	Walnut A				ADA ADA		1,538	Sta Sta	941+35 -				Skip Dash Skip Dash/CL RT
	85	E State S				ADA		1,250	Sta	958+75 -				DBL Yellow CL
	90	White Oal				ADA		263	Sta	965+00 -				Skip Dash/CL LT
	237	Avon St				ADA		671	Sta	967+10 -				Skip Dash
	205	Green St				ADA		1,125	Sta	993+95 -				Skip Dash/CL RT
_	239	Logan St				ADA		3,704	Sta	1002+95 -				DBL CL
	2,299							1,391	Sta	1021+47 -				Skip Dash/CL LT
		<u>IL-72</u>						221	Sta	1032+60 -				Skip Dash
	229	Walnut A	ve			ADA		1,151	Sta	1041+44 -				Skip Dash/CL RT
	191 150	Ash Ave Chestnut	۸۷۸			ADA ADA		17 935	Sta Sta	1050+65 - 1051+32 -	140 CH-04-1006			Skip Dash Skip Dash/CL LT
	119	Oak Ave	AVE			ADA		274	Sta	1051+32 -				DBL CL
	301	Plum Ave				ADA		1,245	Sta	1050+65 -				Skip Dash/CL RT
	557	Locust A				ADA		3,682	Sta	1070+13 -				DBL CL
	24	Mastersoi				ADA		1,240	Sta	1088+54 -				Skip Dash/CL LT
-	1,571							335	Sta	1098+45 -				Skip Dash
	3,870							1,434	Sta	1111+87 -				Skip Dash/CL RT
	.20.202 - 20.200							860	Sta	1123+34 -				DBL CL
300100	SHORT TERM PAV	<u>'EMENT MARK</u>	CING					51	Sta	1105+57 -	1107	+61		Skip Dash
	FOOT	LOCATION			OFFSET	REMARKS		23,883						White
	1001	LOCATION			OITSLI	*3 appli	ions	576	Sta	913+00 -	921-	-50		Parking lines LT/RT
		IL-26				White	70113	4,596	Sta	936+02 -			12'	Edge Line LT/RT
	6,456	Sta	890+92 -	1127+64	CL	4' dash	skip	600	Sta	959+00 -			12'	Edge Line LT/RT
	86	Sta	956+80 -	959+68	12' RT	RT Turn	e	22,750	Sta	962+00 -			12'	Edge Line LT/RT
	56	Sta	1077+45 -	1079 + 30	12' LT	RT Turn		450	Sta	1075+75 -			12'	Edge Line LT/RT
						White D		9,928	Sta	1078+00 -	1127	+64	12'	Edge Line LT/RT
-	1,392	Sta	890+92 -	112/+64	LI & RI	4' diagn	200' skip	38,900						
	7,990								BAILEYVIL	LE RD				
300150	SHORT TERM PAV	EMENT MARK	KING REMOVAL						D/MILLIVIE					Yellow
								200	CL of Bai	ileyville Rd				DBL CL
	SQ FT	LOCATION			<u>OFFSET</u>	REMARKS								
						*3 appli	ions							White
	7.7	<u>IL-26</u>	000.00	1127.64	C.I.	White	3.2	160	RT Sta.	960+65			12' RT	Island Perimeter
	717 10	Sta Sta	890+92 - 956+80 -			4' dash RT Turn			FREEPORT	RD				
	6	Sta	956+80 - 1077+45 -		12' KT 12' LT	RT Turn RT Turn			INLLPUNI	NU				Yellow
	U	Jla	1011147 -	10/9730	ıc LI	White D		200	CL of Fre	eeport Rd				DBL CL
	155	Sta	890+92 -	1127+64	LT & RT	4' diagn		200						
_	887	Strong Factorial I				3.00								White
								150_	LT Sta.	1076+70			12' LT	Island Perimeter
00000	MODIFIES USES		THE MARKETS			21.6		710						
09000	MODIFIED URETH	IANE PAVEME	NI MARKING -	LETTERS	AND SYMBO	<u>DLS</u>		63,493						
	SQ FT	LOCATION			OFFSET	REMARKS								
	<u> </u>	LOCATION			OTTSET		n groove.							
							OQ for quantities.							
		IL-26				White	A SEC S S POSS CALLED ON SECURITY OF SECUR							
	15.6	Sta	956+67			RT Turn								
	15.6	Sta	957+53			RT Turn								
	15.6	Sta	958+40			RT Turn								
	15.6	Sta	959+27			RT Turn								
	57.6 15.6	Sta	1072+50			RR Cross								
	15.6 15.6	Sta	1077+85 1078+53			RT Turn RT Turn								
	15.6	Sta Sta	1078+53			RT Turn								
			1079+21			RT Turn								
	15 6	214												
	15.6 57.6	Sta Sta	1087+00			RR Cross								

STATE OF ILLINOIS

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TO STA.

SHEET OF SHEETS STA.

SCALE:

* (2,3,4,)RS-7 & 115SW OGLE 132 19

*316 & 549

549 CONTRACT NO. 64P13

ILLINOIS FED. AID PROJECT

	<u>FOOT</u>	LOCATION			OFFSET	REMARKS		<u>SQ FT</u>	LOCATION				OFFSET	
		<u>IL-26</u>				*Recessed in 7" wide groove. Refer to SOQ for quantities. White		16.8	<u>IL-26</u> Sta	956+67			1.	Whit e RT Turn Arrow
	64	Sta	907+35			Midblock Crossing		16.8	Sta	957+53				RT Turn Arrow
	307	Sta	916+00	09+17		Cross walks - IL26/IL72		16.8	Sta	958+40				RT Turn Arrow
	83 90	Sta Sta	917+50 920+00			Cross walks = W Balsam St Cross walks = S Walnut Ave		16.8 62.8	Sta Sta	959+27 1072+50				RT Turn Arrow RR Crossing Symbo
_	454	3 (320100			cross warks a swarmac Ave		16.8	Sta	1077+85				RT Turn Arrow
	5.00	<u>IL-72</u>	260.50			White		16.8	Sta	1078+53				RT Turn Arrow
	566 138	Sta Sta	369+50 371+75			S Walnut Ave Ash Ave		16.8 16.8	Sta Sta	1079+21 1079+90				RT Turn Arrow RT Turn Arrow
	244	Sta	373+90			Chestnut Ave		57.6	Sta	1087+00				RR Crossing Symb
	208	Sta	376+50			Oak		255						
	212 168	Sta Sta	378+50 380+50			Plum Locust	78100200	RAISED REFLECT	TIVE PAVEME	NT MARKER	R FMOV A	ı		
_	108	Sta	383+58			Midblock Crossing	70100200			. INT MARKET	NEMOVA	20.26		
_	1,644 2,098							EACH	LOCATION				OFFSET	<u>REMARKS</u>
									<u>IL-26</u>					
009008	MODIFIED URETH	HANE PAVEMEI	NT MARKING - L	LINE 8"				12	Sta Sta	955+00 1070+00		1+00 8+00		
	FOOT	LOCATION			OFFSET	REMARKS		73 85	3 L a	1070+00	112	0+00		
		<u>IL-26</u>				*Recessed in 9" wide groove. Refer to SOQ for quantities.	X7820007	GUARDRAIL REFL	ECTORS, TY	'PE C (SPE	CIAL)			
	300	Sta	956+47 -	959+47	12' RT	White RT Turn Lane - Baileyville Rd		<u>EACH</u>	LOCATION				OFFSET	<u>REMARKS</u>
	173	Sta	960+50		12' RT	Island - Bailryville Rd								100
	225	Sta Sta	1077+65 = 1076+50	1079+90	12' LT 12' LT	RT Turn Lane - Freeport Rd Island - Freeport Rd		6.0	<u>IL-26</u> Sta	1102.65	SS 111	0.15	LT C DT	Loof Divor Pris
					12 LI	island - Freepolt Ru		60	Sta	1102+65	111	0+15	LI & KI	Leaf River 🗷 Brid
_	127 825	3 C a	10/0150					60						
_		Sta	1070130				X2100104	60 GEOTECHNICAL F	RE I NFORCEME	<u>ENT</u> ,				
-	825			LINE 12			X2100104		REINFORCEME LOCATION	<u>ENT</u> :			OFFSET	<u>REMARKS</u>
_ 009012	825			LINE 12	<u></u>		X2100104	GEOTECHNICAL F		ENT.			<u>OFFSET</u>	<u>REMARKS</u>
009012	825			LINE 12	<u>"</u> <u>OFFSET</u>	<u>REMARKS</u>	X2100104	GEOTECHNICAL F	<u>LOCATION</u> <u>IL-26</u> Sta	897+22		3+05		Per David Alamy
009012	825	HANE PAVEMEI LOCATION		LINE 12		*Recessed in 13" wide groove.	X2100104	GEOTECHNICAL F SQ YD 33 197	LOCATION IL-26	В			OFFSET LT & RT	
009012	825	<u>HANE PAVEMEI</u>		LINE 12			X2100104	GEOTECHNICAL F	<u>LOCATION</u> <u>IL-26</u> Sta	897+22				Per David Alamy
009012	825 MODIFIED URETH FOOT 100	HANE PAVEMEI LOCATION IL-26 Sta	NT MARKING - L 907+35	LINE 12		*Recessed in 13" wide groove. Refer to SOQ for quantities. White Midblock Crossing	X2100104	GEOTECHNICAL F SQ YD 33 197	<u>LOCATION</u> <u>IL-26</u> Sta	897+22				Per David Alamy
009012	825 MODIFIED URETH FOOT 100 126	HANE PAVEMEI LOCATION JL-26 Sta Sta	NT MARKING - L 907+35 920+03	LINE 12	OFFSET	*Recessed in 13" wide groove. Refer to SOQ for quantities. White Midblock Crossing Walnut Median	X2100104	GEOTECHNICAL F SQ YD 33 197	<u>LOCATION</u> <u>IL-26</u> Sta	897+22				Per David Alamy
009012	825 MODIFIED URETH FOOT 100	HANE PAVEMEI LOCATION IL-26 Sta	NT MARKING - L 907+35	LINE 12		*Recessed in 13" wide groove. Refer to SOQ for quantities. White Midblock Crossing	X2100104	GEOTECHNICAL F SQ YD 33 197	<u>LOCATION</u> <u>IL-26</u> Sta	897+22				Per David Alamy
009012	825 MODIFIED URETH FOOT 100 126 75	HANE PAVEMEI LOCATION IL-26 Sta Sta Sta Sta	NT MARKING - L 907+35 920+03 960+65	LINE 12	OFFSET 12' RT	*Recessed in 13" wide groove. Refer to SOQ for quantities. White Midblock Crossing Walnut Median Island Diagonals	X2100104	GEOTECHNICAL F SQ YD 33 197	<u>LOCATION</u> <u>IL-26</u> Sta	897+22				Per David Alamy
_	825 MODIFIED URETH FOOT 100 126 75 75	HANE PAVEMEI LOCATION IL-26 Sta Sta Sta Sta Sta	907+35 920+03 960+65 1076+70		OFFSET 12' RT 12' LT	*Recessed in 13" wide groove. Refer to SOQ for quantities. White Midblock Crossing Walnut Median Island Diagonals	X2100104	GEOTECHNICAL F SQ YD 33 197	<u>LOCATION</u> <u>IL-26</u> Sta	897+22				Per David Alamy
_	825 MODIFIED URETH FOOT 100 126 75 75 75 376	HANE PAVEMEI LOCATION IL-26 Sta Sta Sta Sta Sta	907+35 920+03 960+65 1076+70		OFFSET 12' RT 12' LT	*Recessed in 13" wide groove. Refer to SOQ for quantities. White Midblock Crossing Walnut Median Island Diagonals Island Diagonals	X2100104	GEOTECHNICAL F SQ YD 33 197	<u>LOCATION</u> <u>IL-26</u> Sta	897+22				Per David Alamy
_	MODIFIED URETH FOOT 100 126 75 75 376 MODIFIED URETH	HANE PAVEMEI LOCATION IL-26 Sta Sta Sta Sta Sta Sta	907+35 920+03 960+65 1076+70		OFFSET 12' RT 12' LT	*Recessed in 13" wide groove. Refer to SOQ for quantities. White Midblock Crossing Walnut Median Island Diagonals Island Diagonals *REMARKS *Recessed in 25" wide groove. Refer to SOQ for quantities.	X2100104	GEOTECHNICAL F SQ YD 33 197	<u>LOCATION</u> <u>IL-26</u> Sta	897+22				Per David Alamy
_	MODIFIED URETH FOOT 100 126 75 75 376 MODIFIED URETH	HANE PAVEMENT LOCATION IL - 26 Sta Sta Sta Sta Sta Sta LOCATION	907+35 920+03 960+65 1076+70		OFFSET 12' RT 12' LT	*Recessed in 13" wide groove. Refer to SOQ for quantities. White Midblock Crossing Walnut Median Island Diagonals Island Diagonals Island Diagonals *REMARKS. *Recessed in 25" wide groove. Refer to SOQ for quantities. White	X2100104	GEOTECHNICAL F SQ YD 33 197	<u>LOCATION</u> <u>IL-26</u> Sta	897+22				Per David Alamy
_	825 MODIFIED URETH FOOT 100 126 75 75 376 MODIFIED URETH FOOT 12 12 12	HANE PAVEMENT LOCATION Sta Sta Sta Sta Sta Sta LOCATION LOCATION LOCATION LOCATION Sta Sta	907+35 920+03 960+65 1076+70 NT MARKING - L		OFFSET 12' RT 12' LT	*Recessed in 13" wide groove. Refer to SOQ for quantities. White Midblock Crossing Walnut Median Island Diagonals Island Diagonals Island Diagonals *Recessed in 25" wide groove. Refer to SOQ for quantities. White RR Symobol Stop Bar RR Symobol Stop Bar	X2100104	GEOTECHNICAL F SQ YD 33 197	<u>LOCATION</u> <u>IL-26</u> Sta	897+22				Per David Alamy
_	825 MODIFIED URETH FOOT 100 126 75 75 376 MODIFIED URETH FOOT 12 12 12 12 12	HANE PAVEME! LOCATION IL - 26 Sta Sta Sta Sta Sta HANE PAVEME! LOCATION IL - 26 Sta Sta Sta	907+35 920+03 960+65 1076+70 NT MARKING - L		OFFSET 12' RT 12' LT	*Recessed in 13" wide groove. Refer to SOQ for quantities. White Midblock Crossing Walnut Median Island Diagonals Island Diagonals *REMARKS *Recessed in 25" wide groove. Refer to SOQ for quantities. White RR Symobol Stop Bar RR Symobol Stop Bar RR Track Stop Bar	X2100104	GEOTECHNICAL F SQ YD 33 197	<u>LOCATION</u> <u>IL-26</u> Sta	897+22				Per David Alamy
_	825 MODIFIED URETH FOOT 100 126 75 75 376 MODIFIED URETH FOOT 12 12 12 12 12 12 12 12	HANE PAVEME! LOCATION IL - 26 Sta Sta Sta Sta HANE PAVEME! LOCATION IL - 26 Sta Sta Sta Sta	907+35 920+03 960+65 1076+70 NT MARKING - L 1072+23 1072+73 1079+08 1080+08		OFFSET 12' RT 12' LT	*Recessed in 13" wide groove. Refer to SOQ for quantities. White Midblock Crossing Walnut Median Island Diagonals Island Diagonals *Recessed in 25" wide groove. Refer to SOQ for quantities. White RR Symobol Stop Bar RR Symobol Stop Bar RR Track Stop Bar RR Track Stop Bar	X2100104	GEOTECHNICAL F SQ YD 33 197	<u>LOCATION</u> <u>IL-26</u> Sta	897+22				Per David Alamy
_	825 MODIFIED URETH FOOT 100 126 75 75 376 MODIFIED URETH FOOT 12 12 12 12 12	HANE PAVEMENT LOCATION IL - 26 Sta Sta Sta Sta HANE PAVEMENT LOCATION IL - 26 Sta Sta Sta Sta Sta Sta Sta Sta Sta St	907+35 920+03 960+65 1076+70 NT MARKING - L		OFFSET 12' RT 12' LT	*Recessed in 13" wide groove. Refer to SOQ for quantities. White Midblock Crossing Walnut Median Island Diagonals Island Diagonals *REMARKS *Recessed in 25" wide groove. Refer to SOQ for quantities. White RR Symobol Stop Bar RR Symobol Stop Bar RR Track Stop Bar	X2100104	GEOTECHNICAL F SQ YD 33 197	<u>LOCATION</u> <u>IL-26</u> Sta	897+22				Per David Alamy
_	825 MODIFIED URETH FOOT 100 126 75 75 376 MODIFIED URETH FOOT 12 12 12 12 12 12 12 12 12 12	HANE PAVEMENT LOCATION IL - 26 Sta Sta Sta Sta Sta HANE PAVEMENT LOCATION IL - 26 Sta Sta Sta Sta Sta Sta Sta Sta Sta St	907+35 920+03 960+65 1076+70 NT MARKING - L 1072+23 1072+73 1072+73 1079+08 1080+08 1086+44 1086+94		OFFSET 12' RT 12' LT	*Recessed in 13" wide groove. Refer to SOQ for quantities. White Midblock Crossing Walnut Median Island Diagonals Island Diagonals *Recessed in 25" wide groove. Refer to SOQ for quantities. White RR Symobol Stop Bar RR Track Stop Bar RR Track Stop Bar RR Symobol Stop Bar RR Symobol Stop Bar RR Symobol Stop Bar	X2100104	GEOTECHNICAL F SQ YD 33 197	<u>LOCATION</u> <u>IL-26</u> Sta	897+22				Per David Alamy
_	825 MODIFIED URETH FOOT 100 126 75 75 376 MODIFIED URETH FOOT 12 12 12 12 12 12 12 12 12 12 12 12 12	HANE PAVEMENT LOCATION IL - 26 Sta Sta Sta Sta Sta HANE PAVEMENT LOCATION IL - 26 Sta Sta Sta Sta Sta Sta Sta Sta Sta St	907+35 920+03 960+65 1076+70 NT MARKING - L 1072+23 1072+73 1072+73 1079+08 1080+08 1086+44 1086+94 LE RD leyville to the	LINE 24	OFFSET 12' RT 12' LT	*Recessed in 13" wide groove. Refer to SOQ for quantities. White Midblock Crossing Walnut Median Island Diagonals Island Diagonals Island Diagonals *Recessed in 25" wide groove. Refer to SOQ for quantities. White RR Symobol Stop Bar RR Track Stop Bar RR Track Stop Bar RR Symobol Stop Bar	X2100104	GEOTECHNICAL F SQ YD 33 197	<u>LOCATION</u> <u>IL-26</u> Sta	897+22				Per David Alamy
_	825 MODIFIED URETH FOOT 100 126 75 75 376 MODIFIED URETH FOOT 12 12 12 12 12 12 12 12 12	HANE PAVEMENT LOCATION IL - 26 Sta Sta Sta Sta Sta HANE PAVEMENT LOCATION IL - 26 Sta Sta Sta Sta Sta Sta Sta Sta Sta St	907+35 920+03 960+65 1076+70 NT MARKING - L 1072+23 1072+73 1072+73 1079+08 1080+08 1086+44 1086+94 LE RD leyville to the	LINE 24	OFFSET 12' RT 12' LT	*Recessed in 13" wide groove. Refer to SOQ for quantities. White Midblock Crossing Walnut Median Island Diagonals Island Diagonals Island Diagonals *Recessed in 25" wide groove. Refer to SOQ for quantities. White RR Symobol Stop Bar RR Track Stop Bar RR Track Stop Bar RR Track Stop Bar RR Symobol Stop Bar	X2100104	GEOTECHNICAL F SQ YD 33 197	<u>LOCATION</u> <u>IL-26</u> Sta	897+22				Per David Alamy
_	825 MODIFIED URETH FOOT 100 126 75 75 376 MODIFIED URETH FOOT 12 12 12 12 12 12 12 12 12 12 12 12 12	HANE PAVEMENT LOCATION IL - 26 Sta Sta Sta Sta Sta HANE PAVEMENT LOCATION IL - 26 Sta Sta Sta Sta Sta Sta Sta Sta Sta St	907+35 920+03 960+65 1076+70 NT MARKING - L 1072+23 1072+73 1079+08 1080+08 1086+44 1086+94 LE RD leyville to the	LINE 24	OFFSET 12' RT 12' LT	*Recessed in 13" wide groove. Refer to SOQ for quantities. White Midblock Crossing Walnut Median Island Diagonals Island Diagonals Island Diagonals *Recessed in 25" wide groove. Refer to SOQ for quantities. White RR Symobol Stop Bar RR Track Stop Bar RR Track Stop Bar RR Symobol Stop Bar	X2100104	GEOTECHNICAL F SQ YD 33 197	<u>LOCATION</u> <u>IL-26</u> Sta	897+22				Per David Alamy
_	825 MODIFIED URETH FOOT 100 126 75 75 376 MODIFIED URETH FOOT 12 12 12 12 12 12 12 12 12 12 12 12 12	HANE PAVEME! LOCATION IL - 26 Sta Sta Sta Sta HANE PAVEME! LOCATION IL - 26 Sta Sta Sta Sta Sta Sta Sta Sta Sta St	907+35 920+03 960+65 1076+70 NT MARKING - L 1072+23 1072+73 1079+08 1080+08 1086+44 1086+94 LE RD leyville to the ane	LINE 24 e Island	OFFSET 12' RT 12' LT	*Recessed in 13" wide groove. Refer to SOQ for quantities. White Midblock Crossing Walnut Median Island Diagonals Island Diagonals *Recessed in 25" wide groove. Refer to SOQ for quantities. White RR Symobol Stop Bar RR Symobol Stop Bar RR Track Stop Bar RR Track Stop Bar RR Symobol Stop Bar RR Symobol Stop Bar RR Track Stop Bar RR Symobol Stop Bar	X2100104	GEOTECHNICAL F SQ YD 33 197	<u>LOCATION</u> <u>IL-26</u> Sta	897+22				Per David Alamy

COUNTY	TOTAL	SHEET	NO.
NS-7 & 1155W	OGLE	132	20
& 549	CONTRACT	NO.	64P13
ILLINOIS	FED. AID	PROJECT	F.A.P. SECTION

* (2,3,4,)RS-7 & 1155W

*316 & 549

| ILLINOIS | FED. AII USER NAME = Andrew.p.dewey DESIGNED REVISED STATE OF ILLINOIS DRAWN REVISED SCHEDULE OF QUANTITIES PLOT SCALE = \$SCALE\$ CHECKED REVISED **DEPARTMENT OF TRANSPORTATION** SCALE: SHEET OF SHEETS STA. TO STA. PLOT DATE = 1/24/2025 DATE REVISED

HOT-MIX ASPHALT SCHEDULE

				40600295*	40604050**	40602965**	40604000**	40800050**	44000160	48102100	X4400196	40600370
				Polymerized		HMA Dindor Course	HMA	Incidental	Hot-Mix	Aggregate	HMA	Longitudinal
Location	Remarks	Mainline	Shlder	Bituminous Materials	Surface Course IL-9.5, MIX "C"	IL-9.5FG,	Surface Course IL-9.5FG, MIX "C"	Hot-Mix Asphalt	Asphalt Surface	Wedge shoulder,	Surface Removal,	Joint Sealant
Location	KellidTKS	Surface	Silider	(Tack Coat)	N50	N50	N50		Removal, 2.75"	111111111111111111111111111111111111111	Special	Searant
		SQ YD	SO YD	POUND	TON	TON	TON	TON	SQ YD	TON	SQ YD	FOOT
						1.49-770	A 300000					
I L - 26												
STA 888 + 13 - 913 + 00	Begin Project	8,014		7,212	685	685			8,014		553	2,487
STA 913 + 00 - 921 + 50	Parking Lanes	2,267	1,936	3,783	194	194	305		4,203		189	2,550
STA 921 + 50 - 935 + 70		4,576		4,118	391	391			4,576		316	1,420
STA 935 + 70 - 952 + 00		4,709	1,449	5,542	403	403	237	_	6,158		362	1,630
STA 952 + 00 - 955 + 70		1,069	288	1,221	92	92	47		1,357	41	82	370
STA 955 + 70 - 959 + 68	Turn-lane	1,061	265	1,194	91	91	44		1,327	44	88	796
STA 959 + 68 - 964 + 17		1,297	200	1,347	111	111	35		1,497	50	100	449
STA 964 + 17 - 993 + 17	Super	8,378	2,127	9,454	717	717	352		10,504	323	644	2,900
STA 993 + 17 - 1006 + 70		3,909	601	4,059	335	335	104		4,510	151	301	1,353
STA 1006 + 70 - 1011 + 83		1,482	513	1,796	127	127	83		1,995	57	114	513
STA 1011 + 83 - 1045 + 22		9,646	1,484	10,017	826	826	257		11,130	372	742	3,339
STA 1045 + 22 - 1049 + 80		1,323	458	1,603	113	113	74		1,781	51	102	458
STA 1049 + 80 - 1065 + 49		4,533	697	4,707	388	388	121		5,230	175	349	1,569
STA 1065 + 49 - 1075 + 35	Super	2,848	723	3,214	244	244	120		3,572	110	219	986
STA 1075 + 35 - 1076 + 90		448	69	465	38	38	12		517	17	34	155
STA 1076 + 90 - 1081 + 13		1,128	282	1,269	97	97	47		1,410	47	94	846
STA 1081 + 13 - 1082 + 29	Turn-lane	335	52	348	29	29	9		387	13	26	232
STA 1082 + 29 - 1093 + 78	Super	3,319	843	3,746	284	284	140		4,162	128	255	1,149
STA 1093 + 78 - 1105 + 57		3,406	524	3,537	292	292	91		3,930	131	262	1,179
STA 1105 + 57 - 1107 + 61	Paving Gap		53	48			9		53	4		
STA 1107 + 61 - 1127 + 64	End Project	5,786	890	6,009	495	495	154		6,677	223	445	2,003
SUB - TOTAL		69,533	13,454	74,688	5,952	5,952	2,242	-	82,987	1,937	5,277	26,384
GRAND TOTAL		75,197	13,454	79,338	5,952	5,952	2,242	872	88,651	1,937	5,277	27,343

JSER NAME = Andrew p.dewey DESIGNED -REVISED DRAWN REVISED CHECKED REVISED PLOT DATE = 1/24/2025 REVISED DATE

STATE OF ILLINOIS **DEPARTMENT OF TRANSPORTATION**

SECTION HOT-MIX ASPHALT SCHEDULE (2,3,4,)RS-7 & 115SW OGLE 132 21 *316 & 549 CONTRACT NO. 64P13 SHEET OF SHEETS STA. TO STA.

^{*} Polymerized Bituminous Materials (Tack Coat) Rate of Application = 0.05 Lb / Sq Ft on Existing HMA & Between Lifts ** Hot-Mix Asphalt Rate of Application = 112 Lbs / Sq Yd / in *** Quantities are Figured 6" Wider on Each Edge Side for Joint Trimming (Mainline HMA Surface, Binder, and Tack Coat)

HOT-MIX ASPHALT SCHEDULE

						40600295* Polymerized		40602965** HMA	40604000** HMA	40800050** Incidental	44000160 Hot-Mix	48102100 Aggregate	X4400196 HMA	40600370 Longitudinal
	Location	Domarks	Main	ıline	Chldor	Bituminous Materials	Surface Course IL-9.5, MIX "C"	Binder Course IL-9.5FG,	Surface Course IL-9.5FG, MIX "C"	Hot-Mix	Asphalt Surface	Wedge	Surface	Joint Sealant
	Location	Remarks	W. 15	face	Shlder	(Tack Coat)	N50	N50	N50	Asphalt	Removal, 2.75"	shoulder, Type B	Removal, Special	Searant
				YD	SQ YD	POUND	TON	TON	TON	TON	SQ YD	TON	SQ YD	FOOT
9	SIDE ROADS		LT	RT										
STA	894 + 40	Willow st	117	123		216				37	240			66
STA	899 + 06	Pine st	222	137		324				55	360			66
STA	903 + 70	Elm st	131	147		250				43	278			66
STA	908 + 32	Birch st	131			118				20	131			33
STA	912 + 97	Cherry St	112	186		268				46	298			66
STA	916 + 36	E Main St		67		60				10	67			33
STA	917 + 61	Balsam St	234			211				36	234			33
STA	921 + 51	S Walnut St		686		618				106	686			33
STA	921 + 61	E State St		190		171				29	190			33
STA	922 + 29	White Oak St	204			183				31	204			33
STA	926 + 29	Avon St	150	148		268				46	297			66
STA	931 + 01	Green St	130	133		237				40	263			66
STA	935 + 71	Logan St	169	119		259				44	288			66
STA	940 + 45	Spruce St		61		55				9	61			33
STA	945 + 15	Magnolia St	84			76				13	84			33
STA	947 + 80	Phil Pkwy	66			59				10	66			33
STA	960 + 45	Baileyville Rd		696		626				107	696			100
STA	1077 + 00	Freeport Rd	725			652				112	725			100
SUB - TO	TAL		2,474	2,692	î	4,650	E	-	1	796	5,166	E	-	959
	ENTRANCES		LT	RT										
STA	888 + 13	PE	31							5	31			
STA	889 + 07	CE		77						12	77			
STA	889 + 70	PE	36							5	36	-		
STA	889 + 80	PE		44						7	44			
STA	892 + 36	PE		63						10	63			
STA	951 + 60	CE		137						21	137			
STA	953 + 40	CE		109						17	109			
SUB - TO	TAL		67	431	=>	-	-	K=	-	77	498	-	-	-
GRAND -	TOTAL			75,197	13,454	79,338	5,952	5,952	2,242	872	88,651	1,937	5,277	27,343

^{*} Polymerized Bituminous Materials (Tack Coat) Rate of Application = 0.05 Lb / Sq Ft on Existing HMA & Between Lifts ** Hot-Mix Asphalt Rate of Application = 112 Lbs / Sq Yd / in *** Quantities are Figured 6" Wider on Each Edge Side for Joint Trimming (Mainline HMA Surface, Binder, and Tack Coat)

JSER NAME = Andrew p.dewey DESIGNED -REVISED DRAWN REVISED CHECKED REVISED PLOT DATE = 1/24/2025 REVISED DATE

STATE OF ILLINOIS **DEPARTMENT OF TRANSPORTATION**

SECTION HOT-MIX ASPHALT SCHEDULE (2,3,4,)RS-7 & 115SW OGLE 132 22 *316 & 549 CONTRACT NO. 64P13 SHEET OF SHEETS STA. TO STA.

						1	72000100	72000200	72400310	72400320	72400710	72400720	72800100	72800100	73000100	X7240505	
							SIGN PANEL	SIGN PANEL	REMOVE	REMOVE	RELOCATE	RELOCATE	TELESCOPING	TELESCOPING			
					Size	Size	TYPE 1	TYPE 2	SIGN PANEL	SIGN PANEL	SIGN PANEL	SIGN PANEL	STEEL SIGN	STEEL SIGN	WOOD SIGN	RELOCATE SIGN	
D 1000					Hor	Ver			Type 1	TYPE 2	TYPE I	TYPE 2	SUPPORT	SUPPORT	SUPPORT	PANEL & POST	
Mile	Station	Side	Common Name of Sign	Sign Code	(in)	(in)	(SQ FT)	(SQ FT)	(SQ FT)	(SQ FT)	(SQ FT)	(SQ FT)	(FOOT) (2 in)	(FOOT) (2 1/4 in)	(FOOT)	(EACH)	Notes
17.33	890+60	L,	Stop	R1-1	30	30	2.22		6.30								
			Stop	R1-1	36	36	9.00						9.0	5.0		-	
-	891+05		Charack Names Cierr Assembly	-					-							1.0	
	891+05	L	Street Name Sign Assembly													1.0	
17.35	891+50	R	No Passing Zone	W14-3	64	48						10.70	_		16.0	-	Replace post
17.33	831130	I I	NOT assing Zone	WITS	04	40						10.70			10.0		Replace post
17.39	893+50	L	Speed Limit 35	R2-1	30	36	-				7.50		11.0	5.0			
17.39	893+50	R	Speed Limit 30	R2-1	30	36					7.50		11.0	5.0			
	2																
17.40	894+25	L	Stop	R1-1	36	36					9.00		11.0	5.0			
	894+69	L	Street Name Sign Assembly										_			1.0	
			27	15.00													
17.49	898+85	L	Stop	R1-1	36	36	9.00						11.0	5.0		-	
	000.75		Ci I N C' A I I I	<u> </u>									_			1.0	
	898+75	L	Street Name Sign Assembly													1.0	
17.49	898+88	1	Stop	R1-1	30	30			6.30							+	
17.45	030700	L	σιομ	NI-I	30	30			0.30							+	
17.50	899+26	R	Stop	R1-1	30	30			6.30				_				
			Stop	R1-1	36	36	9.00						9.0	5.0			
	·																
17.53	900+73	R	Speed Limit 30	R2-1	30	36			7.50								Remove sign and post
			·														
	903+37	L	Street Name Sign Assembly													1.0	
17.58	903+47	L	Stop	R1-1	36	36	9.00						9.0	5.0			
17.58	903+50	L	Stop	R1-1	30	30			6.30								
		_				1-77-11											
17.58	903+92	R	Stop	R1-1	30	30	2.22		6.30				0.0	F.0			
			Stop	R1-1	36	36	9.00						9.0	5.0			
17.59	904+10	R	School Speed Limit 20	S4-I100	24	48	8.00		8.00				_		17.0		
17.55	304+10	IX	Fine Higher	R2-6P	24	18	3.00		3.00						17.0	-	
			Time riigher	112 01	2.7	10	3.00		3.00								
	908+05	L	Street Name Sign Assembly													1.0	
			,										_				
17.67	908+15	L	Stop	R1-1	30	30			6.30								
			Stop	R1-1	36	36	9.00						9.0	5.0			
			No parking on Sunday	R8-Spl	12	18			1.50								Cannot have below Stop sign
17.73	911+30	L	School	S1-1	36	36	9.00		9.00				12.0	5.0			
			Ahead	W16-9P	24	12	2.00		2.00								
3	045		6 11: ***	Do :		2.5			7.50								
17.75	912+55	L	Speed Limit 30	R2-1	30	36			7.50				_			-	Remove sign and post
	012.71	1	Stroot Nama Sign ALi.													1.0	
	912+71	L	Street Name Sign Assembly							+				+		1.0	
17.76	912+75	L	Stop	R1-1	30	30			6.30							+	
17.70	9127/3	-	σιορ	1/1-1	30	30			0.30							+	Bolt to power pole, offset away from
			Stop	R1-1	36	36	9.00										road
				112.2		33	3.00			1				1		+	1000
17.76	913+18	R	Stop	R1-1	30	30			6.30							+	
					ıbtotal		85.00	0.00	88.90	0.00	24.00	10.70	101.00	50.00	33.00	6.00	
							The state of the s		1	I.				The state of the s	CONCORD.	1	

USER NAME = Andrew.p.dewey	DESIGNED -	REVISED -
	DRAWN -	REVISED -
PLOT SCALE = \$SCALE\$	CHECKED -	REVISED -
PLOT DATE = 1/24/2025	DATE	REVISED

STATE 0	F ILLINOIS
DEPARTMENT OF	TRANSPORTATION

		01011		=		F.A.P. RTE	SECTION	COUNTY	TOTAL SHEETS	SHEET NO.
		SIGN	SCHED	ULE		*	(2,3,4,)RS-7 & 115SW	OGLE	132	23
							*316 & 549	CONTRACT	NO. 64	₽13
SCALE:	SHEET	OF	SHEETS	STA.	TO STA.		ILLINOIS FED. A	ID PROJECT		

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	ans/Design/CADD/CADsheets/D2_64P13-sht-schedule.dgn	
	Development/Studies & Pla	
	Projects/64P13/Program	
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				<u> </u>			72000100 SIGN PANEL	72000200 SIGN PANEL	72400310 REMOVE	72400320 REMOVE	72400710 RELOCATE	72400720 RELOCATE	72800100 TELESCOPING	72800100 TELESCOPING	73000100	X7240505	
					Size Hor	Size Ver	TYPE 1	TYPE 2	SIGN PANEL Type 1	SIGN PANEL TYPE 2	SIGN PANEL TYPE I	SIGN PANEL TYPE 2	STEEL SIGN SUPPORT	STEEL SIGN SUPPORT	WOOD SIGN SUPPORT	RELOCATE SIGN PANEL & POST	
Mile	Station	Side	Common Name of Sign	Sign Code	(in)	(in)	(SQ FT)	(SQ FT)	(SQ FT)	(SQ FT)	(SQ FT)	(SQ FT)	(FOOT) (2 in)	(FOOT) (2 1/4 in)	(FOOT)	(EACH)	Notes
			Stop	R1-1	36	36	9.00						_				Move closer to crosswalk. Need t core
17.79	914+78	1	Speed Limit 30	R2-1	30	36	7.50						_				Band to light pole
17.75	311170		Speed Elline 30				7.00									 	Bana to light pole
			^ Shannon														
			^ Freeport														
17.80	915+00	R	Byron>	D1-3	48	30		10.00							14.0		Need to core
47.00	045.00		0 11 (11)										44.0				No.
17.82	915+80	L	South (white) Illinois 26	M3-3 M1-I100	24 24	12 24					2.00 4.00		11.0	3.0			Need to core
			IIIInois 26	IVI1-I100	24	24					4.00					 	
17.82	916+00	R	West (white)	M3-4	24	12	2.00								16.0		Core/sleeve 10" hole
			East (white)	M3-2	24	12	2.00										,
			Illinois Route 72	M1-I100	24	24	4.00										
			Illinois Route 72	M1-I100	24	24	4.00										
			Straight up arrow (white)	M6-3	21	15	2.20										
			Right turn arrow (white)	M5-1R	21	15	2.20										
17.82	916+80	R	Stop	R1-1	36	36	9.00		9.00				11.0	3.0			Need to Core / sleeve
17.02	910+00	N	Stop	V1-1	30	30	9.00		9.00				11.0	5.0			Need to core / sieeve
17.83	916+90	R	West (white)	M3-4	24	12			2.00								
			East (white)	M3-2	24	12			2.00								
			Illinois Route 72	M1-I100	24	24			4.00								
			Illinois Route 72	M1-I100	24	24			4.00								
			Straight up arrow (white)	M6-3	21	15			2.20								
			Right turn arrow (white)	M5-1R	21	15	and the state of		2.20								
			Stop Ahead	W3-1	36	36	9.00										
17.84	917+37	L	Stop	R1-1	30	30			6.30							_	
17.04	31/13/		Stop	R1-1	36	36	9.00		0.50				11.0	3.0			Core hole
			3.00				0.00						1110	5.0			33/2 110/2
17.85	917+90	R	North (white)	M3-4	24	12	2.00								16.0		Core 10" hole
			West (white)	M3-2	24	12	2.00										
			Illinois Route 26	M1-I100	24	24	4.00										
			Illinois Route 72	M1-I100	24	24	4.00										
			Advance Left Angle turn (white)	M5-2L	21	15	2.20										
17.87	918+95	R	North (white)	M3-4	24	12	2.00			ř					16.0		Core 10" hole
17.07	310133	13	West (white)	M3-2	24	12	2.00						_		10.0		Core to note
			Illinois Route 26	M1-I100	24	24	4.00										
			Illinois Route 72	M1-I100	24	24	4.00										
			diagonal left arrow (white)	M6-2L	21	15	2.20										
17.89	919+90	R	Stop	R1-1	36	36	2.00				9.00		12.0	3.0			
			Stop at Line	R10-I100	30	18	3.80									+	
	920+20	R	Illinois 72	M1-I100	24	24					4.00		11.0	3.0		+	
	323.20	.,	Illinois 26	M1-I100	24	24					4.00		22.0	3.0			
			straight up arrow (white)	M6-3	21	15					2.20						
			diagonal right arrow (white)	M6-2R	21	15					2.20						
	100 10000	No.			WASTER?						50. 9. 9						
17.90	920+42	L	South (white)	M3-3	24	12					2.00		_				move 1 light pole north
			Illinois 26	M1-I100	24	24					4.00					+	
17.92	922+00	R	Stop	R1-1	30	30			6.30							+	
11.32	322100	IX	Stop	R1-1	36	36	9.00		0.50				12.0	5.0			
			Stop at Line	R10-I100	30	18	3.80						12.0	5.0		1	
			**************************************		btotal		104.90	10.00	38.00	0.00	33.40	0.00	68.00	20.00	62.00	0.00	

USER NAME = Andrew p.dewey	DESIGNED -	REVISED -
	DRAWN -	REVISED -
PLOT SCALE = \$SCALE\$	CHECKED -	REVISED -
PLOT DATE = 1/24/2025	DATE -	REVISED -

STATE OF ILLINOIS
DEPARTMENT OF TRANSPORTATION

		0101				F.A.P. RTE	SECTION	COUNTY	TOTAL SHEETS	SHEET NO.
		SIGN	I SCHED	ULE		*	(2,3,4,)RS-7 & 115SW	OGLE	132	24
							*316 & 549	CONTRACT	NO. 64	4P13
SCALE:	SHEET	OF SHEETS STA.			TO STA.		ILLINOIS FED. A	AID PROJECT		

	,				4		72000100	72000200	72400310	72400320	72400710	72400720	72800100	72800100	73000100	X7240505	
Mile	Station	Side	Common Name of Sign	Sign Code	Size Hor (in)	Size Ver (in)	SIGN PANEL TYPE 1 (SQ FT)	SIGN PANEL TYPE 2 (SQ FT)	REMOVE SIGN PANEL Type 1 (SQ FT)	REMOVE SIGN PANEL TYPE 2 (SQ FT)	RELOCATE SIGN PANEL TYPE I (SQ FT)	RELOCATE SIGN PANEL TYPE 2 (SQ FT)	TELESCOPING STEEL SIGN SUPPORT (FOOT) (2 in)	TELESCOPING STEEL SIGN SUPPORT (FOOT) (2 1/4 in)	WOOD SIGN SUPPORT (FOOT)	RELOCATE SIGN PANEL & POST (EACH)	Notes
17.94	922+20	L	Stop	R1-1	30	30			6.30								
17.54	922+20		Stop	R1-1	36	36	9.00		0.30				11.0	3.0			
			0.00	1,12.2	- 50	30	3.00							3.0			
17.94	922+20	R	North (white)	M3-1	24	12	2.00								15.0		
			West (white)	M3-4	24	12	2.00										
			Illinois 26	M1-I100	24	24	4.00										
			Illinois 72	M1-I100	24	24	4.00										
17.00	022.25	D.	C	D2 1	20	26					7.50		11.0	2.0			
17.96	923+35	R	Speed Limit 30	R2-1	30	36				-	7.50		11.0	3.0			
17.98	924+10	R	Warnken Park	DSPC	24	18			3.00								Remove sign and post
17,100	321110		Right arrow (brown)	M6-1R	21	15			2.20								Hemove sign and post
			, and the same of										_				
18.01	926+10	L	Stop	R1-1	30	30			6.30								
			Stop	R1-1	36	36	9.00						11.0	3.0			
				202										760 700			
18.01	926+50	R	Stop	R1-1	36	36					9.00		11.0	3.0		-	
18.06	929+15	1	Warnken Park	DSPC	24	18			3.00							-	Pomovo sign and nest
18.00	929+13	L	Left arrow (brown)	M6-1L	21	15			2.20								Remove sign and post
			Left affow (blown)	IVIO-1L	21	15			2.20								
18.10	930+77	L	Stop	R1-1	36	36					9.00		11.0	5.0			Replace post
18.10	931+17	R	Stop	R1-1	36	36					9.00		11.0	5.0			Install in front of power pole
	931+25	L	Street Name Sign Assembly													1.0	
			·														
18.11	931+35	L	No Passing Zone	W14-3	48	36	6.00		6.00				12.0	5.0			
	935+72	L	Street Name Sign Assembly													1.0	
18.19	935+50	L	Stop	R1-1	36	36					9.00		11.0	5.0		-	Replace post
18.19	933+30		stop	KT-T	30	30					9.00		11.0	3.0			Replace post
18.19	935+95	R	Stop	R1-1	30	30			6.30				_				
			Stop	R1-1	36	36	9.00						11.0	3.0			
18.19	935+95	R	Speed Limit 35	R2-1	30	36					7.50		11.0	5.0			in front of power pole
													_				
18.29	940+65	R	Stop	R1-1	30	30	0.00		6.30				11.0	2.0		+	
			Stop	R1-1	36	36	9.00						11.0	3.0		+	
18.30	941+55	L	Speed Limit 35	R2-1	30	36					7.50		11.0	5.0			Replace post
18.30	941+55	R	Speed Limit 40	R2-1	30	36	7.50		7.50						14.0	+	Move 2 feet further from road
10.00	3,1,55		No passing zone	W14-3	64	48	,,,,,,	10.70		10.70			_		24.0	<u> </u>	, see E rece, and or from road
			. 3	manaCiri Nili Wi	30.5	200											
18.37	945+00	L	Stop	R1-1	36	36					9.00		11.0	5.0			
18.40	946+65	L	No passing zone	W14-3	64	48		10.70		10.70					14.0		
18.42	947+67	L	Stop	R1-1	36	36					9.00		11.0	5.0			Replace post
40 -	050			2-1	gre				-	-							
18.51	952+60	R	Speed Limit 55	R2-1	30	36	7.50		7.50				10.0	5.0		+	

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STATE (OF ILLINOIS
DEPARTMENT O	TRANSPORTATION

		01011				F.A.P. RTE	SECTION	COUNTY	TOTAL SHEETS	SHEET NO.
		SIGN	SCHED	ULE		*	(2,3,4,)RS-7 & 115SW	OGLE	132	25
							*316 & 549	CONTRACT	NO. 64	₽13
SCALE:	SHEET OF SHEETS STA. TO STA.						ILLINOIS FED. A	AID PROJECT		

					ı		72000100	72000200	72400310	72400320	72400710	72400720	72800100	72800100	73000100	X7240505	
							SIGN PANEL	SIGN PANEL	REMOVE	REMOVE	RELOCATE	RELOCATE	TELESCOPING	TELESCOPING			
					Size	Size	TYPE 1	TYPE 2	SIGN PANEL	SIGN PANEL	SIGN PANEL	SIGN PANEL	STEEL SIGN	STEEL SIGN	WOOD SIGN	RELOCATE SIGN	
n a:1	C1 11	6:1	6.00	6: 6 1	Hor	Ver	(CO FT)	(CO FT)	Type 1	TYPE 2	TYPE I	TYPE 2	SUPPORT	SUPPORT	SUPPORT	PANEL & POST	
Mile	Station	Side	Common Name of Sign	Sign Code	(in)	(in)	(SQ FT)	(SQ FT)	(SQ FT)	(SQ FT)	(SQ FT)	(SQ FT)	(FOOT) (2 in)	(FOOT) (2 1/4 in)	(FOOT)	(EACH)	Notes
18.51	952+60	L	Speed Limit 40	R2-1	30	36	7.50		7.50	10.00			9.0	5.0			
			Forreston 1400	11-1100	48	30				10.00			_				
18.54	954+35	R	Right side road	W2-2R	36	36	9.00		9.00						16.0		
10.0	331133		Baileyville Road	W16-8P	36	15			3.80								
			Baileyville Rd	W16-8P	42	9	2.60										-
18.55	954+60	L	Excessive Engine Braking Prohibited	R5-I106	30	36					7.50		11.0	5.0			
18.59	956+67	L	Forreston 1400	11-1100	48	24	8.00						24.0	10.0		+	Set at a 7.5 foot bottom
10.55	930107	L	Porreston 1400	11-1100	40	24	8.00						24.0	10.0			Set at a 7.5 foot bottom
18.63	958+60	L	Speed Zone Ahead 40	W3-5	36	36	9.00								15.0		
							_		_								
18.63	959+30	L	South (white)	M3-3	24	12					2.00				14.0		side by side
			East (white)	M3-2	24	12					2.00						
			Illinois 26	M1-I100	24	24					4.00 4.00		_			+	
			Illinois 72	M1-I100	24	24					4.00		_			+	
18.66	961+05	R	Stop	R1-1	36	36					9.00		9.0	5.0		<u> </u>	
			Do Not Enter	R5-1	36	36					9.00						
																	55 80 0 0
18.68	961+65	L	North (white)	M3-1	24	12					2.00				15.0		side by side
			West (white)	M3-4	24	12					2.00						
			Illinois 26	M1-I100	24	24					4.00						
			Illinois 72	M1-I100	24	24					4.00		_				
18.67	962+50	L	Speed Zone Ahead 40	W3-5	36	36	-		9.00								Remove sign and post
18.78	966+90	L	Left side road	W2-2L	36	36	9.00								16.0		
			Baileyville Rd	W16-8P	42	9	2.60										
18.79	967+51	L	Left side road	W2-2L	36	36			9.00								Remove signs and post
10.75	307.31		Baileyville Road	W16-8P	36	15			3.80								Nemeve signs and post
			,														
			Shannon 10														
18.79	967+25	R	Freeport 14	D2-2	60	30		12.50		12.50			22.0	10.0			
	,		No passing zone	W14-3	64	48		10.70		10.70							
10.00	978+40	R	26 / Ogle / 19 mile marker	M1-I200	18	18					2.30		9.0	5.0			
19.00	3/0+40	ų	26 / Ogle / 19 mile marker	M1-I200	18	18			-		2.30		9.0	3.0			
			20 / Ogie / 15 Illile Illaikei	1417-1200	10	10					2.30						
19.30	994+10	L	No passing zone	W14-3	64	48		10.70		10.70							
20.00	1031+20	R	26 / Ogle / 20 mile marker	M1-I200	18	18					2.30		9.0	5.0			
			26 / Ogle / 20 mile marker	M1-I200	18	18					2.30		_			+	
	1031+95	R	No passing zone	W14-3	64	48		10.70		10.70			1		16.0	+	
		(C) (C)															
	1041+47	L	No passing zone	W14-3	64	48		10.70		10.70					16.0		
	1050.07	1	No	14/4 4 2		40				10.70							
	1058+87	L	No passing zone	W14-3	64	48				10.70						+	
	1060+16	R	No passing zone	W14-3	64	48		10.70		10.70			 		16.0	+	
			Curve Right	W1-2R	36	36			9.00	200000 CO					_		
	1063+50	R	Curve Right	W1-2R	36	36	9.00	policie wear-	Section 1 Sections	ALTERIO ATT	Politica Maria	900 2000	D. MANAGO 100 mm = 1	Sandada sanagara	16.0	AND THE PARTY	
				Su	btotal		56.70	66.00	51.10	86.70	58.70	0.00	93.00	45.00	140.00	0.00	

USER NAME = Andrew p.dewey	DESIGNED -	REVISED -
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		01011				F.A.P. RTE	SECT	ION	COUNTY	TOTAL SHEETS	SHEET NO.
		SIGN	SCHED	ULE		*	(2,3,4,)RS-7	' & 115SW	OGLE	132	26
							*316 & 54	19	CONTRACT	NO. 64	P13
SCALE:	SHEET OF SHEETS STA. TO STA.							ILLINOIS FED. AI	D PROJECT		

							72000100	72000200	72400310	72400320	72400710	72400720	72800100	72800100	73000100	X7240505	
					Size	Size	SIGN PANEL TYPE 1	SIGN PANEL TYPE 2	REMOVE SIGN PANEL	REMOVE SIGN PANEL	RELOCATE SIGN PANEL	RELOCATE SIGN PANEL	TELESCOPING STEEL SIGN	TELESCOPING STEEL SIGN	WOOD SIGN	RELOCATE SIGN	
Mile	Station	Side	Common Name of Sign	Sign Code	Hor (in)	Ver (in)	(SQ FT)	(SQ FT)	Type 1 (SQ FT)	TYPE 2 (SQ FT)	TYPE I (SQ FT)	TYPE 2 (SQ FT)	SUPPORT (FOOT) (2 in)	SUPPORT (FOOT) (2 1/4 in)	SUPPORT (FOOT)	PANEL & POST (EACH)	Notes
TVIIIC		Side	_		(,		(34,1)	(54,1)		(52.17	(54.1)	(34,11)	(1001)(211)	(1001) (21) 111)	(1001)	(2,10,1)	notes
	1070+05	R	Left side road	W2-2L	36	36			9.00				_				Remove signs and post
		-	Freeport Rd	W16-8P	36	9			2.30								
	1070+42	R	Left side road	W2-2L	36	36	9.00									_	
	1070112		Freeport Rd	W16-8P	36	9	2.30										
			·														
	1072+68	R	Railroad advance warning	W10-1	36	36					9.00				15.0		
	1075 . 02		C Pill	14/1 2D	26	26			0.00								
	1075+02	R	Curve Right	W1-2R	36	36			9.00								Remove sign and post
-	1075+70	L	South (white)	M3-3	24	12					2.00				15.0		
		- 1	East (white)	M3-2	24	12					2.00						
			Illinois 26	M1-I100	24	24					4.00						
			Illinois 72	M1-I100	24	24					4.00						
	4676		5 7	D4 1	2.0	26	2.22		0.05				10.0	F 0			
	1076+36	L	Stop Do Not Enter	R1-1 R5-1	36 36	36 36	9.00		9.00	-		-	10.0	5.0		-	
		+ +	DO NOT ENTER	η-1	30	30	5.00		9.00							+	
	1076+66	L	Stop	R1-1	36	36	9.00		9.00								
			-						000 000000								
	1076+90	R	Large Two headed arrow	W1-7	60	30		12.50		12.50					28.0		
			26 / Ogle / 21 mile marker	M1-I200	18	18			2.30								
		-	26 / Ogle / 21 mile marker	M1-I200	18	18			2.30				_				
	1078+00	L	Curve Left	W1-2L	36	36	9.00								16.0		
	1070100		curve Left	VV I-ZL	30	30	3.00								10.0		
	1080+30	R	Curve Right	W1-2R	36	36	9.00								16.0		
	1081+49	L	Curve Left	W1-2L	36	36			9.00								Remove sign and post
	1083+51	L	Right side road	W2-2R	36	36					9.00				16.0		
	1085+51	L	Freeport Rd	W16-8P	36	9	2.30				9.00				16.0		
			ricoportina	1125 6.	"		2.00										
	1084+00	R	26 / Ogle / 21 mile marker	M1-I200	18	18	2.30						9.0	5.0			
			26 / Ogle / 21 mile marker	M1-I200	18	18	2.30										
			2			-											
	1084+98	L	Freeport Rd	W16-8P	36	9			2.30								
	1086+43	L	Railroad advance warning	W10-1	36	36					9.00				15.0		
																	-
	1095+78	L	Curve Left	W1-2L	36	36	9.00								16.0		
	1098+35	R	No passing zone	W14-3	64	48	·			10.70			_				
	1099+72	L	Curve Left	W1-2L	36	36			9.00			-	_			-	Remove sign and post
	1033+72	-	Cuive Leit	AA T-7 L	30	30			5.00								Memore sign and post
	1098+34	R	No passing Zone	W14-3	64	48		10.70		10.70					16.0		
	1111+84	L	No passing Zone	W14-3	64	48						10.70			16.0		Replace post
	1121		Ante a Letteral	140 -		4.5	2.22								10.5		
	1121+64	R	West (white) North (white)	M3-2 M3-4	24 24	12 12	2.00		 	-		-	_		16.0	 	
		++	Illinois Route 72	M1-I100	24	24	4.00						_				
			Illinois Route 26	M1-I100	24	24	4.00										
					btotal		84.20	23.20	72.20	33.90	39.00	10.70	19.00	10.00	185.00	0.00	

USER NAME = Andrew p.dewey	DESIGNED -	REVISED -
	DRAWN -	REVISED -
PLOT SCALE = \$SCALE\$	CHECKED -	REVISED -
PLOT DATE = 1/24/2025	DATE -	REVISED -


STATE 0	F ILLINOIS
DEPARTMENT OF	TRANSPORTATION


		0101		F.A.P. RTE	SECTION	COUNTY	TOTAL SHEETS	SHEET NO.			
SIGN SCHEDULE						*	(2,3,4,)RS-7 & 115SW	OGLE	132	24	
				*316 & 549 CONTRACT NO. 64P							
SCALE:	SHEET	OF	SHEETS	STA.	TO STA.		ILLINOIS FED. AID PROJECT				


							72000100	72000200	72400310	72400320	72400710	72400720	72800100	72800100	73000100	X7240505	
							SIGN PANEL	SIGN PANEL	REMOVE	REMOVE	RELOCATE	RELOCATE	TELESCOPING	TELESCOPING			
					Size	Size	TYPE 1	TYPE 2	SIGN PANEL	SIGN PANEL	SIGN PANEL	SIGN PANEL	STEEL SIGN	STEEL SIGN	WOOD SIGN	RELOCATE SIGN	
					Hor	Ver			Type 1	TYPE 2	TYPE I	TYPE 2	SUPPORT	SUPPORT	SUPPORT	PANEL & POST	
Mile	Station	Side	Common Name of Sign	Sign Code	(in)	(in)	(SQ FT)	(SQ FT)	(SQ FT)	(SQ FT)	(SQ FT)	(SQ FT)	(FOOT) (2 in)	(FOOT) (2 1/4 in)	(FOOT)	(EACH)	Notes
			Advance left turn arrow (white)	M5-1L	21	15	2.20	(- 52 57	(= -, -)		(==,:)	(==,::/	(, , , , , , , , , , , , , , , , , , ,	(*) = = + / (= = / + :)	((======================================	
			straight up arrow (white)	M6-3	21	15	2.20										
			Forreston 4														
	1123+38	L	Dixon 27	D2-2	60	30		12.50		12.50							
	1123+45	R	West (white)	M3-2	24	12			2.00								
			North (white)	M3-4	24	12			2.00								
			Illinois Route 72	M1-I100	24	24			4.00								
			Illinois Route 26	M1-I100	24	24			4.00								
			Advance left turn arrow (white)	M5-1L	21	15			2.20								
			straight up arrow (white)	M6-3	21	15			2.20								
		\perp															
			^ Freeport														
	1124+64	R	< Shannon	D1-2	60	30		12.50					22.0	10.0			
		\perp															
			^ Freeport			175											
	1125+45	R	< Shannon	D1-2	60	30				12.50							
	LONG TOWNS IN A TOWN IN		1000										_				
	1125+50	L	Speed Limit 55	R2-1	30	36	7.50						_		14.0		
	4407.64				-						2.00						
	1127+64	R	West (white)	M3-2	24	12					2.00		_		16.0		
			North (white)	M3-4	24	12					2.00					_	
			Illinois Route 72	M1-I100	24	24					4.00						
			Illinois Route 26	M1-I100	24	24					4.00						
			Left turn arrow (white)	M6-1L	21	15					2.30						
	-	-	straight up arrow (white)	M6-3	21	15					2.30						
	1127+64		South (white)	M3-3	24	12					2.00				15.0		
	1127+04	L	East (white)	M3-2	24	12					2.00				13.0		
			Illinois 26	M1-I100	24	24					4.00		-				
	+		Illinois 72	M1-I100	24	24					4.00		-			-	
			IIIIIIOIS 72	WIT-IIOO	27	24	-				4.00						
	7			Su	btotal		11.90	25.00	16.40	25.00	28.60	0.00	22.00	10.00	45.00	0.00	
Illingia	Poute 72			34			11.50	25.00	25.40	23.00	20.00	5.55	22.00	10.00	-3.00	5.00	
	Route 72				1200-0											-	
7.29	369+10	L	Stop Ahead	W3-1	36	36	9.00		9.00				12.0	3.0		-	Need to core / return base to IDOT
4122	200 22																
7.29	369+90	R	Stop	R1-1	30	30			6.30								
		-	Stop	R1-1	36	36	9.00						11.0	3.0			Need to core
7.00	274 65	. .		Dr. 1		2.0	-									+	
7.33	371+65	L	Stop	R1-1	30	30	0.00		6.30				12.0	F 0		+	
		+	Stop	R1-1	36	36	9.00		6.30				12.0	5.0		-	
		+ +	Do Not Enter	R5-1	30	30	0.00		0.30					+		+	
		+ +	Do Not Enter	R5-1	36	36	9.00							+		-	
7.41	376+19	L	Stop	R1-1	36	36					9.00		11.0	5.0		+	
7.41	3/0+13	-	σιορ	W1-1	30	30					5.00		11.0	5.0		+	
	380+95	R	Street Name Sign Assembly	+					 				_			1.0	
	300+33	IX	Street Marile Sign Assembly				-									1.0	
		+ +		Çı	ıbtotal		36.00	0.00	27.90	0.00	9.00	0.00	46.00	16.00	0.00	1.00	
					Total		447.70	145.60	351.10	167.00	269.20	21.40	514.00	214.00	508.00	9.00	


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	DRAWN -	REVISED -
PLOT SCALE = \$SCALE\$	CHECKED -	REVISED -
PLOT DATE = 1/24/2025	DATE -	REVISED -


		21211		F.A.P. RTE	SECTION	COUNTY	TOTAL SHEETS	SHEET NO.		
SIGN SCHEDULE							(2,3,4,)RS-7 & 115SW	OGLE	132	28
							*316 & 549	CONTRACT	NO. 64	IP13
CALE:	SHEET	OF	SHEETS	STA.	TO STA.	ILLINOIS FED. AID PROJECT				

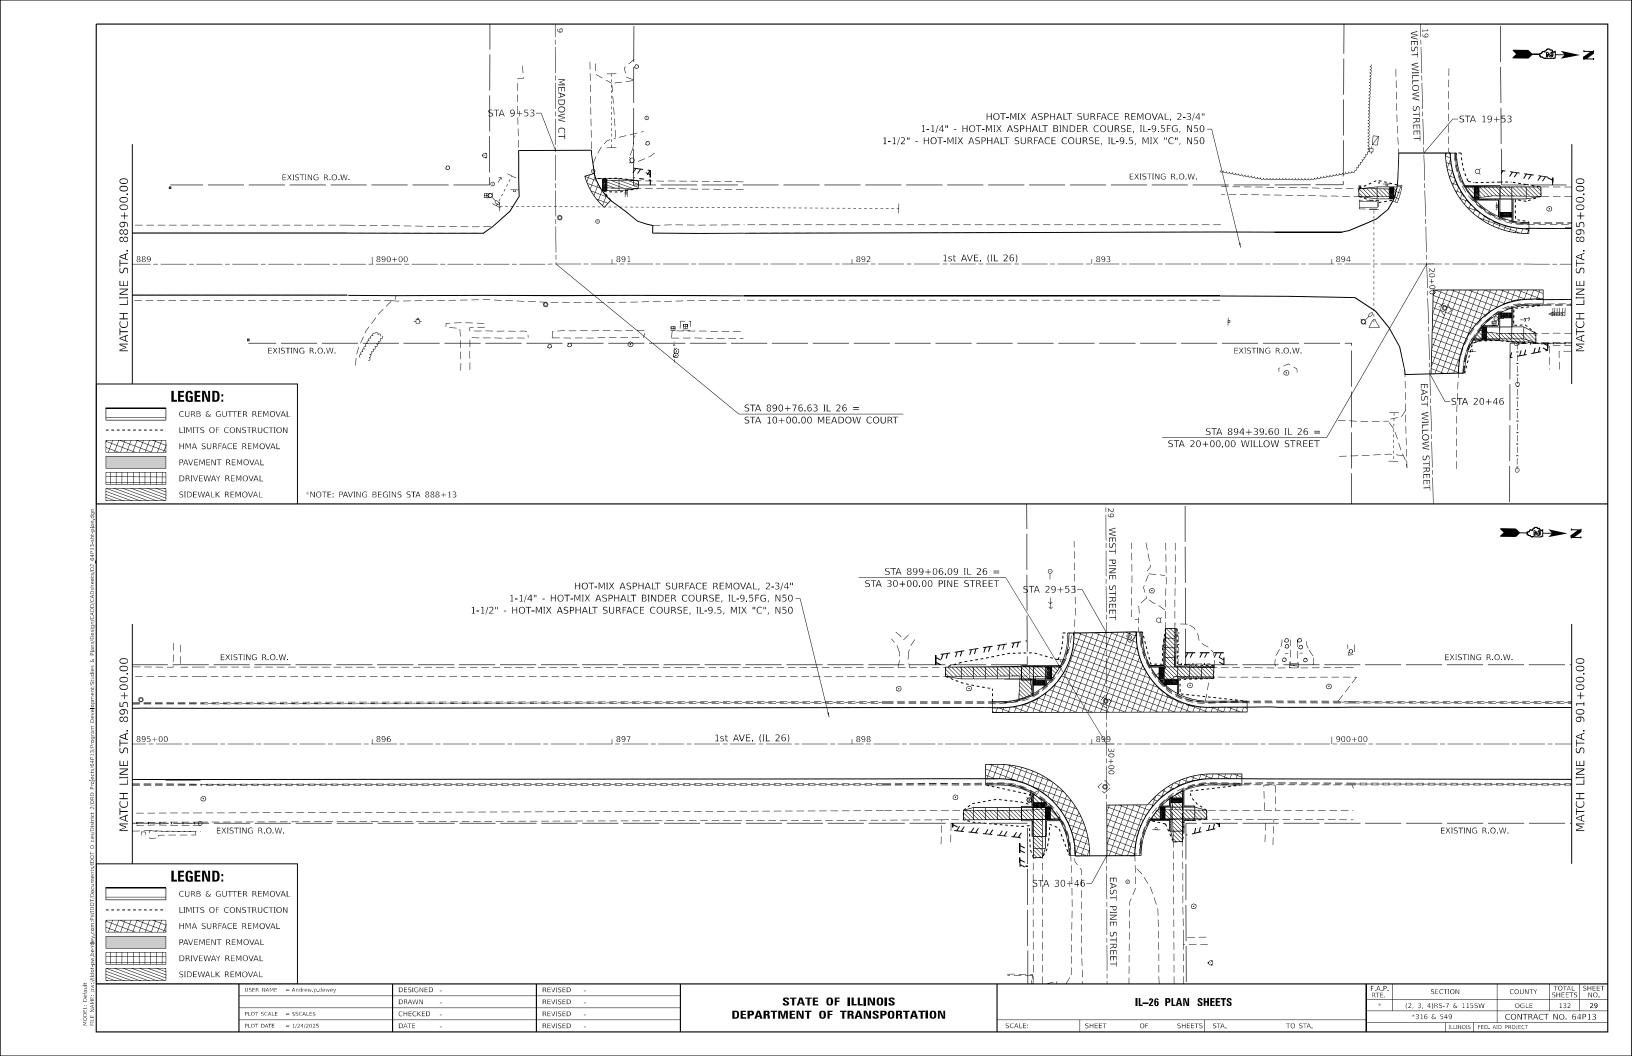


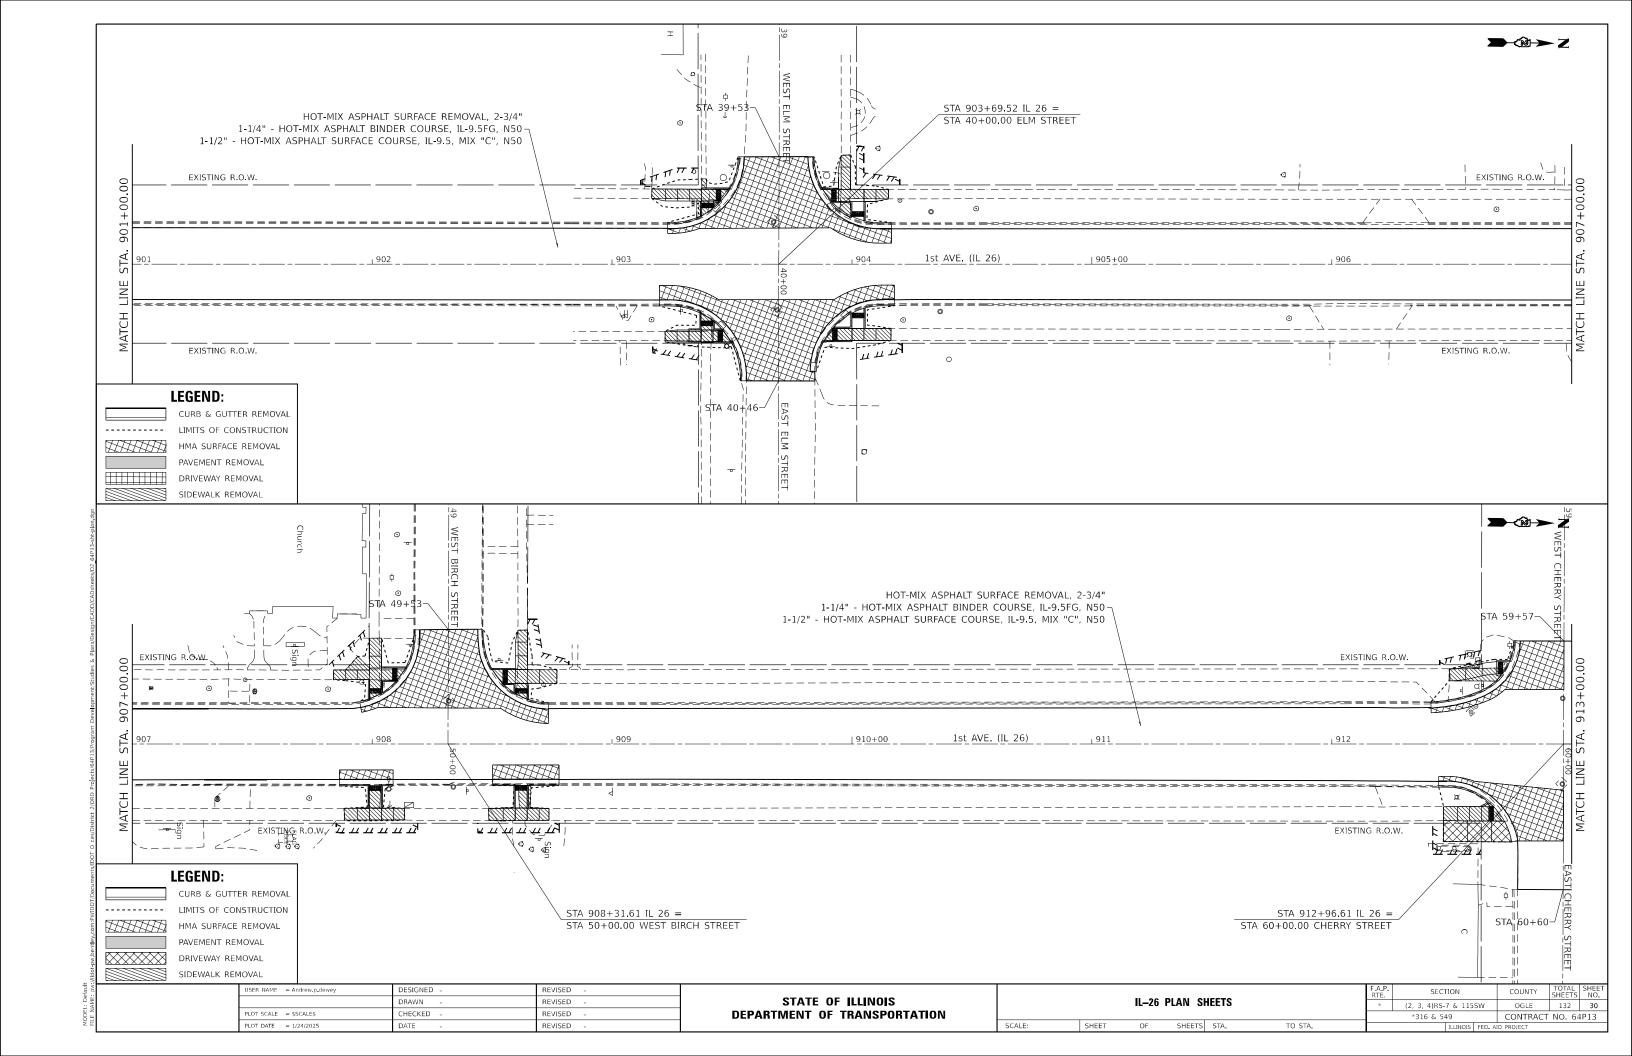


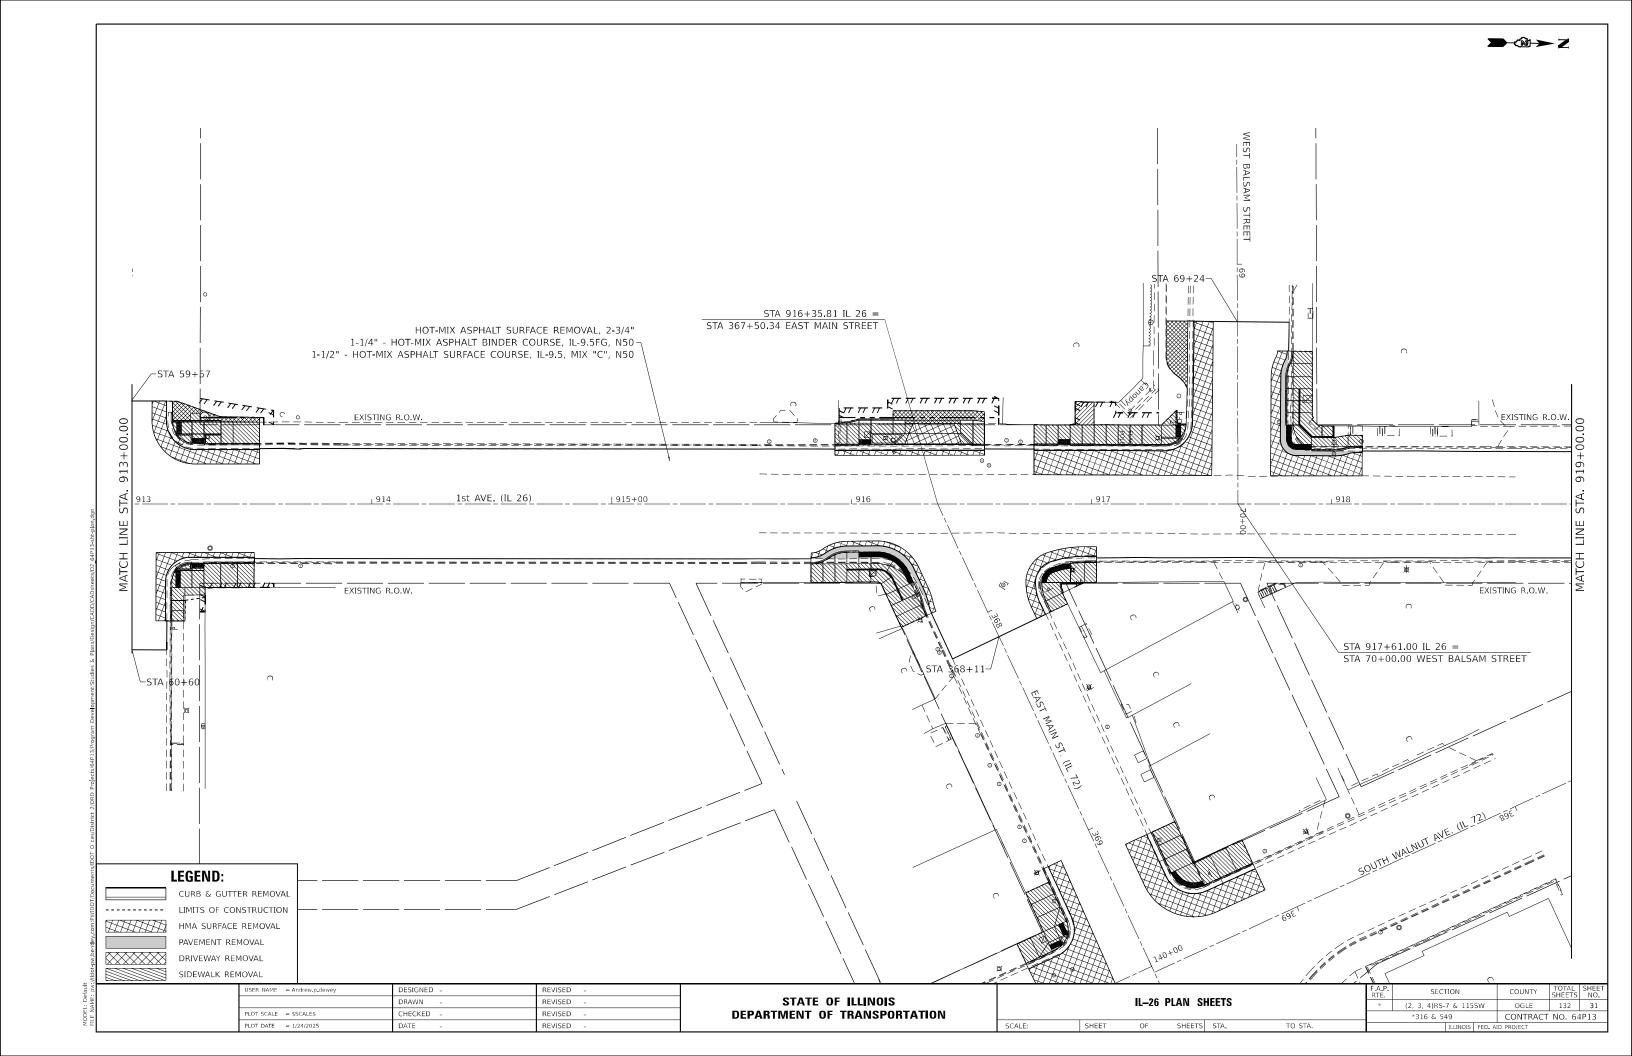


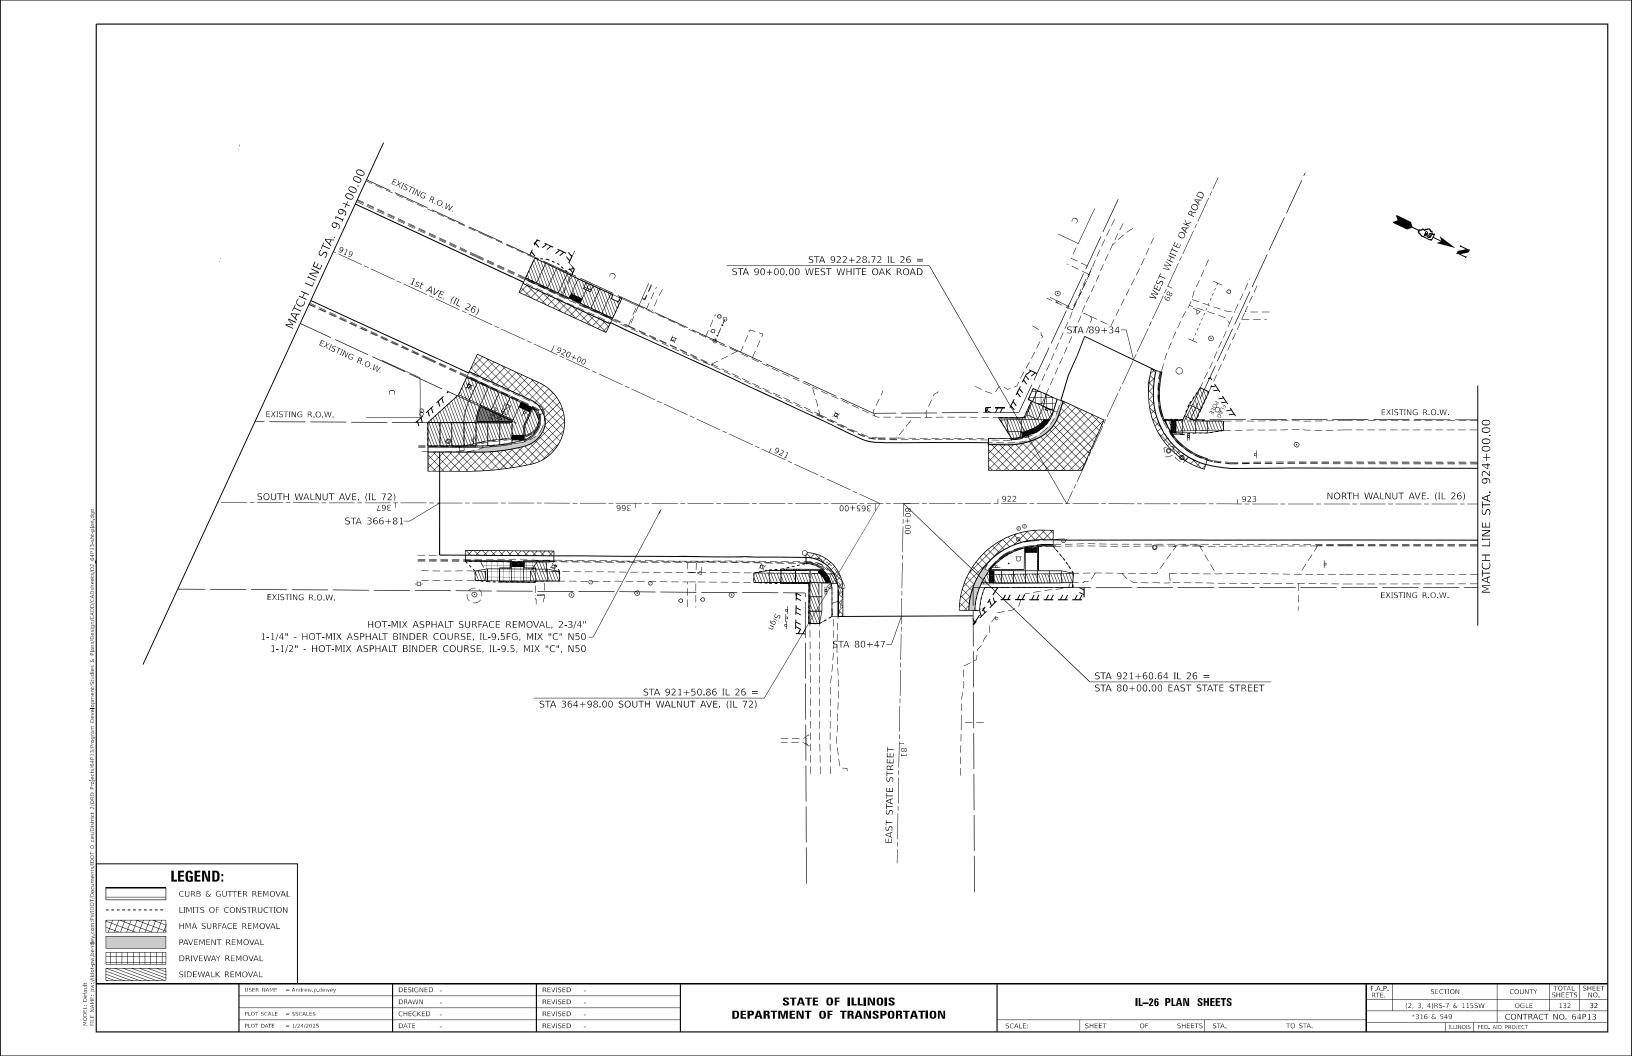


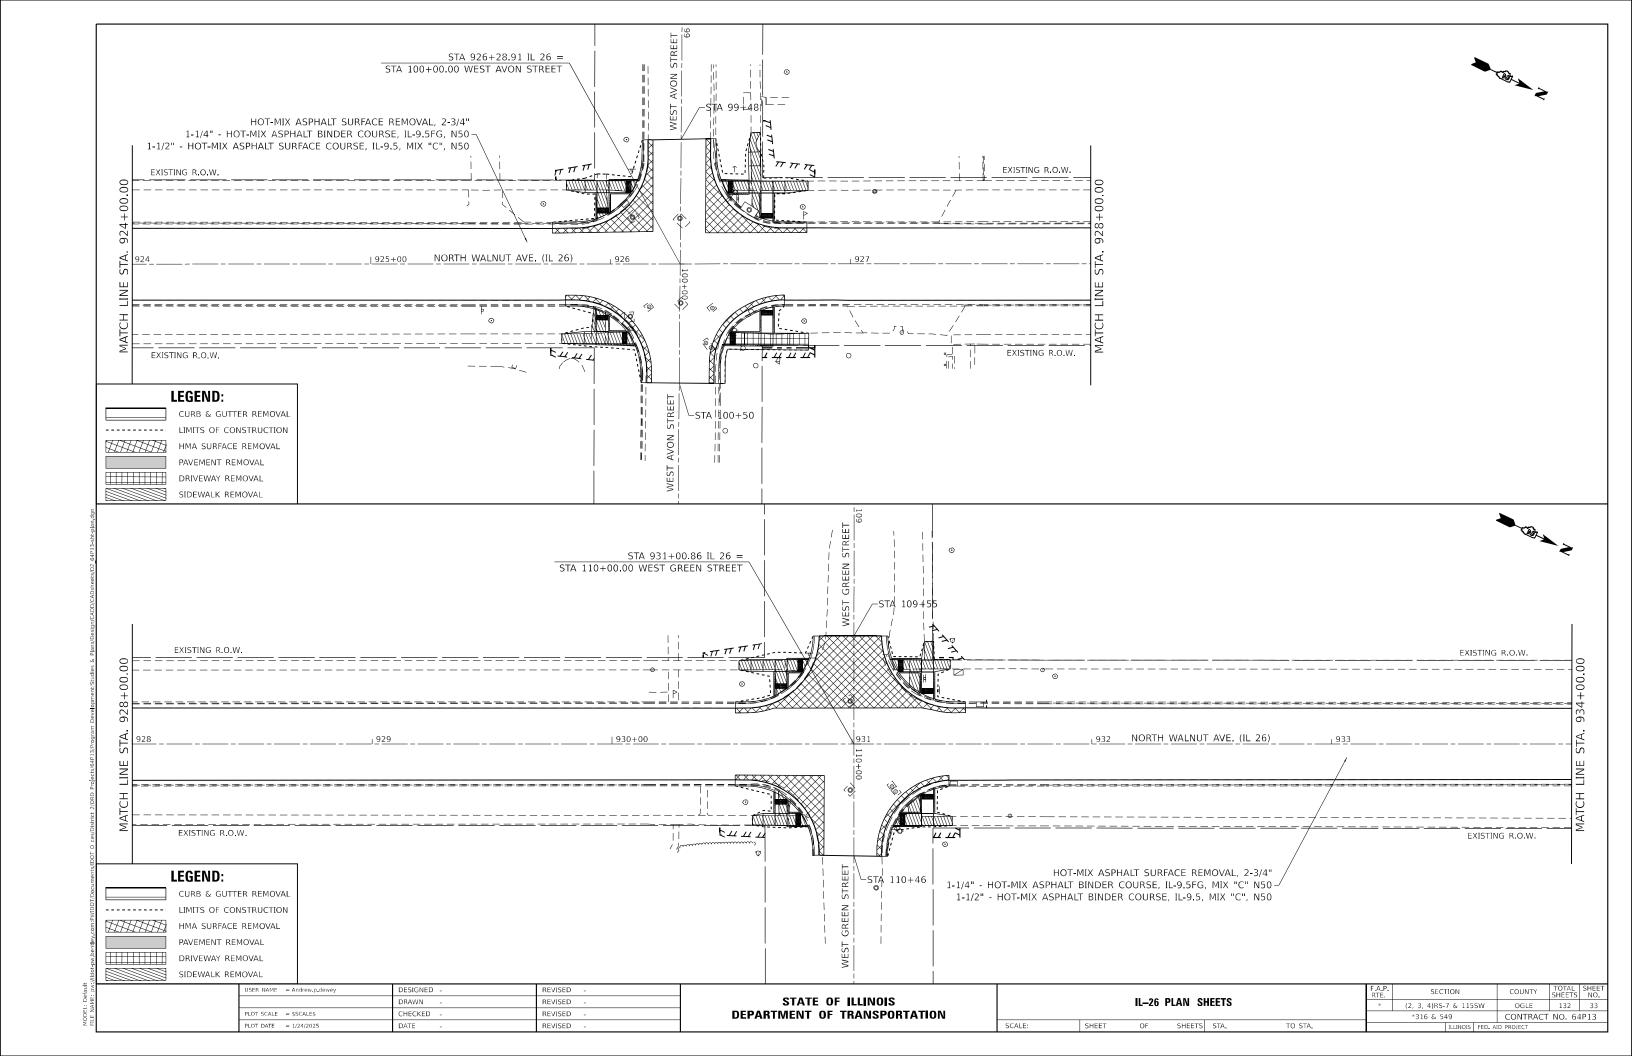

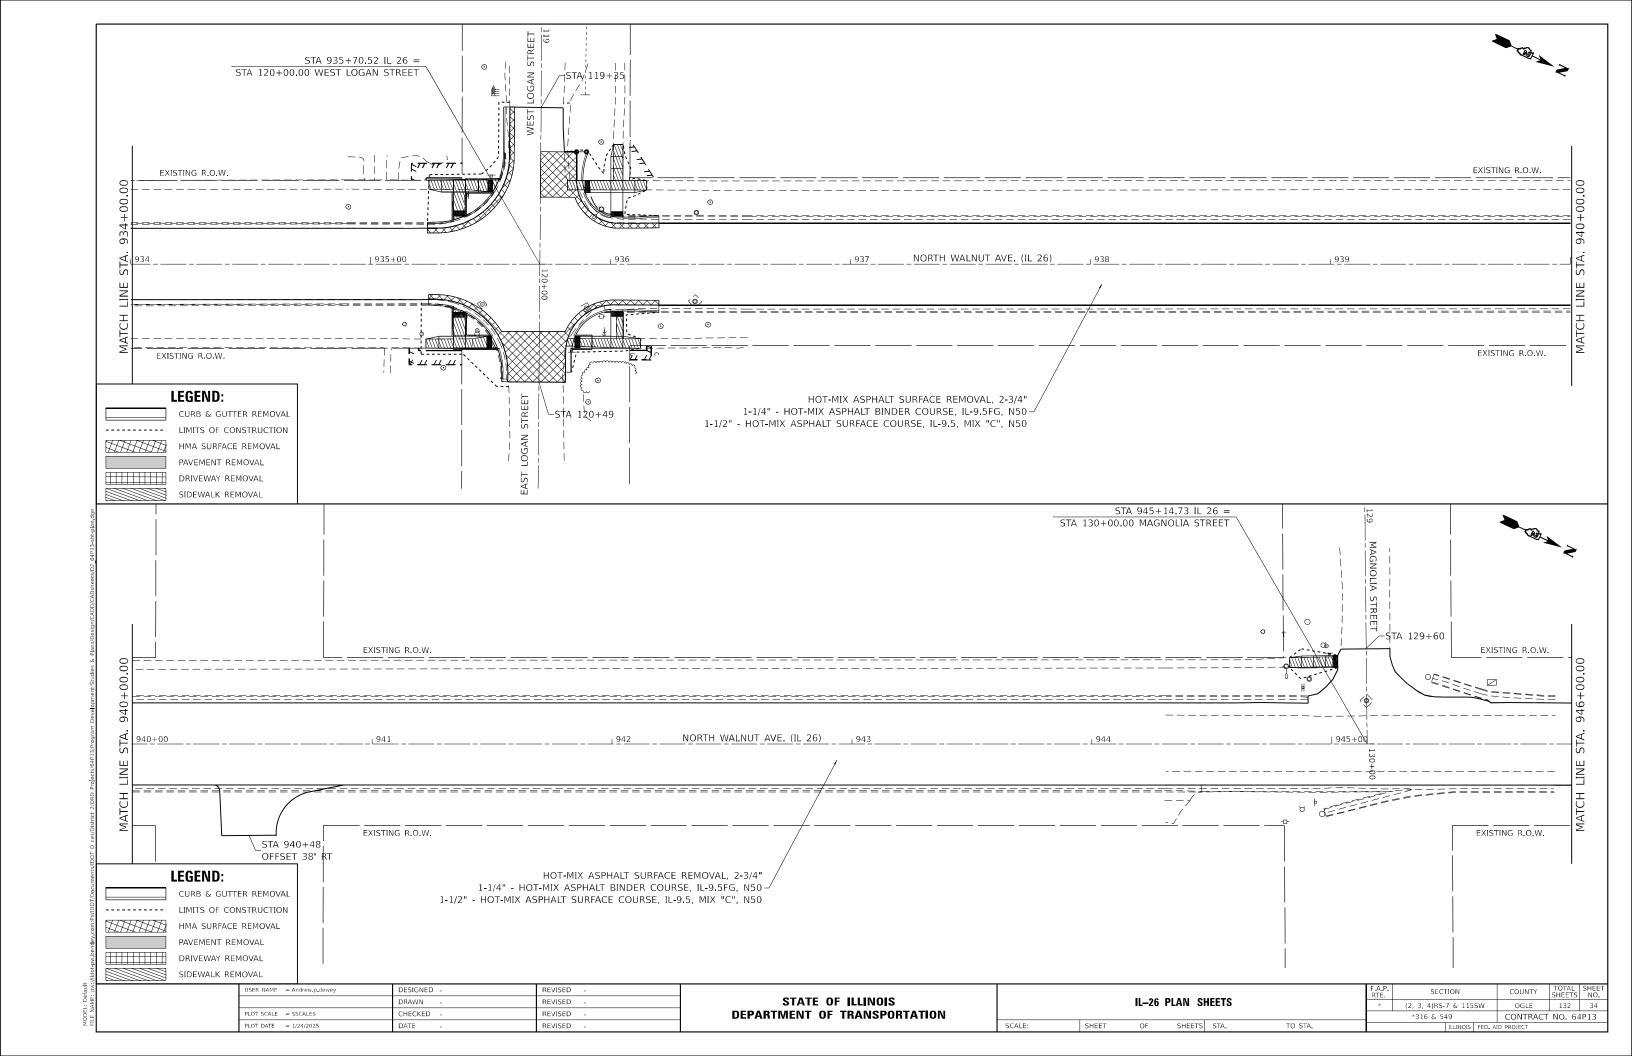


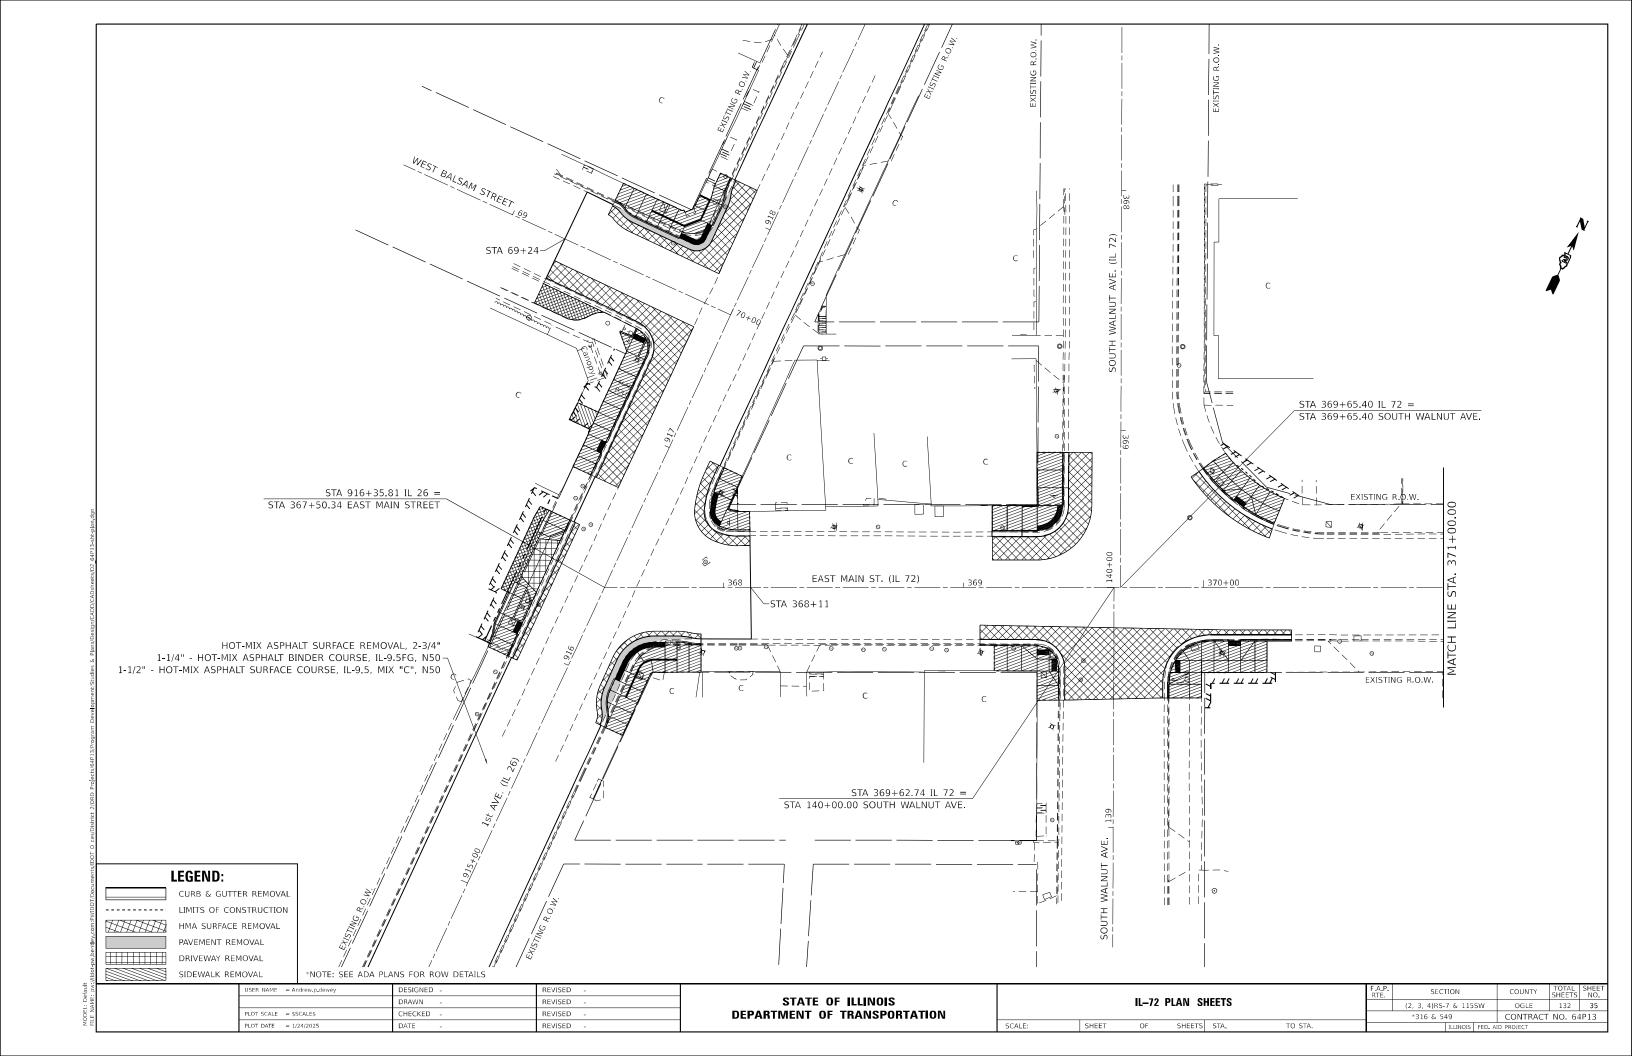


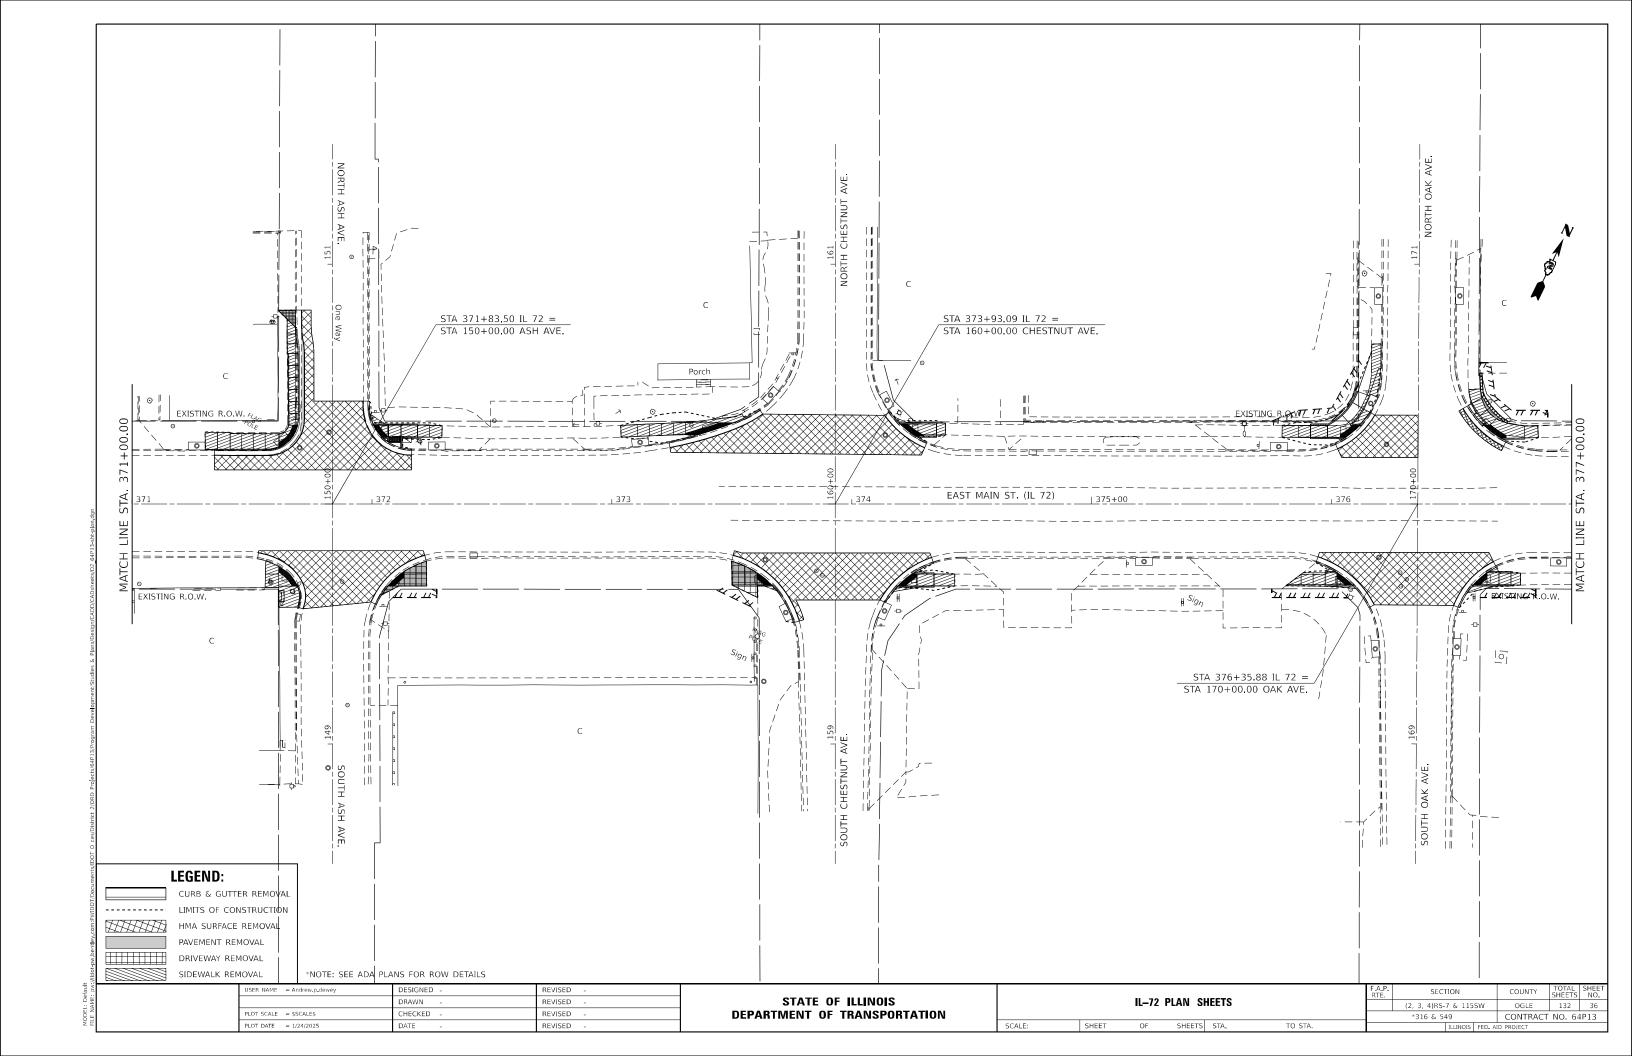


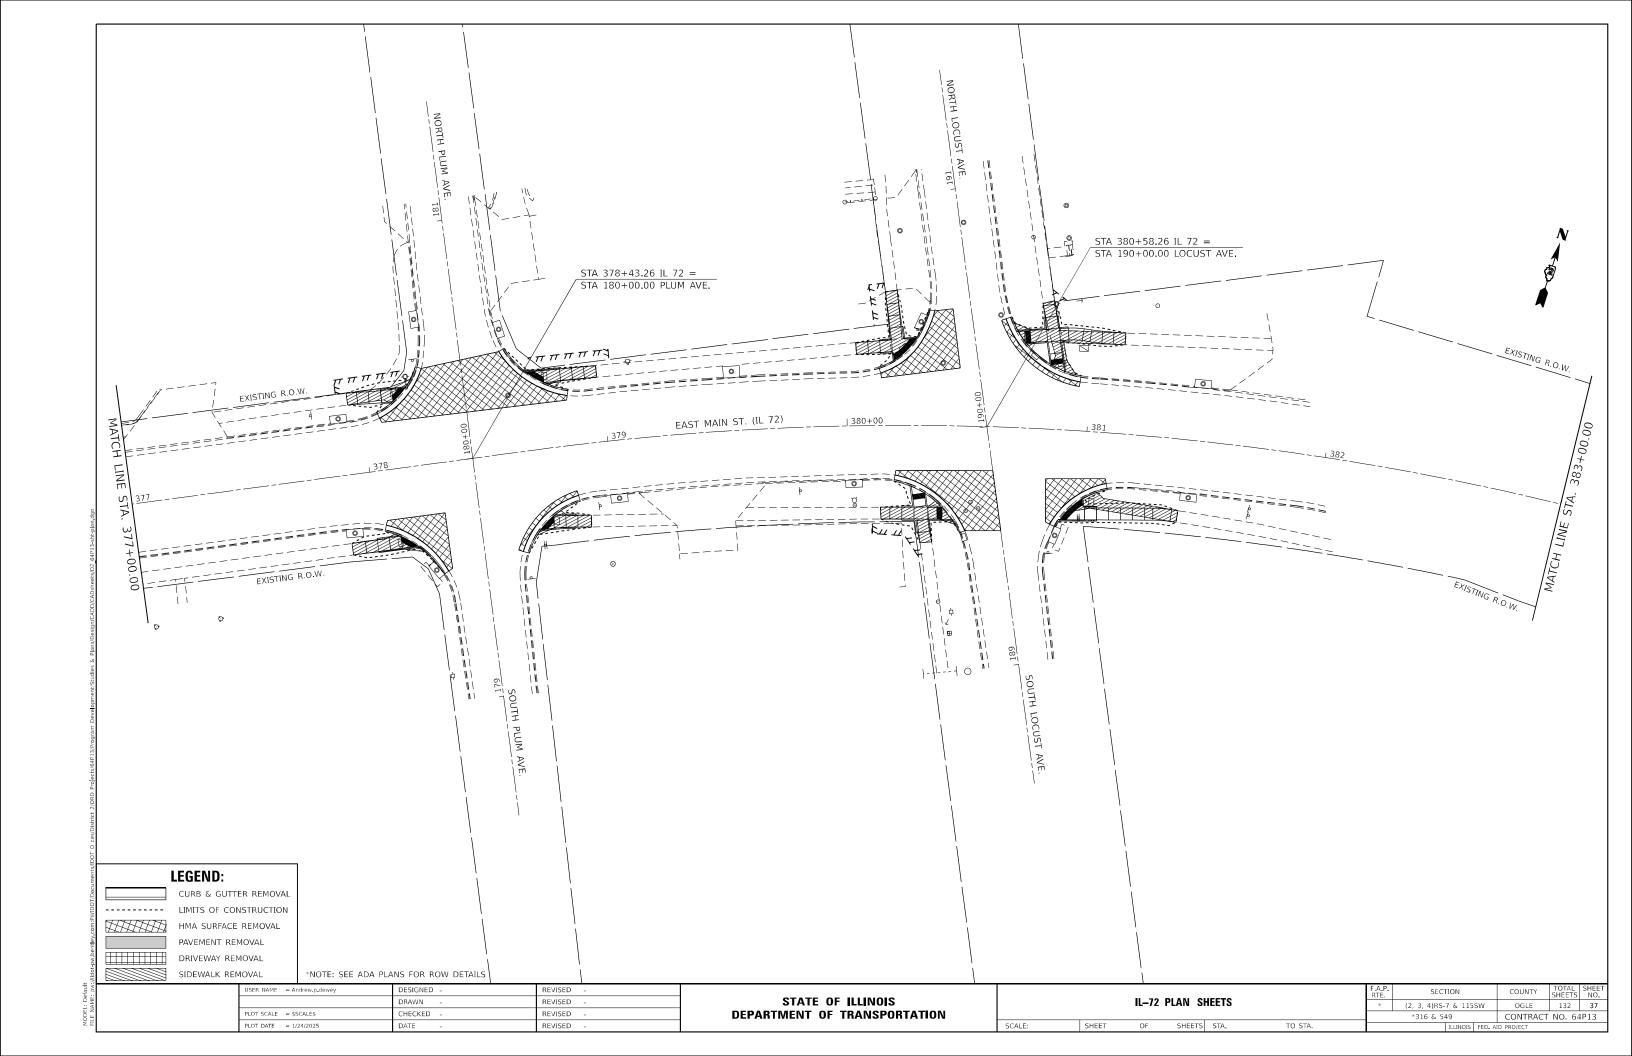



STA 392+92.07 IL 72 = STA 210+00.00 MASTERSON AVE. EXISTING R.O.W. EXISTING R.O.W. 389+00.00 └-IMPROVEMENT ENDS EXISTING R.O.W. EXISTING R.O.W. **LEGEND**: CURB & GUTTER REMOVAL ----- LIMITS OF CONSTRUCTION HMA SURFACE REMOVAL PAVEMENT REMOVAL DRIVEWAY REMOVAL SIDEWALK REMOVAL *NOTE: SEE ADA PLANS FOR ROW DETAILS DESIGNED REVISED SECTION STATE OF ILLINOIS IL-72 PLAN SHEETS DRAWN REVISED OGLE 132 38 CONTRACT NO. 64P13 * (2, 3, 4)RS-7 & 115SW **DEPARTMENT OF TRANSPORTATION** PLOT SCALE = \$SCALE\$ CHECKED REVISED *316 & 549 PLOT DATE = 1/24/2025 DATE SHEET OF SHEETS STA. TO STA.

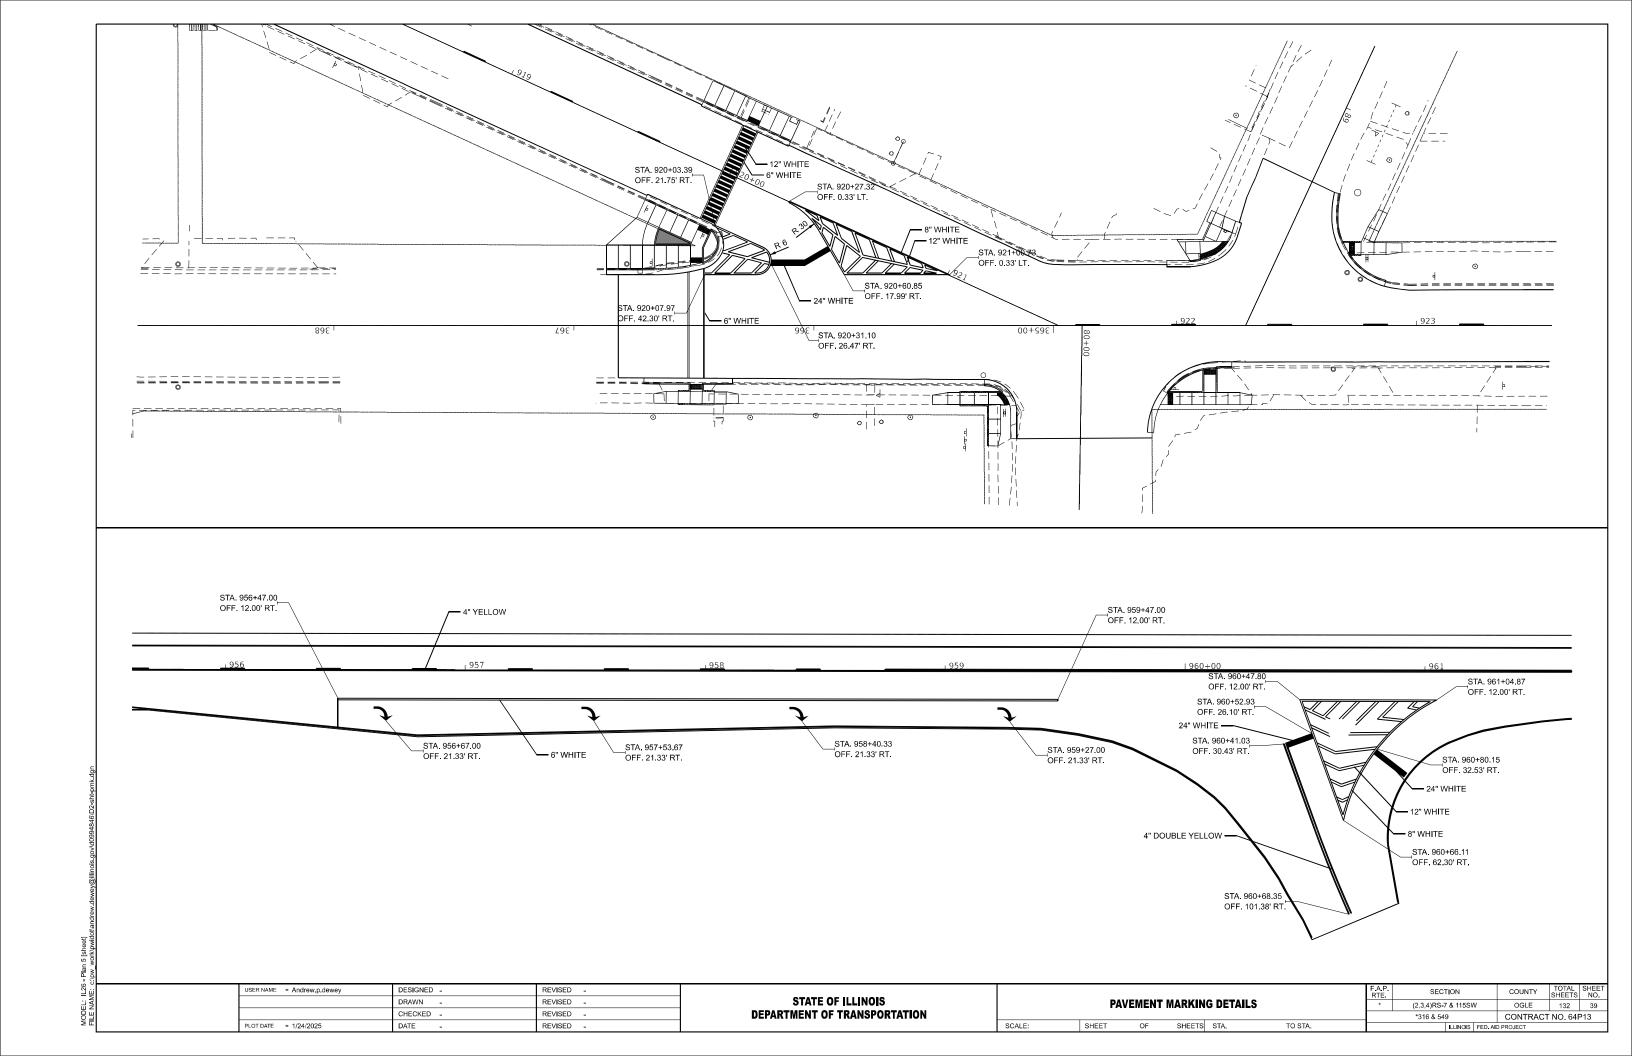


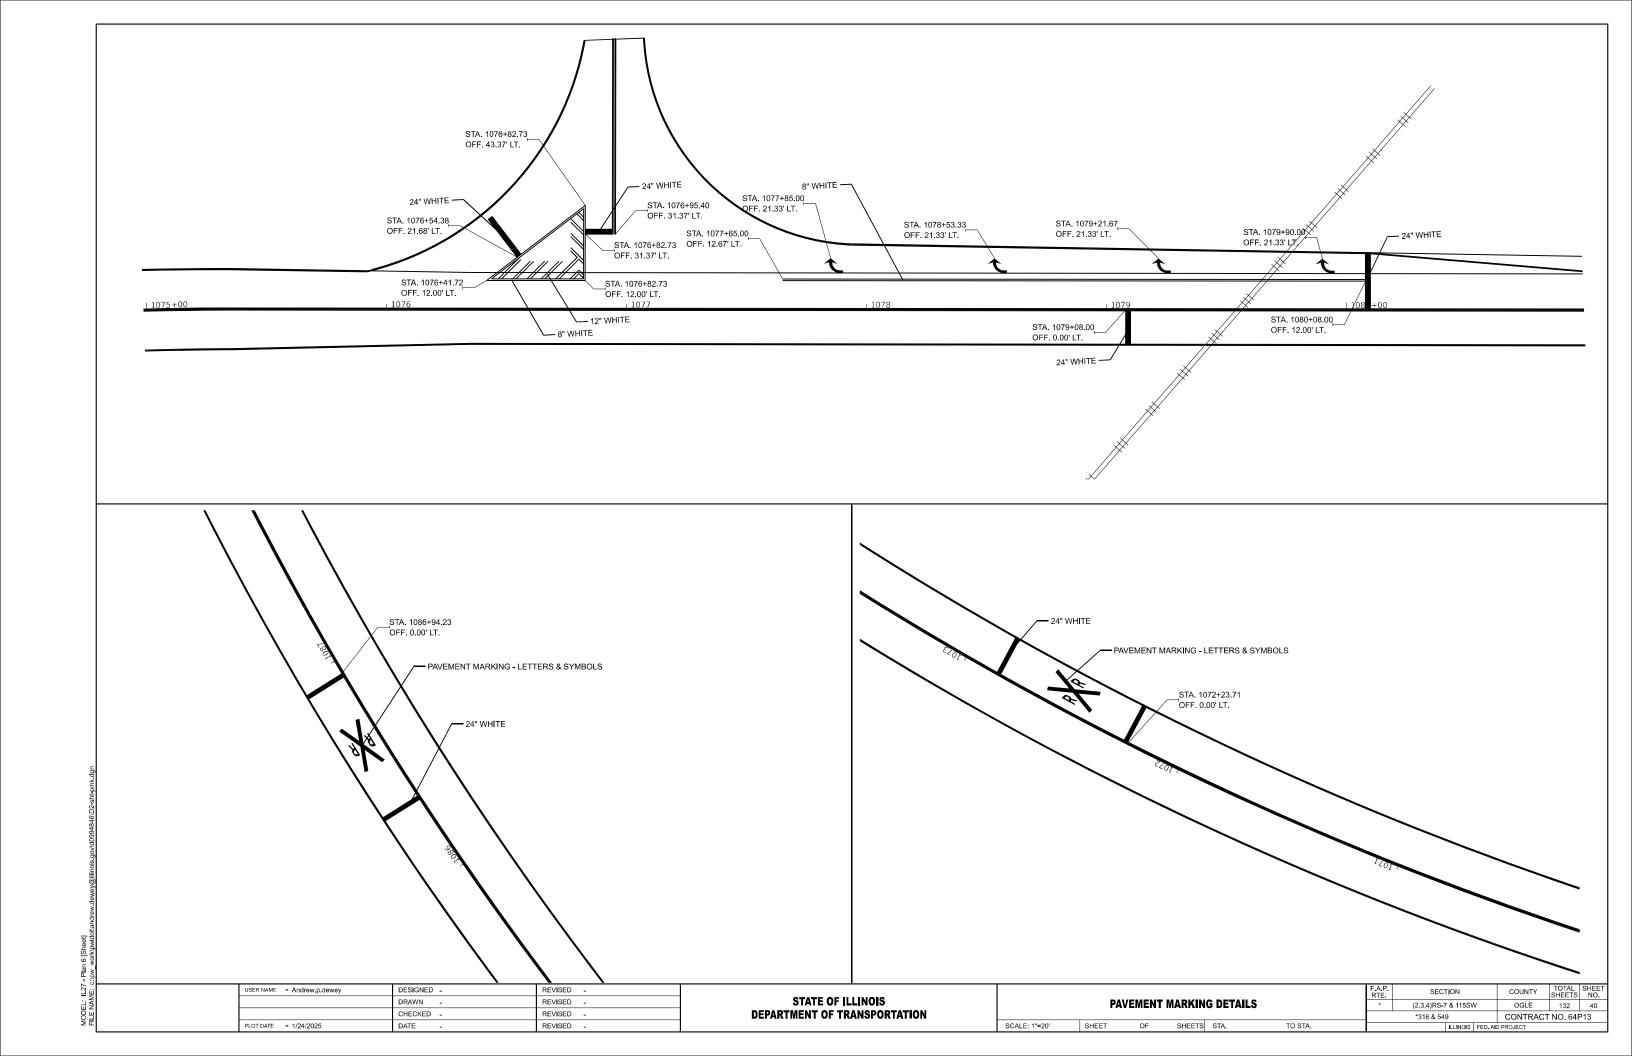


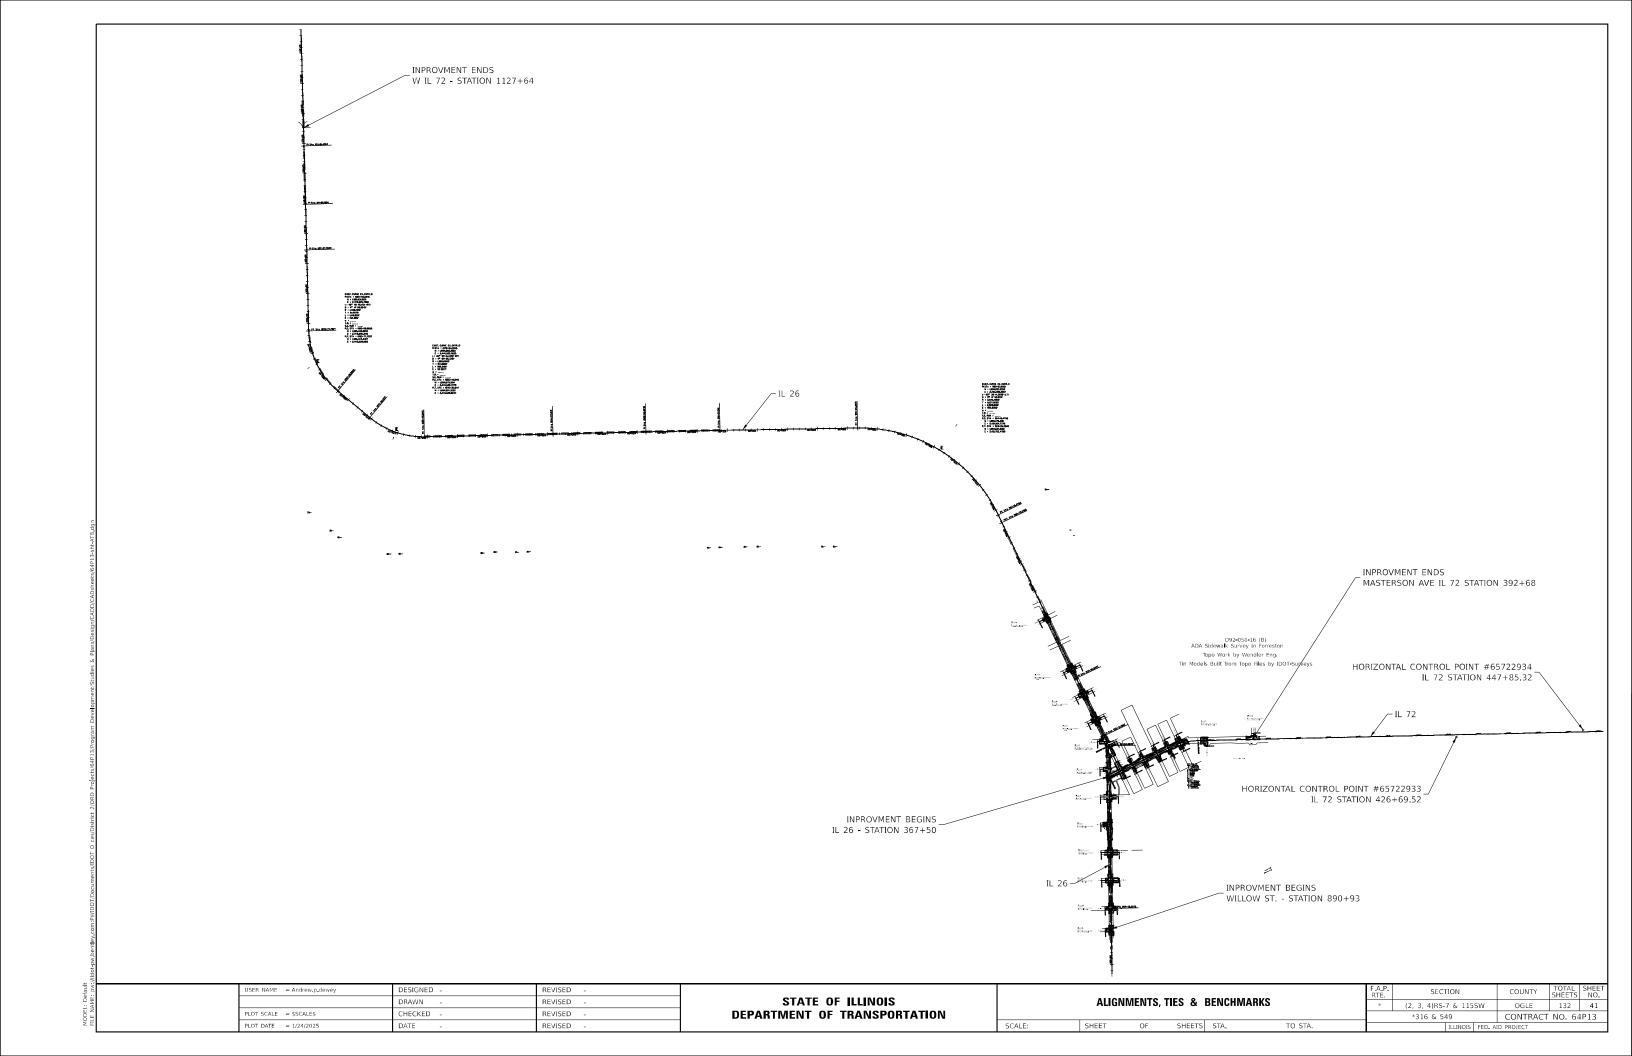


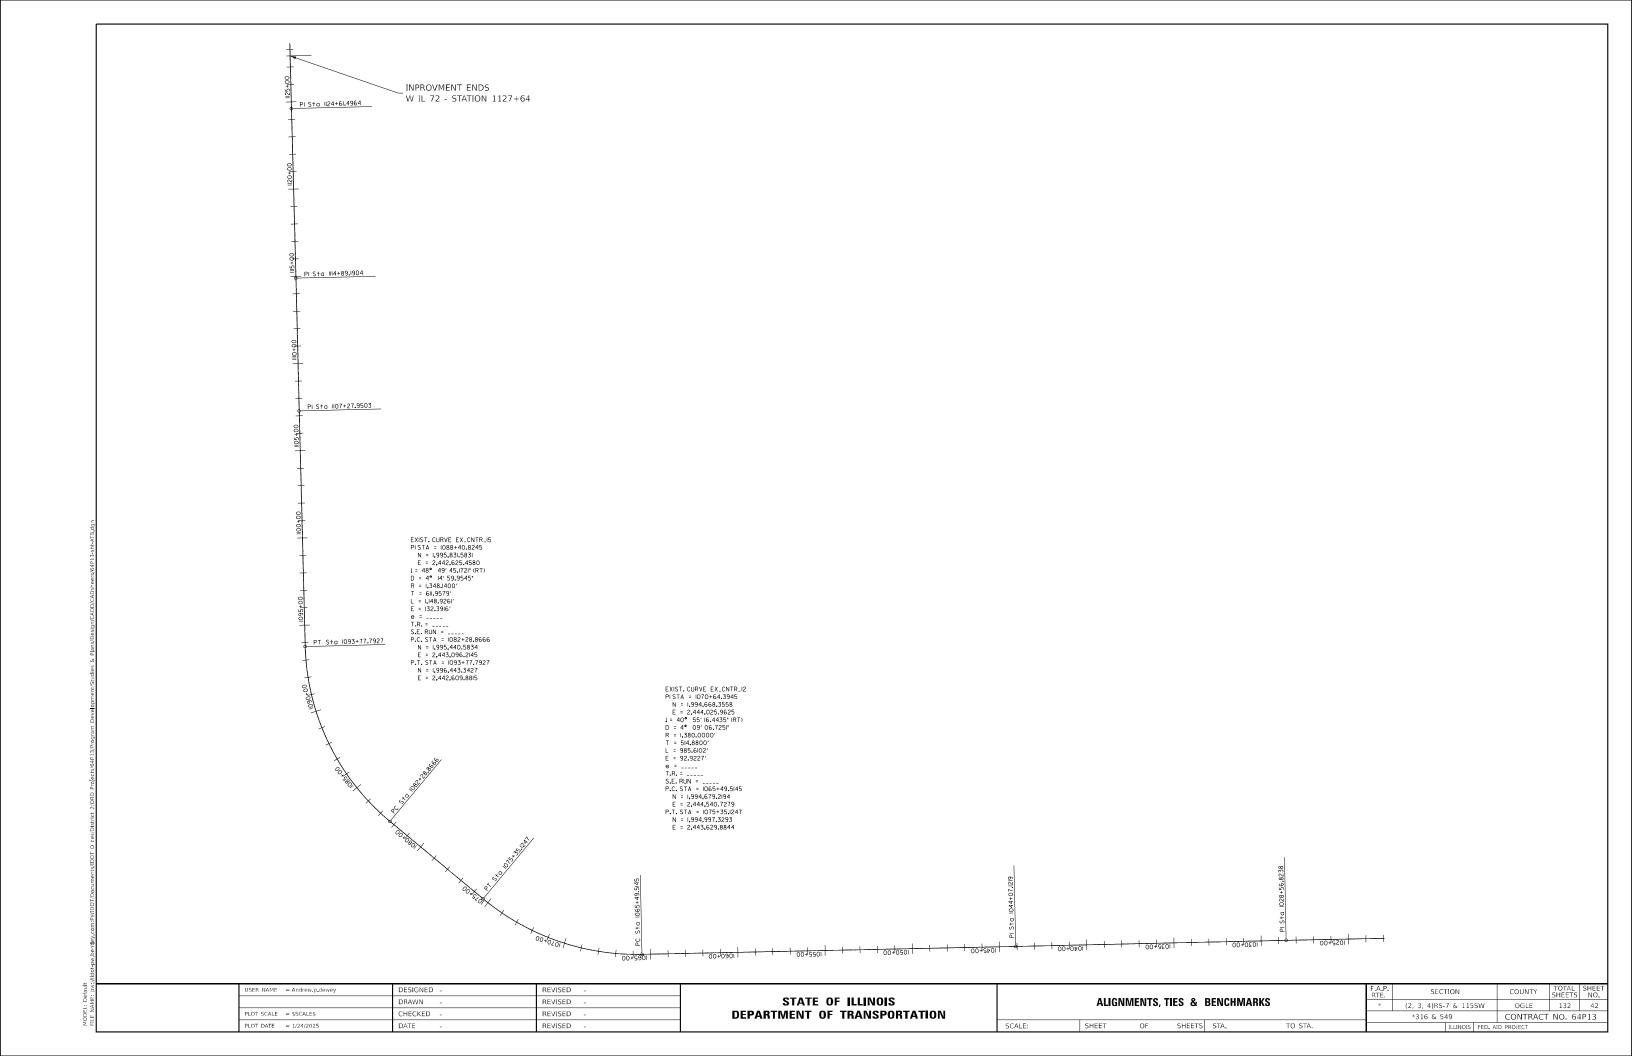

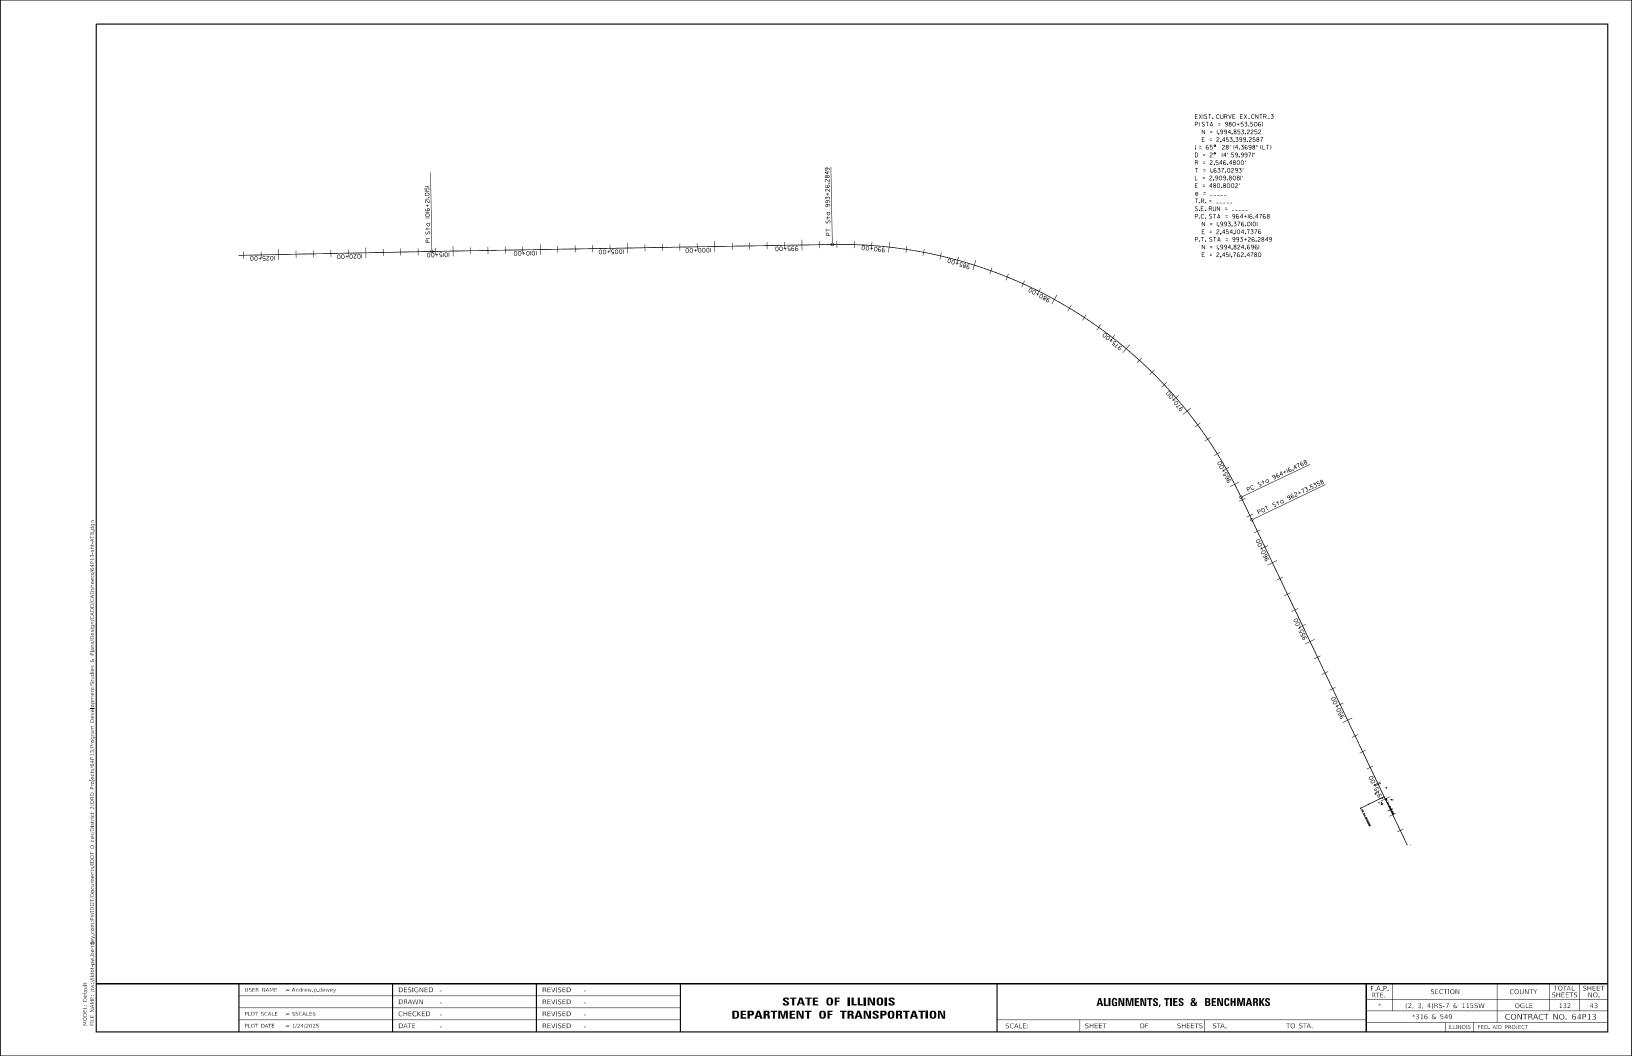

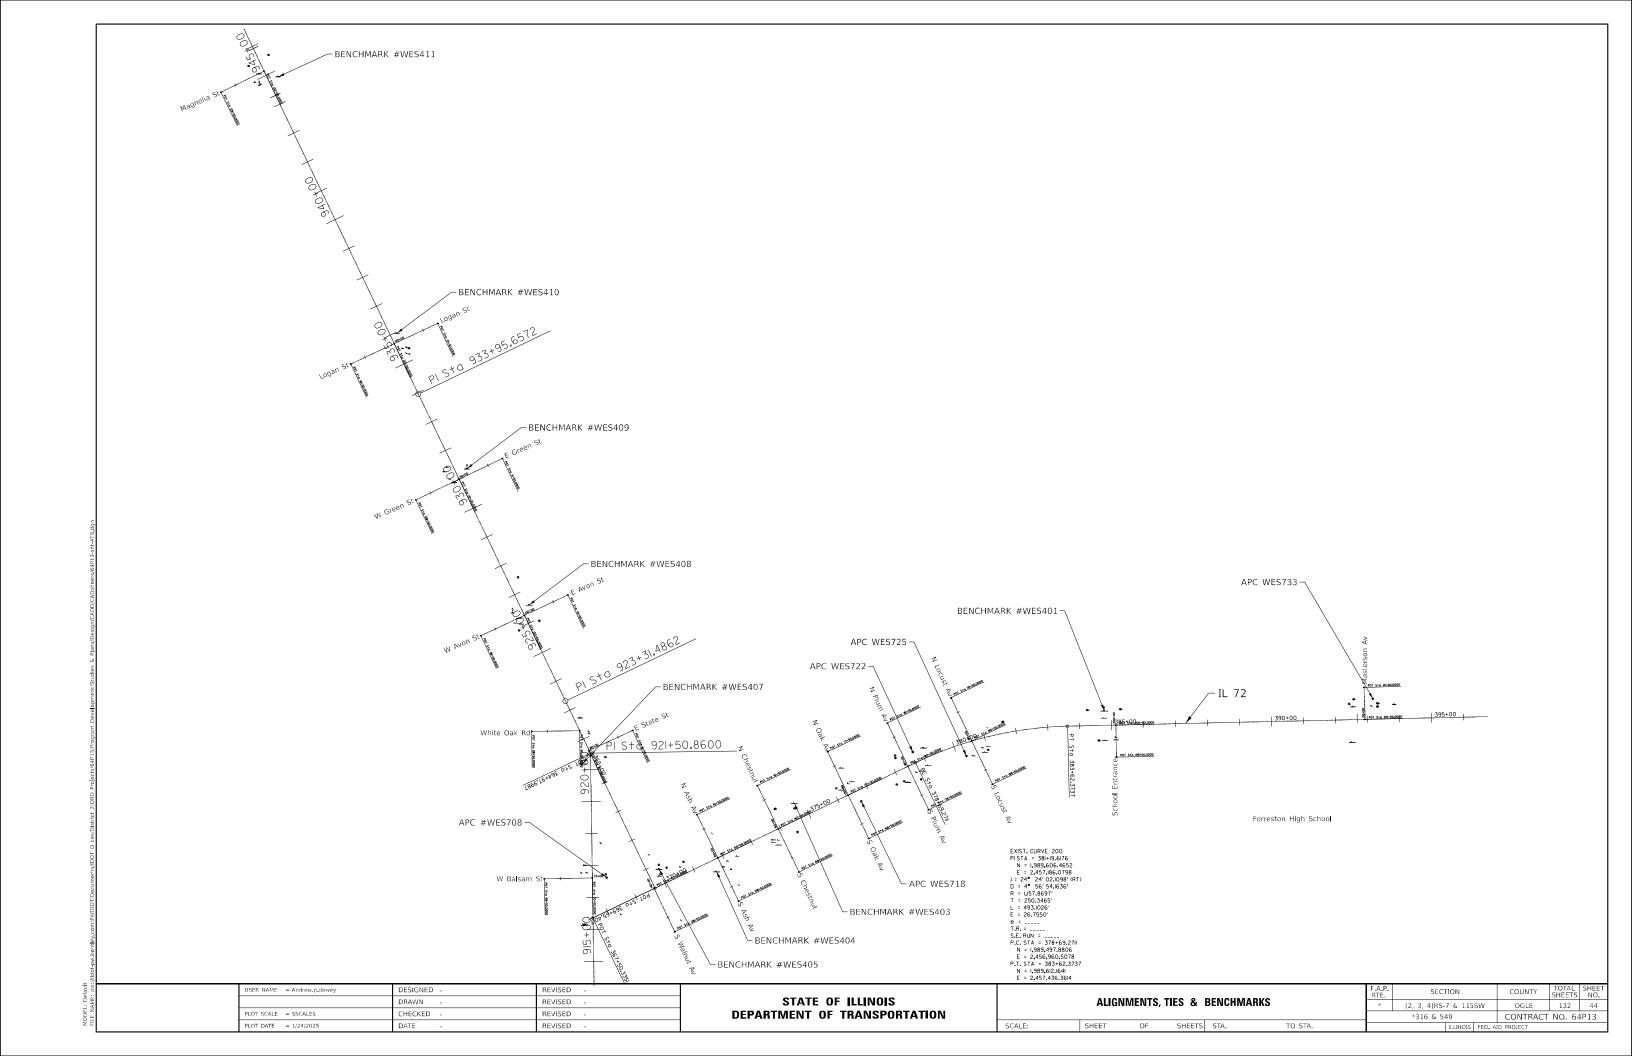

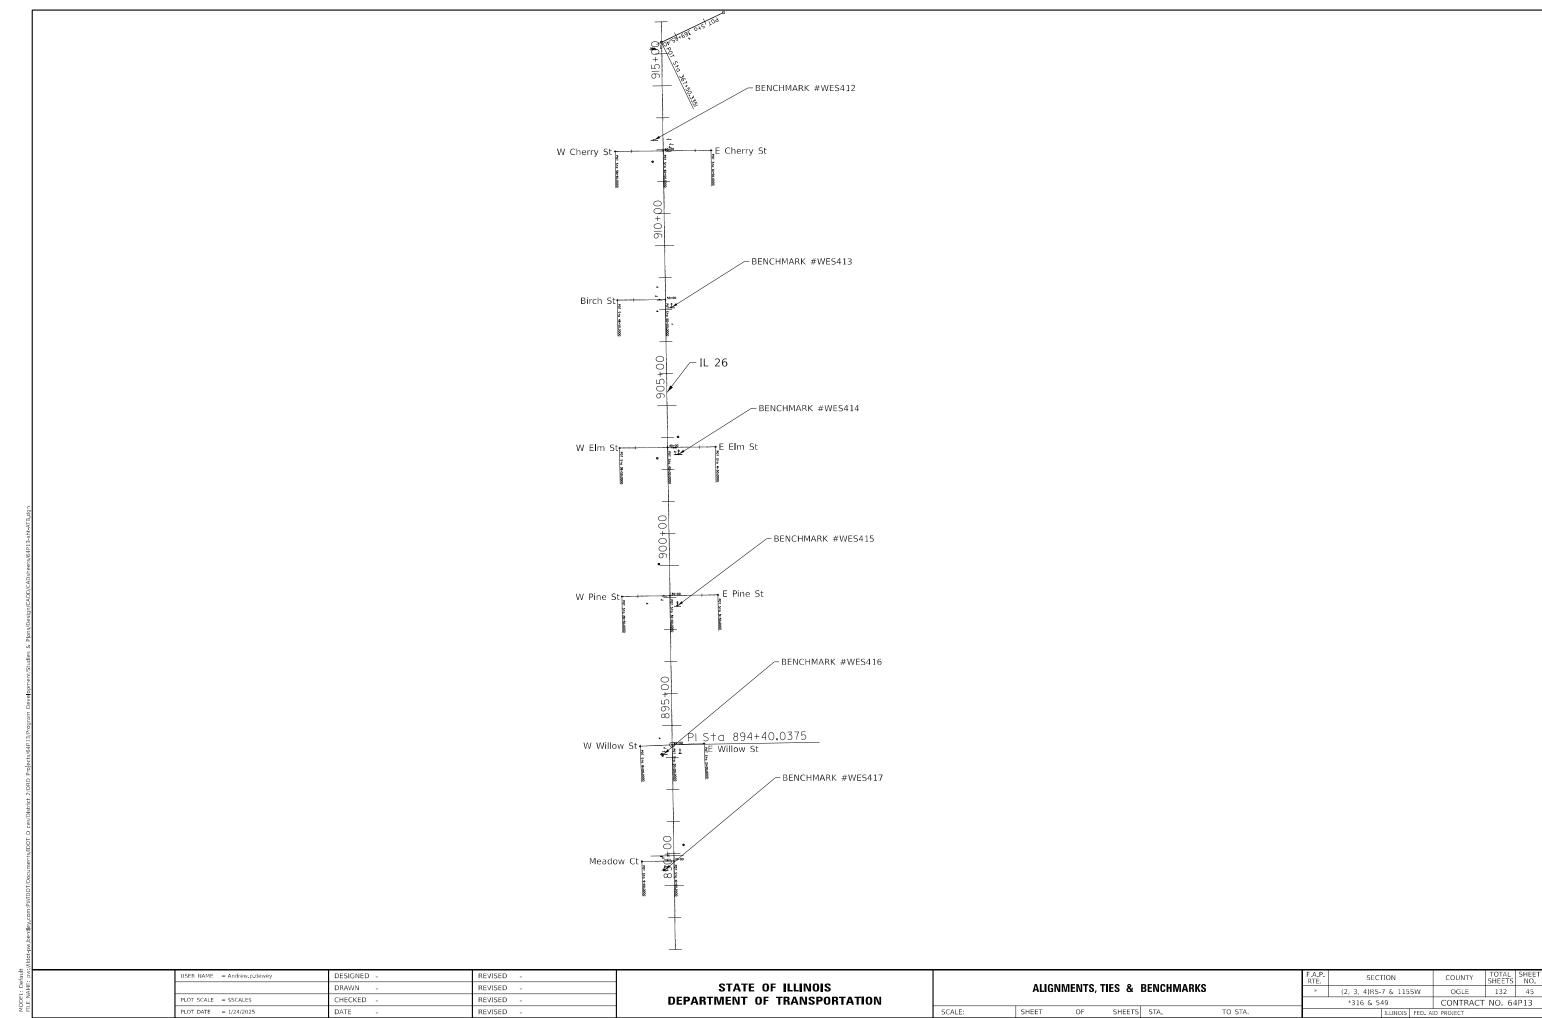

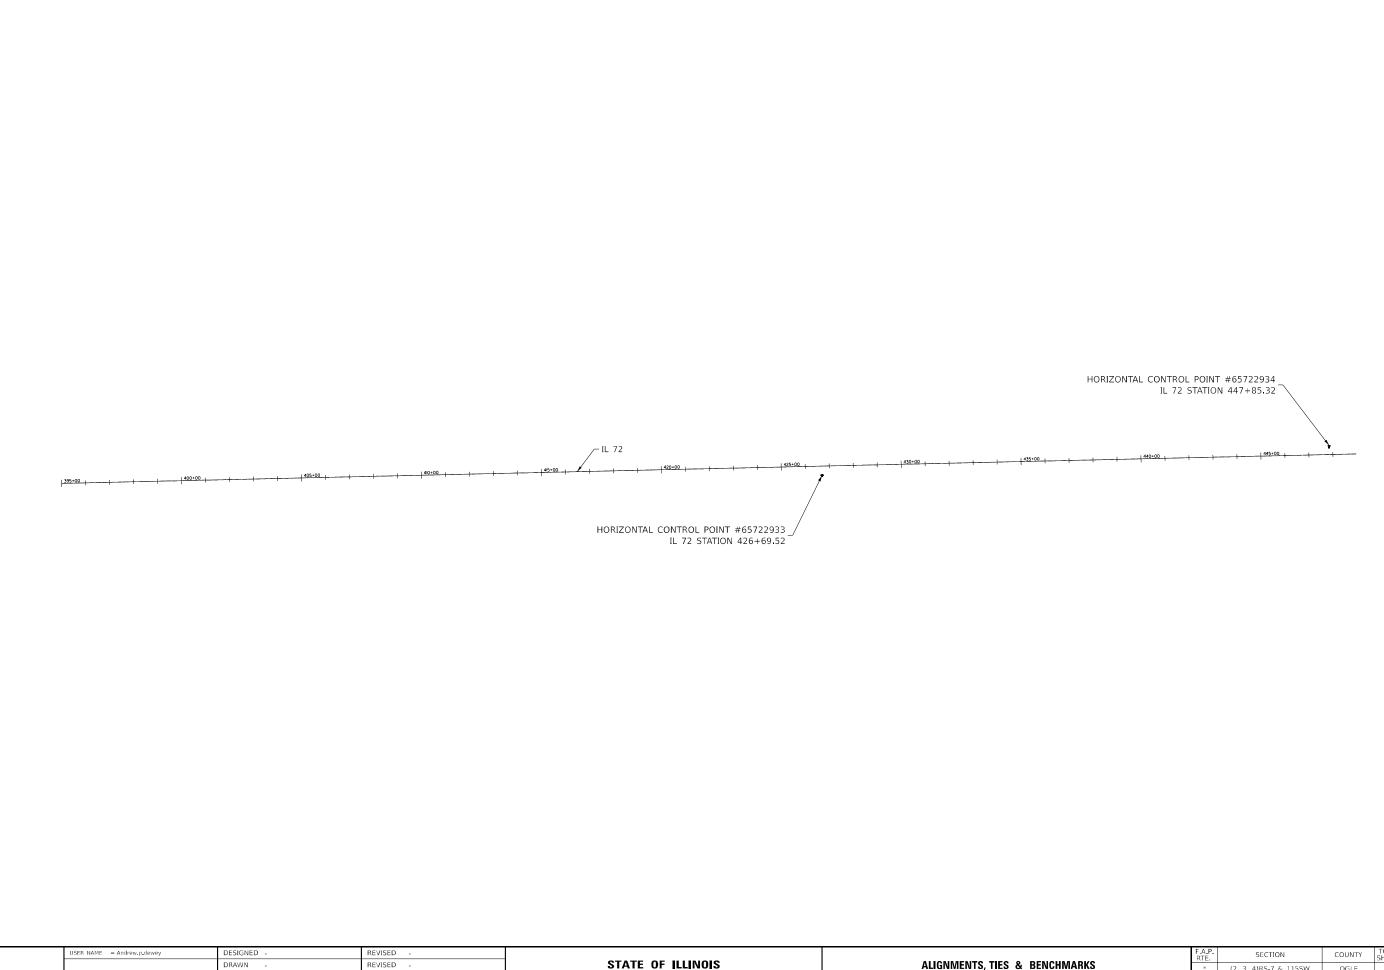

MODEL Default

PLOT SCALE = \$SCALE\$

PLOT DATE = 1/24/2025

CHECKED


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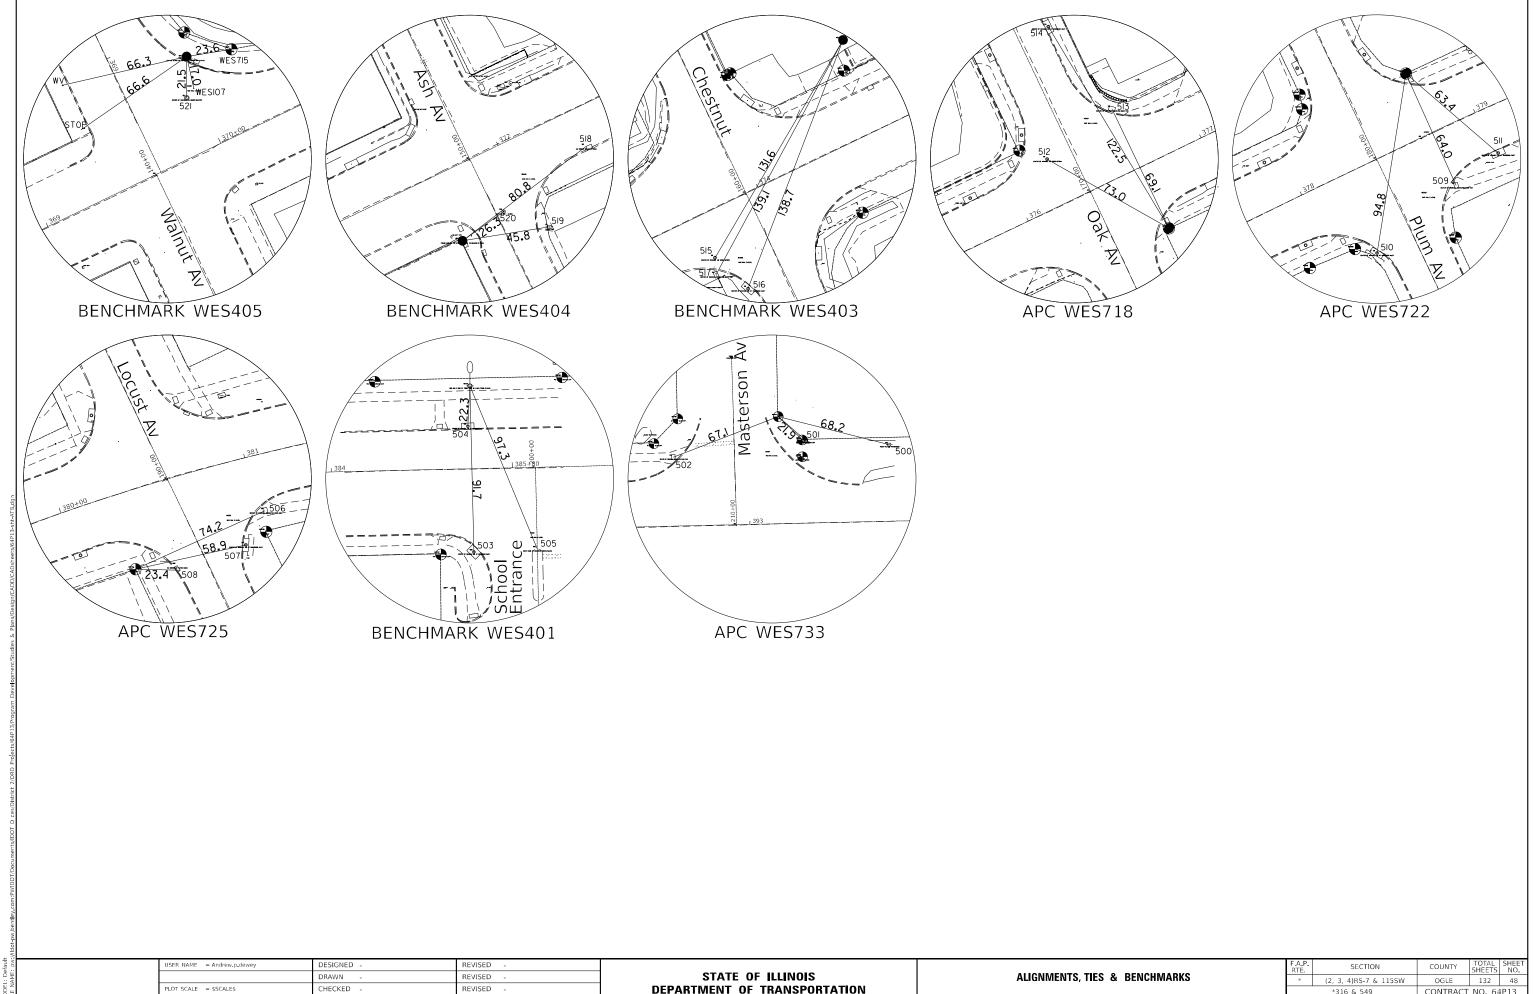
REVISED

REVISED

STATE OF ILLINOIS DEPARTMENT OF TRANSPORTATION

SCALE:



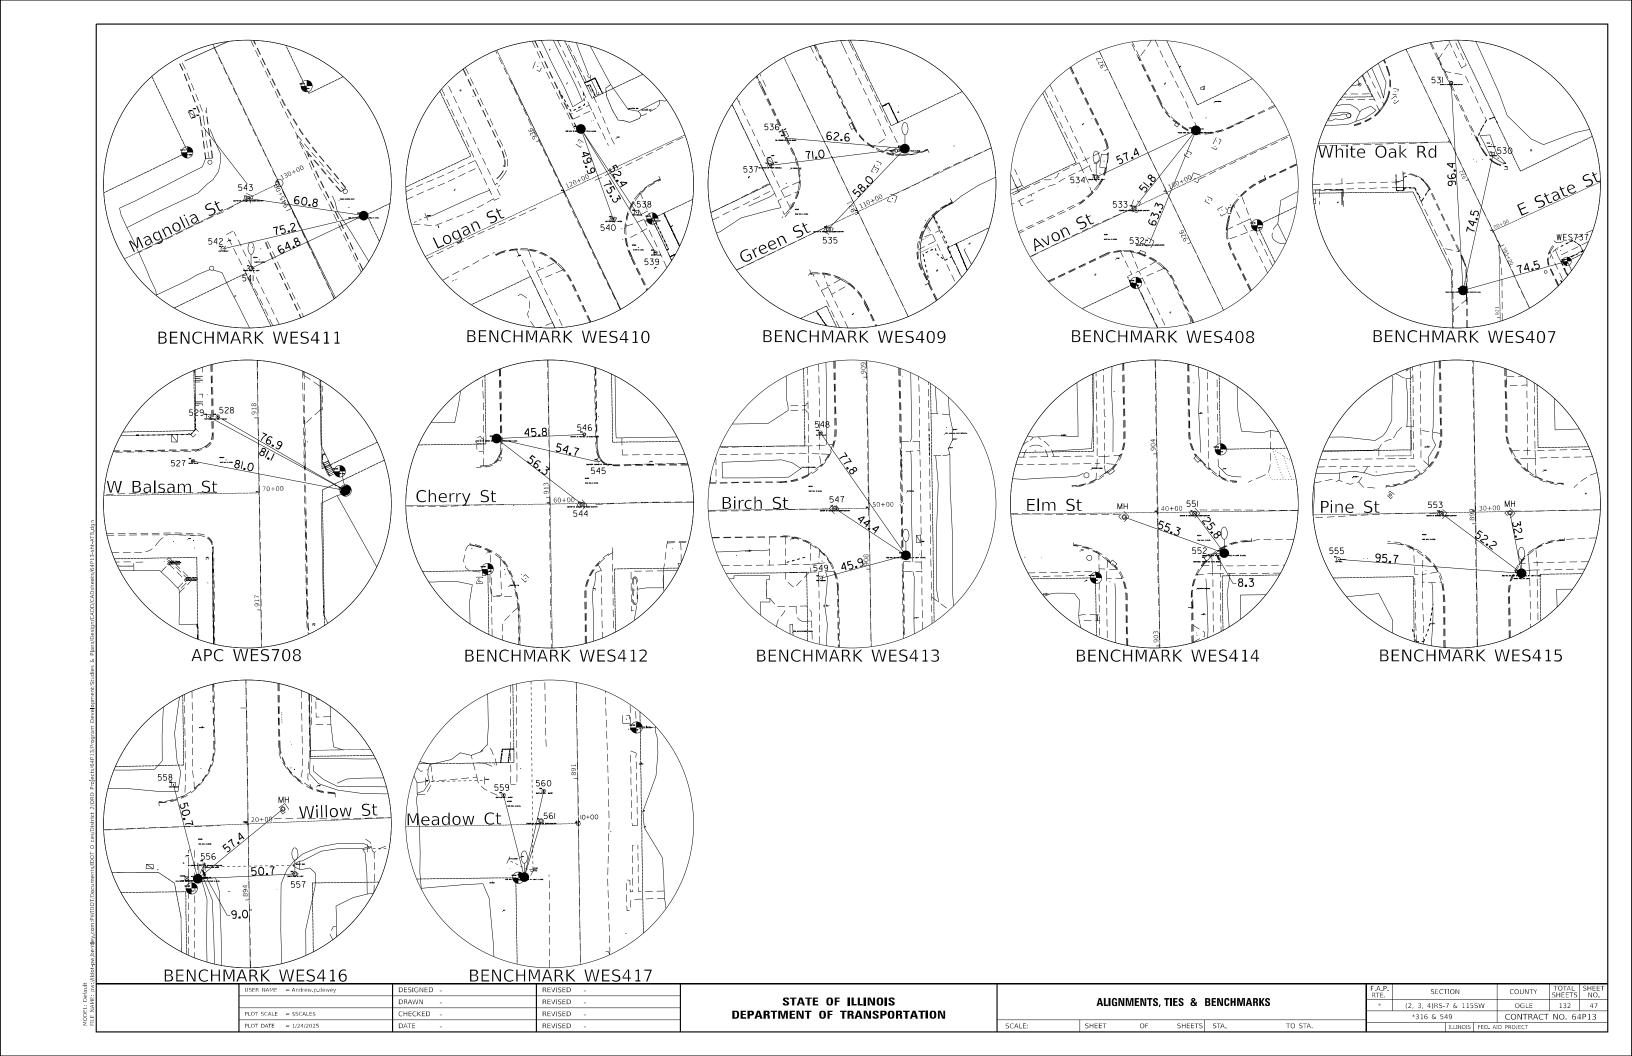

PLOT DATE = 1/24/2025

DEPARTMENT OF TRANSPORTATION

*316 & 549 CONTRACT NO. 64P13 OF SHEETS STA.

	HORIZONTAL CONTROL POINTS								
POINT	POINT NORTH EAST ELEVATION				STATION	OFFSET	DESCRIPTION		
65722933	1989671.4980	2461743.2760	882.3680	IL72	426+69.52	38.7247' RT	DISTRICT NETWORK MONUMENT, NGS MONUMENT		
65722934	1989792.7660	2463856.8570	883.9770	383.9770 IL72		34.3981' LT	DISTRICT NETWORK MONUMENT, NGS MONUMENT		

				SURVEY	WORK POII	NTS	
POINT	NORTH	EAST	ELEVATION	CHAIN	STATION	OFFSET	DESCRIPTION
WES100	1989675.6890	2458386.6120	928.7680	IL72	393+13.82	41.8768' LT	SURVEY WORK POINT, PK NAIL
WES101	1989578.0780	2457587.3520	923.9640	IL72	385+12.55	37.5145' RT	SURVEY WORK POINT, PK NAIL
WES102	1989545.3960	2457170.9490	922.3300	IL72	380+86.11	28.7205' RT	SURVEY WORK POINT, PK NAIL
WES103	1989467.8960	2456964.0850	924.4950	IL72	378+59.49	28.5688' RT	SURVEY WORK POINT, PK NAIL
WES104	1989433.2670	2456750.3390	927.2260	IL72	376+51.88	32.9387' LT	SURVEY WORK POINT, PK NAIL
WES105	1989256,5480	2456530.7920	931.4730	IL72	373+77.41	31.0663' RT	SURVEY WORK POINT, PK NAIL
WES106	1989191.2890	2456373.1990	935.8840	IL72	372+07.10	21.5132' RT	SURVEY WORK POINT, PK NAIL
WES107	1989149.4990	2456163.1740	940.3890	IL72	369+99.74	31.9281' LT	SURVEY WORK POINT, PK NAIL
WES108	1988994.1510	2455921.5350	942.3950	IL26	916+17.88	31.0423' LT	SURVEY WORK POINT, PK NAIL
WES109	1989154,8560	2455933,2370	942.0640	IL26	917+78.39	16.9114' LT	SURVEY WORK POINT, PK NAIL
WES110	1989595.9630	2455939.4780	936.0820	IL26	922+14.76	24.9635' RT	SURVEY WORK POINT, PIN
WES111	1989935.4410	2455708.4910	931.1190	IL26	926+20.71	36.6984' LT	SURVEY WORK POINT, PK NAIL
WES112	1990384.2750	2455504.5150	932.6090	IL26	931+13.61	26.5914' LT	SURVEY WORK POINT, PK NAIL
WES113	1990778,6830	2455369,8630	935,2360	IL26	935+27.51	22.2984' RT	SURVEY WORK POINT, PIN
WES114	1991619.9750	2454914.1530	936.3560	IL26	944+83.06	26.3678' LT	SURVEY WORK POINT, PIN
WES115	1988685.5510	2455978.8970	936.7710	IL26	913+08.44	21.6464' RT	SURVEY WORK POINT, PK NAIL
WES116	1988218,6860	2455936.2840	938.4720	IL26	908+42.28	28.0217' LT	SURVEY WORK POINT, PK NAIL
WES117	1987733.1520	2455995.3090	936.1290	IL26	903+55.91	23.6542' RT	SURVEY WORK POINT, PK NAIL
WES118	1987270,0600	2455953,9210	948.0590	IL26	898+93.49	24.732' LT	SURVEY WORK POINT, PK NAIL
WES119	1986807.3450	2455962.9290	953.5050	IL26	894+30.70	22.7253' LT	SURVEY WORK POINT, PK NAIL
WES120	1986464,0410	2455957.4990	956.7580	IL26	890+87.52	33.4573' LT	SURVEY WORK POINT, PK NAIL
WES122	1988130.7010	2455987.5360	938.3750	IL26	907+53.53	21.8939' RT	SURVEY WORK POINT, NAIL
WES123	1989247,1850	2455977.2240	940,8310	IL26	918+70.04	28.4667' RT	SURVEY WORK POINT
WES124	1989024.5980	2456039.5920	941.7010	IL72	368+34.21	27.0105' RT	SURVEY WORK POINT
WES125	1989210,6710	2456127,8530	940,2050	IL72	369+94.44	102,3665' LT	SURVEY WORK POINT
WES126	1989005.1850	2456228.3140	938.6250	IL72	369+95.84	126.3581' RT	SURVEY WORK POINT
WES127	1989114.9650	2456409.3820	936.8800	IL72	372+06.60	105.978' RT	SURVEY WORK POINT, PK NAIL
WES128	1989276.7190	2456324.9630	936.5390	IL72	372+00.69	76.3844' LT	SURVEY WORK POINT, NAIL
WES129	1989625.6460	2457234.2340	922.9370	IL72	381+65.62	35.2636' LT	HORIZONTAL CONTROL STATION

CURVE POINT NUMBERS										
CHAIN	CURVE	PI	CC	PC	PT					
IL26	A01970240	01970240	1970241	1970242	1970243					
IL26	A01970250	01970250	1970251	1970252	1970253					
IL26	A019220	019220	19221	19222	19223					
IL26	A019230	019230	19231	19232	19233					
IL26	EX_CNTR_3	X_CNTR_3	1	2	3					
IL26	EX_CNTR_12	X_CNTR_12	1	2	3					
IL26	EX_CNTR_15	X_CNTR_15	1	2	3					

USER NAME = Andrew p.dewey	DESIGNED -	REVISED -
	DRAWN -	REVISED -
PLOT SCALE = \$SCALE\$	CHECKED -	REVISED -
PLOT DATE = 1/24/2025	DATE -	REVISED -

SCALE:

				I DIVO	F.A.P. RTE	SECTION	COUNTY	TOTAL SHEETS	SHEET NO.
ALIGNMENTS, TIES & BENCHMARKS			*	* (2, 3, 4)RS-7 & 115SW OGLE		132	49		
						*316 & 549	CONTRACT	NO. 64	P13
SHEET	OF	SHEETS	STA.	TO STA.	ILLINOIS FED. AID PROJECT				

ey.com.PWIDOT/Documents/IDOT 0 ces/District 2/ORD Projects/64P13/Program Development/Studies & Plans/Design/CADD/CAD

POINT	NORTH	EAST	CHAIN	STATION	OFFSET	DESCRIPTION
500	1989681,0830	2458456,8180	IL72	393+84.13	45.6712' LT	POWER POLE WITH TRANSFORMER
501	1989683,5600	2458407,2380	IL72	393+34.62	49.2762' LT	TELEPHONE SPLICE BOX
502	1989673.5800	2458328.1000	IL72	392+55.28	41.1003' LT	TELEPHONE SPLICE BOX, CENTER
		+	IL72		+	·
503 504	1989568,7990 1989638,2560	2457552.8030 2457549.4790	IL72	384+77.80 384+76.06	46.0046 RT 23.5101 LT	STORM SEWER, CENTER STORM SEWER, CENTER
505	1989570,5500	2457587,7820	IL72		45.0503 RT	MISC, CONCRETE SLAB
506	1989549.0900	2457187.7000	IL72	385+12.81 381+03.69	29.3503 RT	MISC. CONCRETE SLAB MISC. CONCRETE SLAB, CENTER
507	1989531.2650	2457177.5980	IL72	380+88.99	44.0863 RT	STORM SEWER, CENTER
508	1989520,4700	2457141.7380	IL72	380+50.05	44.7122' RT	CATCH BASIN PEREMITER, CORNER
509	1989320.4700	2456978.5300	IL72	378+74.79	30.3757' RT	CORNER, CENTER
510 510			IL72		44.1886' RT	STORM SEWER, CENTER
511	1989437.6570 1989489.7770	2456937.2790 2457000.3930	IL72	378+22.22 379+02.39	24.1376' RT	STORM SEWER, CENTER STORM SEWER, CENTER
						STORM SEWER, CENTER
512 513	1989413.3900 1989439.6600	2456727.7060 2456761.4700	IL72 IL72	376+22.86 376+64.68	24.8455' LT 33.8711' LT	CENTER, CENTER
514	1989439.0000	2456728,3740	IL72	376+53,40	86.7419' LT	STORM SEWER, CENTER
515	1989462,4000	2456515.2690	IL72	373+63.94	23.253' RT	STORM SEWER, CENTER STORM SEWER, CENTER
516		+	IL72		_	·
517	1989241.6590	2456532.4640	IL72	373+72.45	45.207' RT	STORM SEWER, CENTER
518	1989248.9140	2456515.7580	IL72	373+60.55	31.424' RT 20.4085' RT	CATCH PASIN PEREMITER CORNER
	1989206.9230	2456403.1300	<u> </u>	372+40.85	+	CATCH BASIN PEREMITER, CORNER
519	1989165.1050	2456384.1290	IL72	372+05.59	49.8468' RT	POWER POLE
520	1989173.0860	2456360.2900	IL72	371+87.58	32.3157' RT	WATER BUFFALO BOX
521	1989144.5810	2456159.5290	IL72	369+94.32	29.0778' LT	SANITARY SEWER, CENTER
522	1989165.9220	2456159.6880	IL72	370+03.72	48.2379' LT	STREET LIGHT
523	1989172,2070	2456225.1580	IL72	370+65.44	25.5041' LT	STREET LIGHT
524	1988993.4980	2455926.0240	IL26	916+17.16	26.5637' LT	FIRE HYDRANT
525	1988990.4020	2455925.1640	IL26	916+14.07	27.4704' LT	STREET LIGHT
526	1988994.0780	2455930.6460	IL26	916+17.67	21.9335' LT	WATER NAME
527	1989154.3060	2455915.9610	IL26	917+78.10	34.1938' LT	WATER PURELLO DOY
528	1989177.3990	2455928.8810	IL26	918+00.99	20.926' LT	WATER BUFFALO BOX
529	1989177.3780	2455924,0810	IL26	918+01.04	25.7258' LT	FIRE HYDRANT
530	1989589.6280	2455940.3700	IL26	922+08.66	23.0362' RT	FIRE HYDRANT
531	1989638.7210	2455911.5040	IL26	922+65.40	18.1644' RT	SANITARY SEWER, CENTER
532	1989932.4120	2455729.0370	IL26	926+09.09	19.4811' LT	STORM SEWER, CENTER
533	1989950,4060	2455720,9390	IL26	926+28.82	19,0042' LT	SANITARY SEWER, CENTER
534	1989966.5840	2455701.1810	IL26	926+51.95	29.8265' LT	POWER POLE WITH LIGHT
535	1990375.1540	2455518.6030	IL26	930+99.30	17.8311' LT	SANITARY SEWER, CENTER
536	1990422.7220	2455496.1830	IL26	931+51.88	17.4834' LT	CATCH BASIN PEREMITER, CORNER
537	1990408,3860	2455488,0310	IL26	931+42,48	31,0319' LT	HANDHOLE, CORNER
538	1990796.8480	2455368.8890	IL26	935+44.32	29.2477' RT	FIRE HYDRANT
539	1990776.0060	2455378.7010	IL26	935+21.28	29.1199' RT	WATER RUFFALO ROY
540	1990793.5320	2455356.7040	IL26	935+46.58	16.8232' RT	WATER BUFFALO BOX
541	1991615.5490	2454909.6250	IL26	944+81.01	32.3612' LT	POWER POLE WITH LIGHT
542	1991625.6560	2454895.0890	IL26	944+96.40	41.1225' LT	FIRE HYDRANT
543	1991651.8920	2454908.1210	IL26	945+14.46	18.0563' LT	SANITARY SEWER, CENTER
544	1988673.1180	2455974.1200	IL26	912+96.09	16.682 RT	SANITARY SEWER, CENTER

USER NAME = Andrew p.dewey	DESIGNED -	REVISED -
	DRAWN -	REVISED -
PLOT SCALE = \$SCALE\$	CHECKED -	REVISED -
PLOT DATE = 1/24/2025	DATE -	REVISED -

SCALE:

F.A.P. RTE			TOTAL SHEETS	SHEET NO.
*	(2, 3, 4)RS-7 & 115SW	OGLE	132	50
	*316 & 549 CONTRACT NO. 6			4P13
	ILLINOIS FED. AID PROJECT			
		* (2, 3, 4)RS-7 & 115SW * *316 & 549	* (2, 3, 4)RS-7 & 115SW OGLE *316 & 549 CONTRAC	* (2, 3, 4)RS-7 & 115SW OGLE 132 *316 & 549 CONTRACT NO. 64

			i	REFERENCE	TIES	
POINT	NORTH	EAST	CHAIN	STATION OFFSET		DESCRIPTION
546	1988709.6530	2455975.2490	IL26	913+32.60	18.3633' RT	STORM SEWER, CENTER
547	1988208.4670	2455946.5520	IL26	908+31.90	17.9094' LT	SANITARY SEWER, CENTER
548	1988247.8590	2455939.1610	IL26	908+71.40	24.7039' LT	WATER VALVE
549	1988172,1040	2455939,2610	IL26	907+95.66	25.7495' LT	FIRE HYDRANT
550	1987725.2030	2456006.0060	IL26	903+47.80	34.2298' RT	POWER POLE WITH LIGHT
551	1987745.9410	2455990,5780	IL26	903+68.77	19.1172' RT	SANITARY SEWER, CENTER
552	1987724.6400	2455997.7380	IL26	903+47.36	25.9542' RT	CATCH BASIN PEREMITER, CORNER
553	1987282.4030	2455960.5590	IL26	899+05.73	17.9081' LT	SANITARY SEWER, CENTER
554	1987251.1560	2456002.3310	IL26	898+73.86	23.3866' RT	POWER POLE WITH LIGHT
555	1987258.4470	2455906.9050	IL26	898+82.59	71.9182' LT	GUY POLE
556	1986796.1680	2455962,9690	IL26	894+19.53	22.8579' LT	WALL, CORNER
557	1986790.5160	2456009.9750	IL26	894+13.15	24.0552' RT	POWER POLE WITH LIGHT
558	1986837.0640	2455946.6570	IL26	894+60.66	38.543' LT	FIRE HYDRANT
559	1986468.5810	2455952.1680	IL26	890+92.15	38.7176' LT	WATER BUFFALO BOX
560	1986470,7390	2455973.0930	IL26	890+93,98	17.7617' LT	WATER BUFFALO BOX
561	1986454.9560	2455971.7530	IL26	890+78.22	19.3453' LT	SANITARY SEWER, CENTER

				ВЕ	NCH MARKS)	
POINT	NORTH	EAST	ELEVATION	CHAIN	STATION	OFFSET	DESCRIPTION
WES400	1989562.5800	2458326.2000	929.7010	IL72	392+50.85	69.8277' RT	FOUNDATION, CHISELED SQUARE
WES401	1989660.4950	2457550.6050	925.5010	IL72	384+77.69	45.7177' LT	POWER POLE WITH LIGHT, NAIL
WES402	1989545.1320	2456985.8710	925.4180	IL72	379+11.45	32.364' LT	POWER POLE WITH TRANSFORMER, NAIL
WES403	1989371.2100	2456581.9400	931.2540	IL72	374+73.22	50.0639' LT	FOUNDATION, CHISELED SQUARE
WES404	1989157.8790	2456338.8820	938.0130	IL72	371+61.69	36.7323' RT	STEP, CHISELED SQUARE
WES405	1989165.2650	2456158.9810	941.7360	IL72	370+02.80	47.9525' LT	MISC. CONCRETE SLAB, CHISELED SQUARE
WES406	1988990.6320	2455925.6700	943.4580	IL26	916+14.30	26.961' LT	MISC. CONCRETE SLAB, CHISELED SQUARE
WES407	1989495.4440	2455919.7210	938.9050	IL26	921+19.14	25.2755' LT	MISC. CONCRETE SLAB, CHISELED SQUARE
WES408	1989990.9880	2455753.1470	931.8050	IL26	926+51,49	27.5826' RT	POWER POLE, NAIL
WES409	1990417.2110	2455558.5090	933.3900	IL26	931+19.97	36.3349' RT	POWER POLE WITH LIGHT, NAIL
WES410	1990840.4940	2455339.8490	934.5940	IL26	935+96.22	21.852' RT	POWER POLE, NAIL
WES411	1991643.0210	2454968.2750	935.0140	IL26	944+80.53	32.4022' RT	POWER POLE, NAIL
WES412	1988707.4690	2455929.5030	939.0330	IL26	913+31.11	27.4105' LT	MISC. CONCRETE SLAB, CHISELED SQUARE
WES413	1988184.0430	2455983.6180	939.2830	IL26	908+06.92	18.783' RT	POWER POLE WITH LIGHT, NAIL
WES414	1987725.2030	2456006.0060	936.5560	IL26	903+47.80	34.2298' RT	POWER POLE WITH LIGHT, RAIL ROAD SPIKE
WES415	1987251.1560	2456002.3310	949.3090	IL26	898+73.86	23.3866' RT	POWER POLE WITH LIGHT, NAIL
WES416	1986787.9740	2455959.3220	952.9060	IL26	894+11.39	26.6311' LT	WALL, CHISELED SQUARE
WES417	1986425.8110	2455962.9840	957.6190	IL26	890+49.21	28.5635' LT	POWER POLE WITH LIGHT, NAIL

USER NAME = Andrew.p.dewey	DESIGNED -	REVISED -
	DRAWN -	REVISED -
PLOT SCALE = \$SCALE\$	CHECKED -	REVISED -
PLOT DATE = 1/24/2025	DATE -	REVISED -

SCALE:

ALICAMMENTO TIEC O DENICUMADICO					F.A.P. SECTION		COUNTY	TOTAL SHEETS	SHEET NO.
ALIGNMENTS, TIES & BENCHMARKS			*	* (2, 3, 4)RS-7 & 115SW OGLE 1		132	51		
					*316 & 549 CONTRACT NC			NO. 64	IP13
SHEET OF	SHEETS	STA.	TO STA.		ILLINOIS FED. AID PROJECT				

กษาเมาพมอบาวองเขาตาเรามอบ - จะระบารแนะ 2/จกม กับเราระจะการทายยูเล่า มีชายุทายาเราเนตรร & rianspessgriveคมระคงม

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Chain IL26 contains:
A01973 CUR A01970240 CUR A01970250 CUR A019220 CUR A019230 A06460 1046 1043 10-
44 1045 CUR EX_CNTR_3 1307 1308 1309 CUR EX_CNTR_12 CUR EX_CNTR_15 1310 1311 13-
12 1313 1314 1315 1316 1317 1318 1319 1320 1321 1322 1323 1324
Beginning chain IL26 description
Point A01973 N 1,959,638,9100 E 2,453,862,6000 Sta 608+97,19
Course from A01973 to PC A01970240 N 0° 47' 03.75" W Dist 12,463.8693'
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Curve Data

Curve A01970240 P.I. Station 745+90.68 N 1,973,331.1091 E 2,453,675.1432 Delta = 78° 41' 08.97" (RT) Degree = 3° 49' 10.99" Tangent = 1,229.6130'Length = 2,059.9901Radius = 1,500.0000' External = 439.5742Long Chord = 1,901.8808'Mid. Ord. = 339.9516' P.C. Station 733+61.06 N 1,972,101.6113 E 2,453,691.9760 P.T. Station 754+21.05 N 1,973,588.8284 E 2,454,877.4447 C.C. N 1,972,122.1456 E 2,455,191.8355

Course from PT A01970240 to PC A01970250 N 77° 54' 05.22" E Dist 268.0346'

Curve Data

Curve A01970250 P.I. Station 769+18.81 N 1,973,902.7492 E 2,456,341.9355 Delta = $78^{\circ} 41' 27.14'' (LT)$ Degree = 3° 49' 10.99" Tangent = 1,229.7235' Length = 2,060.1222Radius = 1.500.0000External = 439.6443'Long Chord = 1,901.9830Mid. Ord. = 339.9935P.C. Station 756+89.09 N 1,973,645.0068 E 2,455,139.5260 P.T. Station 777+49.21 N 1,975,132.3560 E 2,456,324.9929 C.C. N 1,975,111.6896 E 2,454,825.1352

Course from PT A01970250 to PC A019220 N 0° 47' 21.92" W Dist 3,052.5732'

Curve Data

Curve A019220 P.I. Station 813+80.06 N 1,978,762.8606 E 2,456,274.9686 Delta = 1° 48' 17.28" (LT) Degree = $0^{\circ} 09' 21.83"$ Tangent = 578.2760'Length = 1,156.4564Radius = 36,713.2260External = 4.5540Long Chord = 1,156.4085' Mid. Ord. = 4.5534P.C. Station 808+01.78 N 1,978,184.6395 E 2,456,282.9358 P.T. Station 819+58.24 N 1,979,340.5439 E 2,456,248.7945 C.C. N 1,977,678.8201 E 2,419,573.1944

Course from PT A019220 to PC A019230 N 2° 35' 39,20" W Dist 4,495,9144'

JSER NAME = Andrew.p.dewey DESIGNED -REVISED DRAWN REVISED HECKED REVISED PLOT DATE = 1/24/2025 REVISED DATE

STATE OF ILLINOIS **DEPARTMENT OF TRANSPORTATION**

SECTION COUNTY **ALIGNMENTS, TIES & BENCHMARKS** (2, 3, 4)RS-7 & 115SW OGLE

TO STA.

Curve Data Curve A019230 P.I. Station 869+12.65 N 1,984,289.8790 E 2,456,024.5465 Delta = 1° 42' 33.10" (RT) Degree = 0° 11' 11.06" Tangent = 458.4983' Length = 916.9287Radius = 30,737,3653' External = 3.4194Long Chord = 916.8947Mid. Ord. = 3.4191P.C. Station 864+54.15 N 1,983,831.8506 E 2,456,045.2992 P.T. Station 873+71.08 N 1,984,748.3227 E 2,456,017.4645 C.C. N 1,985,223.0935 E 2,486,751.1630 Course from PT A019230 to A06460 N 0° 53' 06.10" W Dist 2,068.9541' Point A06460 N 1,986,817.0300 E 2,455,985.5074 Sta 894+40.04

Course from A06460 to 1046 N 0° 51' 59.29" W Dist 2,710.8225'

Point 1046 N 1,989,527.5425 E 2,455,944.5139 Sta 921+50.86

Course from 1046 to 1043 N 25° 32' 51.10" W Dist 180.6262'

Point 1043 N 1,989,690.5085 E 2,455,866.6171 Sta 923+31.49

Course from 1043 to 1044 N 25° 36' 52.06" W Dist 1,064.1710'

Point 1044 N 1.990.650.0964 E 2.455.406.5618 Sta 933+95.66

Course from 1044 to 1045 N 25° 31' 40.46" W Dist 2,877.8787'

Point 1045 N 1.993.247.0236 E 2.454.166.3381 Sta 962+73.54

Course from 1045 to PC EX_CNTR_3 N 25° 31' 40.46" W Dist 142.9410'

Curve Data

Curve EX CNTR 3 P.I. Station 980+53.51 N 1,994,853.2252 E 2,453,399.2587 Delta = 65° 28' 14.37" (LT) Degree = 2° 15' 00.00" Tangent = 1,637.0293' Length = 2,909.8081Radius = 2,546.4800External = 480.8002'Long Chord = 2,754.0645Mid. Ord. = 404.4383P.C. Station 964+16.48 N 1,993,376.0101 E 2,454,104.7376 P.T. Station 993+26.28 N 1,994,824.6961 E 2,451,762.4780 C.C. N 1,992,278.6028 E 2,451,806.8564

Course from PT EX CNTR 3 to 1307 S 89° 00' 05.17" W Dist 2,294.7302'

Point 1307 N 1,994,784.7050 E 2,449,468.0963 Sta 1016+21.02

Course from 1307 to 1308 S 88° 50' 03.15" W Dist 1,235.8087'

Point 1308 N 1,994,759.5619 E 2,448,232.5434 Sta 1028+56.82

Course from 1308 to 1309 S 88° 42' 04.30" W Dist 1,550.2981'

Point 1309 N 1,994,724.4221 E 2,446,682.6436 Sta 1044+07.12

Course from 1309 to PC EX CNTR 12 S 88° 47' 27.66" W Dist 2,142.3926'

Curve Data

SCALE:

Curve EX_CNTR_12 P.I. Station 1070+64.39 N 1,994,668.3558 E 2,444,025.9625 Delta = 40° 55' 16.44" (RT) Degree = 4° 09' 06.73" Tangent = 514.8800'Length = 985.6102'Radius = 1,380.0000External = 92.9227Long Chord = 964.7952'Mid. Ord. = 87.0605P.C. Station 1065+49.51 N 1,994,679.2194 E 2,444,540.7279 P.T. Station 1075+35.12 N 1,994,997.3293 E 2,443,629.8844 C.C. N 1,996,058.9122 E 2,444,511.6110

SHEET OF SHEETS STA.

Course from PT EX CNTR 12 to PC EX CNTR 15 N 50° 17' 15.90" W Dist 693.7419'

132 52 *316 & 549 CONTRACT NO. 64P13

Curve Data

Curve EX_CNTR_15 P.I. Station 1088+40.82 N 1,995,831.5831 E 2,442,625.4580 Delta = $48^{\circ} 49' 45.17'' (RT)$ Degree = 4° 14' 59.95"

Tangent = 611.9579Length = 1,148.9261Radius = 1,348.1400' External = 132.3916Long Chord = 1,114.4712'

Mid. Ord. = 120.5530P.C. Station 1082+28.87 N 1,995,440.5834 E 2,443,096.2145 P.T. Station 1093+77.79 N 1,996,443.3427 E 2,442,609.8815 C.C. N 1,996,477.6576 E 2,443,957.5847

Course from PT EX CNTR 15 to 1310 N 1° 27' 30.72" W Dist 1,350.1576'

Point 1310 N 1,997,793,0628 E 2,442,575,5153 Sta 1107+27,95

Course from 1310 to 1311 N 1° 24' 47.57" W Dist 761.2401'

Point 1311 N 1,998,554.0714 E 2,442,556.7410 Sta 1114+89.19

Course from 1311 to 1312 N 1° 31' 11.55" W Dist 972.3060'

Point 1312 N 1,999,526.0354 E 2,442,530.9518 Sta 1124+61.50

Course from 1312 to 1313 N 1° 29' 32.22" W Dist 2,599.9495'

Point 1313 N 2,002,125.1031 E 2,442,463.2431 Sta 1150+61.45

Course from 1313 to 1314 N 1° 27' 32.02" W Dist 2.724.3591'

Point 1314 N 2,004,848.5791 E 2,442,393.8817 Sta 1177+85.81

Course from 1314 to 1315 N 1° 35' 43.86" W Dist 399.8302'

Point 1315 N 2,005,248.2543 E 2,442,382.7490 Sta 1181+85.64

Course from 1315 to 1316 N 1° 45' 32.91" W Dist 498.4295'

Point 1316 N 2,005,746.4488 E 2,442,367.4482 Sta 1186+84.06

Course from 1316 to 1317 N 1° 48' 19.13" W Dist 1,207.0643'

Point 1317 N 2,006,952,9140 E 2,442,329,4215 Sta 1198+91.13 Course from 1317 to 1318 N 1° 50' 23.33" W Dist 3,033.3538'

Point 1318 N 2,009,984.7041 E 2,442,232.0348 Sta 1229+24.48

Course from 1318 to 1319 N 1° 51' 04.41" W Dist 3,487.5147'

Point 1319 N 2,013,470.3985 E 2,442,119.3730 Sta 1264+12.00

Course from 1319 to 1320 N 1° 44' 10.94" W Dist 781.5025'

Point 1320 N 2,014,251.5422 E 2,442,095.6929 Sta 1271+93.50

Course from 1320 to 1321 N 1° 57' 16.23" W Dist 351.4619'

Point 1321 N 2,014,602.7997 E 2,442,083.7059 Sta 1275+44.96

Course from 1321 to 1322 N 1° 42' 36.95" W Dist 399.5084'

Point 1322 N 2,015,002.1301 E 2,442,071.7825 Sta 1279+44.47

Course from 1322 to 1323 N 1° 38' 29.50" W Dist 698.6856'

Point 1323 N 2,015,700.5290 E 2,442,051.7678 Sta 1286+43.16

Course from 1323 to 1324 N 1° 34' 50,03" W Dist 358,8658'

Point 1324 N 2,016,059.2582 E 2,442,041.8694 Sta 1290+02.02

Ending chain IL26 description

Chain IL72 contains: 1047 CUR 200 CUR A076210

Beginning chain IL72 description

Point 1047 N 1,989,012.5560 E 2,455,952.3025 Sta 367+50.34

Course from 1047 to PC 200 N 64° 17' 42.05" E Dist 1,118.9360'

Curve Data

Curve 200 P.I. Station 381+19.62 N 1,989,606.4652 E 2,457,186.0798 Delta = $24^{\circ} 24' 02.11'' (RT)$ Degree = 4° 56' 54.16" Tangent = 250.3465Length = 493.1026Radius = 1.157.8697External = 26.7550Long Chord = 489.3847'

Mid. Ord. = 26.1507' P.C. Station 378+69.27 N 1.989.497.8806 E 2.456.960.5078 P.T. Station 383+62.37 N 1,989,612.1641 E 2,457,436.3614

C.C. N 1,988,454.5945 E 2,457,462.7193

Course from PT 200 to PC A076210 N 88° 41' 44.16" E Dist 8,402,6772'

Curve Data

Curve A076210 P.I. Station 472+65.02 N 1,989,814.8251 E 2,466,336.7008 Delta = 0° 12' 29.63" (RT) Degree = 0° 01' 14.97"

Tangent = 499.9692Length = 999.9373'Radius = 275,138.6112' External = 0.4543'Long Chord = 999.9367'Mid. Ord. = 0.4543

P.C. Station 467+65.05 N 1,989,803.4437 E 2,465,836.8611 P.T. Station 477+64.99 N 1,989,824.3898 E 2,466,836.5785

C.C. N 1,714,736.1309 E 2,472,100.1513

Ending chain IL72 description

Chain IL72_N contains: 1049 1048

Beginning chain IL72 N description

Point 1049 N 1,989,527.5425 E 2,455,944.5139 Sta 364+98.00

Course from 1049 to 1048 S 25° 32' 51.10" E Dist 467.4030'

Point 1048 N 1,989,105.8385 E 2,456,146.0860 Sta 369+65.40

SCALE:

Ending chain IL72 N description

USER NAME = Andrew.p.dewey	DESIGNED -	REVISED -
	DRAWN -	REVISED -
PLOT SCALE = \$SCALE\$	CHECKED -	REVISED -
PLOT DATE = 1/24/2025	DATE -	REVISED -

				DI/O	F.A.P. RTE	SECTION	COUNTY	TOTAL SHEETS	SHEET NO.
ALIGNMENTS, TIES & BENCHMARKS					*	(2, 3, 4)RS-7 & 115SW	OGLE	132	53
						*316 & 549	CONTRAC	T NO. 64	₽13
SHEET	OF	SHEETS	STA.	TO STA.		ILLINOIS FED. A	AID PROJECT		

Chain ASH contains: 1085 1086 1087 Beginning chain ASH description ______ Point 1085 N 1,989,065.3056 E 2,456,407.7148 Sta 148+50.00 Course from 1085 to 1086 N 25° 43' 34.28" W Dist 150.0000' Point 1086 N 1,989,200.4374 E 2,456,342.6042 Sta 150+00.00 Course from 1086 to 1087 N 25° 43' 34.28" W Dist 150.0000' Point 1087 N 1,989,335.5692 E 2,456,277.4935 Sta 151+50.00 ______ Ending chain ASH description Chain AVON contains: 1072 1073 1074 Beginning chain AVON description ______ Point 1072 N 1,989,894.9890 E 2,455,602.2407 Sta 98+50.00 Course from 1072 to 1073 N 64° 51' 56.45" E Dist 150.0000' Point 1073 N 1,989,958.7002 E 2,455,738.0379 Sta 100+00.00 Course from 1073 to 1074 N 64° 51' 56.45" E Dist 150.0000' Point 1074 N 1,990,022,4115 E 2,455,873,8351 Sta 101+50,00 ______ Ending chain AVON description Chain BALSAM contains: 1066 1067 Beginning chain BALSAM description _______ Point 1066 N 1,989,134.9248 E 2,455,800.4356 Sta 68+50.00 Course from 1066 to 1067 N 88° 55' 52.17" E Dist 150.0000' Point 1067 N 1,989,137.7228 E 2,455,950.4095 Sta 70+00.00 Ending chain BALSAM description

Chain BIRCH contains: 1061 1062

Beginning chain BIRCH description

Point 1061 N 1,988,206.7256 E 2,455,814.4737 Sta 48+50.00

Course from 1061 to 1062 N 89° 20' 41.91" E Dist 150.0000'

Point 1062 N 1,988,208.4404 E 2,455,964.4638 Sta 50+00.00

Ending chain BIRCH description

Chain CHERRY contains:

1063 1064 1065

Beginning chain CHERRY description

Point 1063 N 1,988,671.6108 E 2,455,807.4426 Sta 58+50.00

Course from 1063 to 1064 N 89° 19' 17.36" E Dist 150,0000'

Point 1064 N 1.988.673.3871 E 2.455.957.4320 Sta 60+00.00

Course from 1064 to 1065 N 89° 19' 17.36" E Dist 150.0000'

Point 1065 N 1.988.675.1634 E 2.456.107.4215 Sta 61+50.00

Ending chain CHERRY description

Chain CHESNUT contains:

1088 1089 1090

Beginning chain CHESNUT description

Point 1088 N 1,989,156.1817 E 2,456,596.4994 Sta 158+50.00

Course from 1088 to 1089 N 25° 41' 58.05" W Dist 150.0000'

Point 1089 N 1,989,291.3439 E 2,456,531.4518 Sta 160+00.00

Course from 1089 to 1090 N 25° 41' 58.05" W Dist 150.0000'

Point 1090 N 1,989,426.5060 E 2,456,466.4042 Sta 161+50.00

Ending chain CHESNUT description

Chain ELM contains: 1058 1059 1060

Beginning chain ELM description

Point 1058 N 1,987,744.4857 E 2,455,821.4639 Sta 38+50.00

Course from 1058 to 1059 N 89° 15' 59.64" E Dist 150.0000'

Point 1059 N 1,987,746.4057 E 2,455,971.4516 Sta 40+00.00

Course from 1059 to 1060 N 89° 15' 59.64" E Dist 150.0000'

Point 1060 N 1,987,748.3258 E 2,456,121.4393 Sta 41+50.00

Ending chain ELM description

SCALE:

USER NAME = Andrew.p.dewey	DESIGNED -	REVISED -
	DRAWN -	REVISED -
PLOT SCALE = \$SCALE\$	CHECKED -	REVISED -
PLOT DATE = 1/24/2025	DATE -	REVISED -

STATE OF ILLINOIS **DEPARTMENT OF TRANSPORTATION**

ALICAIRATAITE TITE O DENIGURAADVE						SECTION	COUNTY	TOTAL SHEETS	SHEET NO.
ALIGNMENTS, TIES & BENCHMARKS					*	(2, 3, 4)RS-7 & 115SW	OGLE	132	54
					_	*316 & 549	CONTRAC	Γ NO. 64	IP13
SHEET	OF	SHEETS	STA.	TO STA.		ILLINOIS FED. A	ID PROJECT		

Chain ESTATE contains: 1068 1069 Beginning chain ESTATE description ______ Point 1068 N 1,989,536,3699 E 2,455,940,2945 Sta 80+00.00 Course from 1068 to 1069 N 65° 22' 57.92" E Dist 150.0000' Point 1069 N 1,989,598.8530 E 2,456,076.6611 Sta 81+50.00 ______ Ending chain ESTATE description Chain GREEN contains: 1075 1076 1077 Beginning chain GREEN description _____ Point 1075 N 1,990,319.4807 E 2,455,398.7208 Sta 108+50.00 Course from 1075 to 1076 N 64° 24' 33.96" E Dist 150.0000' Point 1076 N 1,990,384.2713 E 2,455,534.0064 Sta 110+00.00 Course from 1076 to 1077 N 64° 24' 33,96" E Dist 150,0000' Point 1077 N 1,990,449.0618 E 2,455,669.2919 Sta 111+50.00 ______ Ending chain GREEN description Chain LOCUST contains: 1101 1102 1103 Beginning chain LOCUST description ______ Point 1101 N 1.989.430.3836 E 2.457.201.6018 Sta 188+50.00 Course from 1101 to 1102 N 25° 37' 55.96" W Dist 150.0000' Point 1102 N 1,989,565.6220 E 2,457,136.7129 Sta 190+00.00 Course from 1102 to 1103 N 25° 37' 55.96" W Dist 150.0000' Point 1103 N 1,989,700.8604 E 2,457,071.8240 Sta 191+50.00 ______ Ending chain LOCUST description Chain LOGAN contains: 1078 1079 1080 Beginning chain LOGAN description ______ Point 1078 N 1,990,744.2925 E 2,455,195.3533 Sta 118+50.00 Course from 1078 to 1079 N 64° 54' 57.25" E Dist 150.0000' Point 1079 N 1,990,807.8848 E 2,455,331.2063 Sta 120+00.00 Course from 1079 to 1080 N 64° 54' 57.25" E Dist 150.0000' Point 1080 N 1.990.871.4770 E 2.455.467.0592 Sta 121+50.00 ______ Ending chain LOGAN description

Chain MAGNOLIA contains: 1081 1082

Beginning chain MAGNOLIA description

Point 1081 N 1,991,593.9217 E 2,454,789.5963 Sta 128+50.00

Course from 1081 to 1082 N 63° 53' 52.03" E Dist 150.0000'

Point 1082 N 1,991,659.9178 E 2,454,924.2978 Sta 130+00.00

Ending chain MAGNOLIA description

Chain MASTERSON contains:

1106 1107

Beginning chain MASTERSON description

Point 1106 N 1,989,633.3279 E 2,458,365.8192 Sta 210+00.00

Course from 1106 to 1107 N 1° 43' 22.11" W Dist 100.0000'

Point 1107 N 1,989,733,2827 E 2,458,362,8128 Sta 211+00,00

Ending chain MASTERSON description

Chain MEADOWCT contains: 1050 1051

Beginning chain MEADOWCT description

Point 1050 N 1,986,451.7893 E 2,455,891.1382 Sta 9+00.00

Course from 1050 to 1051 N 88° 55' 36.24" E Dist 100.0000'

Point 1051 N 1,986,453.6624 E 2,455,991.1206 Sta 10+00.00

Ending chain MEADOWCT description

Chain OAK contains:

1095 1096 1097

Beginning chain OAK description

Point 1095 N 1,989,261.1068 E 2,456,814.4629 Sta 168+50.00

Course from 1095 to 1096 N 25° 21' 43.20" W Dist 150.0000'

Point 1096 N 1,989,396.6497 E 2,456,750.2125 Sta 170+00.00

Course from 1096 to 1097 N 25° 21' 43.20" W Dist 150.0000'

Point 1097 N 1,989,532.1927 E 2,456,685.9621 Sta 171+50.00

Ending chain OAK description

SCALE:

USER NAME = Andrew.p.dewey	DESIGNED -	REVISED -	
	DRAWN -	REVISED -	
PLOT SCALE = \$SCALE\$	CHECKED -	REVISED -	
PLOT DATE = 1/24/2025	DATE -	REVISED -	

STATE OF	ILLINOIS
DEPARTMENT OF	TRANSPORTATION

				14 B1/0				TOTAL SHEETS	SHEET NO.
ALIGNMENTS, TIES & BENCHMARKS					* (2, 3, 4)RS-7 & 115SW OGLE 13			132	55
						*316 & 549	CONTRACT	NO. 64	P13
SHEET	OF	SHEETS	STA.	TO STA.	TILLINOIS FED AID PROJECT				

Chain PINE contains: 1055 1056 1057 Beginning chain PINE description Point 1055 N 1,987,280.4256 E 2,455,828.4823 Sta 28+50.00 Course from 1055 to 1056 N 89° 00' 21,23" E Dist 150,0000' Point 1056 N 1,987,283,0280 E 2,455,978,4597 Sta 30+00,00 Course from 1056 to 1057 N 89° 00' 21.23" E Dist 150.0000' Point 1057 N 1,987,285.6304 E 2,456,128.4371 Sta 31+50.00 ______ Ending chain PINE description Chain PLUM contains: 1098 1099 1100 Beginning chain PLUM description _____ Point 1098 N 1,989,351.1594 E 2,457,001.5396 Sta 178+50.00 Course from 1098 to 1099 N 25° 27' 19.52" W Dist 150.0000' Point 1099 N 1,989,486.5974 E 2,456,937.0683 Sta 180+00.00 Course from 1099 to 1100 N 25° 27' 19.52" W Dist 150.0000' Point 1100 N 1,989,622.0354 E 2,456,872.5970 Sta 181+50.00 ______ Ending chain PLUM description Chain SCHOOLENTR contains: 1104 1105 Beginning chain SCHOOLENTR description ______ Point 1104 N 1,989,515.6146 E 2,457,589.0324 Sta 199+00.00 Course from 1104 to 1105 N 1° 16' 17.23" W Dist 100.0000' Point 1105 N 1,989,615.5899 E 2,457,586.8135 Sta 200+00.00 ______ Ending chain SCHOOLENTR description Chain WALNUT contains: 1083 1084 Beginning chain WALNUT description ______ Point 1083 N 1,988,969.2836 E 2,456,208.2379 Sta 138+50.00 Course from 1083 to 1084 N 25° 29' 22.59" W Dist 150.0000' Point 1084 N 1,989,104.6831 E 2,456,143.6858 Sta 140+00.00 ______ Ending chain WALNUT description

Chain WHITEOAK contains: 1070 1071

Beginning chain WHITEOAK description

Point 1070 N 1,989,595.9171 E 2,455,760.9462 Sta 88+50.00

Course from 1070 to 1071 N 89° 17' 00,23" E Dist 150,0000'

Point 1071 N 1.989.597.7931 E 2.455.910.9345 Sta 90+00.00

Ending chain WHITEOAK description

Chain WILLOW contains:

1052 1053 1054

Beginning chain WILLOW description

Point 1052 N 1,986,812.3375 E 2,455,885.6048 Sta 19+00.00

Course from 1052 to 1053 N 87° 33' 32.85" E Dist 100.0000'

Point 1053 N 1,986,816.5964 E 2,455,985.5141 Sta 20+00.00

Course from 1053 to 1054 N 87° 33' 32.85" E Dist 100.0000'

Point 1054 N 1,986,820.8552 E 2,456,085.4233 Sta 21+00.00

Ending chain WILLOW description

SCALE:

USER NAME = Andrew.p.dewey	DESIGNED -	REVISED -
	DRAWN -	REVISED -
PLOT SCALE = \$SCALE\$	CHECKED -	REVISED -
PLOT DATE = 1/24/2025	DATE -	REVISED -

STATE OF ILLINOIS
DEPARTMENT OF TRANSPORTATION

			DE11011111111		F.A.P. RTE	SECTION		COUNTY	TOTAL SHEETS	SHEET NO.
ALIGNMENTS, TIES & BENCHMARKS				*	* (2, 3, 4)RS-7 & 115SW OGLE 13			132	56	
						*316 & 549		CONTRACT	T NO. 64	₽13
SHEET	OF	SHEETS	STA	TO STA		TI LINOIC E	CD AIR	DROJECT		

STATE OF ILLINOIS **DEPARTMENT OF TRANSPORTATION**

	SHEET	INDEX
SHEET NO.	STATION to STATION	DESCRIPTION
1		COVERSHEET
2		LEGENDS & STATEMENTS
3		PARCEL INDEX
4	890+50 to 891+50	ROW & EASEMENT PLAT
5	894+00 to 895+00	ROW & EASEMENT PLAT
6	898+30 to 899+60	ROW & EASEMENT PLAT
7	903+00 to 904+50	ROW & EASEMENT PLAT
8	907+50 TO 909+00	ROW & EASEMENT PLAT
9	912+35 TO 913+60	ROW & EASEMENT PLAT
10	915+90 TO 917+50	ROW & EASEMENT PLAT
11	919+50 TO 920+50	ROW & EASEMENT PLAT
12	920+50 TO 923+00	ROW & EASEMENT PLAT
13	925+50 TO 927+00	ROW & EASEMENT PLAT
14	930+50 TO 931+50	ROW & EASEMENT PLAT
15	935+00 TO 936+50	ROW & EASEMENT PLAT
16	369+65 TO 372+50	ROW & EASEMENT PLAT
17	373+00 TO 375+50	ROW & EASEMENT PLAT
18	375+00 TO 377+50	ROW & EASEMENT PLAT
19	377+00 TO 379+50	ROW & EASEMENT PLAT
20	379+50 TO 382+00	ROW & EASEMENT PLAT
21	890+00 TO 904+00	OVERALL IL. RTE. 26
22	903+00 to 918+00	OVERALL IL. RTE. 26
23	916+00 to 931+00	OVERALL IL. RTE. 26
24	930+00 to 941+00	OVERALL IL. RTE. 26
25	367+50 to 382+00	OVERALL IL. RTE. 72

PLAT OF HIGHWAYS

SPACE RESERVED FOR RECORDING OFFICER

STEPHENSON WINNEBAGO BOONE

OGLE

LEE

DISTRICT 2

JO DAVIESS

CARROLL

FAP ROUTE 316 (IL 26) & FAP ROUTE 549 (IL 72) **SECTION (2,3,4)RS-7 & 115SW OGLE COUNTY** JOB NO. R-92-009-20

WHITESIDE **ROCK ISLAND HENRY ACQUISITION ENDS** R.8E STA, 936 + 18 * DISTRICT HEADQUARTERS LOCATION OF SECTION INDICATED THUS: ACQUISITION ENDS STA.380 + 89**ACQUISITION BEGINS** STA.891 + 08

PREPARED BY:

ILLINOIS IOWA WISCONSIN

ASE JOB # 118152.5

USER NAME = \$USER\$	DESIGNED -	REVISED -		PLAT OF HIGHWAYS		F.A.P.	SECTION	COUNTY	TOTAL SHEET	
	DRAWN -	REVISED -	STATE OF ILLINOIS	LAND S	ECTION 28, 33	T 25N, R 8E OF 4TH P.M.	316 & 549	(2.3.4)RS-7 & 115SW	OGLE	132 57
PLOT SCALE = \$SCALE\$	CHECKED -	REVISED -	DEPARTMENT OF TRANSPORTATION	JOB#	R-92-009-20	DRAWER FOLDER		(-1-) () (-1-)	CONTRACT	NO. 64P13
PLOT DATE = 4/5/2024	DATE -	REVISED -		SCALE: NTS	SHEET 1 OF 25 SHEETS	STA. 891+08 TO STA. 936+18		ILLINOIS FED. /	JD PROJECT	

LEGEND FOR EXISTING TOPOGRAPHIC SYMBOLS

TRAFFIC SIGNAL GULFBOX	0	DRAINAGE FLOW LINE	FL
TRAFFIC SIGNAL HANDHOLE		RIP RAP	PONOONOS
TRAFFIC SIGNAL SIGNAL POST	0	HEADWALL	_
TRAFFIC SIGNAL STEEL MAST ARM	0	CULVERT END SECTION	◁
TRAFFIC SIGNAL PEDESTRIAN PUSH BUTTON	•	DRAINAGE MANHOLE	0
TRAFFIC SIGNAL WOODEN POLE	8	INLET	
TRAFFIC SIGNAL VEHICLE DETECTION PRIORITY	⋖	ROADWAY DITCH FLOW	- ∼>
TRAFFIC SIGNAL VEHICLE DETECTION MAGNET	D	VEGETATION LINE	~~~~
TRAFFIC SIGNAL JUNCTION BOX	0	STUMP	R
TRAFFIC SIGNAL CONTROLLER	\boxtimes	SHRUB	0
TRAFFIC SIGNAL HEAVY DUTY HANDHOLE	H	EVERGREEN TREE	•
RAILROAD CANTILEVER MAST ARM	XOX X X	DECIDUOUS TREE	③
RAILROAD CROSSBUCK	X -	WOODS/BUSH LINE	
RAILROAD TRACK	######	TRAFFIC SIGN	þ
RAILROAD TRACK (ABANDONED)	-+	GUARDRAIL POST	0
RAILROAD CROSSGATE	20 ₹>	GUARDRAIL	0 0 0 0 0 0 0
RAILROAD CONTROL BOX	\boxtimes	FIELD LINE	E
RAILROAD FLASHING SIGNAL	⊠⊕ ⊠	LEVEE/NOISE BARRIER	
UTILITY TELEPHONE SPLICE BOX	⊞	FENCE	$- \ \imath - \imath - \imath - \imath - \imath - \imath - \imath -$
UTILITY POWER POLE	-0-	MAIL BOX	P
UTILITY TRAFFIC SIGNAL	Ф	ADVERTISING SIGN	þ
UTILITY LIGHT POLE	¤	MARSH	يتتلتير
UTILITY FIRE HYDRANT	Ø	LIGHTING HANDHOLE	
UTILITY MANHOLE	0	LIGHTING POWER POLE	-0-
UTILITY TELEPHONE POLE	-0-	LIGHTING JUNCTION BOX	0
UTILITY GUY ANCHOR	\leftarrow	LIGHTING HEAVYDUTY HANDHOLE	H
UTILITY PIPELINE WARNING SIGN	þ	LIGHTING CONTROLLER	⊠
UTILITY HANDHOLE		LIGHTING PULL POINT	Ø
UTILITY SPLICE BOX	⊞	HIGHWAY LIGHTING ELECTRICAL GROUND	→
UTILITY JUNCTION BOX	0	HIGHWAY LIGHTING SINGLE UNIT	\longrightarrow
UTILITY HEAVY DUTY HANDHOLE	H	HIGHWAY LIGHTING DOUBLE UNIT	\bigcirc
UTILITY DOUBLE HANDHOLE		EXISTING CONCRETE BARRIER	
UTILITY CONTROLLER	\boxtimes	EXISTING CREEK OR DITCH	
UTILITY WATER METER	0	EXISTING EDGE OF PAVEMENT	

BASIS OF COORDINATE & BEARING STATEMENT

ALL COORDINATES, BEARINGS AND DISTANCES SHOWN HEREON ARE BASED ON ILLINOIS STATE PLANE (WEST ZONE) NAD83 (2011 ADJUSTMENT)

GROUND DISTANCE = GRID DISTANCE DIVIDED BY PROJECT COMBINATION FACTOR OF 0.99993535

AREAS SHOWN BASED ON GROUND DISTANCES

TOPOGRAPHIC STATEMENT

THE TOPOGRAPHY SHOWN HEREON WAS PROVIDED TO THE SURVEYOR BY THE ILLINOIS DEPARTMENT OF TRANSPORTATION. THE SURVEYOR VISUALLY FIELD VERIFIED THE EXISTENCE OF THE TOPOGRAPHY SHOWN HEREON. IN ADDITION THE SURVEYOR PHYSICALLY LOCATED IN THE FIELD THE FOLLOWING ITEMS ON __/_/_:

PREPARED BY:



ILLINOIS IOWA WISCONSIN

ENGINEERING & ENVIRONMENTAL

FEHR GRAHAM JOB NO. 19-148K & 19-148N

ASE JOB # 118152.5

RIGHT OF WAY LEGEND







— – — EXISTING CENTERLINE — — EXISTING RIGHT-OF-WAY LINE

---- FORMER RIGHT OF WAY LINE ----- BUILDING SETBACK LINE - — AC — EXISTING ACCESS CONTROL LINE

— - - PROPOSED RIGHT-OF-WAY LINE 77 77 77 77 77 77 7 PROPOSED TEMPORARY EASEMENT LINE PROPOSED PERMANENT EASEMENT LINE

— - - - — SECTION LINE QUARTER SECTION LINE — – — QUARTER QUARTER SECTION LINE PROPERTY LINE (TITLE)

APPARENT PROPERTY LINE SAME OWNERSHIP 121.45 MEASURED DIMENSION (121.45') RECORDED DIMENSION

- - - - - - RECORDED PLAT/DEED LINE

FOUND STONE FOUND IRON PIPE OR IRON ROD AT CORNER UNLESS OTHERWISE NOTED SET 5/8 INCH IRON ROD WITH PLASTIC CAP

IDENTIFIED BY SURVEYORS LICENSE NUMBER AT CORNER UNLESS OTHERWISE NOTED PERMANENT SURVEY MONUMENT,

I.D.O.T. STD. 667101 (TO BE SET BY OTHERS) SET 5/8 INCH IRON ROD AS SURVEY

CONTROL UNLESS OTHERWISE NOTED FOUND CUT CROSS

SET CUT CROSS STAKING OF PROPOSED RIGHT-OF-WAY AND PERMANENT

EASEMENT CORNERS. SET 5/8 INCH METAL ROD WITH DEPARTMENT OF TRANSPORTATION SURVEY ALUMINUM CAP TO MONUMENT THE POSITION SHOWN. IDENTIFIED BY INSCRIPTION DATA AND SURVEYORS LICENSE NUMBER. STAKING OF PROPOSED RIGHT-OF-WAY AND PERMANENT

EASEMENT CORNERS IN CULTIVATED AREA. A MINIMUM OF 20 INCHES BELOW THE GROUND SURFACE. SET 5/8 INCH METAL ROD WITH DIVISION OF HIGHWAY SURVEY ALUMINUM CAP TO MONUMENT THE POSITION SHOWN. IDENTIFIED BY INSCRIPTION DATA AND SURVEYORS

STAKING OF PROPOSED RIGHT-OF-WAY AND PERMANENT EASEMENT CORNERS. SET LARGE TIMBER NAIL OR

LEGEND FOR ABBREVIATIONS

ACRE

AVENUE

AC

AVE

BK

CAB

СН

Ch

CP

CPS

DB

EX

FΑ

FΔP

FAS

FAU

FND

ha

LT

ACCESS CONTROL

BOOK BLVD BOULEVARD CENTERLINE CABINET COUNTY HIGHWAY CHAIN CONTROL POINT COTTON PICKER SPINDLE DEED BOOK EAST EXISTING FEDERAL AID FEDERAL AID INTERSTATE FEDERAL AID PRIMARY FEDERAL AID SECONDARY FEDERAL AID URBAN FOUND HECTARE IRON PIPE IRON ROD LEFT METER SQUARE METERS NORTH

N/F NOW OR FORMERLY N & BC NAIL AND BOTTLE CAP N & C NAIL AND CAP NAIL AND WASHER N & W NE NORTHEAST NORTHWEST PB PLAT BOOK PG PAGE POB POINT OF BEGINNING POC POINT OF COMMENCEMENT POT POINT ON TANGENT PROPERTY LINE PROPOSED

RANGE RD ROAD REC RECORD ROW RIGHT-OF-WAY RR RAILROAD RRS RAILROAD SPIKE RT RIGHT RTE ROUTE SOUTH STATE BOND ISSUE

SE SOUTHEAST SEC SECTION SQ FT SQUARE FEET SR STATE ROUTE ST STREET STA STATION SMK SURVEY MARKER SW SOUTHWEST TOWNSHIP TOWNSHIP ROAD USGS U.S. GEOLOGICAL SURVEY

WEST

PROPOSED PARCEL NUMBER LEGEND

8001001 8001001PE 8001001TE 8001001DFD 8001001AC

PROPOSED FEE SIMPLE ACQUISITION PROPOSED PERMANENT EASEMENT PROPOSED TEMPORARY EASEMENT PROPOSED DEDICATION PROPOSED ACCESS CONTROL LINE

CURVE ABBREVIATIONS

POINT OF INTERSECTION PT POINT OF TANGENCY POINT OF REVERSE CURVE PCC POINT OF COMPOUND CURVE RADIUS OF CURVE LENGTH OF CURVE CB CHORD BEARING CHORD LENGTH DEGREE OF CURVE EXTERNAL ORDINATE DELTA

USER NAME = \$USER\$ DESIGNED -REVISED DRAWN REVISED CHECKED REVISED PLOT DATE = 4/30/2024 REVISED DATE

STATE OF ILLINOIS **DEPARTMENT OF TRANSPORTATION**

PLAT OF HIGHWAYS SECTION COUNTY T 25N, R 8E OF 4TH P.M. LAND SECTION 28, 33 316 & 549 (2,3,4)RS-7 & 115SW OGLE 132 58 JOB# R-92-009-20 DRAWER FOLDER CONTRACT NO. 64P13

PARCEL NO.	OWNER	SHEET NUMBER(S)	PERMANENT TAX NUMBER(S) AFFECTED	PROPERTY ACQUIRED BY
2092001	KOELLER BUILDING, LLC, A WYOMING LIMITED LIABILITY COPMANY	10	02-33-201-003	
2092002	FORRESTON TOWNSHIP	12	02-28-452-003 02-28-452-004	
2092003	CASEY'S RETAIL COMPANY, AN IOWA CORPORATION	18	02-33-207-017	
2092004	MICHAEL A. GLICK & DEBRA F. GLICK	4	02-33-330-021	
2092005	DEANE R. HEINZE	5	02-33-329-003	
2092006	WHITE OAKS CEMETERY ASSOCIATION	5	02-33-401-001	
2092007	JOSHUA D. KEISTER	6	02-33-187-005	
2092008	JUSTIN W. BUTLER AND NICKOLE M. BUTLER	6	02-33-259-001	
2092009	ROBERT L. DILLAVOU	6	02-33-183-011	
2092010	DOUGLAS S. SCUDDER AND SHARON S. SCUDDER	6	02-33-255-005	
2092011	JONATHAN TAYLOR	7	02-33-183-007	
2092012	THOMAS E. ALEXANDER AND ANGELA M. BUTLER	7	02-33-255-010	
2092013	KATIE HUNDERTMARK	7	02-33-179-010	
2092014	FORRESTVILLE VALLEY SCHOOL DISTRICT #221	7	02-33-251-009	
2092015	FIRST UNITED METHODIST CHURCH OF FORRESTON	8	02-33-179-007	
2092016	FORRESTVILLE COMMUNITY SCHOOL #221	8	02-33-251-005 02-33-251-006	
2092017	DAVID J. MYERS AND GAIL E. MEYERS	8	02-33-137-010	
2092018	K-W ENTERPRISES, INC.	9	02-33-137-006	
2092019	NIKOLAS K. CRUZ AND MERRI L. CRUZ, AS JOINT TENANTS	9	02-33-251-013	
2092020	RICHARD DOUGLAS JENNINGS AND PATTI JENNINGS	9	02-33-133-015	
2092021	STEVEN L. LEHNE	9	02-33-202-011	
2092022	SUSAN M. NOLTING, TRUSTEE	10	02-33-133-009	
2092023	BOARD OF LIBRARY TRUSTEES OF THE VILLAGE OF FORRESTON	10	02-33-133-007 02-33-133-008	
2092024	KYLE GROENHAGEN	11	02-33-129-014	
2092025	DANIEL J. STEELE II	11	02-33-129-008	
2092026	THE TOWN OF FORRESTON, ILLINOIS	11	02-33-201-001	
2092027	EMIL L. ALICH, TRUSTEE	12	02-33-204-001	

PREPARED BY:

FEHR GRAHAM
ENGINEERING & ENVIRONMENTAL
LLINGS DESIGN FIRM NO. 184-003525

ILLINOIS IOWA WISCONSIN

FEHR GRAHAM JOB NO. 19-148K & 19-148N


ASE JOB # 118152.5


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	DRAWN -	REVISED -
PLOT SCALE = \$SCALE\$	CHECKED -	REVISED -
PLOT DATE = 4/16/2024	DATE -	REVISED -


STATE OF ILLINOIS
DEPARTMENT OF TRANSPORTATION

PLAT OF HIGHWAYS					F.A.P. RTE.	SI	ECTION		COUNTY	TOTAL SHEETS	SHEET NO.
LAND SE	T 25N,	R 8E OF	4TH P.M.	316 & 549	(2,3,4)R	5-7 & 115	SW	OGLE	132	59	
JOB# R-92-009-20		DRAWER		FOLDER		·			CONTRACT NO. 64P13		
SCALE: NTS	SHEET 3 OF 25 SHEETS	STA.	891+08	TO STA. 936+18			ILLINOIS F	FED. AII	D PROJECT		

PARCEL NO.	OWNER	SHEET NUMBER(S)	PERMANENT TAX NUMBER(S) AFFECTED	PROPERTY ACQUIRED BY
2092028	CHRISTOPHER R. THIEL AND REBECCA R. THIEL	12	02-33-129-007	
2092029	KIRK C. JANICKE AND ANGELA R. JANICKE	12	02-28-387-008	
2092030	SHADY OAK HOLDINGS, LLC, AN ILLINOIS LIMITED LIABILITY COMPANY	13	02-28-387-005	
2092031	FORRESTON REAL ESTATE, INC.	13	02-28-388-001	
2092032	RODNEY L. HAMMIL	13	02-28-383-013	
2092033	VILLAGE OF FORRESTON	13	02-28-384-005	
2092034	KRISTEN JOHANNSEN	14	02-28-383-006	
2092035	CLYDE R. HULL AND BARBARA K. HULL	14	02-28-384-001	
2092036	BRIAN T. LAWSON	14	02-28-378-013	
2092037	JUSTIN L. MILLS	14	02-28-379-005	
2092038	LANE F. SCHURR AND PAULA D. SCHURR	15	02-28-378-016	
2092039	SKYLAR W. MILLER AND AMANDA E. BURGETT	15	02-28-379-001	
2092040	KALAH O. BARRY	15	02-28-328-007	
2092041	MELVIN FAY MILNES	15	02-28-331-003	
2092042	SOLUTIONS BANK SUCCESSOR TO FORRETON STATE BANK	16	02-33-204-017	
2092043	JEREMY T. WHITEHEAD	16	02-33-205-009	
2092044	ALLIED WASTE TRANSPORTATION INC.	16 & 17	02-33-207-004 02-33-207-005	PARCEL NOT REQUIRED
2092045	FORRESTON FIRE PROTECTION DISTRICT	16 & 17	02-33-208-010	
2092046	ALLIED WASTE TRANSPORTATION INC.	17	02-33-207-012	PARCEL NOT REQUIRED
2092047	DULCE MARIA MONTES & EMELIA MONTES	18	02-33-213-006	
2092048	STANLEY B. HAWKINS & DEBORAH L. HAWKINS	18	02-33-211-001	
2092049	EILEEN J. ANDERSON, TRUSTEE	18,19	02-33-210-001	
2092050	STKE, LLC, AN ILLINOIS LIMITED LIABILITY COMPANY	19 & 20	02-28-460-009	
2092051	EILEEN J. ANDERSON, TRUSTEE	20	02-33-211-007	
2092052	MELVIN SCHAAR	20	02-28-461-010	
	1	l	l l	

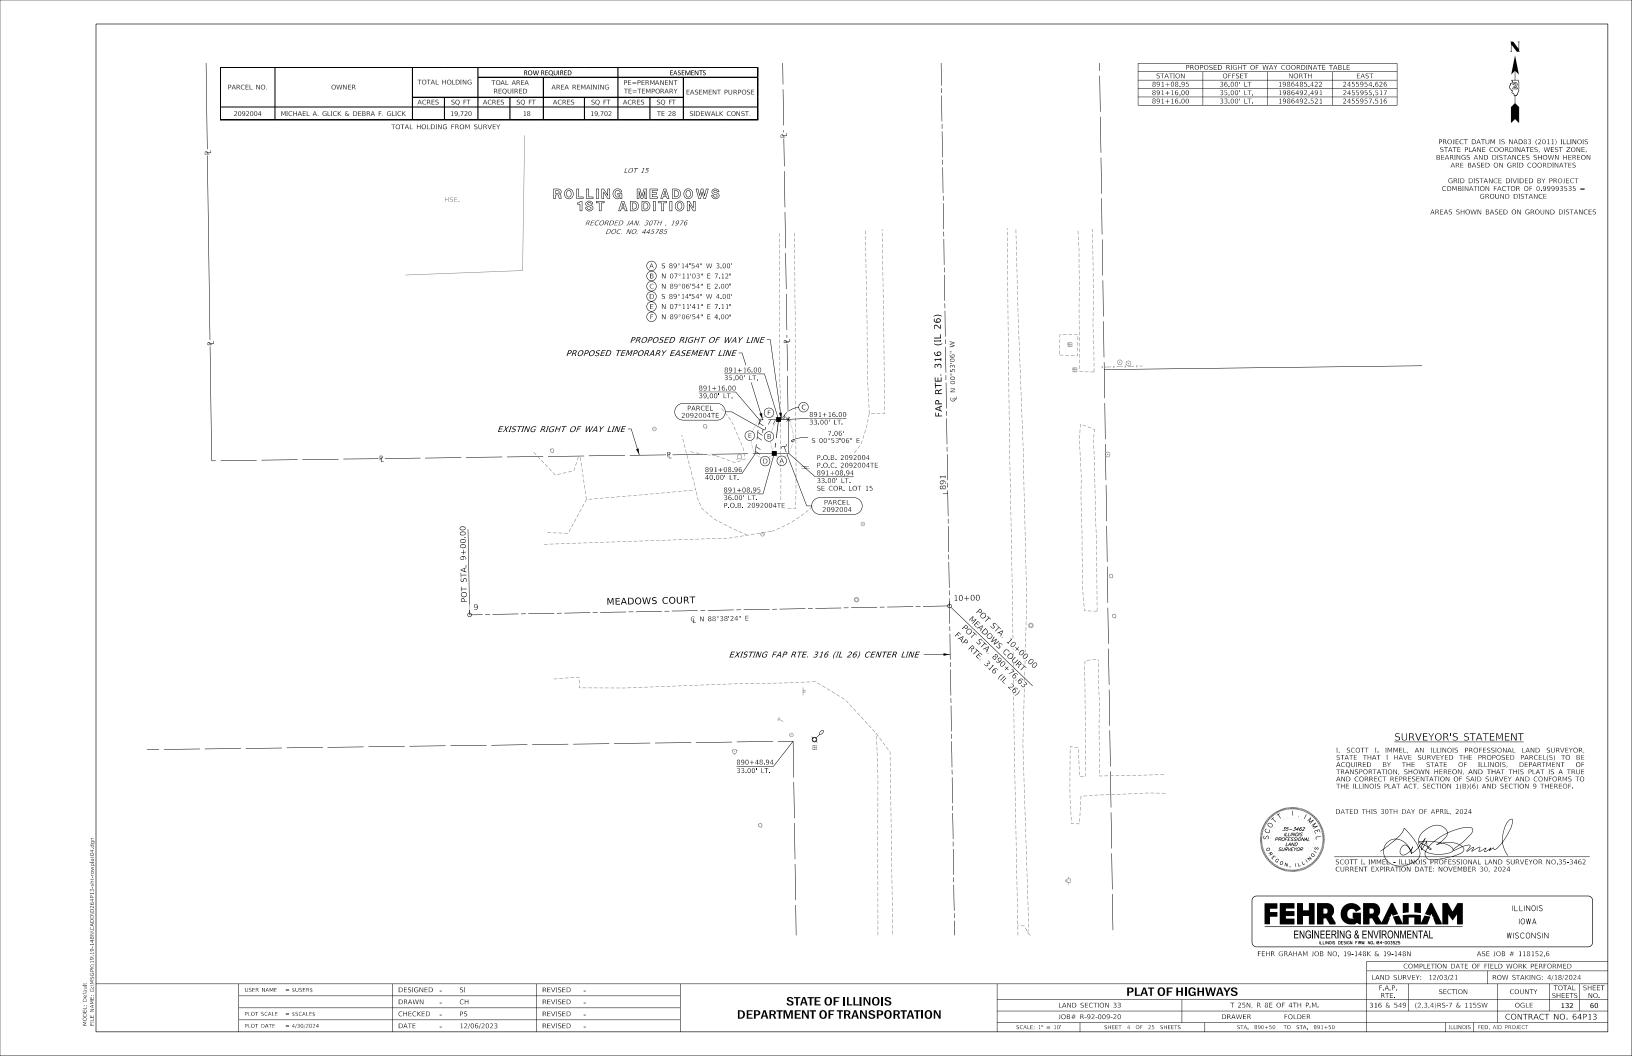

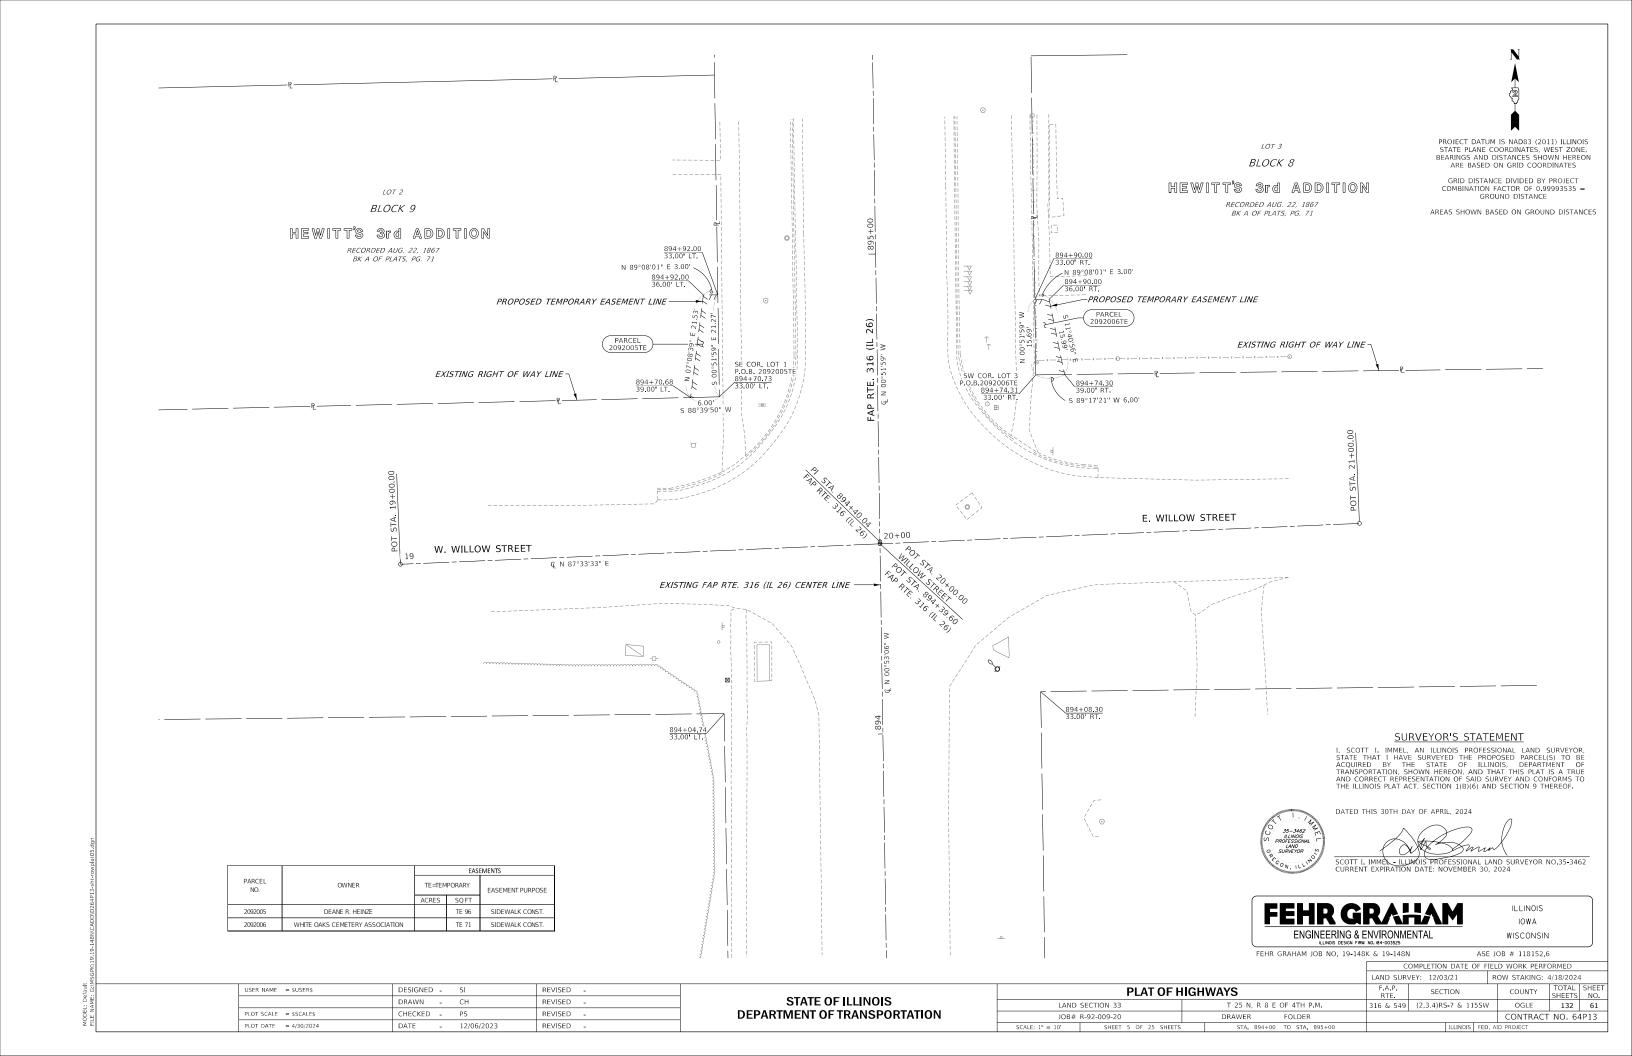

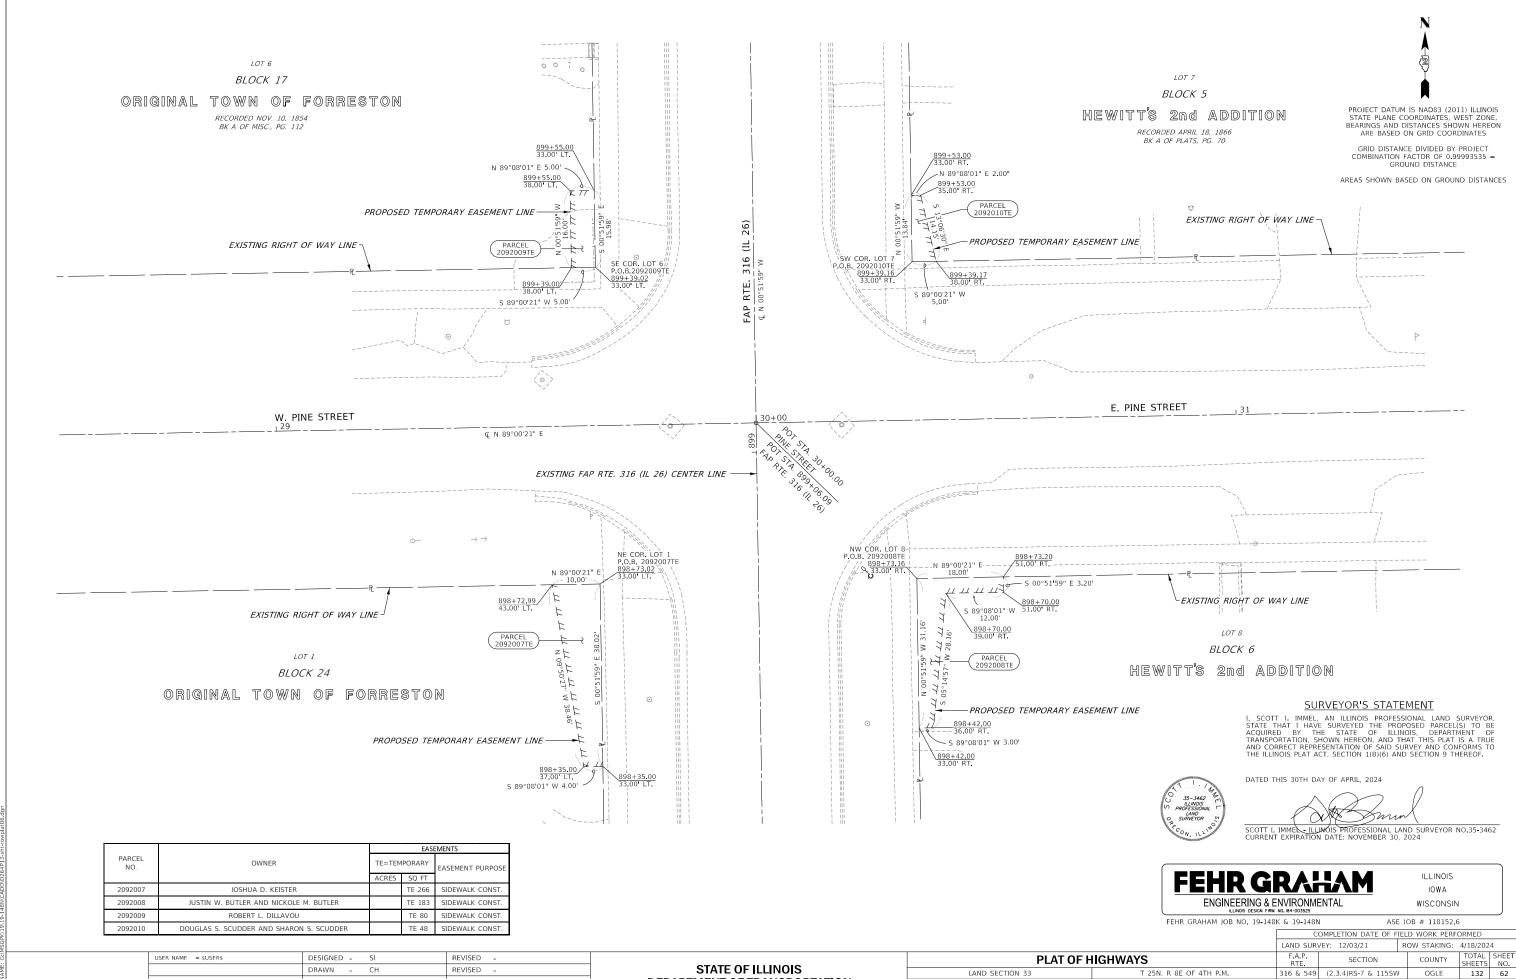

DEPARTMENT OF TRANSPORTATION

JOB# R-92-009-20

DRAWER

FOLDER

CONTRACT NO. 64P13

REVISED


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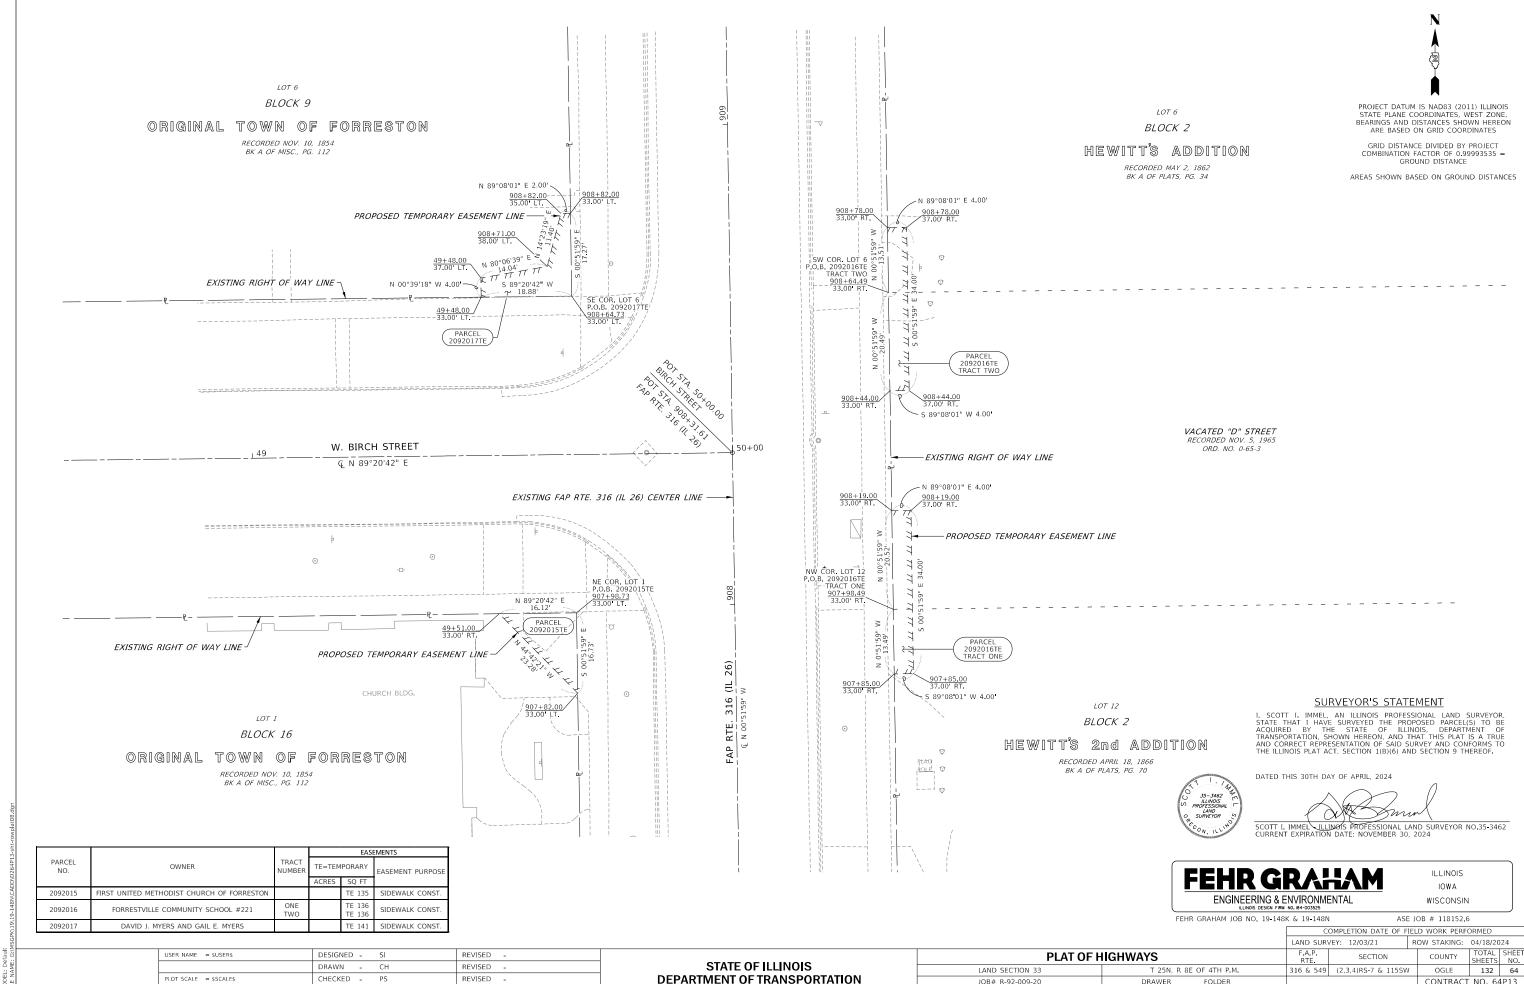
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DATE

12/06/2023





JOB# R-92-009-20

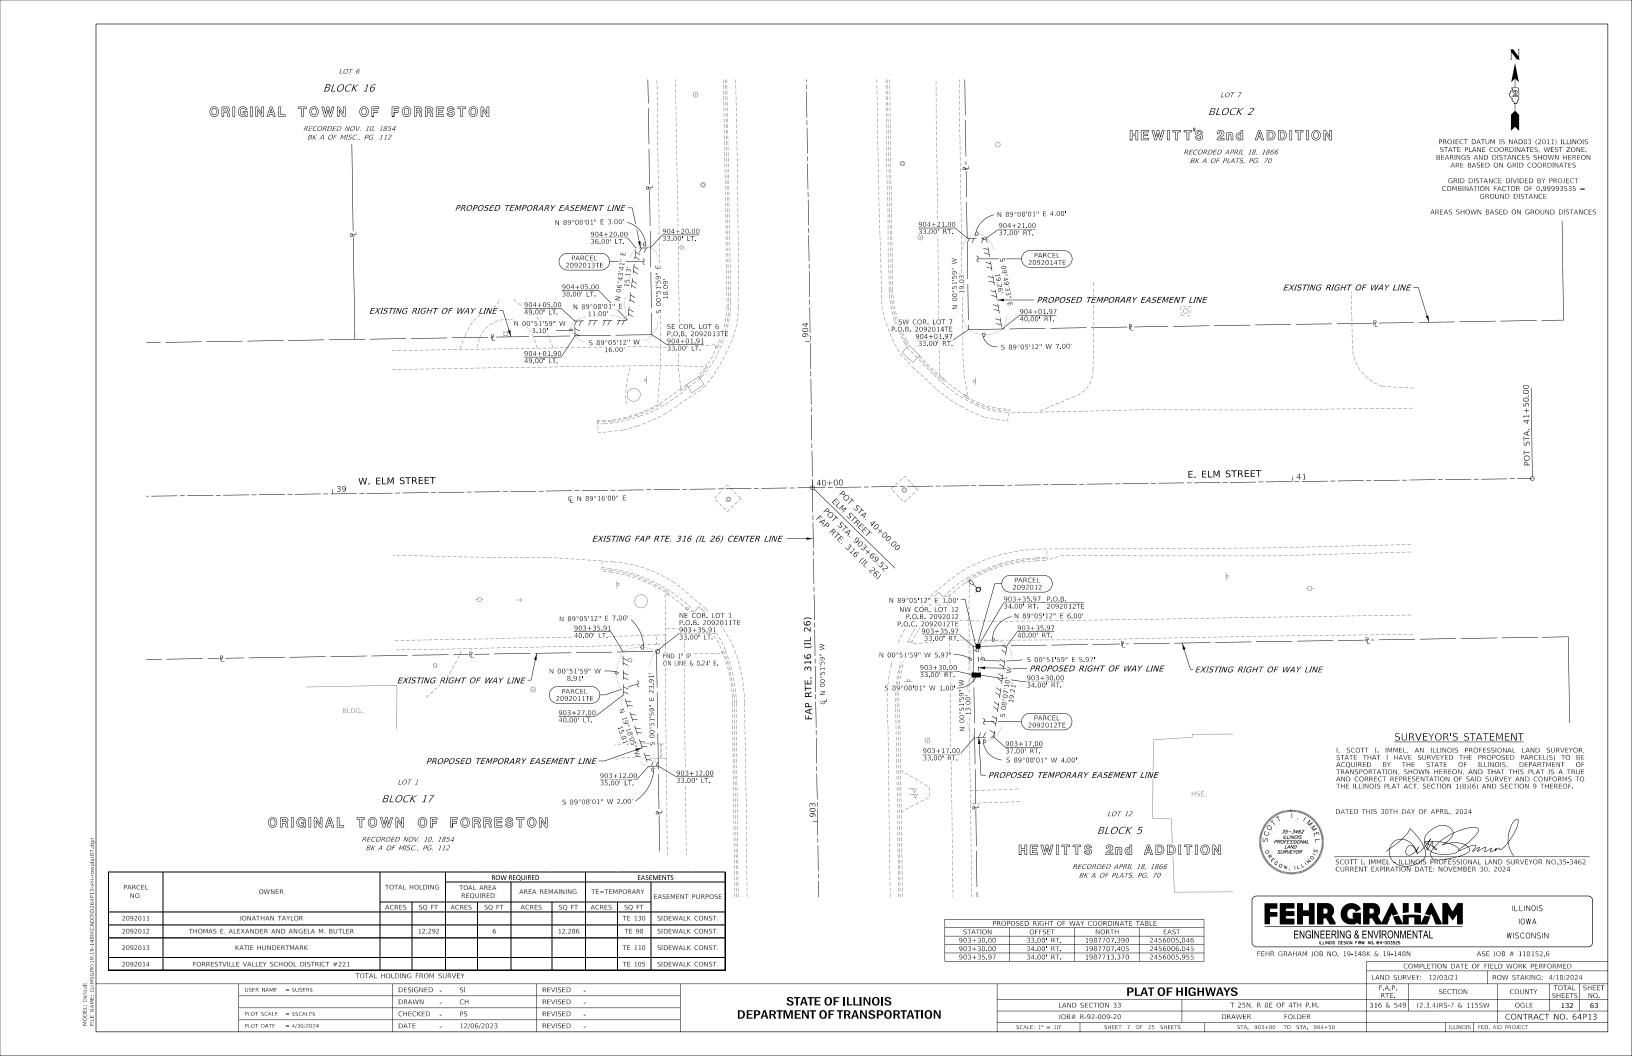DRAWER

FOLDER


CONTRACT NO. 64P13


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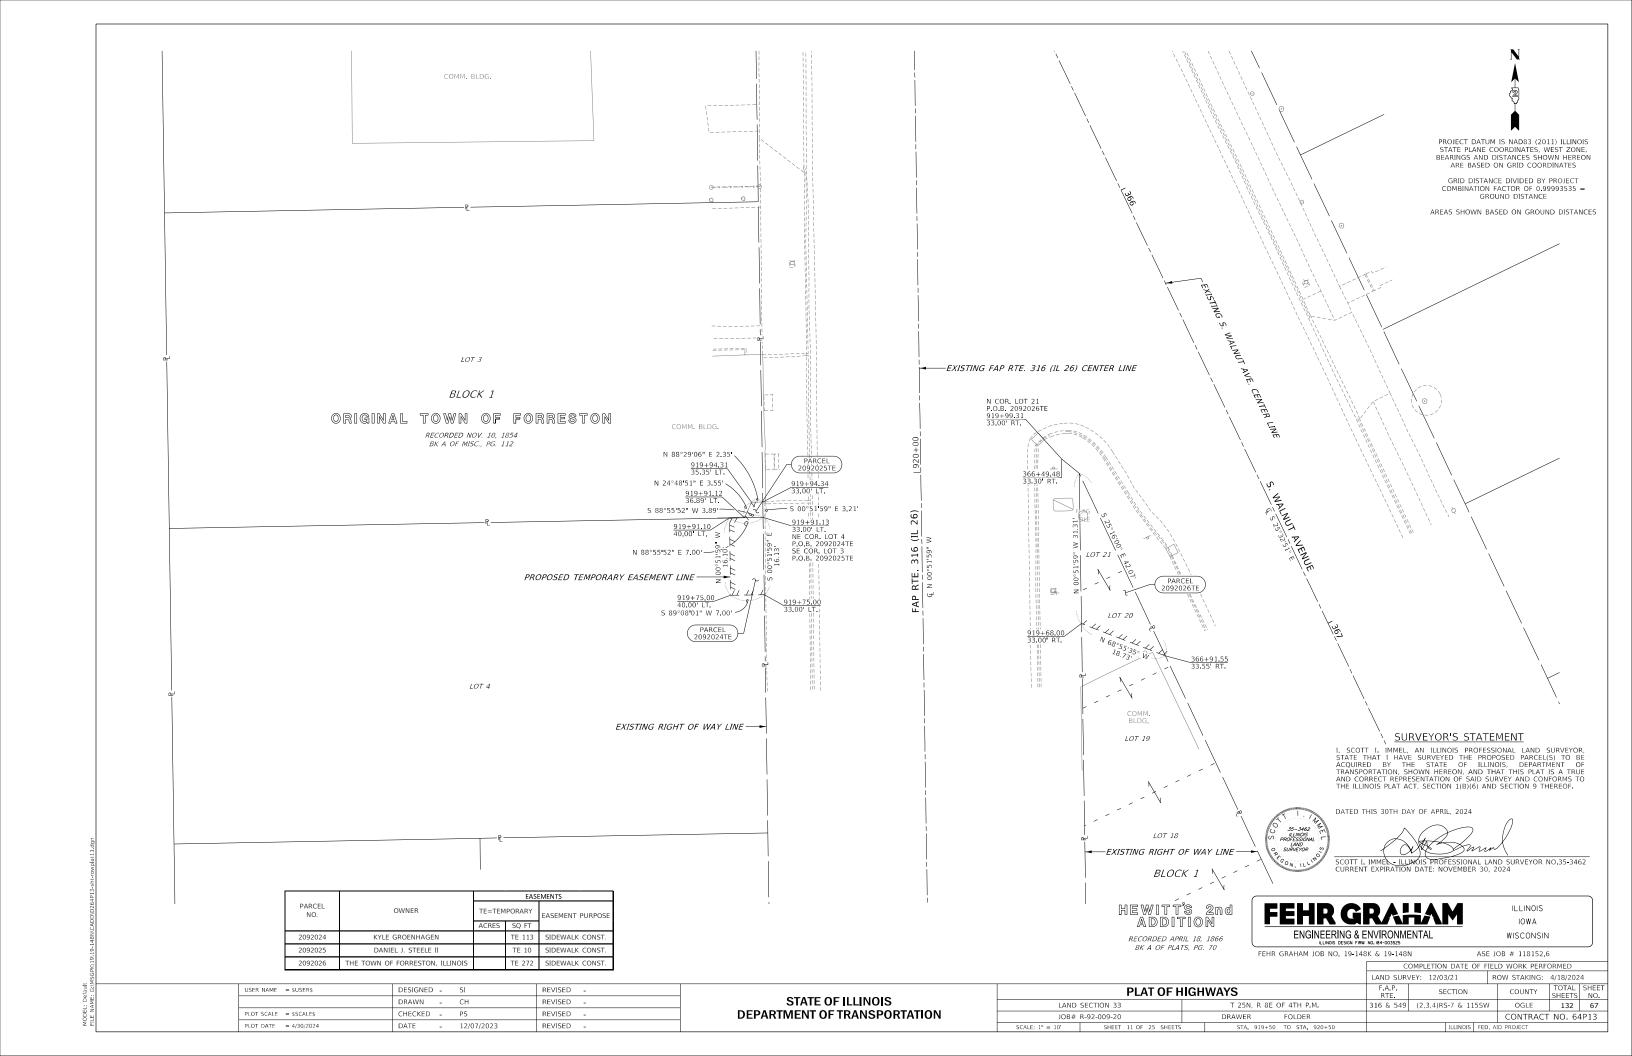
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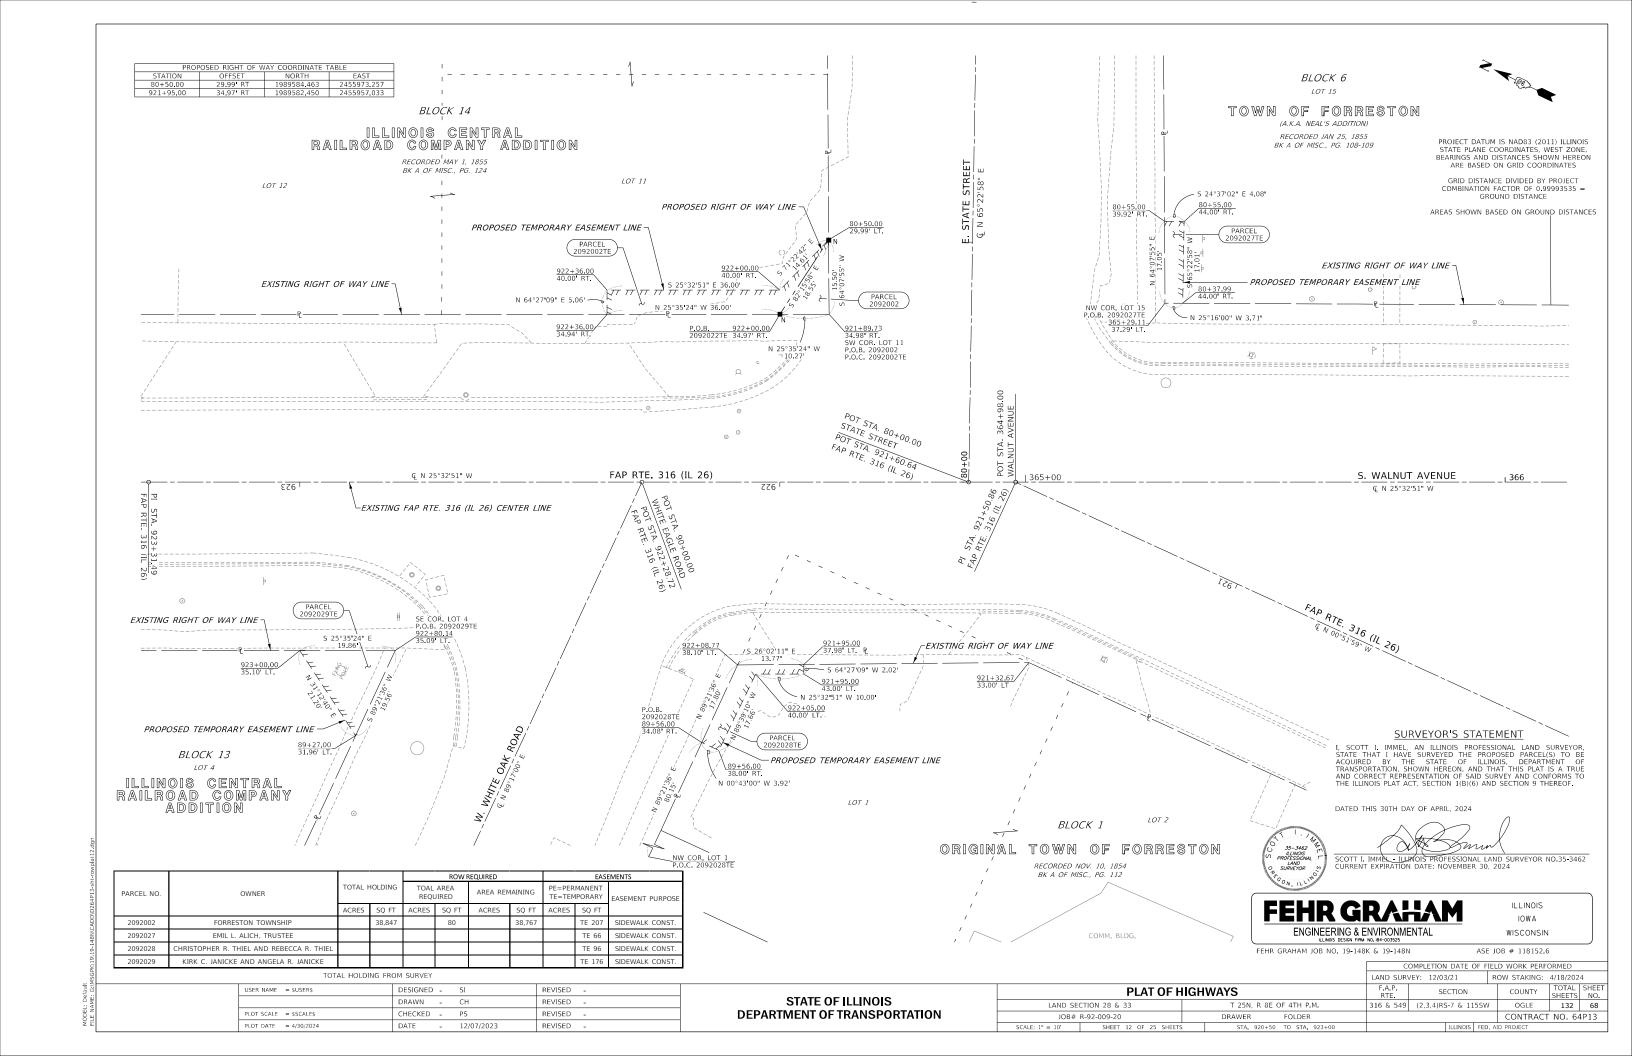
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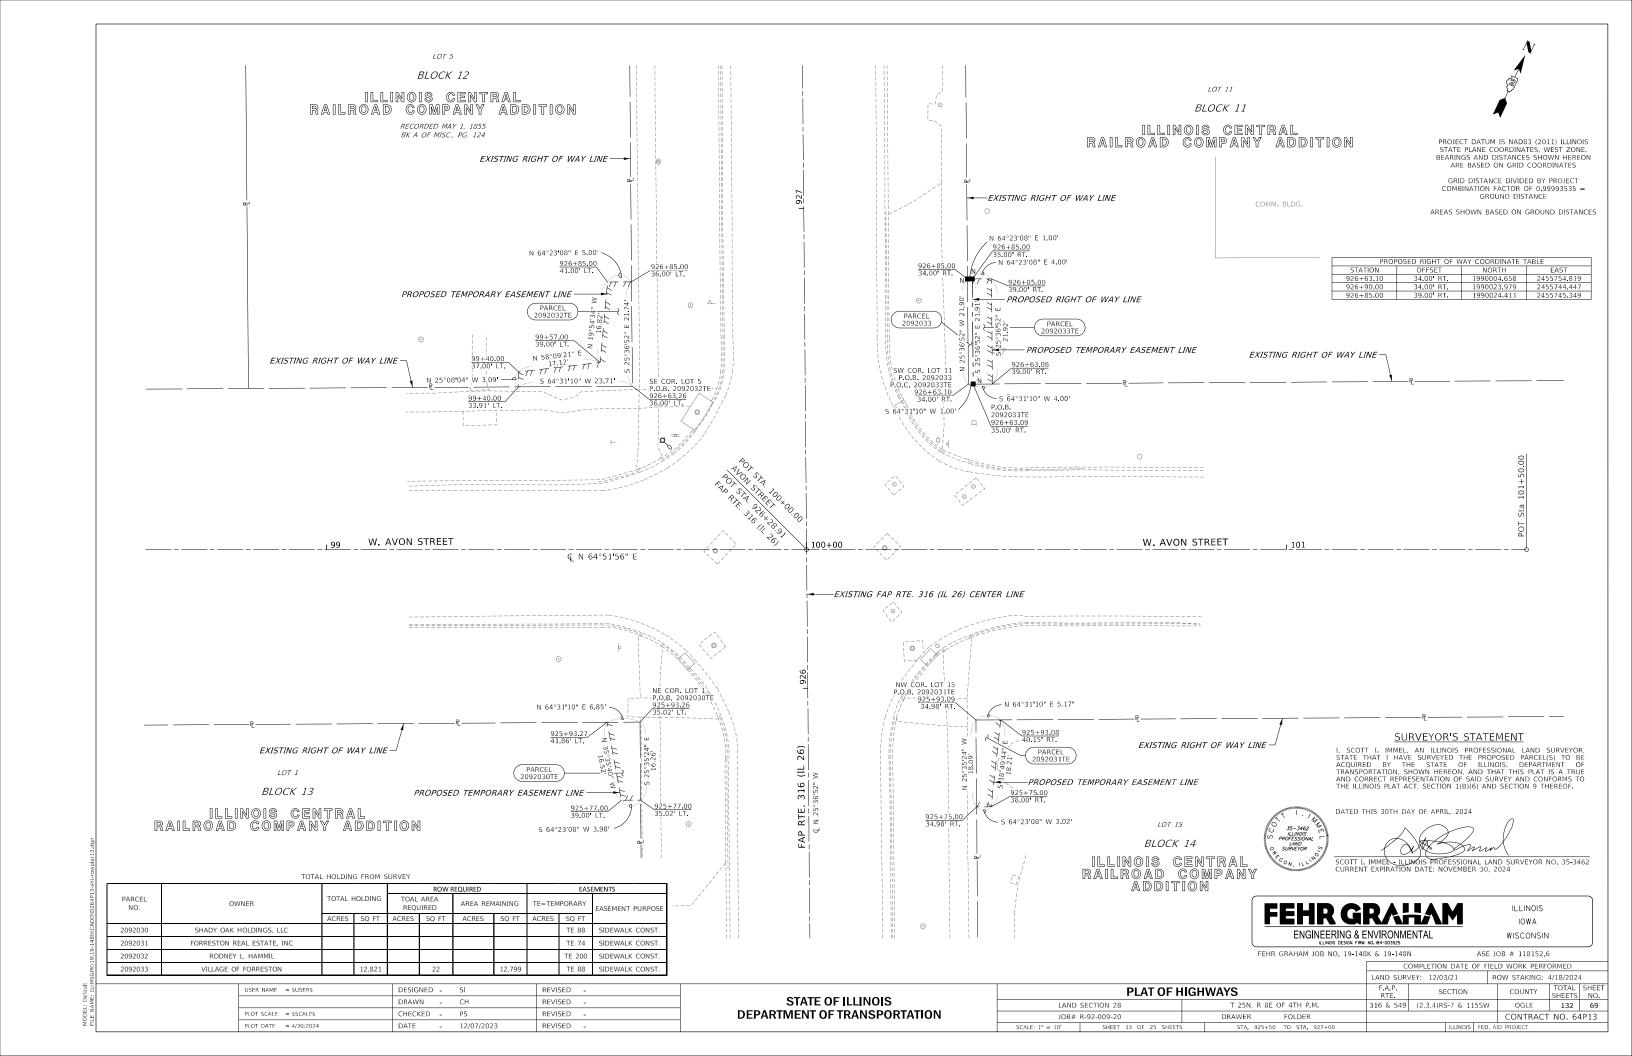
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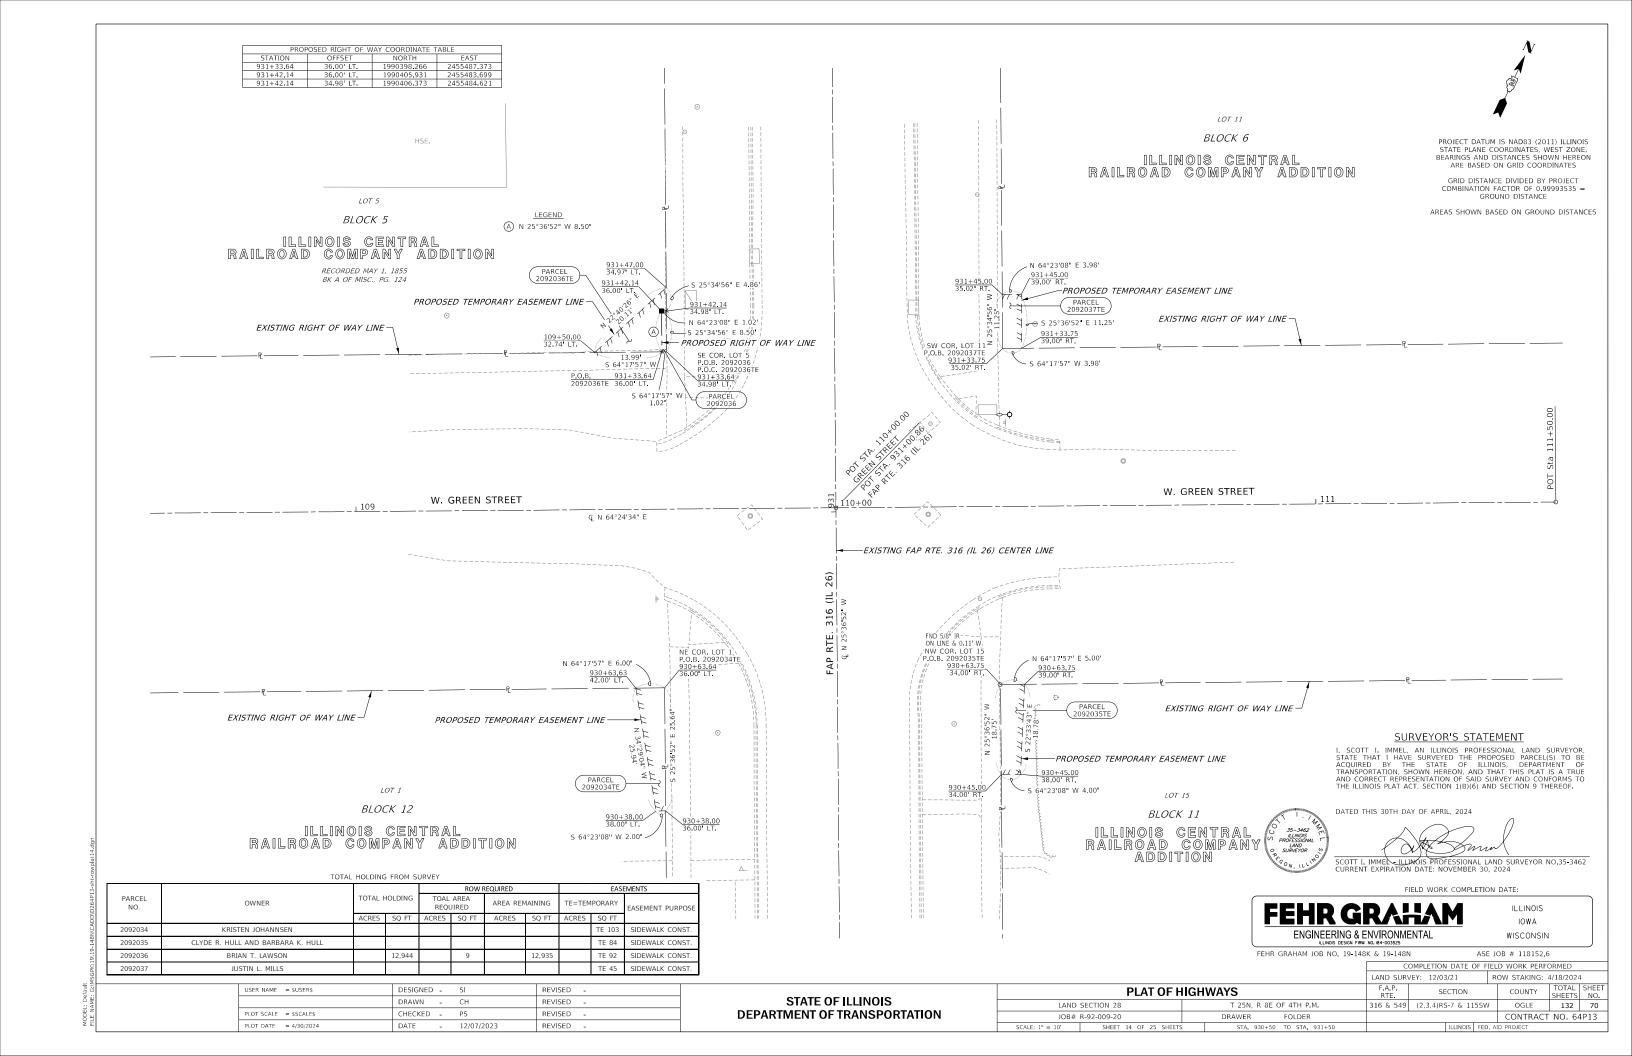











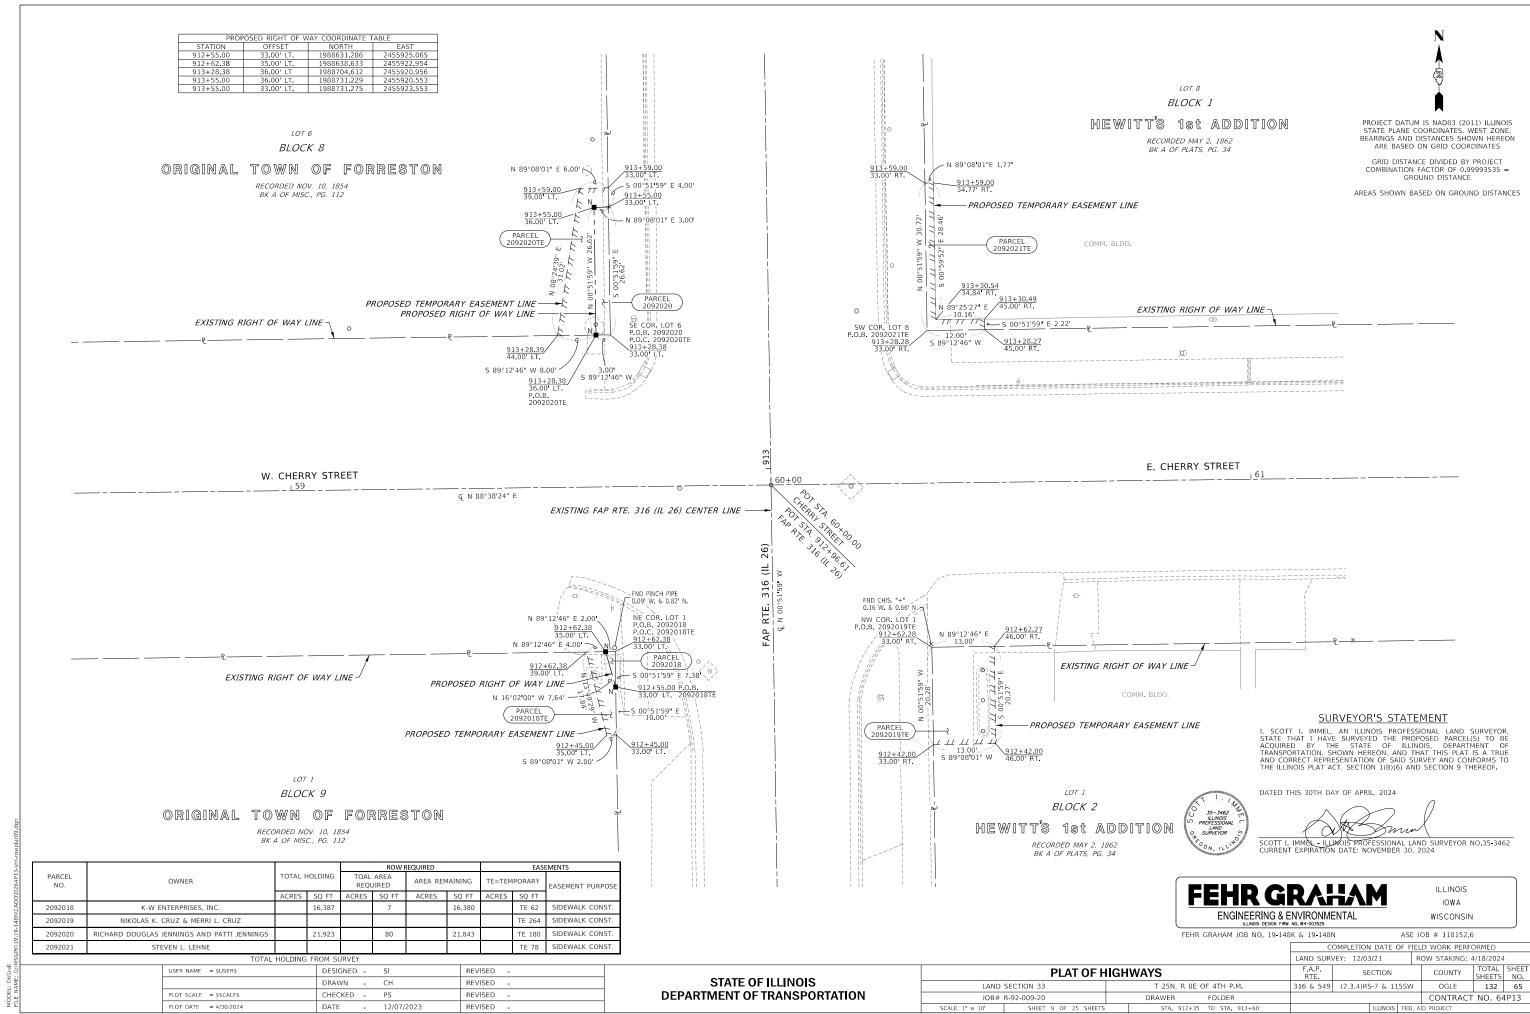


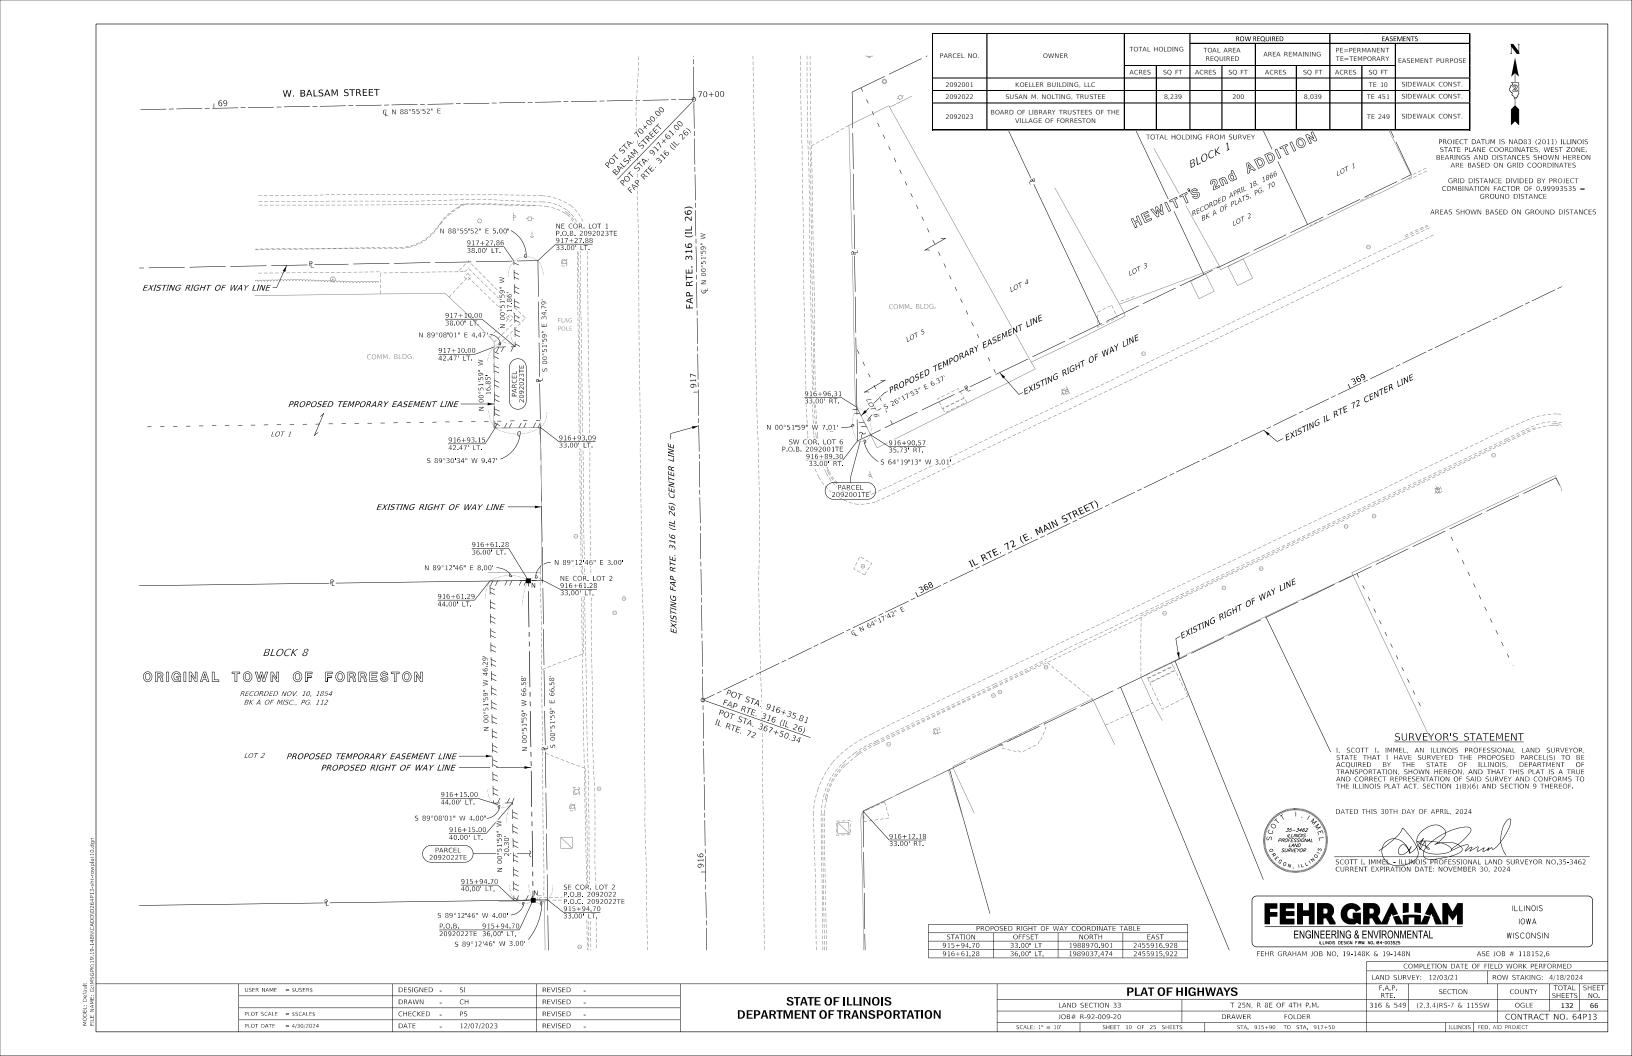


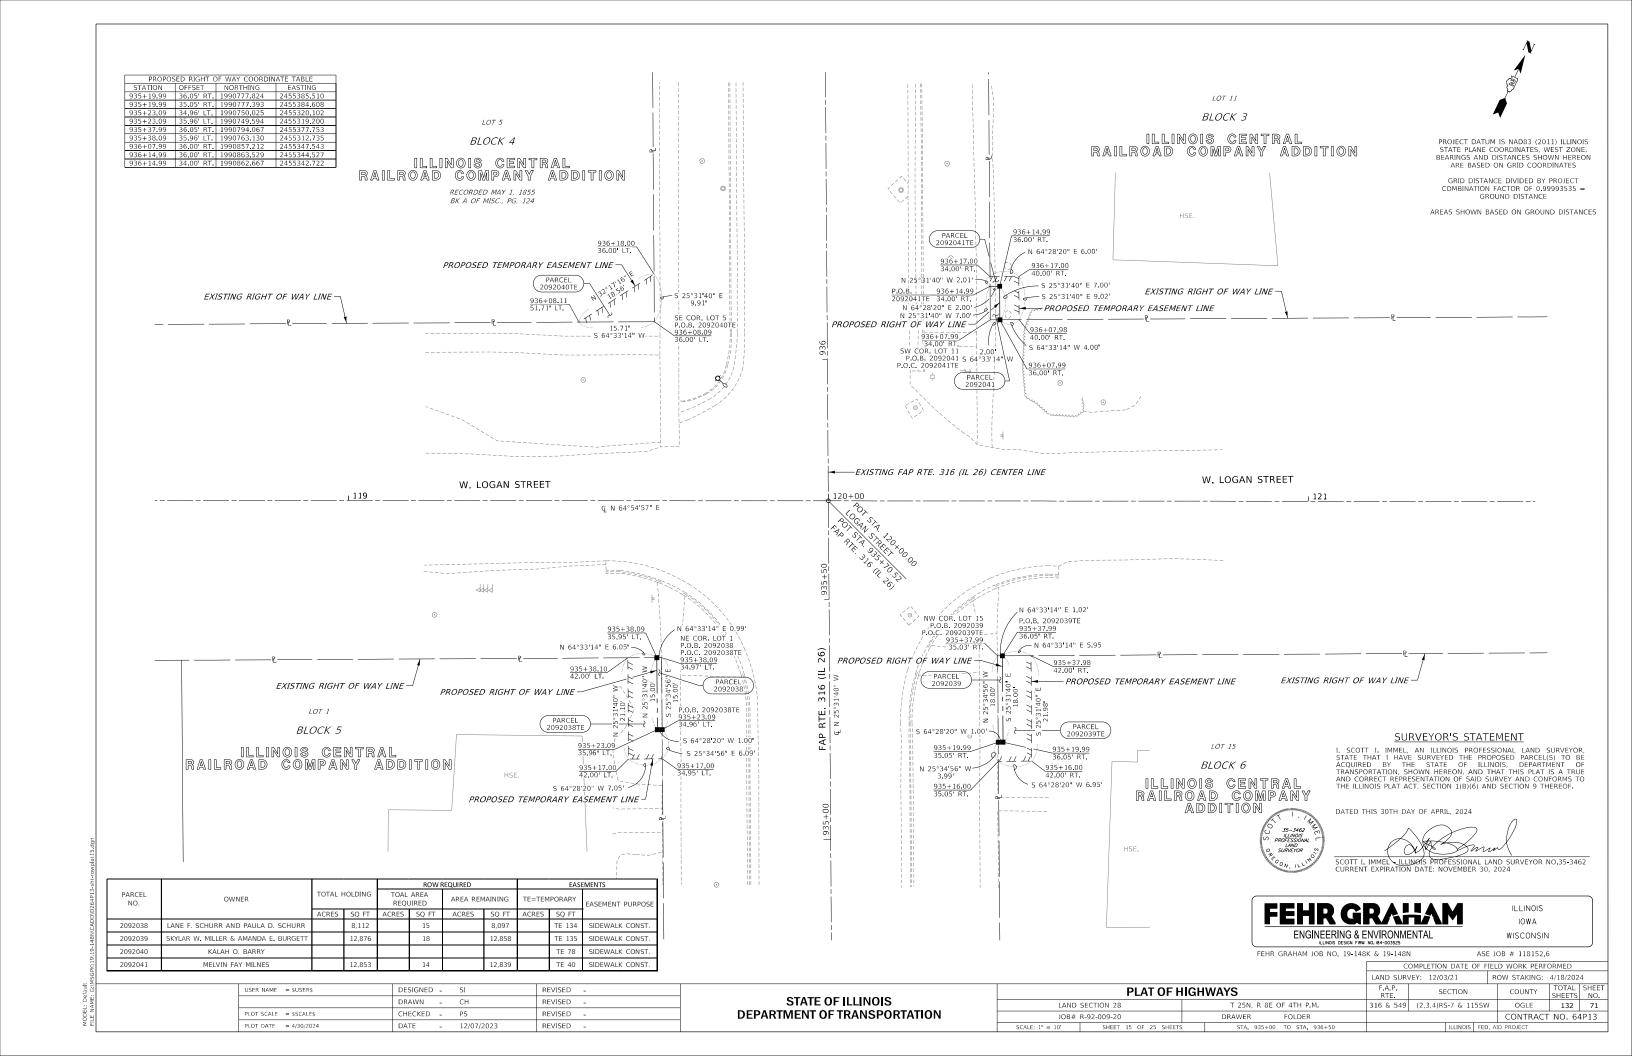


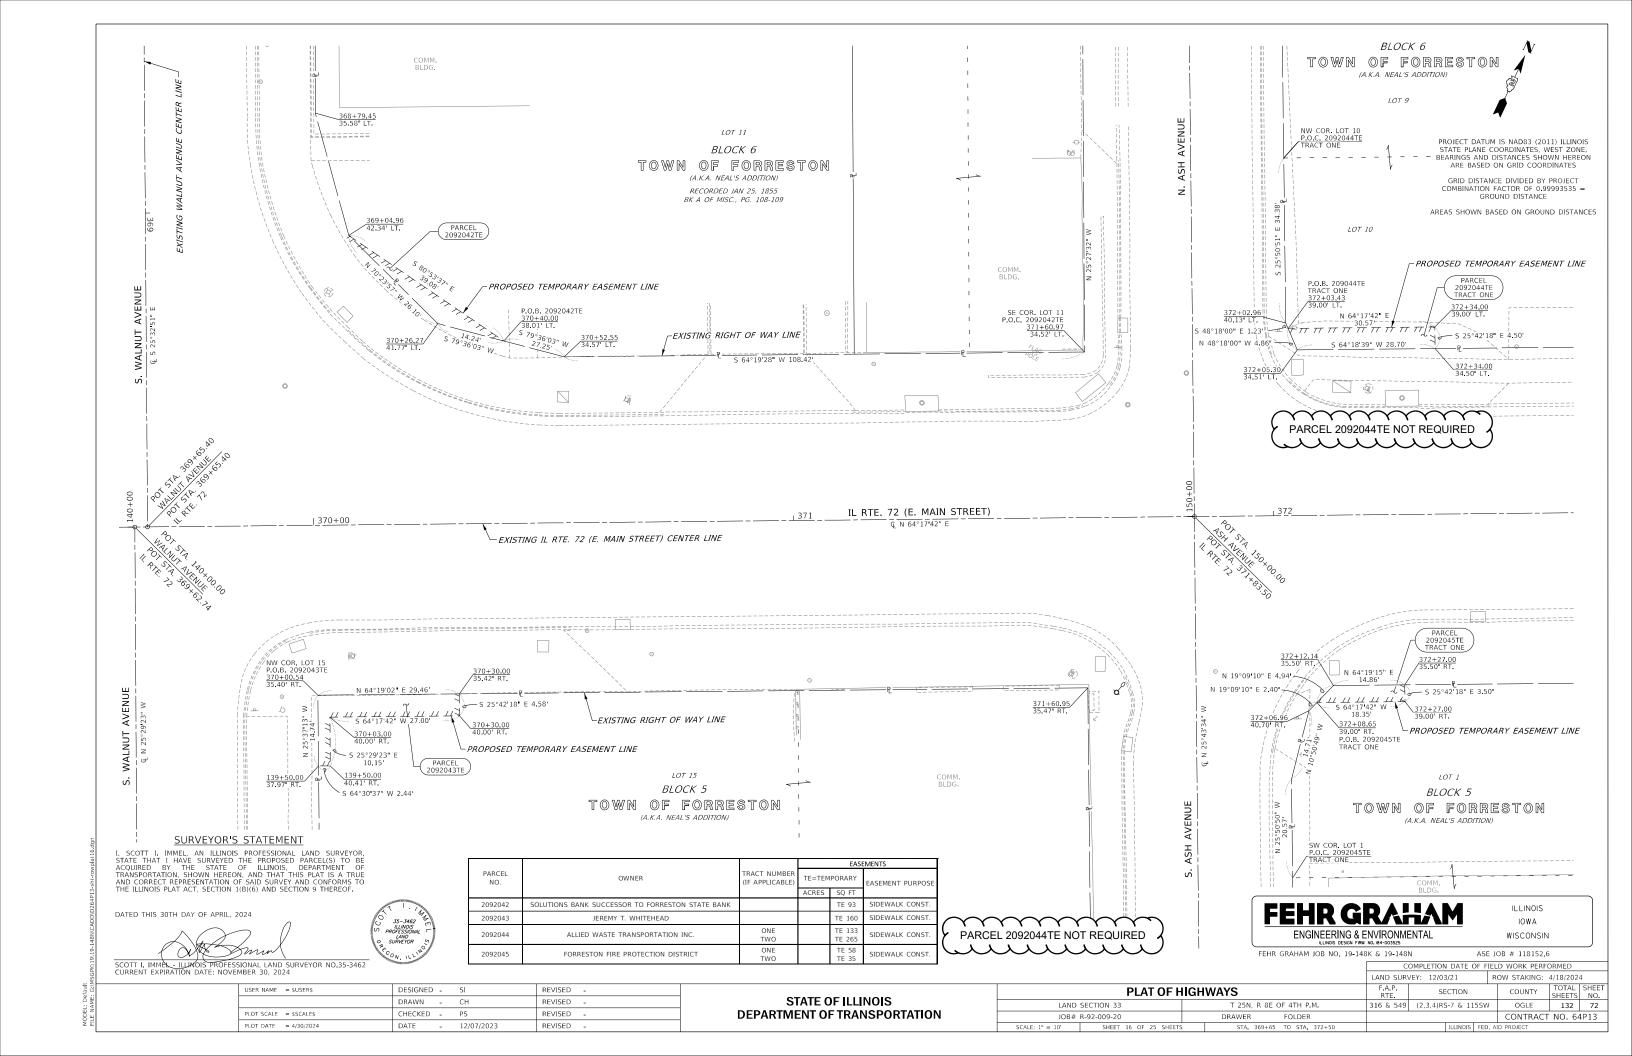

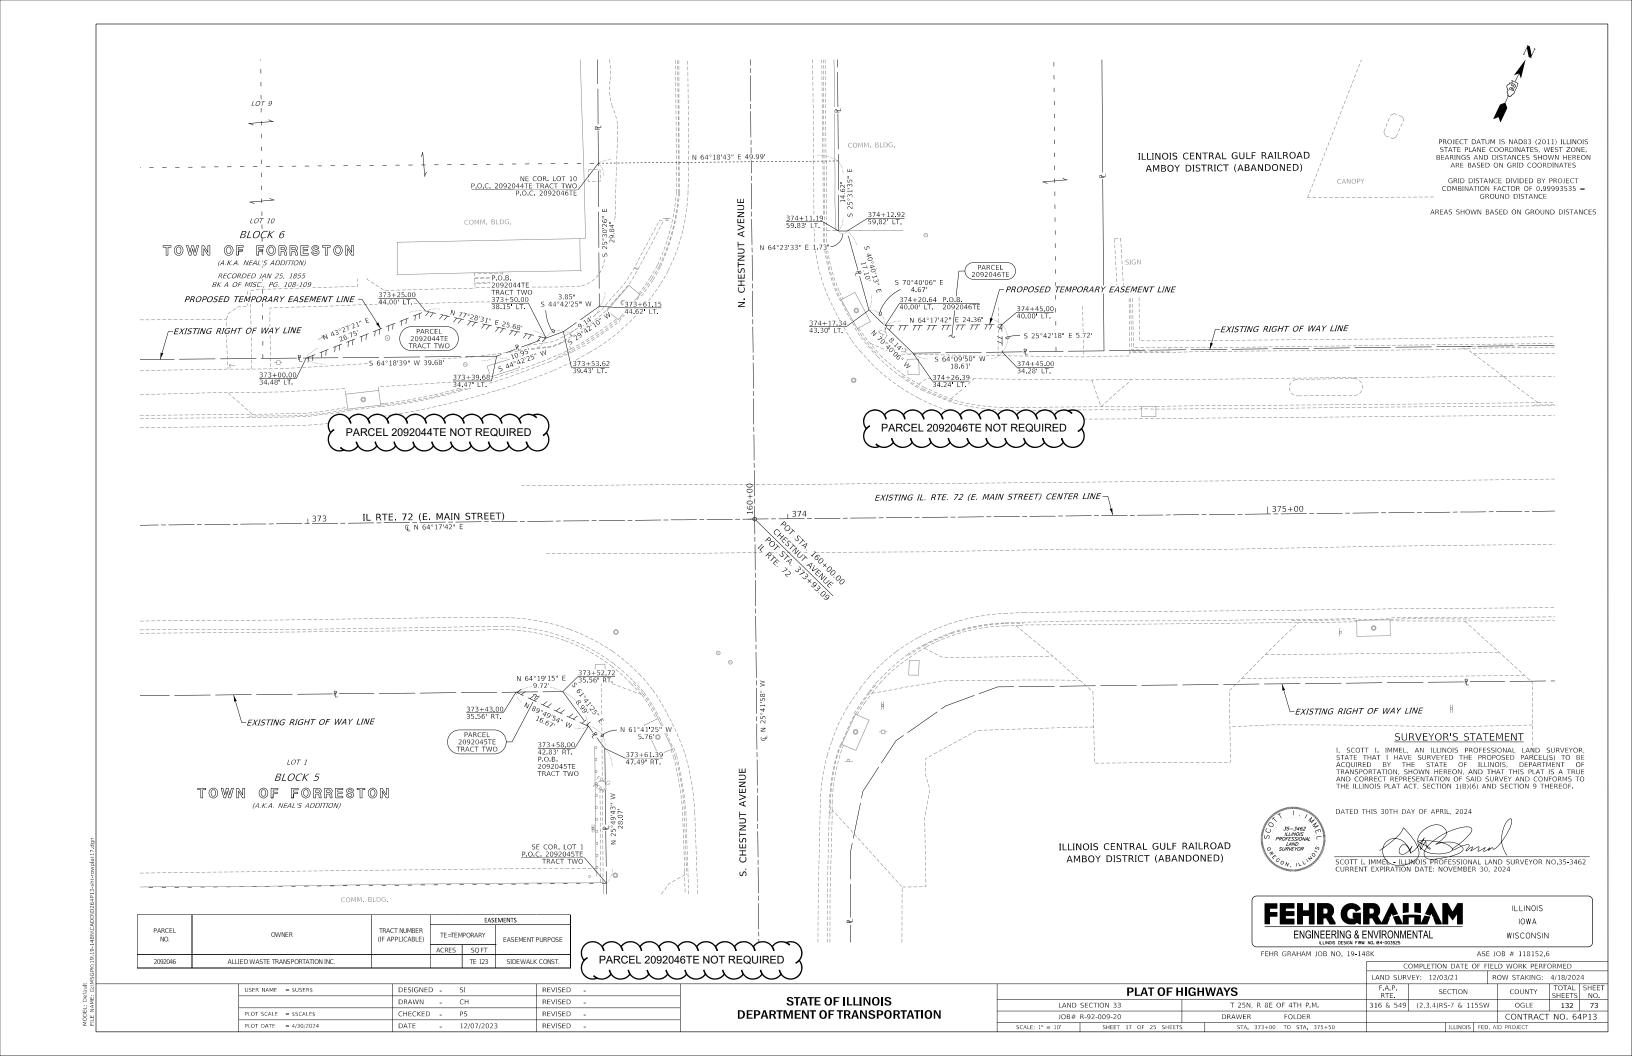

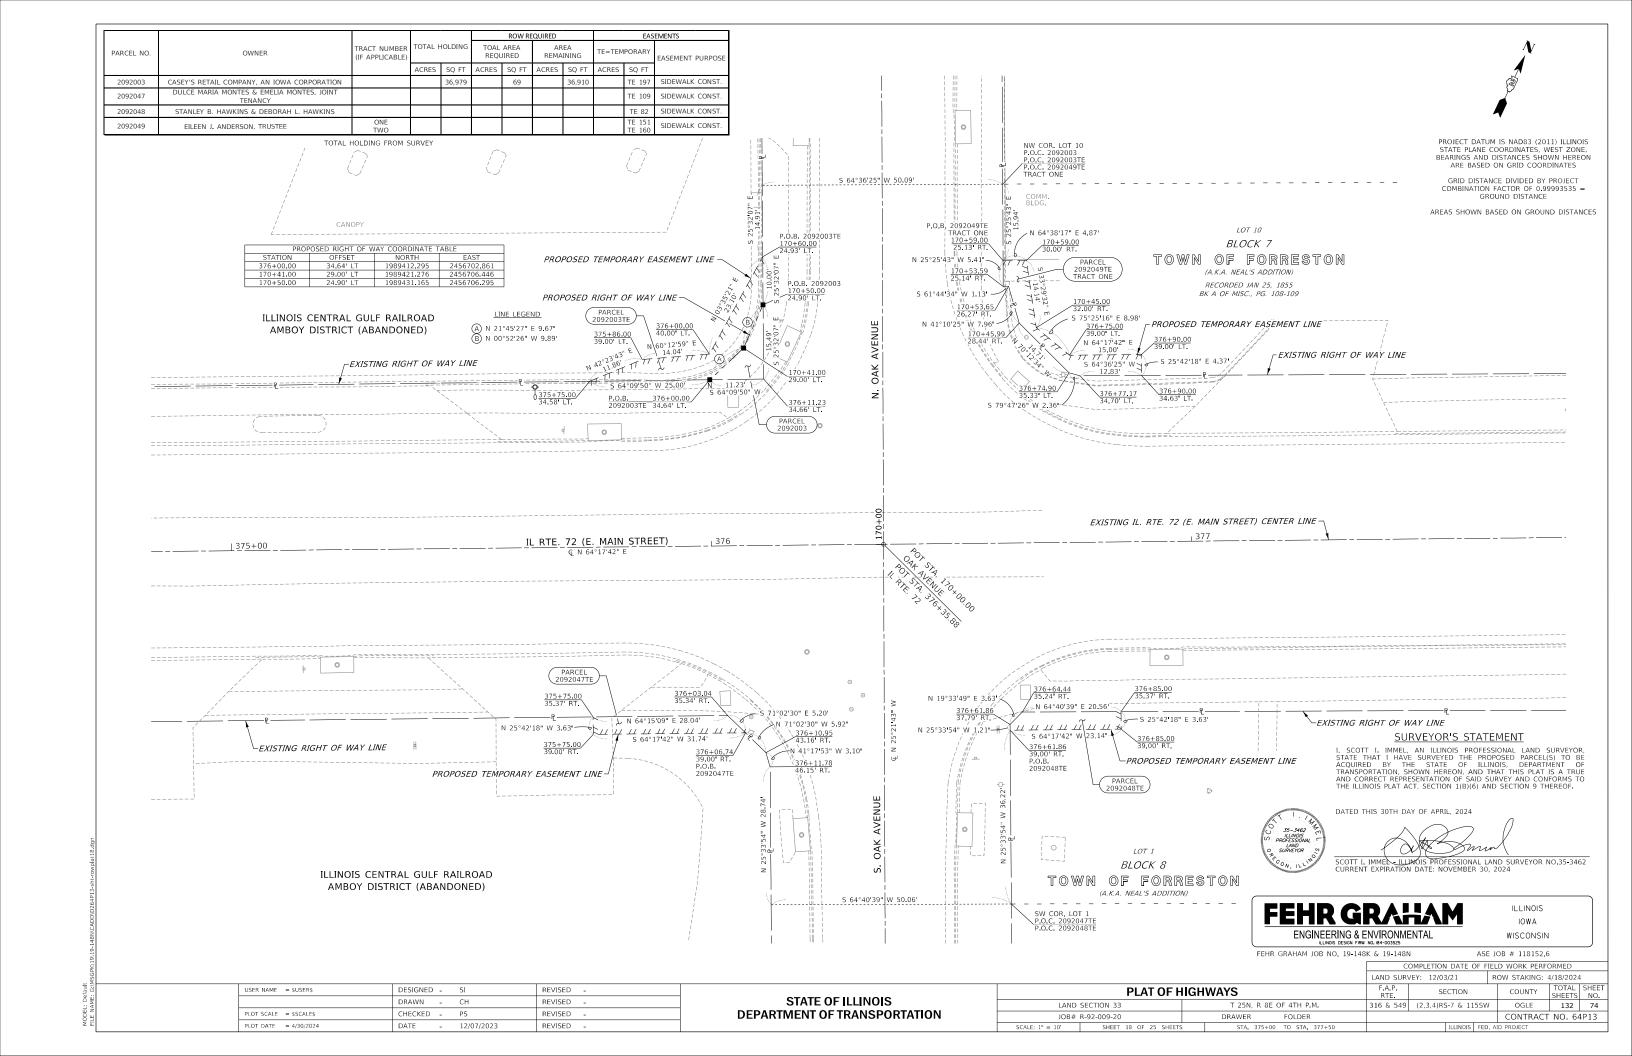

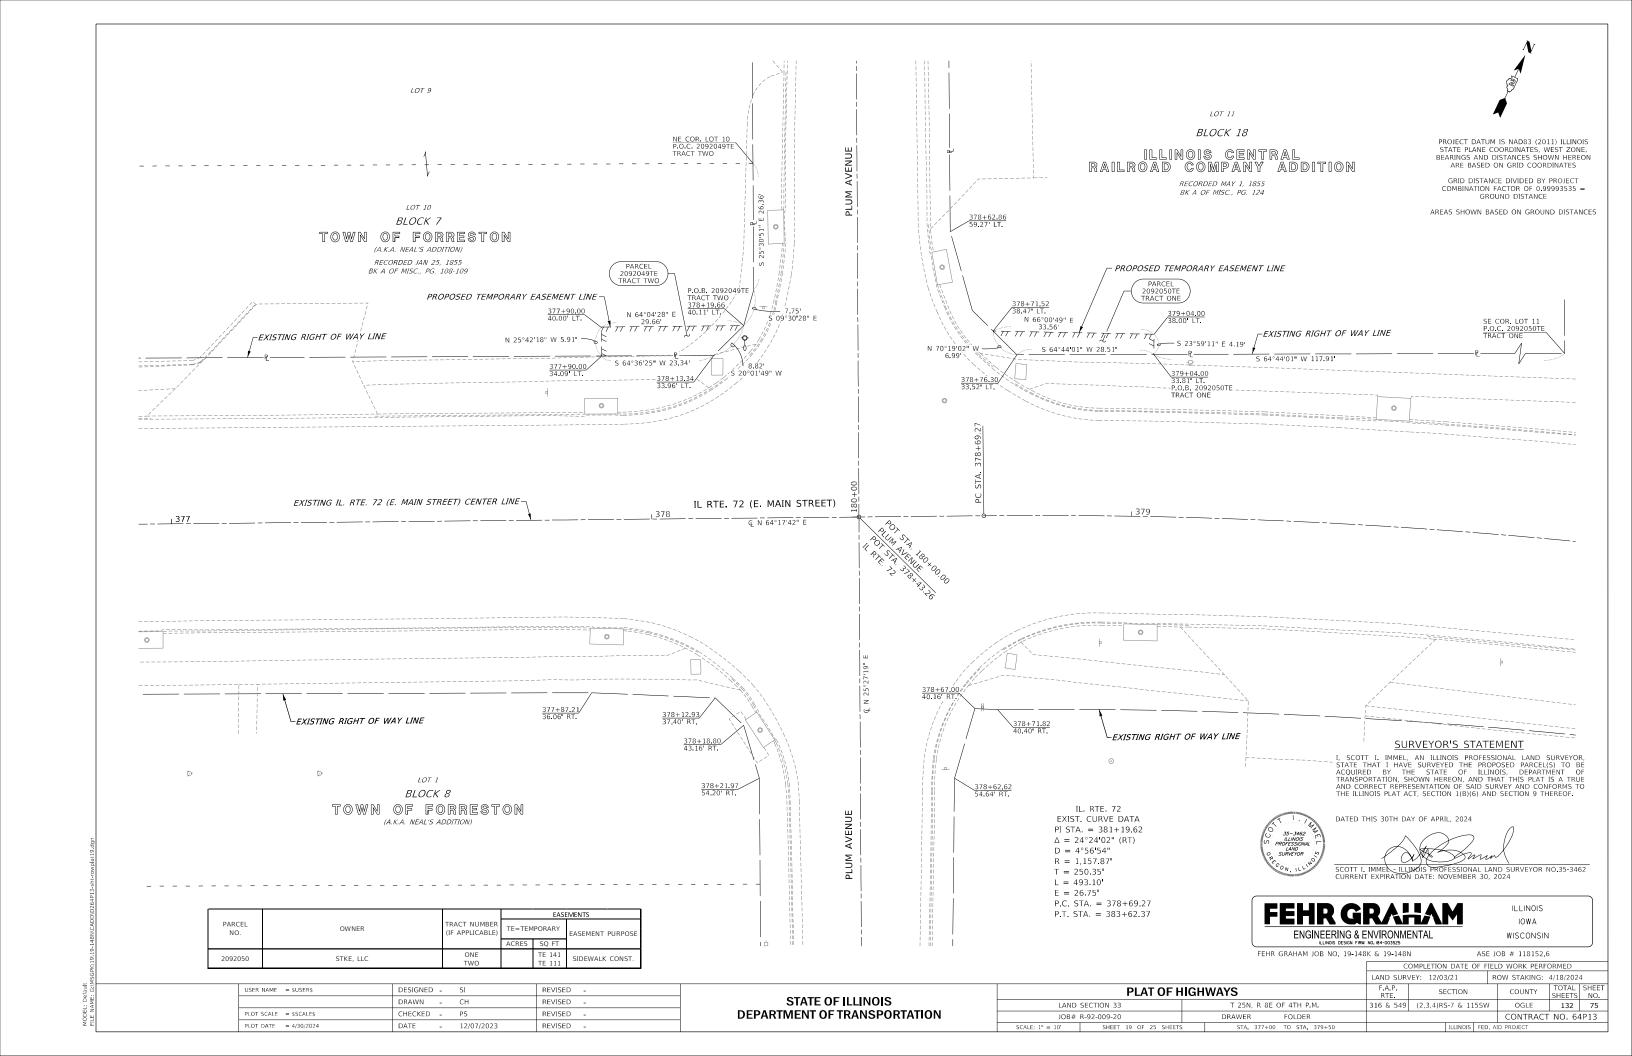

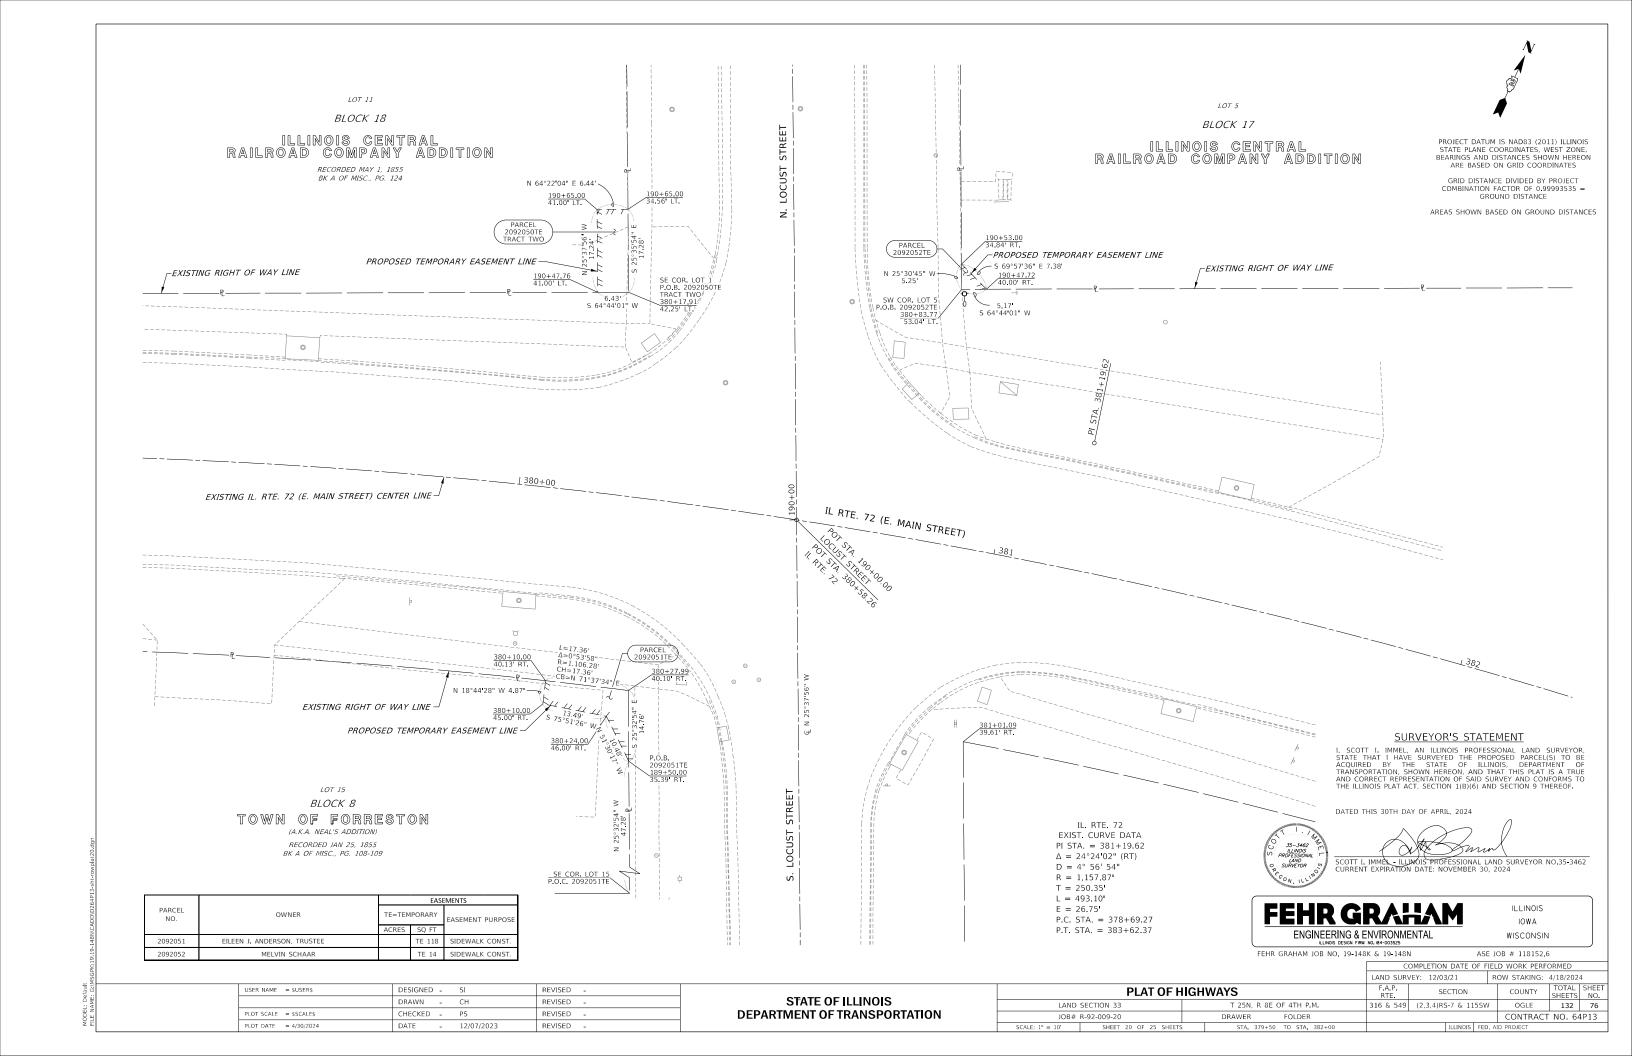



PROJECT DATUM IS NAD83 (2011) ILLINOIS STATE PLANE COORDINATES, WEST ZONE, BEARINGS AND DISTANCES SHOWN HEREON ARE BASED ON GRID COORDINATES

GRID DISTANCE DIVIDED BY PROJECT COMBINATION FACTOR OF 0.99993535 = GROUND DISTANCE

AREAS SHOWN BASED ON GROUND DISTANCES

FAP RTE. 316 (IL 26)


FAP RIE. 310 (IL 20)						
STATION		NORTHING	EASTING			
PT	873+71.08	1984748.3227	2456017.4645			
PΙ	894+40.04	1986817.0300	2455985.5074			
ΡI	921+50.86	1989527.5425	2455944.5139			
PΙ	923+31.49	1989690.5085	2455866.6171			
PΙ	933+95.66	1990650.0964	2455406.5618			
PC	962+73.54	1993247.0236	2454166.3381			

HEWITT'S 2ND ADDITION

RECORDED APRIL 18, 1866 BK A OF PLATS, PG. 70

HEWITT'S 3RD ADDITION

RECORDED AUG. 22, 1867 BK A OF PLATS, PG. 71

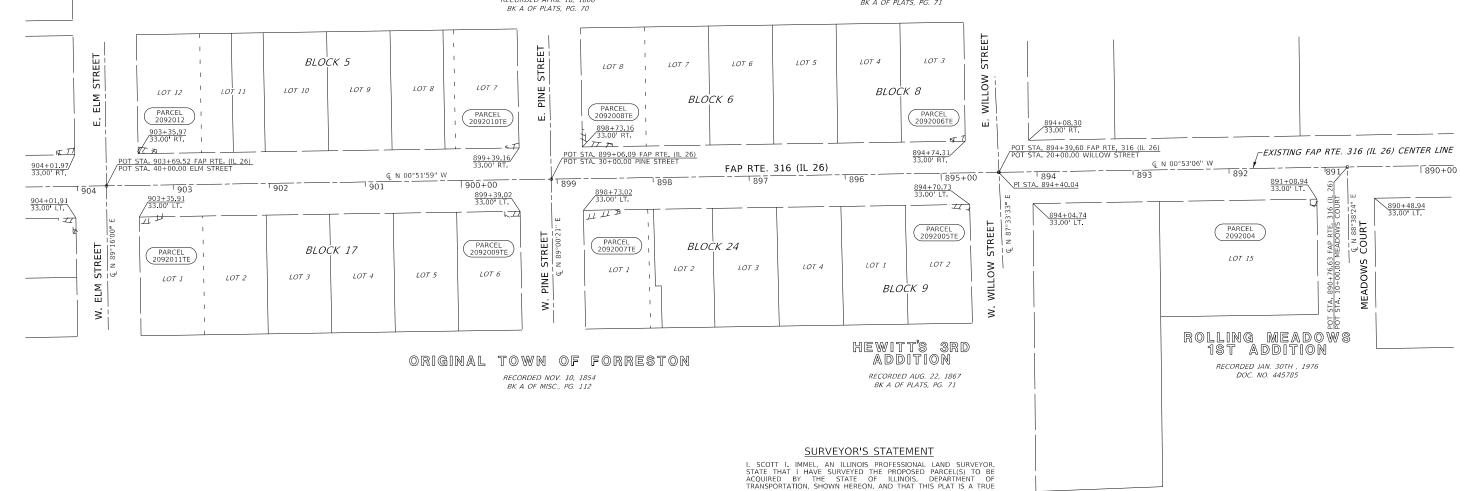

I, SCOTT I. IMMEL, AN ILLINOIS PROFESSIONAL LAND SURVEYOR, STATE THAT I HAVE SURVEYED THE PROPOSED PARCEL(S) TO BE ACQUIRED BY THE STATE OF ILLINOIS, DEPARTMENT OF TRANSPORTATION, SHOWN HEREON, AND THAT THIS PLAT IS A TRUE AND CORRECT REPRESENTATION OF SAID SURVEY AND CONFORMS TO THE ILLINOIS PLAT ACT, SECTION 1(B)(6) AND SECTION 9 THEREOF.



DATED THIS 30TH DAY OF APRIL, 2024

Smur SCOTT I. IMMES - ILLINOIS PROFESSIONAL LAND SURVEYOR NO.35-3462 CURRENT EXPIRATION DATE: NOVEMBER 30, 2024

FEHR GRAHAM
ENGINEERING & ENVIRONMENTAL ILLINOIS DESIGN FIRM NO. 184-003525

ILLINOIS IOWA WISCONSIN

USER NAME = \$USER\$ DESIGNED - SI REVISED -	
DRAWN - CH REVISED -	
PLOT SCALE = \$SCALE\$ CHECKED - PS REVISED -	
PLOT DATE = 4/30/2024 DATE - 12/07/2023 REVISED -	

STATE OF ILLINOIS **DEPARTMENT OF TRANSPORTATION**

TEHN GRAHAM JOB NO. 19-140				K Ø 15-1401	V		AJL J	JD # 1101J2.0	,	
PLAT OF HIGHWAYS					SECTION		COUNTY	TOTAL SHEETS	SHEE NO.	
LAND SECTION 33			T 25N, R 8E OF 4TH P.M.		(2,3,4)RS	(2,3,4)RS-7 & 115SW		OGLE	132	77
JOB# R-92-009-20			DRAWER FOLDER					CONTRACT	NO. 64	4P13
1" - 50'	CHEET 21 OF 25 CHEETS		CTA 900±00 TO STA 904±00			THIMOIS	EED A	D PROJECT		

FAP RTF, 316 (II 26)

		,
STATION	NORTHING	EASTING
PI 894+40.04	1986817.0300	2455985.507
PL 921+50.86	1989527 5425	2455944 5139


IL RTE 72 (E MAIN STREET)

STATION	NORTHING	EASTING
PI 367+50.34	1989012.5560	2455952.
PC 378+69 27	1989497 8806	2456960

 $Z \leftarrow \mathbb{R} \rightarrow \mathbb{Z}$

PROJECT DATUM IS NAD83 (2011) ILLINOIS STATE PLANE COORDINATES, WEST ZONE, BEARINGS AND DISTANCES SHOWN HEREON

GRID DISTANCE DIVIDED BY PROJECT

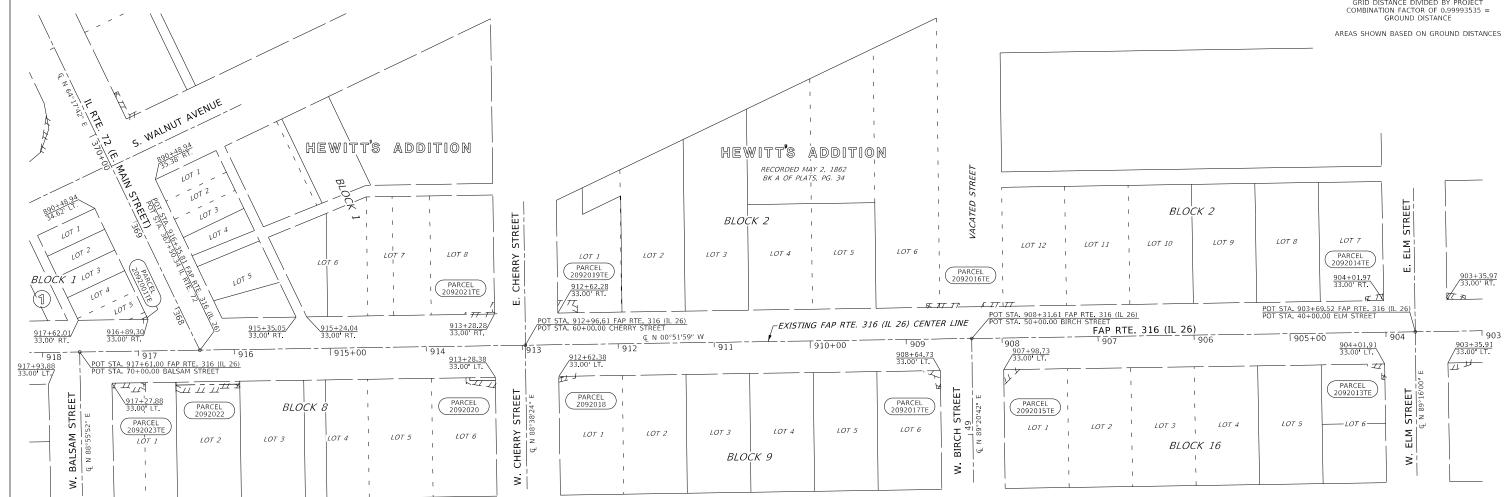

ORIGINAL TOWN OF FORRESTON

RECORDED NOV 10, 1854 BK A OF MISC., PG. 112

SURVEYOR'S STATEMENT

I, SCOTT I, IMMEL, AN ILLINOIS PROFESSIONAL LAND SURVEYOR, STATE THAT I HAVE SURVEYED THE PROPOSED PARCEL(S) TO BE ACQUIRED BY THE STATE OF ILLINOIS, DEPARTMENT OF TRANSPORTATION, SHOWN HEREON, AND THAT THIS PLAT IS A TRUE AND CORRECT REPRESENTATION OF SAID SURVEY AND CONFORMS TO THE ILLINOIS PLAT ACT, SECTION 1(B)(6) AND SECTION 9 THEREOF.



DATED THIS 30TH DAY OF APRIL, 2024

SCOTT I. IMMEL - ILLINOIS PROFESSIONAL LAND SURVEYOR NO.35-3462
CURRENT EXPIRATION DATE: NOVEMBER 30, 2024

ILL INOIS IOWA

ENGINEERING & ENVIRONMENTAL

WISCONSIN

FEHR GRAHAM JOB NO. 19-148K & 19-148N

ASE JOB # 118152.6

USER NAME = \$USER\$ DESIGNED -REVISED DRAWN -CH REVISED REVISED

12/07/2023

REVISED

DATE

STATE OF ILLINOIS **DEPARTMENT OF TRANSPORTATION**

PLAT OF HIGHWAYS SECTION COUNTY T 25N, R 8E OF 4TH P.M. LAND SECTION 33 316 & 549 (2,3,4)RS-7 & 115SW OGLE 132 78 JOB# R-92-009-20 DRAWER FOLDER CONTRACT NO. 64P13 SHEET 22

HEWITT'S 2ND ADDITION RECORDED APRIL 18 1866 BK A OF PLATS, PG. 70

PLOT DATE = 4/30/2024

FAP RTE. 316 (IL 26)

STATION NORTHING EASTING
PT 873+71.08 1984748.3227 2456017.4645
PI 894+40.04 1986817.0300 2455985.5074
PI 921+50.86 1989527.5425 2455944.5139
PI 923+31.49 1989690.5085 2455866.6171
PI 933+95.66 1990650.0964 2455406.5618




PROJECT DATUM IS NAD83 (2011) ILLINOIS STATE PLANE COORDINATES, WEST ZONE, BEARINGS AND DISTANCES SHOWN HEREON ARE BASED ON GRID COORDINATES

GRID DISTANCE DIVIDED BY PROJECT COMBINATION FACTOR OF 0.99993535 = GROUND DISTANCE

AREAS SHOWN BASED ON GROUND DISTANCES

ILLINOIS IOWA

WISCONSIN

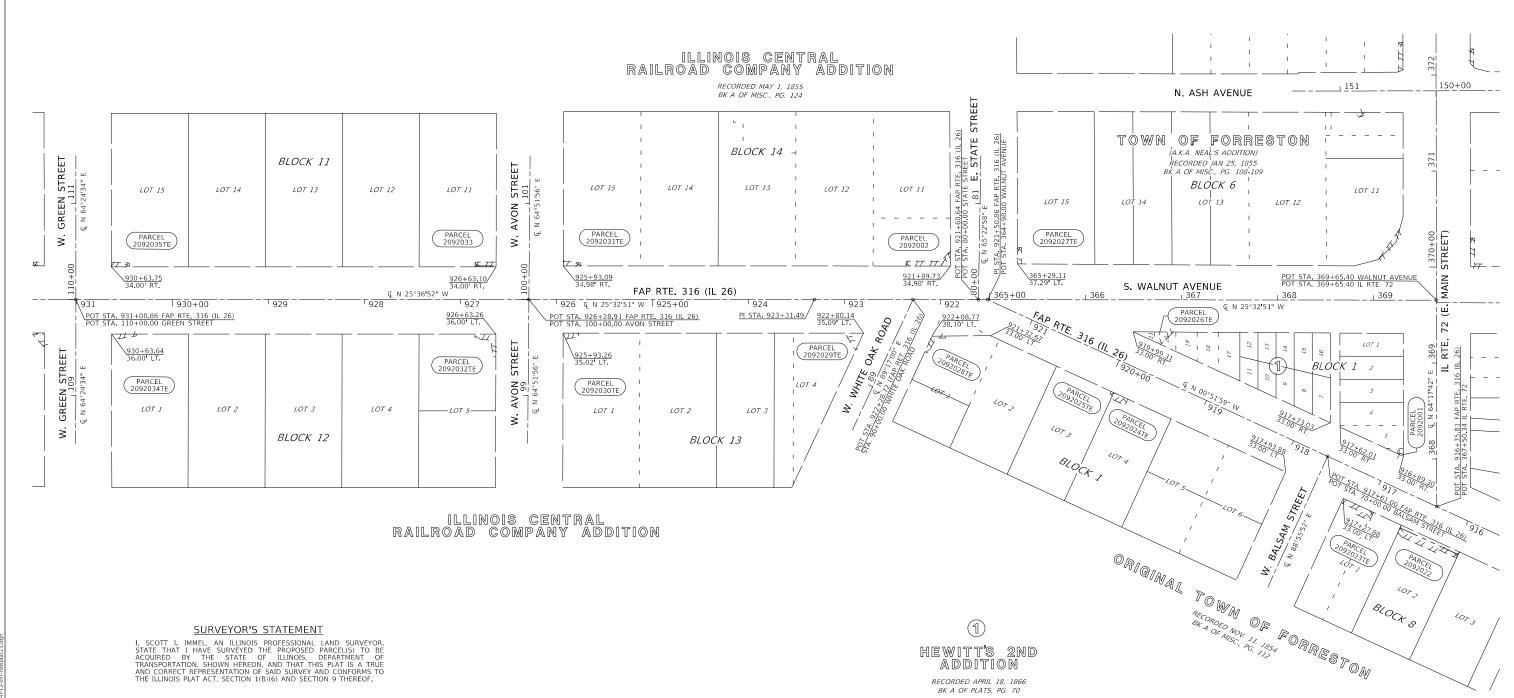

MINOS TAGE OF THE PROPERTY OF

DATED THIS 30TH DAY OF APRIL, 2024

USER NAME = \$USER\$

PLOT DATE = 4/30/2024

SCOTT I. IMMÈN. ILLIMOIS PROFESSIONAL LAND SURVEYOR NO.35-3462
CURRENT EXPIRATION DATE: NOVEMBER 30, 2024

DESIGNED -

DRAWN -

DATE

CH

12/07/2023

REVISED

REVISED REVISED

REVISED

STATE OF ILLINOIS

DEPARTMENT OF TRANSPORTATION

FEHR GRAHAM JOB NO. 19-148					ı	ASE	JOB # 118152.)	
PLAT OF HIGHWAYS					SE	CTION	COUNTY	TOTAL SHEETS	SHEE NO.
LAND	SECTION 33	T 25N, R 8E OF 4TH P.M.		316 & 549	(2,3,4)RS	6-7 & 115SW	OGLE	132	79
JOB#	R-92-009-20	DRAWER	FOLDER				CONTRACT	NO. 64	IP13
SCALE: 1" = 50'	SHEET 23 OF 25 SHEETS	STA, 916+00	TO STA, 931+00	ILLINOIS FED, AID PRO			AID PROJECT		

ENGINEERING & ENVIRONMENTAL
ILLINOIS DESIGN FIRM NO. 184-003525

MODEL: Default



PROJECT DATUM IS NAD83 (2011) ILLINOIS STATE PLANE COORDINATES, WEST ZONE, BEARINGS AND DISTANCES SHOWN HEREON ARE BASED ON GRID COORDINATES

GRID DISTANCE DIVIDED BY PROJECT COMBINATION FACTOR OF 0.99993535 = GROUND DISTANCE


AREAS SHOWN BASED ON GROUND DISTANCES

FAP RTE. 316 (IL 26)

TAI THE. 510 (IE 20)							
STA	TION	NORTHING	EASTING				
PT	873+71.08	1984748.3227	2456017.4645				
PI	894+40.04	1986817.0300	2455985.5074				
ΡI	921+50.86	1989527.5425	2455944.5139				
PI	923+31.49	1989690.5085	2455866.6171				
PΙ	933+95.66	1990650.0964	2455406.5618				
PC	962+73.54	1993247.0236	2454166.3381				

ILLINOIS CENTRAL RAILROAD COMPANY ADDITION

RECORDED MAY 1, 1855 BK A OF MISC., PG. 124

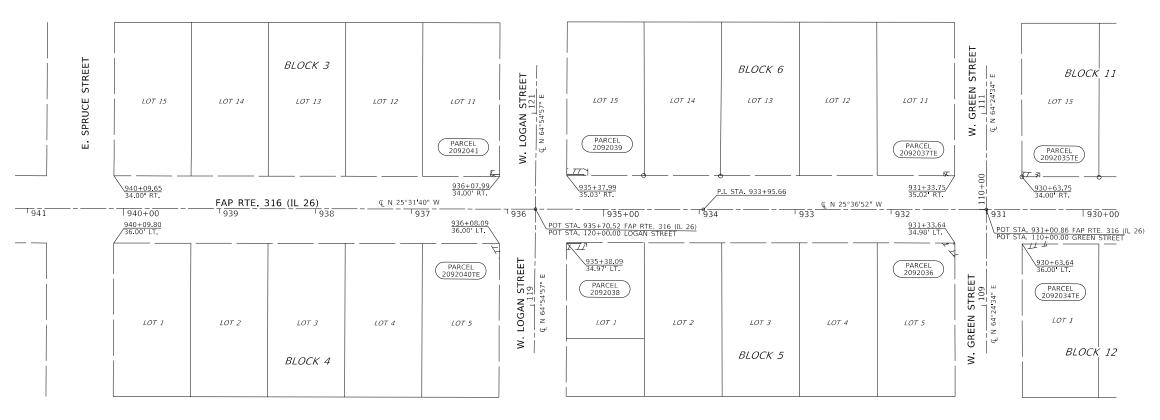

ILLINOIS CENTRAL RAILROAD COMPANY ADDITION

SURVEYOR'S STATEMENT

I, SCOTT I, IMMEL, AN ILLINOIS PROFESSIONAL LAND SURVEYOR, STATE THAT I HAVE SURVEYED THE PROPOSED PARCEL(S) TO BE ACQUIRED BY THE STATE OF ILLINOIS, DEPARTMENT OF TRANSPORTATION, SHOWN HEREON, AND THAT THIS PLAT IS A TRUE AND CORRECT REPRESENTATION OF SAID SURVEY AND CONFORMS TO THE ILLINOIS PLAT ACT, SECTION 1(B)(6) AND SECTION 9 THEREOF.



DATED THIS 30TH DAY OF APRIL, 2024

SCOTT I. IMME LILLIMOIS PROFESSIONAL LAND SURVEYOR NO.35-3462 CURRENT EXPIRATION DATE: NOVEMBER 30, 2024

FEHR GRAHAM

ENGINEERING & ENVIRONMENTAL

ILLINOIS IOWA WISCONSIN

FEHR GRAHAM JOB NO. 19-148K & 19-148N

ASE JOB # 118152.6

USER NAME = SUSERS DESIGNED - SI REVISED
PLATO

 PLAT OF HIGHWAYS
 F.A.P. RTE.
 SECTION
 COUNTY
 TOTAL SHEETS NO.


 LAND SECTION 33
 T 25N, R 8E 0F 4TH P.M.
 316 & 549 (2,3,4)RS-7 & 1155W
 OGLE
 132 80

 JOB# R-92-009-20
 DRAWER
 FOLDER
 CONTRACT NO. 64 P13

 LE: 1" = 50"
 SHEET 24 0F 25 SHEETS
 STA. 930+00 TO STA. 941+00
 ILLINOIS FED. AID PROJECT

FILE NAME: G:\MSGPK\19\19-1

 STATE OF ILLINOIS DEPARTMENT OF TRANSPORTATION

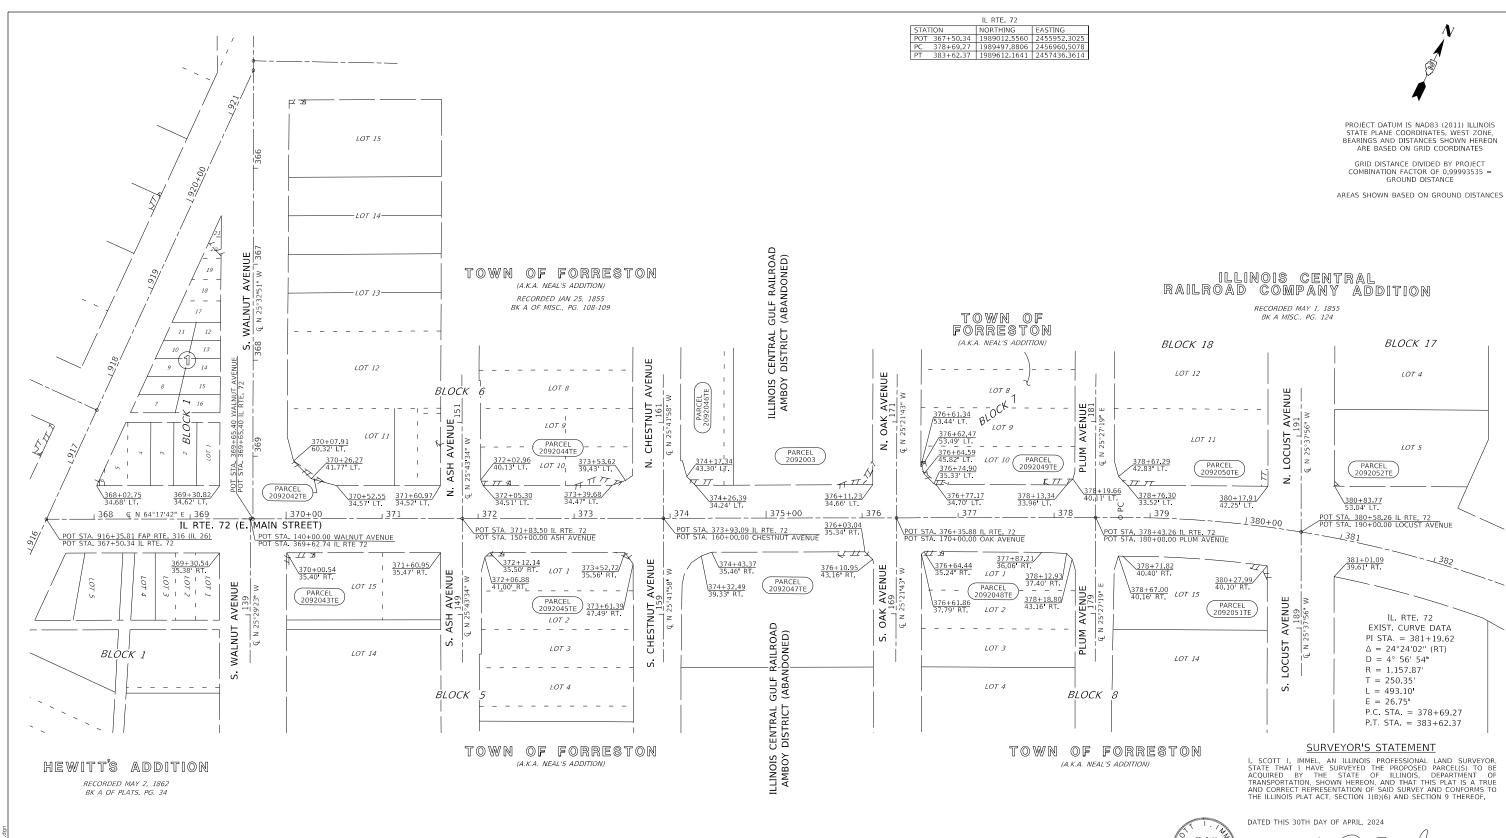

1

HEWITT'S

RECORDED APRIL 18, 1866 BK A OF PLATS, PG. 70

ENGINEERING & ENVIRONMENTAL

Donn

SCOTT I. IMMEL ILLINOIS PROFESSIONAL LAND SURVEYOR NO.35-3462 CURRENT EXPIRATION DATE: NOVEMBER 30, 2024

ILL INOIS IOWA


FEHR GRAHAM JOB NO. 19-148K & 19-148N


WISCONSIN


ASE JOB # 118152.6


OSER MARIE - POSERS	DESIGNED	-	31	INEVISED	-
	DRAWN	-	СН	REVISED	-
PLOT SCALE = \$SCALE\$	CHECKED	-	PS	REVISED	-
PLOT DATE = 4/30/2024	DATE	_	12/07/2023	REVISED	-


DESIGNED

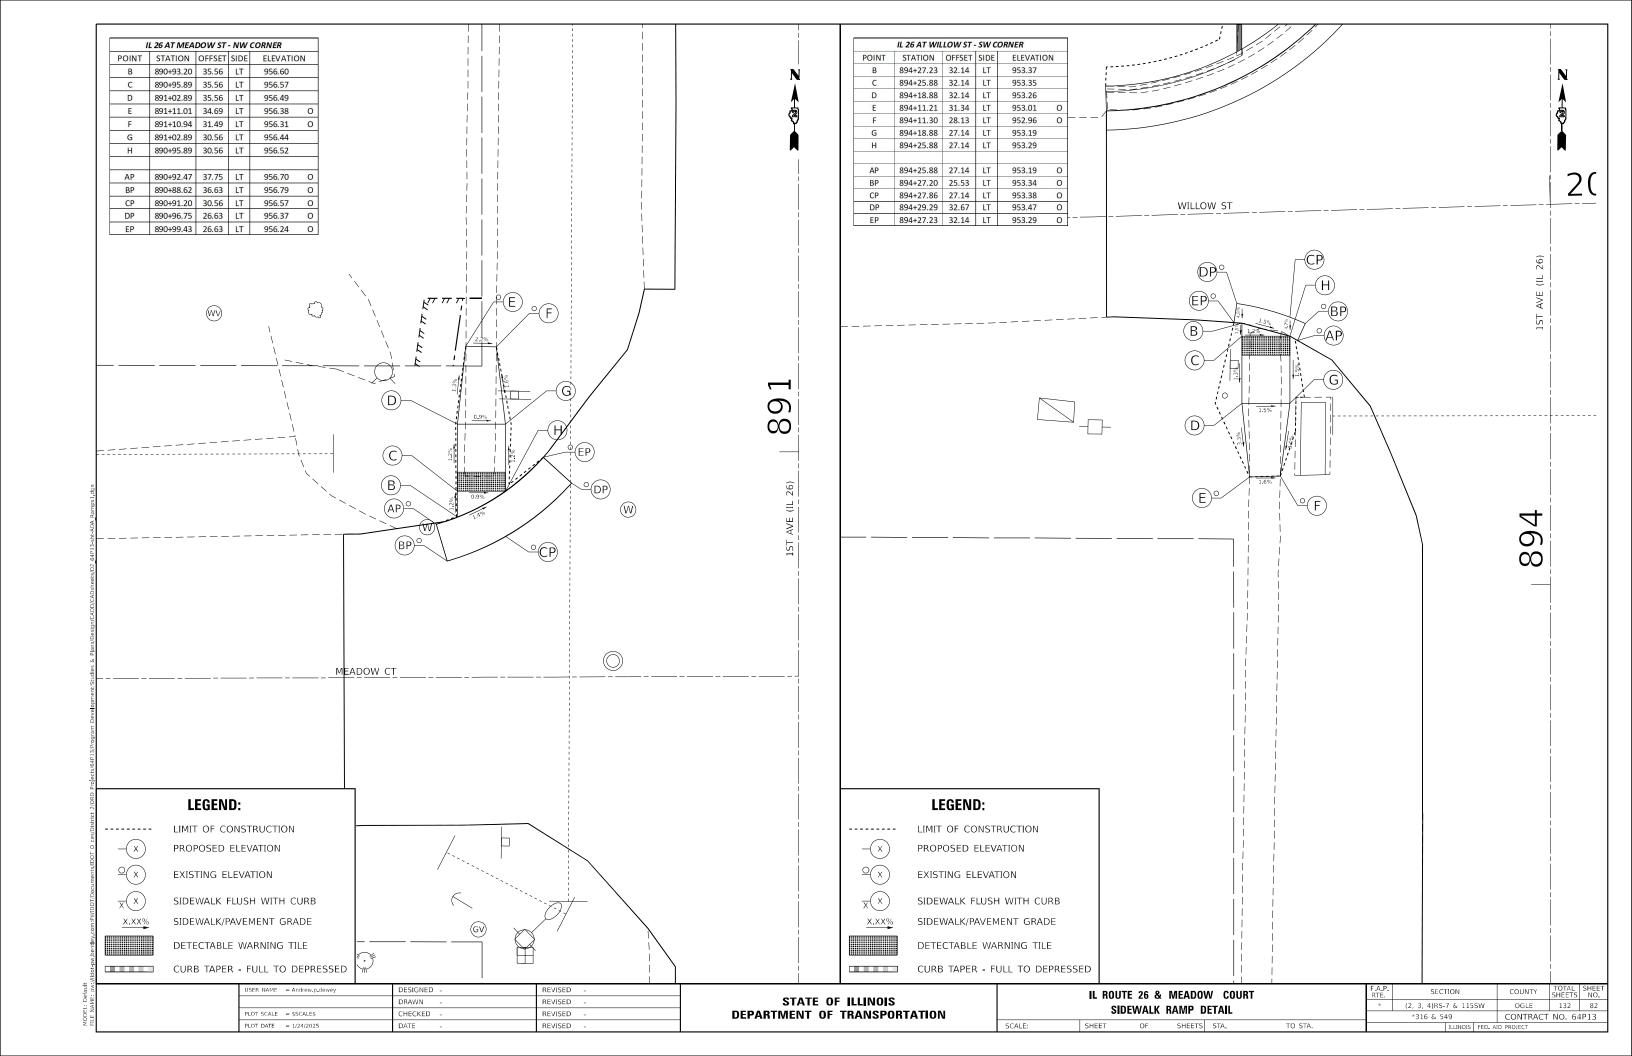


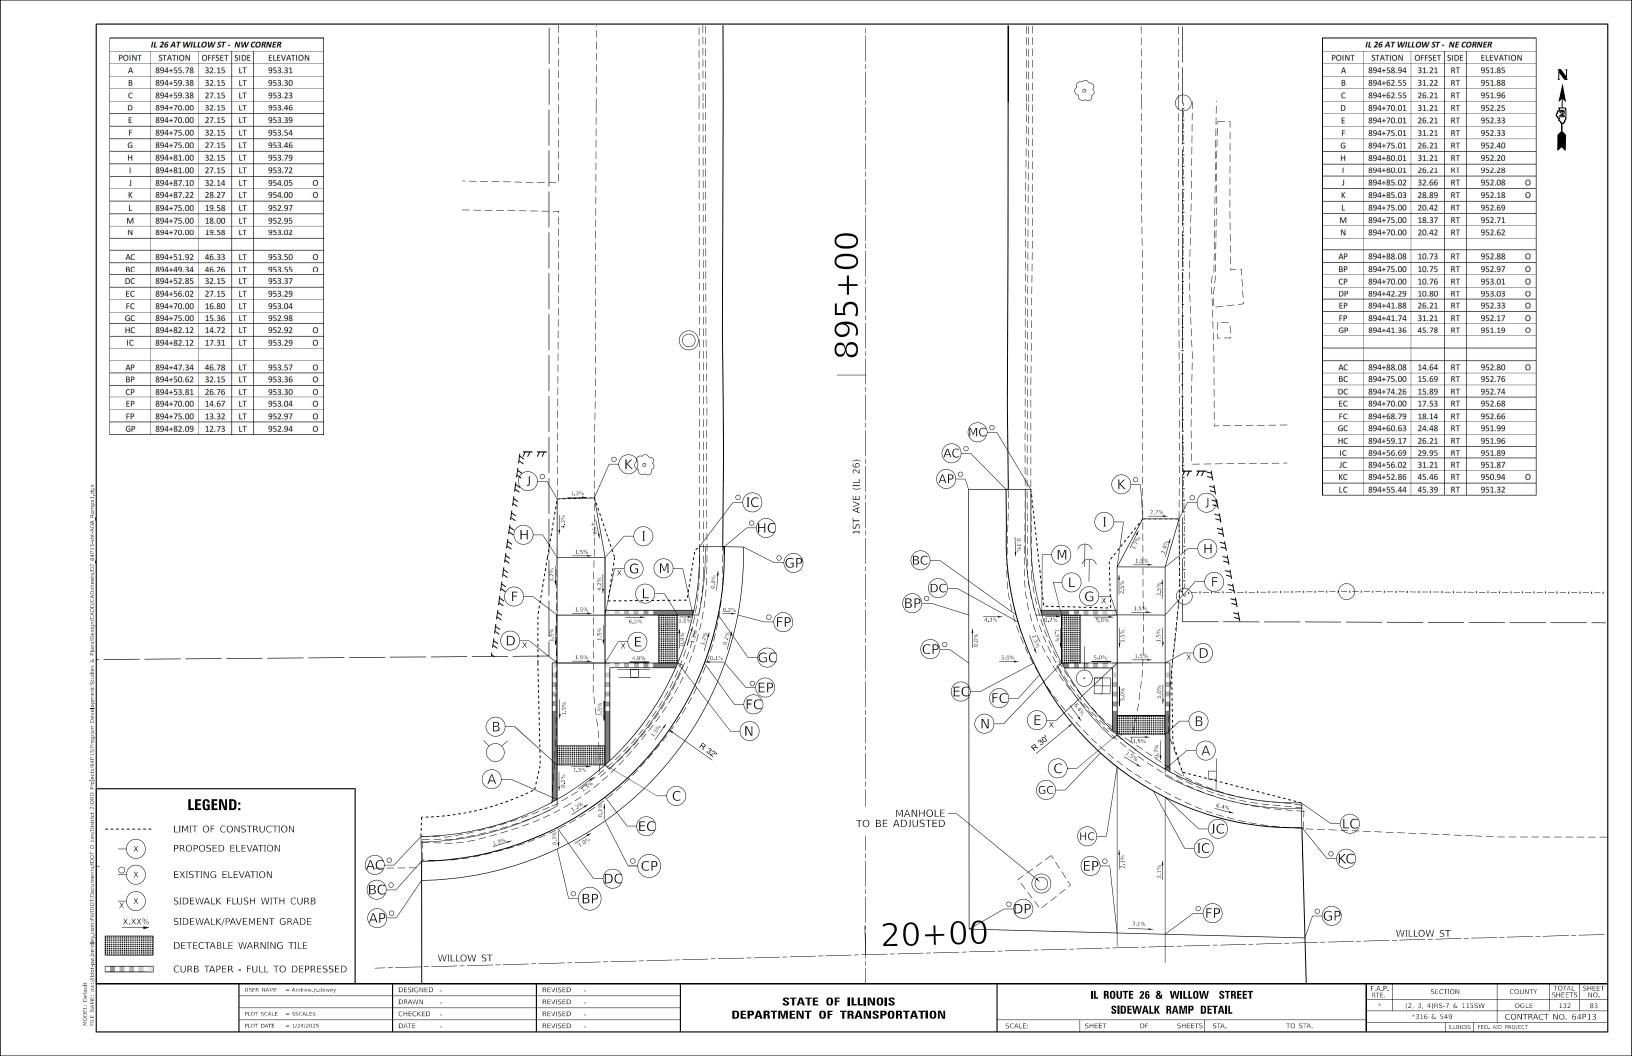


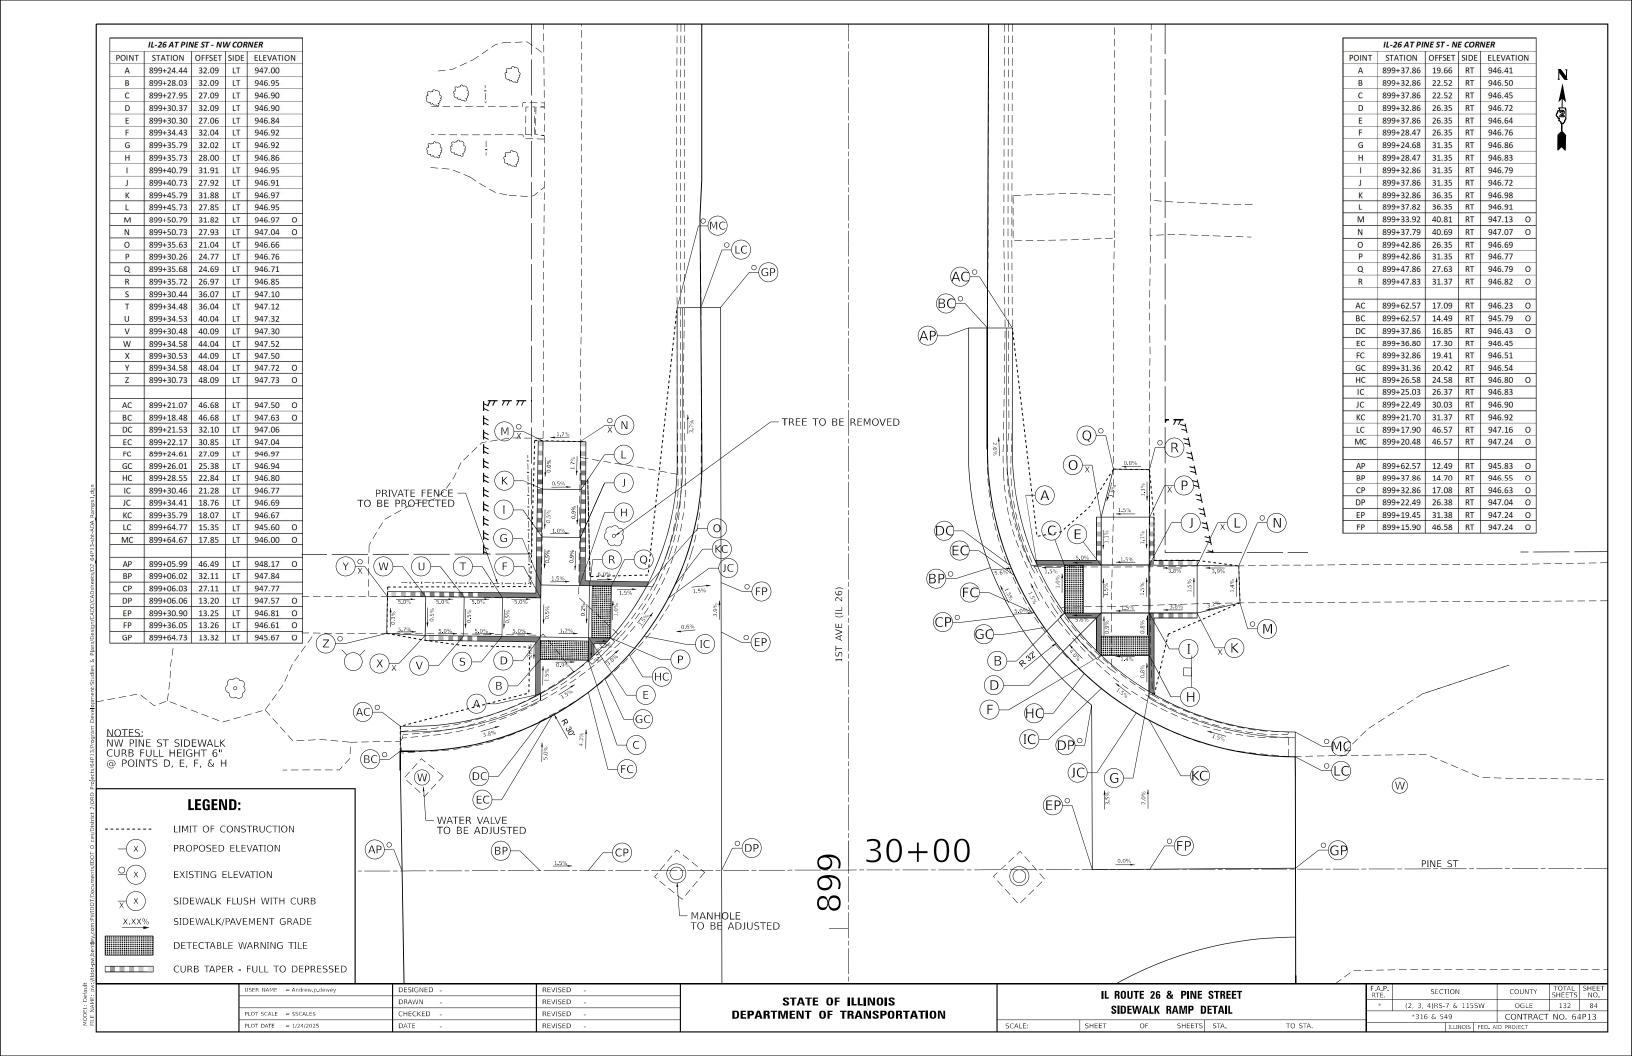


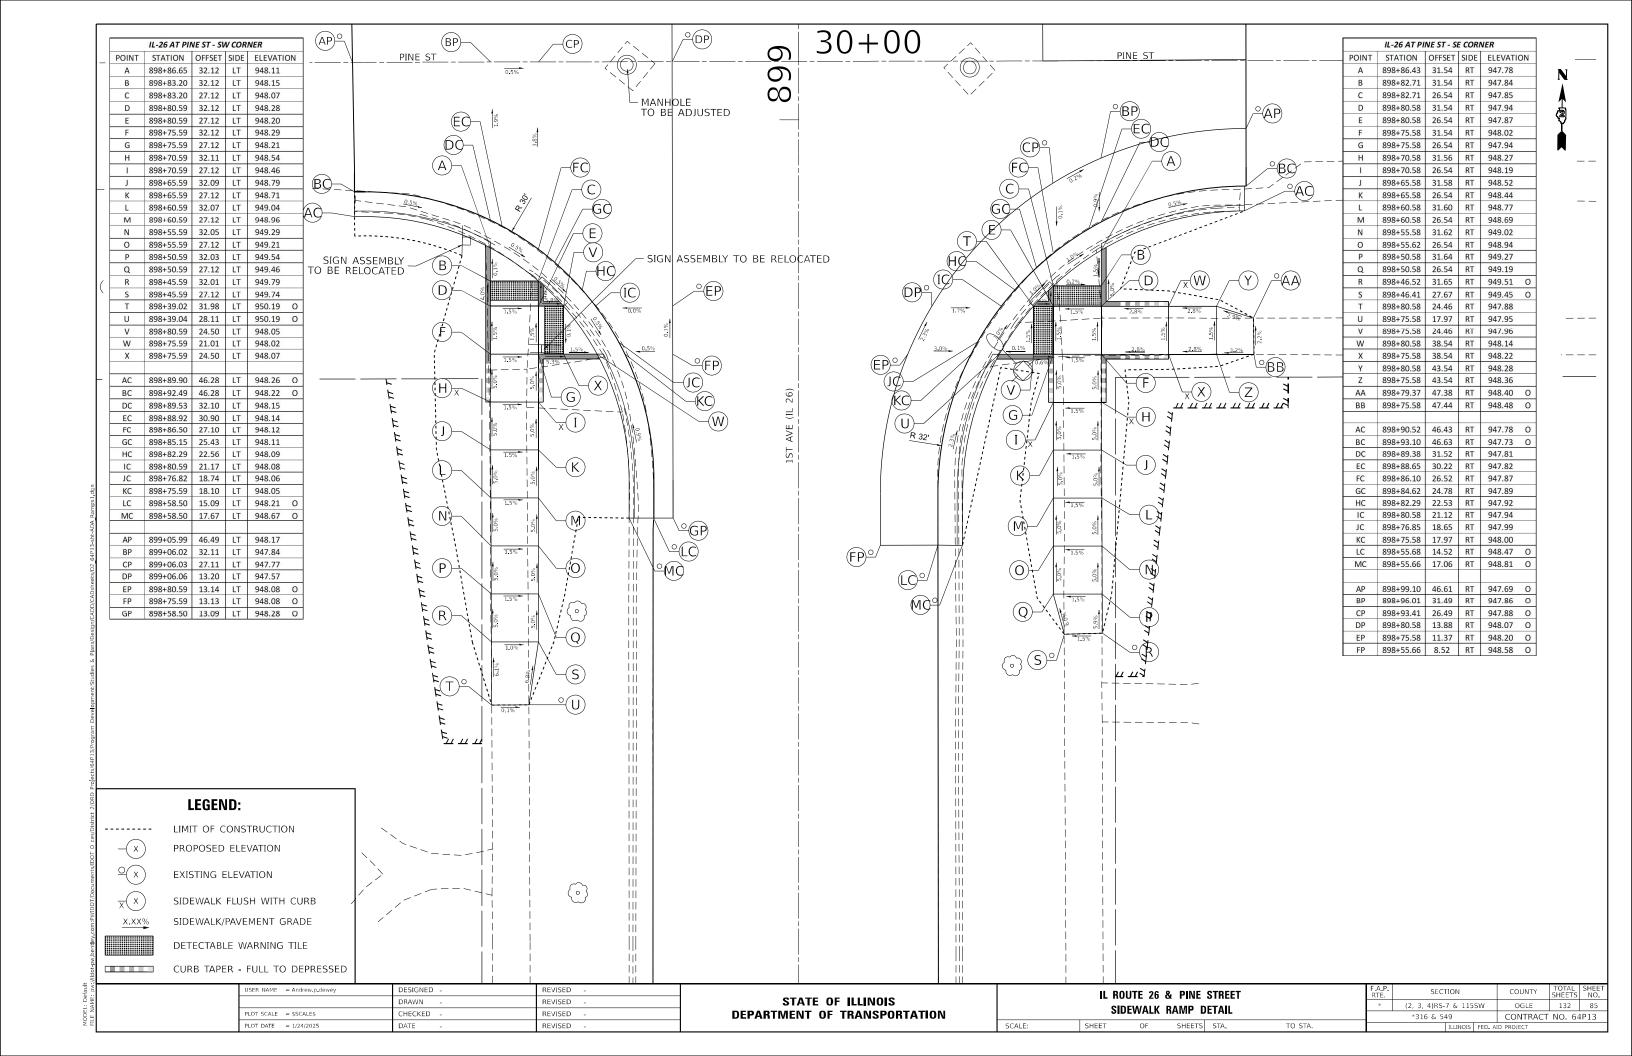


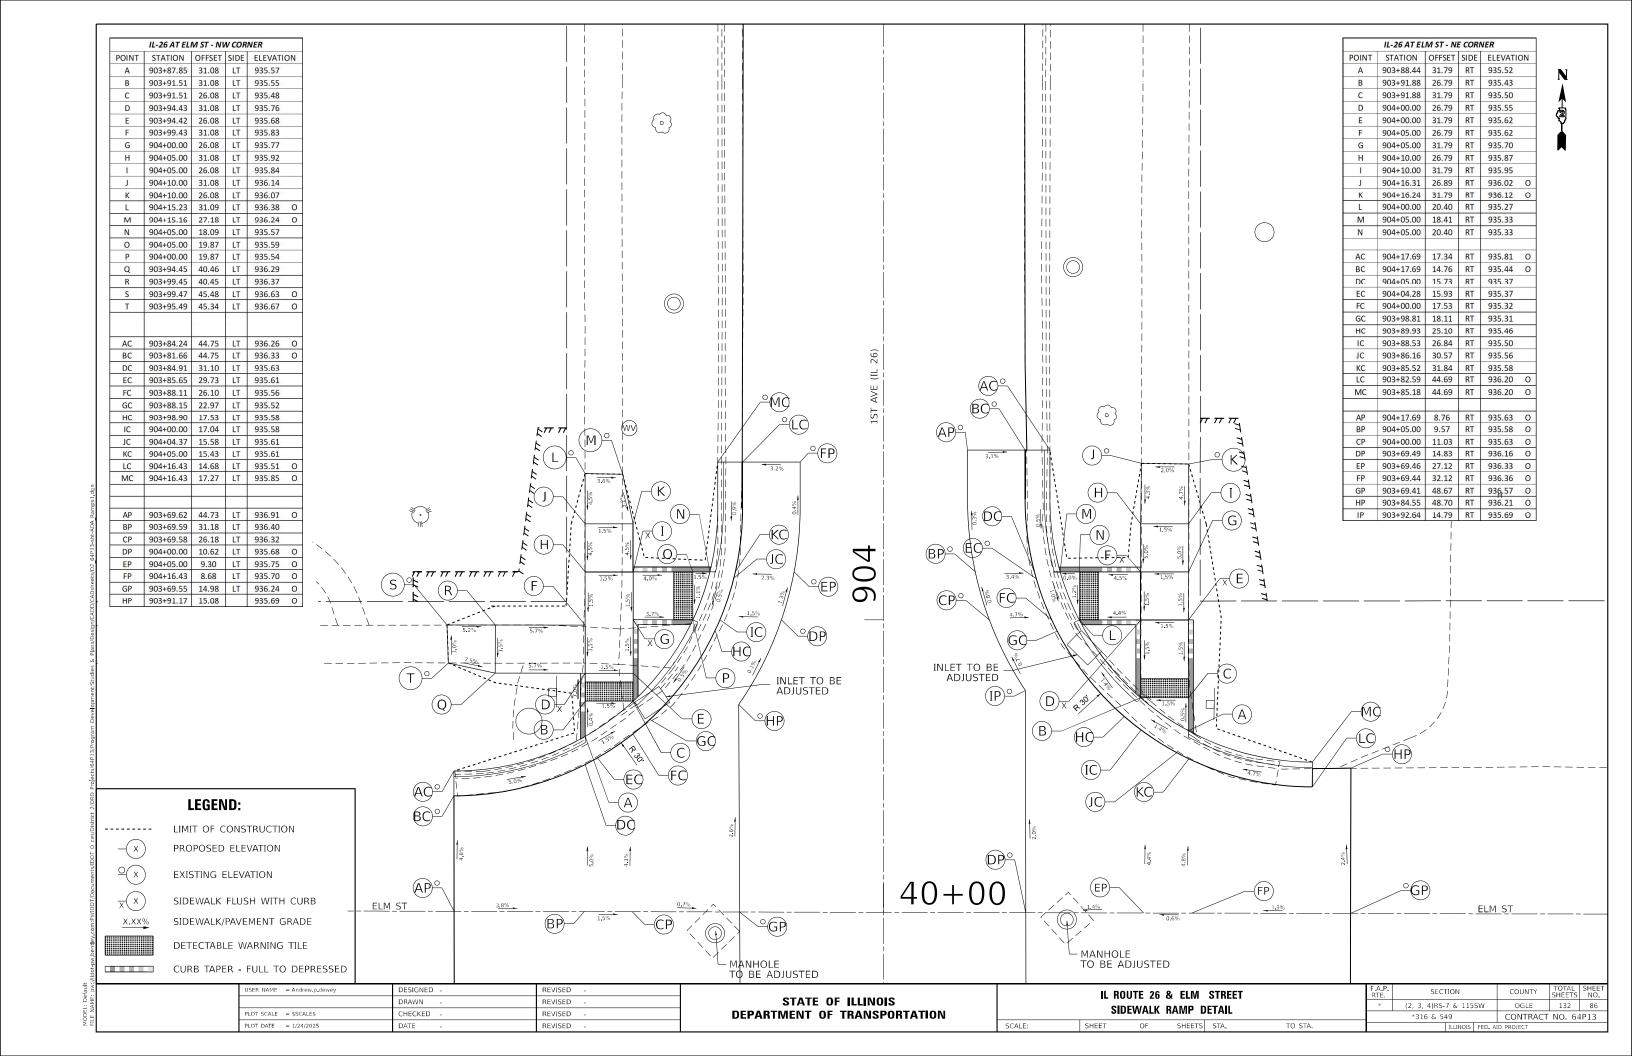


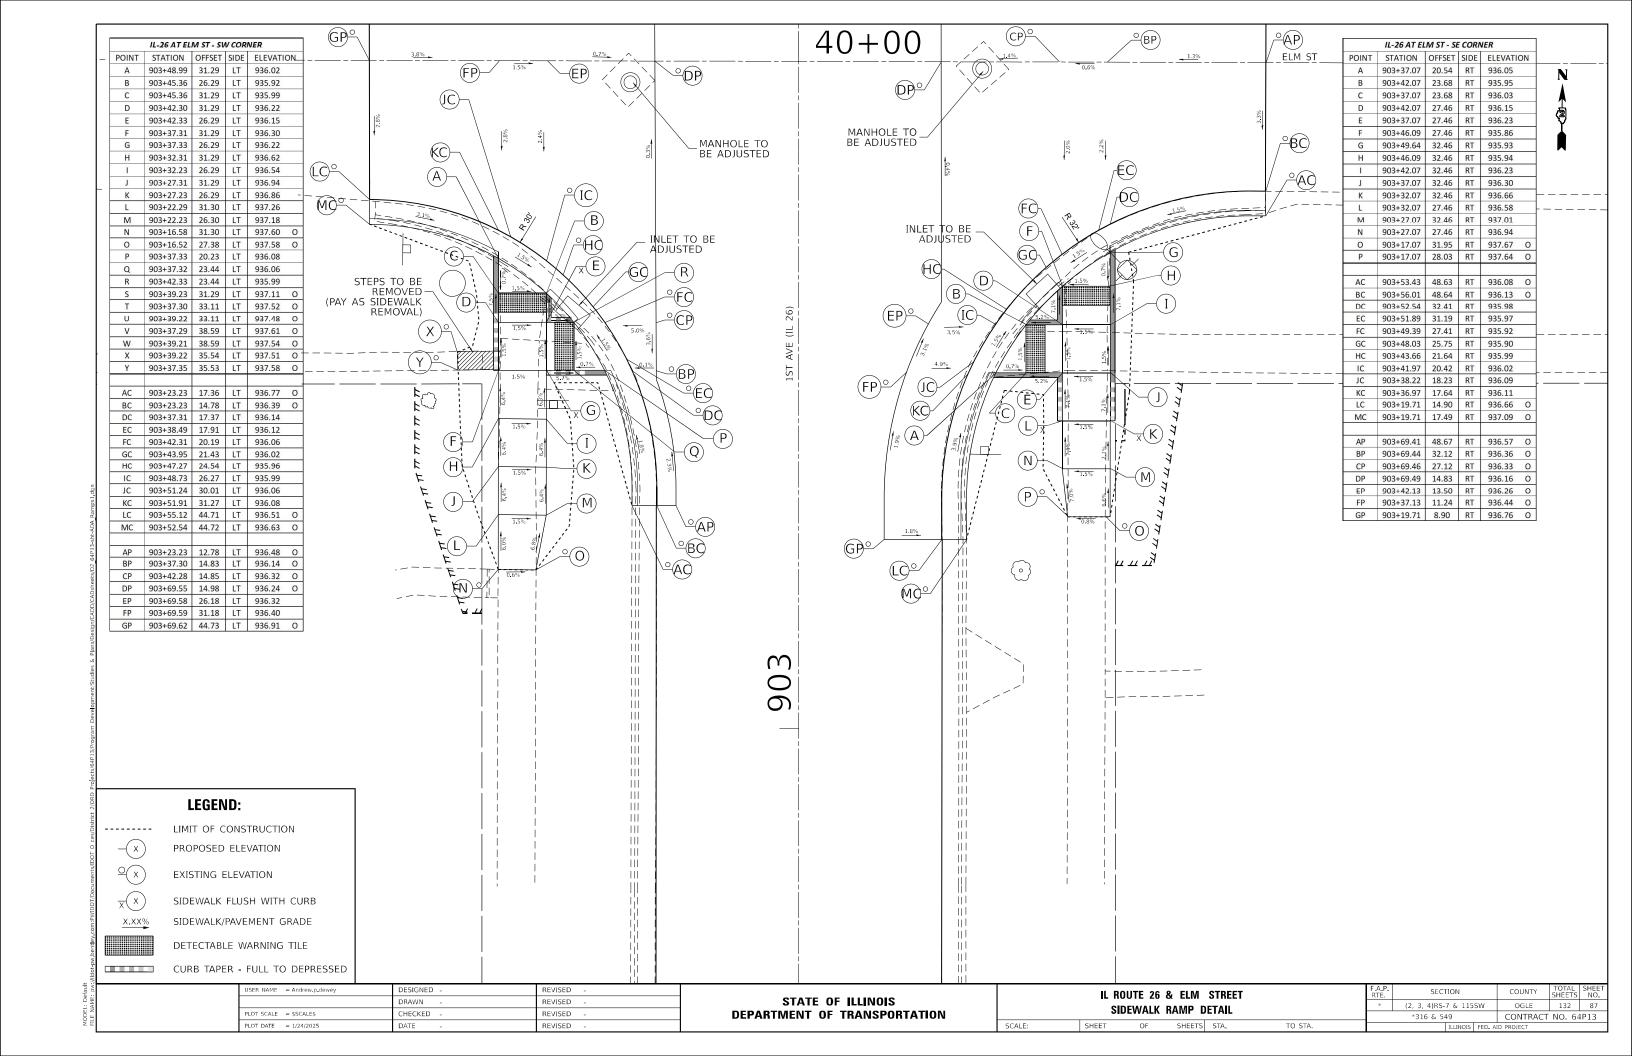


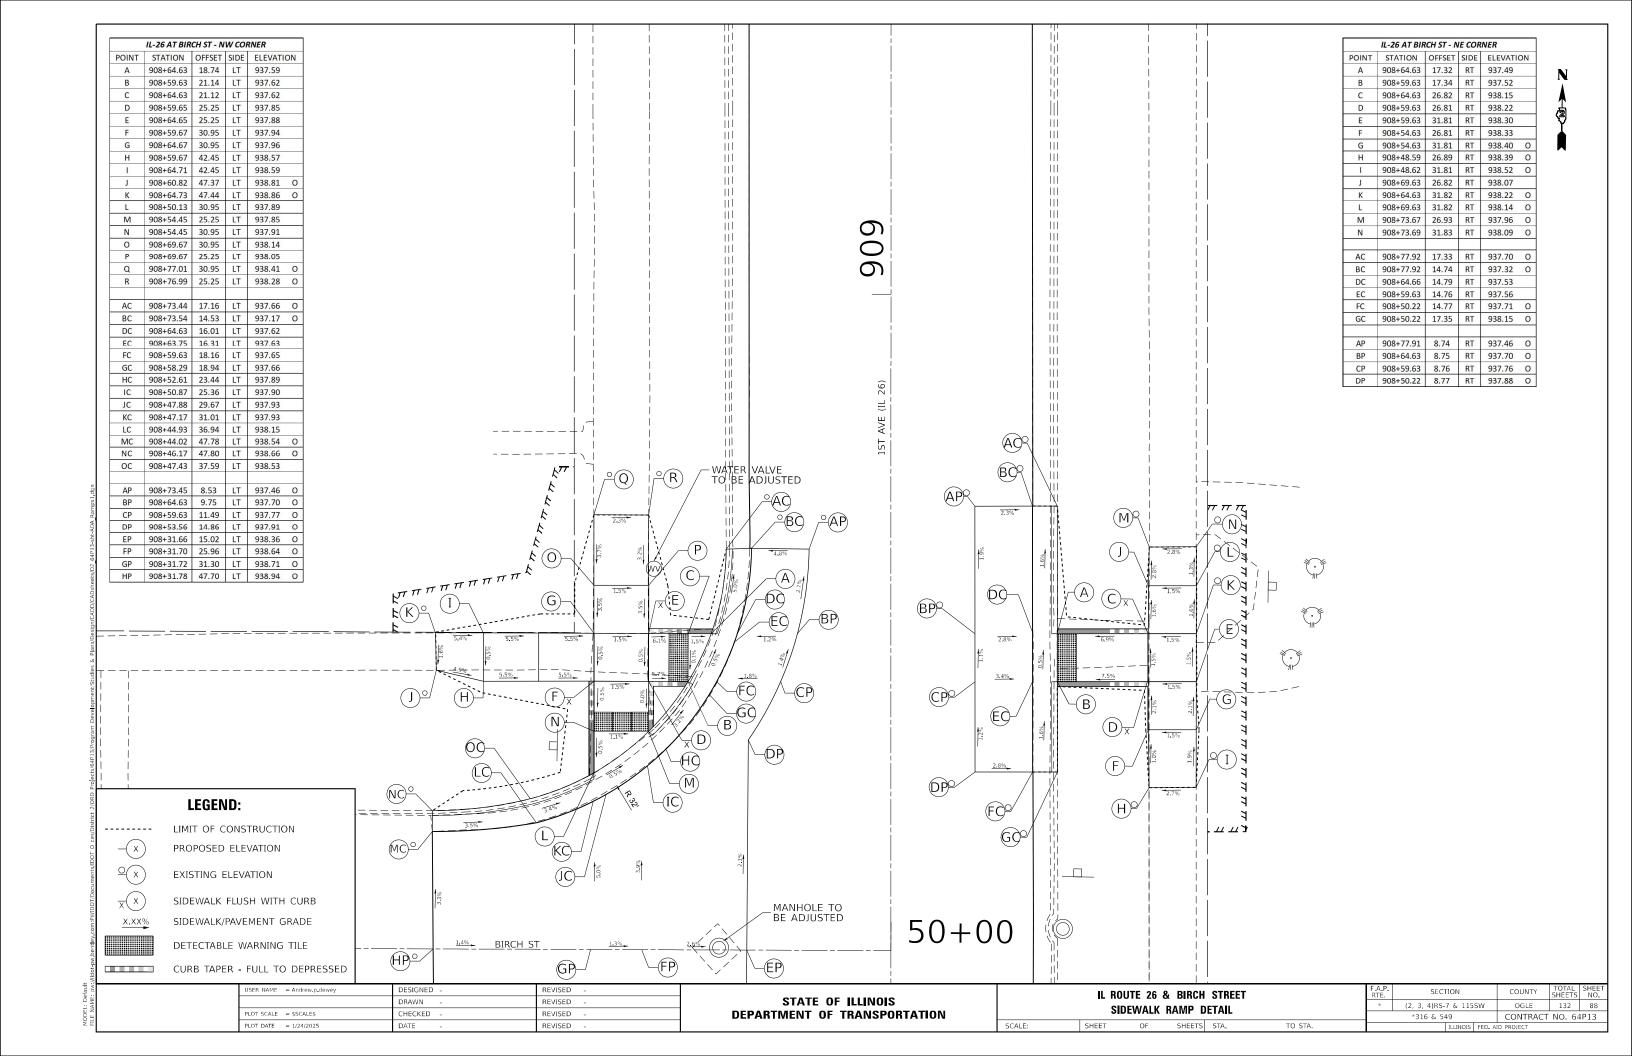


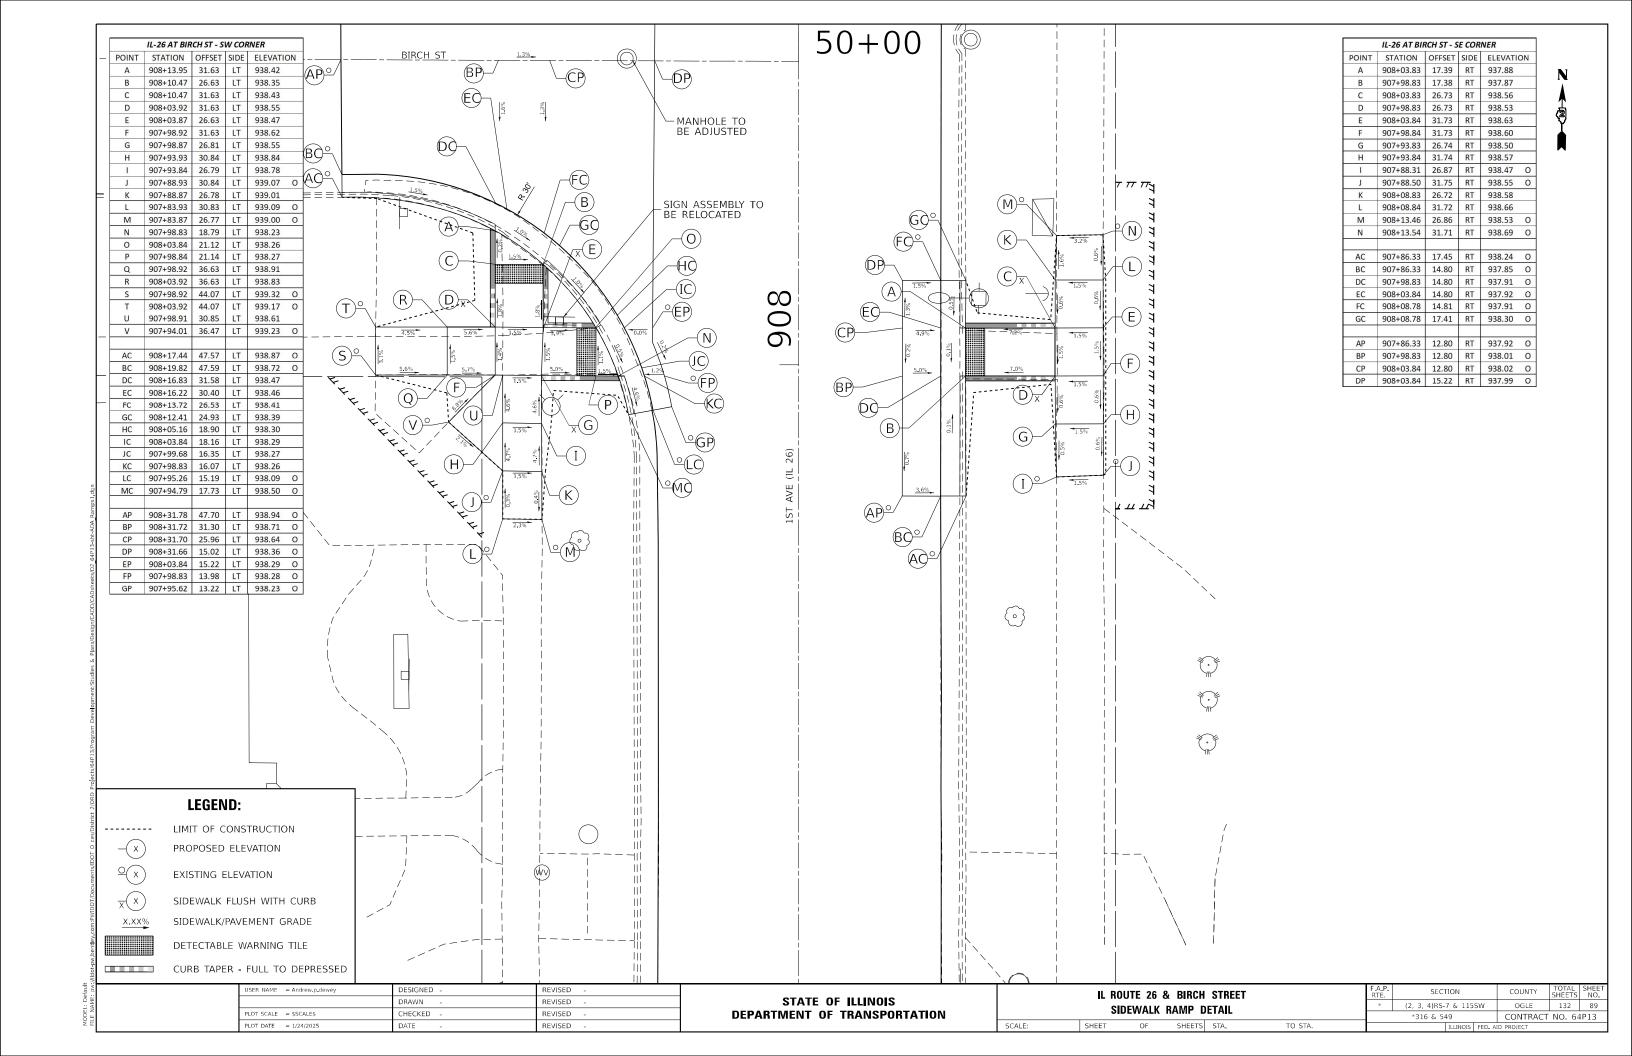


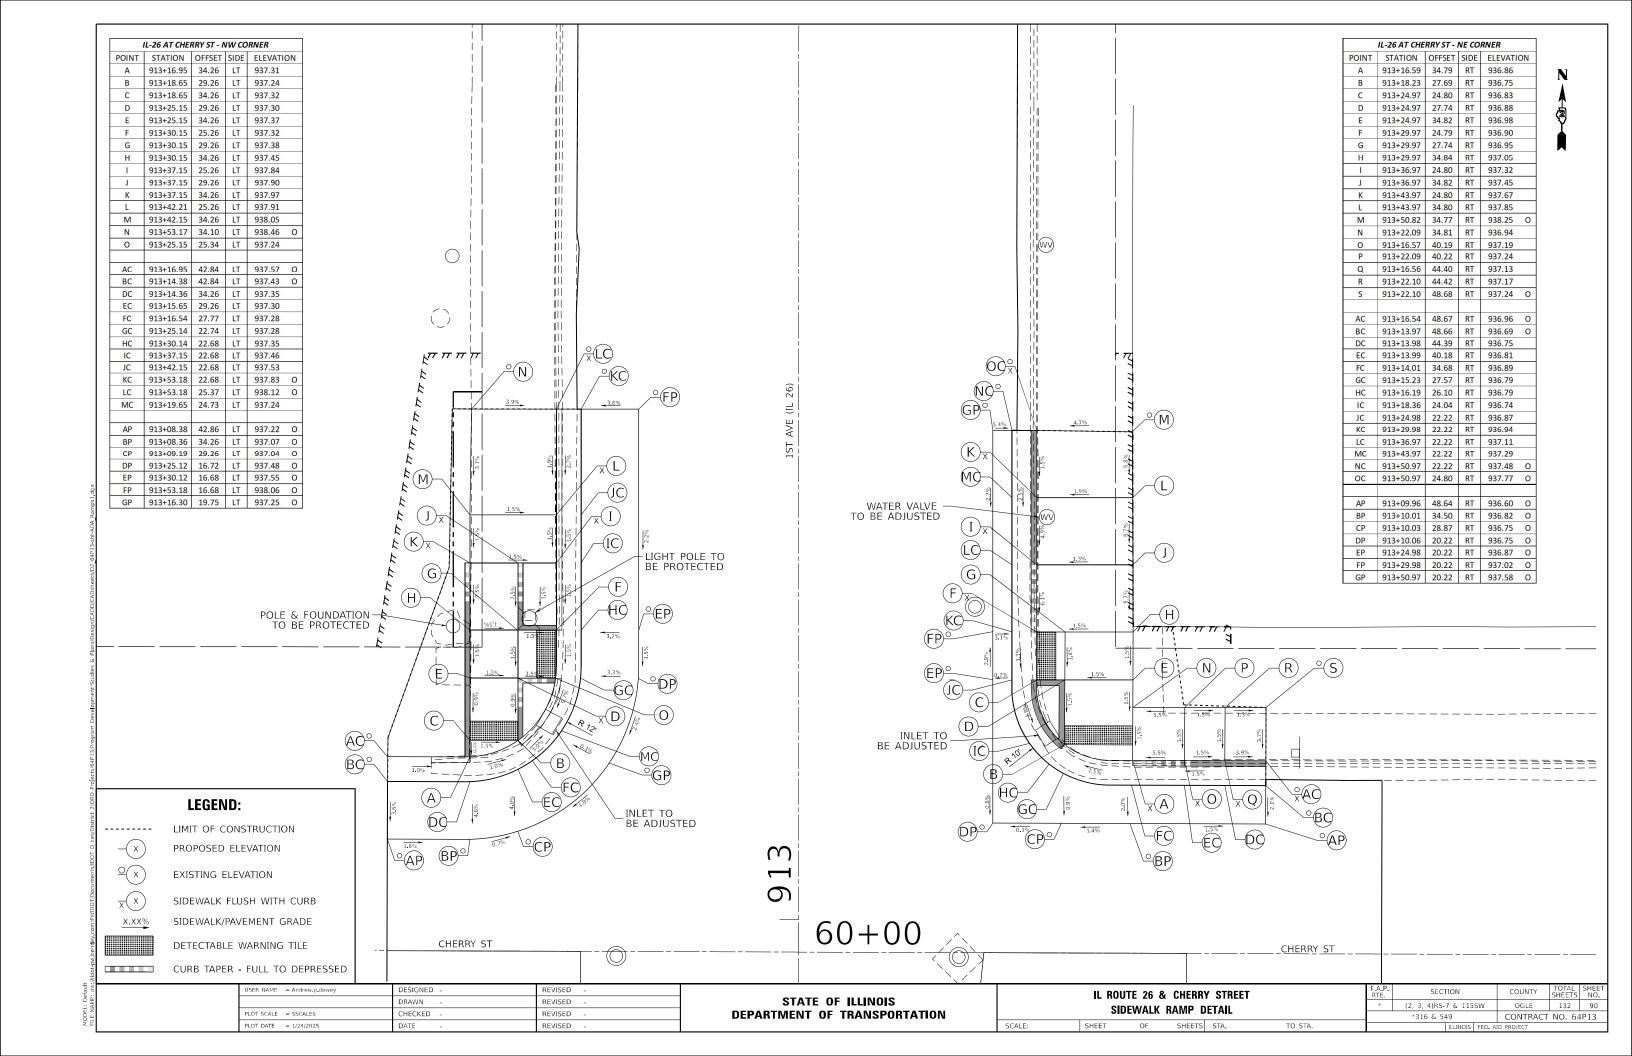


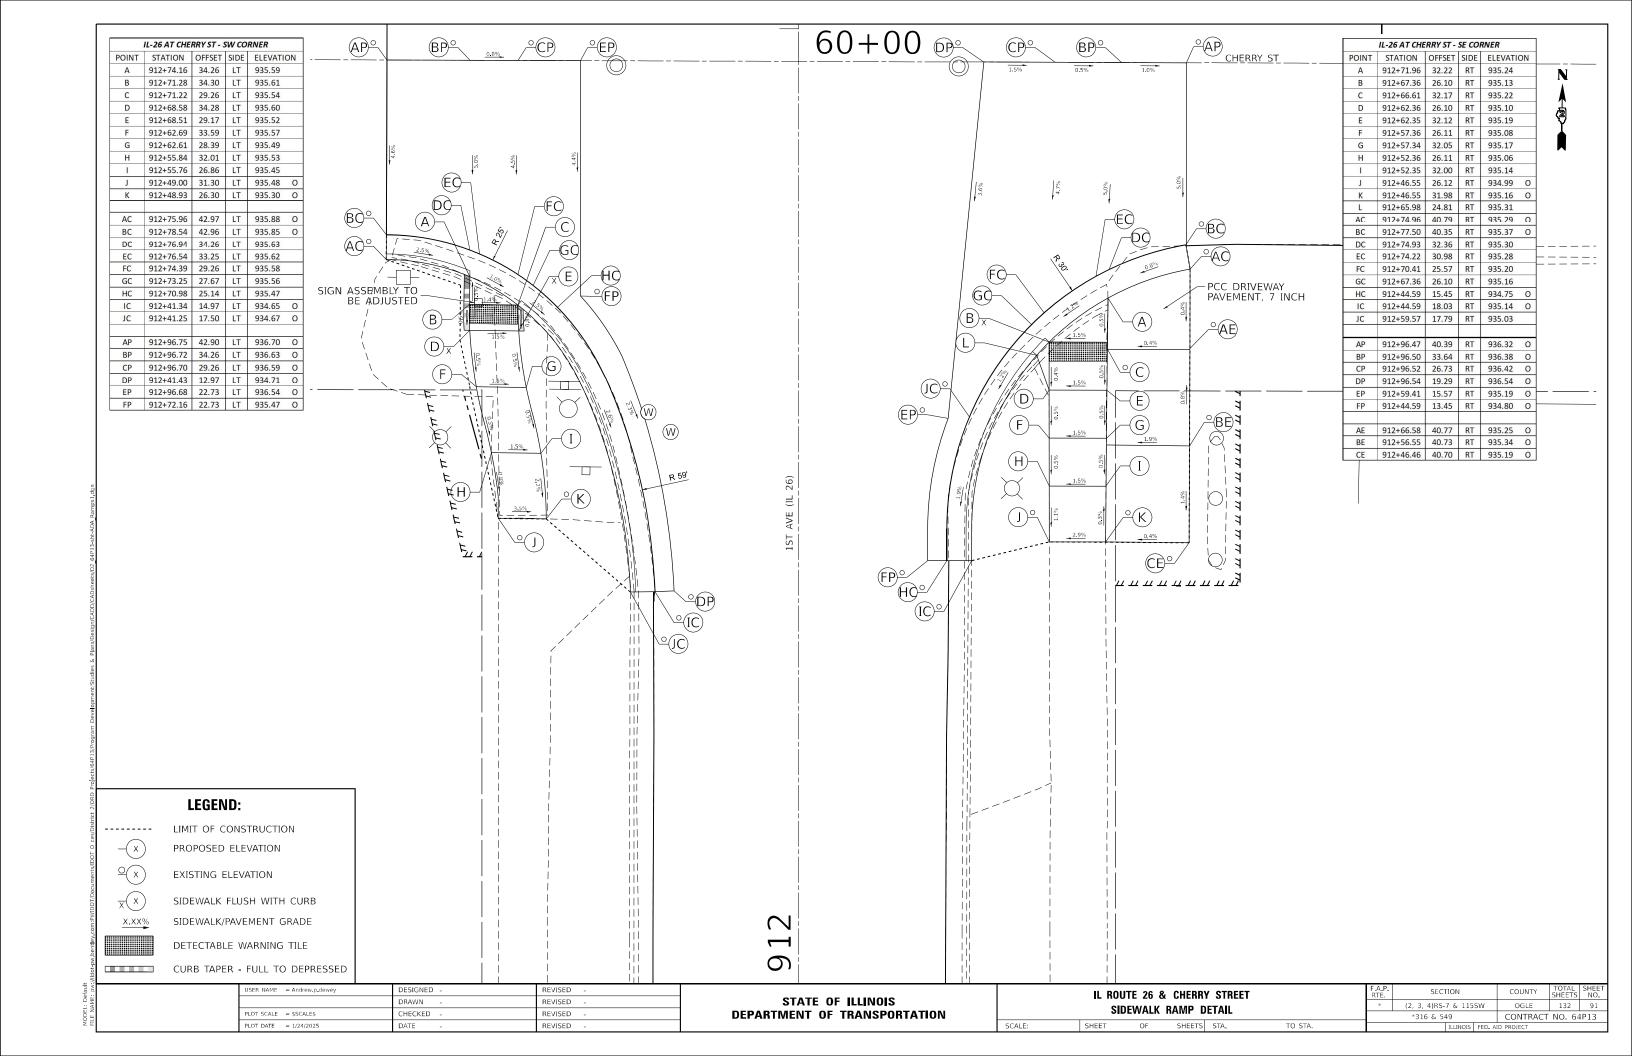


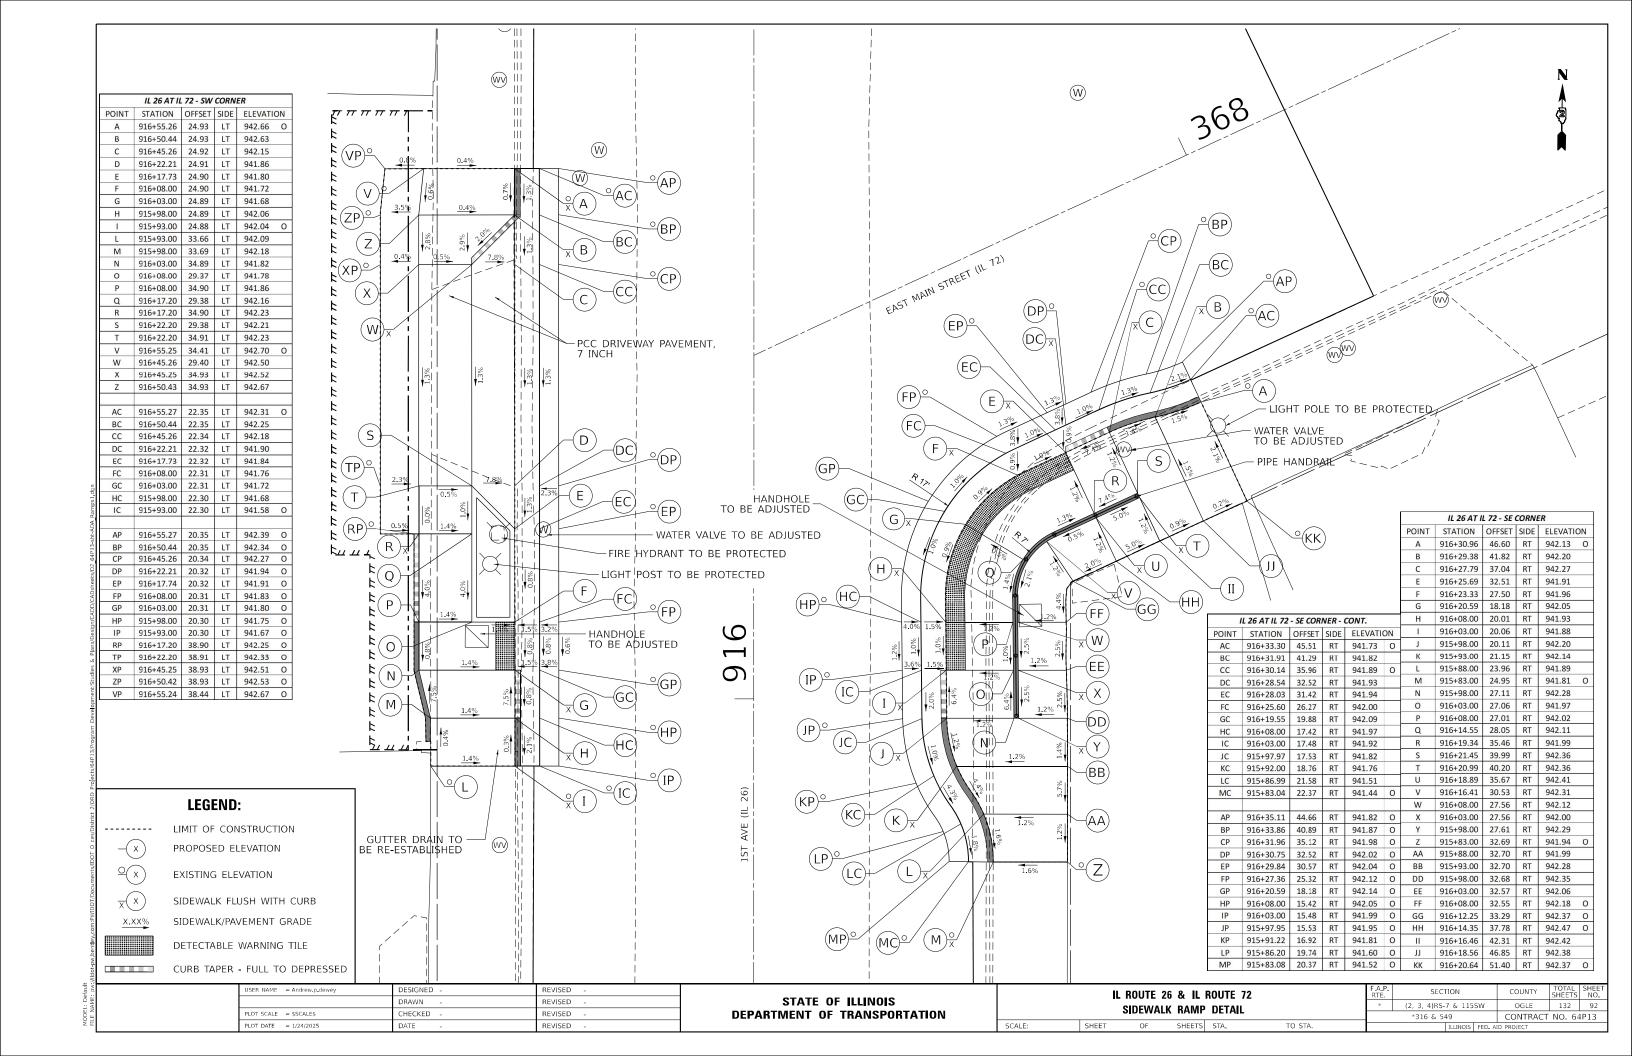


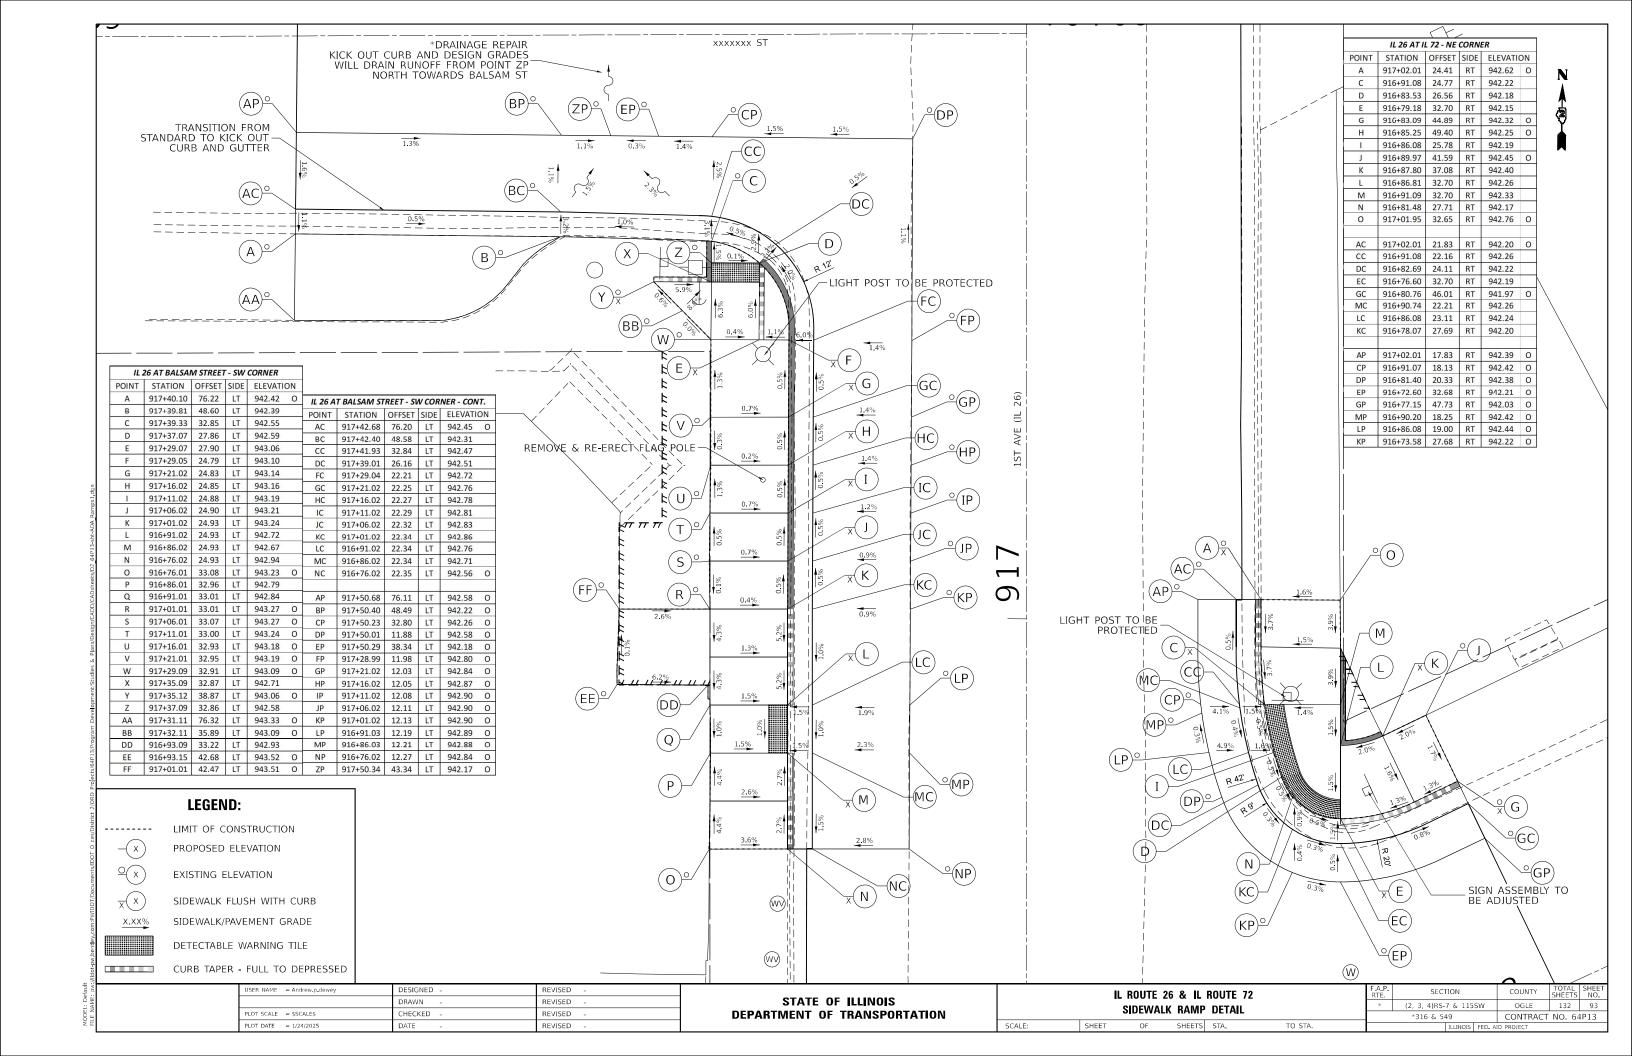


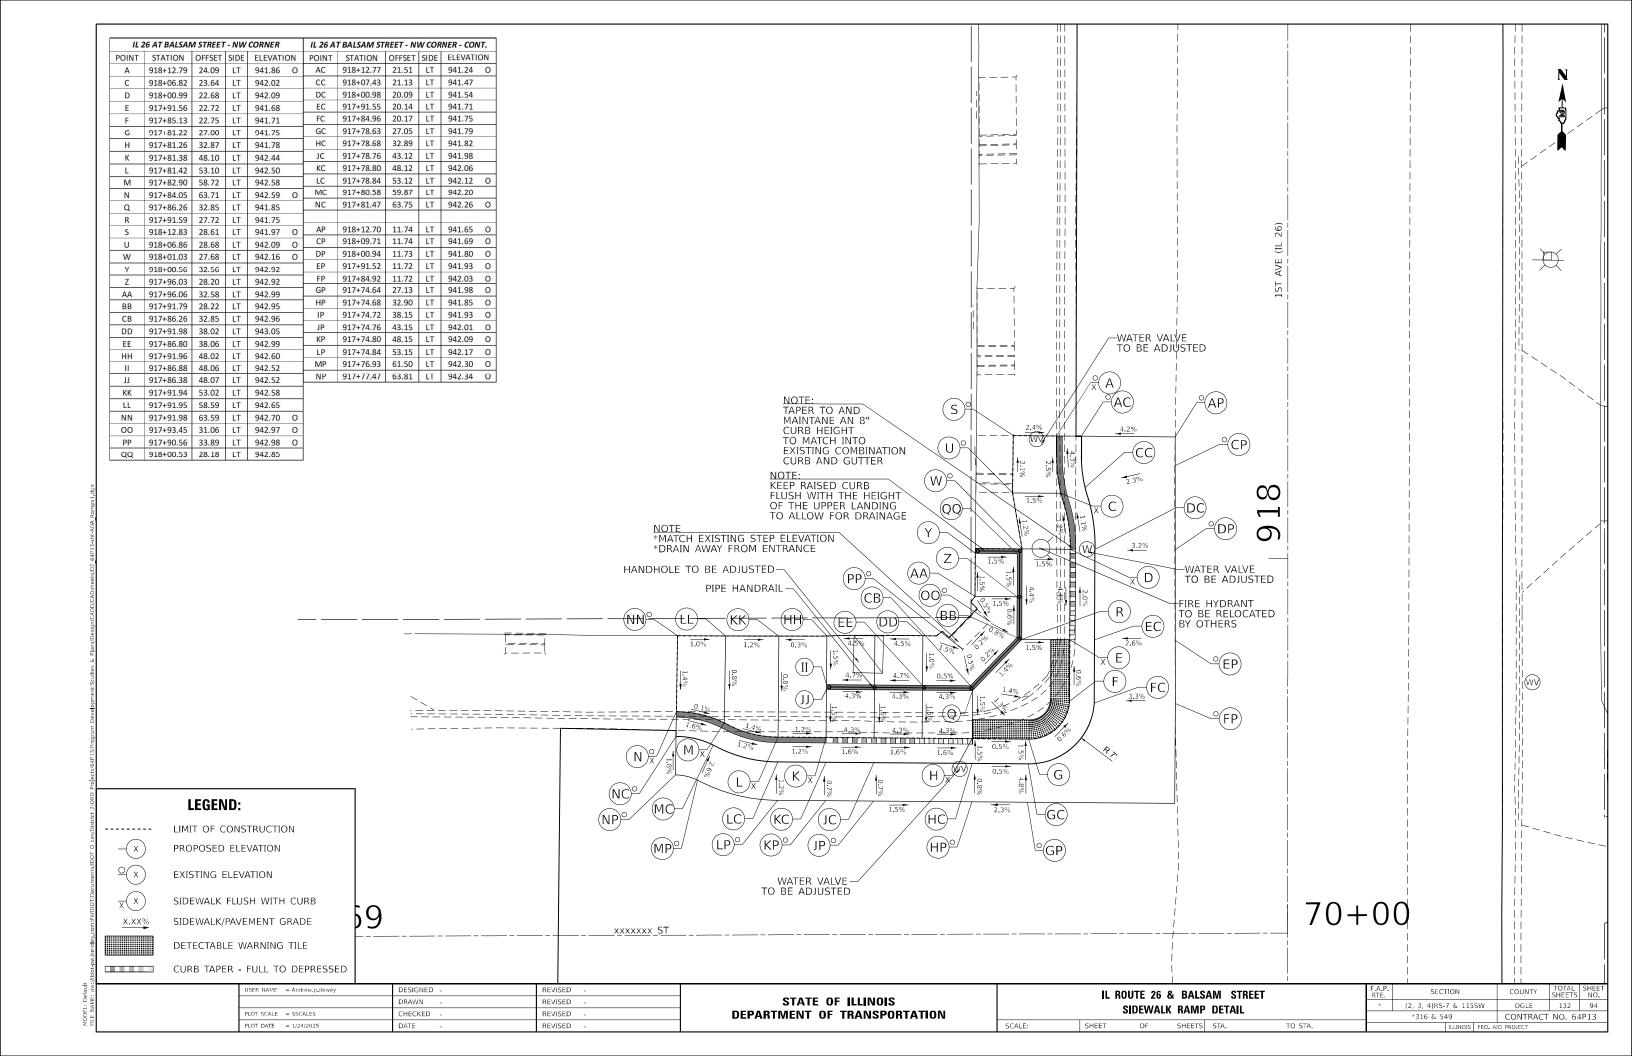


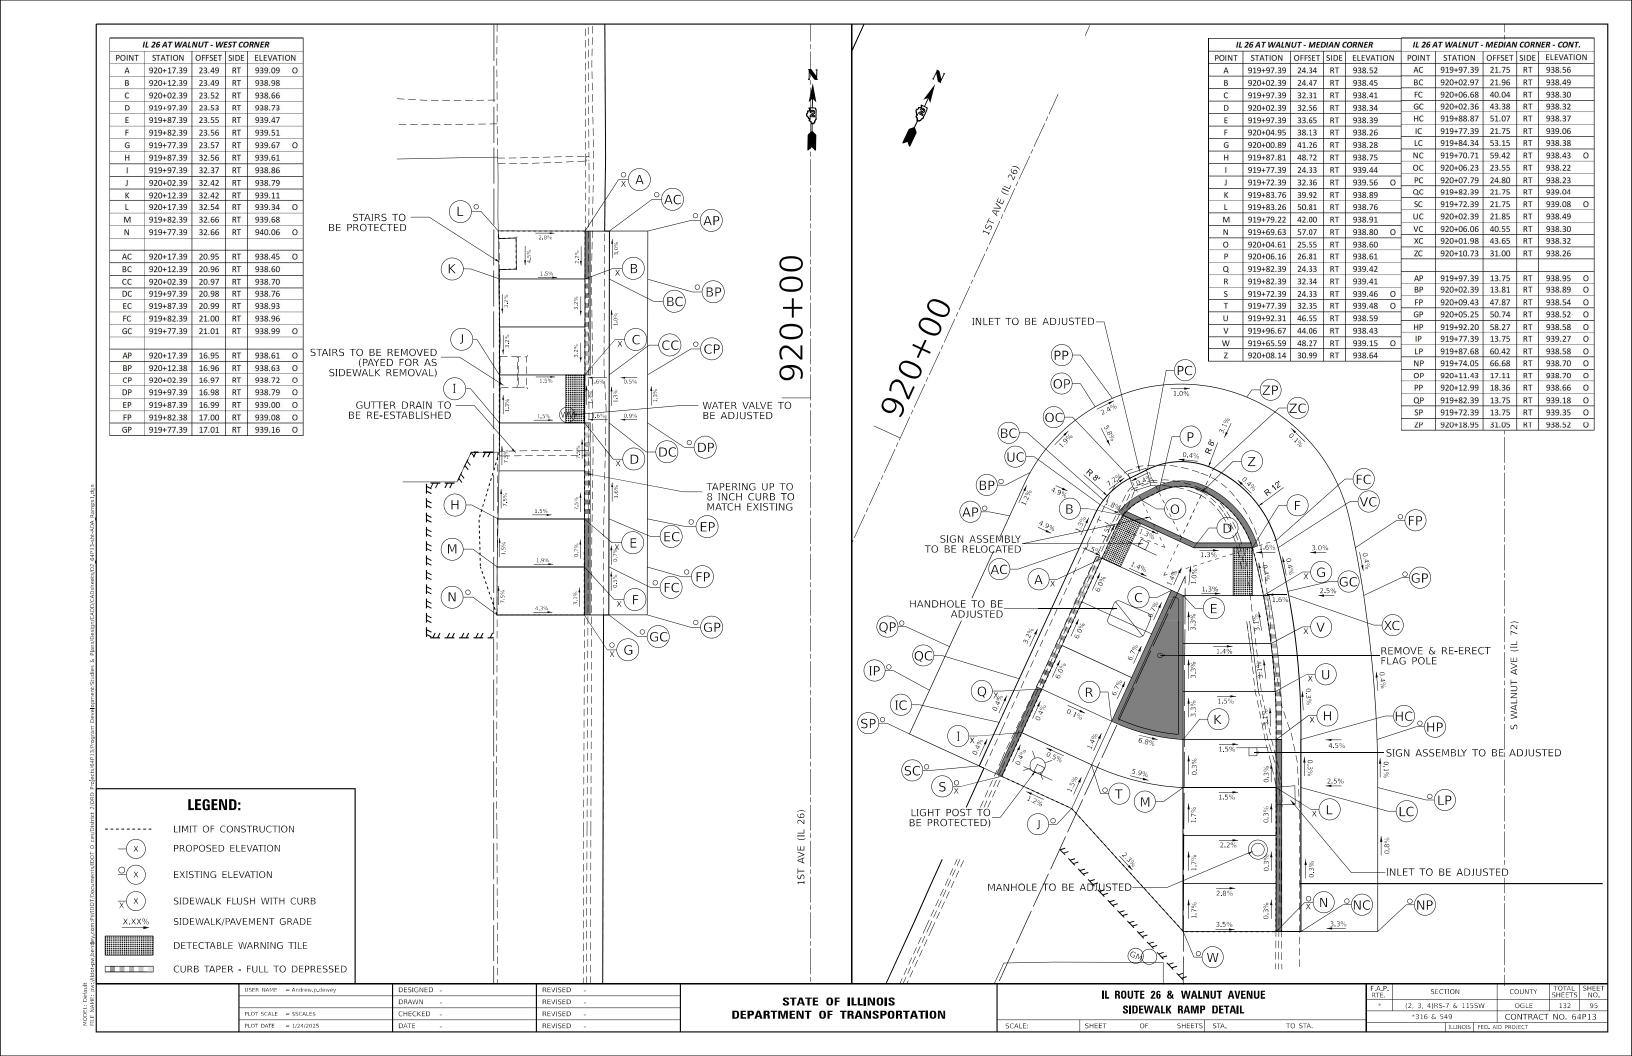


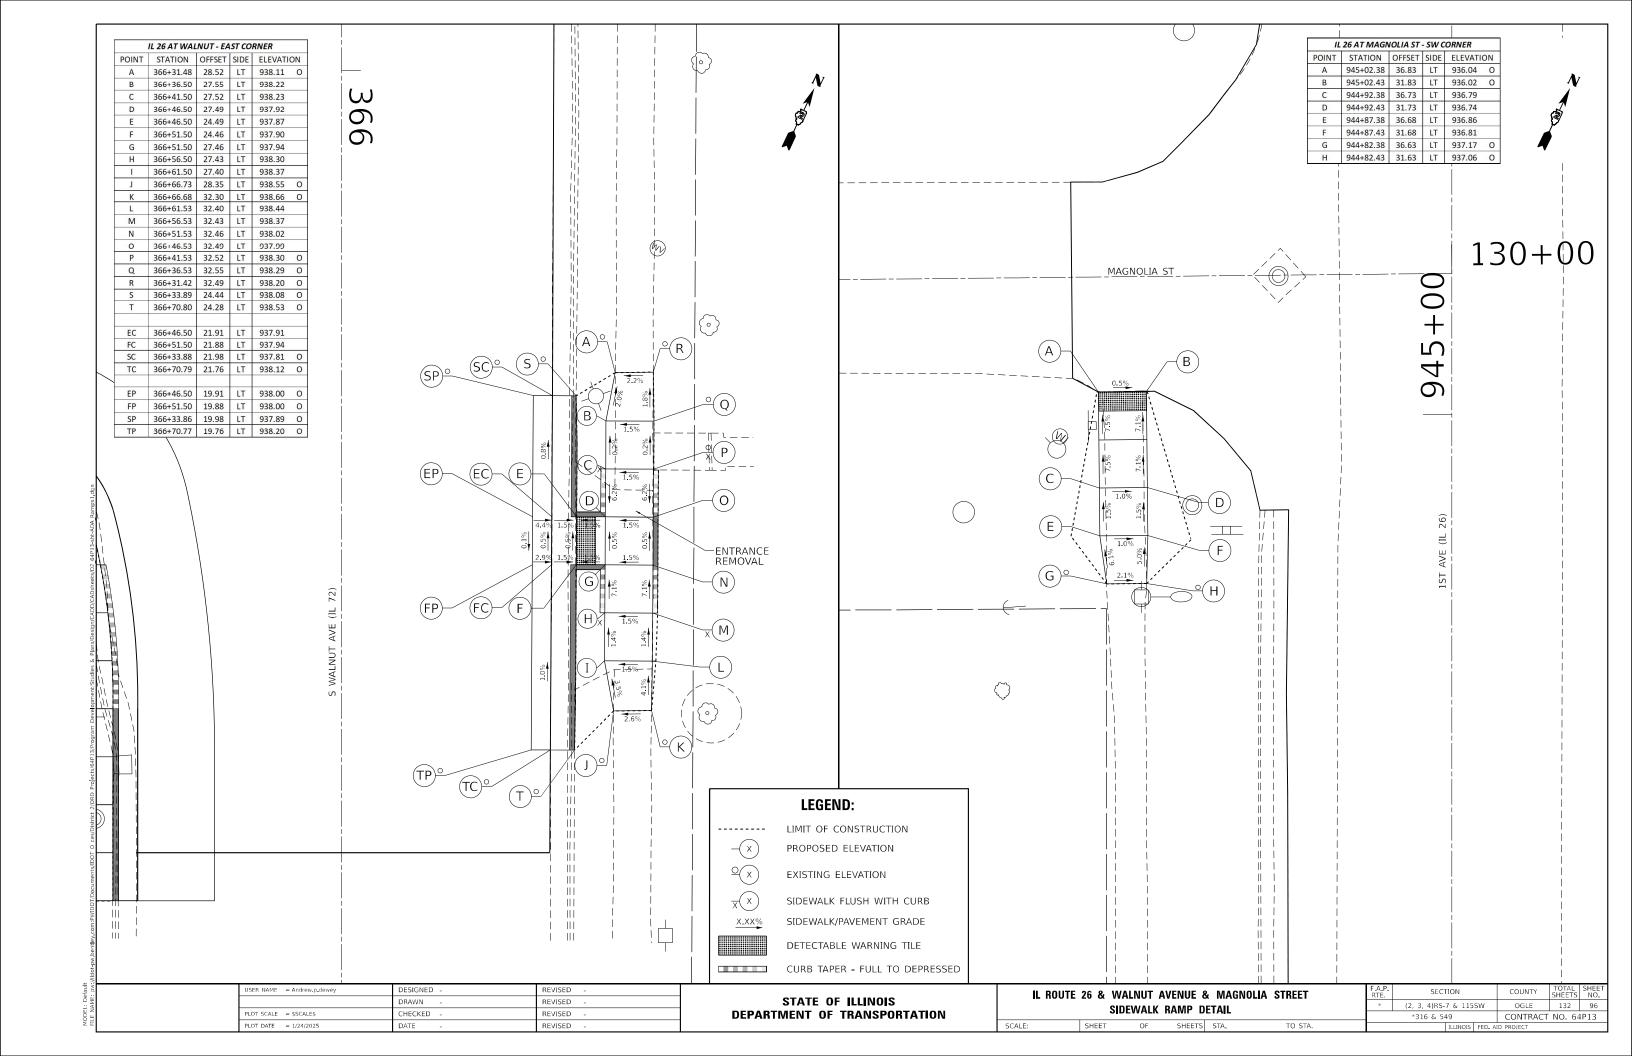


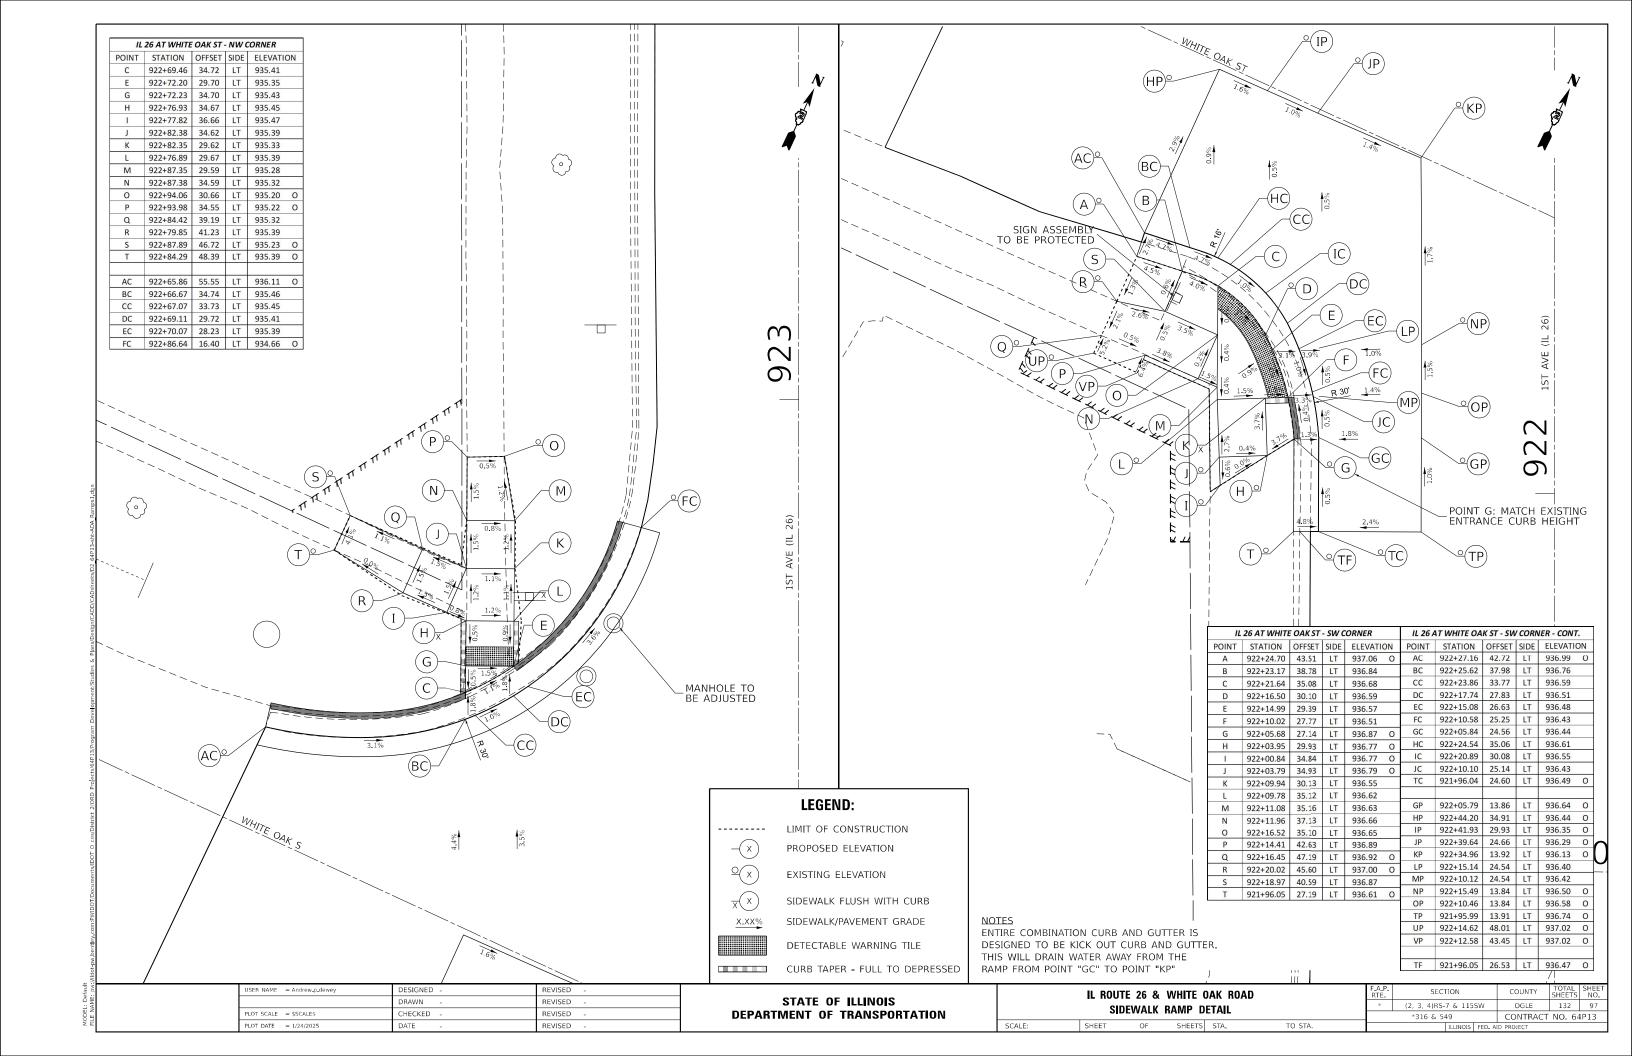


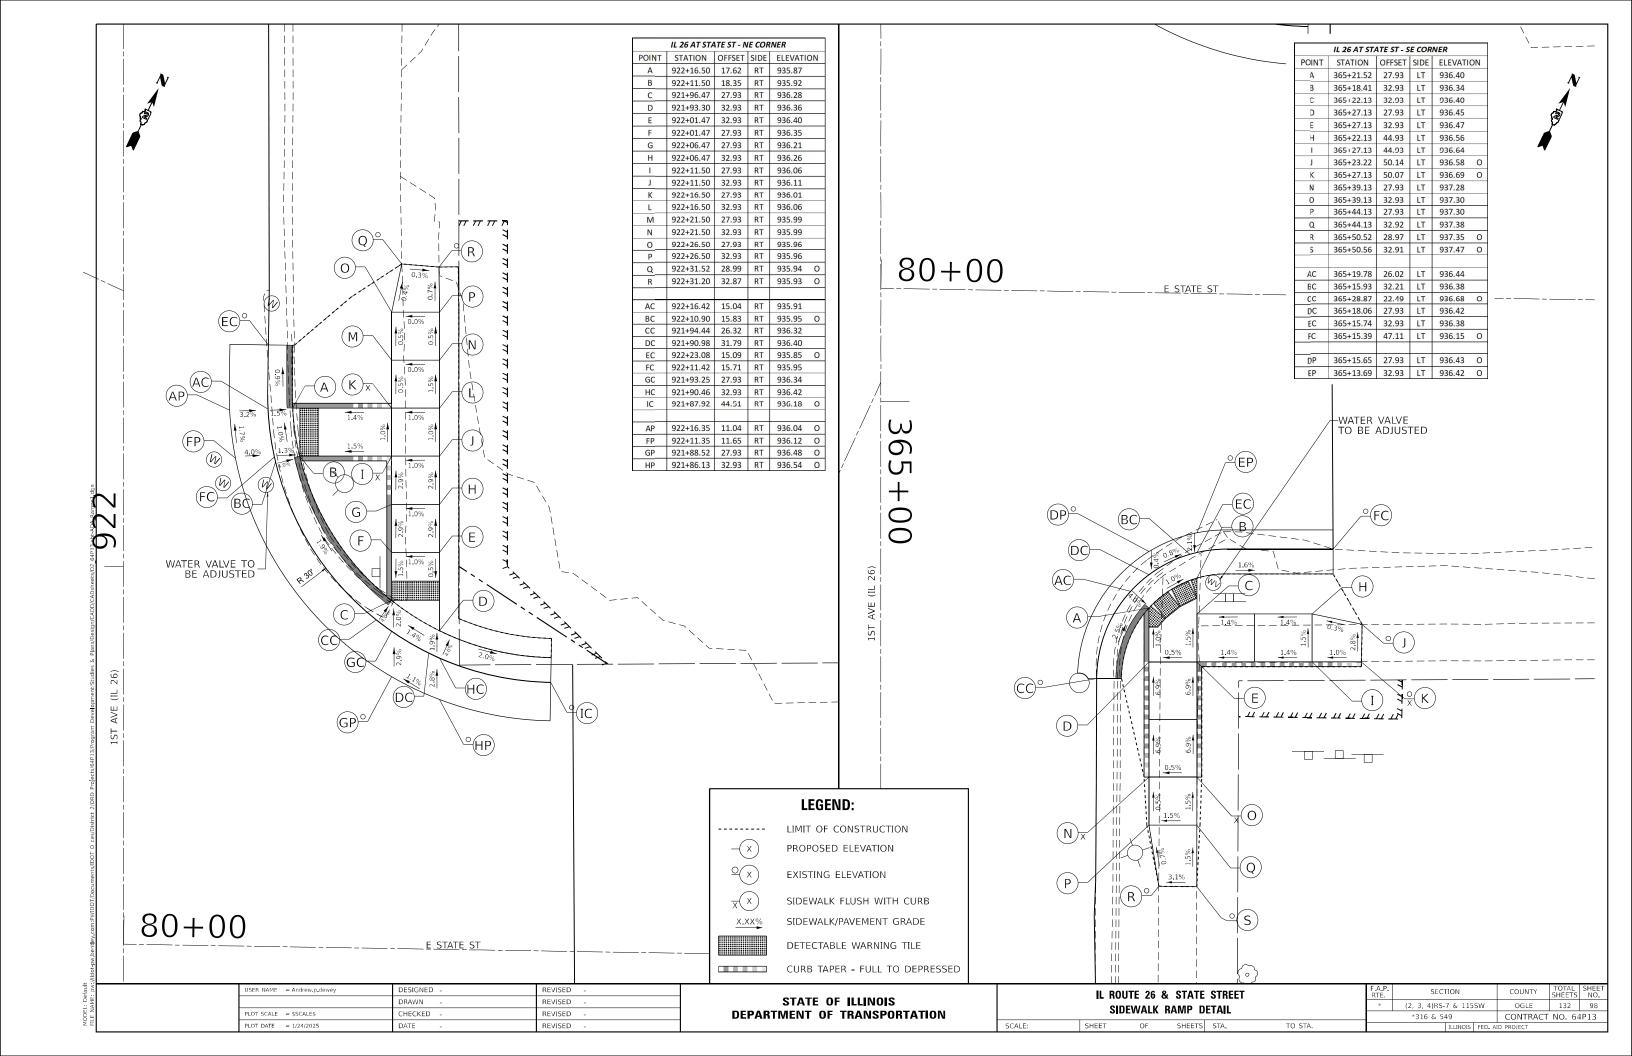


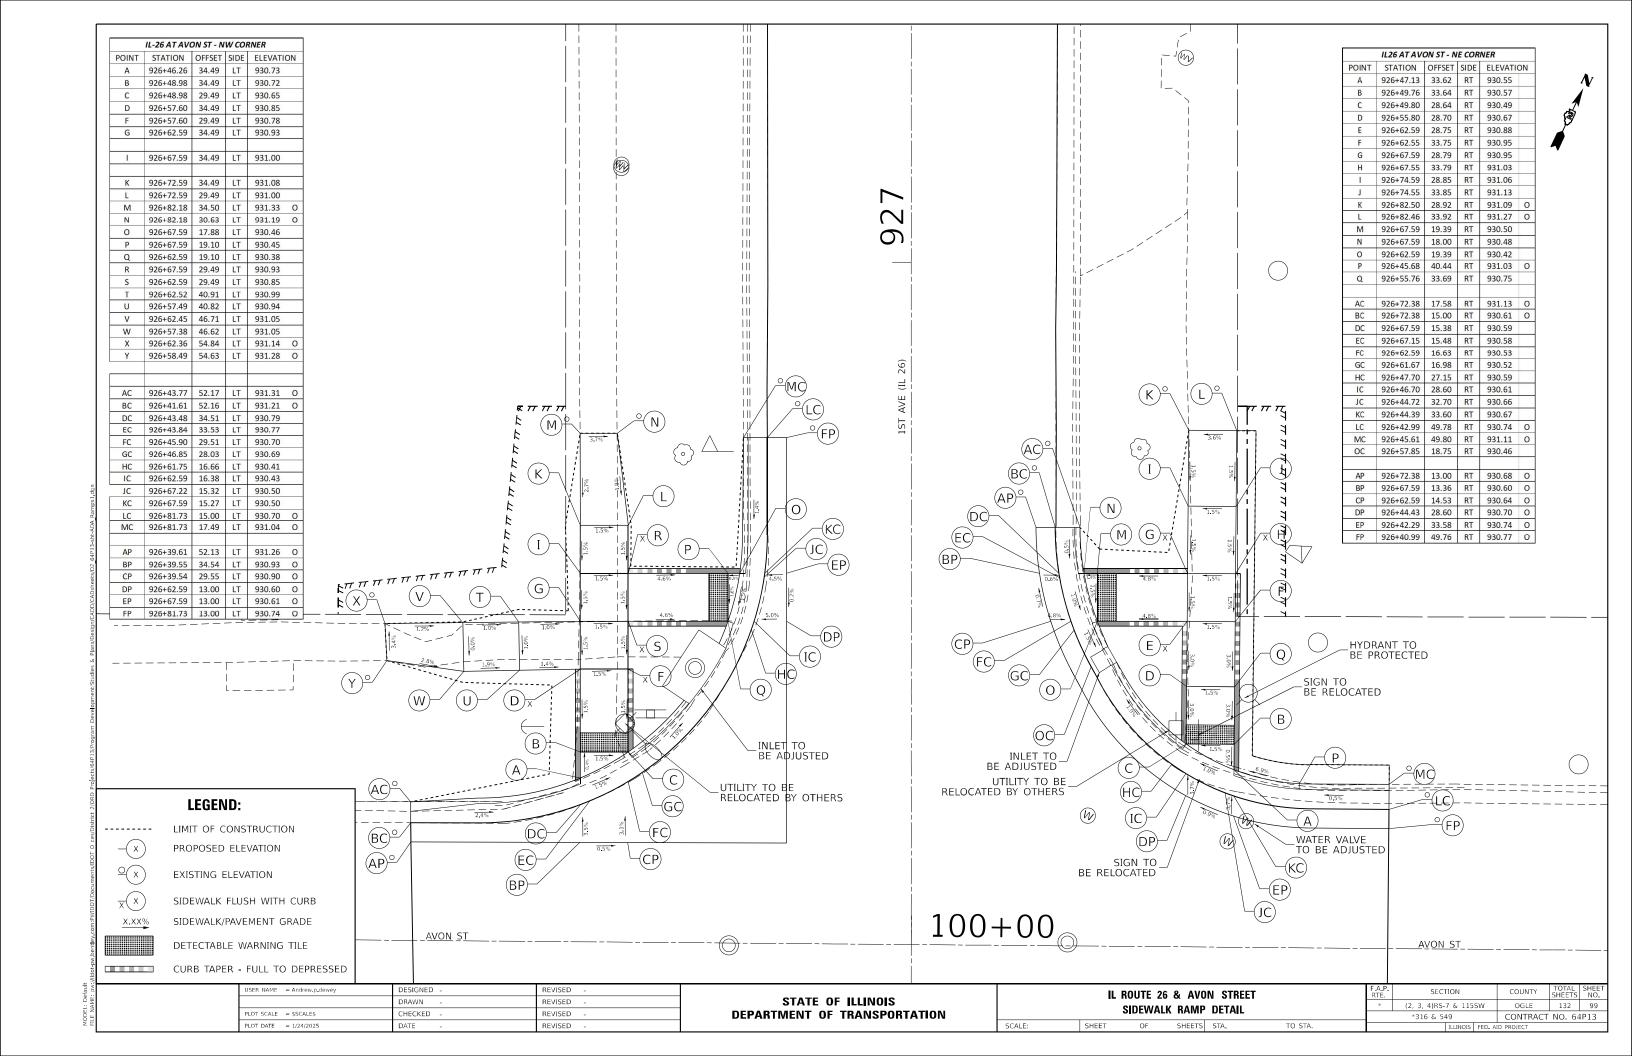


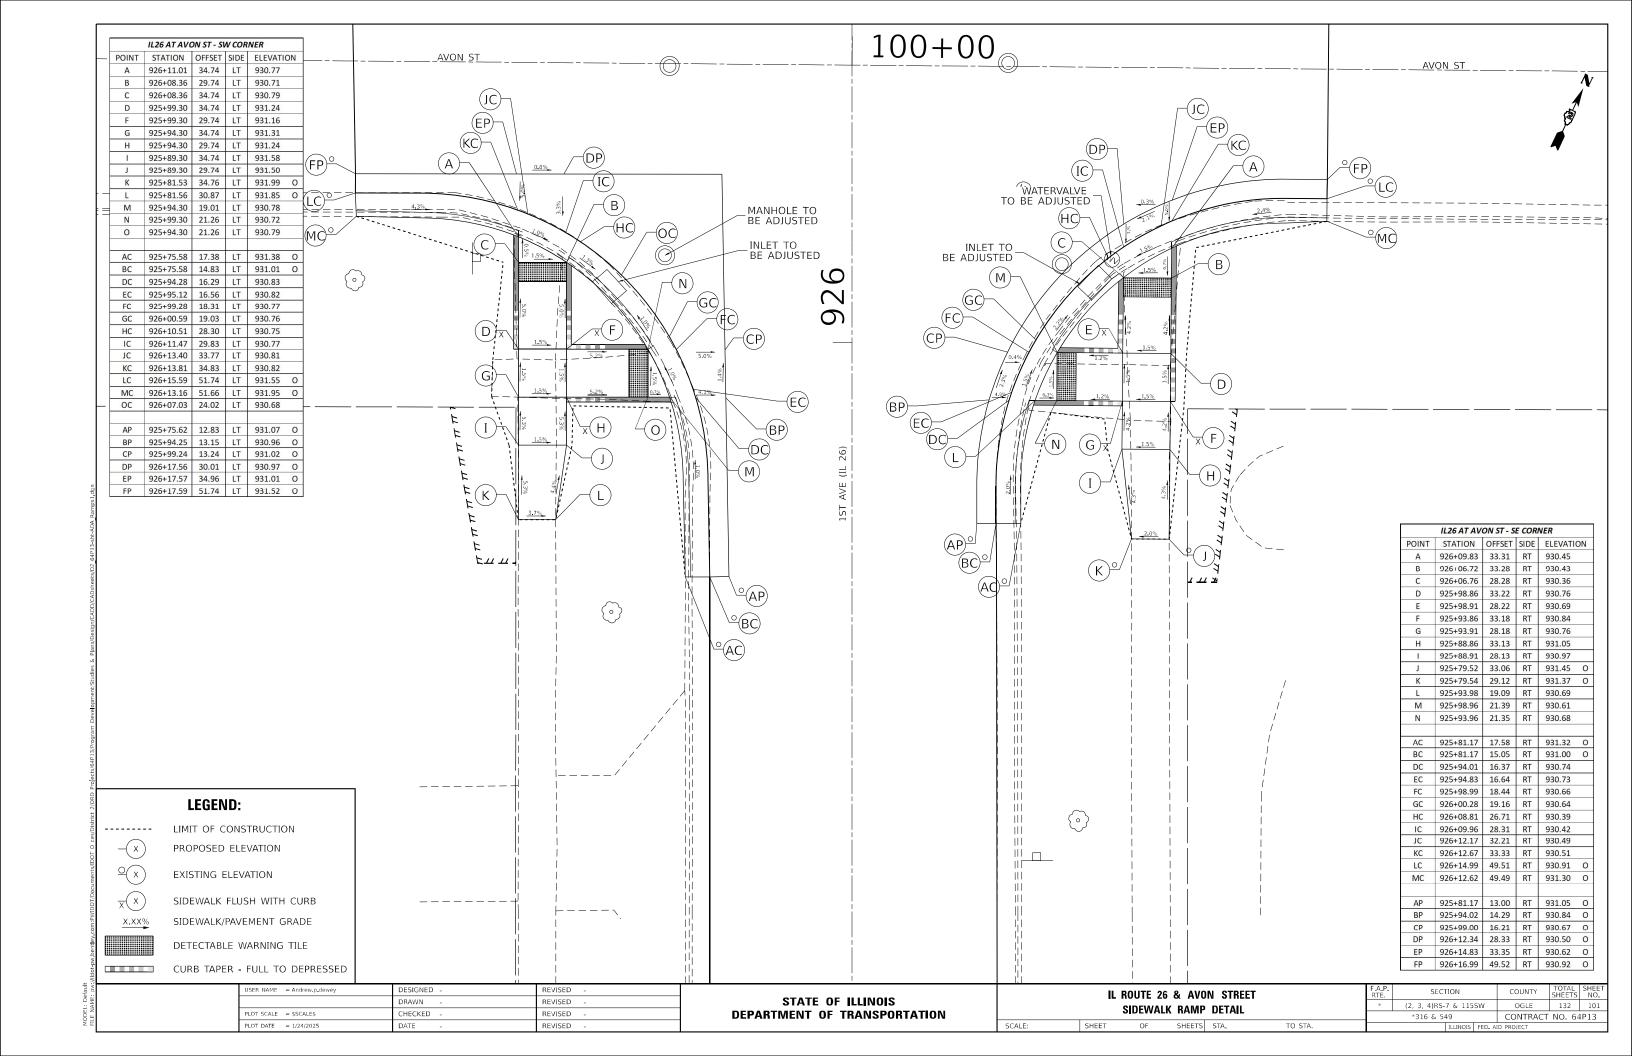


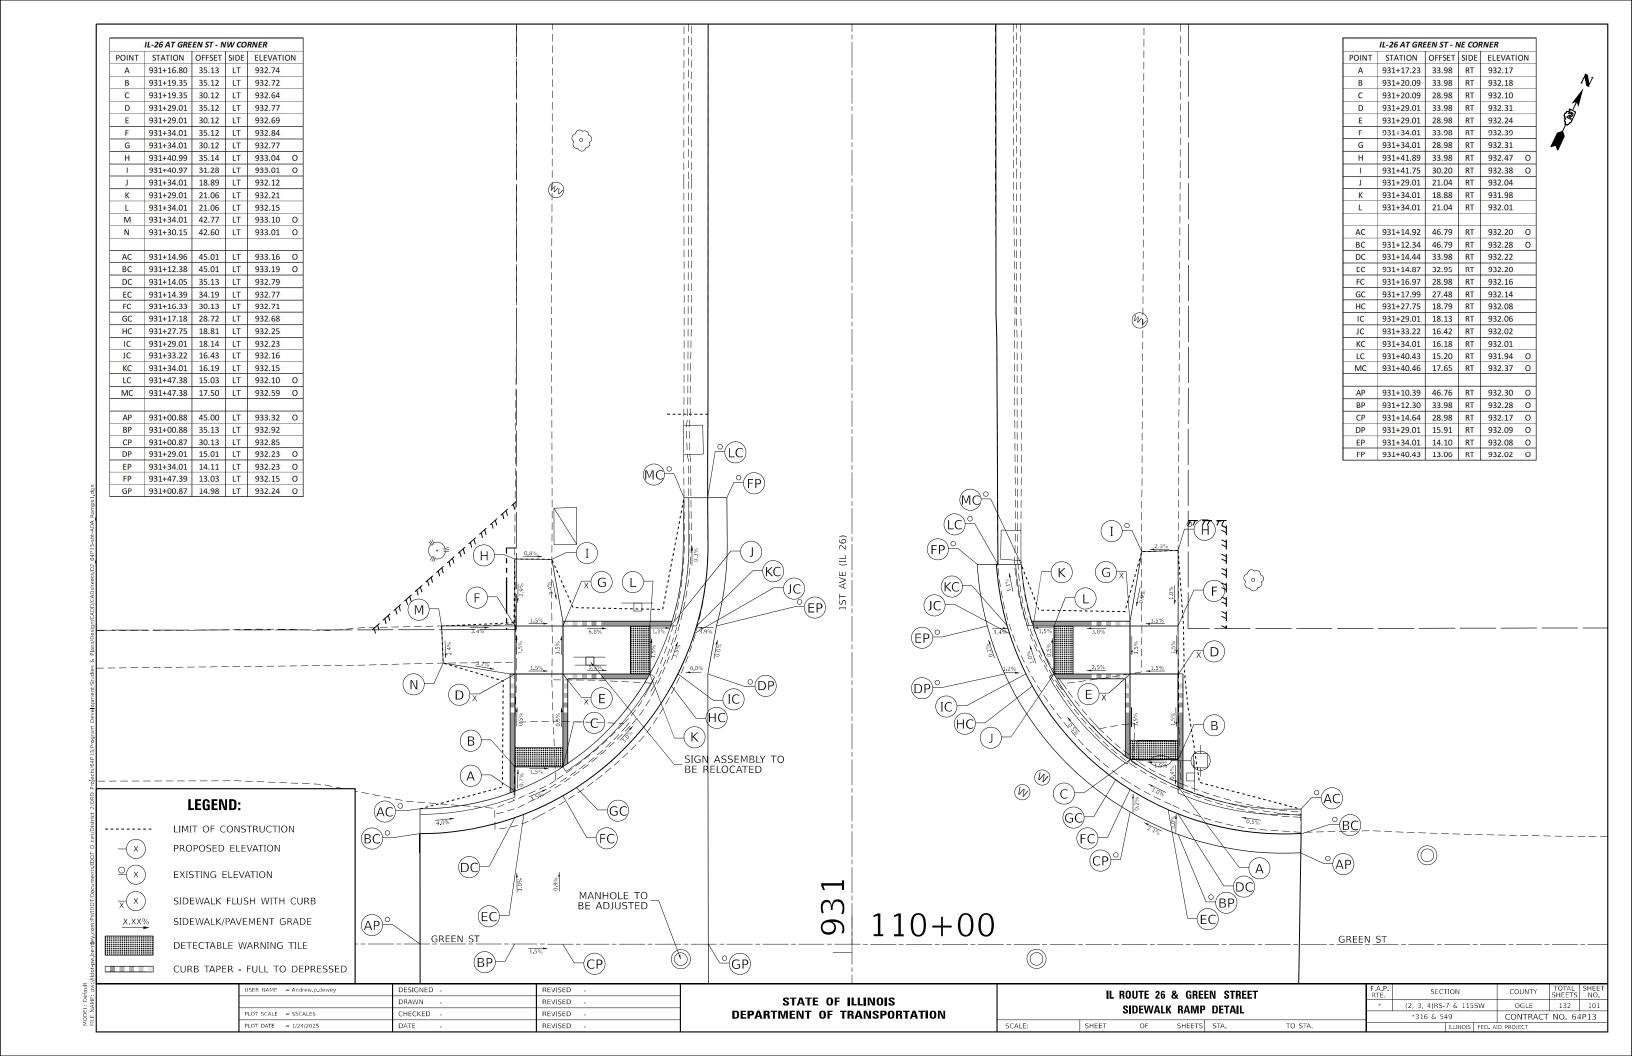


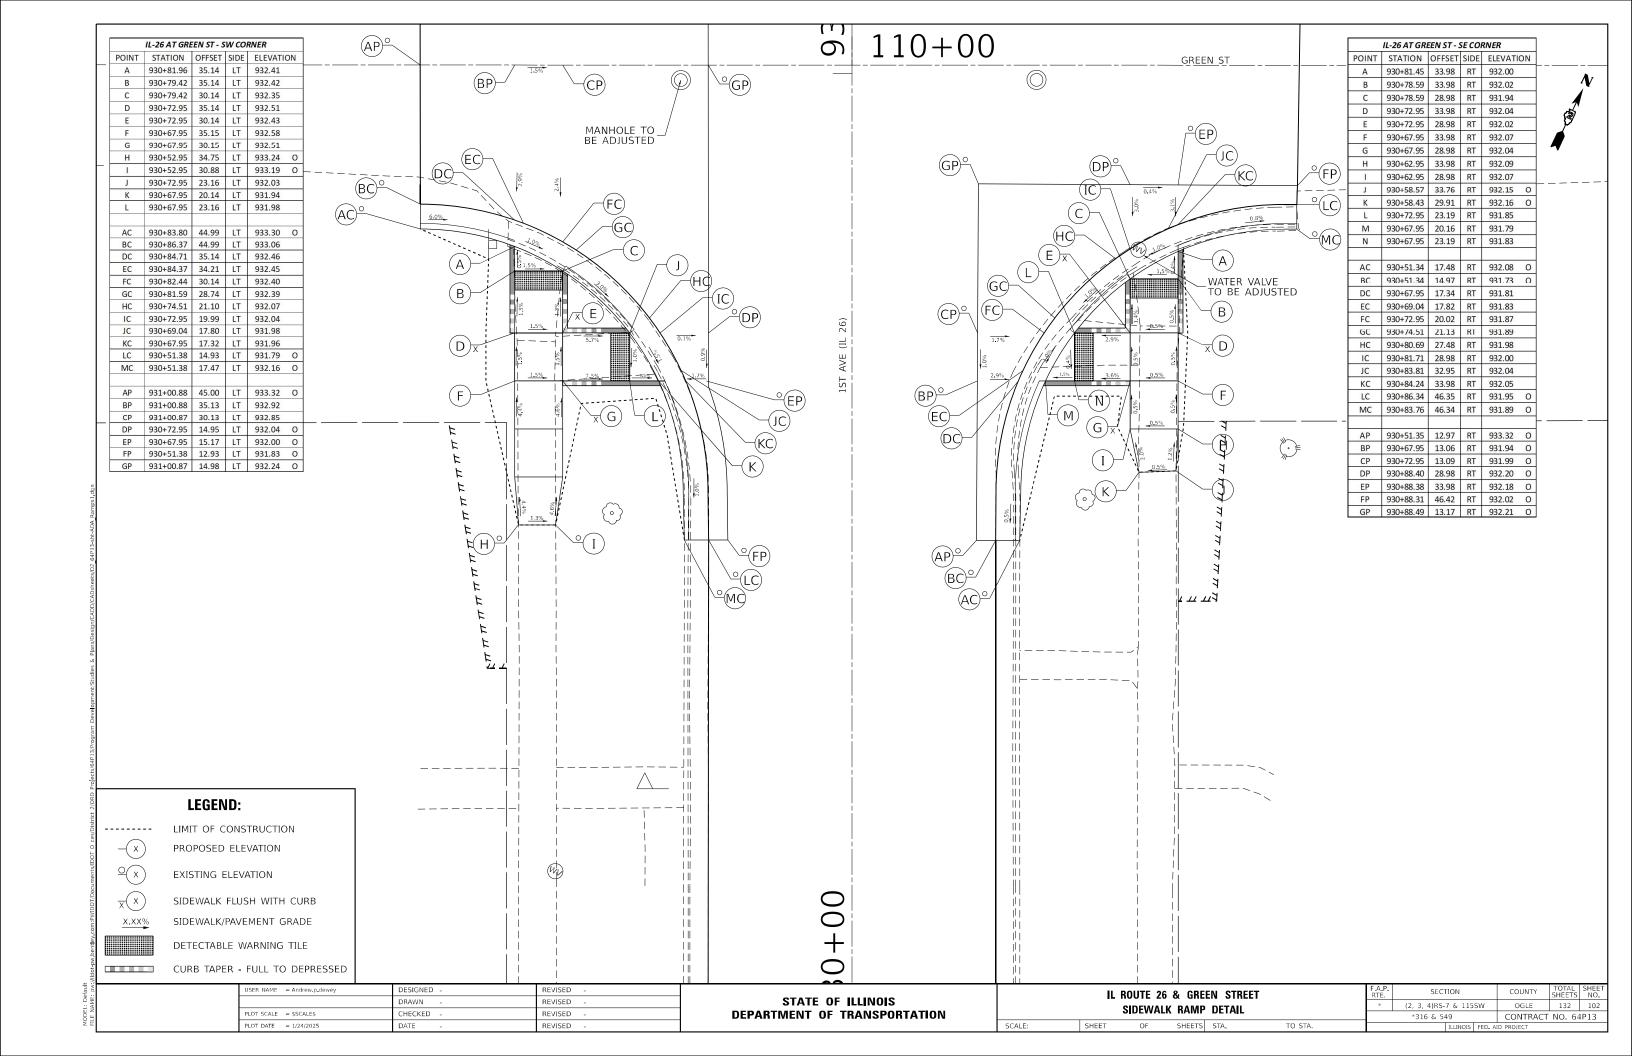


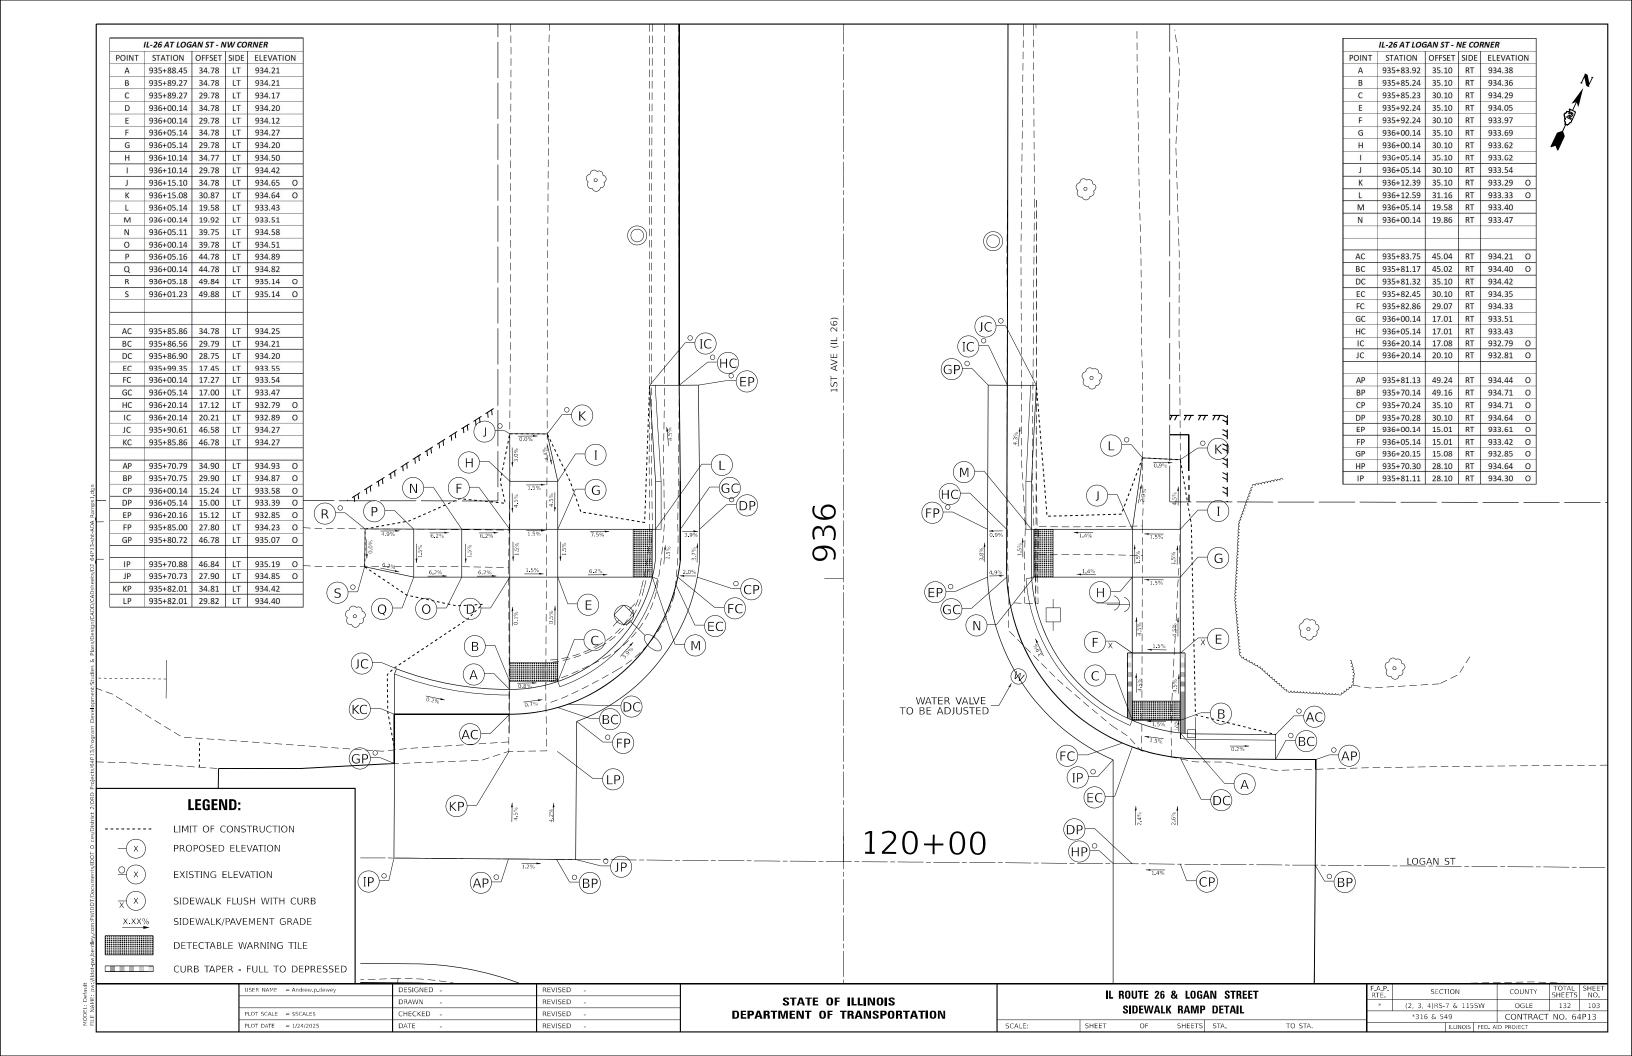


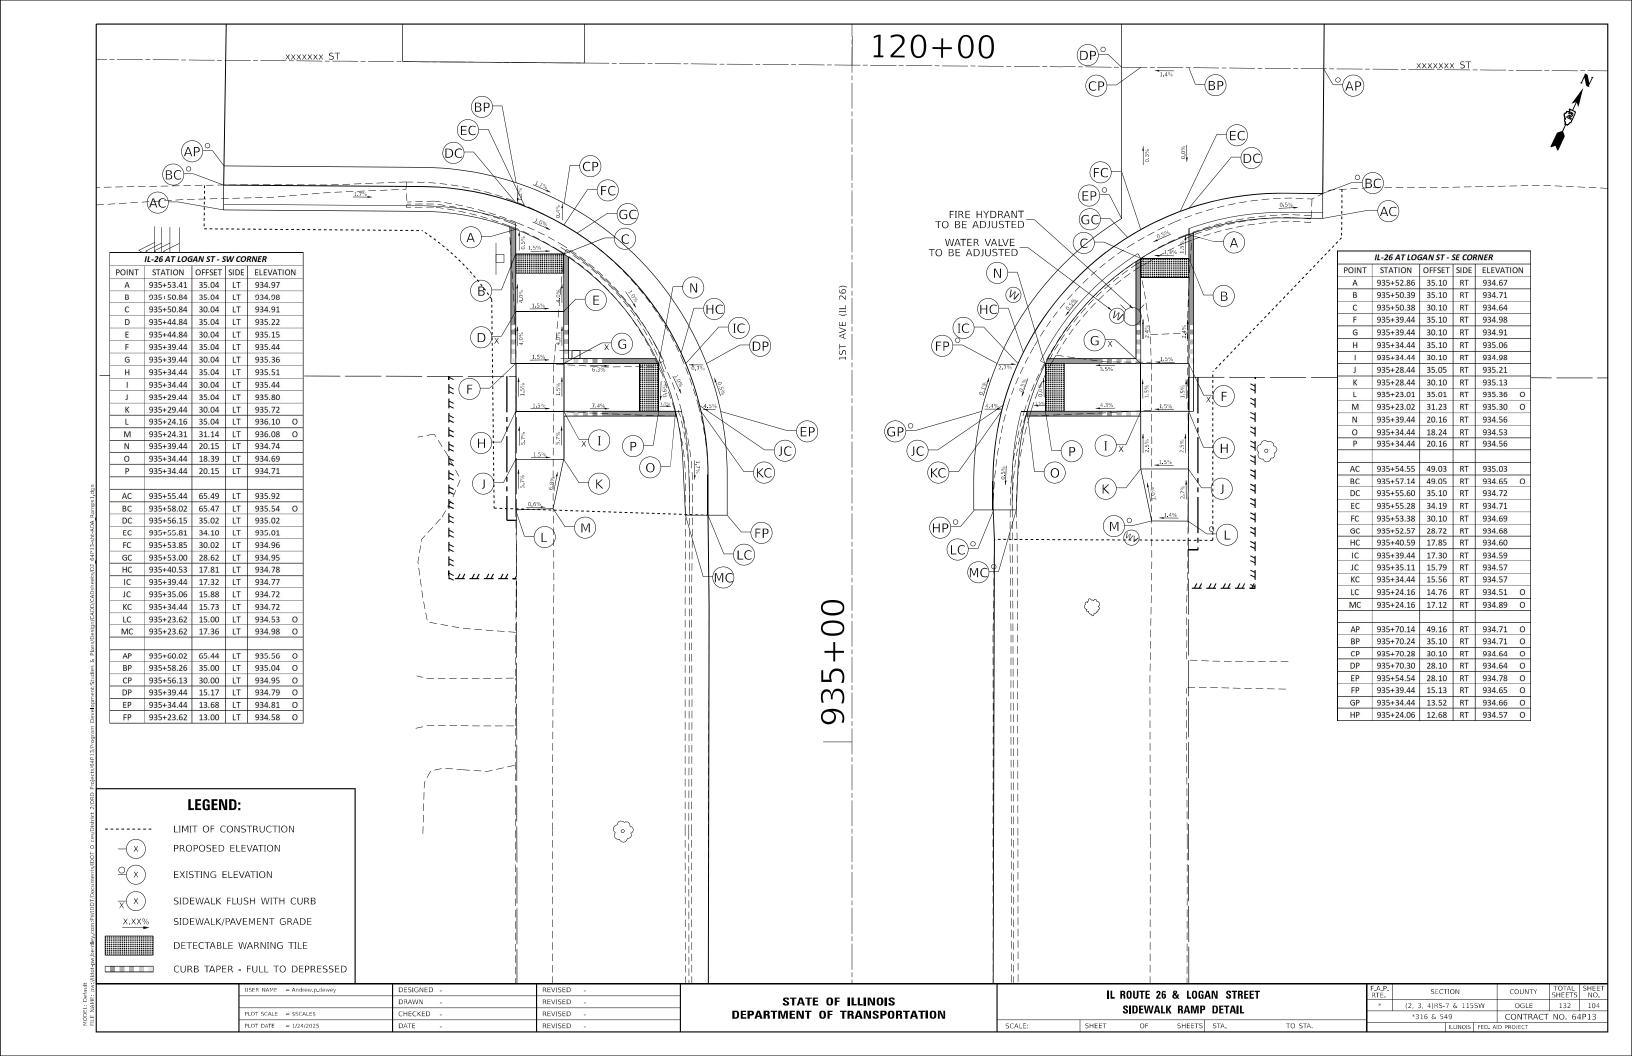


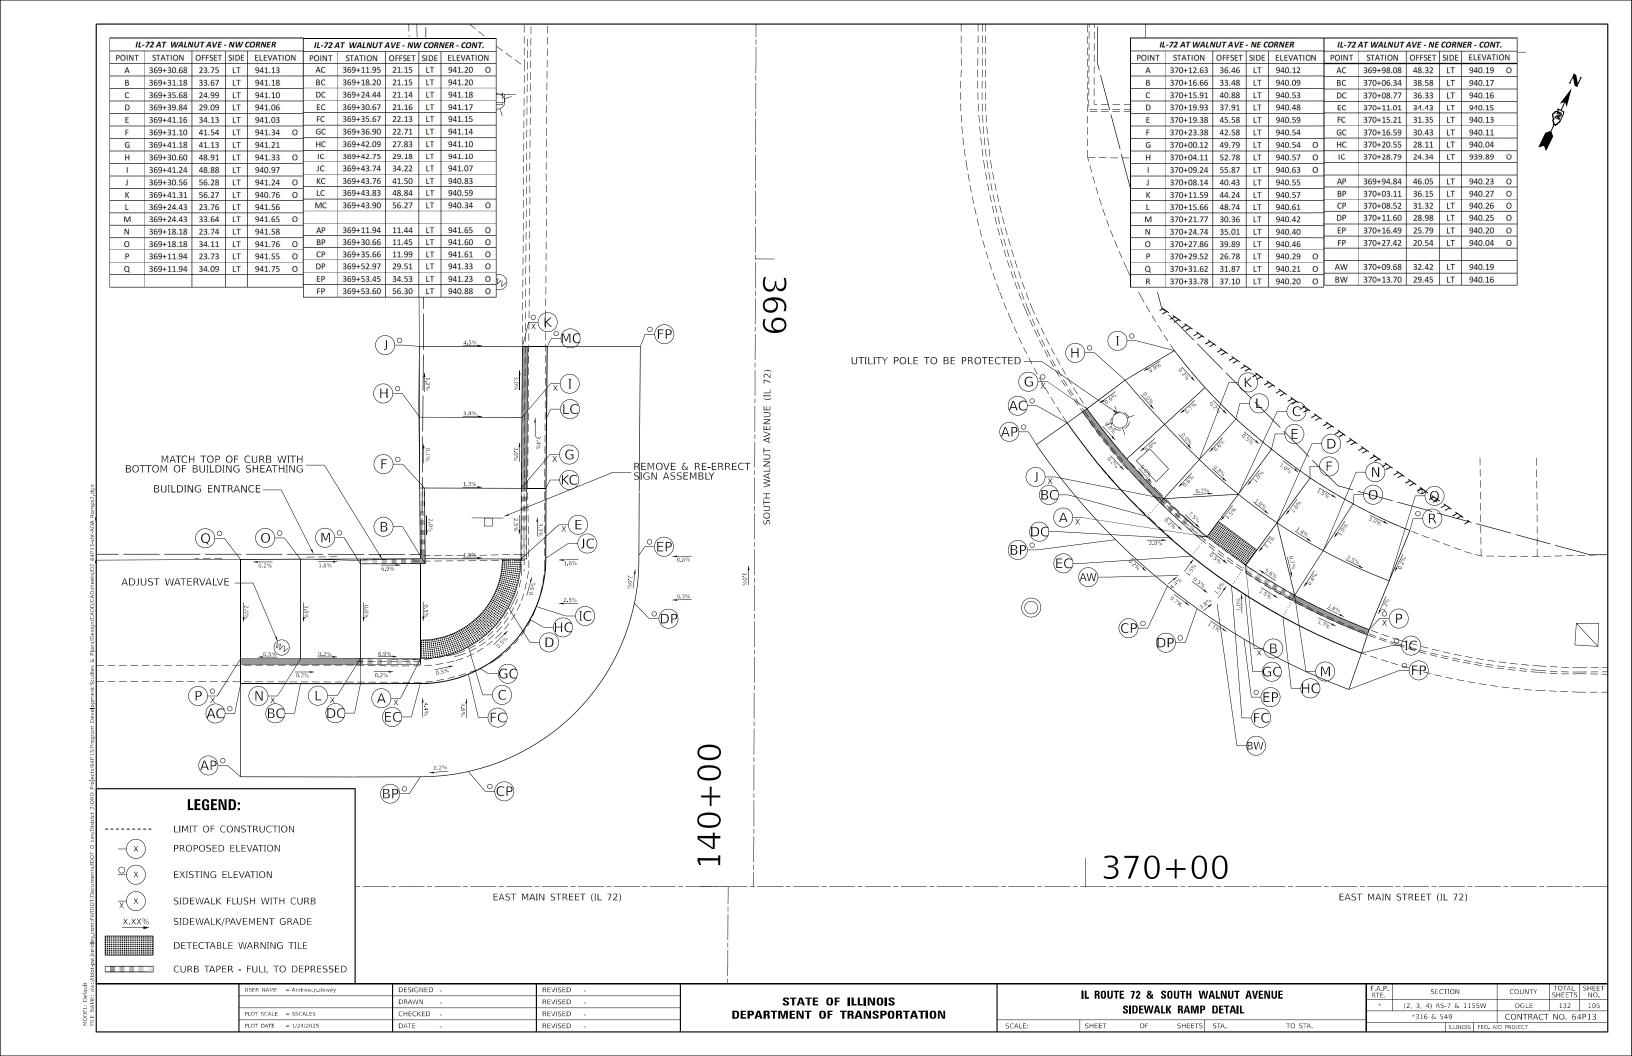


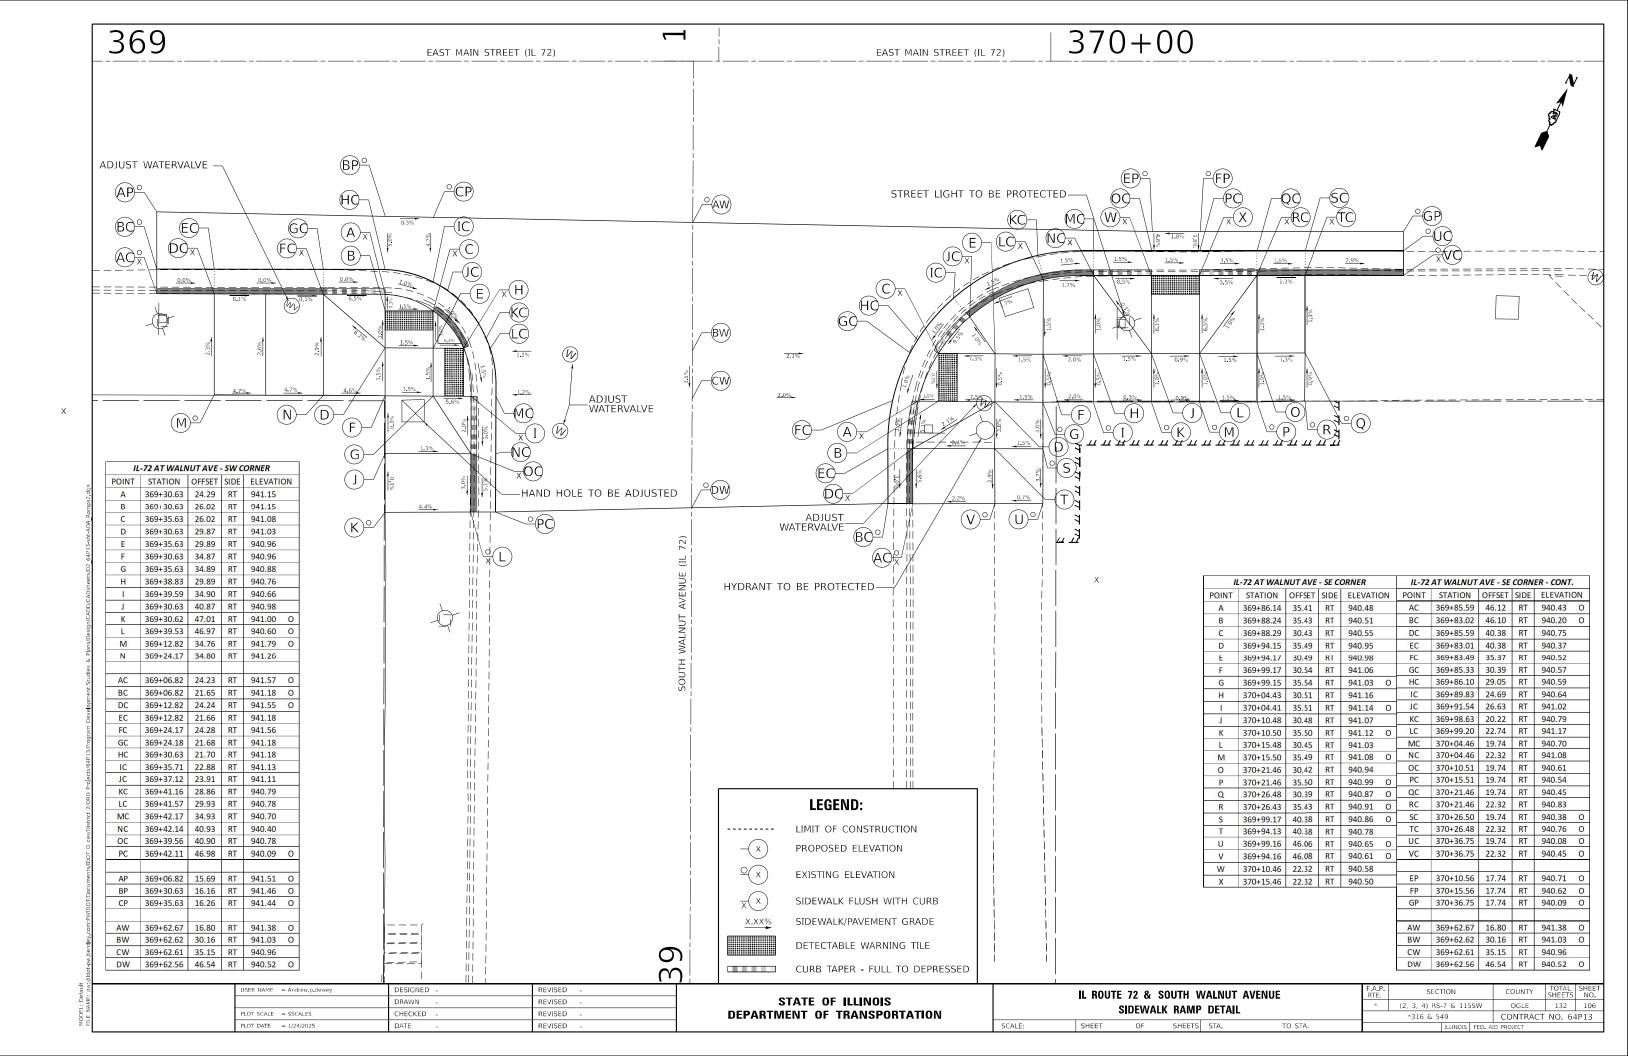


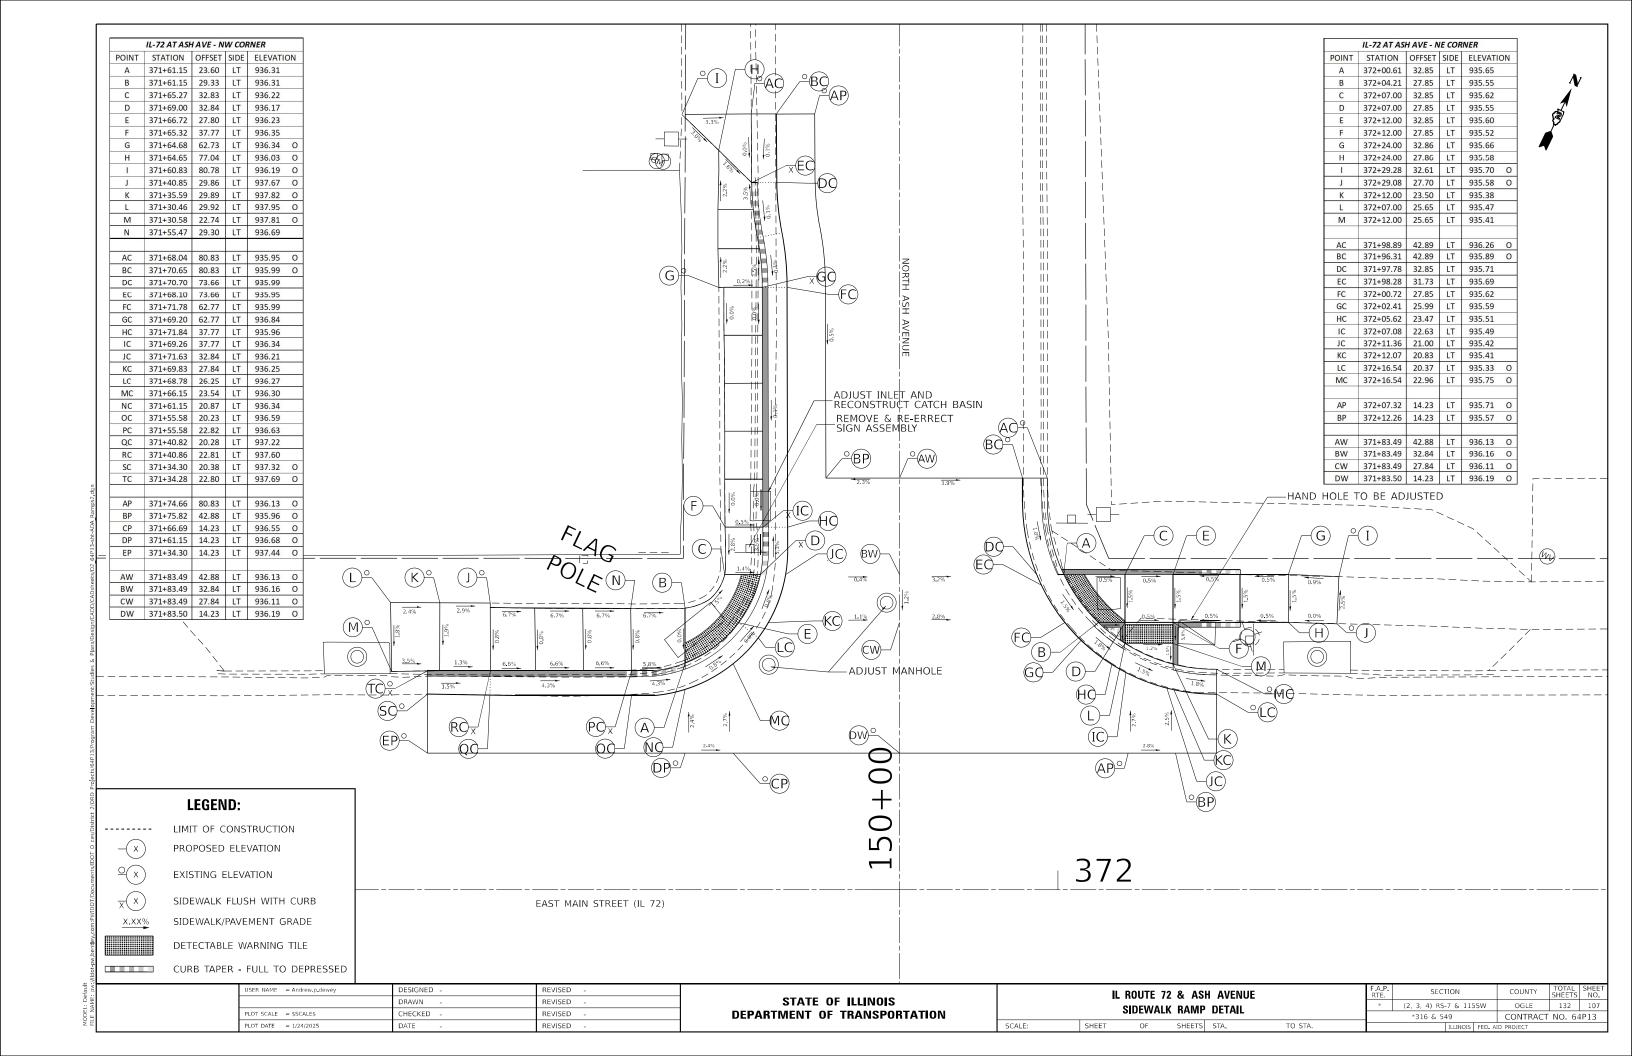


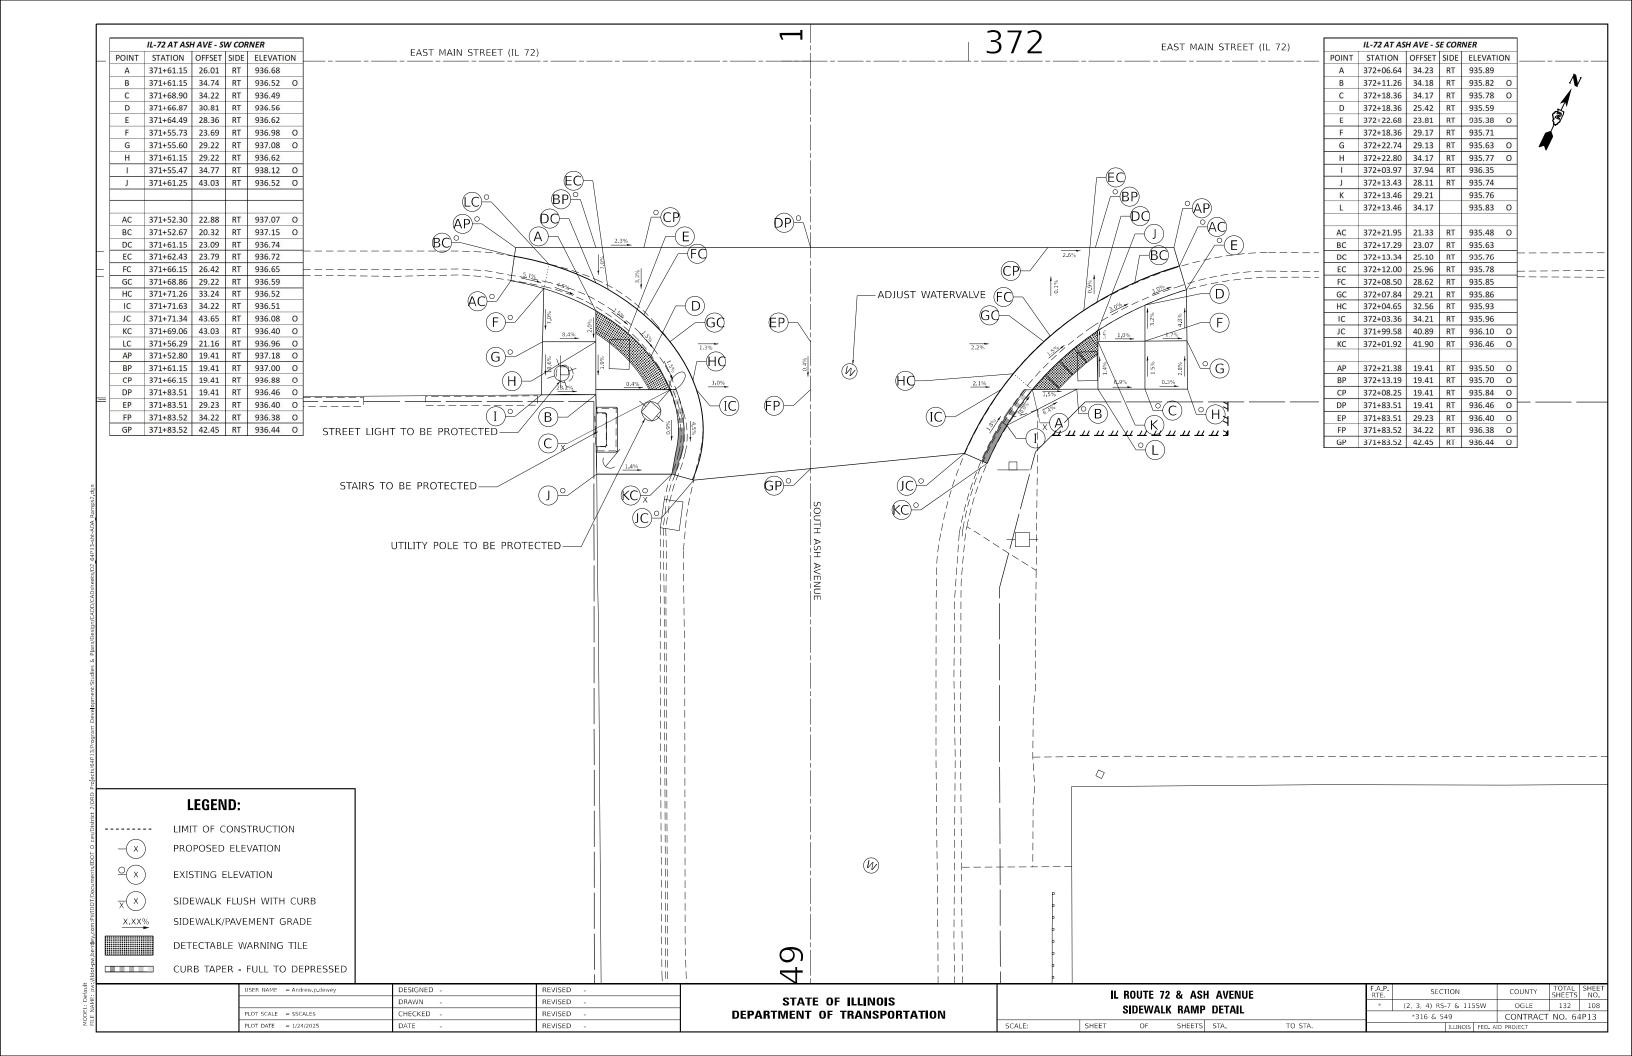


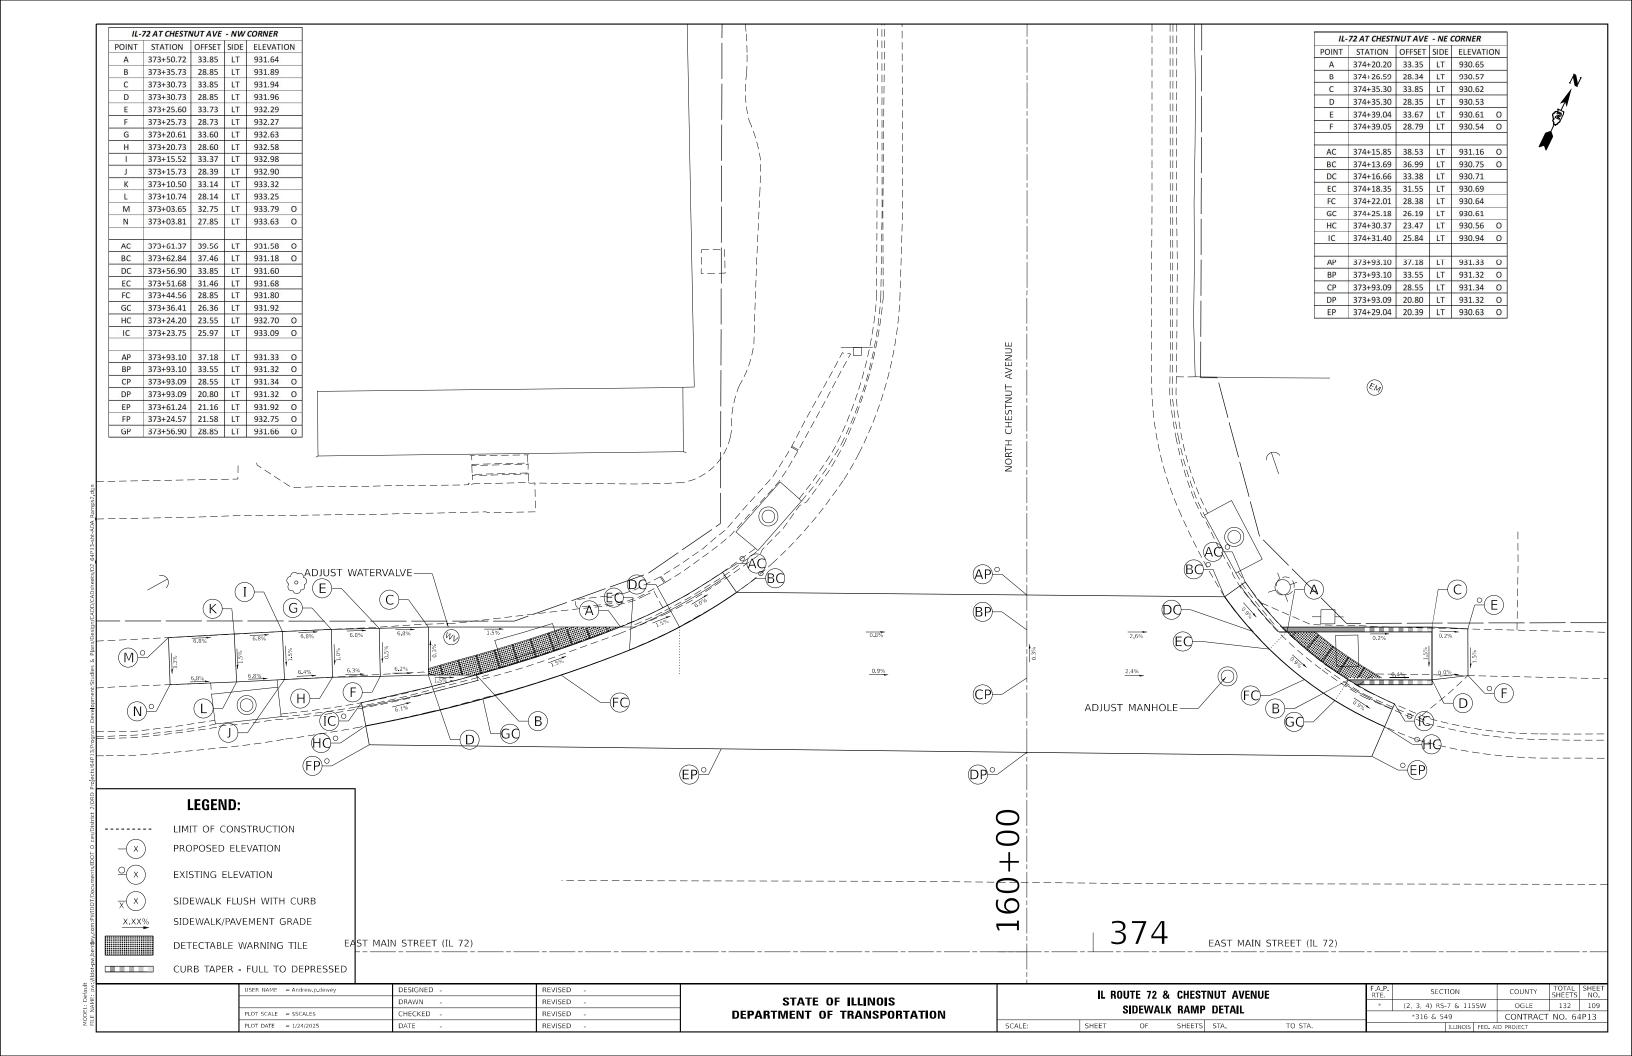


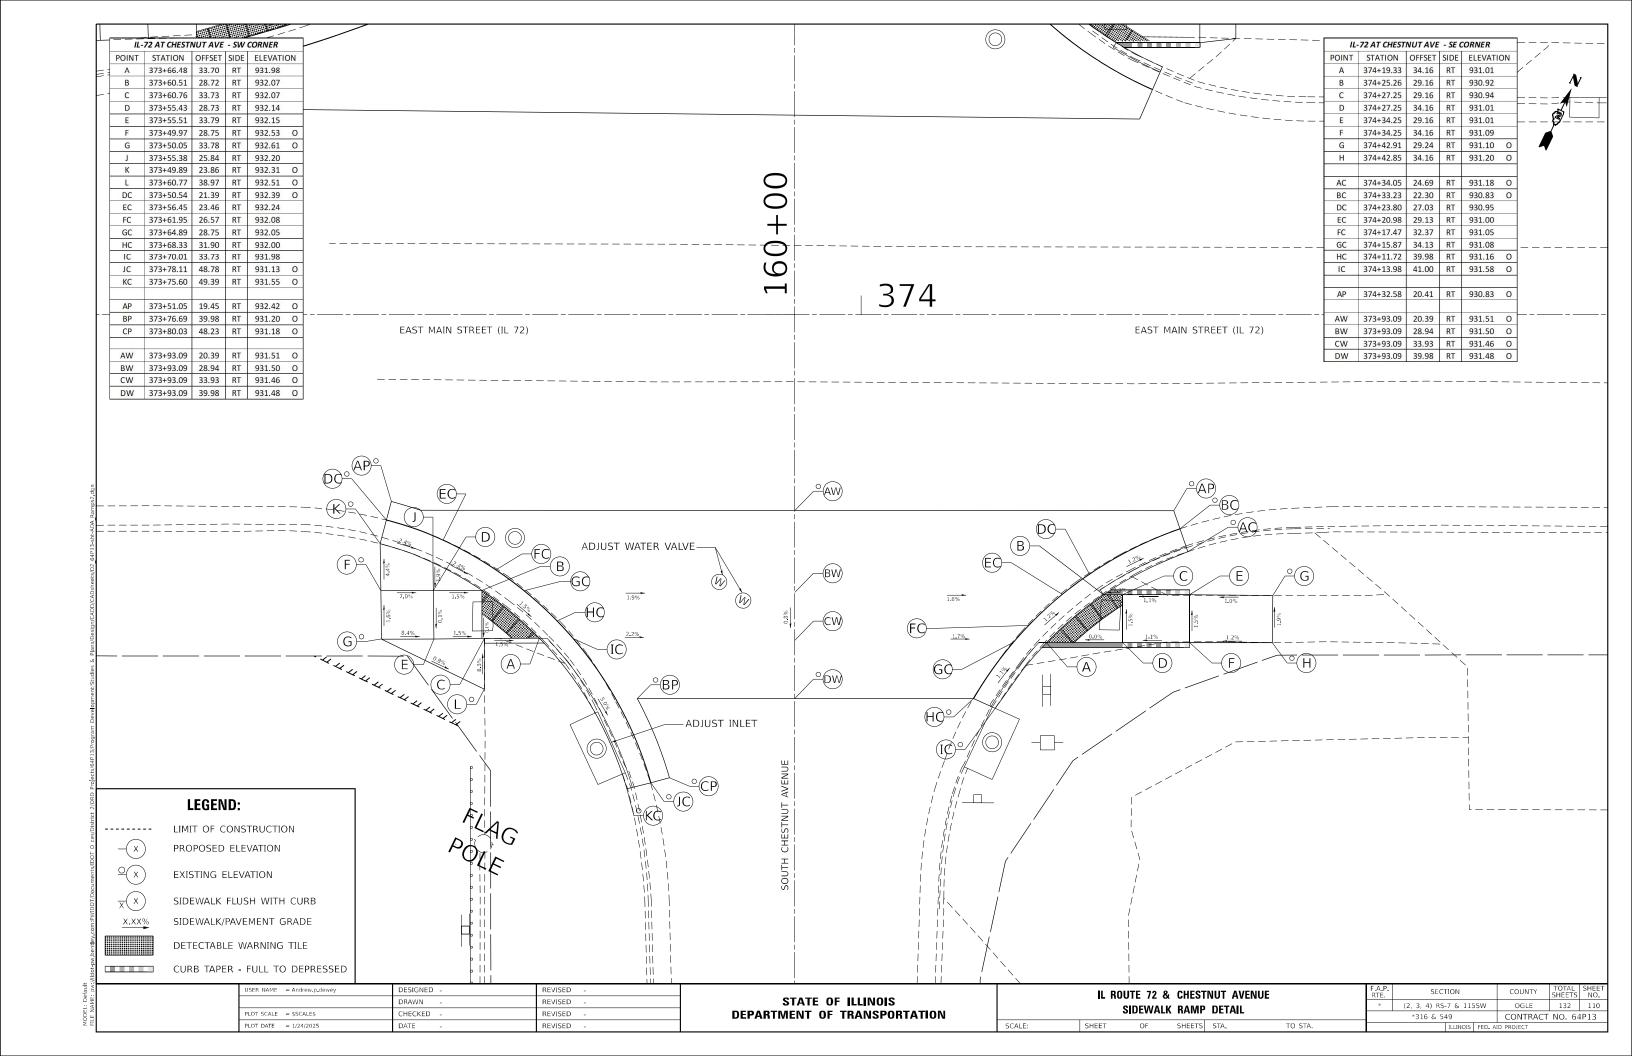


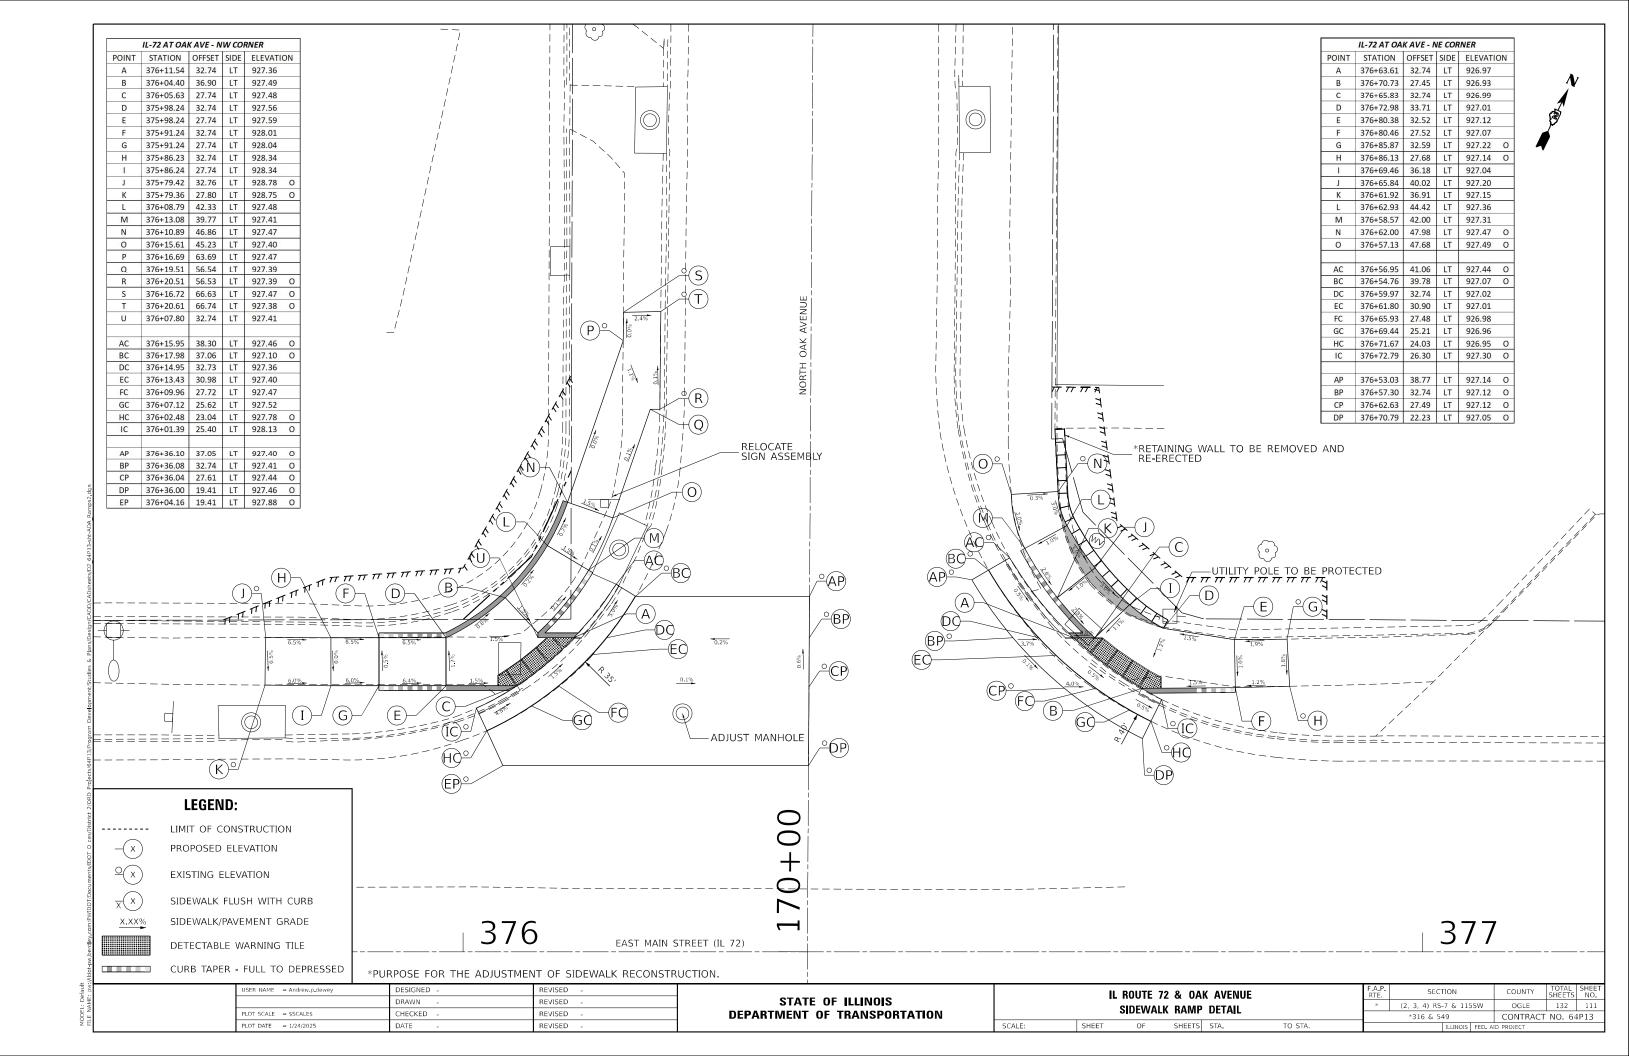


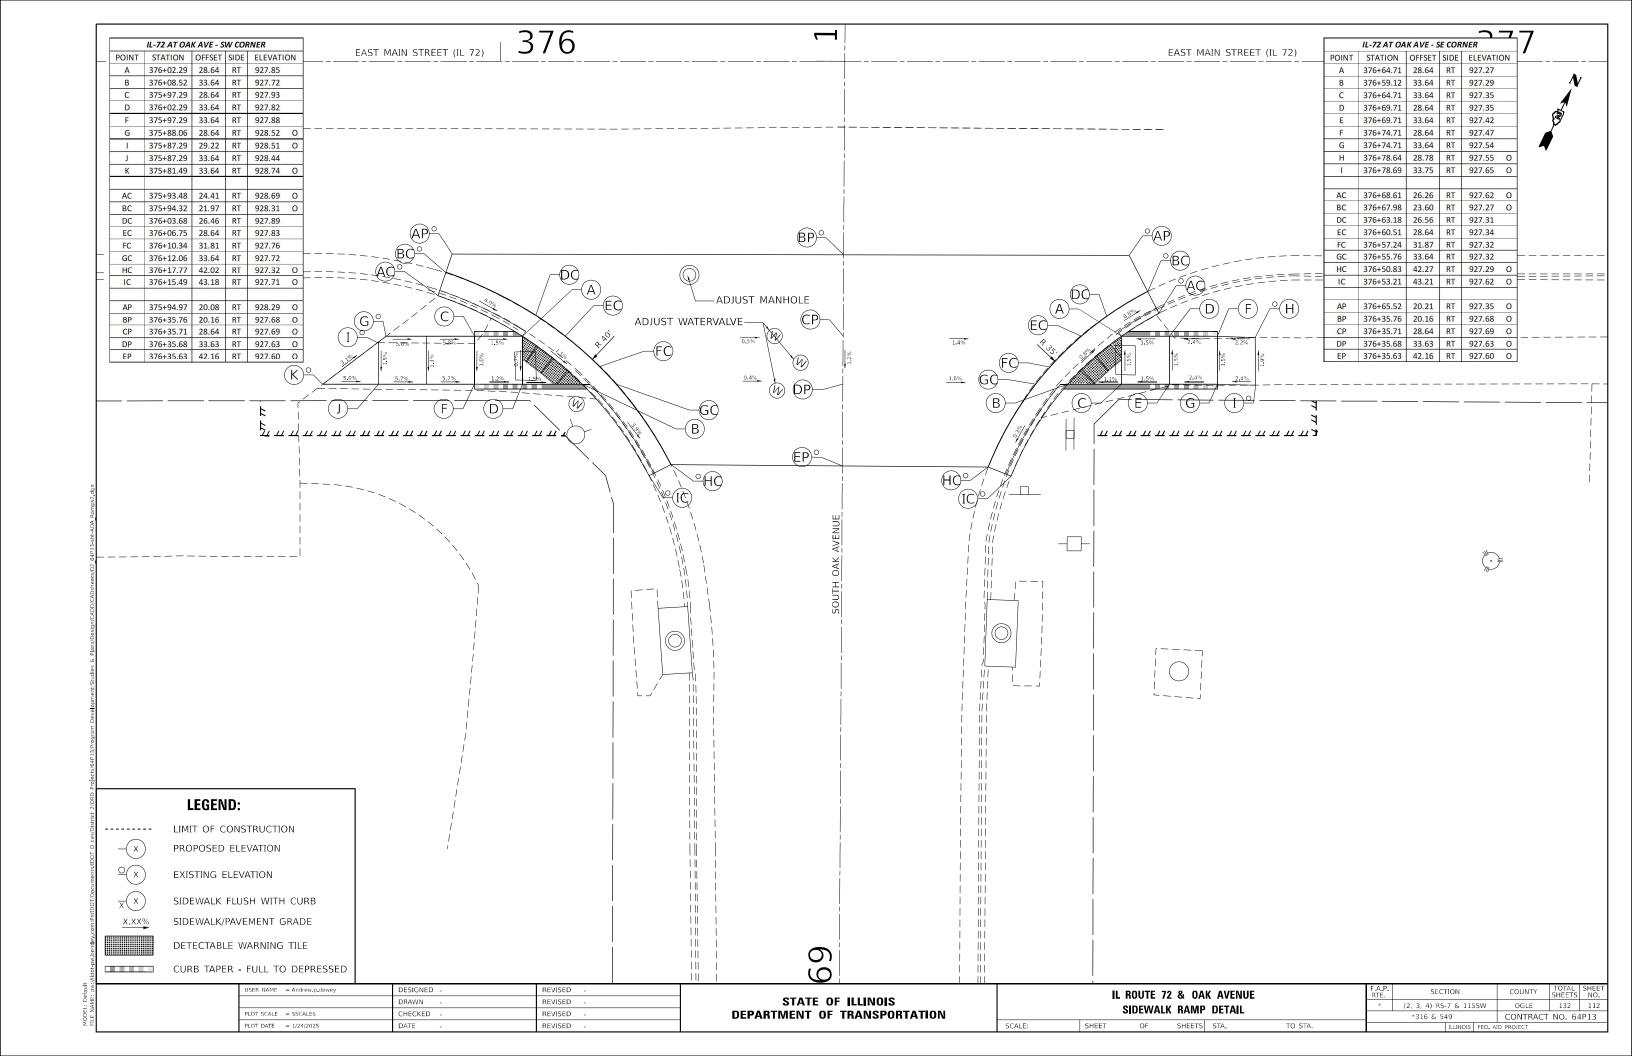


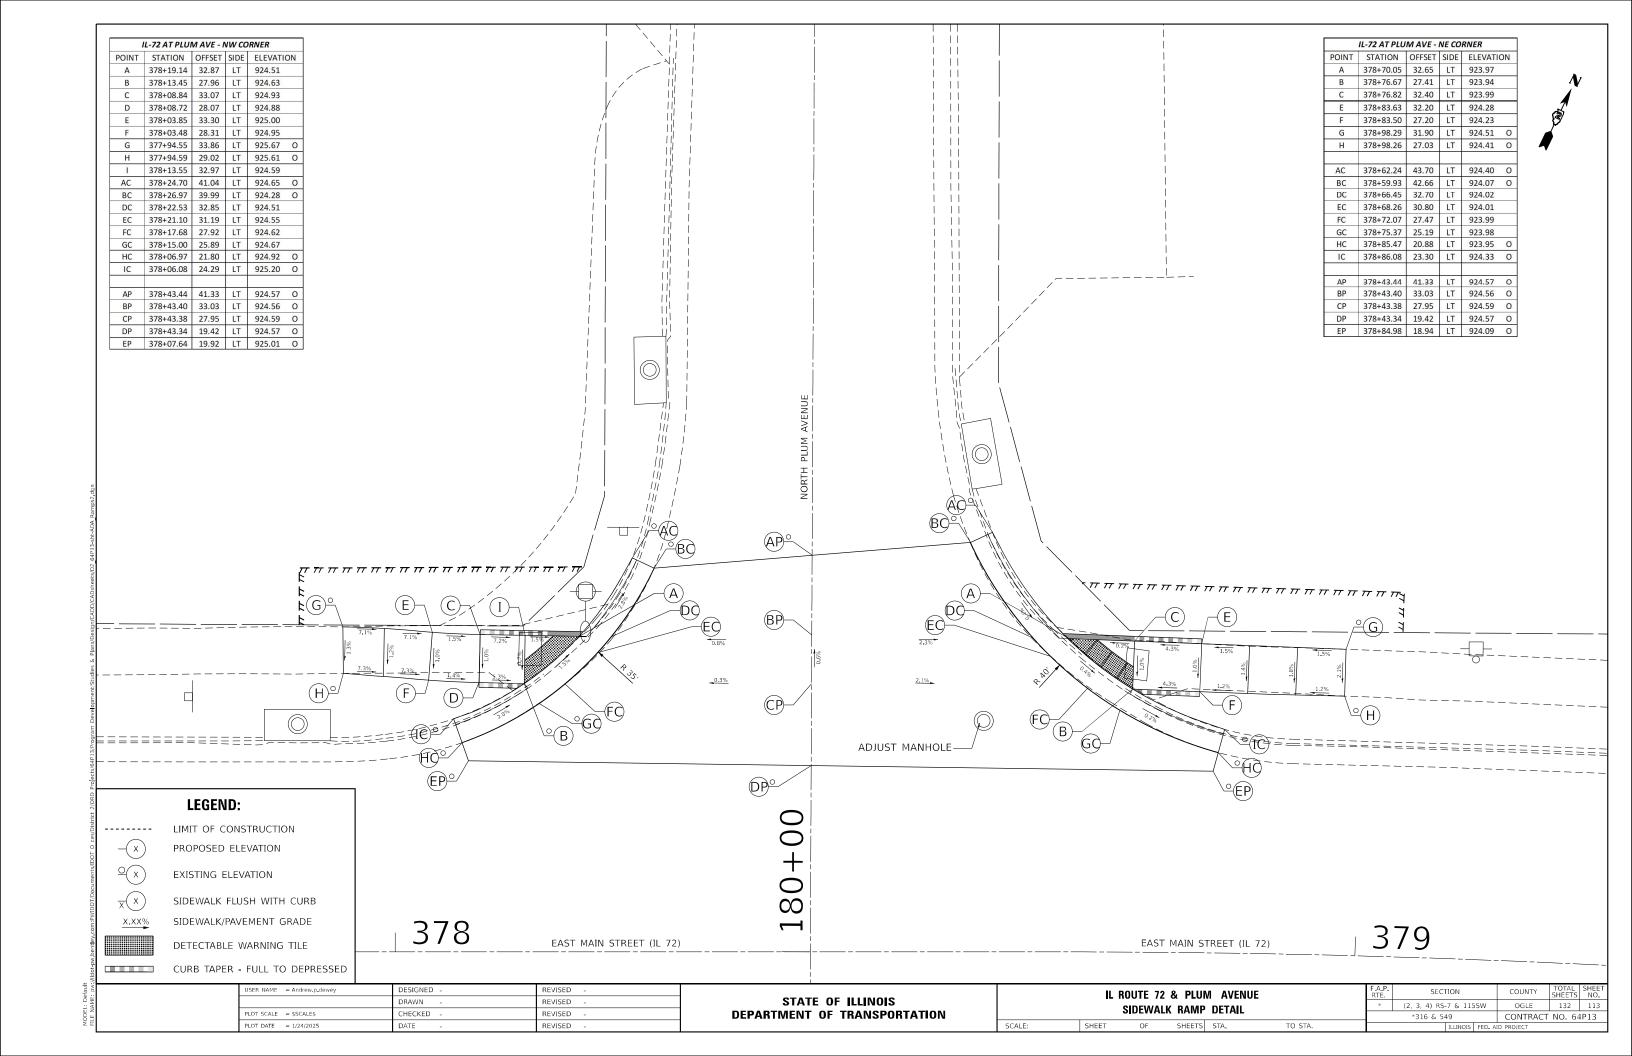


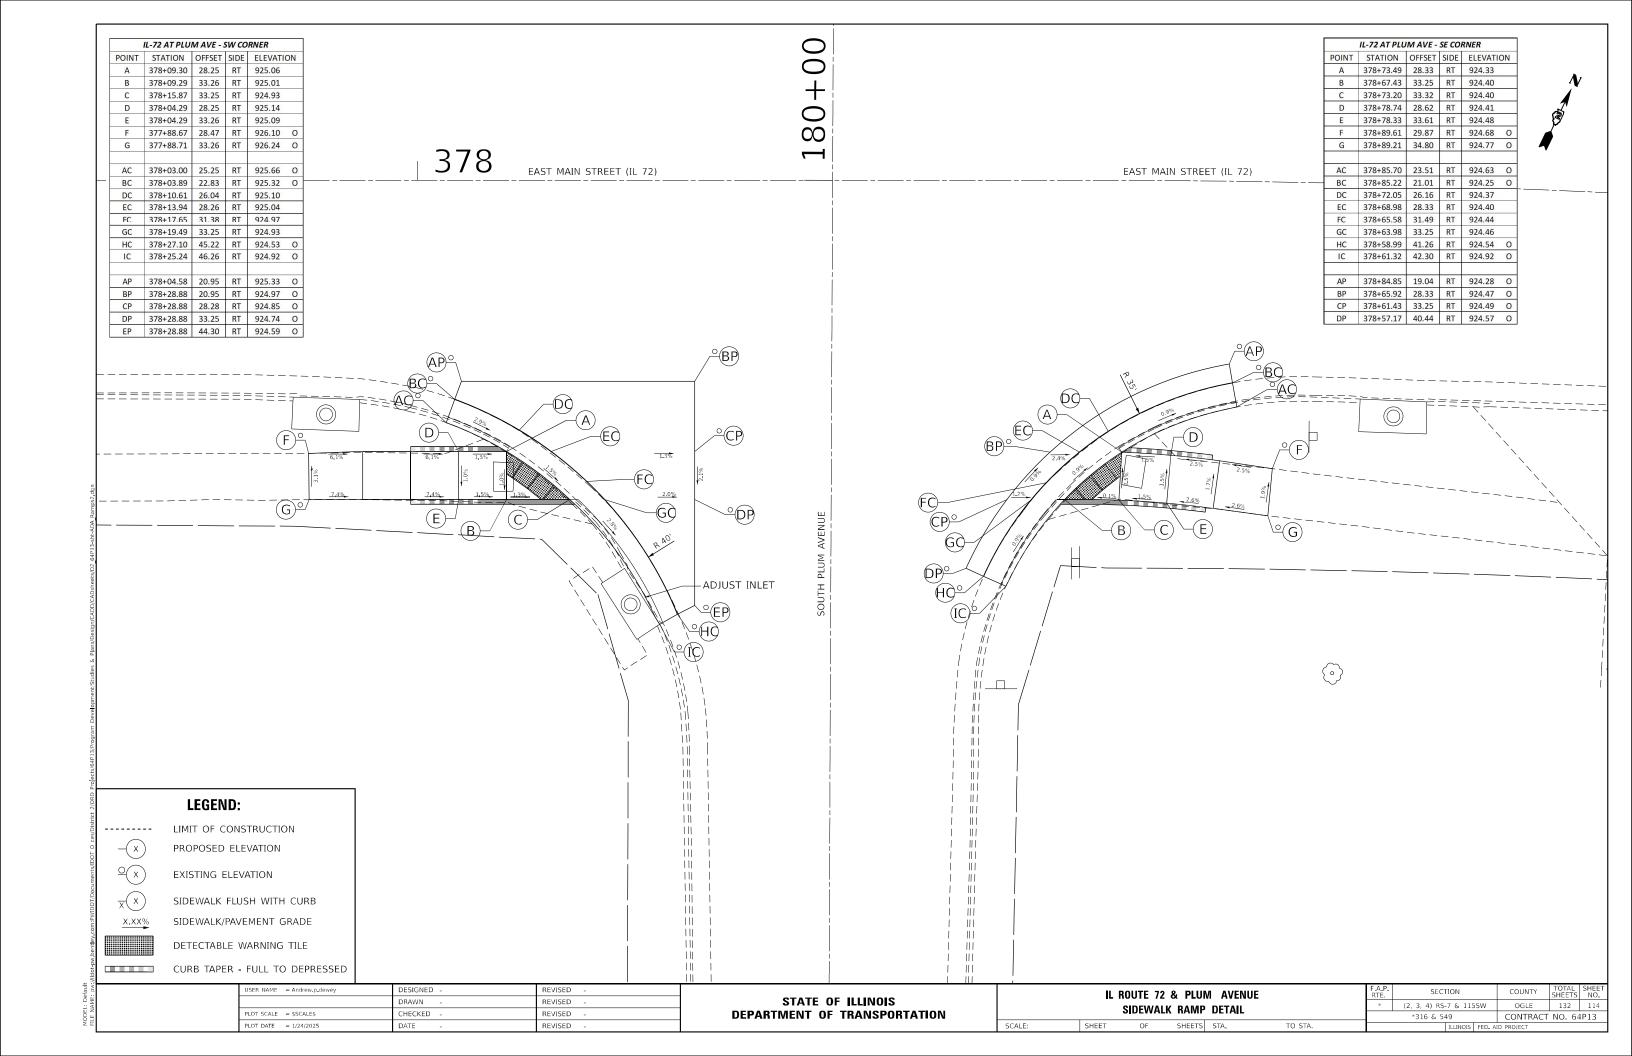

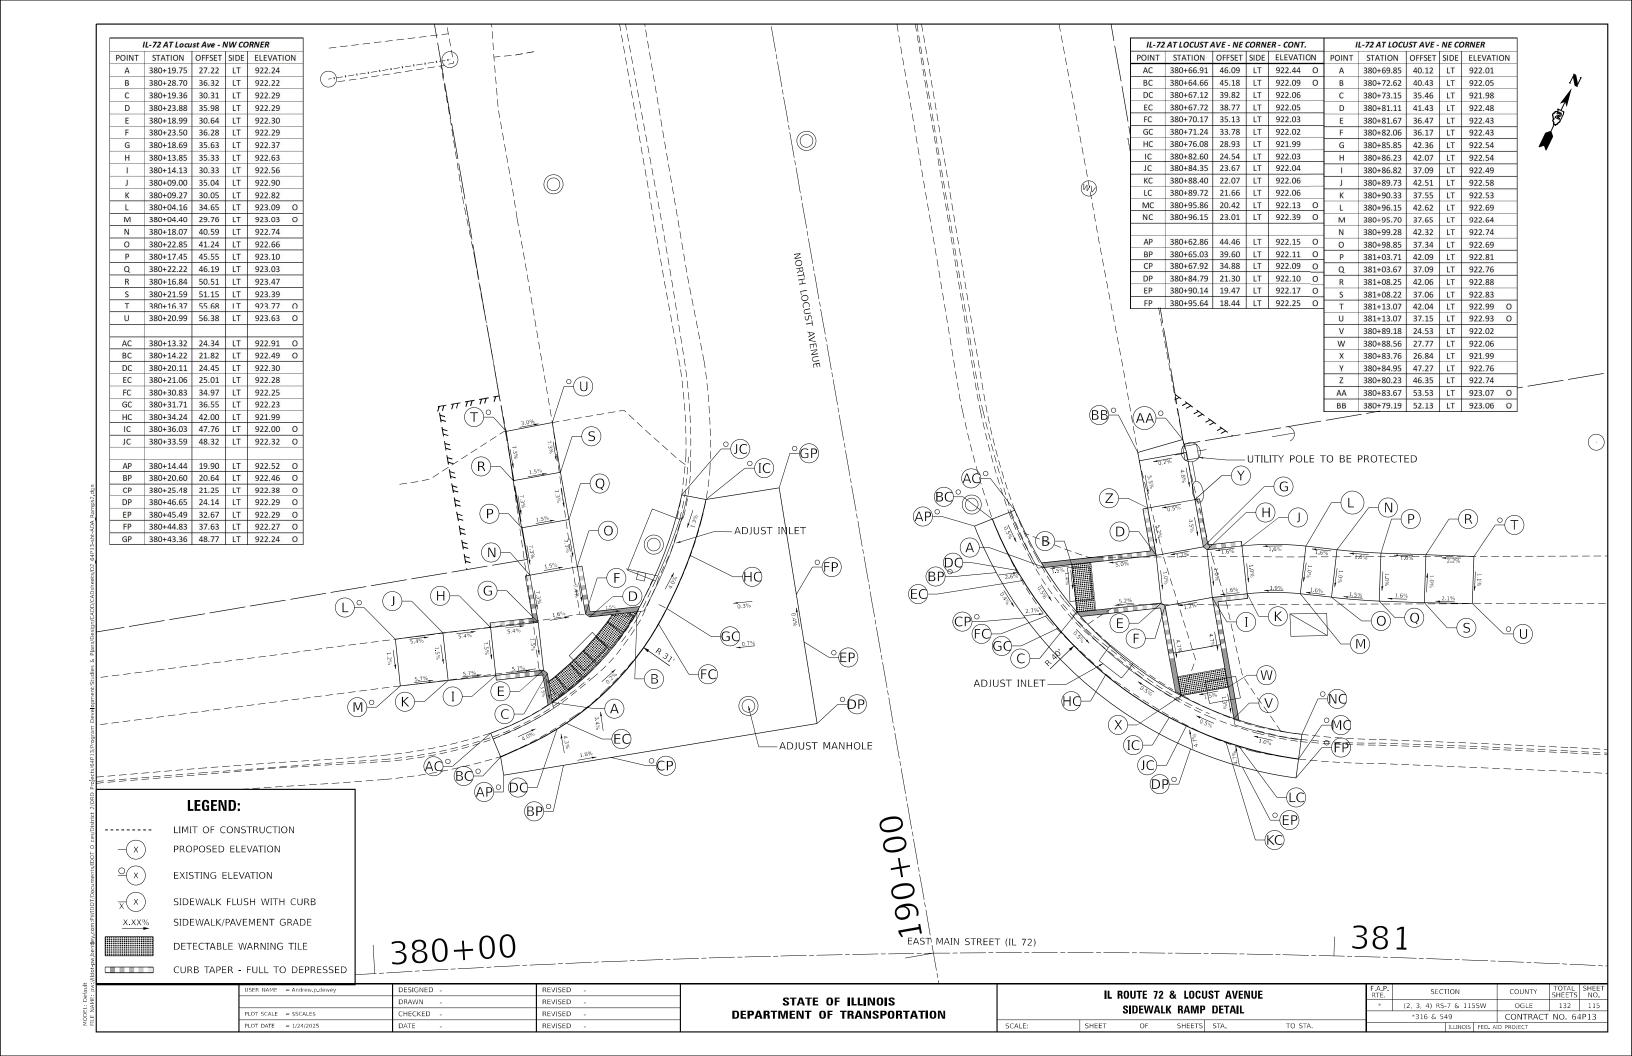


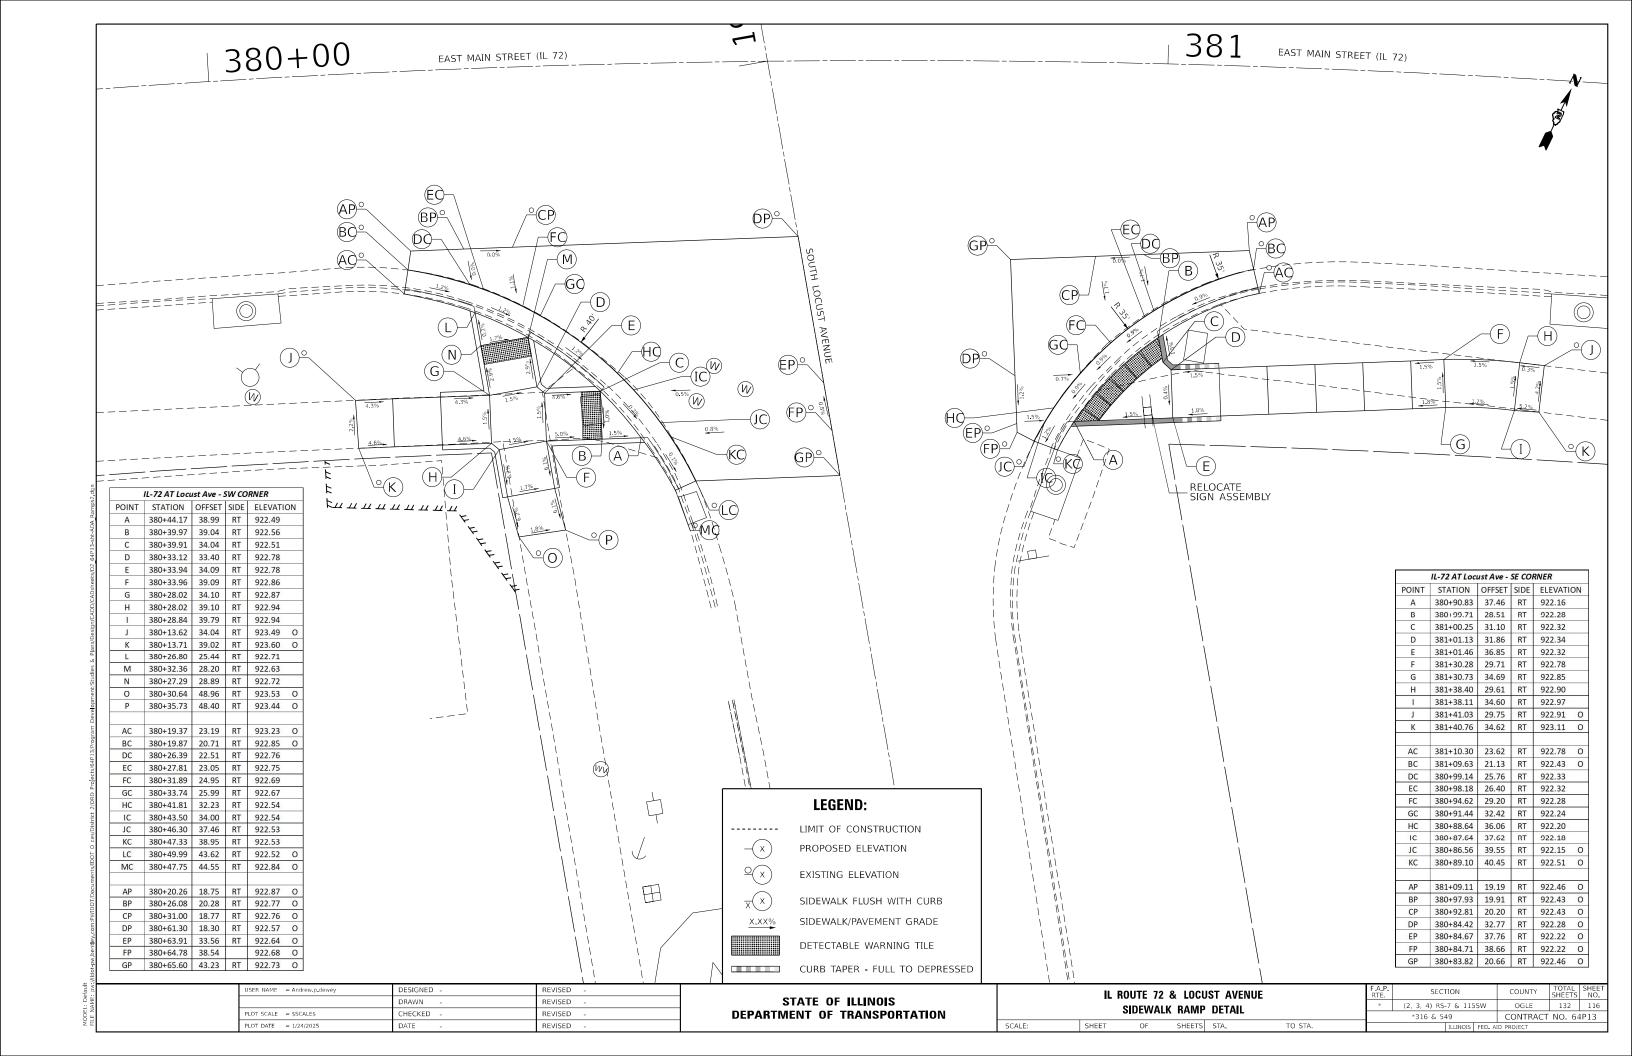

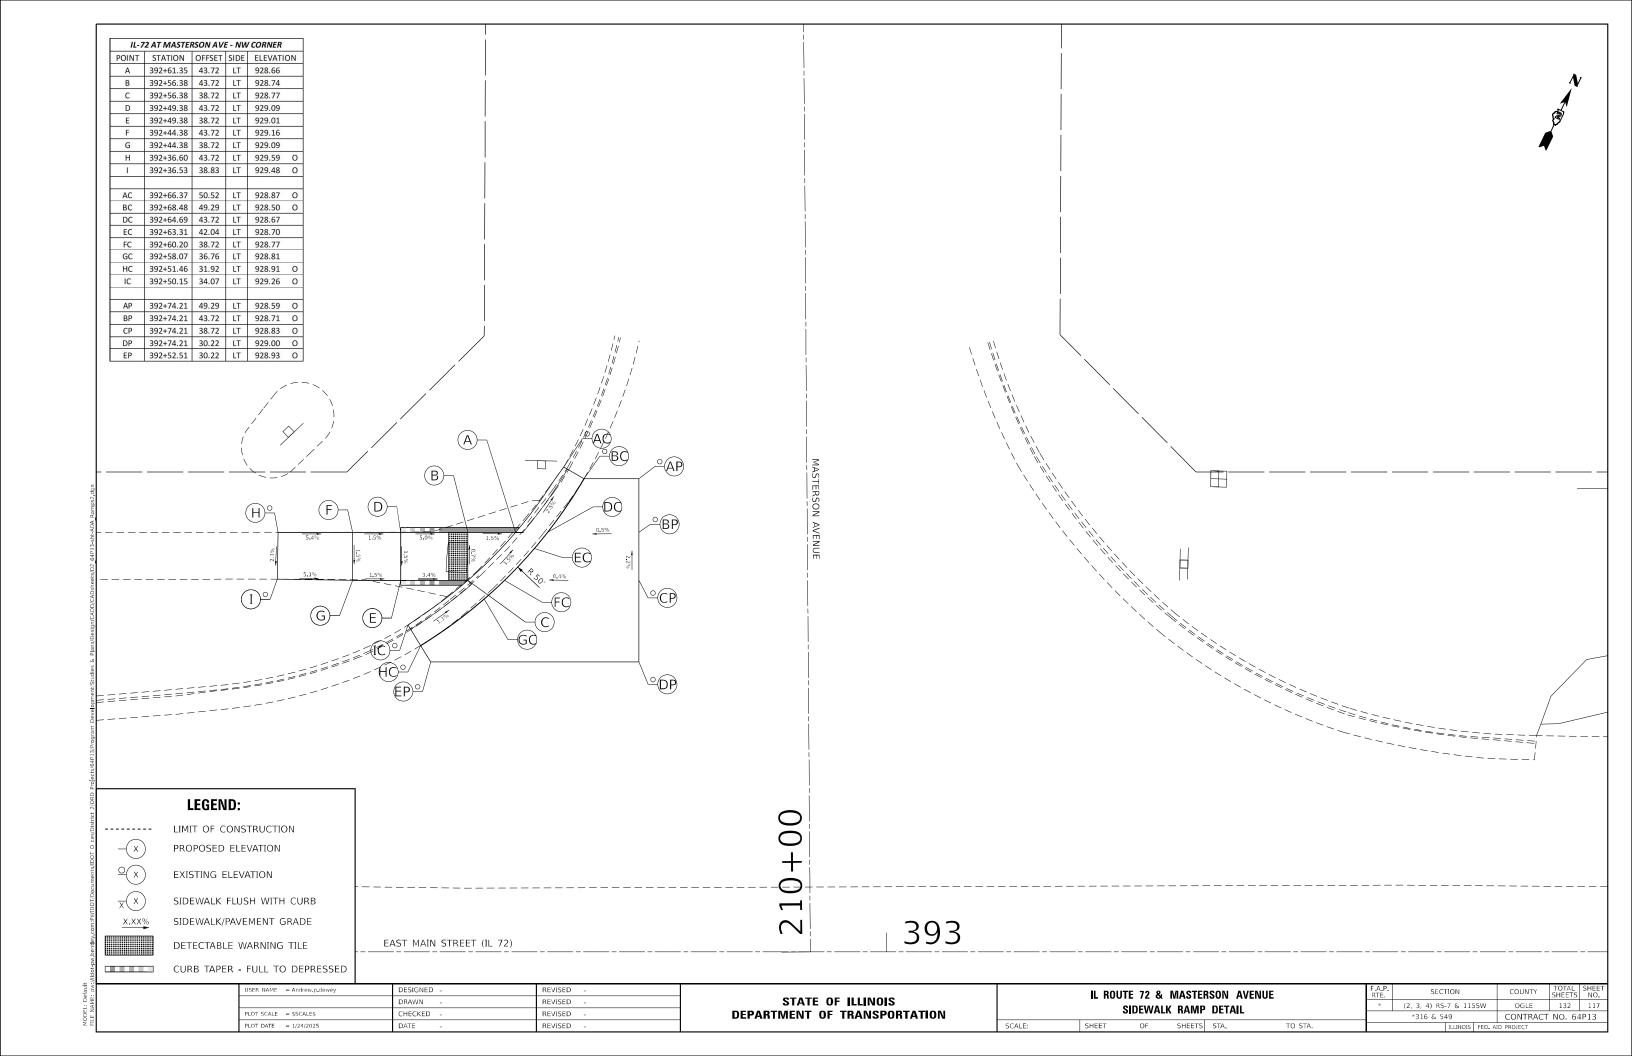


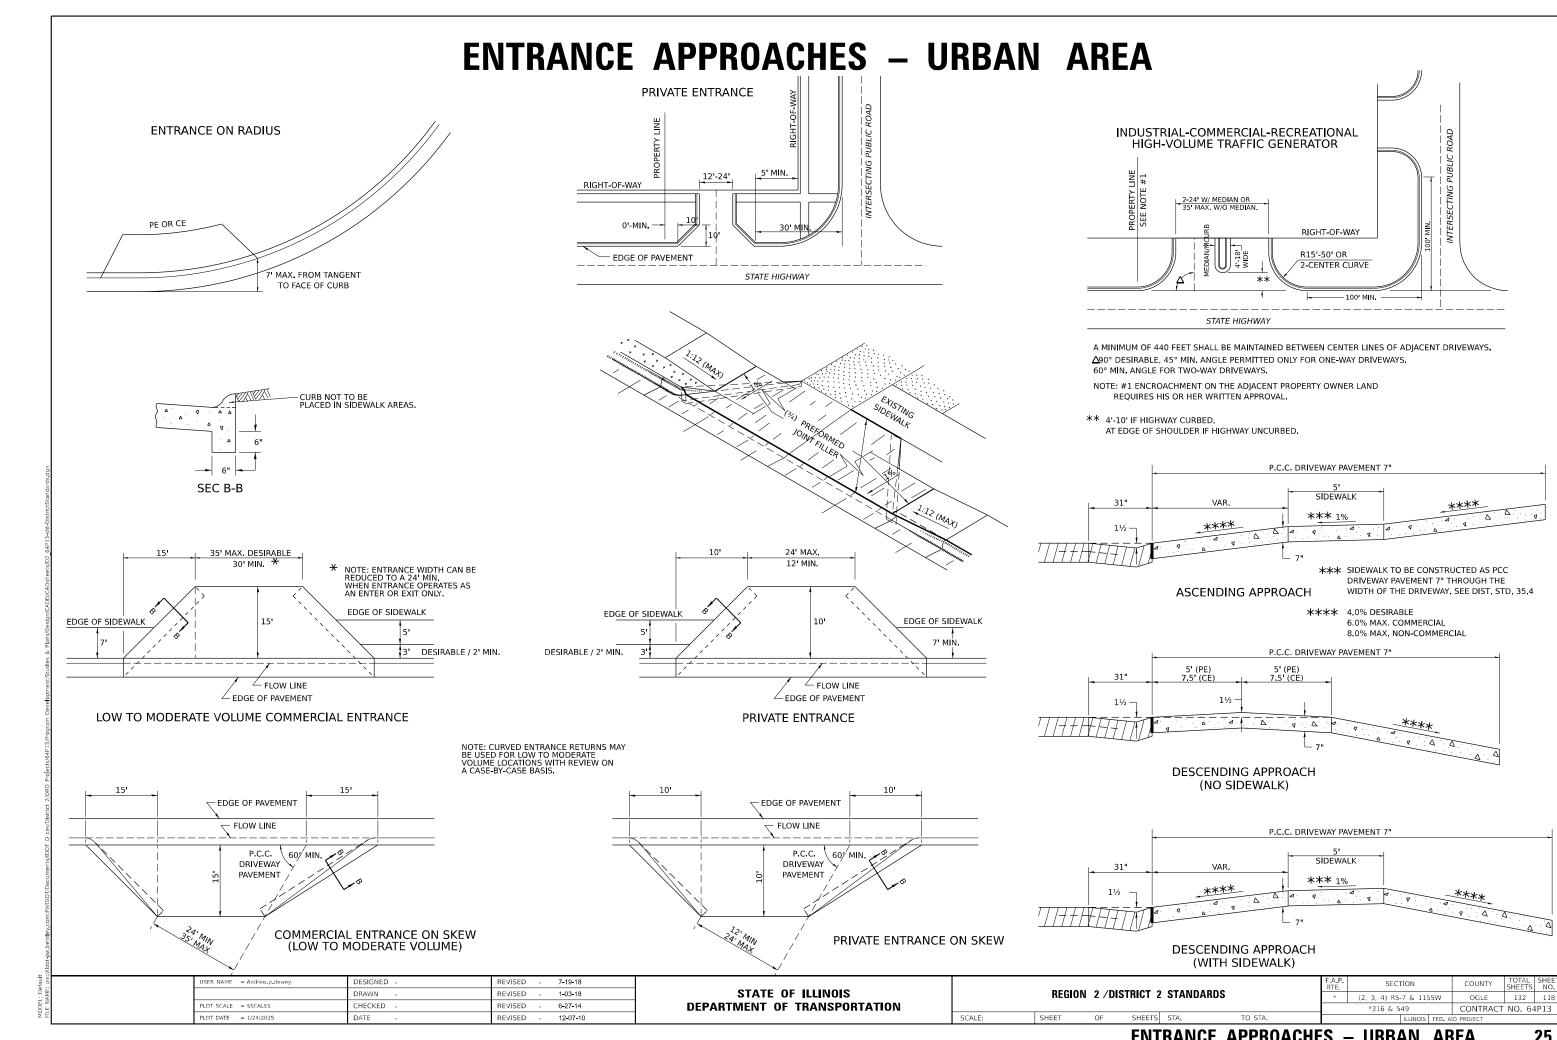

ADA CURB RAMP PAVEMENT REMOVAL AND REPLACEMENT

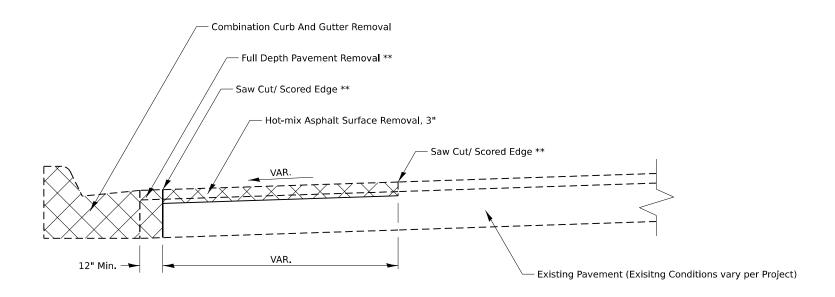

PAVEMENT REMOVAL

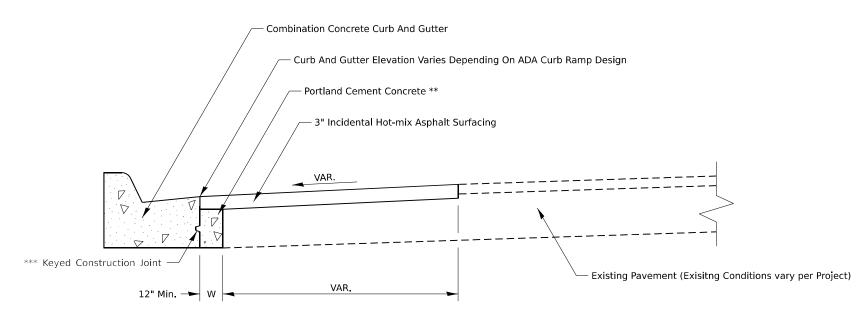

PAVEMENT REPLACEMENT

GENERAL NOTES:

SEE STANDARD 606001 FOR CONCRETE CURB AND COMBINATION CURB AND GUTTER DETAILS NOT SHOWN.

SEE STANDARD 420001 FOR KEYED CONSTRUCTION JOINT DETAILS

SAW CUTTING/ SCORING SHALL BE INCLUDED IN THE UNIT COST OF HOT-MIX ASPHALT SURFACE REMOVAL.

FULL DEPTH PAVEMENT REMOVAL SHALL BE INCLUDED IN THE UNIT COST OF COMBINATION CURB AND GUTTER REMOVAL.

PORTLAND CEMENT CONCRETE NEEDED TO FILL IN THE FORMWORK AREA IN FRONT OF THE COMBINATION CURB AND GUTTER SHALL BE INCLUDED IN THE UNIT COST OF COMBINATION CONCRETE CURB AND GUTTER.

IF THERE IS A CHANGE IN RADIUS AND THE DISTANCE BETWEEN THE NEW COMBINATION CURB AND GUTTER AND THE EXISTING PAVEMENT IS 4FT OF GREATER, THE PCC IN FRONT OF THE CURB AND GUTTER SHALL BE TIED TO THE NEW COMBINATION CURB AND GUTTER AND THE EXISTING PAVEMENT WITH TIE BARS. TIE BARS SHALL BE INCLUDED IN THE UNIT COST OF COMBINATION CONCRETE CURB AND GUTTER.

CONSTRUCTION SEQUENCE

- 1. REMOVE EXISTING FULL DEPTH PAVEMENT AND CURB AND GUTTER
- 2. FORM AND POUR COMBINATION CONCRETE CURB AND GUTTER
- 3. REPLACE FULL DEPTH PAVEMENT WITH PORTLAND CEMENT CONCRETE

 (UP TO 3" FROM FINISHED SURFACE ELVATION TO ALLOW FOR HMA OVERLAY)
- 4. HOT-MIX ASPHALT REMOVAL AND REPLACEMENT.

NOTES

- ALL DIMENSIONS ARE IN INCHES UNLESS OTHERWISE NOTED
- ** COST INCLUDED IN OTHER PAY ITEMS PER GENERAL NOTES
- *** IF W > 24" TIE BARS SHALL BE USED INSTEAD OF A KEYED CONSTRUCTION JOINT


USER NAME = Andrew.p.dewey	DESIGNED -	REVISED - 1-10-22	
	DRAWN -	REVISED -	l
PLOT SCALE = \$SCALE\$	CHECKED -	REVISED -	l
PLOT DATE = 1/24/2025	DATE -	REVISED -	

STATE OF ILLINOIS
DEPARTMENT OF TRANSPORTATION

	PEOLON & (PLOTPIOT		F.A.P. RTE	SECTION	COUNTY	TO SHE
	REGION 2 / DISTRICT	2 STANDARDS	*	(2, 3, 4) RS-7 & 115SW	OGLE	1
_				*316 & 549	CONTRACT	NC

WORK ZONE SIGN DETAILS

ILLINOIS STANDARD G20–I100

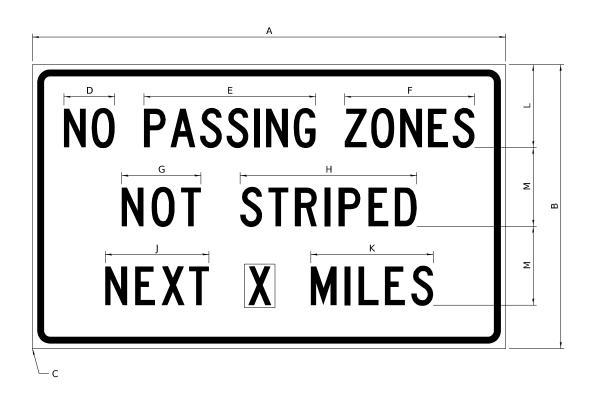

COLOR LEGEND AND BORDER BACKGROUND

BLACK ORANGE NON-REFLECTORIZED REFLECTORIZED

SIGN SIZE		DIMENSIONS										
SIGN SIZE	Α	В	С	D	Е	F	G	Н	J	K	L	М
60 x 36	60.00	36.00	2.25	6.4	21.80	16.40	10.00	22.40	13.20	15.50	10.50	10.00

SIGN SIZE	SER	IES BY L	INE	MARGIN	BORDER	
SIGN SIZE	1	2	3	MANGIN	BORDER	
60 x 36	5C	5C	5C	0.625	0.875	

Sign not to scale

GENERAL NOTES


All work to furnish and install these signs shall be included in the cost of the specified traffic control standards and shall not be paid separately.

All Illinois Standard signs shall conform to the latest edition of the "Illinois Standard Highway Signs Book" in effect on the date of invitation for bids.

Signs shall meet the applicable portions of Sections 701 and 720 of the Standard Specifications.

All dimensions are in inches unless otherwise noted.

ILLINOIS STANDARD W8–I107

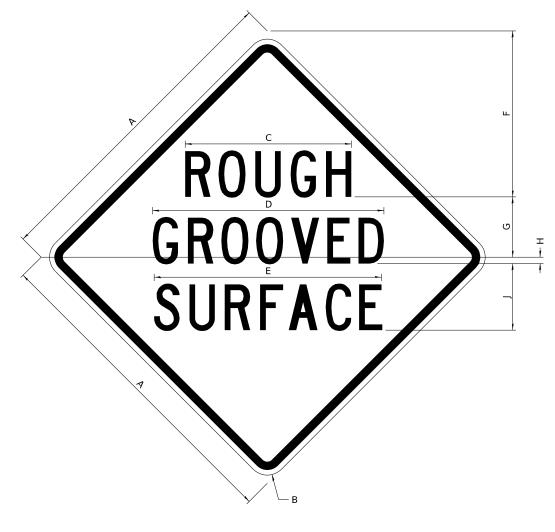

COLOR LEGEND AND BORDER BACKGROUND

BLACK ORANGE NON-REFLECTORIZED REFLECTORIZED

SIGN SIZE		DIMENSIONS								
SIGN SIZE	Α	В	С	D	Е	F	G	Н	J	
48 x 48	48.00	3.00	25.00	34.80	34.20	24.94	9.00	1.00	10.00	


SIGN SIZE	SER	IES BY L	INE	MARGIN	BORDER
SIGN SIZE	1	2	3	MARGIN	BORDER
48 x 48	7C	7C	7C	1.250	0.750

Sign not to scale

USER NAME = Andrew.p.dewey	DESIGNED -	REVISED - 3-02-16									F.A.P. RTF	SECTION	COUNTY	TOTAL SHEET SHEETS NO.
	DRAWN -	REVISED -	STATE OF ILLINOIS		REGIO	ON 2	2 /DIST	RICT 2	STANDARD:	S	*	(2, 3, 4) RS-7 & 115SW	OGLE	132 120
PLOT SCALE = \$SCALES	CHECKED -	REVISED -	DEPARTMENT OF TRANSPORTATION									*316 & 549	CONTRAC	T NO. 64P13
PLOT DATE = 1/24/2025	DATE -	REVISED -		SCALE:	SHEET	С	OF	SHEETS	STA.	TO STA.		ILLINOIS FED. A	ID PROJECT	

WORK ZONE SIGN DETAILS

ILLINOIS STANDARD W12–I102

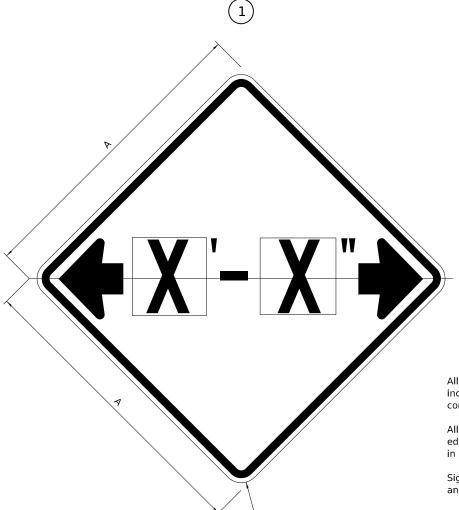

GENERAL NOTES

All work to furnish and install these signs shall be included in the cost of the specified traffic control standards and shall not be paid separately.

All Illinois Standard signs shall conform to the latest edition of the "Illinois Standard Highway Signs Book" in effect on the date of invitation for bids.

Signs shall meet the applicable portions of Sections 701 and 720 of the Standard Specifications.

All dimensions are in inches unless otherwise noted.

COLOR LEGEND AND BORDER BACKGROUND

BLACK FL ORANGE NON-REFLECTORIZED REFLECTORIZED


SIGN SIZE	DIMEN	ISIONS
SIGN SIZE	Α	В
48 x 48	48.00	3.00

Illinois Standard signs W12-I102 and W12-I103 shall be used as described in the special provisions.

SIGN SIZE	SERIES BY LINE	MARGIN	BORDER	
SIGN SIZE	N SIZE 1		BONDEN	
48 x 48	12C	0.750	1.250	

Sign not to scale

ILLINOIS STANDARD W12–I103

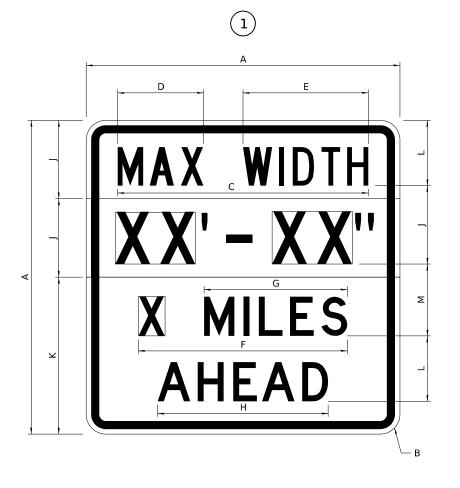

COLOR

LEGEND AND BORDER BACKGROUND BACKGROUND (WIDTH) BLACK WHITE FL ORANGE NON-REFLECTORIZED REFLECTORIZED REFLECTORIZED

SIGN SIZE					[DIMEN	ISIONS	5				
SIGN SIZE	Α	В	С	D	Е	F	G	Н	J	K	٦	М
48 x 48	48.00	3.00	38.40	13.20	19.20	32.00	22.00	26.20	12.00	24.00	10.00	11.00

SIGN SIZE	,	SERIES	BY LINE	MARGIN	BORDER	
SIGN SIZE	1	2	3	4	MARGIN	DONDER
48 x 48	6C	8D	6D	6D	0.750	1.250

Sign not to scale

XX'-XX" WIDTH AND X MILES ARE VARIABLE TOP AND BOTTOM OF BACKGROUND WHITE

USER NAME = Andrew p dewey	DESIGNED -	REVISED - 3-02-16	
	DRAWN -	REVISED -	STATE OF ILLINOIS
PLOT SCALE = \$SCALES	CHECKED -	REVISED -	DEPARTMENT OF TRANSPORTATION
PLOT DATE = 1/24/2025	DATE -	REVISED -	

REGION 2 / DISTRICT 2 STANDARDS

ALE: SHEET OF SHEETS STA.


** (2, 3, 4) RS-7 & 115SW COUNTY TOTAL SHEETS NO.

** (2, 3, 4) RS-7 & 115SW COLE 132 121

**316 & 549 CONTRACT NO. 64P13

WORK ZONE SIGN DETAILS

ROAD CLOSED TO OVERSIZED LOADS

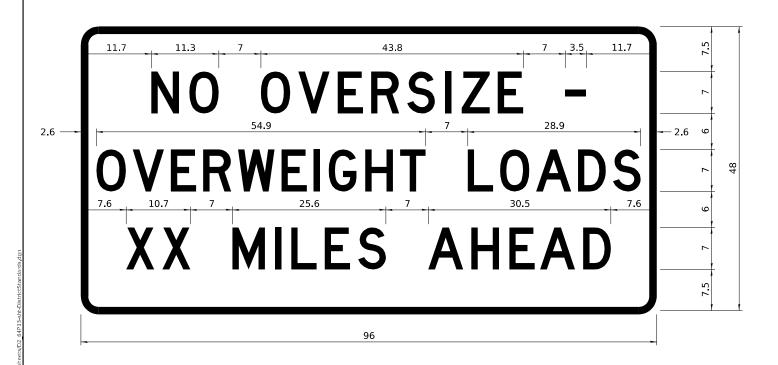

COLOR

LEGEND AND BORDER BACKGROUND


BLACK ORANGE NON-REFLECTORIZED REFLECTORIZED

Permit Loads - Loads Over 13 Feet; 3.0" Radius, 1.3" Border; [NO OVERSIZE -] D; [OVERWEIGHT LOADS] D 85% spacing; [XX MILES AHEAD] D; Table of letter and object lefts.

N 11.7	O 18.1	O 30.0	V 36.2	E 42.8	R 48.4	S 54.4	I 60.7	Z 63.5	E 69.5	- 80.8				
O 2.6	V 8.6	E 15.0	R 20.4	W 26.2	E 33.4	I 38.8	G 41.3	H 47.4	T 53.2	L 64.5	O 69.9	A 75.9	D 82.9	S 88.7
X 7.6	X 13.6	M 25.3	 32.3	L 35.1	E 40.6	S 46.2	A 57.9	H 65.1	E 71.4	A 76.6	D 83.7			

Sign not to scale

STOP LINE SIGN FOR TEMPORARY SIGNALS

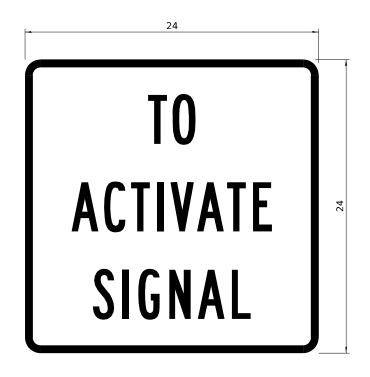

COLOR

LEGEND AND BORDER BACKGROUND

BLACK WH**I**TE NON-REFLECTORIZED REFLECTORIZED

SIGN SIZE	SERIES BY LINE								
SIGN SIZE	1	2	3						
24 x 24	4C	4C	4C						

Sign not to scale

GENERAL NOTES

All work to furnish and install these signs shall be included in the cost of the specified traffic control standards and shall not be paid separately.

All Illinois Standard signs shall conform to the latest edition of the "Illinois Standard Highway Signs Book" in effect on the date of invitation for bids.

Signs shall meet the applicable portions of Sections 701 and 720 of the Standard Specifications.

All dimensions are in inches unless otherwise noted.

USER NAME = Andrew.p.dewey	DESIGNED -	REVISED - 3-02-16
	DRAWN -	REVISED -
PLOT SCALE = \$SCALES	CHECKED -	REVISED -
PLOT DATE = 1/24/2025	DATE -	REVISED -

STATE OF ILLINOIS DEPARTMENT OF TRANSPORTATION REGION 2 / DISTRICT 2 STANDARDS

SHEET OF SHEETS STA.

ENTRANCE SIGN FOR USE WITH TEMPORARY SIGNALS

WORK ZONE SIGN DETAILS

GENERAL NOTES

All work to furnish and install these signs shall be included in the cost of the specified traffic control standards and shall not be paid separately.


All Illinois Standard signs shall conform to the latest edition of the "Illinois Standard Highway Signs Book"

Signs shall meet the applicable portions of Sections 701

All dimensions are in inches unless otherwise noted.

in effect on the date of invitation for bids.

and 720 of the Standard Specifications.

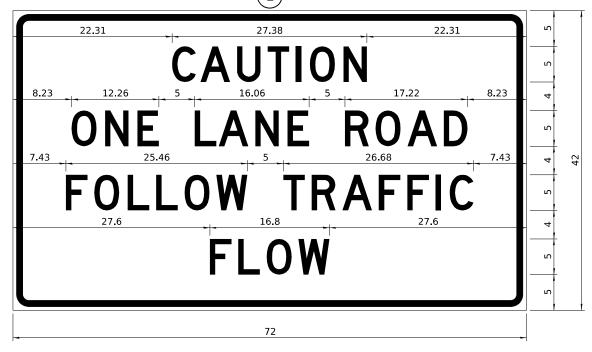

COLOR LEGEN

LEGEND AND BORDER BACKGROUND BLACK ORANGE NON-REFLECTORIZED REFLECTORIZED

2.25" Radius, 0.88" Border, 0.50" IndenT; [CAUTION] D; [ONE LANE ROAD] D; [FOLLOW TRAFFIC] D; [FLOW] D


This sign shall be installed at entrances located between the temporary signals as shown in the staging plans.

Table Of Widths And Spaces


22.31	C 3.36	0.62	A 4.18	0.94	U 3.36	0.94	T 3.04	0.94	I 0.78	1.17	O 3.52	1.17	N 3.36	22.31
-------	-----------	------	------------------	------	-----------	------	-----------	------	------------------	------	-----------	------	-----------	-------

	0		N		Е
8 . 23	3.51	1.17	3.36	1.18	3.04

	R		0		Α		D	
5.00	3.36	0.93	3.52	0.94	4.18	0.93	3.36	8.23

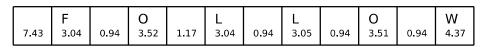


	Т		R		Α		F		F				С	
5.00	3.05	0.94	3.36	0.94	4.18	0.93	3.05	0.94	3.04	0.94	0.78	1.18	3.35	7.43

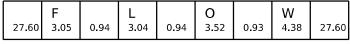

Sign not to scale

STAY IN YOUR LANE

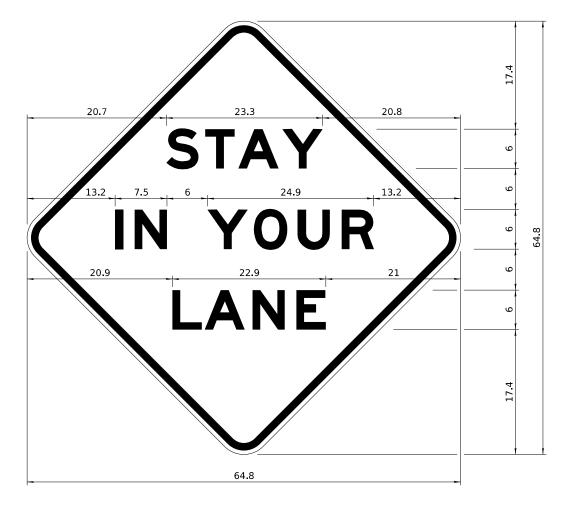

COLOR

LEGEND AND BORDER BACKGROUND

BLACK ORANGE NON-REFLECTORIZED REFLECTORIZED

48.0" across sides 3.8" Radius, 1.0" Border, 0.6" Indent; "STAY" E Mod; "IN YOUR" E Mod; "LANE" E Mod;

Table of Letter and Object Lefts

ſ	S	Т	Α	Υ
	20.7	26.8	31.6	38.0

I N Y 13.2 15.9 26.7	O	U	R
	33.9	40.5	46.8

L	Α	N	Е
20.9	25.8	33.1	39.4


Sign not to scale


	Sign flot to scale						519	gii not to scale	•				
USER NAME = Andrew.p.dewey	DESIGNED -	REVISED - 3-02-16								F.A.P.	SECTION	COUNTY TOTAL	S NO
	DRAWN -	REVISED -	STATE OF ILLINOIS		REGIO	N 2/DIS	STRICT	2 STANDARD	S	*	(2, 3, 4) RS-7 & 115SW	OGLE 132	123
PLOT SCALE = \$SCALES	CHECKED -	REVISED -	DEPARTMENT OF TRANSPORTATION								*316 & 549	CONTRACT NO. 6	54P13
PLOT DATE = 1/24/2025	DATE -	REVISED -		SCALE:	SHEET	OF	SHEETS	S STA.	TO STA.		ILLINOIS FED. A	D PROJECT	

TYPICAL PAVEMENT MARKINGS

MEDIAN PAVEMENT MARKING


TYPICAL PAVEMENT MARKING FOR FLUSH MEDIAN AT LEFT TURN LANE

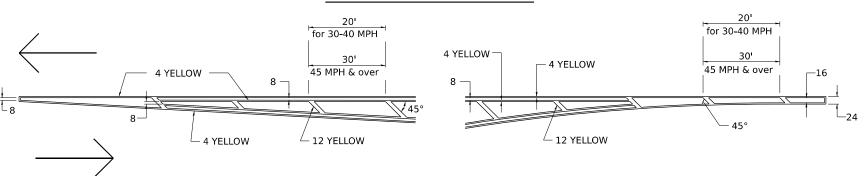

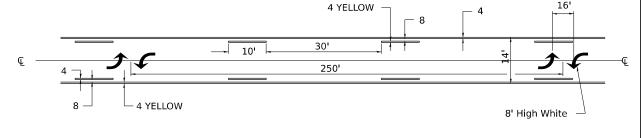


** ALL DIMENSIONS ARE IN INCHES UNLESS OTHERWISE NOTED.

TYPICAL ISLAND OFFSET SHOULDER WIDTH

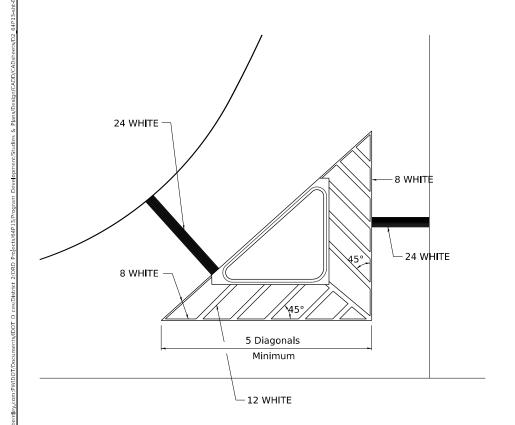


TYPICAL MARKING FOR PAINTED ISLANDS

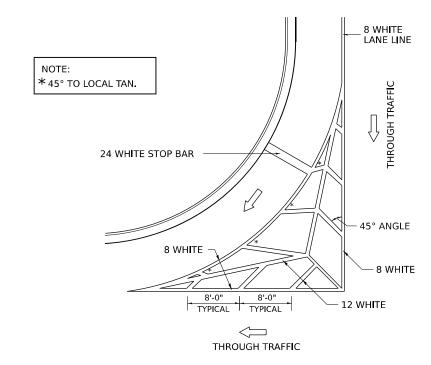

STANDARD CROSSWALK MARKING

See Schedules for Locations

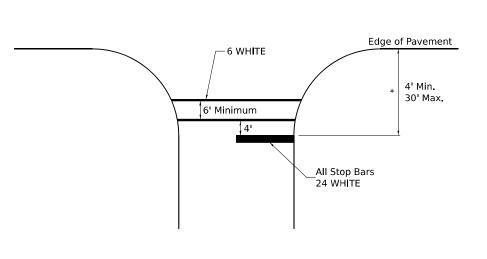

* Distance to the nearest edge of the intersecting roadway in the absence of a marked crosswalk.


USER NAME = Andrew.p.dewey	DESIGNED -	REVISED - 6-27-14
	DRAWN -	REVISED - 3-05-12
PLOT SCALE = \$SCALES	CHECKED -	REVISED -
PLOT DATE = 1/24/2025	DATE -	REVISED -

STATE OF ILLINOIS DEPARTMENT OF TRANSPORTATION REGION 2 / DISTRICT 2 STANDARDS

REGION 2 / DISTRICT 2 STANDARDS


* (2)


CALE: SHEET OF SHEETS STA. TO STA.

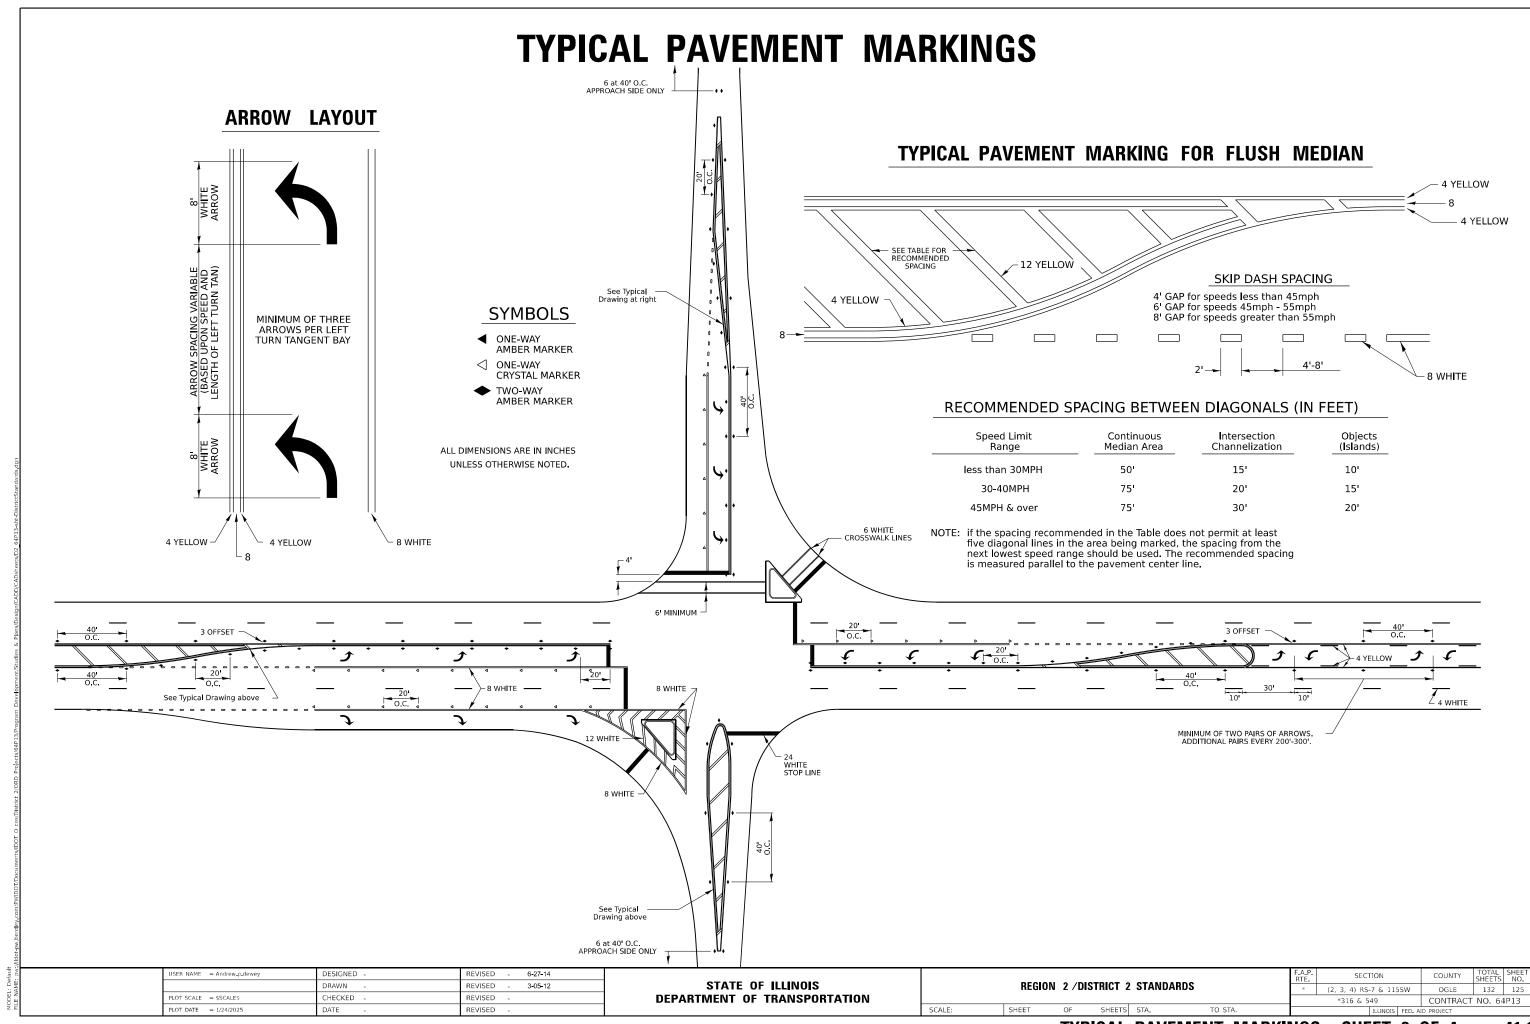

TYPICAL PAVEMENT MARKINGS


TYPICAL PARKING SPACING

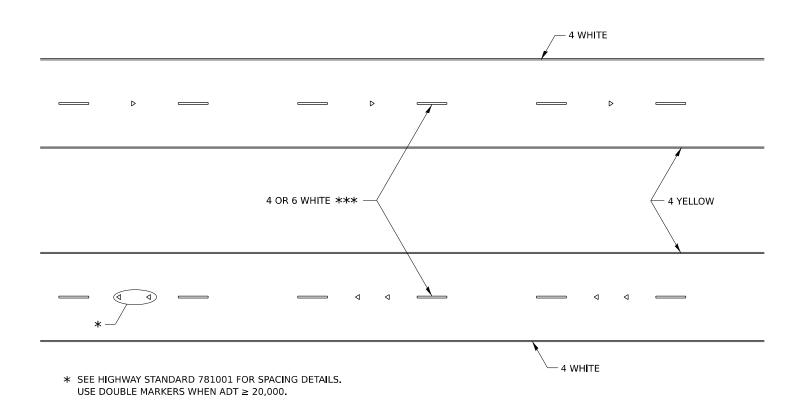

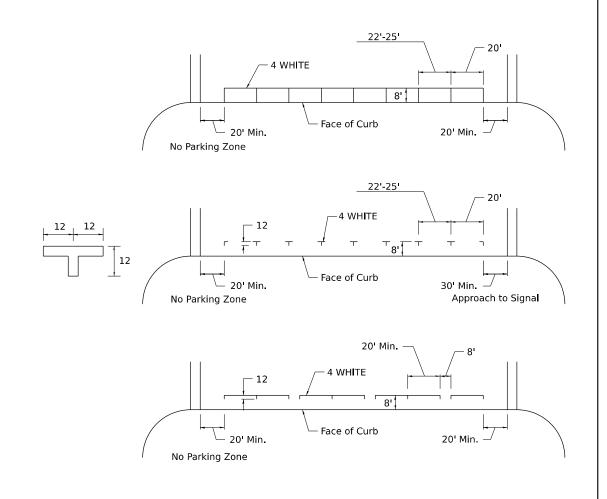

TYPICAL PAVEMENT MARKING FOR TWO LANE SECTION - NO PASSING ZONES

MULTI-LANE / DIVIDED

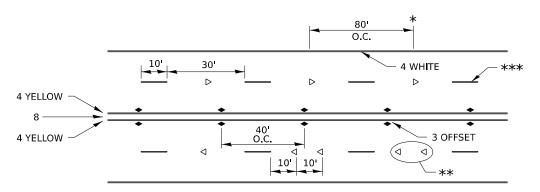

- * REDUCE TO 40' O.C. ON CURVES WHERE ADVISORY SPEEDS ARE 10 MPH LOWER THAN POSTED SPEEDS.
- ** USE DOUBLE MARKERS WHEN ADT ≥ 20,000
- *** CENTERLINE SKIP DASH PAVEMENT MARKING SPEED LIMIT LESS THAN 40 MPH USE 4" LINE. SPEED LIMIT 40 MPH AND OVER USE 6" LINE.

MULTI-LANE / UNDIVIDED & ONE WAY

(FOR MULTI-LANE UNDIVIDED HIGHWAYS USE THIS DETAIL NOT HIGHWAY STANDARD 781001)

USER NAME = Andrew.p.dewey	DESIGNED -	REVISED - 6-27-14
	DRAWN -	REVISED - 8-27-13
PLOT SCALE = \$SCALES	CHECKED -	REVISED - 11-28-12
PLOT DATE = 1/24/2025	DATE -	REVISED -

STATE OF ILLINOIS DEPARTMENT OF TRANSPORTATION


30'

						F.A.P. RTE	SECT	COUNTY	TOTAL SHEETS	SHEET NO.		
						*	* (2, 3, 4) RS-7 & 115SW		OGLE	132	126	
							*316 & 5	49		CONTRACT	NO. 64	P13
ALE:	SHEET	OF	SHEETS	STA.	TO STA.			ILLINOIS	FED. AI	D PROJECT		

EDGE OF PAVEMENT

WHITE

WHITE

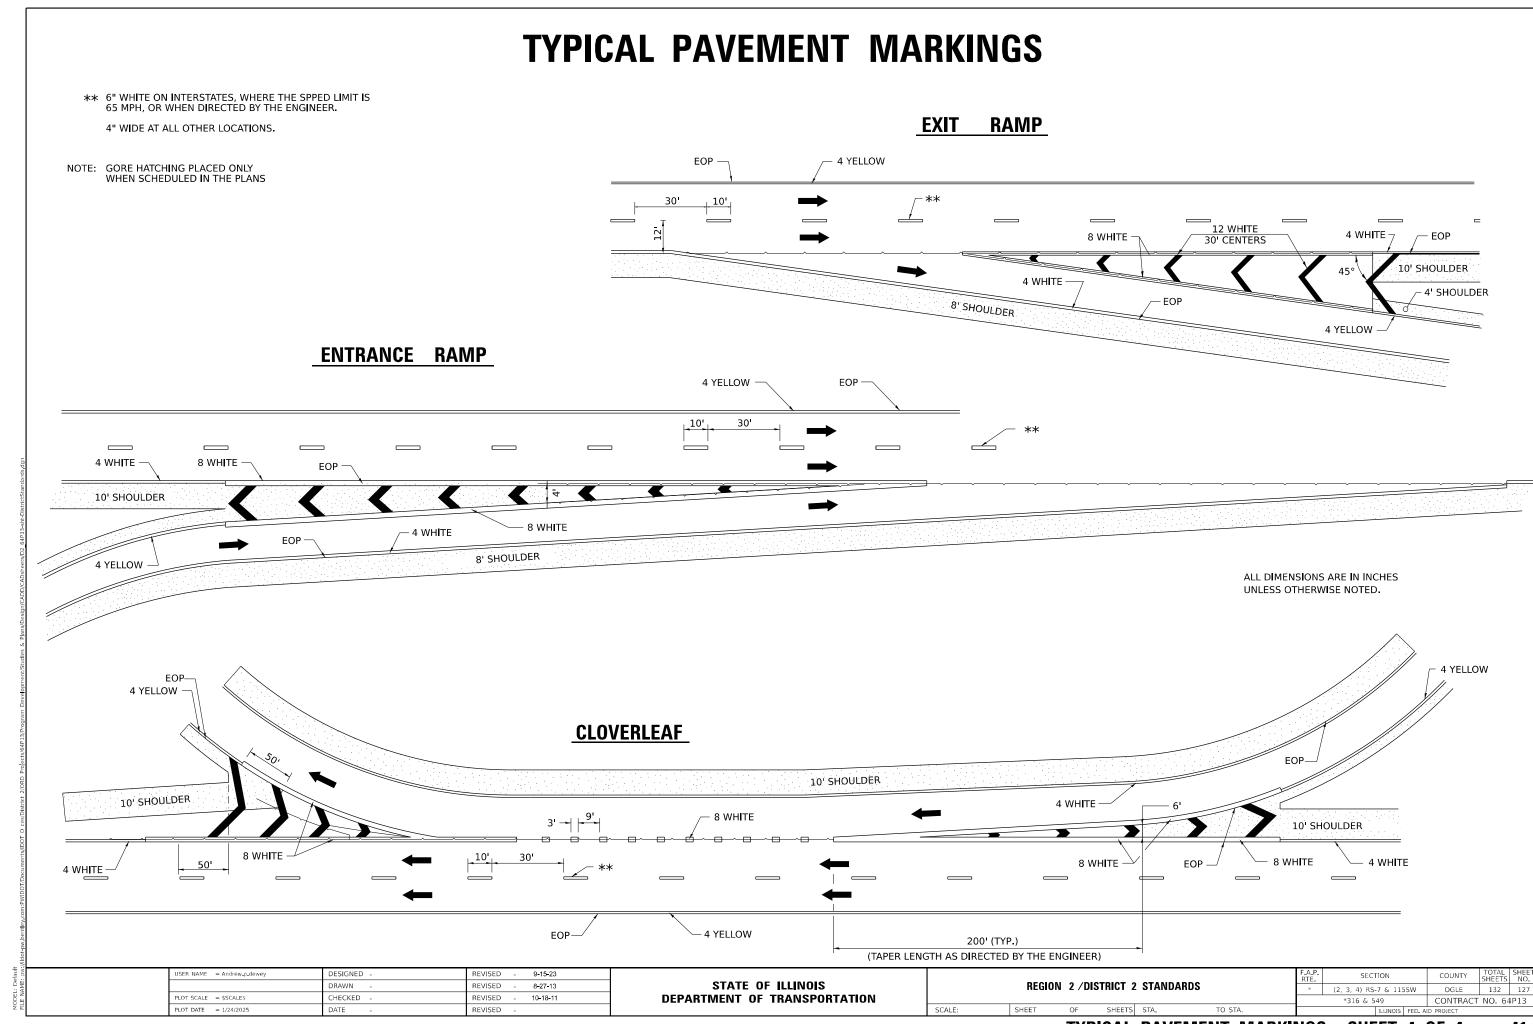


GUARDRAIL REFLECTORS, TYPE C (SPECIAL)


BLOCK OUT

REFLECTORS FOR GUARDRAIL BLOCK OUT OR DELINEATOR POST

STRAIGHT REFLECTOR / DELINEATOR

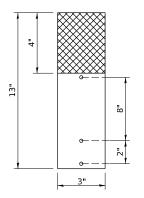

SIDE VIEW

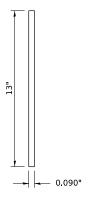

TWO 2 ½" GALVANIZED SCREWS
OR TWO GALVANIZED SELF TAPPING
SCREWS


MOUNTED ON A GUARDRAIL BLOCK OUT

REFLECTORS SHALL BE MOUNTED DIRECTLY TO BLOCK OUTS


REFLECTORS MOUNTED ON WOODEN OR PLASTIC OR METAL BLOCK OUT SHALL BE MOUNTED USING TWO 2 ½" GALVANIZED SCREWS WITH WASHERS OR TWO SELF TAPPING GALVANIZED SCREWS WITH WASHERS.

REFLECTORS MOUNTED ON BARRIER WALL


ADDITIONAL SHEETING MAY BE ADDED AS NEEDED

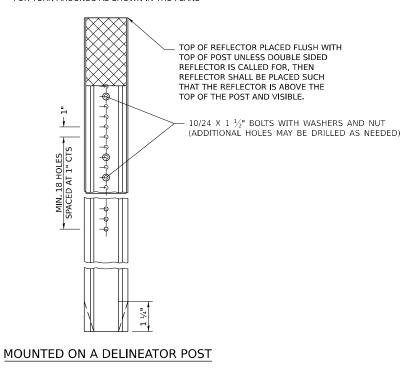


REPLACING 3 BUTTON DELINEATOR

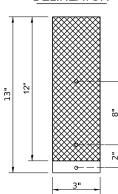

REPLACING 2 BUTTON DELINEATOR

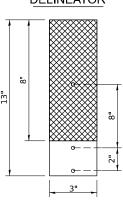

ADDITIONAL HOLES SHALL BE DRILLED IN THE REFLECTORS AS SHOWN ABOVE.

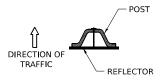

DELINEATORS SHALL BE INSTALLED ACCORDING TO STANDARD 635001 EXCEPT THAT THE POST SHALL BE ROTATED 180°. THE POST WILL HAVE THE WIDE SIDE FACING TRAFFIC AND THE REFLECTOR ATTACHECD AS SHOWN ABOVE.

NOTE:


REFLECTORS SHALL BE PAID FOR AT THE CONTRACT UNIT PRICE PER EACH FOR GUARDRAIL REFLECTORS, TYPE C (SPECIAL), WHICH PRICE SHALL ALSO INCLUDE SCREWS. WASHERS OR AN APPROVED BONDING AGENT.

REFLECTORS INSTALLED ON TWO LANE ROADS SHALL BE DOUBLE SIDED AND BOTH SIDES SHALL BE CRYSTAL.

REFLECTORS INSTALLED ON CENTER BARRIER OR IN THE MEDIAN SHALL BE DOUBLE SIDED AND BOTH SIDES SHALL BE AMBER.

REFLECTORS INSTALLED ON DIVIDED HIGHWAYS ON THE OUTSIDE OF THE ROADWAY SHALL BE DOUBLE SIDED CRYSTAL.

SPACING FOR REFLECTORS SHALL BE ACCORDING TO STANDARD 782006 UNLESS OTHERWISE NOTED IN THE PLANS.

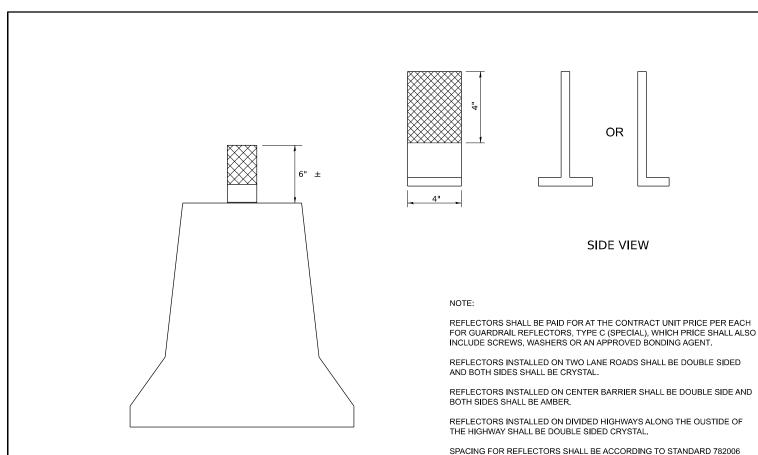

STATE OF ILLINOIS
DEPARTMENT OF TRANSPORTATION

 REGION 2 / DISTRICT 2 STANDARDS
 F.A.P. RTE.
 SECTION

 * (2, 3, 4) RS-7 & *316 & 549


UNLESS OTHERWISE NOTED IN THE PLANS.

132 128


OGLE

CONTRACT NO. 64P13


HOT-MIX ASPHALT APPROACHES & MAILBOX RETURNS FOR TWO LIFT (3P) RESURFACING PROJECTS

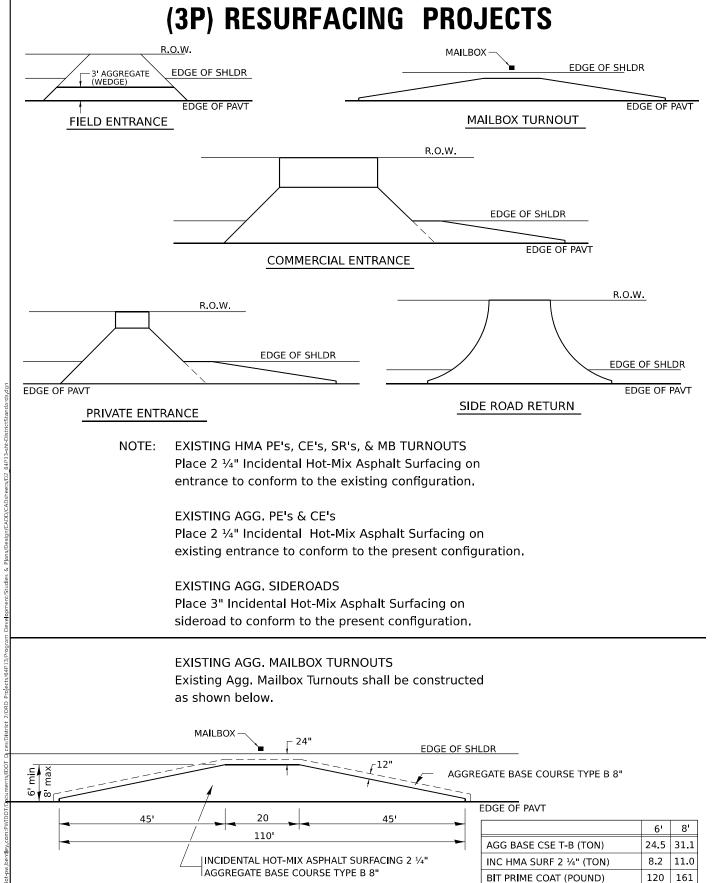

SAFETY EDGE (3P PROJECTS)

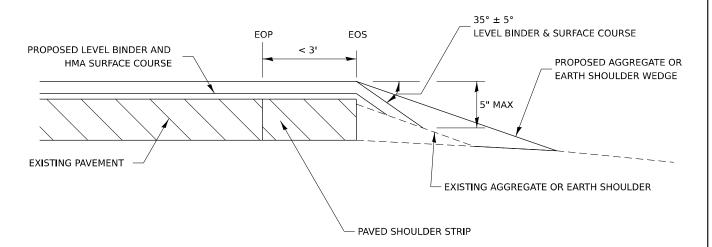

NO MILLING: ADJACENT SHOULDER FLUSH WITH OR LOWER THAN EXISTING PAVEMENT

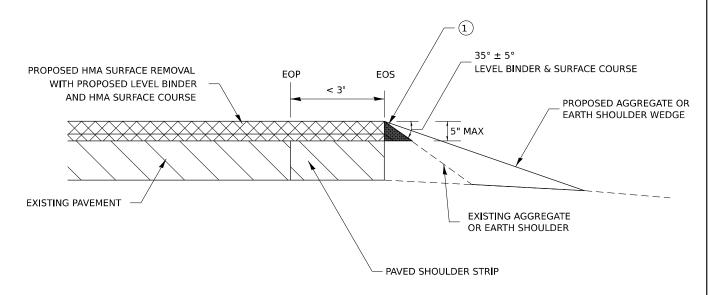

MILLING: WITH ADJACENT SHOULDER FLUSH WITH OR HIGHER THAN MILLED SURFACE

DTES: THE DEVICE WHICH FORMS THE SAFETY EDGE SHALL
BE MOUNTED ON THE PAVER SCREED AGAINST THE
END GATE AND SHALL BE REMOVABLE OR BE ABLE
TO BE LIFTED WHEN NOT IN USE. THE DEVICE SHALL
BE DESIGNED TO MAINTAIN CONTACT WITH SURFACE
OF THE SHOULDER AND ALLOW AUTOMATIC
TRANSITION TO CROSS ROADS, DRIVEWAYS AND
OBSTRUCTIONS. THE DEVICE SHALL ALSO CONSTRAIN
THE HMA MATERIAL AND INCREASE THE
CONSOLIDATION OF THE EXTRUDED PROFILE. THE USE
OF A CONVENTIONAL SINGLE PLATE STRIKE-OFF WILL
NOT BE ALLOWED.

ROLLERS WILL NOT BE ALLOWED ON THE SLOPED FACE OF THE SAFETY EDGE.

REVISED - 1-05-16

REVISED - 10-11-13

SCALE:

1 PRIOR TO THE PLACEMENT OF THE HMA SAFETY EDGE, IF THE ADJACENT AGGREGATE OR EARTH SHOULDER IS HIGHER THAN THE MILLED SURFACE, THE AREA REQUIRED FOR PLACEMENT OF THE SAFETY EDGE SHALL BE BROUGHT FLUSH WITH THE MILLED SURFACE IN A MANNER APPROVED BY THE ENGINEER. THIS WORK SHALL BE CONSIDERED INCLUDED IN THE CONTRACT UNIT PRICE PER TON FOR HOT-MIX ASPHALT SURFACE COURSE OF THE TYPE SPECIFIED.

REGION 2/DISTRICT 2 STANDARDS						F.A.P. RTE	F.A.P. SECTION CO		COUNTY	TOTAL SHEETS	SHEET NO.	1	
						*	(2, 3, 4) RS-7 & 115SW		OGLE	132	129		
							*316 & 5	49		CONTRACT	NO. 64	4P13	
:	SHEET	OF	SHEETS	STA.	TO STA.			ILLINOIS	FED. AI	D PROJECT			

DESIGNED

DRAWN

HECKED

REVISED

REVISED

REVISED

SER NAME = Andrew.p.dewey

PLOT DATE = 1/24/2025

REVISED - 7-21-15


REVISED - 6-27-14


REVISED - 10-21-08

STATE OF ILLINOIS

DEPARTMENT OF TRANSPORTATION

PIPE HANDRAILS FOR STEPS

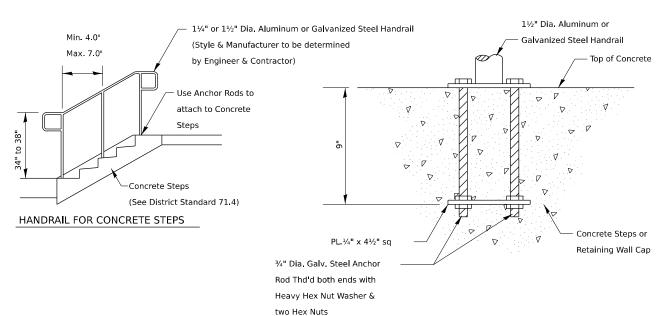

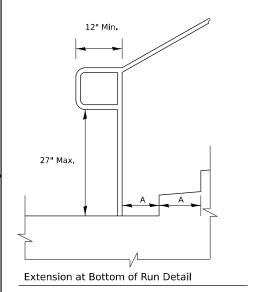

ANCHOR ROD DETAIL (Included in the cost of Hand or Safety Rail) Extension at Top of Run Detail

Stairways shall have continuous handrails both sides of all stairs.

The inside handrail on switchback or dogleg stairs shall

Gripping surfaces shall be uninterrupted by newel posts, other construction elements, or obstructions.

Ends of handrail shall be either rounded or returned smoothly to


Hand & safety rails shall not rotate within their fittings.

The clear space between hanrails and any wall shall be 11/21

Handrail shall conform to Section 509 with the exception that all pipe and connections shall be welded galvanized or aluminum according to Article 1006.30, or 1006.34.

The diameter of the gripping surface of the handrail shall be


This work shall be paid for at the contract unit price per FOOT for PIPE HANDRAIL.

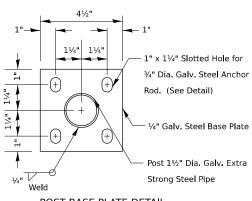


POST BASE PLATE DETAIL

(Included in the cost of Hand or Safety Rail)


PERMANENT SURVEY MARKERS, TYPE II

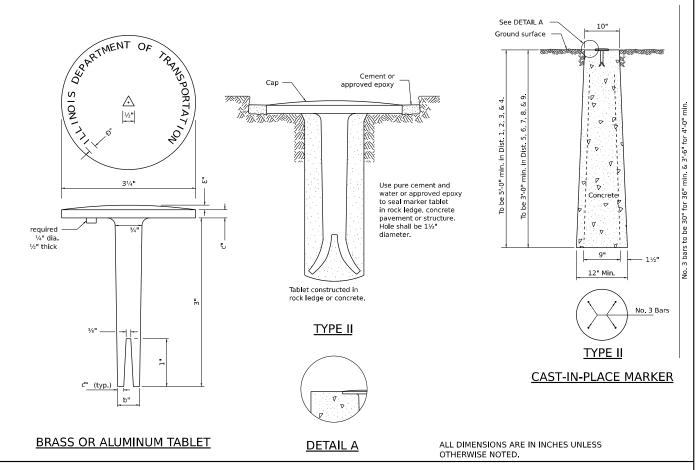

WITNESS MARKER FOR PERMANENT SURVEY MARKERS, TYPE II

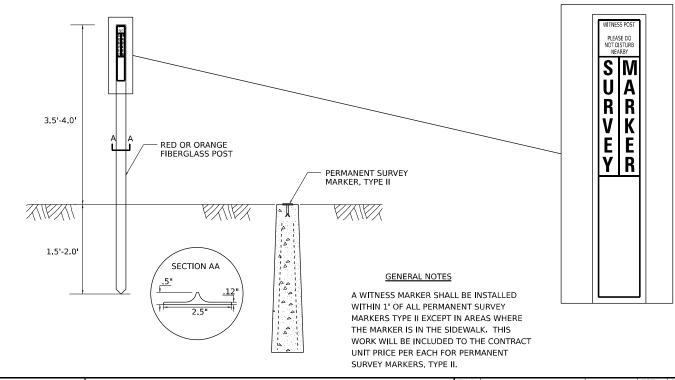

TRAFFIC CONTROL AND PROTECTION AT TURN BAYS (TO REMAIN OPEN TO TRAFFIC)

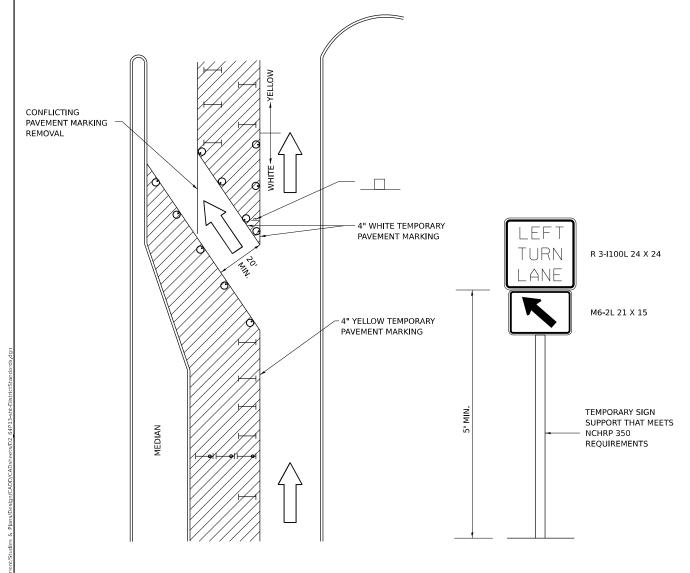

LEGEND

WORK AREA



LANE OPEN TO TRAFFIC



TYPE I OR II BARRICADE OR DRUM WITH FLASHING BURNING LIGHT



SER NAME = Andrew.p.dewey

DRUM OR BARRICADE WITH STEADY BURN LIGHT



REVISED - 10-14-11

SIGN (SEE DETAIL)

TYPE I OR II CHECK BARRICADE WITH STEADY LIGHT BURN

GENERAL NOTES

CONES MAY BE SUBSTITUTED FOR BARRICADES OR DRUMS AT HALF THE SPACING DURING DAY OPERATIONS. CONES SHALL BE A MINIMUM OF 28 IN HEIGHT.

STEADY BURNING LIGHTS WILL NOT BE REQUIRED ON BARRICADES OR DRUMS FOR DAY OPERATIONS. ALL LIGHTS WILL BE MONODIRECTIONAL.

TEMPORARY PAVEMENT MARKING SHALL BE PLACED THROUGHOUT THE BARRICADED AREA OF EACH BAY WHERE THE CLOSURE TIME IS GREATER THAN FOURTEEN DAYS.

THIS APPLICATION ALSO APPLIES WHEN WORK IS BEING PERFORMED IN THE RIGHT LANE(S) AND THE RIGHT TURN BAY IS TO REMAIN OPEN. UNDER THIS CONDITION, "RIGHT TURN LANE" R3-100 24 X 24 AND M6-2R 21 X 15 SHALL BE USED.

THESE CONTROLS SHALL SUPPLEMENT MAINLINE TRAFFIC CONTROL FOR LANE CLOSURES. LONGITUDINAL DIMENSIONS MAY BE ADJUSTED TO FIT FIELD CONDITIONS.

TRAFFIC CONTROL AND PROTECTION AT TURN BAYS (TO REMAIN OPEN TO TRAFFIC) SHALL BE INCLUDED IN THE COST SPECIFIED TRAFFIC CONTROL STANDARDS OR ITEMS.

ALL DIMENSIONS ARE IN INCHES UNLESS OTHERWISE NOTED.

REVISED

REVISED

CATCH BASIN OR INLETS TO BE ADJUSTED OR RECONSTRUCTED

(DETAILS FOR CURB & GUTTER REPLACEMENT)

CONCRETE CURB AND GUTTER SHALL BE CONSTRUCTED IN ACCORDANCE WITH SECTION 606 OF THE STANDARD SPECIFICATIONS, SUPPLEMENTAL SPECIFICATIONS, STANDARD 606001 AND THIS DRAWING.

CLASS SI CONCRETE SHALL BE USED THROUGHOUT. A HOLE 1-1/2 IN DIAMETER AND 9 DEEP SHALL BE DRILLED IN THE EXISTING CONCRETE CURB AS SHOWN. A 1-1/4 X 18 SMOOTH DOWEL BAR SHALL BE GROUTED IN THE HOLE LONGITUDINALLY.

JOINTS OF A TYPE SIMILAR TO THAT IN THE UNDER-LYING PAVEMENT (EXPANSION OR CONTRACTION) SHALL BE INSTALLED IN THE CONCRETE CURB IN ALIGNMENT WITH THE JOINTS IN THE PAVEMENT.

THE PROPOSED CONFIGURATION OF THE CURB AND GUTTER SHALL MATCH THAT REMOVED.

THE LOCATION OF THE DOWEL BAR SHALL BE DETERMINED BY THE ENGINEER.

ALL EXISTING TIE BARS IN EDGE OF PAVEMENT SLAB THRU REPLACEMENT AREA SHALL BE CUT OFF.

THE WORK SHALL BE DONE IN ACCORDANCE WITH SECTION 602 OF THE STANDARD SPECIFICATIONS AND INCLUDES THE REMOVAL AND REPLACEMENT OF SOD, CONCRETE PAVEMENT AND/OR CURB AND GUTTER ADJACENT TO CATCH BASINS OR INLETS TO BE ADJUSTED OR RECONSTRUCTED AND SHALL BE INCLUDED IN THE PAY ITEM OF CATCH BASINS OR INLETS TO BE ADJUSTED OR RECONSTRUCTED AS SECURIOR


REVISED - 9-30-11

REVISED - 10-03-11

STATE OF ILLINOIS

DEPARTMENT OF TRANSPORTATION


94.2

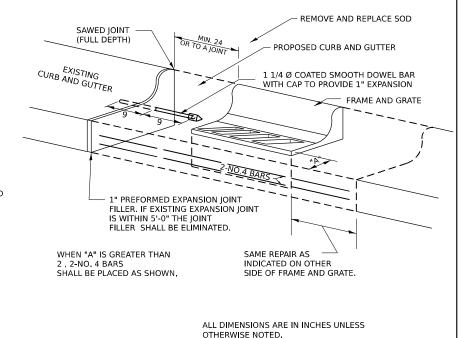

CATCH BASIN OR INLETS TO BE ADJUSTED OR RECONSTRUCTED

17.4

PAVEMENT PATCHING FOR HOT-MIX ASPHALT SURFACED PAVEMENT

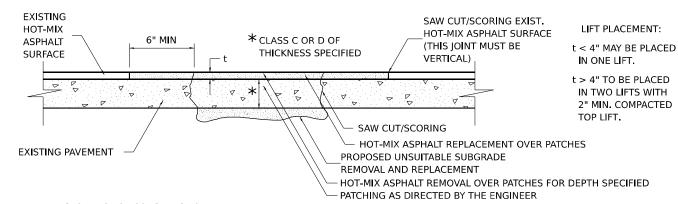

SEQUENCE OF CONSTRUCTION:

- 1. REMOVE THE EXISTING HOT-MIX ASPHALT SURFACE.
- RESIDENT ENGINEER WILL DETERMINE IF LOCATION IS TO BE PATCHED OR TO ONLY REPLACE HOT-MIX ASPHALT SURFACE.
- REMOVE AND REPLACE FULL DEPTH PATCHES AT LOCATIONS DIRECTED BY THE ENGINEER.
- REPLACE HOT-MIX ASPHALT SURFACE OVER FULL DEPTH PATCHES AND AT LOCATIONS OF HOT-MIX ASPHALT SURFACE REMOVAL.

GENERAL NOTES:

 FOR BASIS OF PAYMENT: SEE THE RECURRING SPECIAL PROVISION "PATCHING WITH HOT-MIX ASPHALT OVERLAY REMOVAL".


ALL DIMENSIONS ARE IN INCHES UNLESS OTHERWISE NOTED.

DESIGNED

DRAWN

HECKED

SUBGRADE REPLACEMENT

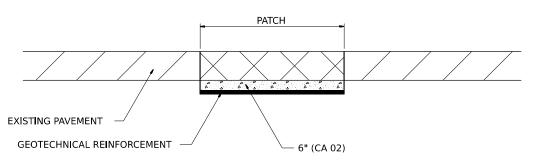

NOTES:

THE CA 02 SHALL BE COMPACTED IN A MANNER APPROVED BY THE ENGINEER. IF THE MOISTURE CONTENT OF THE MATERIAL IS SUCH THAT COMPACTION SATISFACTORY TO THE ENGINEER CANNOT BE OBTAINED, SUFFICIENT WATER SHALL BE ADDED SO THAT SATISFACTORY COMPACTION CAN BE OBTAINED.

THE CA 02 SHALL BE PAID FOR AT THE CONTRACT UNIT PRICE PER CU YD FOR AGGREGATE SUBGRADE IMPROVEMENT WHICH SHALL ALSO INCLUDE ALL EARTH EXCAVATION.

THE GEOTECHNICAL REINFORCEMENT WILL BE PAID FOR AT THE CONTRACT UNIT PRICE PER SQ YD FOR GEOTECHNICAL REINFORCEMENT.

ALL DIMENSIONS ARE IN INCHES UNLESS OTHERWISE NOTED.

REVISED - 3-13-13

USER NAME = Andrew.p.dewey	DESIGNED -	REVISED -
	DRAWN -	REVISED -
PLOT SCALE = \$SCALES	CHECKED -	REVISED -
PLOT DATE = 1/24/2025	DATE -	REVISED -

STATE OF ILLINOIS
DEPARTMENT OF TRANSPORTATION