

| | | | | |
|-----------------------------|--------------|--------|--------------|-----------|
| F.A.P. RTE. | SECTION | COUNTY | TOTAL SHEETS | SHEET NO. |
| 683 | 0303-474HB-R | COOK | 369 | 1 |
| ILLINOIS CONTRACT NO. 60F63 | | | | |

* 368+1 = 369

D-91-177-09

PROJECT LOCATED IN CITY OF CHICAGO

FOR INDEX OF SHEETS, SEE SHEET NO. 2

DESIGN DESIGNATION

DESIGN DESIGNATION:
 RAMP A 1200(40) INTERSTATE 16.30(PCC-20)
 RAMP C 700(40) INTERSTATE 10.87(PCC-20)

| | ADT(2008) | ADT(2040) | DESIGN SPEED | POSTED SPEED |
|------------|-----------|-----------|--------------|--------------|
| RAMP A | 23,230 | 24,000 | 35 | 30 |
| RAMP C | 15,285 | 16,000 | 35 | 30 |
| I-90/94 EB | 118,490 | 124,000 | 50 | 45 |
| I-90/94 WB | 109,010 | 136,000 | 50 | 45 |


DESCRIPTION OF PROJECT

RAMP C OVER I-90/94
 SN 016-1003 (EX.)
 SN 016-1322 (PROP.)
 STRUCTURE REMOVAL AND REPLACEMENT
 LENGTH=305'-4 5/8"

RAMP C OVER RAMP D,
 SN 016-1003 (EX.)
 SN 016-1323 (PROP.)
 STRUCTURE REMOVAL AND REPLACEMENT
 LENGTH=89'-6 1/2"

RAMP C OVER RAMP A,
 SN 016-2573 (EX.)
 STRUCTURE MODIFICATIONS AND PPC DECK BEAM REPLACEMENT
 LENGTH=307'-7"

RETAINING WALL ALONG RAMP C,
 SN 016-2014 (PROP.)
 STA 120+00 TO STA 123+60,
 LENGTH=89'-6 1/2"

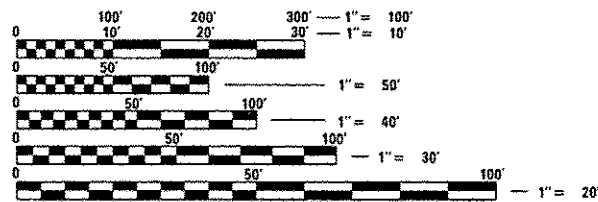

FULL SIZE PLANS HAVE BEEN PREPARED USING STANDARD ENGINEERING SCALES. REDUCED SIZED PLANS WILL NOT CONFORM TO STANDARD SCALES. IN MAKING MEASUREMENTS ON REDUCED PLANS, THE ABOVE SCALES MAY BE USED.

C.U.A.N.
 CHICAGO UTILITY ALERT NETWORK
 (312) 744-7000

PROJECT ENGINEER: ADDIS ABEBAW
 PROJECT MANAGER: BRIAN KUTTAB

CONTRACT NO. 60F63

DEPARTMENT OF TRANSPORTATION

DIVISION OF HIGHWAYS

PROPOSED
 HIGHWAY PLANS

F.A.I. 90 /94 (KENNEDY EXPRESSWAY) AT OHIO STREET

SECTION: 0303-474HB-R

PROJECT: NHPP-0094(401)

BRIDGE REHABILITATION AND RAMP CONSTRUCTION

COOK COUNTY

C-91-177-09

BEGIN IMPROVEMENTS
 RAMP C
 STA. 103+00


RAMP A
 OVER RAMP C

RAMP C
 OVER I-90/94

RAMP C OVER
 RAMP D

RETAINING WALL
 ALONG RAMP C

END IMPROVEMENTS
 RAMP C
 STA. 127+90.44

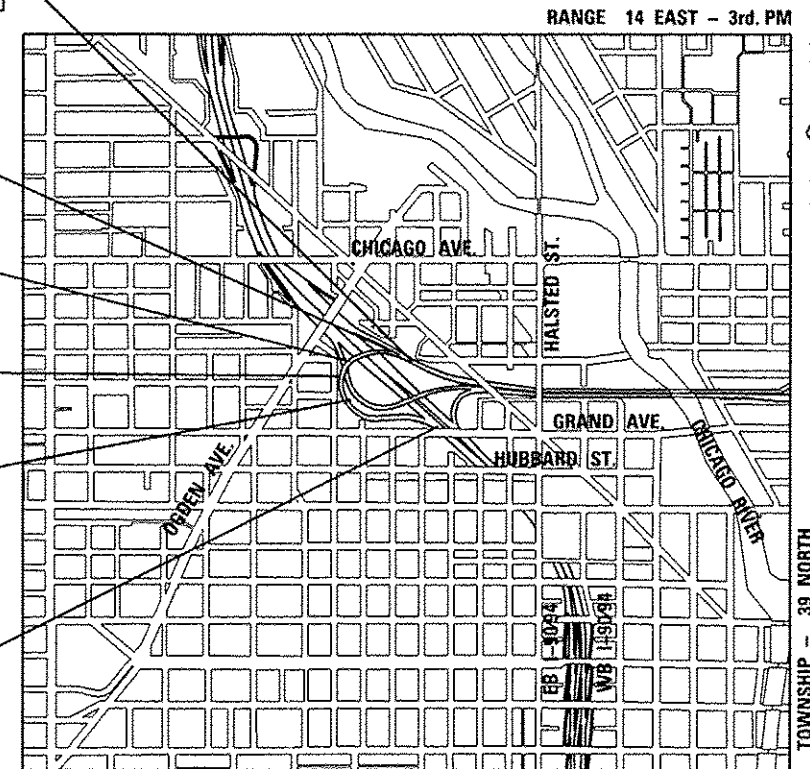

LOCATION MAP
 (SCALE: 1" = 1/2 MI)

CHICAGO

PROJECT GROSS LENGTH = 2490.44 FT. = 0.471674 MILE


PROJECT NET LENGTH = 2490.44 FT. = 0.471674 MILE




LOCATION OF SECTION INDICATED THUS: -




COLLINS ENGINEERS, INC.
 MATTHEW G. REMPFER
 NO. 062-054553
 EXPIRES 11-30-2013
 FOR DRAWINGS:

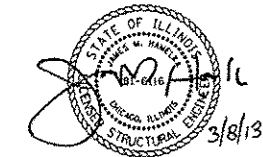

COLLINS ENGINEERS, INC.
 JAMES M. HAMELKA
 NO. 81-6116
 EXPIRES 11-30-2014
 FOR DRAWINGS:

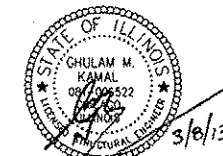

GHULAM MASOOM KAMAL, S.E.
 IL LIC. NO. 081-006522
 EXPIRES 11-30-2014
 FOR DRAWINGS:

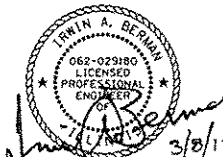

IRWIN A. BERMAN
 NO. 062-029180
 EXPIRES 11-30-2013
 FOR DRAWINGS:

COLLINS ENGINEERS
 123 N. WACKER DR.,
 SUITE 900
 CHICAGO, IL 60606
 (312) 704-9300
 ILLINOIS PROFESSIONAL DESIGN FIRM No. 184-000993

STATE OF ILLINOIS
 DEPARTMENT OF TRANSPORTATION
 DIVISION OF HIGHWAYS

SUBMITTED *March 11 2013*

John Fortman
 DEPUTY DIRECTOR OF HIGHWAYS, REGION ENGINEER

May 10 2013
John D. Boranzelli, P.E.
 ENGINEER OF DESIGN AND ENVIRONMENT

May 10 2013
Omer Osman, P.E.
 DIRECTOR OF HIGHWAYS, CHIEF ENGINEER

PRINTED BY THE AUTHORITY
 OF THE STATE OF ILLINOIS

DISTRICT 1 DESIGN /CONSULTANT SERVICES: BRIAN KUTTAB, P.E. (847)705-4431 SCHAUMBURG, ILLINOIS

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LIST OF STATE STANDARDS

| STD NO. | DESCRIPTION |
|-----------|--|
| 000001-06 | STANDARD SYMBOLS, ABBREVIATIONS AND PATTERNS |
| 001001-02 | AREAS OF REINFORCEMENT BARS |
| 001006 | DECIMAL OF AN INCH AND OF A FOOT |
| 280001-07 | TEMPORARY EROSION CONTROL SYSTEMS |
| 420001-07 | PAVEMENT JOINTS |
| 420101-04 | 24 FT JOINTED PAVEMENT |
| 420111-03 | PCC PAVEMENT ROUNDOUTS |
| 420206-08 | ENTRANCE RAMP TERMINAL (JOINTED PCC RAMP PAVEMENT ADJACENT TO CRC MAINLINE PAVEMENT) |
| 420401-09 | BRIDGE APPROACH PAVEMENT CONNECTOR |
| 421001-02 | BAR REINFORCEMENT FOR CRC PAVEMENT |
| 442001-04 | CLASS A PATCHES |
| 483001-04 | PCC SHOULDER |
| 515001-03 | NAME PLATE FOR BRIDGES |
| 542301-03 | PRECAST REINFORCED CONCRETE FLARED END SECTION |
| 601001-04 | SUB-SURFACE DRAINS |
| 601101-01 | CONCRETE HEADWALL FOR PIPE DRAIN |
| 602001-02 | CATCH BASIN, TYPE A |
| 602301-03 | INLET, TYPE A |
| 602401-03 | MANHOLE, TYPE A |
| 602601-02 | PRECAST REINFORCED CONCRETE FLAT SLAB TOP |
| 602701-02 | MANHOLE STEPS |
| 604001-03 | FRAME AND LIDS, TYPE 1 |
| 604006-04 | FRAME AND GRATE, TYPE 3 |
| 604036-02 | GRATE, TYPE 8 |
| 604046-02 | FRAME AND GRATE, TYPE 10 |
| 604091-02 | FRAME AND GRATE, TYPE 24 |
| 604101-01 | MEDIAN INLET FOR 24" (600 MM) REINFORCED CONCRETE PIPE |
| 606001-04 | CONCRETE CURB TYPE B AND COMBINATION CONCRETE CURB AND GUTTER |
| 606201-02 | TYPE 8 GUTTER (INLET, OUTLET, AND ENTRANCE) |
| 609006-05 | BRIDGE APPROACH PAVEMENT (DRAIN DETAIL) |
| 630001-10 | STEEL PLATE BEAM GUARDRAIL |
| 630301-06 | SHOULDER WIDENING FOR TYPE 1 (SPECIAL) GUARDRAIL TERMINALS |
| 631031-11 | TRAFFIC BARRIER TERMINAL, TYPE 6 |
| 635001-01 | DELINEATORS |
| 635006-03 | REFLECTOR AND TERMINAL MARKER PLACEMENT |
| 635011-02 | REFLECTOR MARKER AND MOUNTING DETAILS |
| 637006-03 | CONCRETE BARRIER 42 IN. (1065 MM) HEIGHT |
| 642001-02 | SHOULDER RUMBLE STRIPS, 16 IN. |
| 643001-01 | SAND MODULE IMPACT ATTENUATORS |
| 664001-02 | CHAIN LINK FENCE |
| 701101-03 | OFF-ROAD OPERATIONS, MULTILANE, 15' (4.5 M) TO 24" (600 MM) FROM PAVEMENT EDGE |
| 701106-02 | OFF-ROAD OPERATIONS, MULTILANE, MORE THAN 15' (4.5 M) AWAY |
| 701301-04 | LANE CLOSURE, 2L, 2W, SHORT TIME OPERATIONS |
| 701311-03 | LANE CLOSURE, 2L, 2W, MOVING OPERATIONS - DAY ONLY |
| 701331-04 | LANE CLOSURE, 2L, 2W, WITH RUN-AROUND, FOR SPEEDS > 45 MPH |
| 701400-06 | APPROACH TO LANE CLOSURE, FREEWAY/EXPRESSWAY |
| 701401-07 | LANE CLOSURE, FREEWAY/EXPRESSWAY |
| 701411-08 | LANE CLOSURE, MULTILANE, AT ENTRANCE OR EXT RAMP, FOR SPEEDS > 45 MPH |
| 701426-05 | LANE CLOSURE, MULTILANE, INTERMITTANT OR MOVING OPERATIONS, FOR SPEEDS >= 45 MPH |
| 701446-04 | TWO LANE CLOSURE, FREEWAY/EXPRESSWAY |
| 701901-02 | TRAFFIC CONTROL DEVICES |
| 704001-07 | TEMPORARY CONCRETE BARRIER |
| 720001-01 | SIGN PANEL MOUNTING DETAILS |
| 720006-03 | SIGN PANEL ERECTION DETAILS |
| 720011-01 | METAL POSTS FOR SIGNS, MARKERS AND DELINEATORS |
| 728001-01 | TELESCOPING STEEL SIGN SUPPORT |
| 729001-01 | APPLICATIONS OF TYPES A AND B METAL POSTS (FOR SIGNS & MARKERS) |
| 731001-01 | BASE FOR TELESCOPING STEEL SIGN SUPPORT |
| 780001-03 | TYPICAL PAVEMENT MARKINGS |
| 781001-03 | TYPICAL APPLICATIONS RAISED REFLECTIVE PAVEMENT MARKERS |
| 814001-02 | HANDHOLES |
| 814006-02 | DOUBLE HANDHOLES |

LIST OF DISTRICT ONE DETAILS

| STD NO. | DESCRIPTION |
|---------|--|
| BD07 | STORM SEWER CONNECTION TO EXISTING SEWER |
| BD27 | CONCRETE BARRIER TRANSITION, GENERAL DETAILS AND CONCRETE BARRIER BASE |
| BD48 | PCC PAVEMENT ROUNDOUTS AT CURB & GUTTER |
| BD49 | DETAIL OF C.L. SAWCUT 4.9 m (16') & VAR. JOINTED PCC PAVT. FOR RAMPS |
| BD51 | BENCHING CONSTRUCTION DETAIL |
| TC08 | ENTRANCE AND EXT RAMP CLOSURE DETAILS |
| TC09 | FREEWAY SINGLE AND MULTI LANE WEAVE |
| TC11 | RAISED REFLECTIVE PAVEMENT MARKERS (SNOW PLOW RESISTANT) |
| TC12 | MULTI-LANE FREEWAY PAVEMENT MARKING (2 SHEETS) |
| TC16 | PAVEMENT MARKING LETTERS AND SYMBOLS FOR TRAFFIC STAGING |
| TC17 | TRAFFIC CONTROL FOR SHOULDER CLOSURES AND PARTIAL RAMP CLOSURES |
| TC18 | SIGNING FOR FLAGGING OPERATIONS AT WORK ZONE OPENINGS |
| TC21 | DETOUR SIGNING FOR CLOSING STATE HIGHWAYS |
| TC24 | CITY OF CHICAGO TYPICAL PAVEMENT MARKINGS (2 SHEETS) |
| TC27 | MILE POST MARKERS - GORE SIGNS - MAJOR GUIDE SIGN LAYOUT - ARROWS |

FILE NAME: I:\2008 - 194 at Ohio Street\1400\0000 SHEETS\016\016-1322-01.dwg



| | | |
|---------------------------|-------------|------------|
| USER NAME: rgeall | DESIGNED: - | REVISED: - |
| PLOT SCALE: 2.0000' / in. | DRAWN: - | REVISED: - |
| PLOT DATE: 3/25/2013 | CHECKED: - | REVISED: - |
| | DATE: - | REVISED: - |

STATE OF ILLINOIS
DEPARTMENT OF TRANSPORTATION

| | | | |
|---|---------------------|--------------|--|
| I-90/94 AT OHIO STREET INDEX OF SHEETS AND HIGHWAY STANDARDS | | | |
| SCALE: | SHEET NO. OF SHEETS | STA. TO STA. | |

| | | | | |
|--------------------------------|--------------|---------|--------------------|------------|
| F.A.I. RTE.: | SECTION: | COUNTY: | TOTAL SHEETS: | SHEET NO.: |
| 90/94 | 0303-474HB-R | COOK | 368 | 2 |
| FED. ROAD DIST. NO. 1 ILLINOIS | | | CONTRACT NO. 60F63 | |

GENERAL NOTES

- 1 THE CONTRACTOR SHALL MAINTAIN ALL ROADWAYS OPEN TO TRAFFIC AS SHOWN ON THE MAINTENANCE OF TRAFFIC PLANS.
- 2 BEFORE STARTING ANY EXCAVATION, THE CONTRACTOR SHALL CALL J.U.L.I.E. AT (800) 892-0123 OR 811 FOR FIELD LOCATIONS OF BURIED ELECTRIC, TELEPHONE, AND GAS UTILITIES (48 HOUR NOTICE IS REQUIRED).
- 3 10 FOOT TRANSITIONS SHALL BE USED TO MATCH PROPOSED CURB AND GUTTER AND MEDIAN ITEMS OF WORK TO EXISTING CURB AND GUTTER AND MEDIAN ITEMS IN THE FIELD, UNLESS OTHERWISE SHOWN. THE TRANSITIONS SHALL BE PAID FOR AT THE CONTRACT UNIT PRICE FOR THE PROPOSED LARGER ITEM OF SPECIFIED WORK.
- 4 THE CONTRACTOR SHALL COORDINATE CONSTRUCTION ACTIVITIES WITH AFFECTED UTILITY COMPANIES AND MUNICIPALITIES
- 5 THE CONTRACTOR WILL NOT BE ALLOWED TO SET UP A YARD OR FIELD OFFICE ON STATE RIGHT-OF-WAY OR PROPERTY WITHOUT PRIOR WRITTEN PERMISSION FROM THE ENGINEER.
- 6 BARRIER WALL MARKERS, TYPE C SHALL BE INSTALLED ON MEDIAN CONCRETE BARRIER WALL AND PARAPETS AT A HEIGHT OF 28 INCHES FROM THE TOP OF SHOULDER TO THE BOTTOM OF THE REFLECTOR AND SPACED AT 50 FEET CENTER-TO-CENTER ON CURVES AND 100 FEET CENTER-TO-CENTER ON TANGENTS OR AS DIRECTED BY THE TRAFFIC OPERATIONS FIELD ENGINEER. THE BARRIER WALL MARKERS SHALL BE INSTALLED PRIOR TO OPENING THE NEW PAVEMENT TO TRAFFIC.
- 7 A BOXED NOTE INDICATES AN ITEM OF WORK THAT IS NOT PAID FOR SEPARATELY, BUT IS PAID FOR AS PART OF ANOTHER ITEM LISTED IN THE SUMMARY OF QUANTITIES.
- 7A NIGHT OPERATIONS: WHEN ARTIFICIAL LIGHTING IS UTILIZED IN NIGHT OPERATIONS, THE CONTRACTOR SHALL EXERCISE THE UTMOST PRECAUTION IN PREVENTING ADVERSE VISIBILITY TO THE MOTORING PUBLIC AS WELL AS THE ADJOINING RESIDENTIAL AREAS.
- 8 USE NO.8 EPOXY-COATED TIE BARS CONFORMING TO ARTICLE 1006.1 (BX2) OF THE STANDARD SPECIFICATIONS FOR LONGITUDINAL CONSTRUCTION JOINT, GROUTED-IN-PLACE TIE BARS, AS SHOWN ON STATE STANDARD 420001 AND FOR TYING PCC PAVEMENT WIDENING TO EXISTING CONCRETE PAVEMENT AS SHOWN ON THE PLANS. THE COST OF THIS ITEM SHALL BE INCLUDED IN THE COST OF THE PAVEMENT ITEMS BEING CONSTRUCTED.
- 9 ALL ELEVATIONS REFER TO U.S.G.S. MEAN SEA LEVEL DATUM.
- 10 BEFORE ORDERING STORM SEWERS, CATCH BASINS, PIPE CULVERTS, PIPE DRAINS, MANHOLES, INLETS, AND SCUPPERS, THE CONTRACTOR SHALL REVIEW THE EXISTING FIELD CONDITIONS AND THE DRAINAGE SCHEDULES FOUND IN THE PLANS FOR THE EXACT LENGTH AND QUANTITY REQUIRED.
- 11 THE CONTRACTOR SHALL MAINTAIN THE SURFACE DRAINAGE OF ALL ROADWAYS DURING CONSTRUCTION OF THIS PROJECT. WHEN EXISTING DRAINAGE FACILITIES ARE DISTURBED, THE CONTRACTOR SHALL PROVIDE AND MAINTAIN TEMPORARY OUTLETS AND CONNECTIONS FOR ALL PRIVATE OR PUBLIC DRAINS, SEWERS, INLETS, AND CATCH BASINS. THE CONTRACTOR SHALL PROVIDE FACILITIES TO TAKE IN ALL STORM WATER, WHICH WILL BE RECEIVED BY THESE DRAINS AND SEWERS AND DISCHARGE SAME. THE CONTRACTOR SHALL PROVIDE AND MAINTAIN A TEMPORARY OUTLET AND BE PREPARED AT ALL TIMES TO DISPOSE OF THE WATER RECEIVED FROM ALL THESE TEMPORARY CONNECTIONS UNTIL INSTALLATION IS COMPLETE, INCLUDING PAVEMENT. THIS WORK SHALL NOT BE PAID FOR DIRECTLY BUT SHALL BE CONSIDERED INCLUDED IN THE CONTRACT. COORDINATION WITH ALL AGENCIES INVOLVED IS REQUIRED.
- 12 NOT USED.
- 13 AGGREGATE SUBGRADE IMPROVEMENT HAS BEEN PROVIDED FOR USE AT THE LOCATIONS INDICATED FOR SOILS THAT TEND TO BE UNSUITABLE OR UNSTABLE. THE ACTUAL NEED FOR THE REMOVAL AND REPLACEMENT WITH AGGREGATE SUBGRADE IMPROVEMENT WILL BE DETERMINED IN THE FIELD AT THE TIME OF CONSTRUCTION BY THE GEOTECHNICAL ENGINEER. ALL POTENTIALLY UNSTABLE SOILS SHOULD BE TESTED WITH A STATIC CONE PENETROMETER AND TREATED IN ACCORDANCE WITH ARTICLE 301.04 AND THE IDOT SUBGRADE STABILITY MANUAL. IF UNSTABLE AND/OR UNSUITABLE MATERIAL IS ENCOUNTERED, THE SOIL SHALL BE REMOVED AND REPLACED WITH AGGREGATE SUBGRADE IMPROVEMENT OR EMBANKMENT AS DETERMINED BY THE GEOTECHNICAL ENGINEER. IF UNSTABLE AND/OR UNSUITABLE MATERIAL IS NOT ENCOUNTERED, THEN THE QUANTITY SHALL BE DEDUCTED AND NO ADDITIONAL COMPENSATION WILL BE DUE TO THE CONTRACTOR.

GENERAL NOTES (CONT.):

- 14 DURING CONSTRUCTION OPERATIONS, IF ANY LOOSE MATERIAL IS DEPOSITED IN THE FLOW LINE OF DRAINAGE STRUCTURES SUCH THAT THE NATURAL FLOW OF WATER IS OBSTRUCTED, THE MATERIAL SHALL BE REMOVED AT THE CLOSE OF EACH WORKING DAY, AT THE CONCLUSION OF CONSTRUCTION OPERATIONS, ALL UTILITY STRUCTURES SHALL BE FREE FROM DUST AND DEBRIS. THE WORK SPECIFIED ABOVE WILL NOT BE PAID SEPARATELY BUT SHALL BE INCLUDED IN THE COST OF THE CONTRACT.
- 15 THE CONTRACTOR SHALL CONTACT THE IDOT TRAFFIC CONTROL SUPERVISOR, AT 847-705-4155 A MINIMUM OF 72 HOURS PRIOR TO THE PLACEMENT OF ANY TEMPORARY TRAFFIC CONTROL DEVICES.
- 16 THE RESIDENT ENGINEER SHALL CONTACT THE AREA TRAFFIC FIELD ENGINEER AT (847) 705-4412 A MINIMUM OF TWO (2) WEEKS PRIOR TO PLACING THE PERMANENT PAVEMENT MARKINGS.
- 17 THE CONTRACTOR SHALL USE CARE IN GRADING OR EXCAVATING NEAR ANY AND ALL EXISTING ITEMS THAT WILL NOT BE REMOVED. ANY DAMAGE DONE TO EXISTING ITEMS BY THE CONTRACTOR SHALL BE REPAIRED OR REPLACED TO THE SATISFACTION OF THE ENGINEER AT THE CONTRACTOR'S OWN EXPENSE.
- 18 ANY ABANDONED UTILITY OR SEWER ENCOUNTERED DURING CONSTRUCTION OR ANY EXISTING UTILITY OR SEWER ABANDONED AS PART OF THE CONSTRUCTION THAT IS NOT BEING FILLED WITH C.L.S.M., AS PER PLAN, SHALL BE PLUGGED AS DIRECTED BY THE ENGINEER AND ABANDONED IN PLACE. THIS WORK SHALL BE INCLUDED IN THE COST OF THE CONTRACT.
- 19 THE CONTRACTOR SHALL BE RESPONSIBLE FOR THE PROTECTION OF ALL UNDERGROUND OR SURFACE UTILITIES EVEN THOUGH THEY MAY NOT BE SHOWN ON THE PLANS. ANY UTILITY THAT IS DAMAGED DURING CONSTRUCTION SHALL BE REPAIRED OR REPLACED TO THE SATISFACTION OF THE ENGINEER. THIS WORK SHALL BE AT THE CONTRACTOR'S EXPENSE.
- 20 ANY EXISTING OR PROPOSED STORM SEWER DAMAGED BY THE CONTRACTOR DURING CONSTRUCTION SHALL BE REPLACED TO THE SATISFACTION OF THE ENGINEER AT THE CONTRACTOR'S EXPENSE.
- 21 THE CONTRACTOR SHALL TAKE ALL NECESSARY SAFETY PRECAUTIONS TO PROTECT AND PROVIDE ACCESS TO ABUTTING PROPERTY, UTILITIES, PEDESTRIANS, AND VEHICULAR TRAFFIC.
- 22 FOR WORK OUTSIDE THE LIMITS OF BRIDGE APPROACH PAVEMENT, ALL REFERENCES IN THE HIGHWAY STANDARDS AND STANDARD SPECIFICATIONS FOR REINFORCEMENT, DOWEL BARS AND TIE BARS IN PAVEMENT, SHOULDERS, CURB, GUTTER, COMBINATION CURB AND GUTTER AND MEDIAN, AND CHAIR SUPPORTS FOR CRC PAVEMENT, SHALL BE EPOXY COATED, UNLESS NOTED ON THE PLAN.
- 23 THE CONTRACTOR SHALL USE CARE IN GRADING OR EXCAVATING NEAR ANY AND ALL EXISTING ITEMS WHICH WILL NOT BE REMOVED. ANY DAMAGE DONE TO EXISTING ITEMS BY THE CONTRACTOR SHALL BE REPAIRED BY THE CONTRACTOR AT THE CONTRACTOR'S EXPENSE.
- 24 AREAS TO BE SEEDED BETWEEN NOVEMBER 1 AND APRIL 1 SHALL REQUIRE DORMANT SEEDING WHICH SHALL BE INCLUDED IN THE COST OF SEEDING CLASS 2A.
- 25 THE CONTRACTOR SHALL TAKE ALL NECESSARY PRECAUTIONS FOR THE PROTECTION OF EXISTING PLANT MATERIAL FOR WHICH THE CONTRACT DOES NOT PROVIDE REMOVAL. THE PROTECTION OF EXISTING PLANT MATERIAL AND THE REPAIR OR REPLACEMENT OF EXISTING PLANT MATERIAL DAMAGED BY THE CONTRACTOR SHALL BE DONE IN ACCORDANCE WITH THE REQUIREMENTS OF SECTION 201 OF THE STANDARD SPECIFICATIONS.
- 26 LAYOUT OF LANDSCAPED AREAS WILL REQUIRE APPROVAL OF THE ENGINEER PRIOR TO SEEDING, AND PLANTING.
- 27 FOR STORM SEWER CONSTRUCTED UNDER THE ROADWAY, BACKFILLING METHODS TWO AND THREE AUTHORIZED UNDER THE PROVISIONS OF ARTICLE 550.07 OF THE STANDARD SPECIFICATIONS WILL NOT BE ALLOWED.
- 28 NOT USED.
- 29 ALL UTILITY LIDS UNDER TRAFFIC SHALL BE SECURED TO THE FRAMES. THE COST OF THIS WORK SHALL BE INCLUDED IN THE COST FOR TRAFFIC CONTROL AND PROTECTION (SPECIAL).
- 30 THE CONTRACTOR SHALL MAKE THEMSELVES AVAILABLE TO ATTEND MEETINGS WITH IDOT WITH IDOT ETP PERSONNEL. THIS WORK SHALL BE CONSIDERED INCIDENTAL TO THE COST OF THE CONTRACT.

GENERAL NOTES (CONT.):

- 31 THE DEPARTMENT HAS NOT OBTAINED ANY PERMITS FOR OFFSITE BORROW OR WASTE/USE (BWU) AREAS. PRIOR TO WORKING IN BWU AREAS, IF THE CONTRACTOR CHOOSES TO USE ACTIVITIES REQUIRING PERMITS IT IS THE CONTRACTOR'S RESPONSIBILITY TO SECURE THE PROPER PERMITS. IN ADDITION TO THE BORROW REVIEW (BOE 2289) AND USE/WASTE REVIEW (BOW 2290) SUBMITTALS, THE CONTRACTOR WILL NEED TO SUBMIT AN EROSION AND SEDIMENT CONTROL (ESC) PLAN FOR EVERY BWU SITE TO THE DEPARTMENT FOR ACCEPTANCE. GUIDELINES FOR ACCEPTABLE BWU PRACTICES CAN BE FOUND IN SECTION 11.5.A AND B OF THE SWPPP. THE COST OF ALL MATERIALS AND LABOR NECESSARY TO COMPLY WITH THE ABOVE PROVISIONS TO PREPARE AND IMPLEMENT ESC PLANS WILL NOT BE PAID FOR SEPARATELY, BUT SHALL BE CONSIDERED AS INCLUDED IN THE UNIT BID PRICES OF THE CONTRACT AND NO ADDITIONAL COMPENSATION WILL BE ALLOWED.
- 32 ALL PAVEMENT PATCHING LOCATIONS WILL BE DETERMINED BY THE ENGINEER IN THE FIELD.
- 33 THE CONTRACTOR WILL NOT BE ALLOWED TO USE ANY AREA AROUND THE PROJECT SITE AS A MATERIAL STAGING AREA WITHOUT PRIOR WRITTEN AUTHORIZATION FROM THE ENGINEER. A SUGGESTED LOCATION FOR STORAGE OF EXCAVATED MATERIALS IS SHOWN ON THE EROSION CONTROL PLANS. THIS LOCATION MAY BE ADJUSTED WITH PRIOR WRITTEN APPROVAL FROM THE ENGINEER. ALL DAMAGE TO EXISTING LANDSCAPING AS A RESULT OF MATERIAL STORAGE AND/OR STAGING GROUNDS SHALL BE REPAIRED BY THE CONTRACTOR AT HIS/HER OWN EXPENSE IN ACCORDANCE WITH NOTE 25.

CITY OF CHICAGO

- 1 BEFORE STARTING ANY EXCAVATION WITHIN THE CITY OF CHICAGO, THE CONTRACTOR SHALL CONTACT "C.U.A.N." (CHICAGO UTILITY ALERT NETWORK) AT (312) 744-7000 FOR FIELD LOCATIONS OF BURIED ELECTRIC, TELEPHONE, AND GAS FACILITIES. 48 HOUR NOTIFICATION IS REQUIRED.

COMMITMENTS

- 1 NONE

FILE NAME: I:\7828 - 194 at Ohio Street\104001\10400 SHEETS\104001\104001.dwg



| | | |
|--------------------------|-------------|------------|
| USER NAME: rgo1 | DESIGNED: - | REVISED: - |
| PLOT SCALE: 2.0000' / 1" | DRAWN: - | REVISED: - |
| PLOT DATE: 3/25/2013 | CHECKED: - | REVISED: - |
| | DATE: - | REVISED: - |

**STATE OF ILLINOIS
DEPARTMENT OF TRANSPORTATION**

**I-90/94 AT OHIO STREET
GENERAL NOTES AND COMMITMENTS**

| | | | | |
|---|--------------|--------|--------------|-----------|
| F.A.I. RTE. | SECTION | COUNTY | TOTAL SHEETS | SHEET NO. |
| 90/94 | 0303-474HB-R | COOK | 368 | 3 |
| CONTRACT NO. 60F63 | | | | |
| FED. ROAD DIST. NO. 1 (ILLINOIS) FED. AID PROJECT | | | | |

SCALE: SHEET NO. OF SHEETS STA. TO STA.

URBAN
90% FED.
10% STATE

| CODE NO. | ITEM | UNIT | TOTAL QUANTITY | CONSTR. CODE | | | | | | | |
|------------|--|-------|----------------|--------------|---------------|-----------------------|-----------------------|-----------------------|-----------------------|---------------|--|
| | | | | ROADWAY | LANDSCAPING | BRIDGE | BRIDGE | BRIDGE | MINOR STRUCTURES | SAFETY | |
| | | | | 0004 S.N. | 0031 URBAN | 0011 S.N. 016-1322 | 0011 S.N. 016-1323 | 0011 S.N. 016-2573 | 0040 S.N. 016-Z014 | 0021 URBAN | |
| 20100110 | TREE REMOVAL (6 TO 15 UNITS DIAMETER) | UNIT | 968 | 968 | 968 | | | | | | |
| 20100210 | TREE REMOVAL (OVER 15 UNITS DIAMETER) | UNIT | 100 | 100 | 100 | | | | | | |
| 20100500 | TREE REMOVAL, ACRES | ACRE | 0.6 | 0.6 | 0.6 | | | | | | |
| 20101000 | TEMPORARY FENCE | FOOT | 805 | 805 | | | | | | | |
| 20101100 | TREE TRUNK PROTECTION | EACH | 20 | 20 | 20 | | | | | | |
| 20101700 | SUPPLEMENTAL WATERING | UNIT | 100 | 100 | 100 | | | | | | |
| 20200100 | EARTH EXCAVATION | CU YD | 8887 | 8887 | | | | | | | |
| 20201200 | REMOVAL AND DISPOSAL OF UNSUITABLE MATERIAL | CU YD | 3716 | 3716 | | | | | | | |
| 20800150 | TRENCH BACKFILL | CU YD | 130 | 130 | | | | | | | |
| 21001000 | GEOTECHNICAL FABRIC FOR GROUND STABILIZATION | SQ YD | 2343 | 2343 | | | | | | | |
| * 21101600 | TOPSOIL FURNISH AND PLACE, VARIABLE DEPTH | SQ YD | 386 | 386 | 386 | | | | | | |
| * 21101615 | TOPSOIL FURNISH AND PLACE, 4" | SQ YD | 12872 | 12,872 | 12872 | | | | | | |
| 21400100 | GRADING AND SHAPING DITCHES | FOOT | 100 | 100 | | | | | | | |
| * 25000210 | SEEDING, CLASS 2A | ACRE | 3.1 | 3.1 | 3.1 | | | | | | |
| * 25000400 | NITROGEN FERTILIZER NUTRIENT | POUND | 207 | 207 | 207 | | | | | | |
| * 25000500 | PHOSPHORUS FERTILIZER NUTRIENT | POUND | 207 | 207 | 207 | | | | | | |
| * 25000600 | POTASSIUM FERTILIZER NUTRIENT | POUND | 207 | 207 | 207 | | | | | | |

FILE NAME: I:\7088 - PM at Ohio Street\ADD\ROAD SHEETS\016P63-500.dwg

* - DENOTES SPECIALTY ITEM
 ☐ - DENOTES 100% CITY OF CHICAGO
 △ - DENOTES NON-PARTICIPATING ITEM
 (100% STATE)

Rev.



| | | |
|--------------------------|-------------|------------|
| USER NAME: r-gall | DESIGNED: - | REVISED: - |
| PLOT SCALE: 2,0000' / 1" | DRAWN: - | REVISED: - |
| PLOT DATE: 3/25/2013 | CHECKED: - | REVISED: - |
| | DATE: - | REVISED: - |

STATE OF ILLINOIS
DEPARTMENT OF TRANSPORTATION

| | | | |
|---|---------------------|------|---------|
| I-90/94 AT OHIO STREET SUMMARY OF QUANTITIES | | | |
| SCALE: | SHEET NO. OF SHEETS | STA. | TO STA. |

| | | | | |
|---|-------------|--------|--------------|-----------|
| F.A.I. RTE. | SECTION | COUNTY | TOTAL SHEETS | SHEET NO. |
| 90/94 | 0303-474B-R | COOK | 368 | 4 |
| CONTRACT NO. 60F63 | | | | |
| FED. ROAD DIST. NO. 1 ILLINOIS FED. AID PROJECT | | | | |

URBAN
90% FED.
10% STATE

| CODE NO. | ITEM | UNIT | TOTAL QUANTITY | CONSTR. CODE | | | | | | | |
|------------|---|-------|----------------|--------------|--------------------------|-----------------------|-----------------------|-----------------------|-----------------------|---------------|--|
| | | | | ROADWAY | LANDSCAPING | BRIDGE | BRIDGE | BRIDGE | MINOR STRUCTURES | SAFETY | |
| | | | | 0004 S.N. | 0001 URBAN | 0011 S.N. 016-1322 | 0011 S.N. 016-1323 | 0011 S.N. 016-2573 | 0040 S.N. 016-Z014 | 0021 URBAN | |
| * 25100115 | MULCH, METHOD 2 | ACRE | 3.0 | 3.0 | | | | | | | |
| * 25100135 | MULCH, METHOD 4 | ACRE | 0.5 | 0.5 | | | | | | | |
| * 25100630 | EROSION CONTROL BLANKET | SQ YD | 14520 | 14520 | | | | | | | |
| * 25100900 | TURF REINFORCEMENT MAT | SQ YD | 67 | 67 | | | | | | | |
| 28000250 | TEMPORARY EROSION CONTROL SEEDING | POUND | 300 | 300 | | | | | | | |
| 28000305 | TEMPORARY DITCH CHECKS | FOOT | 590 | 590 | | | | | | | |
| 28000400 | PERIMETER EROSION BARRIER | FOOT | 505 | 505 | | | | | | | |
| 28000510 | INLET FILTERS | EACH | 40 | 40 | | | | | | | |
| 28100105 | STONE RIPRAP, CLASS A3 | SQ YD | 4 | 4 | | | | | | | |
| 28200200 | FILTER FABRIC | SQ YD | 4 | 4 | | | | | | | |
| 30300001 | AGGREGATE SUBGRADE IMPROVEMENT | CU YD | 937 | 937 | | | | | | | |
| 30300104 | AGGREGATE SUBGRADE IMPROVEMENT 4" | SQ YD | 3628 | 3628 | | | | | | | |
| 30300112 | AGGREGATE SUBGRADE IMPROVEMENT 12" | SQ YD | 9401 | 9401 | | | | | | | |
| 31102150 | SUBBASE GRANULAR MATERIAL, TYPE C 4 1/2" | SQ YD | 5127 | 5127 | | | | | | | |
| 31200502 | STABILIZED SUBBASE - HOT-MIX ASPHALT, 4 1/2" | SQ YD | 9401 | 9401 | | | | | | | |
| 42000506 | PORTLAND CEMENT CONCRETE PAVEMENT 10 1/4" (JOINTED) | SQ YD | 3335 | 3335 | | | | | | | |
| 42001300 | PROTECTIVE COAT | SQ YD | 9401 | 9401 | | | | | | | |

FILE NAME: I:\2008 - 194 at Ohio Street\03\0300 SHEETS\016063-500.dwg

• - DENOTES SPECIALTY ITEM
 (C) - DENOTES 100% CITY OF CHICAGO
 (A) - DENOTES NON-PARTICIPATING ITEM



| | | |
|---------------------------------|-------------|------------|
| USER NAME: rgg11 | DESIGNED: - | REVISED: - |
| PLOT SCALE: 1/20000 = 1" = 100' | DRAWN: - | REVISED: - |
| PLOT DATE: 3/25/2013 | CHECKED: - | REVISED: - |
| | DATE: - | REVISED: - |

STATE OF ILLINOIS
DEPARTMENT OF TRANSPORTATION

I-90/94 AT OHIO STREET
SUMMARY OF QUANTITIES

SCALE: SHEET NO. OF SHEETS STA. TO STA.

| | | | | |
|--------------------|---------------------|-------------|------------------|-------------|
| F.A.I. RTE. 90/94 | SECTION 0303-474B-R | COUNTY COOK | TOTAL SHEETS 368 | SHEET NO. 5 |
| CONTRACT NO. 60F63 | | | | |

FED. ROAD DIST. NO. 1 ILLINOIS FED. AID PROJECT

URBAN
90% FED.
10% STATE

| CODE NO. | ITEM | UNIT | TOTAL QUANTITY | CONSTR. CODE | | | | | | | |
|----------|---|-------|----------------|--------------|--------------------------|-----------------------|-----------------------|-----------------------|-----------------------|---------------|--|
| | | | | ROADWAY | LANDSCAPING | BRIDGE | BRIDGE | BRIDGE | MINOR STRUCTURES | SAFETY | |
| | | | | 0004 S.N. | 0001 URBAN | 0011 S.N. 016-1322 | 0011 S.N. 016-1323 | 0011 S.N. 016-2573 | 0040 S.N. 016-2014 | 0021 URBAN | |
| 42001420 | BRIDGE APPROACH PAVEMENT CONNECTOR (PCC) | SQ YD | 727 | 727 | | | | | | | |
| 42100340 | CONTINUOUSLY REINFORCED PORTLAND CEMENT CONCRETE PAVEMENT 12" | SQ YD | 212 | 212 | | | | | | | |
| 42100615 | PAVEMENT REINFORCEMENT | SQ YD | 939 | 939 | | | | | | | |
| 44000100 | PAVEMENT REMOVAL | SQ YD | 4196 | 4196 | | | | | | | |
| 44000500 | COMBINATION CURB AND GUTTER REMOVAL | FOOT | 110 | 110 | | | | | | | |
| 44001980 | CONCRETE BARRIER REMOVAL | FOOT | 1766 | 1766 | | | | | | | |
| 44003100 | MEDIAN REMOVAL | SQ FT | 319 | 319 | | | | | | | |
| 44004250 | PAVED SHOULDER REMOVAL | SQ YD | 4141 | 4141 | | | | | | | |
| 44200974 | CLASS B PATCHES, TYPE III, 10 INCH | SQ YD | 300 | 300 | | | | | | | |
| 44213200 | SAW CUTS | FOOT | 1343 | 1343 | | | | | | | |
| 44213202 | TIE BARS 1" | EACH | 340 | 340 | | | | | | | |
| 48101500 | AGGREGATE SHOULDERS, TYPE B 6" | SQ YD | 500 | 500 | | | | | | | |
| 48101620 | AGGREGATE SHOULDERS, TYPE B 10" | SQ YD | 837 | 837 | | | | | | | |
| 48300505 | PORTLAND CEMENT CONCRETE SHOULDERS 10 1/4" | SQ YD | 3679 | 3679 | | | | | | | |
| 48300700 | PORTLAND CEMENT CONCRETE SHOULDERS 12" | SQ YD | 1448 | 1448 | | | | | | | |
| 50101700 | REMOVAL OF EXISTING SUPERSTRUCTURES NO. 1 | EACH | 1 | | | | | 1 | | | |
| 50102400 | CONCRETE REMOVAL | CU YD | 173.5 | | | | | 173.5 | | | |

17

FILE NAME: I:\7888 - 194 at Ohio St - 03\ADDON\AQO SHEETS\DIR\63-500.dgn

* - DENOTES SPECIALTY ITEM
 ☐ - DENOTES 100% CITY OF CHICAGO
 △ - DENOTES NON-PARTICIPATING ITEM

Rev.



| | | |
|-------------------------|------------|-----------|
| USER NAME: rgo11 | DESIGNED - | REVISED - |
| PLOT SCALE: 2,000' / 1" | DRAWN - | REVISED - |
| PLOT DATE: 3/25/2013 | CHECKED - | REVISED - |
| | DATE - | REVISED - |

STATE OF ILLINOIS
DEPARTMENT OF TRANSPORTATION

I-90/94 AT OHIO STREET
SUMMARY OF QUANTITIES

SCALE: SHEET NO. OF SHEETS STA. TO STA.

| | | | | |
|---|------------------------|----------------|---------------------|----------------|
| F.A.I. RTE. 90/94 | SECTION 0303-474B-R | COUNTY COOK | TOTAL SHEETS 368 | SHEET NO. 5 |
| FED. ROAD DIST. NO. 1 ILLINOIS FED. AID PROJECT | | | CONTRACT NO. 60F63 | |

URBAN
90% FED.
10% STATE

| CODE NO. | ITEM | UNIT | TOTAL QUANTITY | CONSTR. CODE | | | | | | |
|----------|--|-------|----------------|--------------|--------------------------|-----------------------|-----------------------|-----------------------|-----------------------|---------------|
| | | | | ROADWAY | LANDSCAPING | BRIDGE | BRIDGE | BRIDGE | MINOR STRUCTURES | SAFETY |
| | | | | 0004 S.N. | 0001 URBAN | 0011 S.N. 016-1322 | 0011 S.N. 016-1323 | 0011 S.N. 016-2573 | 0040 S.N. 016-Z014 | 0021 URBAN |
| 50200100 | STRUCTURE EXCAVATION | CU YD | 832.1 | | | | | 321.4 | 510.7 | |
| 50200450 | REMOVAL AND DISPOSAL OF UNSUITABLE MATERIAL FOR STRUCTURES | CU YD | 1323.6 | | | 298.2 | 1025.4 | | | |
| 50300225 | CONCRETE STRUCTURES | CU YD | 889.3 | | | 261.4 | 108.0 | 375.0 | 144.9 | |
| 50300255 | CONCRETE SUPERSTRUCTURE | CU YD | 1181.5 | | | 591.3 | 397.6 | 192.6 | | |
| 50300260 | BRIDGE DECK GROOVING | SQ YD | 1921 | | | 1345 | 576 | | | |
| 50300285 | FORM LINER TEXTURED SURFACE | SQ FT | 1447 | | | | | 1447 | | |
| 50300300 | PROTECTIVE COAT | SQ YD | 3910 | | | 2475 | 1435 | | | |
| 50400405 | PRECAST PRESTRESSED CONCRETE DECK BEAMS (21" DEPTH) | SQ FT | 1371 | | | | | 1371 | | |
| 50400505 | PRECAST PRESTRESSED CONCRETE DECK BEAMS (27" DEPTH) | SQ FT | 11480 | | | | | 11480 | | |
| 50500105 | FURNISHING AND ERECTING STRUCTURAL STEEL | L SUM | 1 | | | 0.81 | 0.19 | | | |
| 50500505 | STUD SHEAR CONNECTORS | EACH | 13928 | | | 9903 | 2853 | | 1172 | |
| 50800105 | REINFORCEMENT BARS | POUND | 65240 | | | 50870 | 14370 | | | |
| 50800205 | REINFORCEMENT BARS, EPOXY COATED | POUND | 460676 | | | 230740 | 118650 | 89120 | 22166 | |
| 50800515 | BAR SPLICERS | EACH | 2138 | | | 1379 | 651 | 108 | | |
| 50800530 | MECHANICAL SPLICERS | EACH | 1464 | | | 1050 | 276 | 138 | | |
| 50901730 | BRIDGE FENCE RAILING | FOOT | 126 | | | | | 126 | | |
| 51200957 | FURNISHING METAL SHELL PILES 12" X 0.250" | FOOT | 396 | | | | | 396 | | |

17

FILE NAME = H:\2003 - 194 of Ohio Street\ROAD\ADD SHEETS\018RF-EJ-S00.dgn

* - DENOTES SPECIALTY ITEM
 [Symbol] - DENOTES 100% CITY OF CHICAGO
 [Symbol] - DENOTES NON-PARTICIPATING ITEM



| | | |
|---------------------------|------------|-----------|
| USER NAME = rjg011 | DESIGNED - | REVISED - |
| PLOT SCALE = 2,0000 1/16" | DRAWN - | REVISED - |
| PLOT DATE = 3/25/2013 | CHECKED - | REVISED - |
| | DATE - | REVISED - |

STATE OF ILLINOIS
DEPARTMENT OF TRANSPORTATION

| | | | |
|---|-----------|-----------|--------------|
| I-90/94 AT OHIO STREET SUMMARY OF QUANTITIES | | | |
| SCALE: | SHEET NO. | OF SHEETS | STA. TO STA. |

| | | | | |
|---|-------------|--------|--------------------|-----------|
| F.A.I. RTE. | SECTION | COUNTY | TOTAL SHEETS | SHEET NO. |
| 90/94 | 0303-474B-R | COOK | 368 | 7 |
| FED. ROAD DIST. NO. 1 ILLINOIS FED. AID PROJECT | | | CONTRACT NO. 60F63 | |

URBAN
90% FED.
10% STATE

| CODE NO. | ITEM | UNIT | TOTAL QUANTITY | CONSTR. CODE | | | | | | |
|----------|---|-------|----------------|--------------|---------------|-----------------------|-----------------------|-----------------------|-----------------------|---------------|
| | | | | ROADWAY | LANDSCAPING | BRIDGE | BRIDGE | BRIDGE | MINOR STRUCTURES | SAFETY |
| | | | | 0004 S.N. | 0021 URBAN | 0011 S.N. 016-1322 | 0011 S.N. 016-1323 | 0011 S.N. 016-2573 | 0040 S.N. 016-2014 | 0021 URBAN |
| 51202305 | DRIVING PILES | FOOT | 396 | | | | | 396 | | |
| 51203200 | TEST PILE METAL SHELLS | EACH | 1 | | | | | 1 | | |
| 51500100 | NAME PLATES | EACH | 3 | | | 1 | 1 | 1 | | |
| 51602000 | PERMANENT CASING | FOOT | 1864 | | | 1109 | 755 | | | |
| 51603000 | DRILLED SHAFT IN SOIL | CU YD | 345 | | | 218.4 | 126.2 | | | |
| 52000110 | PREFORMED JOINT STRIP SEAL | FOOT | 205 | | | 104 | 101 | | | |
| 52100520 | ANCHOR BOLTS, 1" | EACH | 168 | | | 112 | 56 | | | |
| 54213657 | PRECAST REINFORCED CONCRETE FLARED END SECTIONS 12" | EACH | 1 | 1 | | | | | | |
| 5421A012 | PIPE CULVERTS, CLASS A, TYPE 1 12" (TEMPORARY) | FOOT | 130 | 130 | | | | | | |
| 550A0340 | STORM SEWERS, CLASS A, TYPE 2 12" | FOOT | 243 | 243 | | | | | | |
| 550A0380 | STORM SEWERS, CLASS A, TYPE 2 18" | FOOT | 99 | 99 | | | | | | |
| 550A0930 | STORM SEWERS, CLASS A, TYPE 4 10" | FOOT | 56 | 56 | | | | | | |
| 550A0940 | STORM SEWERS, CLASS A, TYPE 4 12" | FOOT | 410 | 410 | | | | | | |
| 550A0960 | STORM SEWERS, CLASS A, TYPE 4 15" | FOOT | 75 | 75 | | | | | | |
| 55100400 | STORM SEWER REMOVAL 10" | FOOT | 24 | 24 | | | | | | |
| 55100500 | STORM SEWER REMOVAL 12" | FOOT | 651 | 651 | | | | | | |
| 55100700 | STORM SEWER REMOVAL 15" | FOOT | 94 | 94 | | | | | | |

FILE NAME = I-90-94 - 194 at Ohio Street - 6063 SHEETS\016063-500.dwg

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- - DENOTES SPECIALTY ITEM
- ☐ - DENOTES 100% CITY OF CHICAGO
- △ - DENOTES NON-PARTICIPATING ITEM



| | | |
|-------------------------|------------|-----------|
| USER NAME = rgo11 | DESIGNED - | REVISED - |
| PLOT SCALE = 2.0000 "/> | | |

STATE OF ILLINOIS
DEPARTMENT OF TRANSPORTATION

I-90/94 AT OHIO STREET
SUMMARY OF QUANTITIES

SCALE: SHEET NO. OF SHEETS STA. TO STA.

| | | | | |
|---|-------------------------|----------------|---------------------|----------------|
| F.A.I. DATE 90/94 | SECTION 0303-474HB-R | COUNTY COOK | TOTAL SHEETS 368 | SHEET NO. 8 |
| CONTRACT NO. 60F63 | | | | |
| FED. ROAD DIST. NO. 1 ILLINOIS FED. AID PROJECT | | | | |

URBAN
90% FED.
10% STATE

| CODE NO. | ITEM | UNIT | TOTAL QUANTITY | CONSTR. CODE | | | | | | | |
|----------|---|-------|----------------|--------------|--------------------------|-----------------------|-----------------------|-----------------------|-----------------------|---------------|--|
| | | | | ROADWAY | LANDSCAPING | BRIDGE | BRIDGE | BRIDGE | MINOR STRUCTURES | SAFETY | |
| | | | | 0004 S.N. | 0001 URBAN | 0011 S.N. 016-1322 | 0011 S.N. 016-1323 | 0011 S.N. 016-2573 | 0040 S.N. 016-Z014 | 0021 URBAN | |
| 55100900 | STORM SEWER REMOVAL 18" | FOOT | 100 | 100 | | | | | | | |
| 55101100 | STORM SEWER REMOVAL 21" | FOOT | 18 | 18 | | | | | | | |
| 56200900 | WATER SERVICE LINE 2 1/2" | FOOT | 120 | 120 | 120 | | | | | | |
| 58100200 | WATERPROOFING MEMBRANE SYSTEM | SQ YD | 1770 | | | | | 1770 | | | |
| 58700300 | CONCRETE SEALER | SQ FT | 8347 | | | 2020 | 1030 | 2279 | | 3018 | |
| 59000200 | EPOXY CRACK INJECTION | FOOT | 10 | | | | | 10 | | | |
| 59100100 | GEOCOMPOSITE WALL DRAIN | SQ YD | 427 | | | | | 310 | | 117 | |
| 59300100 | CONTROLLED LOW-STRENGTH MATERIAL | CU YD | 13.3 | | | | | 13.3 | | | |
| 60100060 | CONCRETE HEADWALLS FOR PIPE DRAINS | EACH | 3 | 3 | | | | | | | |
| 60100945 | PIPE DRAINS 12" | FOOT | 42 | 42 | | | | | | | |
| 60107600 | PIPE UNDERDRAINS 4" | FOOT | 2496 | 2496 | | | | | | | |
| 60108100 | PIPE UNDERDRAINS 4" (SPECIAL) | FOOT | 84 | 84 | | | | | | | |
| 60200105 | CATCH BASINS, TYPE A, 4'-DIAMETER, TYPE 1 FRAME, OPEN LID | EACH | 1 | 1 | | | | | | | |
| 60200205 | CATCH BASINS, TYPE A, 4'-DIAMETER, TYPE 1 FRAME, CLOSED LID | EACH | 1 | 1 | | | | | | | |
| 60200305 | CATCH BASINS, TYPE A, 4'-DIAMETER, TYPE 3 FRAME AND GRATE | EACH | 1 | 1 | | | | | | | |
| 60200805 | CATCH BASINS, TYPE A, 4'-DIAMETER, TYPE 8 GRATE | EACH | 6 | 6 | | | | | | | |
| 60201005 | CATCH BASINS, TYPE A, 4'-DIAMETER, TYPE 10 FRAME AND GRATE | EACH | 1 | 1 | | | | | | | |

17

- - DENOTES SPECIALTY ITEM
- ☐ - DENOTES 100% CITY OF CHICAGO
- △ - DENOTES NON-PARTICIPATING ITEM

FILE NAME: I-90-94 AT OHIO STREET\COOK\COOK SHEET\01606F63-500.dgn



| | | |
|--------------------------|-------------|------------|
| USER NAME: rgoj | DESIGNED: - | REVISED: - |
| PL01 SCALE: 2.0000' = 1" | DRAWN: - | REVISED: - |
| PL07 DATE: 3/25/2013 | CHECKED: - | REVISED: - |
| | DATE: - | REVISED: - |

STATE OF ILLINOIS
DEPARTMENT OF TRANSPORTATION

| | | | |
|------------------------|-----------|-----------|--------------|
| I-90/94 AT OHIO STREET | | | |
| SUMMARY OF QUANTITIES | | | |
| SCALE: | SHEET NO. | OF SHEETS | STA. TO STA. |

| | | | | |
|---|----------------------|-------------|------------------|-------------|
| F.I.T. RTE. 90/94 | SECTION 0303-474HB-R | COUNTY COOK | TOTAL SHEETS 368 | SHEET NO. 9 |
| CONTRACT NO. 60F63 | | | | |
| FED. ROAD DIST. NO. 1 ILLINOIS FED. AID PROJECT | | | | |

URBAN
90% FED.
10% STATE

| CODE NO. | ITEM | UNIT | TOTAL QUANTITY | CONSTR. CODE | | | | | | | |
|----------|--|-------|----------------|--------------|---------------|-----------------------|-----------------------|-----------------------|-----------------------|---------------|--|
| | | | | ROADWAY | LANDSCAPING | BRIDGE | BRIDGE | BRIDGE | MINOR STRUCTURES | SAFETY | |
| | | | | 0004 S.N. | 0001 URBAN | 0011 S.N. 016-1322 | 0011 S.N. 016-1323 | 0011 S.N. 016-2573 | 0040 S.N. 016-2014 | 0021 URBAN | |
| 60500105 | FILLING MANHOLES | EACH | 4 | 4 | | | | | | | |
| 60500205 | FILLING CATCH BASINS | EACH | 4 | 4 | | | | | | | |
| 60500305 | FILLING INLETS | EACH | 1 | 1 | | | | | | | |
| 60600095 | CLASS SI CONCRETE (OUTLET) | CU YD | 17 | 17 | | | | | | | |
| 60600605 | CONCRETE CURB, TYPE B | FOOT | 100 | 100 | | | | | | | |
| 60618320 | CONCRETE MEDIAN SURFACE, 6 INCH | SQ FT | 465 | 465 | | | | | | | |
| 60900315 | TYPE D INLET BOX, STANDARD 609006 | EACH | 1 | 1 | | | | | | | |
| 60900515 | CONCRETE THRUST BLOCKS | EACH | 1 | 1 | | | | | | | |
| 63100085 | TRAFFIC BARRIER TERMINAL, TYPE 6 | EACH | 2 | 2 | | | | | | | |
| 63100167 | TRAFFIC BARRIER TERMINAL, TYPE 1 (SPECIAL) TANGENT | EACH | 2 | 2 | | | | | | | |
| 63500105 | DELINEATORS | EACH | 44 | 44 | | | | | | | |
| 63700275 | CONCRETE BARRIER, DOUBLE FACE, 42 INCH HEIGHT | FOOT | 475 | 475 | | | | | | | |
| 63700805 | CONCRETE BARRIER TRANSITION | FOOT | 30 | 30 | | | | | | | |
| 63700900 | CONCRETE BARRIER BASE | FOOT | 3101 | 3101 | | | | | | | |
| 64200116 | SHOULDER RUMBLE STRIPS, 16 INCH | FOOT | 950 | 950 | | | | | | | |
| 64300450 | IMPACT ATTENUATORS (NON-REDIRECTIVE), TEST LEVEL 3 | EACH | 1 | 1 | | | | | | | |
| 67100100 | MOBILIZATION | L SUM | 1 | 1 | | | | | | | |

FILE NAME: I:\2008 - 114 at Ohio Street\ROAD\CADD SHEETS\016F63-500.dwg

- - DENOTES SPECIALTY ITEM
- ☐ - DENOTES 100% CITY OF CHICAGO
- △ - DENOTES NON-PARTICIPATING ITEM



USER NAME: krgall
 PLOT SCALE: 2.0000' / 1" IN.
 PLOT DATE: 3/25/2013

DESIGNED -
 DRAWN -
 CHECKED -
 DATE -

REVISED -
 REVISED -
 REVISED -
 REVISED -

STATE OF ILLINOIS
 DEPARTMENT OF TRANSPORTATION

I-90/94 AT OHIO STREET
 SUMMARY OF QUANTITIES

SCALE: SHEET NO. OF SHEETS STA. TO STA.

| | | | | |
|---|--------------|--------|--------------------|-----------|
| F.A.I. RTE. | SECTION | COUNTY | TOTAL SHEETS | SHEET NO. |
| 90/94 | 0303-474HB-R | COOK | 368 | 11 |
| FED. ROAD DIST. NO. 1 [ILLINOIS] FED. AID PROJECT | | | CONTRACT NO. 60F63 | |

URBAN
90% FED.
10% STATE

| CODE NO. | ITEM | UNIT | TOTAL QUANTITY | CONSTR. CODE | | | | | | | |
|------------|--|------|----------------|--------------|---------------|-----------------------|-----------------------|-----------------------|-----------------------|---------------|---|
| | | | | ROADWAY | LANDSCAPING | BRIDGE | BRIDGE | BRIDGE | MINOR STRUCTURES | SAFETY | |
| | | | | 0004 S.N. | 0021 URBAN | 0011 S.N. 016-1322 | 0011 S.N. 016-1323 | 0011 S.N. 016-2573 | 0040 S.N. 016-2014 | 0021 URBAN | |
| * 72400200 | REMOVE SIGN PANEL ASSEMBLY - TYPE B | EACH | 10 | 10 | | | | | | | |
| * 72400310 | REMOVE SIGN PANEL - TYPE 1 | SQFT | 7 | 7 | | | | | | | |
| * 72400320 | REMOVE SIGN PANEL - TYPE 2 | SQFT | 165 | 165 | | | | | | | |
| * 72400330 | REMOVE SIGN PANEL - TYPE 3 | SQFT | 93 | 93 | | | | | | | |
| * 72800100 | TELESCOPING STEEL SIGN SUPPORT | FOOT | 8 | 8 | | | | | | | |
| * 73000100 | WOOD SIGN SUPPORT | FOOT | 114 | 114 | | | | | | | |
| * 73100100 | BASE FOR TELESCOPING STEEL SIGN SUPPORT | EACH | 1 | 1 | | | | | | | |
| * 73302110 | OVERHEAD SIGN STRUCTURE - CANTILEVER, TYPE I-C-A (24" X 4'-6") | FOOT | 22 | 22 | | | | | | | |
| * 73600200 | REMOVE OVERHEAD SIGN STRUCTURE - CANTILEVER | EACH | 1 | 1 | | | | | | | |
| * 73700200 | REMOVE CONCRETE FOUNDATION - GROUND MOUNT | EACH | 1 | | | | | | | | 1 |
| * 78000100 | THERMOPLASTIC PAVEMENT MARKING - LETTERS AND SYMBOLS | SQFT | 132 | 132 | | | | | | | |
| * 78000200 | THERMOPLASTIC PAVEMENT MARKING - LINE 4" | FOOT | 200 | 200 | | | | | | | |
| * 78000400 | THERMOPLASTIC PAVEMENT MARKING - LINE 6" | FOOT | 300 | 300 | | | | | | | |
| * 78000500 | THERMOPLASTIC PAVEMENT MARKING - LINE 8" | FOOT | 150 | 150 | | | | | | | |
| * 78000600 | THERMOPLASTIC PAVEMENT MARKING - LINE 12" | FOOT | 50 | 50 | | | | | | | |
| * 78000650 | THERMOPLASTIC PAVEMENT MARKING - LINE 24" | FOOT | 150 | 150 | | | | | | | |
| * 78008200 | POLYUREA PAVEMENT MARKING TYPE 1 - LETTERS AND SYMBOLS | SQFT | 110 | 110 | | | | | | | |

FILE NAME = I:\2003 - 194 at Ohio Street\ADD\LOAD SHEETS\016063-500.dwg

* - DENOTES SPECIALTY ITEM
 (C) - DENOTES 100% CITY OF CHICAGO
 (A) - DENOTES NON-PARTICIPATING ITEM



| | | |
|-------------------------|------------|-----------|
| USER NAME : rge11 | DESIGNED - | REVISED - |
| PLOT SCALE : 2.0000 "/> | | |

STATE OF ILLINOIS
DEPARTMENT OF TRANSPORTATION

I-90/94 AT OHIO STREET
SUMMARY OF QUANTITIES

SCALE: SHEET NO. OF SHEETS STA. TO STA.

| | | | | |
|---|--------------|--------|--------------------|-----------|
| F.A.I. RTE. | SECTION | COUNTY | TOTAL SHEETS | SHEET NO. |
| 90/94 | 0303-4748B-R | COOK | 368 | 13 |
| FED. ROAD DIST. NO. 1 ILLINOIS FED. AID PROJECT | | | CONTRACT NO. 60F63 | |

URBAN
90% FED.
10% STATE

| CODE NO. | ITEM | UNIT | TOTAL QUANTITY | CONSTR. CODE | | | | | | | |
|-----------------------|---|-----------------|----------------|--------------|--------------------------|-----------------------|-----------------------|-----------------------|-----------------------|---------------|----------------|
| | | | | ROADWAY | LANDSCAPING | BRIDGE | BRIDGE | BRIDGE | MINOR STRUCTURES | SAFETY | |
| | | | | 0004 S.N. | 0001 URBAN | 0011 S.N. 016-1322 | 0011 S.N. 016-1323 | 0011 S.N. 016-2573 | 0040 S.N. 016-2014 | 0021 URBAN | |
| * 78008210 | POLYUREA PAVEMENT MARKING TYPE I - LINE 4" | FOOT | 8956 | 8956 | | | | | | | |
| * 78008220 | POLYUREA PAVEMENT MARKING TYPE I - LINE 5" | FOOT | 2598 | 2598 | | | | | | | |
| * 78008240 | POLYUREA PAVEMENT MARKING TYPE I - LINE 8" | FOOT | 1027 | 1027 | | | | | | | |
| * 78008250 | POLYUREA PAVEMENT MARKING TYPE I - LINE 12" | FOOT | 493 | 493 | | | | | | | |
| * 78100100 | RAISED REFLECTIVE PAVEMENT MARKER | EACH | 12 | 12 | | | | | | | |
| * 78100300 | REPLACEMENT REFLECTOR | EACH | 300 | 300 | | | | | | | |
| * 78200410 | GUARDRAIL MARKERS, TYPE A | EACH | 8 | 8 | | | | | | | |
| * 78200530 | BARRIER WALL MARKERS, TYPE C | EACH | 889 | 889 | | | | | | | |
| * 78201000 | TERMINAL MARKER - DIRECT APPLIED | EACH | 2 | 2 | | | | | | | |
| * 78300100 | PAVEMENT MARKING REMOVAL | SQFT | 8956 | 8956 | | | | | | | |
| * 78300200 | RAISED REFLECTIVE PAVEMENT MARKER REMOVAL | EACH | 12 | 12 | | | | | | | |
| * 80400100 | ELECTRIC SERVICE INSTALLATION | EACH | 1 | | | | | | | | 1 |
| * 80400200 | ELECTRIC UTILITY SERVICE CONNECTION | L.SUM | 1 | | | | | | | | 1 |
| * 81028170 | UNDERGROUND CONDUIT, GALVANIZED STEEL, 1" DIA. | FOOT | 210 | | | | | | | | 210 |
| * 81028200 | UNDERGROUND CONDUIT, GALVANIZED STEEL, 2" DIA. | FOOT | 360 | | | | | | | | 360 |
| * 81028240 | UNDERGROUND CONDUIT, GALVANIZED STEEL, 4" DIA. | FOOT | 160 | | | | | | | | 160 |
| * 81028300 | UNDERGROUND CONDUIT, PVC, 4" DIA. | FOOT | 360 | | | | | | | | 360 |
| * 81028750 | UNDERGROUND CONDUIT, COHABLE NONMETALLIC CONDUIT, 2" DIA. | FOOT | 800 | | | | | | | | 800 |

FILE NAME: I:\2003 - 194 at Ohio Street\CONVOG00 SHEET\DRP03-500.dwg

* - DENOTES SPECIALTY ITEM
 (C) - DENOTES 100% CITY OF CHICAGO
 (A) - DENOTES NON-PARTICIPATING ITEM

Rev-



| | | |
|----------------------------|------------|-----------|
| USER NAME: rgeil | DESIGNED - | REVISED - |
| PLOT SCALE: 2.0000 1/2 in. | DRAWN - | REVISED - |
| PLOT DATE: 3/25/2013 | CHECKED - | REVISED - |
| | DATE - | REVISED - |

STATE OF ILLINOIS
DEPARTMENT OF TRANSPORTATION

I-90/94 AT OHIO STREET
SUMMARY OF QUANTITIES

SCALE: SHEET NO. OF SHEETS STA. TO STA.

| | | | | |
|---|-------------|--------|--------------------|-----------|
| F.A.I. RTE. | SECTION | COUNTY | TOTAL SHEETS | SHEET NO. |
| 90/94 | 0303-474H-R | COOK | 368 | 14 |
| FED. ROAD DIST. NO. 1 ILLINOIS FED. AID PROJECT | | | CONTRACT NO. 60F63 | |

URBAN
90% FED.
10% STATE

| CODE NO. | ITEM | UNIT | TOTAL QUANTITY | CONSTR. CODE | | | | | | | | |
|------------|--|------|----------------|--------------|---------------|-----------------------|-----------------------|-----------------------|-----------------------|---------------|--|------|
| | | | | ROADWAY | LANDSCAPING | BRIDGE | BRIDGE | BRIDGE | MINOR STRUCTURES | SAFETY | | |
| | | | | 0004 S.N. | 0021 URBAN | 0011 S.N. 016-1322 | 0011 S.N. 016-1323 | 0011 S.N. 016-2573 | 0040 S.N. 016-2014 | 0021 URBAN | | |
| * 81028760 | UNDERGROUND CONDUIT, COHABLE NONMETALLIC CONDUIT, 2" DIA. | FOOT | 700 | | | | | | | | | 700 |
| * 81100510 | CONDUIT ATTACHED TO STRUCTURE, 1 1/2" DIA., PVC COATED GALVANIZED STEEL | FOOT | 320 | | | | | | | | | 320 |
| * 81100605 | CONDUIT ATTACHED TO STRUCTURE, 2" DIA., PVC COATED GALVANIZED STEEL | FOOT | 750 | | | | | | | | | 750 |
| * 81300310 | JUNCTION BOX, STAINLESS STEEL, ATTACHED TO STRUCTURE, 8" X 6" X 4" | EACH | 8 | | | | | | | | | 8 |
| * 81300520 | JUNCTION BOX, STAINLESS STEEL, ATTACHED TO STRUCTURE, 12" X 8" X 6" | EACH | 56 | | | | | | | | | 56 |
| * 81300830 | JUNCTION BOX, STAINLESS STEEL, ATTACHED TO STRUCTURE, 18" X 18" X 8" | EACH | 3 | | | | | | | | | 3 |
| * 81400200 | HEAVY-DUTY HANDHOLE | EACH | 1 | | | | | | | | | 1 |
| * 81603080 | UNIT DUCT, 600V, 3-1/C NO.2, 1/C NO.4 GROUND, (XLP-TYPE USE), 1 1/4" DIA. POLYETHYLENE | FOOT | 2000 | | | | | | | | | 2000 |
| * 81702110 | ELECTRIC CABLE IN CONDUIT, 600V (XLP-TYPE USE) 1-C NO. 10 | FOOT | 5000 | | | | | | | | | 5000 |
| * 81702120 | ELECTRIC CABLE IN CONDUIT, 600V (XLP-TYPE USE) 1-C NO. 8 | FOOT | 3200 | | | | | | | | | 3200 |
| * 81702140 | ELECTRIC CABLE IN CONDUIT, 600V (XLP-TYPE USE) 1-C NO. 4 | FOOT | 8580 | | | | | | | | | 8580 |
| * 81702180 | ELECTRIC CABLE IN CONDUIT, 600V (XLP-TYPE USE) 1-C NO. 3/0 | FOOT | 350 | | | | | | | | | 350 |
| * 81800320 | AERIAL CABLE, 3-1/C NO. 4 WITH MESSENGER WIRE | FOOT | 110 | | | | | | | | | 110 |
| * 81800340 | AERIAL CABLE, 3-1/C NO. 8 WITH MESSENGER WIRE | FOOT | 530 | | | | | | | | | 530 |
| * 82102400 | LUMINAIRE, SODIUM VAPOR, HORIZONTAL MOUNT, 400 WATT | EACH | 2 | | | | | | | | | 2 |
| * 82107100 | UNDERPASS LUMINAIRE, 70 WATT, HIGH PRESSURE SODIUM VAPOR | EACH | 8 | | | | | | | | | 8 |
| * 82107700 | UNDERPASS LUMINAIRE, 400 WATT, HIGH PRESSURE SODIUM VAPOR | EACH | 100 | | | | | | | | | 100 |

* - DENOTES SPECIALTY ITEM
 ☐ - DENOTES 100% CITY OF CHICAGO
 △ - DENOTES NON-PARTICIPATING ITEM

FILE NAME: I:\19280 - 194 at Ohio Street\CAD\CADD SHEETS\DRB\F3-SD0.dgn



| | | |
|--------------------------|-------------|------------|
| USER NAME: r-gall | DESIGNED: - | REVISED: - |
| PLOT SCALE: 2.0000' / 1" | DRAWN: - | REVISED: - |
| PLOT DATE: 3/25/2013 | CHECKED: - | REVISED: - |
| | DATE: - | REVISED: - |

STATE OF ILLINOIS
DEPARTMENT OF TRANSPORTATION

I-90/94 AT OHIO STREET
SUMMARY OF QUANTITIES

SCALE: SHEET NO. OF SHEETS STA. TO STA.

| | | | | |
|--------------------------------|---------------------|-------------|--------------------|--------------|
| F.A.I. RTE. 90/94 | SECTION 0303-474B-R | COUNTY COOK | TOTAL SHEETS 369 | SHEET NO. 15 |
| FED. ROAD DIST. NO. 1 ILLINOIS | | | CONTRACT NO. 60F63 | |

URBAN
90% FED.
10% STATE

| CODE NO. | ITEM | UNIT | TOTAL QUANTITY | CONSTR. CODE | | | | | | | | |
|------------|---|------|----------------|--------------|---------------|-----------------------|-----------------------|-----------------------|-----------------------|---------------|--|-----|
| | | | | ROADWAY | LANDSCAPING | BRIDGE | BRIDGE | BRIDGE | MINOR STRUCTURES | SAFETY | | |
| | | | | 0004 S.N. | 0001 URBAN | 0011 S.N. 016-1322 | 0011 S.N. 016-1323 | 0011 S.N. 016-2573 | 0040 S.N. 016-2014 | 0021 URBAN | | |
| * 83057340 | LIGHT POLE, WOOD, 60 FOOT, CLASS 3 | EACH | 2 | | | | | | | | | 2 |
| * 83057355 | LIGHT POLE, WOOD, 60 FOOT, CLASS 4, WITH 15 FT MAST ARM | EACH | 2 | | | | | | | | | 2 |
| * 84500110 | REMOVAL OF LIGHTING CONTROLLER | EACH | 1 | | | | | | | | | 1 |
| * 84500120 | REMOVAL OF ELECTRIC SERVICE INSTALLATION | EACH | 1 | | | | | | | | | 1 |
| * 84500130 | REMOVAL OF LIGHTING CONTROLLER FOUNDATION | EACH | 1 | | | | | | | | | 1 |
| * 87000885 | ELECTRIC CABLE ASSEMBLY IN CONDUIT, 600V (XLP-TYPE TC) 2/C NO. 6 AND NO. 8 | FOOT | 800 | | | | | | | | | 800 |
| * 87301727 | ELECTRIC CABLE IN CONDUIT, COMMUNICATION NO. 19 6C | FOOT | 800 | | | | | | | | | 800 |
| * 87800200 | CONCRETE FOUNDATION, TYPED | FOOT | 4 | | | | | | | | | 4 |
| * A2000220 | TREE, ACER X FREEMANI MARMO (MARMO FREEMAN MAPLE), 2-1/2" CALIPER, BALLED AND BURLAPPED | EACH | 5 | 5 | 5 | | | | | | | |
| * A2002009 | TREE, AESCULUS FLA VEA (YELLOW SWEET BUCKEYE), 2-1/2" CALIPER, BALLED AND BURLAPPED | EACH | 16 | 16 | 16 | | | | | | | |
| * A2002920 | TREE, CELTIS OCCIDENTALIS (COMMON HACKBERRY), 2-1/2" CALIPER, BALLED AND BURLAPPED | EACH | 16 | 16 | 16 | | | | | | | |
| * A2005015 | TREE, GYMNOCLADUS DIOICUS (KENTUCKY COFFEETREE), 8' HEIGHT, MULTI-STEM FORM, BALLED AND BURLAPPED | EACH | 5 | 5 | 5 | | | | | | | |
| * A2006520 | TREE, QUERCUS BICOLOR (SW AMP WHITE OAK), 2-1/2" CALIPER, BALLED AND BURLAPPED | EACH | 3 | 3 | 3 | | | | | | | |
| * A2006570 | TREE, QUERCUS BICOLOR (SW AMP WHITE OAK), 8' HEIGHT, CLUMP FORM, BALLED AND BURLAPPED | EACH | 8 | 8 | 8 | | | | | | | |
| * A2064012 | TREE, QUERCUS ALBA X ROBUR CRIMSCHMIDT (CRIMSON SPIRE OAK), 2-1/2" CALIPER, BALLED AND BURLAPPED | EACH | 3 | 3 | 3 | | | | | | | |
| * C20058G5 | SHRUB, RHUS AROMATICA GRO-LOW (GRO-LOW FRAGRANT SUMAC), 5-GALLON | EACH | 25 | 25 | 25 | | | | | | | |
| * C2011036 | SHRUB, SYRINGA PATULA MISS KIM (MISS KIM MANCHURIAN LILA C), 3' HEIGHT, BALLED AND BURLAPPED | EACH | 25 | 25 | 25 | | | | | | | |

17

• - DENOTES SPECIALTY ITEM
 ☐ - DENOTES 100% CITY OF CHICAGO
 △ - DENOTES NON-PARTICIPATING ITEM

Rev.

FILE NAME: I:\17088 - 174 - 01 - Ohio Street\174001\174001_SHEETS\01RPF03-500.dwg

| | | | | | | | | | | | |
|---|--|--|---|---|---------------------|--------------|---|------------------------|----------------|---------------------|-----------------|
| COLLINS ENGINEERS USER NAME : rgall PLOT SCALE : 2,0000 / 1" = 100' PLOT DATE : 3/25/2013 | DESIGNED - DRAWN - CHECKED - DATE - | REVISED - REVISED - REVISED - REVISED - | STATE OF ILLINOIS DEPARTMENT OF TRANSPORTATION | I-90/94 AT OHIO STREET SUMMARY OF QUANTITIES | | | F.A.I. RYE. 90/94 | SECTION 0303-474H-R | COUNTY COOK | TOTAL SHEETS 368 | SHEET NO. 16 |
| | | | | SCALE: | SHEET NO. OF SHEETS | STA. TO STA. | CONTRACT NO. 60F63 FED. ROAD DIST. NO. 1 ILLINOIS FED. AID PROJECT | | | | |

URBAN
90% FED.
10% STATE

| CODE NO. | ITEM | UNIT | TOTAL QUANTITY | CONSTR. CODE | | | | | | | |
|------------|--|-------|----------------|--------------|---------------|-----------------------|-----------------------|-----------------------|-----------------------|---------------|---|
| | | | | ROADWAY | LANDSCAPING | BRIDGE | BRIDGE | BRIDGE | MINOR STRUCTURES | SAFETY | |
| | | | | 0004 S.N. | 0031 URBAN | 0011 S.N. 016-1322 | 0011 S.N. 016-1323 | 0011 S.N. 016-2573 | 0040 S.N. 016-2014 | 0021 URBAN | |
| * C3005924 | SHRUB, RHUS GLABRA (SMOOTH SUMAC), 2' HEIGHT, BARE ROOT | EACH | 350 | 350 | 350 | | | | | | |
| * C3006024 | SHRUB, RHUS TYPHINA (STAGHORN SUMAC), 2' HEIGHT, BARE ROOT | EACH | 200 | 200 | 200 | | | | | | |
| * D2002484 | EVERGREEN, PINUS FLEXILIS VANDERWOLF'S PYRAMID (VANDERWOLF'S PYRAMID LIMBER PINE), 7' HEIGHT, BALLED AND BURLAPPED | EACH | 13 | 13 | 13 | | | | | | |
| * E20210G1 | VINE-PARTHENOCISSUS QUINQUEFOLIA ENGEL MANNII (ENGELMANNII VIRGINIA CREEPER), 1-GALLON POT | EACH | 240 | 240 | 240 | | | | | | |
| * K0012990 | PERENNIAL PLANTS, ORNAMENTAL TYPE, GALLON POT | UNIT | 15.16 | 15.16 | 15.16 | | | | | | |
| * K0026850 | PERENNIAL PLANT CARE | SQ YD | 7730 | 7730 | 7730 | | | | | | |
| * K0029634 | WEED CONTROL, PRE-EMERGENT GRANULAR HERBICIDE | POUND | 500 | 500 | 500 | | | | | | |
| * K0036120 | MULCH PLACEMENT 4" | SQ YD | 100 | 100 | 100 | | | | | | |
| * K1001987 | IRRIGATION SYSTEM | SQ YD | 1420 | 1420 | 1420 | | | | | | |
| * X0322247 | MAINTENANCE OF EXISTING TRAFFIC SURVEILLANCE | L SUM | 1 | | | | | | | | 1 |
| * X0322441 | DIGITAL LOOP DETECTOR SENSOR UNIT (4 CHANNEL) | EACH | 2 | | | | | | | | 2 |
| * X0322442 | TONE EQUIPMENT - 3 FREQUENCY RECEIVER PROGRAMMABLE | EACH | 8 | | | | | | | | 8 |
| * X0322443 | TONE EQUIPMENT - 3 FREQUENCY TRANSMITTER PROGRAMMABLE | EACH | 8 | | | | | | | | 8 |
| * X0322444 | TONE EQUIPMENT - POWER SUPPLY | EACH | 2 | | | | | | | | 2 |
| * X0322445 | TONE EQUIPMENT - MOUNTING FRAME | EACH | 1 | | | | | | | | 1 |
| * X0322446 | CABINET HOUSING EQUIPMENT, TYPE III | EACH | 1 | | | | | | | | 1 |
| * X0323149 | TEMPORARY MECHANICALLY STABILIZED EARTH RETAINING WALL | SQ FT | 5841 | | | 1464 | 4377 | | | | |

17

* - DENOTES SPECIALTY ITEM
 [Symbol] - DENOTES 100% CITY OF CHICAGO
 [Symbol] - DENOTES NON-PARTICIPATING ITEM

Rev.

FILE NAME = I:\7022 - 191 - 01 Ohio Street\ROADWAY\ROAD SHEETS\016063-500.dgn



| | | |
|---------------------------|------------|-----------|
| USER NAME : rgal | DESIGNED - | REVISED - |
| PLOT SCALE : 2.0000' / 1" | DRAWN - | REVISED - |
| PLOT DATE : 3/25/2013 | CHECKED - | REVISED - |
| | DATE - | REVISED - |

STATE OF ILLINOIS
DEPARTMENT OF TRANSPORTATION

I-90/94 AT OHIO STREET
SUMMARY OF QUANTITIES

SCALE: SHEET NO. OF SHEETS STA. TO STA.

| | | | | |
|---|--------------|--------|--------------------|-----------|
| F.A.I. RTE. | SECTION | COUNTY | TOTAL SHEETS | SHEET NO. |
| 90/94 | 0303-474HB-R | COOK | 368 | 17 |
| FED. ROAD DIST. NO. 1 ILLINOIS FED. AID PROJECT | | | CONTRACT NO. 60F63 | |

URBAN
90% FED
10% STATE

| CODE NO. | ITEM | UNIT | TOTAL QUANTITY | CONSTR. CODE | | | | | | |
|------------|---|--------|----------------|--------------|---------------|-----------------------|-----------------------|-----------------------|-----------------------|---------------|
| | | | | ROADWAY | LANDSCAPING | BRIDGE | BRIDGE | BRIDGE | MINOR STRUCTURES | SAFETY |
| | | | | 0004 S.N. | 0001 URBAN | 0011 S.N. 016-1322 | 0011 S.N. 016-1323 | 0011 S.N. 016-2573 | 0040 S.N. 016-2014 | 0021 URBAN |
| X560110 | GRANULAR BACKFILL FOR STRUCTURES | CU YD | 410.7 | | | | | 410.7 | | |
| X6020073 | INLETS, TYPE A, TYPE 8 GRATE, TEMPORARY | EACH | 2 | 2 | | | | | | |
| X6370279 | CONCRETE BARRIER, SINGLE FACE, 42 INCH HEIGHT (SPECIAL) | FOOT | 2626 | 2626 | | | | | | |
| X6700410 | ENGINEER'S FIELD OFFICE, TYPE A (SPECIAL) | CAL MO | 15 | 15 | | | | | | |
| X7010216 | TRAFFIC CONTROL AND PROTECTION, (SPECIAL) | L SUM | 1 | 1 | | | | | | |
| X7010420 | MOVABLE TRAFFIC BARRIER | FOOT | 421 | 421 | | | | | | |
| X7010442 | TEMPORARY WATER FILLED BARRIER | FOOT | 100 | 100 | | | | | | |
| X7011015 | TRAFFIC CONTROL AND PROTECTION (EXPRESSWAYS) | L SUM | 1 | 1 | | | | | | |
| X7013820 | TRAFFIC CONTROL SURVEILLANCE, EXPRESSWAYS | CAL DA | 9 | 9 | | | | | | |
| X7030030 | WET REFLECTIVE TEMPORARY TAPE TYPE III, 4 INCH | FOOT | 35401 | 35401 | | | | | | |
| X7030035 | WET REFLECTIVE TEMPORARY TAPE TYPE III, 5 INCH | FOOT | 3329 | 3329 | | | | | | |
| X7030045 | WET REFLECTIVE TEMPORARY TAPE TYPE III, 8 INCH | FOOT | 750 | 750 | | | | | | |
| X7030050 | WET REFLECTIVE TEMPORARY TAPE TYPE III, 12 INCH | FOOT | 100 | 100 | | | | | | |
| * X7380510 | REMOVE OVERHEAD SIGN STRUCTURE - LIGHTING EQUIPMENT | LSUM | 1 | 1 | | | | | | |
| * X8040310 | ELECTRICAL SERVICE DISCONNECT | EACH | 1 | | | | | | | 1 |
| * X8850102 | INDUCTION LOOP | FOOT | 45 | | | | | | | 45 |
| * Z0007118 | UNTREATED TIMBER LAGGING | SQ FT | 2743 | | | | | 2743 | | |

17

* - DENOTES SPECIALTY ITEM
 ☐ - DENOTES 100% CITY OF CHICAGO
 △ - DENOTES NON-PARTICIPATING ITEM

FILE NAME: I:\17000 - 194 at Ohio Street\CA00\CA00 SHEETS\0160F03-500.dwg



| | | |
|-------------------------|------------|-----------|
| USER NAME : rge011 | DESIGNED - | REVISED - |
| PLOT SCALE : 2.0000 "/> | | |
| PLOT DATE : 3/25/2013 | CHECKED - | REVISED - |
| | DATE - | REVISED - |

STATE OF ILLINOIS
DEPARTMENT OF TRANSPORTATION

I-90/94 AT OHIO STREET
SUMMARY OF QUANTITIES

SCALE: SHEET NO. OF SHEETS STA. TO STA.

| | | | | |
|---|-------------|--------|--------------------|-----------|
| F.A.I. RITE | SECTION | COUNTY | TOTAL SHEETS | SHEET NO. |
| 90/94 | 0303-474B-R | COOK | 368 | 19 |
| FED. ROAD DIST. NO. 1 ILLINOIS FED. AID PROJECT | | | CONTRACT NO. 60F63 | |

URBAN
90%-FED
10%-STATE

| CODE NO. | ITEM | UNIT | TOTAL QUANTITY | CONSTR. CODE | | | | | | |
|----------|--|--------|----------------|--------------|-------------------------------------|-----------------------|-----------------------|-----------------------|-----------------------|---------------|
| | | | | ROADWAY | LANDSCAPING | BRIDGE | BRIDGE | BRIDGE | MINOR STRUCTURES | SAFETY |
| | | | | 0004 S.N. | 0001 URBAN | 0011 S.N. 016-1322 | 0011 S.N. 016-1323 | 0011 S.N. 016-2573 | 0040 S.N. 016-2014 | 0021 URBAN |
| Z0012754 | STRUCTURAL REPAIR OF CONCRETE (DEPTH EQUAL TO OR LESS THAN 5 INCHES) | SQ FT | 110 | | | | | 110 | | |
| Z0013797 | STABILIZED CONSTRUCTION ENTRANCE | SQ YD | 200 | 200 | | | | | | |
| Z0013798 | CONSTRUCTION LAYOUT | L SUM | 1 | 1 | | | | | | |
| Z0018004 | DRAINAGE SCUPPERS, DS-12 | EACH | 2 | | | 1 | 1 | | | |
| Z0018800 | DRAINAGE SYSTEM | L SUM | 1 | | | 0.5 | 0.5 | | | |
| Z0022800 | FENCE REMOVAL | FOOT | 94 | 94 | | | | | | |
| Z0026404 | FURNISHING SOLDIER PILES (W SECTION) | FOOT | 3992 | | | | | | 3992 | |
| Z0028462 | GEOTEXTILE RETAINING WALL | SQ FT | 190 | | | | | 190 | | |
| Z0030850 | TEMPORARY INFORMATION SIGNING | SQ FT | 25.7 | 25.7 | | | | | | |
| Z0033028 | MAINTENANCE OF LIGHTING SYSTEM | CAL MO | 14 | | | | | | | 14 |
| Z0034210 | MECHANICALLY STABILIZED EARTH RETAINING WALL | SQ FT | 12826 | | | 2930 | 9896 | | | |
| Z0046304 | PIPE UNDERDRAINS FOR STRUCTURES 4" | FOOT | 518 | | | | | 150 | 368 | |
| Z0046306 | PIPE UNDERDRAINS FOR STRUCTURES 6" | FOOT | 308 | | | | | 308 | | |
| Z0062456 | TEMPORARY PAVEMENT | SQ YD | 3628 | 3628 | | | | | | |
| Z0084600 | SELECTIVE CLEARING | ACRE | 0.5 | 0.5 | | | | | | |
| Z0073002 | TEMPORARY SOIL RETENTION SYSTEM | SQ FT | 2410 | | | | | 2410 | | |
| Z0076600 | TRAINING | HOUR | | | | | | | | |

16

- - DENOTES SPECIALTY ITEM
- ◻ - DENOTES 100% CITY OF CHICAGO
- △ - DENOTES NON-PARTICIPATING ITEM

FILE NAME: I:\17828 - 194 at Ohio Street\ACAD\ACAD00 SHEETS\016063-000.dwg



| | | |
|--------------------------|-------------|------------|
| USER NAME: rgeil | DESIGNED: - | REVISED: - |
| PLOT SCALE: 2.0000' / 1" | DRAWN: - | REVISED: - |
| PLOT DATE: 3/25/2013 | CHECKED: - | REVISED: - |
| | DATE: - | REVISED: - |

STATE OF ILLINOIS
DEPARTMENT OF TRANSPORTATION

| | | | |
|------------------------|-----------|-----------|--------------|
| I-90/94 AT OHIO STREET | | | |
| SUMMARY OF QUANTITIES | | | |
| SCALE: | SHEET NO. | OF SHEETS | STA. TO STA. |


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|---|------------------------|----------------|---------------------|-----------------|
| F.A.I. RTE. 90/94 | SECTION 0303-474B-R | COUNTY COOK | TOTAL SHEETS 368 | SHEET NO. 20 |
| CONTRACT NO. 60F63 | | | | |
| FED. ROAD DIST. NO. 1 ILLINOIS FED. AID PROJECT | | | | |

EXISTING LEGEND:


- (A) PCC PAVEMENT, 10" & VAR.
- (B) PCC SHOULDER, 10" & VAR.
- (C) NOT USED
- (D) CONCRETE BARRIER AND BASE
- (E) RETAINING WALL (CAST IN PLACE)
- (F) PROTECTIVE PCC SLAB, 5"
- (G) TOPSOIL, 6"
- (H) KNEE WALL AND FENCE
- (I) CURB AND GUTTER
- (J) CRC PAVEMENT, 12" & VAR.
- (K) PCC SHOULDER, 12" & VAR.
- (L) HMA SHOULDER, 8" & VAR.
- (M) REMOVAL AND DISPOSAL OF UNSUITABLE MATERIAL



MATCHLINE
SEE BELOW

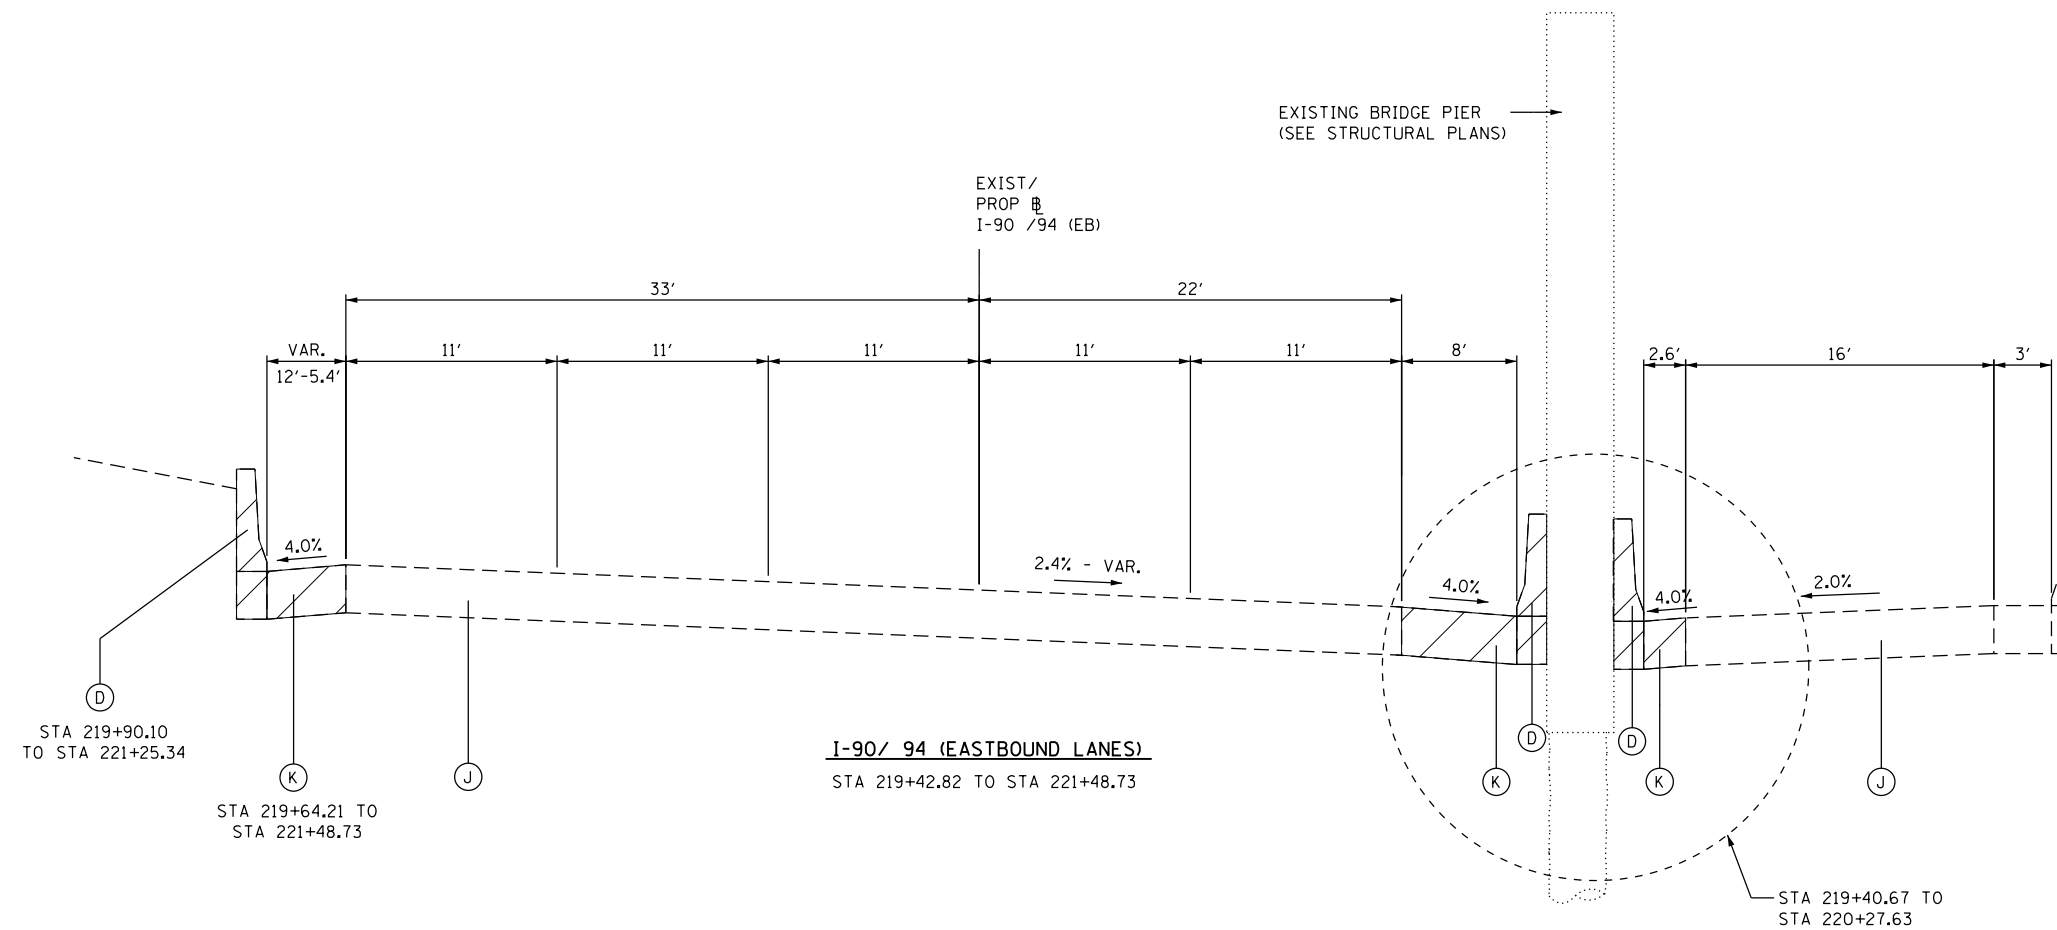

I-90/ 94 (EASTBOUND LANES)
STA 219+42.82 TO STA 221+48.73

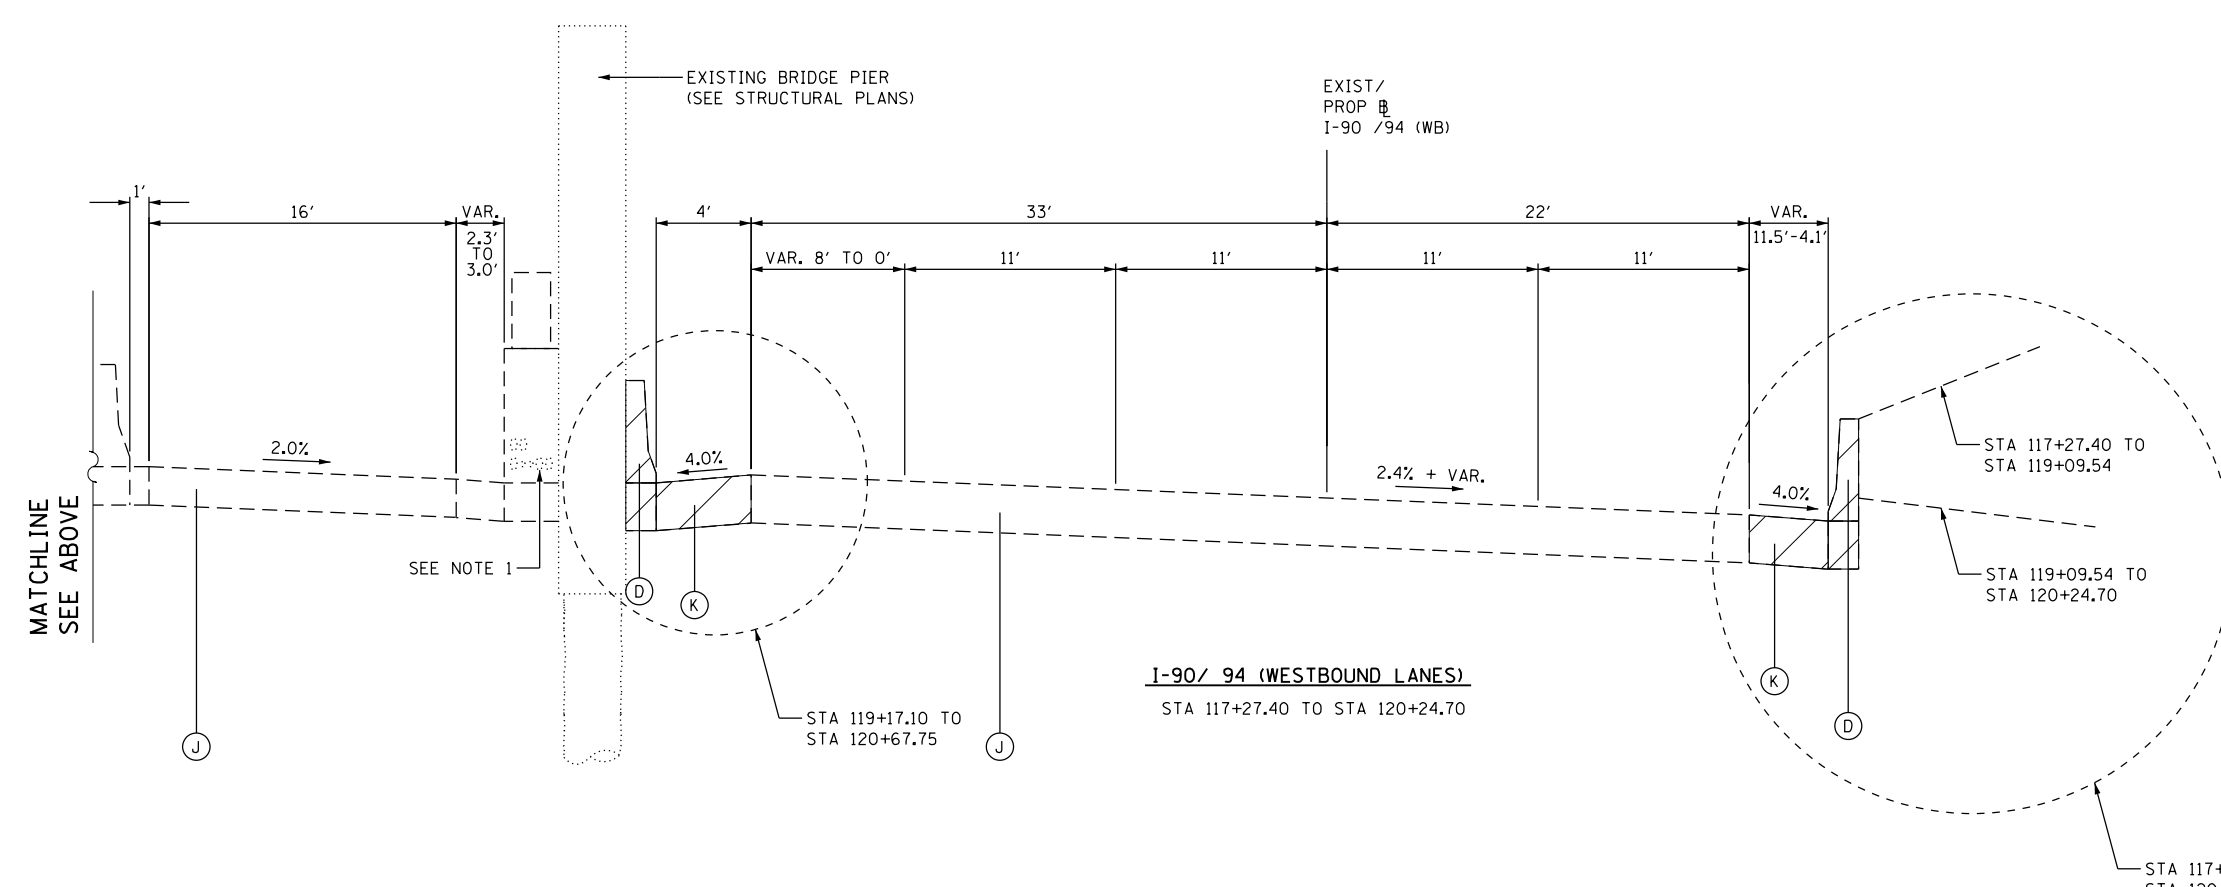

I-90/ 94 (WESTBOUND LANES)
STA 117+27.40 TO STA 120+24.70

NOTES:

1. CONTRACTOR SHALL EXERCISE EXTREME CARE NOT TO IMPACT EXISTING REVLAC CONDUITS DURING EXCAVATION OPERATIONS.
2. EXISTING TOPSOIL SHALL BE STRIPPED FROM WITHIN PROPOSED CONSTRUCTION LIMITS. THE QUANTITY WAS BASED ON AN ASSUMED DEPTH OF 6".

FILE NAME = \\collinsengr.com\1\adate\1\Posanden\00CS\7000 - I94.ctb\hvc Streets\CADD\CADD SHEETS\0160F63-ht-tp2.dgn




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|-----------------------------|------------|-----------|
| USER NAME = rge11 | DESIGNED - | REVISED - |
| PLOT SCALE = 10.0000' / in. | DRAWN - | REVISED - |
| PLOT DATE = 3/25/2013 | CHECKED - | REVISED - |
| | DATE - | REVISED - |

**STATE OF ILLINOIS
DEPARTMENT OF TRANSPORTATION**

**I-90/94 (KENNEDY EXPRESSWAY)
EXISTING TYPICAL SECTIONS**

SCALE: SHEET NO. OF SHEETS STA. TO STA.


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|---|--------------|--------|--------------------|-----------|
| F.A.I. RTE. | SECTION | COUNTY | TOTAL SHEETS | SHEET NO. |
| 90/94 | 0303-474HB-R | COOK | 368 | 22 |
| FED. ROAD DIST. NO. 1 ILLINOIS FED. AID PROJECT | | | CONTRACT NO. 60F63 | |

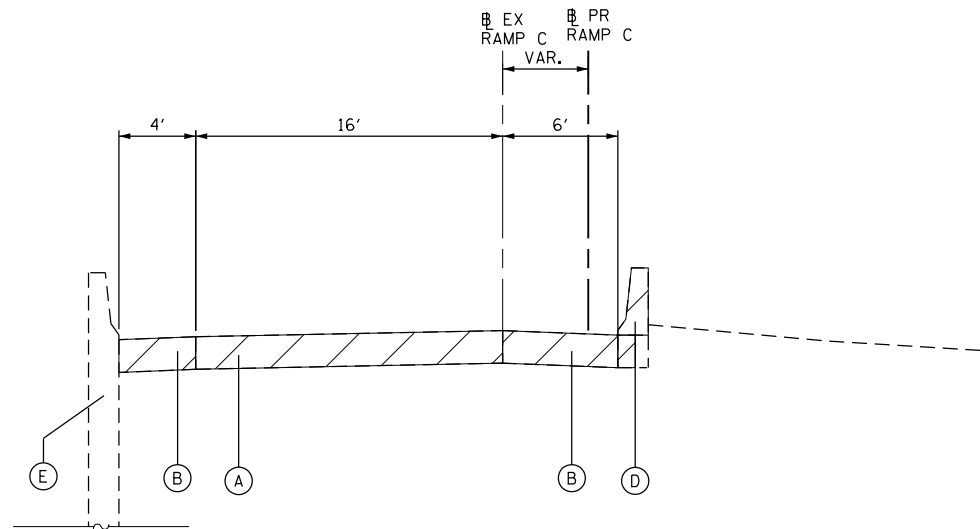

EXISTING RAMP C
STA 103+00 TO STA 103+95.88

EXISTING LEGEND:

- (A) PCC PAVEMENT, 10" & VAR.
- (B) PCC SHOULDER, 10" & VAR.
- (C) NOT USED
- (D) CONCRETE BARRIER AND BASE
- (E) RETAINING WALL (CAST IN PLACE)
- (F) PROTECTIVE PCC SLAB, 5"
- (G) TOPSOIL, 6"
- (H) KNEE WALL AND FENCE
- (I) CURB AND GUTTER
- (J) CRC PAVEMENT, 12" & VAR.
- (K) PCC SHOULDER, 12" & VAR.
- (L) HMA SHOULDER, 8" & VAR.
- (M) REMOVAL AND DISPOSAL OF UNSUITABLE MATERIAL

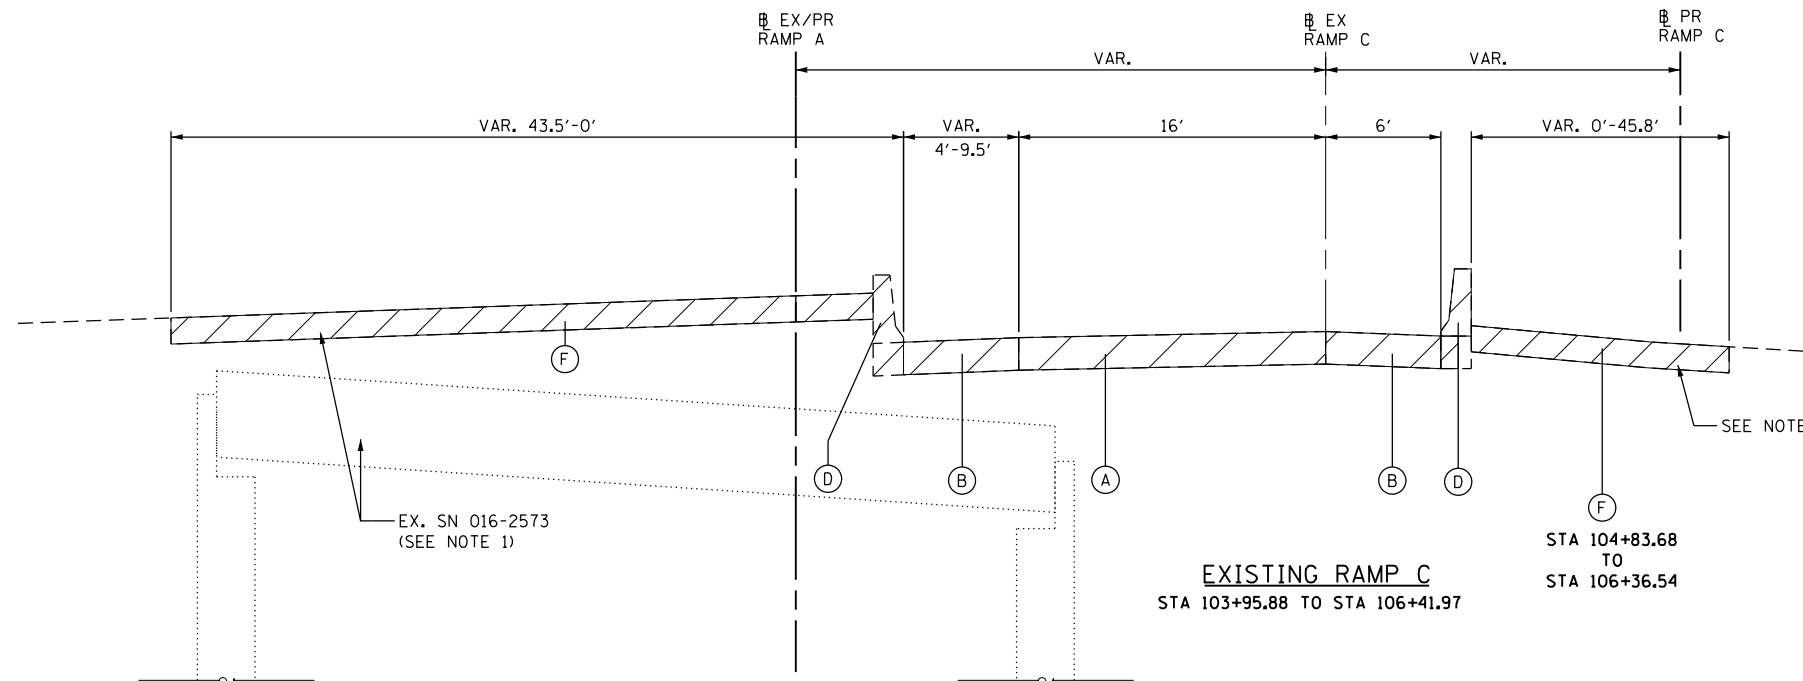

EXISTING RAMP C
STA 103+95.88 TO STA 106+41.97

STA 104+83.68
TO
STA 106+36.54

SEE NOTE 1

NOTES:

1. SEE STRUCTURE SN 016-2573 PLANS FOR DETAILS
2. EXISTING TOPSOIL SHALL BE STRIPPED FROM WITHIN PROPOSED CONSTRUCTION LIMITS. THE QUANTITY WAS BASED ON AN ASSUMED DEPTH OF 6".

FILE NAME = \\collinsengr.com\1\adate\1\Posarden\DDCS\Y2000 - 134.ct_0hvo.Street\CADD\SHETS\0160F63-ht-tpz.dgn

COLLINS ENGINEERS

| | | |
|-----------------------------|------------|-----------|
| USER NAME = rge11 | DESIGNED - | REVISED - |
| PLOT SCALE = 10.0000' / in. | DRAWN - | REVISED - |
| PLOT DATE = 3/25/2013 | CHECKED - | REVISED - |
| | DATE - | REVISED - |


**STATE OF ILLINOIS
DEPARTMENT OF TRANSPORTATION**

**RAMP C
EXISTING TYPICAL SECTIONS**


| F.A.I. RTE. | SECTION | COUNTY | TOTAL SHEETS | SHEET NO. |
|---|--------------|--------|--------------------|-----------|
| 90/94 | 0303-474HB-R | COOK | 368 | 23 |
| FED. ROAD DIST. NO. 1 ILLINOIS FED. AID PROJECT | | | CONTRACT NO. 60F63 | |

EXISTING LEGEND:


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- (B) PCC SHOULDER, 10" & VAR.
- (C) NOT USED
- (D) CONCRETE BARRIER AND BASE
- (E) RETAINING WALL (CAST IN PLACE)
- (F) PROTECTIVE PCC SLAB, 5"
- (G) TOPSOIL, 6"
- (H) KNEE WALL AND FENCE
- (I) CURB AND GUTTER
- (J) CRC PAVEMENT, 12" & VAR.
- (K) PCC SHOULDER, 12" & VAR.
- (L) HMA SHOULDER, 8" & VAR.
- (M) REMOVAL AND DISPOSAL OF UNSUITABLE MATERIAL

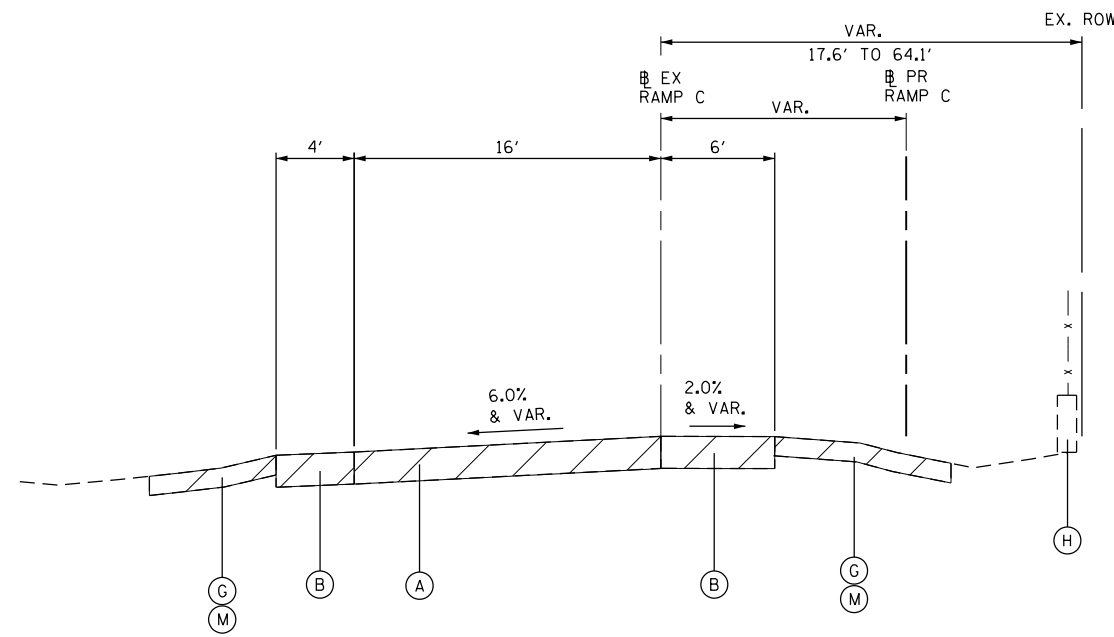


EXISTING RAMP C
STA 116+88.44 TO STA 120+66.19

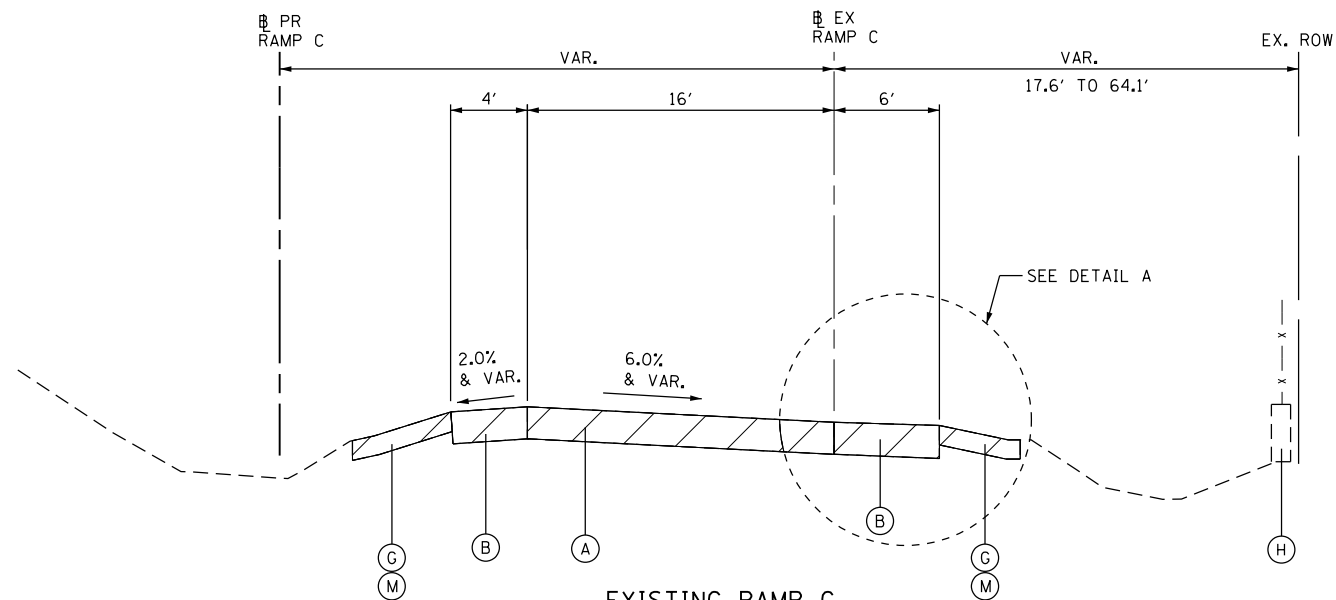


EXISTING RAMP C
STA 120+66.19 TO STA 125+62.62

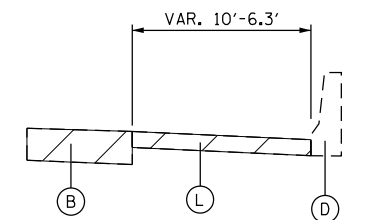

DETAIL A
STA 125+25.38 TO STA 125+62.62

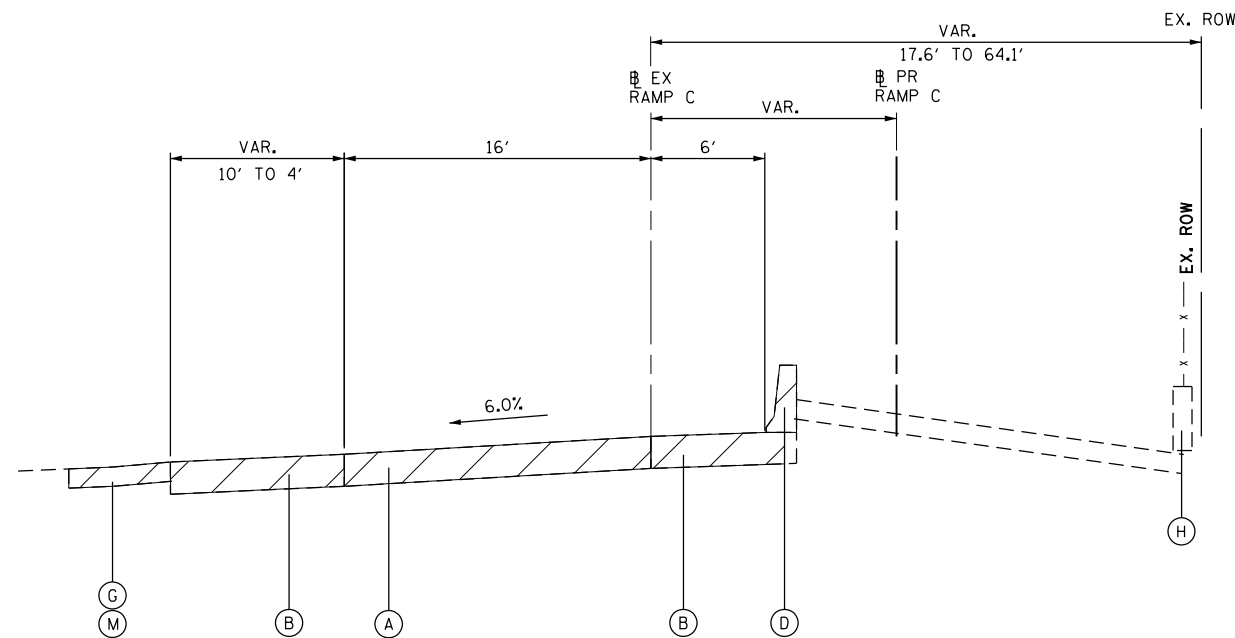

EXISTING RAMP C
STA 113+17.15 TO STA 116+88.44

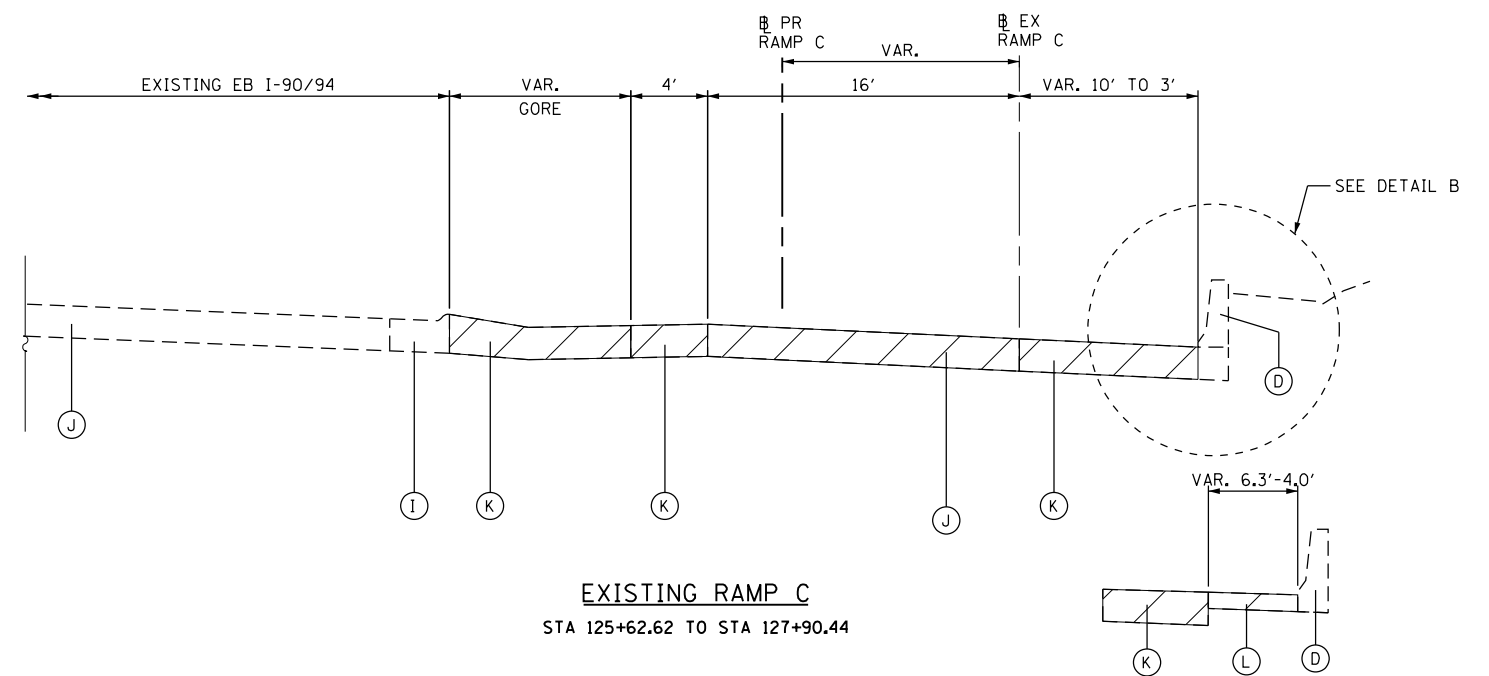

EXISTING RAMP C
STA 125+62.62 TO STA 127+90.44

DETAIL B
STA 125+62.62 TO STA 125+88.39

NOTES:

- EXISTING TOPSOIL SHALL BE STRIPPED FROM WITHIN PROPOSED CONSTRUCTION LIMITS. THE QUANTITY WAS BASED ON AN ASSUMED DEPTH OF 6".

FILE NAME = \\collinsengr.com\1\adate\1\Posanden\DDCS\Y2000 - 134.ct_0hvo.Street\CADD\SHETS\0160F63-ht-tp2.dgn





| | | |
|----------------------------|------------|-----------|
| USER NAME = rge11 | DESIGNED - | REVISED - |
| PLOT SCALE = 10.0000' / 1" | DRAWN - | REVISED - |
| PLOT DATE = 3/25/2013 | CHECKED - | REVISED - |
| | DATE - | REVISED - |

**STATE OF ILLINOIS
DEPARTMENT OF TRANSPORTATION**

**RAMP C
EXISTING TYPICAL SECTIONS**

| | | | | |
|---|-------------------------|----------------|---------------------|-----------------|
| F.A.I. RTE. 90/94 | SECTION 0303-474HB-R | COUNTY COOK | TOTAL SHEETS 368 | SHEET NO. 24 |
| CONTRACT NO. 60F63 | | | | |
| FED. ROAD DIST. NO. 1 ILLINOIS FED. AID PROJECT | | | | |

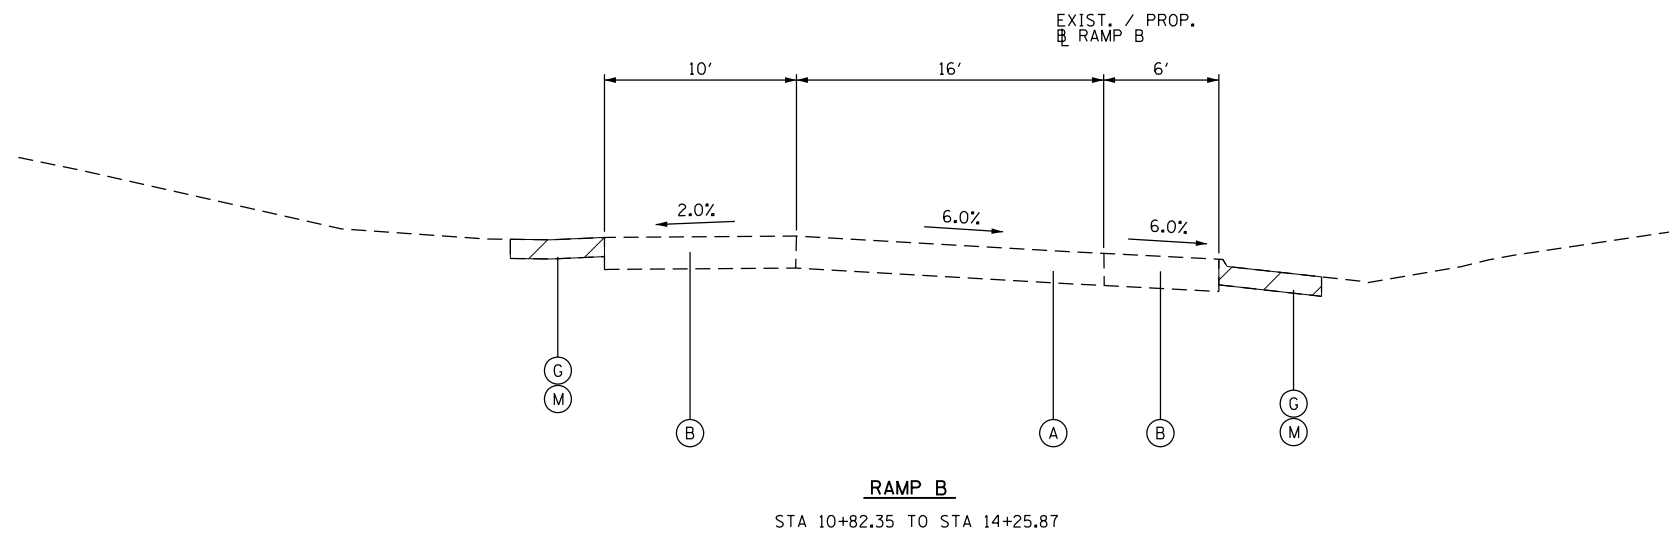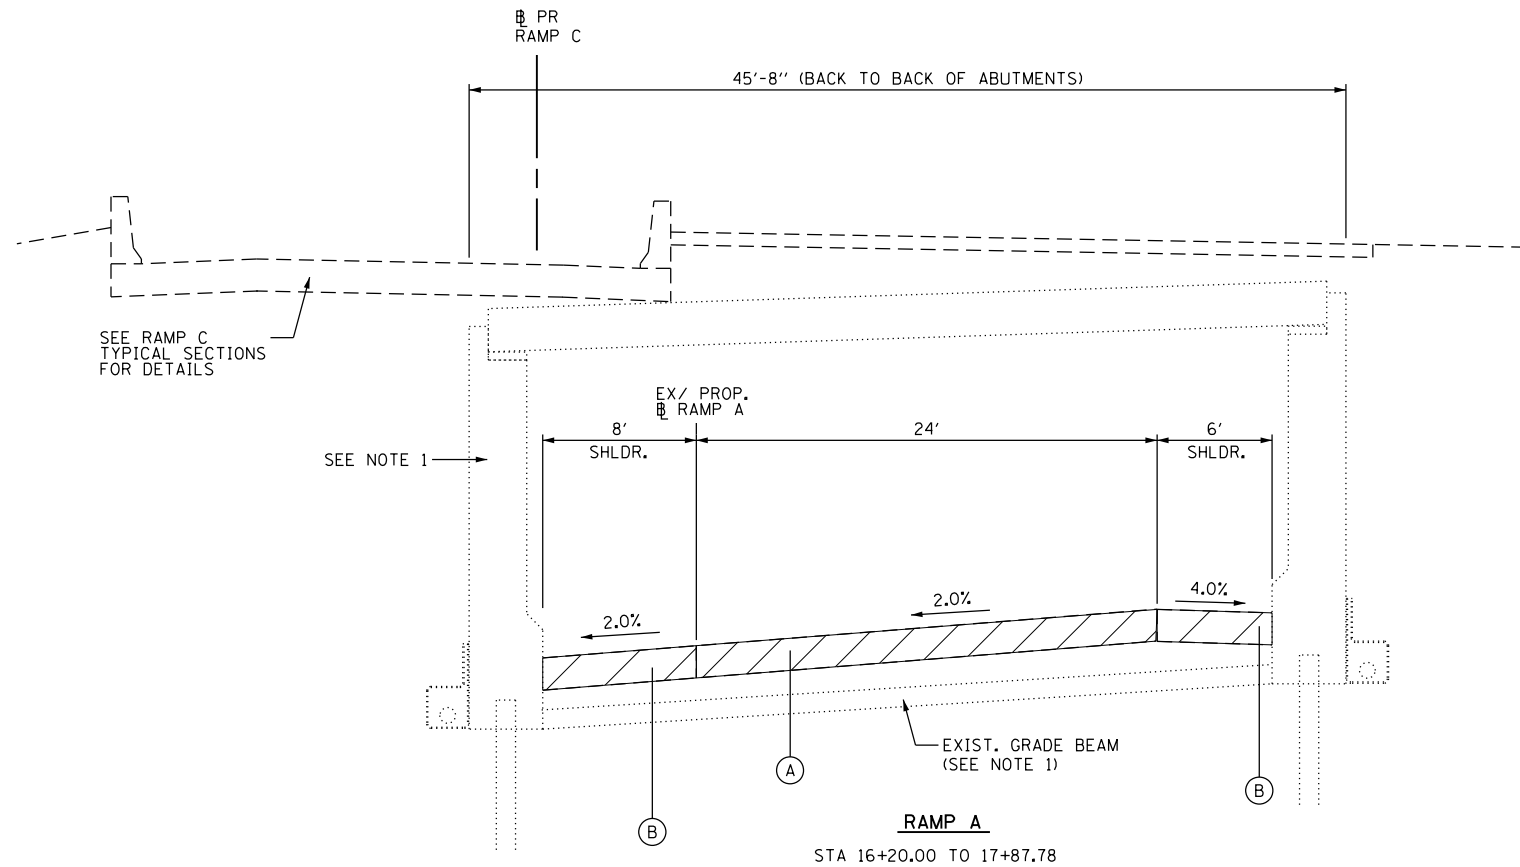

NOTES:

- SEE STRUCTURE SN 016-2573 PLANS FOR DETAILS
- EXISTING TOPSOIL SHALL BE STRIPPED FROM WITHIN PROPOSED CONSTRUCTION LIMITS. THE QUANTITY WAS BASED ON AN ASSUMED DEPTH OF 6".

FILE NAME = \\collinsengr.com\1\adate\1\Posanden\DDCS\Y2000 - 134 ot_0hvc_Street\CADD\SHEETS\0160F63-ht-tp2.dgn

**COLLINS
ENGINEERS**

| | | |
|-----------------------------|------------|-----------|
| USER NAME = rge11 | DESIGNED - | REVISED - |
| PLOT SCALE = 10.0000' / in. | DRAWN - | REVISED - |
| PLOT DATE = 3/25/2013 | CHECKED - | REVISED - |
| | DATE - | REVISED - |

**STATE OF ILLINOIS
DEPARTMENT OF TRANSPORTATION**


**RAMP A AND RAMP B
EXISTING TYPICAL SECTIONS**

SCALE: SHEET NO. OF SHEETS STA. TO STA.


| F.A.I. RTE. | SECTION | COUNTY | TOTAL SHEETS | SHEET NO. |
|---|--------------|--------|-----------------|--------------|
| 90/94 | 0303-474HB-R | COOK | 368 | 25 |
| CONTRACT NO. 60F63 | | | | |
| FED. ROAD DIST. NO. 1 ILLINOIS FED. AID PROJECT | | | | |

EXISTING LEGEND:

- (A) PCC PAVEMENT, 10" & VAR.
- (B) PCC SHOULDER, 10" & VAR.
- (C) NOT USED
- (D) CONCRETE BARRIER AND BASE
- (E) RETAINING WALL (CAST IN PLACE)
- (F) PROTECTIVE PCC SLAB, 5"
- (G) TOPSOIL, 6"
- (H) KNEE WALL AND FENCE
- (I) CURB AND GUTTER
- (J) CRC PAVEMENT, 12" & VAR.
- (K) PCC SHOULDER, 12" & VAR.
- (L) HMA SHOULDER, 8" & VAR.
- (M) REMOVAL AND DISPOSAL OF UNSUITABLE MATERIAL

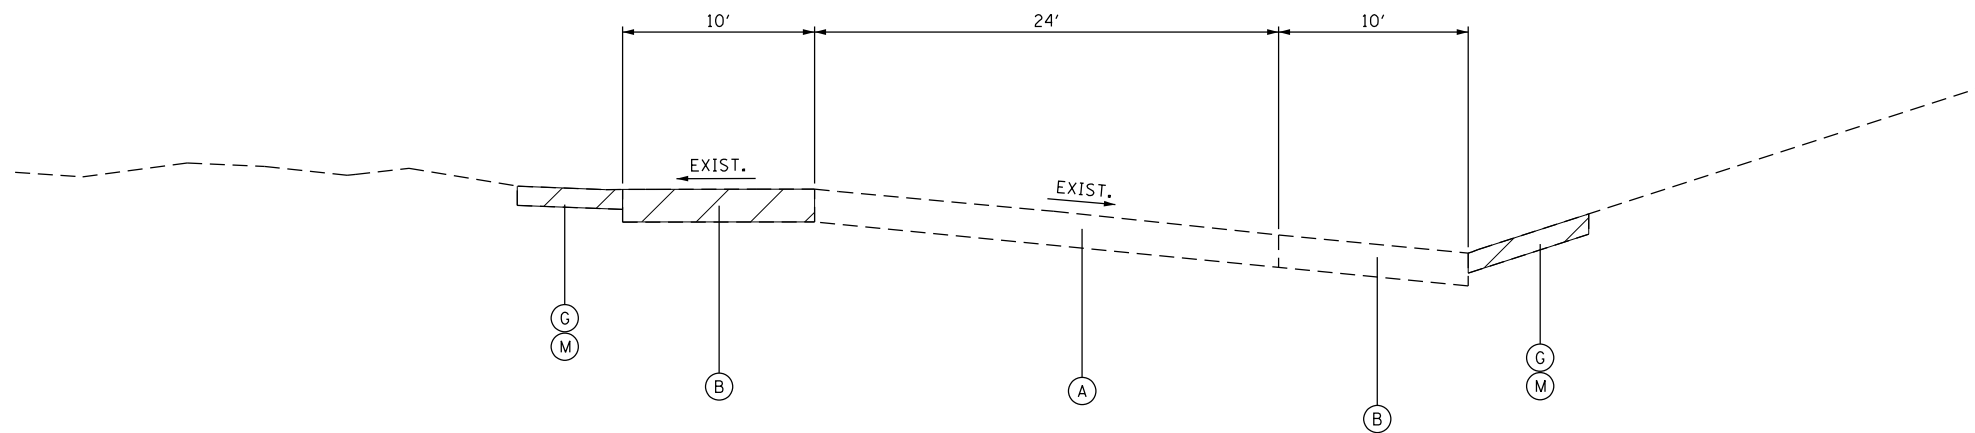

RAMP D
STA 8+21.39 TO STA 9+18.08

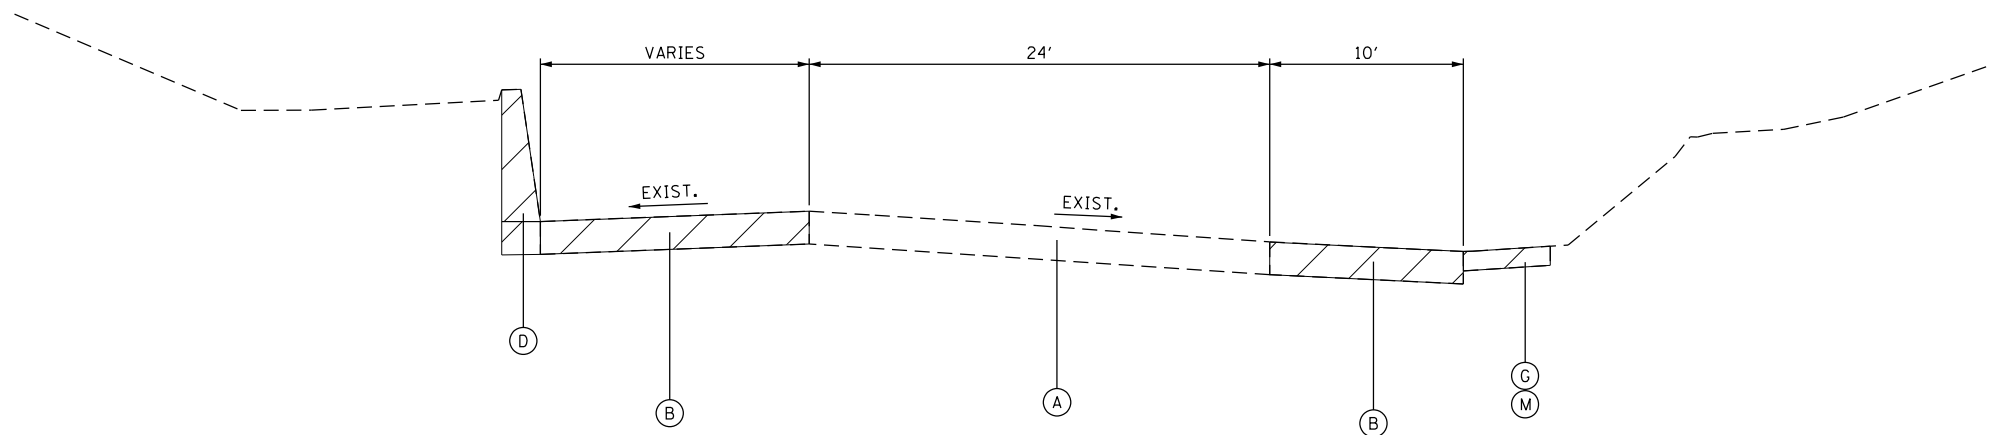

RAMP D
STA 9+18.08 TO STA 11+06.71

NOTES:

1. EXISTING TOPSOIL SHALL BE STRIPPED FROM WITHIN PROPOSED CONSTRUCTION LIMITS. THE QUANTITY WAS BASED ON AN ASSUMED DEPTH OF 6".

FILE NAME = \\collinsengr.com\1\adate\1\Posanden\DDCS\7200 - I34 at Ohio Street\CADD\SHEETS\0160F63-ht-tp2.dgn



| | | |
|----------------------------|------------|-----------|
| USER NAME = rge11 | DESIGNED - | REVISED - |
| PLOT SCALE = 10.0000' / 1" | DRAWN - | REVISED - |
| PLOT DATE = 3/25/2013 | CHECKED - | REVISED - |
| | DATE - | REVISED - |

**STATE OF ILLINOIS
DEPARTMENT OF TRANSPORTATION**


**RAMP D
EXISTING TYPICAL SECTIONS**

SCALE: SHEET NO. OF SHEETS STA. TO STA.

| F.A.I. RTÉ. | SECTION | COUNTY | TOTAL SHEETS | SHEET NO. |
|---|--------------|--------|--------------|-----------|
| 90/94 | 0303-474HB-R | COOK | 368 | 26 |
| CONTRACT NO. 60F63 | | | | |
| FED. ROAD DIST. NO. 1 ILLINOIS FED. AID PROJECT | | | | |

PROPOSED LEGEND:

- ① PORTLAND CEMENT CONCRETE PAVEMENT, 10-1/4" (JOINTED)
- ② PORTLAND CEMENT CONCRETE SHOULDERS, 10-1/4"
- ③ STABILIZED SUBBASE, HOT-MIX ASPHALT, 4 1/2"
- ④ AGGREGATE SUBGRADE IMPROVEMENT, 12"
- ⑤ SUBBASE GRANULAR MATERIAL, TYPE C, 4 1/2"
- ⑥ PROPOSED PIPE UNDERDRAIN, 4"
- ⑦ AGGREGATE SHOULDERS, TYPE B, 10"
- ⑧ CONCRETE RETAINING WALL (PROPOSED)
- ⑨ MECHANICALLY STABILIZED EARTH RETAINING WALL (PROPOSED)
- ⑩ EROSION CONTROL BLANKET
- ⑪ TOPSOIL FURNISH AND PLACE, 4"
- ⑫ SEEDING, CLASS 2A
- ⑬ STEEL PLATE BEAM GUARDRAIL
- ⑭ LONGITUDINAL CONSTRUCTION JOINT WITH NO. 6 TIE BARS @ 24" CENTERS (INCLUDED IN THE COST OF PCC PAVEMENT)
- ⑮ LONGITUDINAL CONSTRUCTION JOINT WITH NO. 6 TIE BARS DRILL AND GROUT IN PLACE (INCLUDED IN THE COST OF PCC PAVEMENT)
- ⑯ BRIDGE APPROACH PAVEMENT CONNECTOR (PCC)
- ⑰ ANCHORAGE SLAB (SEE STRUCT. PLANS)
- ⑱ REINFORCED SOIL MASS (SEE STRUCT. PLANS)
- ⑲ CONCRETE BARRIER, SINGLE FACE, 42" (SPECIAL), TYPE 1
- ⑳ CONCRETE BARRIER BASE (SPECIAL)
- ㉑ CONCRETE BARRIER, SINGLE FACE, 42" (SPECIAL), TYPE 2
- ㉒ PORTLAND CEMENT CONCRETE SHOULDERS, 12"
- ㉓ AGGREGATE SUBGRADE IMPROVEMENT, UNDERCUT
- ㉔ GEOTECHNICAL FABRIC FOR GROUND STABILIZATION
- ㉕ PROTECTIVE CONCRETE SLAB (SEE STRUCT. PLANS)
- ㉖ CONTINUOUSLY REINFORCED CONCRETE PAVEMENT, 12"

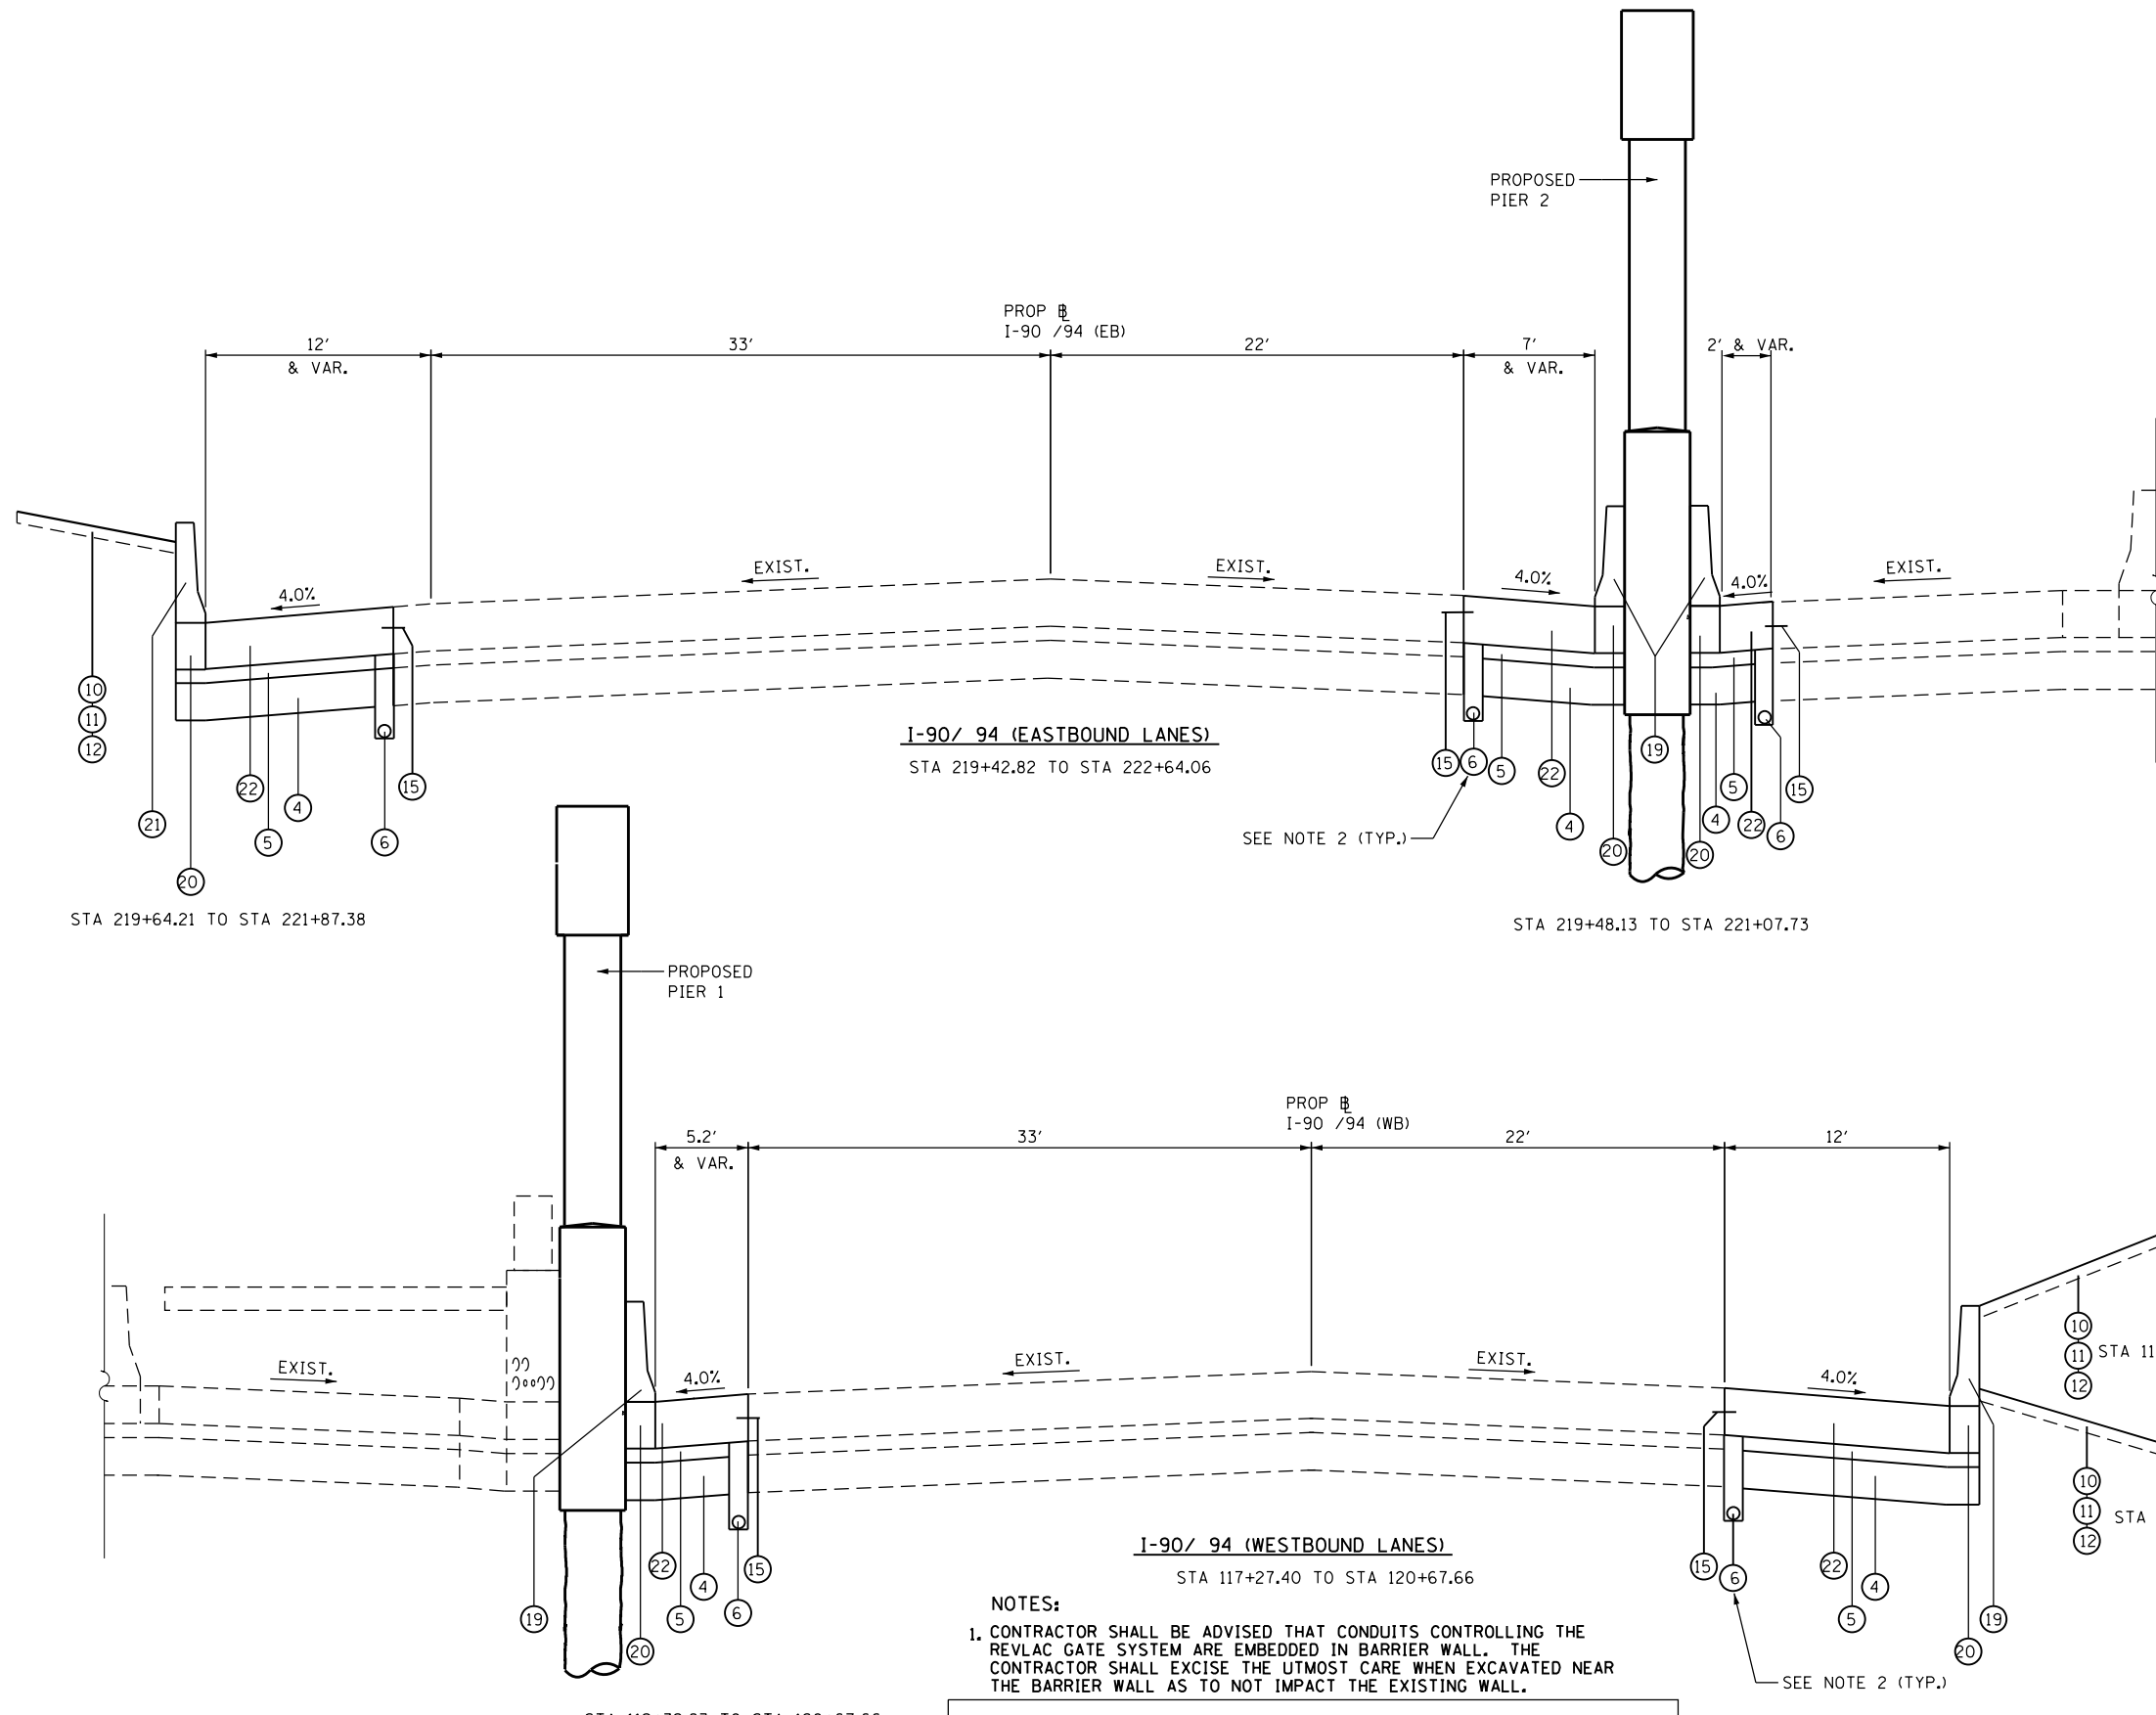

NOTES:

1. CONTRACTOR SHALL BE ADVISED THAT CONDUITS CONTROLLING THE REVLOC GATE SYSTEM ARE EMBEDDED IN BARRIER WALL. THE CONTRACTOR SHALL EXCISE THE UTMOST CARE WHEN EXCAVATED NEAR THE BARRIER WALL AS TO NOT IMPACT THE EXISTING WALL.
2. CONTRACTOR SHALL CONNECT PROPOSED UNDERDRAIN SYSTEM TO EXISTING UNDERDRAIN SYSTEM. COST OF CONNECTION SHALL BE INCIDENTAL TO INSTALLATION OF THE PROPOSED UNDERDRAIN.

FILE NAME = \\collinsengr.com\1\adate\1\Posanden\DDCS\Y2000 - 194.ct_0hvo.Street\CADD\CADD_SHEETS\0160F63-ht-tpz.dgn








| | | |
|-----------------------------|------------|-----------|
| USER NAME = rge11 | DESIGNED - | REVISED - |
| PLOT SCALE = 10.0000' / in. | DRAWN - | REVISED - |
| PLOT DATE = 3/25/2013 | CHECKED - | REVISED - |
| | DATE - | REVISED - |

**STATE OF ILLINOIS
DEPARTMENT OF TRANSPORTATION**

| | | | |
|---|-----------|-----------|--------------|
| I-90/94 (KENNEDY EXPRESSWAY) PROPOSED TYPICAL SECTIONS | | | |
| SCALE: | SHEET NO. | OF SHEETS | STA. TO STA. |

| | | | | |
|---|--------------|--------|---------------------------|-----------|
| F.A.I. RTE. | SECTION | COUNTY | TOTAL SHEETS | SHEET NO. |
| 90/94 | 0303-474HB-R | COOK | 368 | 27 |
| FED. ROAD DIST. NO. 1 ILLINOIS FED. AID PROJECT | | | CONTRACT NO. 60F63 | |

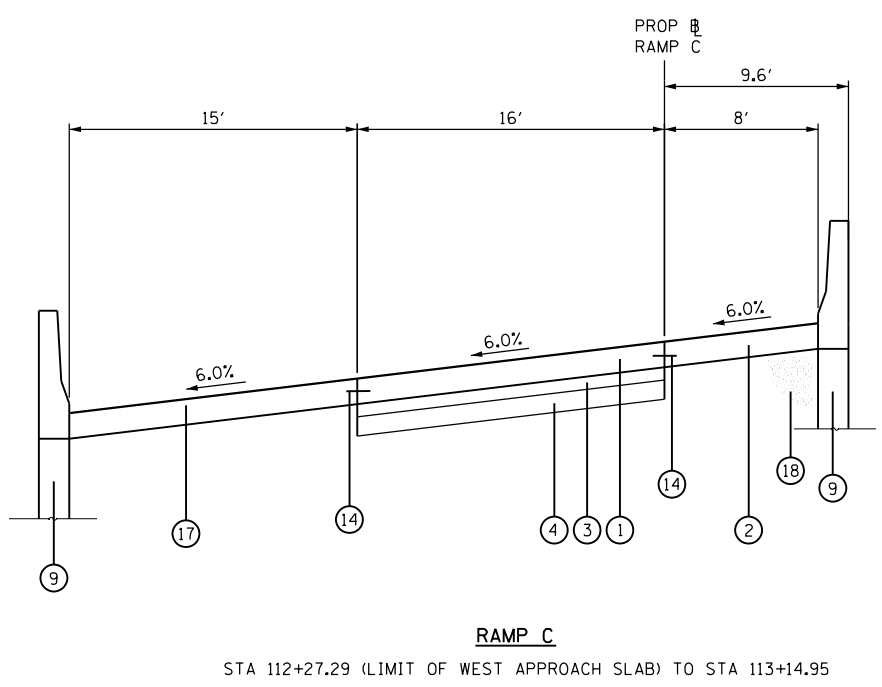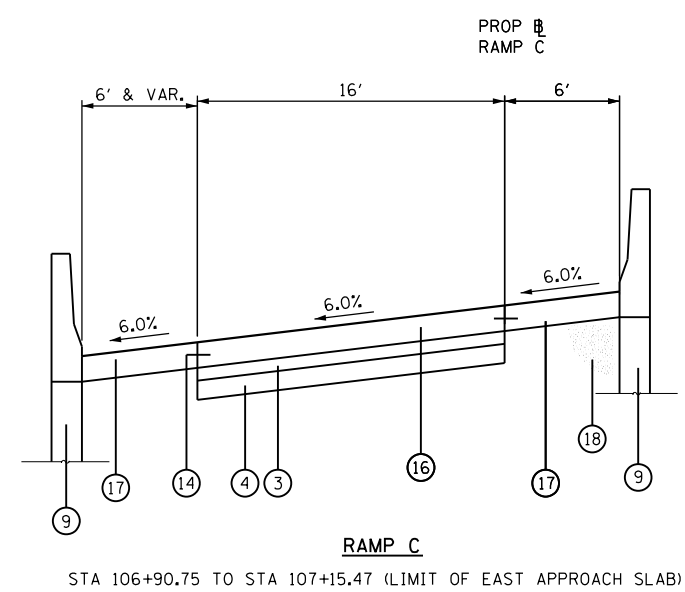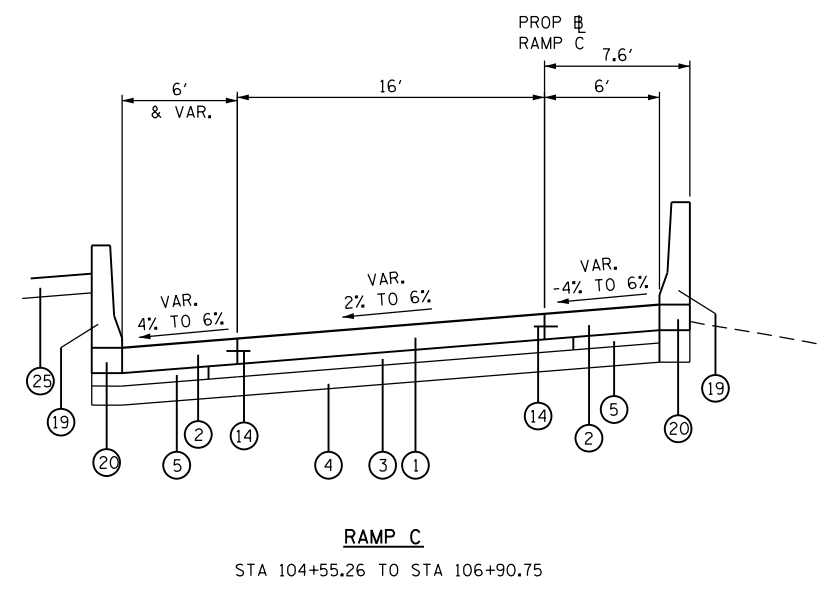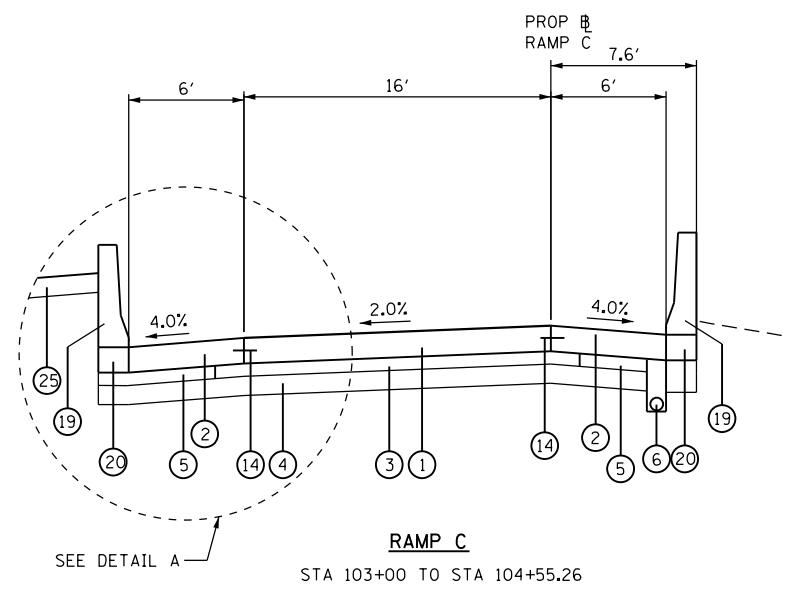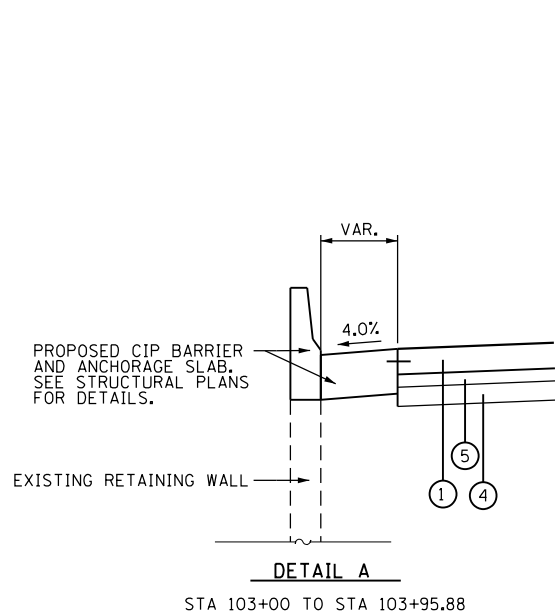

- PROPOSED LEGEND:**
- ① PORTLAND CEMENT CONCRETE PAVEMENT, 10-1/4" (JOINTED)
 - ② PORTLAND CEMENT CONCRETE SHOULDERS, 10-1/4"
 - ③ STABILIZED SUBBASE, HOT-MIX ASPHALT, 4 1/2"
 - ④ AGGREGATE SUBGRADE IMPROVEMENT, 12"
 - ⑤ SUBBASE GRANULAR MATERIAL, TYPE C, 4 1/2"
 - ⑥ PROPOSED PIPE UNDERDRAIN, 4"
 - ⑦ AGGREGATE SHOULDERS, TYPE B, 10"
 - ⑧ CONCRETE RETAINING WALL (PROPOSED)
 - ⑨ MECHANICALLY STABILIZED EARTH RETAINING WALL (PROPOSED)
 - ⑩ EROSION CONTROL BLANKET
 - ⑪ TOPSOIL FURNISH AND PLACE, 4"
 - ⑫ SEEDING, CLASS 2A
 - ⑬ STEEL PLATE BEAM GUARDRAIL
 - ⑭ LONGITUDINAL CONSTRUCTION JOINT WITH NO. 6 TIE BARS @ 24" CENTERS (INCLUDED IN THE COST OF PCC PAVEMENT)
 - ⑮ LONGITUDINAL CONSTRUCTION JOINT WITH NO. 6 TIE BARS DRILL AND GROUT IN PLACE (INCLUDED IN THE COST OF PCC PAVEMENT)
 - ⑯ BRIDGE APPROACH PAVEMENT CONNECTOR (PCC)
 - ⑰ ANCHORAGE SLAB (SEE STRUCT. PLANS)
 - ⑱ REINFORCED SOIL MASS (SEE STRUCT. PLANS)
 - ⑲ CONCRETE BARRIER, SINGLE FACE, 42" (SPECIAL), TYPE 1
 - ⑳ CONCRETE BARRIER BASE (SPECIAL)
 - ㉑ CONCRETE BARRIER, SINGLE FACE, 42" (SPECIAL), TYPE 2
 - ㉒ PORTLAND CEMENT CONCRETE SHOULDERS, 12"
 - ㉓ AGGREGATE SUBGRADE IMPROVEMENT, UNDERCUT
 - ㉔ GEOTECHNICAL FABRIC FOR GROUND STABILIZATION
 - ㉕ PROTECTIVE CONCRETE SLAB (SEE STRUCT. PLANS)
 - ㉖ CONTINUOUSLY REINFORCED CONCRETE PAVEMENT, 12"

HOT-MIX ASPHALT MIXTURE REQUIREMENTS

| MIXTURE TYPE | AIR VOIDS |
|--|--------------|
| STABILIZED SUBBASE | |
| STABILIZED SUBBASE, HOT-MIX ASPHALT, 4 1/2" | 3% @ 50 GYR. |
| TEMPORARY PAVEMENT (NON-INTERSTATE) | |
| HOT-MIX ASPHALT SURFACE COURSE, MIX "D" N50 (IL 9.5mm), 2" | 4% @ 50 Gyr |
| TEMPORARY PAVEMENT (HMA BINDER IL-19 MM), 8" | 4% @ 50 Gyr |

- 1) THE UNIT WEIGHT USED TO CALCULATE ALL HMA SURFACE MIXTURE QUANTITIES IS 112 LBS/SOYD/IN
- 2) THE "AC TYPE" FOR POLMERIZED HMA MIXTURES SHALL BE "SBS/SBR PG 76-22" AND FOR NON-POLYMERIZED HMA THE "AC TYPE" SHALL BE "PG 64-22" UNLESS MODIFIED BY DISTRICT ONE SPECIAL PROVISIONS.
- 3) FOR USE OF RECYCLED MATERIALS, SEE SPECIAL PROVISIONS.
- 4) THE CONTRACTOR HAS THE OPTION TO USE PC TEMPORARY PAVEMENT. PC CONCRETE TEMPORARY PAVEMENT SHALL CONSIST OF CLASS PV CONCRETE MEETING THE REQUIREMENTS OF ART. 1020 OF THE STANDARD SPECIFICATIONS"; TYPICALLY 8" THICK.
- 5) TEMPORARY PAVEMENT DOES NOT REQUIRE DOWEL BAR.

| | | |
|---|-----------|-------------|
| STRUCTURAL DESIGN TRAFFIC (RAMP C) | | YEAR = 2012 |
| PV = 14080 | SU = 1440 | MU = 480 |
| ROAD / STREET CLASSIFICATION: CLASS: I | | |
| PERCENT OF STRUCTURAL TRAFFIC IN DESIGN LANE: | | |
| PV = 100% | SU = 100% | MU = 100% |
| TRAFFIC FACTOR ACTUAL TF = 10.87 | | |
| MINIMUM TF = | | |
| PG GRADE: BINDER: N/A SURFACE: N/A | | |
| SUBGRADE SUPPORT RATING: | | |
| SSR = POOR | | |

**BRIDGE OMISSION
RAMP C
STA 107+15.47 TO STA 112+27.29**



| | | |
|-----------------------------|------------|-----------|
| USER NAME = rge11 | DESIGNED - | REVISED - |
| PLOT SCALE = 10,0000' / in. | DRAWN - | REVISED - |
| PLOT DATE = 3/25/2013 | CHECKED - | REVISED - |
| | DATE - | REVISED - |


**STATE OF ILLINOIS
DEPARTMENT OF TRANSPORTATION**

| | | | |
|---|-----------|-----------|--------------|
| RAMP C PROPOSED TYPICAL SECTIONS | | | |
| SCALE: | SHEET NO. | OF SHEETS | STA. TO STA. |

| | | | | |
|---|--------------|--------|--------------|-----------|
| F.A.I. RTÉ. | SECTION | COUNTY | TOTAL SHEETS | SHEET NO. |
| 90/94 | 0303-474HB-R | COOK | 368 | 28 |
| CONTRACT NO. 60F63 | | | | |
| FED. ROAD DIST. NO. 1 ILLINOIS FED. AID PROJECT | | | | |

FILE NAME = \\collinsengr.com\1\adator\1\Posanden\DDCS\Y2000 - 134.ctb\hvo.Street\CADD\CADD_SHEETS\0160F63-ht-1up2.dgn

FILE NAME = \\collinsengr.com\1\adate\1\Posarden\DDCS\7200 - 194 at Ohio Street\CADD\CADD SHEETS\0160F63-ht-tpz.dgn

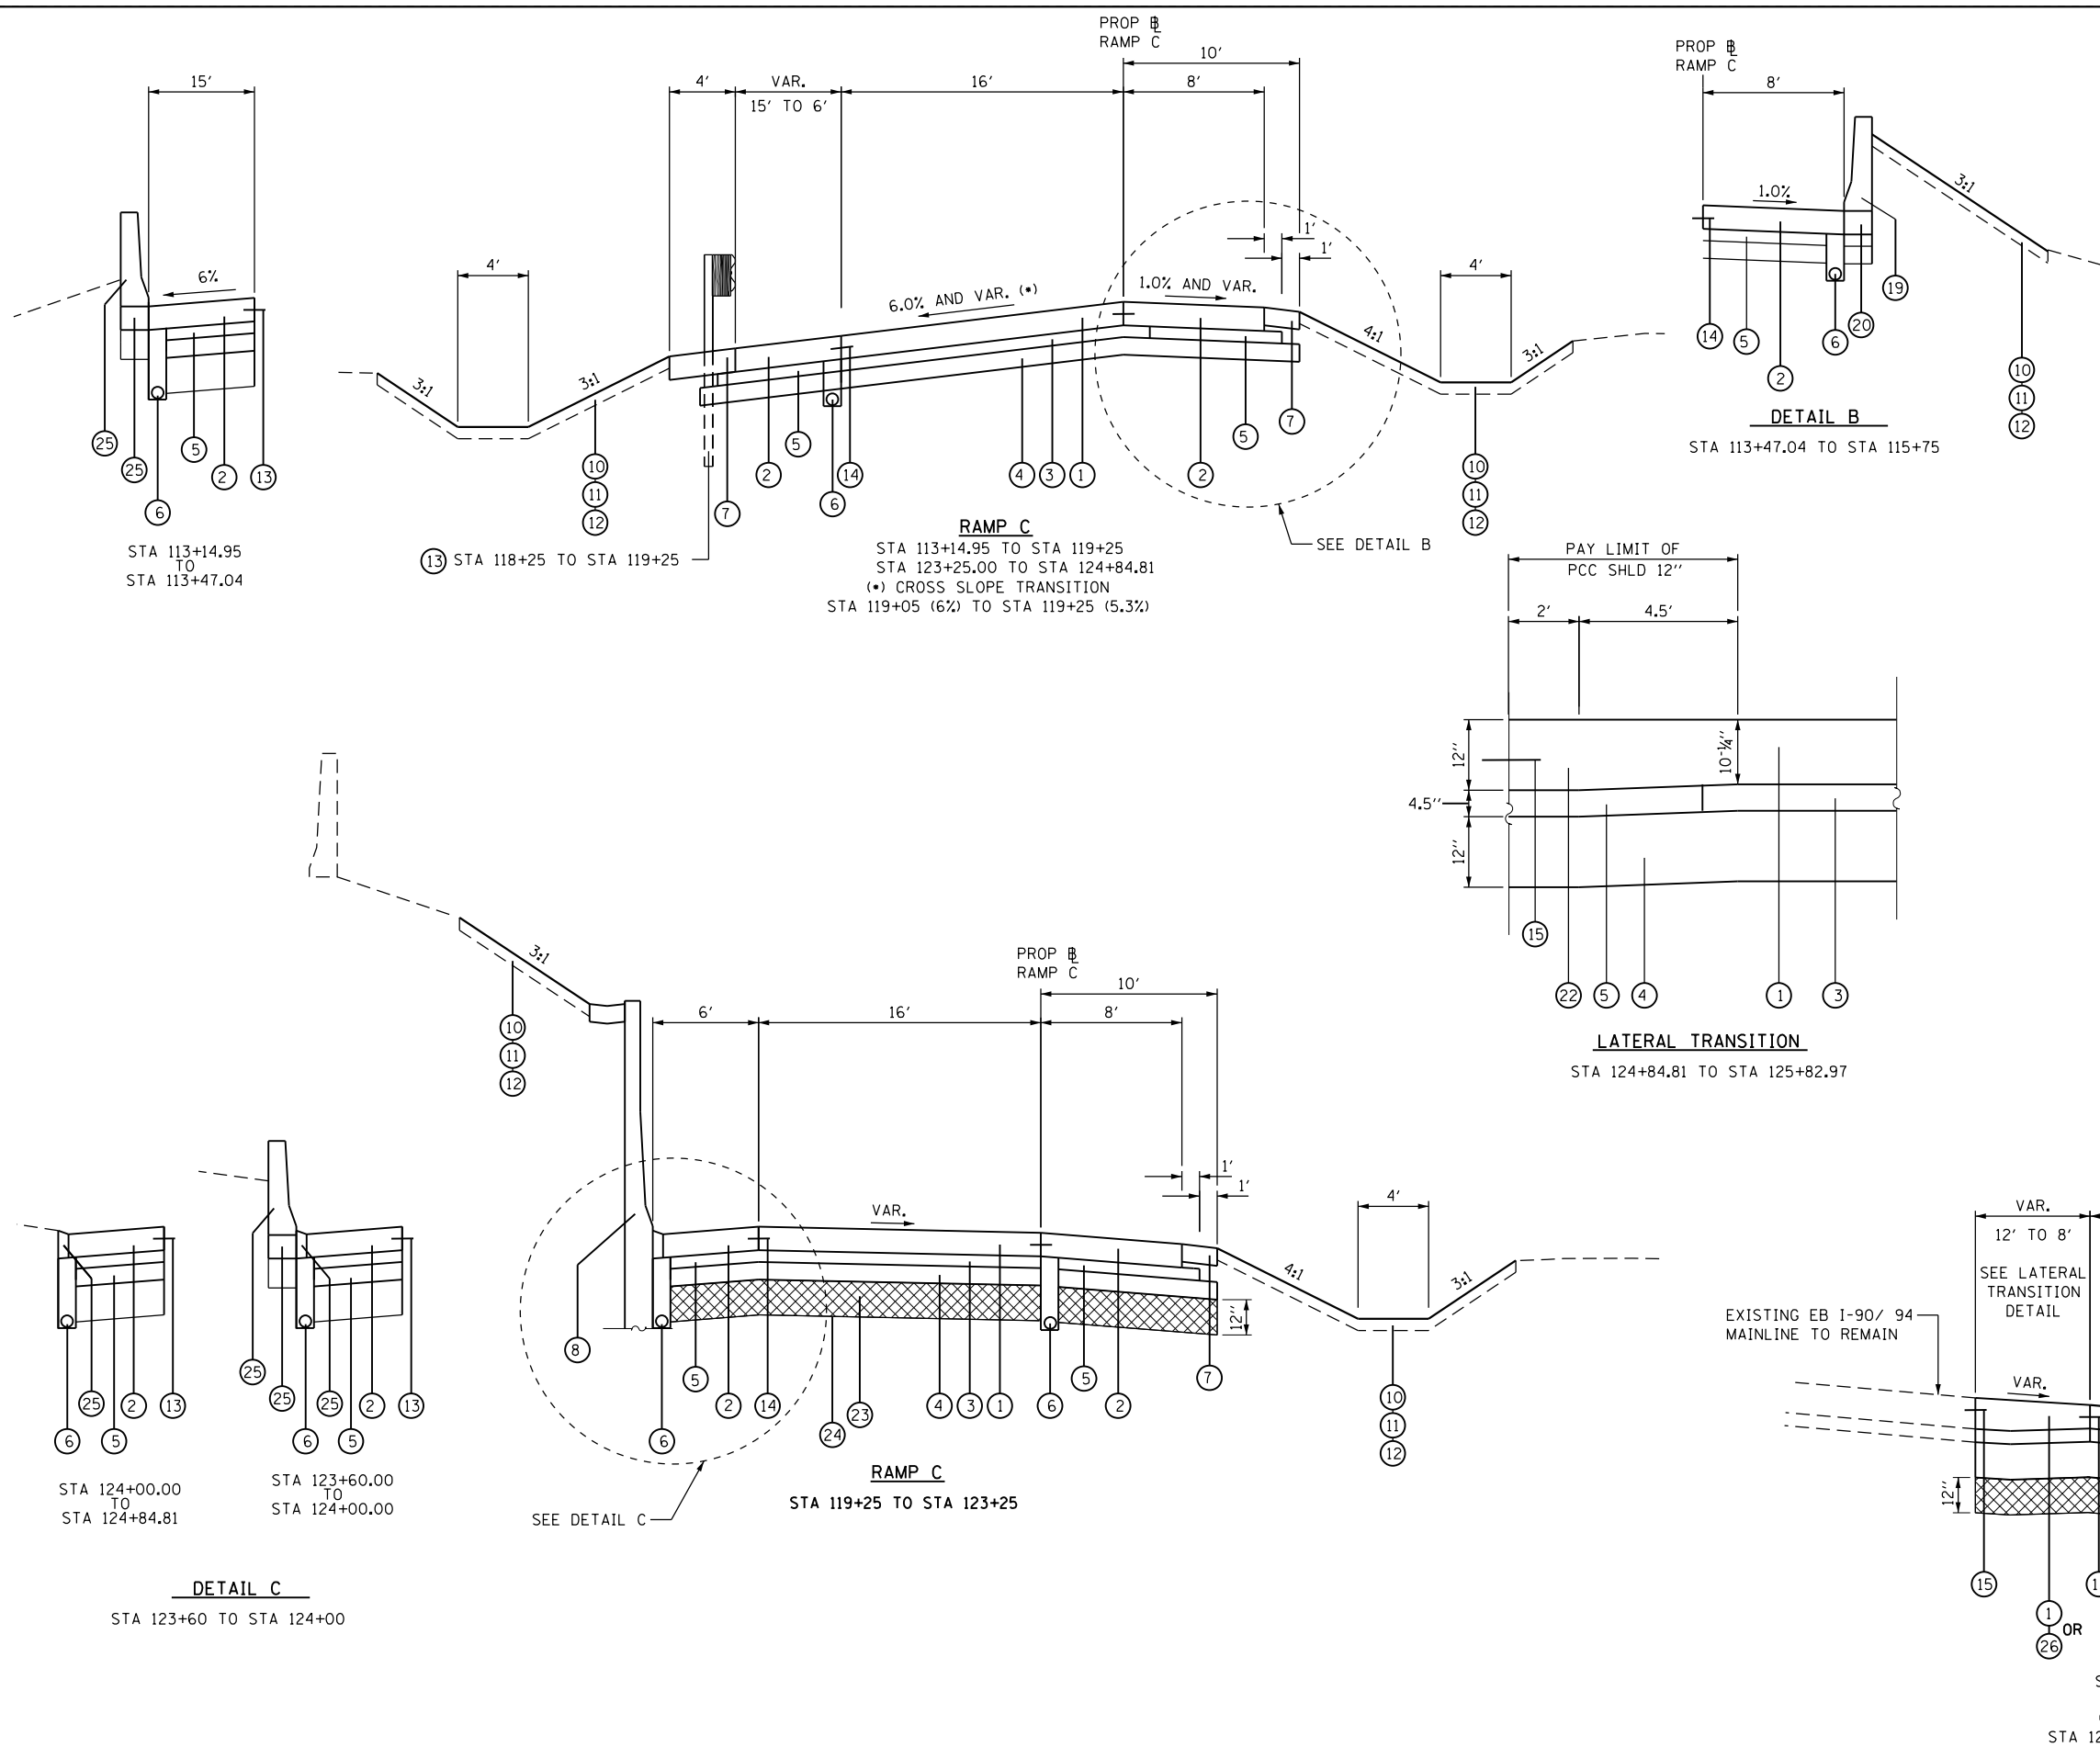

- PROPOSED LEGEND:**
- ① PORTLAND CEMENT CONCRETE PAVEMENT, 10-1/4" (JOINTED)
 - ② PORTLAND CEMENT CONCRETE SHOULDERS, 10-1/4"
 - ③ STABILIZED SUBBASE, HOT-MIX ASPHALT, 4 1/2"
 - ④ AGGREGATE SUBGRADE IMPROVEMENT, 12"
 - ⑤ SUBBASE GRANULAR MATERIAL, TYPE C, 4 1/2"
 - ⑥ PROPOSED PIPE UNDERDRAIN, 4"
 - ⑦ AGGREGATE SHOULDERS, TYPE B, 10"
 - ⑧ CONCRETE RETAINING WALL (PROPOSED)
 - ⑨ MECHANICALLY STABILIZED EARTH RETAINING WALL (PROPOSED)
 - ⑩ EROSION CONTROL BLANKET
 - ⑪ TOPSOIL FURNISH AND PLACE, 4"
 - ⑫ SEEDING, CLASS 2A
 - ⑬ STEEL PLATE BEAM GUARDRAIL
 - ⑭ LONGITUDINAL CONSTRUCTION JOINT WITH NO. 6 TIE BARS @ 24" CENTERS (INCLUDED IN THE COST OF PCC PAVEMENT)
 - ⑮ LONGITUDINAL CONSTRUCTION JOINT WITH NO. 6 TIE BARS DRILL AND GROUT IN PLACE (INCLUDED IN THE COST OF PCC PAVEMENT)
 - ⑯ BRIDGE APPROACH PAVEMENT CONNECTOR (PCC)
 - ⑰ ANCHORAGE SLAB (SEE STRUCT. PLANS)
 - ⑱ REINFORCED SOIL MASS (SEE STRUCT. PLANS)
 - ⑲ CONCRETE BARRIER, SINGLE FACE, 42" (SPECIAL), TYPE 1
 - ⑳ CONCRETE BARRIER BASE (SPECIAL)
 - ㉑ CONCRETE BARRIER, SINGLE FACE, 42" (SPECIAL), TYPE 2
 - ㉒ PORTLAND CEMENT CONCRETE SHOULDERS, 12"
 - ㉓ AGGREGATE SUBGRADE IMPROVEMENT, UNDERCUT
 - ㉔ GEOTECHNICAL FABRIC FOR GROUND STABILIZATION
 - ㉕ PROTECTIVE CONCRETE SLAB (SEE STRUCT. PLANS)
 - ㉖ CONTINUOUSLY REINFORCED CONCRETE PAVEMENT, 12"

COLLINS ENGINEERS

USER NAME = rge11
 PLOT SCALE = 10.0000' / 1"
 PLOT DATE = 3/25/2013

| | |
|------------|-----------|
| DESIGNED - | REVISED - |
| DRAWN - | REVISED - |
| CHECKED - | REVISED - |
| DATE - | REVISED - |


**STATE OF ILLINOIS
 DEPARTMENT OF TRANSPORTATION**

**RAMP C
 PROPOSED TYPICAL SECTIONS**


SCALE: SHEET NO. OF SHEETS STA. TO STA.

| | | | | |
|---|----------------------|-------------|------------------|--------------|
| F.A.I. RTE. 90/94 | SECTION 0303-474HB-R | COUNTY COOK | TOTAL SHEETS 368 | SHEET NO. 29 |
| CONTRACT NO. 60F63 | | | | |
| FED. ROAD DIST. NO. 1 ILLINOIS FED. AID PROJECT | | | | |

FILE NAME = \\collinsengr.com\1\adate\1\Posanden\DDCS\Y2000 - I34 at Ohio Street\CADD\CADD SHEETS\0160F63-ht-tpz.dgn

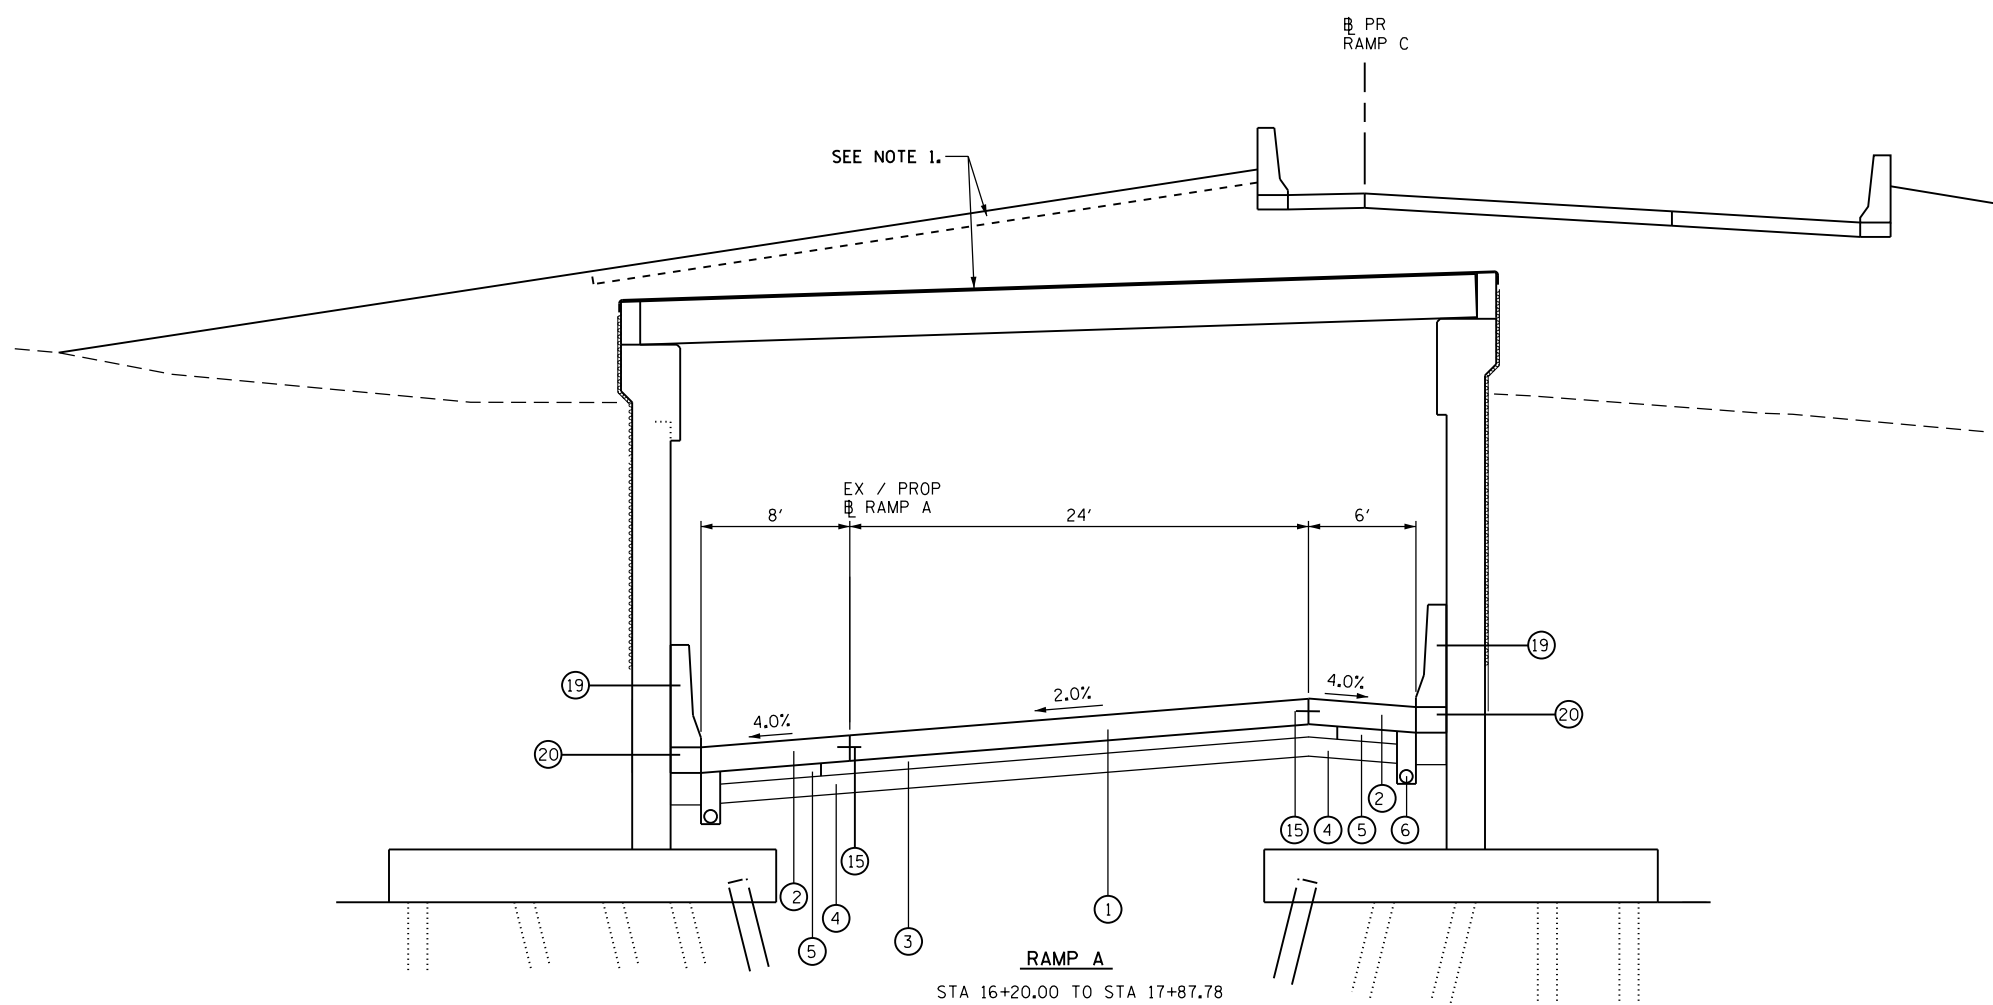

RAMP A
STA 16+20.00 TO STA 17+87.78

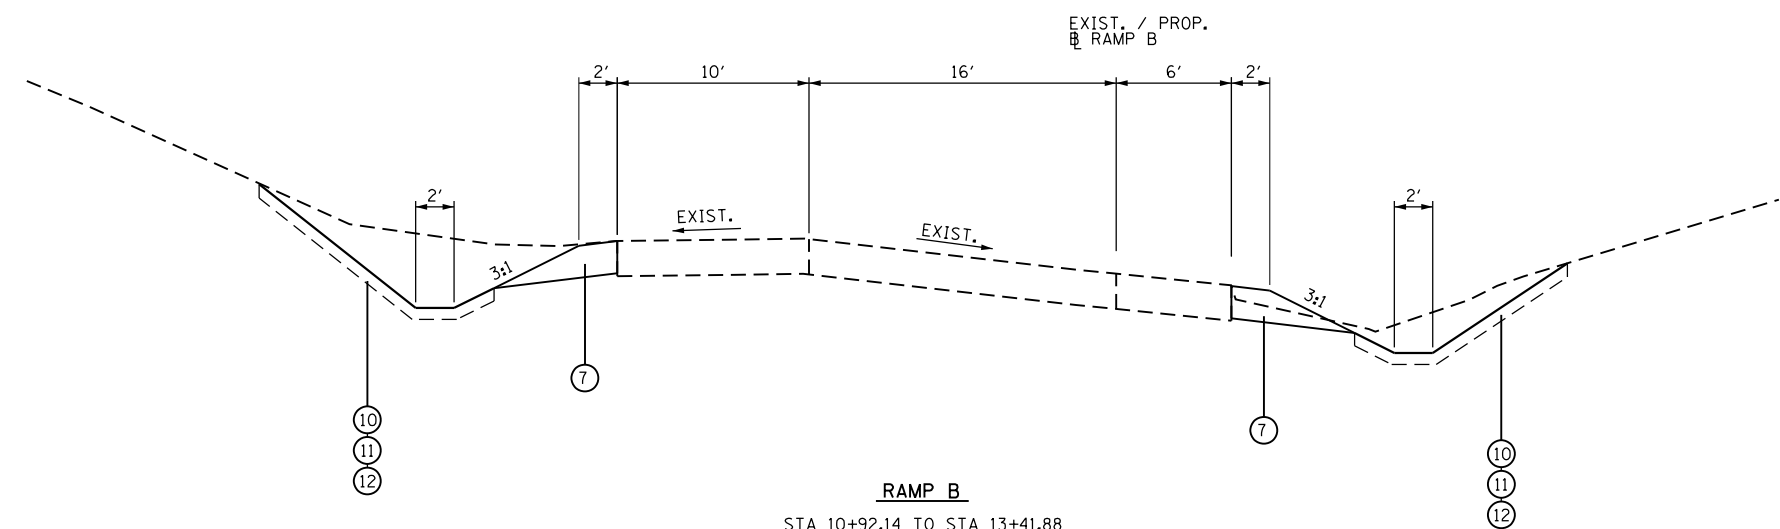

RAMP B
STA 10+92.14 TO STA 13+41.88

- PROPOSED LEGEND:**
- ① PORTLAND CEMENT CONCRETE PAVEMENT, 10-1/4" (JOINTED)
 - ② PORTLAND CEMENT CONCRETE SHOULDERS, 10-1/4"
 - ③ STABILIZED SUBBASE, HOT-MIX ASPHALT, 4 1/2"
 - ④ AGGREGATE SUBGRADE IMPROVEMENT, 12"
 - ⑤ SUBBASE GRANULAR MATERIAL, TYPE C, 4 1/2"
 - ⑥ PROPOSED PIPE UNDERDRAIN, 4"
 - ⑦ AGGREGATE SHOULDERS, TYPE B, 10"
 - ⑧ CONCRETE RETAINING WALL (PROPOSED)
 - ⑨ MECHANICALLY STABILIZED EARTH RETAINING WALL (PROPOSED)
 - ⑩ EROSION CONTROL BLANKET
 - ⑪ TOPSOIL FURNISH AND PLACE, 4"
 - ⑫ SEEDING, CLASS 2A
 - ⑬ STEEL PLATE BEAM GUARDRAIL
 - ⑭ LONGITUDINAL CONSTRUCTION JOINT WITH NO. 6 TIE BARS @ 24" CENTERS (INCLUDED IN THE COST OF PCC PAVEMENT)
 - ⑮ LONGITUDINAL CONSTRUCTION JOINT WITH NO. 6 TIE BARS DRILL AND GROUT IN PLACE (INCLUDED IN THE COST OF PCC PAVEMENT)
 - ⑯ BRIDGE APPROACH PAVEMENT CONNECTOR (PCC)
 - ⑰ ANCHORAGE SLAB (SEE STRUCT. PLANS)
 - ⑱ REINFORCED SOIL MASS (SEE STRUCT. PLANS)
 - ⑲ CONCRETE BARRIER, SINGLE FACE, 42" (SPECIAL), TYPE 1
 - ⑳ CONCRETE BARRIER BASE (SPECIAL)
 - ㉑ CONCRETE BARRIER, SINGLE FACE, 42" (SPECIAL), TYPE 2
 - ㉒ PORTLAND CEMENT CONCRETE SHOULDERS, 12"
 - ㉓ AGGREGATE SUBGRADE IMPROVEMENT, UNDERCUT
 - ㉔ GEOTECHNICAL FABRIC FOR GROUND STABILIZATION
 - ㉕ PROTECTIVE CONCRETE SLAB (SEE STRUCT. PLANS)
 - ㉖ CONTINUOUSLY REINFORCED CONCRETE PAVEMENT, 12"

NOTES:
1. SEE STRUCTURE SN 016-2573 PLANS FOR DETAILS (STA 17+22.62 TO STA 17+87.78)



| | | |
|----------------------------|------------|-----------|
| USER NAME = rge11 | DESIGNED - | REVISED - |
| PLOT SCALE = 10.0000' / 1" | DRAWN - | REVISED - |
| PLOT DATE = 3/25/2013 | CHECKED - | REVISED - |
| | DATE - | REVISED - |

**STATE OF ILLINOIS
DEPARTMENT OF TRANSPORTATION**


**RAMP A AND RAMP B
PROPOSED TYPICAL SECTIONS**

| | | | | | | |
|--------|-----------|----|--------|------|----|------|
| SCALE: | SHEET NO. | OF | SHEETS | STA. | TO | STA. |
|--------|-----------|----|--------|------|----|------|


| | | | | |
|---|--------------|--------|--------------|-----------|
| F.A.I. RTE. | SECTION | COUNTY | TOTAL SHEETS | SHEET NO. |
| 90/94 | 0303-474HB-R | COOK | 368 | 30 |
| CONTRACT NO. 60F63 | | | | |
| FED. ROAD DIST. NO. 1 ILLINOIS FED. AID PROJECT | | | | |

PROPOSED LEGEND:

- ① PORTLAND CEMENT CONCRETE PAVEMENT, 10-1/4" (JOINTED)
- ② PORTLAND CEMENT CONCRETE SHOULDERS, 10-1/4"
- ③ STABILIZED SUBBASE, HOT-MIX ASPHALT, 4 1/2"
- ④ AGGREGATE SUBGRADE IMPROVEMENT, 12"
- ⑤ SUBBASE GRANULAR MATERIAL, TYPE C, 4 1/2"
- ⑥ PROPOSED PIPE UNDERDRAIN, 4"
- ⑦ AGGREGATE SHOULDERS, TYPE B, 10"
- ⑧ CONCRETE RETAINING WALL (PROPOSED)
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- ⑩ EROSION CONTROL BLANKET
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- ⑫ SEEDING, CLASS 2A
- ⑬ STEEL PLATE BEAM GUARDRAIL
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- ⑲ CONCRETE BARRIER, SINGLE FACE, 42" (SPECIAL), TYPE 1
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- ㉑ CONCRETE BARRIER, SINGLE FACE, 42" (SPECIAL), TYPE 2
- ㉒ PORTLAND CEMENT CONCRETE SHOULDERS, 12"
- ㉓ AGGREGATE SUBGRADE IMPROVEMENT, UNDERCUT
- ㉔ GEOTECHNICAL FABRIC FOR GROUND STABILIZATION
- ㉕ PROTECTIVE CONCRETE SLAB (SEE STRUCT. PLANS)
- ㉖ CONTINUOUSLY REINFORCED CONCRETE PAVEMENT, 12"

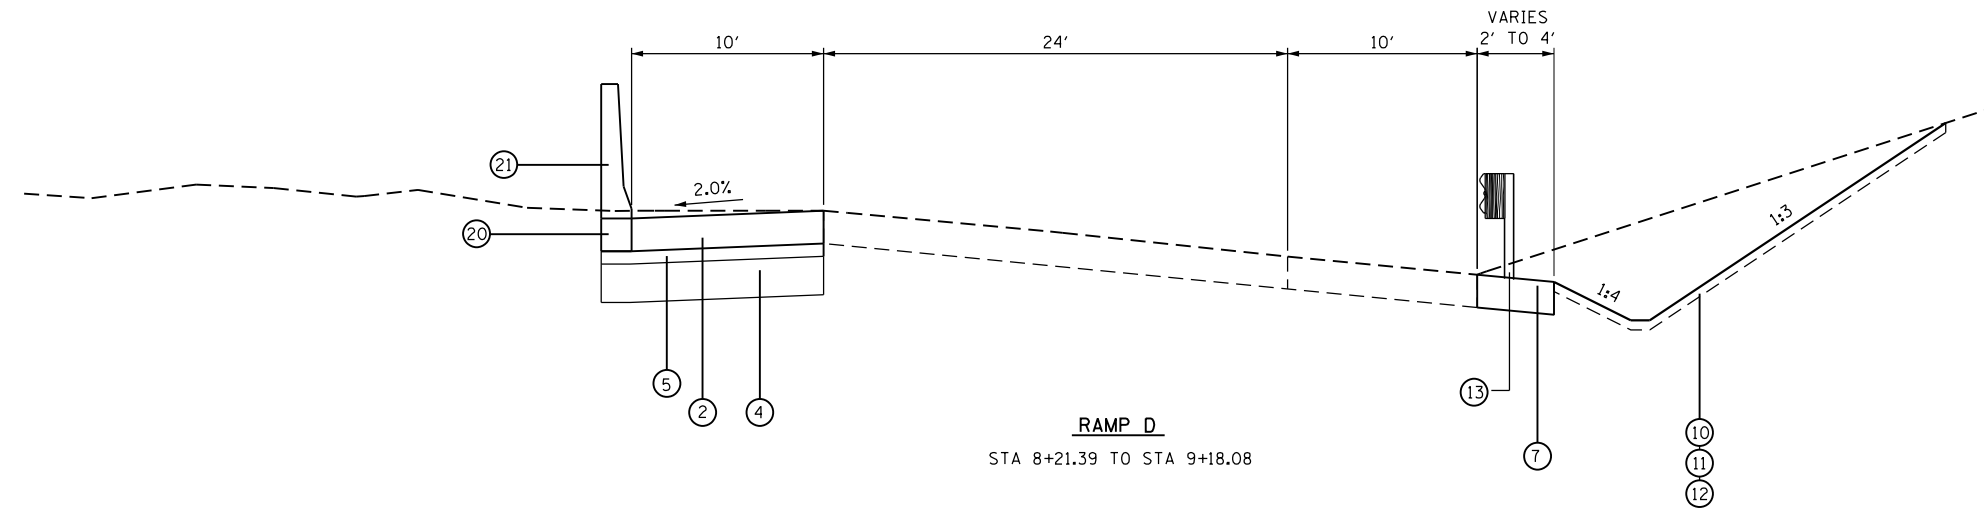

RAMP D
STA 8+21.39 TO STA 9+18.08

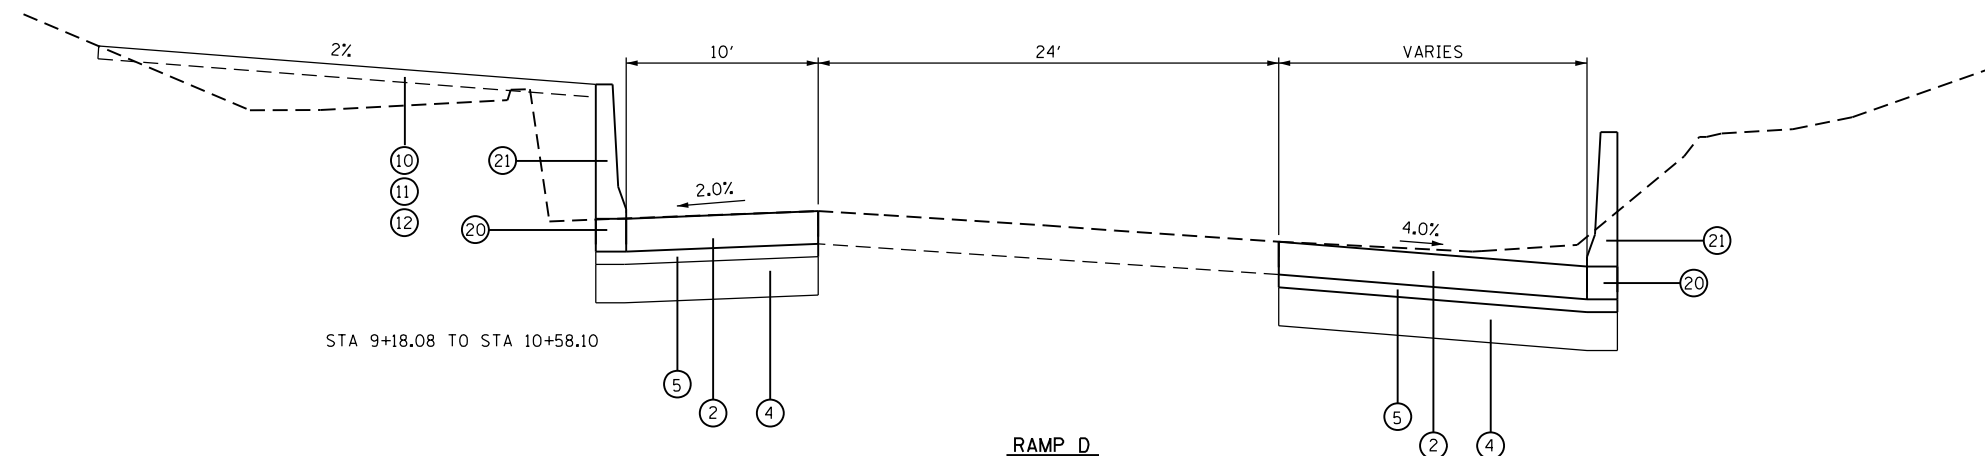

RAMP D
STA 9+18.08 TO STA 11+06.71

FILE NAME = \\collinsengr.com\1\adate\1\Posanden\DDCS\7000 - I34 at Ohio Street\CADD\CADD SHEETS\0160F63-ht-tpz.dgn



| | | |
|-----------------------------|------------|-----------|
| USER NAME = rge11 | DESIGNED - | REVISED - |
| PLOT SCALE = 10.0000' / in. | DRAWN - | REVISED - |
| PLOT DATE = 3/25/2013 | CHECKED - | REVISED - |
| | DATE - | REVISED - |

STATE OF ILLINOIS
DEPARTMENT OF TRANSPORTATION

| | | | |
|----------------------------------|-----------|-----------|--------------|
| RAMP D | | | |
| PROPOSED TYPICAL SECTIONS | | | |
| SCALE: | SHEET NO. | OF SHEETS | STA. TO STA. |

| | | | | |
|---|--------------|--------|--------------|-----------|
| F.A.I. RE. | SECTION | COUNTY | TOTAL SHEETS | SHEET NO. |
| 90/94 | 0303-474HB-R | COOK | 368 | 31 |
| CONTRACT NO. 60F63 | | | | |
| FED. ROAD DIST. NO. 1 ILLINOIS FED. AID PROJECT | | | | |

PROPOSED PAVEMENT

| LOCATION | STATION | | AGG SUBGRADE 12" (SQ YD) | STAB SUBBASE 4" (SQ YD) | PCC PVT 10-1/4" JOINTED (SQ YD) | BRIDGE APPROACH PVT CONNECTOR (SQ YD) | CRC 12" (SQ YD) | AGG SHLD, TY B 8" (SQ YD) | PCC SHLD, 10- 1/4" (SQ YD) | PCC SHLD, 12" (SQ YD) | |
|--------------|-----------|-----------|-----------------------------|----------------------------|------------------------------------|---|--------------------|---------------------------------|-------------------------------|--------------------------|--|
| | FROM | TO | | | | | | | | | |
| RAMP A | 09+19.73 | 10+26.31 | 670 | 670 | 422 | | | | 248 | | |
| RAMP C | 103+00.00 | 106+01.10 | | | 535 | | | | 508 | | |
| RAMP C | 106+01.10 | 107+21.79 | 6659 | 6659 | | 318 | | | | | |
| RAMP C | 112+18.45 | 113+39.17 | | | | 409 | | | | | |
| RAMP C | 113+39.17 | 126+84.08 | | | | | 2378 | | 686 | 2300 | |
| RAMP C | 126+84.08 | 127+90.43 | | | | | | 212 | | | |
| RAMP B | 10+92.14 | 13+41.88 | | | | | | | 111 | | |
| RAMP D | 08+20.00 | 11+06.71 | 624 | 624 | | | 40 | 624 | | | |
| I-90/94 (WB) | 117+27.29 | 120+67.75 | 486 | 486 | | | | | | 486 | |
| I-90/94 (EB) | 207+03.90 | 221+02.35 | 962 | 962 | | | | | | 962 | |
| TOTAL | | | 9400 | 9400 | 3334 | 727 | 212 | 837 | 3679 | 1447 | |

PROPOSED BARRIER WALL

| LOCATION | STATION | | OFFSET | CONC BAR, VAR. CROSS SECT, 42" (LF) | CONC BAR, 1F, 42" HT SPL (LF) | CONC BAR BASE (LF) | CONC BAR TRANSITION (LF) |
|------------|-----------|-----------|--------|---|----------------------------------|-----------------------|--------------------------------|
| | FROM | TO | | | | | |
| I-90/94 WB | 11727.78 | 12024.64 | RT | | 297 | 297 | |
| I-90/94 WB | 119+17.13 | 120+67.79 | RT | 151 | | 151 | |
| I-90/94 EB | 219+40.64 | 221+02.38 | LT | 162 | | 162 | |
| I-90/94 EB | 219+40.64 | 221+02.38 | RT | 162 | | 162 | |
| I-90/94 EB | 219+64.21 | 222+26.42 | RT | | 285 | 285 | |
| RAMP C | 103+00.00 | 106+90.75 | RT | | 391 | 391 | |
| | 103+00.00 | 106+90.75 | LT | | 391 | 391 | |
| | 113+14.95 | 113+47.04 | LT | | 32 | 32 | |
| | 113+14.95 | 115+75.22 | RT | | 260 | 260 | |
| | 119+20.00 | 120+00.00 | LT | | 80 | 80 | 15 |
| | 123+60.00 | 124+00.00 | LT | | 40 | 40 | |
| | 123+60.00 | 124+00.00 | LT | | 40 | 40 | |
| | 16+20.00 | 17+87.77 | RT | | 168 | 168 | |
| | 16+20.00 | 17+87.77 | LT | | 168 | 168 | |
| RAMP D | 09+18.08 | 11+06.71 | RT | | 189 | 189 | 15 |
| RAMP D | 07+93.59 | 10+58.12 | LT | | 285 | 285 | |
| TOTAL | | | | 474 | 2625 | 3100 | 30 |

PROPOSED BARRIER WALL

| LOCATION | STATION | | OFFSET | IMP ATT T3 (NON- REDIRECTIVE) | TR BAR TRMT1 SPL TAN (EACH) | TR BAR TRM T6 (EACH) | GUARDRAIL MARKERS (EACH) | TERM MARK DIRECT APPLIED (EACH) |
|----------|-----------|----|--------|----------------------------------|--------------------------------|-------------------------|--------------------------------|---------------------------------------|
| | FROM | TO | | | | | | |
| RAMP C | 118+39.88 | | LT | | | 1 | | |
| RAMP C | 118+61.00 | | LT | | 1 | | 4 | 1 |
| RAMP D | 07+93.59 | | LT | 1 | | | 4 | |
| RAMP D | 08+46.00 | | RT | | 1 | | | 1 |
| RAMP D | 08+88.00 | | RT | | | 1 | | |
| TOTAL | | | | 1 | 2 | 2 | 8 | 2 |

FILE NAME = I:\7000 - 194 at Ohio Street\CADD\CADD_SHEETS\160663-SCHEDULES.dgn



| | | |
|----------------------------|------------|-----------|
| USER NAME = rge11 | DESIGNED - | REVISED - |
| PLOT SCALE = 2.0000' / in. | DRAWN - | REVISED - |
| PLOT DATE = 3/25/2013 | CHECKED - | REVISED - |
| | DATE - | REVISED - |

**STATE OF ILLINOIS
DEPARTMENT OF TRANSPORTATION**

| | | | |
|--|-----------|-----------|--------------|
| I-90/94 AT OHIO STREET SCHEDULE OF QUANTITIES | | | |
| SCALE: | SHEET NO. | OF SHEETS | STA. TO STA. |

| | | | | |
|---|-------------------------|----------------|------------------------|--------------------|
| F.A.I. RTE. 90/94 | SECTION 0303-474HB-R | COUNTY COOK | TOTAL SHEETS 368 | SHEET NO. 32 |
| FED. ROAD DIST. NO. 1 ILLINOIS FED. AID PROJECT | | | CONTRACT NO. 60F63 | |

PROPOSED DRAINAGE STRUCTURES

| PIPE NUMBER | U/S STRUCTURE | D/S STRUCTURE | TYPE | DIA (IN) | LENGTH (FT) | SLOPE (%) | TBF (CY) |
|-------------|---------------|---------------|------|----------|-------------|-----------|----------|
| P-1 | 1 | EX MH | TY 4 | 12 | 77.0 | 3.6% | 0.0 |
| P-2 | 3 | 2 | TY 2 | 12 | 5.4 | 1.1% | 4.0 |
| P-3 | 4 | 3 | TY 2 | 12 | 81.2 | 1.0% | 0.0 |
| P-4 | 5B | EX CB | TY 4 | 12 | 6.0 | 1.0% | 1.0 |
| P-5 | 6 | 6A | TY 4 | 12 | 3.0 | 9.0% | 1.0 |
| P-6 | 6A | 8 | TY 4 | 12 | 20.5 | 1.0% | 1.0 |
| P-7 | 8A | 9A | TY 4 | 15 | 8.0 | 1.0% | 1.0 |
| P-8 | 7 | 9 | TY 4 | 12 | 5.2 | 1.0% | 1.0 |
| P-9 | 9 | 9A | TY 4 | 15 | 28.0 | 1.0% | 15.0 |
| P-10 | 9A | 11 | TY 2 | 18 | 98.6 | 1.0% | 44.0 |
| P-11 | 10 | 9A | TY 4 | 12 | 3.0 | 8.3% | 1.0 |
| P-12 | 8 | 8A | TY 4 | 12 | 3.0 | 8.3% | 1.0 |
| P-13 | 12 | 13 | TY 4 | 10 | 13.0 | 0.6% | 1.0 |
| P-14 | 14 | 15 | TY 4 | 12 | 17.2 | 1.0% | 1.0 |
| P-15 | 16 | 15 | TY 4 | 12 | 3.0 | 1.0% | 1.0 |
| P-16 | 17 | 17A | TY 4 | 12 | 48.0 | 3.5% | 0.0 |
| P-17 | 18 | 18A | TY 4 | 10 | 43.0 | 1.0% | 5.0 |
| P-18 | 19A | 19 | TY 2 | 12 | 53.0 | 1.0% | 1.0 |
| P-19 | 20 | 19 | TY 2 | 12 | 89.4 | 0.8% | 0.0 |
| P-20 | 20A | 20 | TY 4 | 12 | 115.6 | 1.0% | 41.0 |
| P-21 | 29 | 28 | TY 4 | 12 | 13.3 | 1.1% | 0.0 |
| P-22 | 28 | EX MH | TY 4 | 15 | 39.2 | 2.8% | 6.0 |
| P-23 | 21 | 22 | TY 2 | 12 | 1.7 | 2.9% | 0.0 |
| P-24 | 22 | 23 | TY 2 | 12 | 12.7 | 0.9% | 0.0 |
| P-25 | 23 | 26 | TY 4 | 12 | 88.0 | 2.3% | 0.0 |
| P-26 | 24 | 25 | TY 4 | 12 | 7.0 | 1.4% | 0.0 |
| P-27 | 25 | 26 | TY 4 | 12 | 48.1 | 1.0% | 4.0 |

PROPOSED DRAINAGE PIPES

| STRUCTURE NUMBER | ALIGN | STATION | OFFSET | STRUCTURE TYPE | | | DIA (FT.) | FRAME & LID | TOP OF FRAME | N INV. | E INV. | S INV. | W INV. |
|------------------|------------|-----------|-----------|----------------|----|-----|-----------|-------------|--------------|-------------|-------------|-------------|-------------|
| | | | | MH/FES | CB | INL | | | | | | | |
| 1 | RAMP C | 106+46.12 | 22.0' LT | | A | | 4 | T24F&G | 600.23 | | | 580.00 | |
| 2 | I-90/94 WB | 118+17.42 | 34.1' RT | | A | | 4 | T24F&G | 577.72 | 573.05 | | | |
| 3 | I-90/94 WB | 118+17.50 | 39.3' RT | A | | | 4 | T1F CL | 582.00 | | | 573.11 | 573.19 |
| 4 | I-90/94 WB | 119+02.82 | 38.5' RT | | A | | 4 | T8G | 579.00 | | 574.00 | | |
| 5 | I-90/94 WB | 119+21.22 | 34.0' RT | | A | | 4 | T24F&G | 578.01 | | | | 574.00 |
| 5A | I-90/94 EB | 220+70.24 | 33.7' LT | | A | | 4 | T24F&G | 578.43 | | | | 574.00 |
| 5B | RAMP D | 008+24.07 | 24.4' LT | | | A | 4 | T24F&G | 577.64 | 574.26 | | | |
| 6 | RAMP A | 017+68.86 | 7.67' LT | | | A | 4 (P) | T24F&G | 573.00 | | | 570.67 | |
| 6A | RAMP A | 017+68.86 | 2.0' LT | A | | | 4 | T1F CL | 573.23 | 570.40 | | | 570.32 |
| 7 | RAMP A | 017+39.50 | 29.27' RT | | | A | 4 | T3F&G | 573.52 | | | | 570.46 |
| 8 | RAMP A | 017+43.43 | 7.63' LT | | | A | 4 (P) | T3F&G | 573.01 | | | 570.85 | |
| 8A | RAMP A | 017+43.43 | 2.0' LT | | | A | 4 | T1F OL | 573.26 | 570.60 | 570.12 | | 570.04 |
| 9 | RAMP A | 017+30.43 | 28.94' RT | | | A | 4 | T3F&G | 573.48 | 567.81 | 570.41 | | |
| 9A | RAMP A | 017+30.47 | 2.0' LT | | | A | 5 | T1F OL | 573.21 | 570.55 | 569.96 | 567.67 | 567.09 |
| 10 | RAMP A | 017+30.47 | 7.61' LT | | | A | 4 (P) | T3F&G | 572.96 | | | 570.80 | |
| 11 | RAMP A | 016+29.11 | 8.1' LT | | | A | 4 | T24F&G | 573.71 | | 566.10 | 565.95 | |
| 12 | RAMP D | 010+32.00 | 21.0' RT | A | | | 4 | T1F CL | 577.11 | 574.41 (EX) | | 574.49 | |
| 13 | RAMP D | 010+45.56 | 33.1' RT | | | A | 4 | T8G | 577.80 | 574.57 | | | |
| 14 | RAMP D | 010+99.88 | 27.4' RT | | | A | 4 | T24F&G | 577.98 | | | 575.30 | |
| 15 | RAMP D | 011+21.07 | 27.1' RT | | | A | 4 | T24F&G | 578.23 | 575.10 (NW) | 575.03 (SE) | 575.10 (SW) | |
| 16 | RAMP D | 011+19.82 | 29.4' RT | | | A | 4 | T8G | 578.50 | 575.13 (NE) | | | |
| 17 | RAMP C | 113+44.35 | 31.0' LT | | | A | 4 | TYPE D INL | 599.89 | | 581.47 | | |
| 17A | RAMP C | 113+42.73 | 75.82' LT | | | A | 4 | T1F CL | 584.70 | 576.00 (NE) | | | 580.00 |
| 18 | RAMP C | 115+73.60 | 8.0' RT | | | A | 4 | T24F&G | 596.03 | | 592.41 | | |
| 18A | RAMP C | 116+00.00 | 31.0' LT | FES | | | 12 | | | | | | 591.98 |
| 19 | RAMP C | 117+47.00 | 32.3' LT | | | A | 5 | T8G | 588.22 | 577.42 (EX) | 578.33 | 583.31 | |
| 19A | RAMP C | 117+70.00 | 18.5' RT | | | A | 4 | T8G | 588.73 | 583.88 | | | |
| 20 | RAMP C | 118+50.00 | 34.5' LT | | | A | 4 | T8G | 585.58 | | | 579.02 (SE) | 579.02 |
| 20A | RAMP C | 119+50.00 | 20.0' RT | | | A | 4 | T8G | 584.01 | 580.25 (NW) | | | |
| 21 | RAMP C | 123+97.54 | 22.0' LT | | | A | 4 | T24F&G | 574.25 | | 569.60 | | |
| 22 | RAMP C | 123+97.54 | 24.9' LT | | | A | 4 | T10F&G | 574.27 | 569.47 (NE) | | 569.55 (SW) | |
| 23 | RAMP C | 124+05.39 | 42.0' LT | | | A | 4 | T8G | 573.39 | | 569.27 (SE) | | 569.35 (SW) |
| 24 | RAMP C | 124+50.00 | 19.0' RT | | | A | 4 | 604101 | 571.40 | | 568.80 | | |
| 25 | RAMP C | 124+60.00 | 19.0' RT | | | A | 4 | 604101 | 571.45 | | 568.62 (NE) | | 568.70 (NW) |
| 26 | RAMP C | 124+89.98 | 24.0' LT | | | A | 5 | T24F&G | 574.28 | 567.28 (NW) | 568.03 (NE) | 568.11 (SW) | |
| 27 | NOT USED | | | | | | | | | | | | |
| 28 | RAMP B | 010+82.00 | 17.0' RT | | | A | 4 | T8G | 570.65 | 567.59 | | | 566.87 |
| 29 | RAMP B | 011+00.00 | 17.0' RT | | | A | 4 | T8G | 571.18 | | | 567.74 | |
| 30 | RAMP B | 012+39.60 | 20.0' RT | | | A | 4 | T8G | 575.26 | 559.61 | | 559.61 | |

(P) - PRECAST INLET REQUIRED

FILE NAME = I:\7000 - 194 at Ohio Street\CADD\CADD_SHEET\SD1606\63-SCHEDULES.dgn



| | | |
|----------------------------|------------|-----------|
| USER NAME = rge11 | DESIGNED - | REVISED - |
| PLOT SCALE = 2.0000' / in. | DRAWN - | REVISED - |
| PLOT DATE = 3/25/2013 | CHECKED - | REVISED - |
| | DATE - | REVISED - |

STATE OF ILLINOIS
DEPARTMENT OF TRANSPORTATION

| | | | |
|--|-----------|-----------|--------------|
| I-90/94 AT OHIO STREET SCHEDULE OF QUANTITIES | | | |
| SCALE: | SHEET NO. | OF SHEETS | STA. TO STA. |

| | | | | |
|---|----------------------|-------------|------------------|--------------|
| F.A.I. RTE. 90/94 | SECTION 0303-474HB-R | COUNTY COOK | TOTAL SHEETS 368 | SHEET NO. 33 |
| CONTRACT NO. 60F63 | | | | |
| FED. ROAD DIST. NO. 1 ILLINOIS FED. AID PROJECT | | | | |

TREE REMOVAL (6 TO 15 UNITS)

| LOCATION | | | TREE REMOVAL | | |
|----------|----------|-------|--------------|-----------|-------|
| ROAD | STATION | LT/RT | EACH | DIA (IN.) | UNITS |
| RAMP C | 10+76.01 | RT | 1 | 8 | 8 |
| | 11+01.86 | RT | 1 | 10 | 10 |
| | 11+26.66 | RT | 1 | 10 | 10 |
| | 11+49.77 | RT | 1 | 8 | 8 |
| | 12+88.93 | RT | 1 | 8 | 8 |
| | 13+13.17 | RT | 1 | 8 | 8 |
| | 13+13.27 | RT | 1 | 12 | 12 |
| | 14+80.09 | LT | 1 | 10 | 10 |
| | 15+27.52 | LT | 1 | 6 | 6 |
| | 15+66.60 | LT | 1 | 8 | 8 |
| | 16+10.50 | LT | 1 | 12 | 12 |
| | 18+37.02 | LT | 1 | 8 | 8 |
| | 18+48.17 | LT | 1 | 5 | 5 |
| | 18+51.56 | LT | 1 | 9 | 9 |
| | 18+60.92 | LT | 1 | 10 | 10 |
| | 18+69.11 | LT | 1 | 10 | 10 |
| | 18+87.00 | LT | 1 | 10 | 10 |
| RAMP A | 11+61.09 | LT | 13 | 8 | 104 |
| | 19+77.75 | LT | 14 | 8 | 112 |
| | 19+59.11 | LT | 25 | 10 | 250 |
| | 18+90.71 | RT | 35 | 10 | 350 |
| TOTAL | | | | | 968 |

TREE REMOVAL (ACRES)

| LOCATION | | | TREE REMOVAL | | |
|----------|----------|-------|--------------|--|------|
| ROAD | STATION | LT/RT | SQ FT | | ACRE |
| | 11+61.09 | LT | 11073.0 | | 0.3 |
| | 19+77.75 | LT | 1574.0 | | 0.0 |
| RAMP A | 19+59.11 | LT | 1459.1 | | 0.0 |
| | 18+90.71 | RT | 8147.0 | | 0.2 |
| TOTAL | | | | | 0.5 |

PAVED SHOULDER REMOVAL

| LOCATION | | | | PVMT AREA |
|----------|------------|-----------|-------|-----------|
| ROAD | STATION TO | STATION | LT/RT | SQ YD |
| RAMP C | 103+00.00 | 106+42.44 | RT | 230 |
| RAMP C | 103+00.00 | 106+38.12 | LT | 182 |
| I-90/94 | 220+27.91 | 219+40.62 | RT | 86 |
| I-90/94 | 220+27.91 | 219+40.62 | RT | 40 |
| I-90/94 | 120+67.75 | 119+17.10 | LT | 92 |
| I-90/94 | 117+27.28 | 120+24.58 | LT | 270 |
| I-90/94 | 219+64.21 | 222+35.94 | RT | 394 |
| RAMP D | 7+93.59 | 10+58.10 | LT | 394 |
| RAMP D | 9+16.85 | 11+04.15 | RT | 222 |
| RAMP C | 113+17.15 | 127+90.16 | RT | 1019 |
| RAMP C | 113+19.14 | 125+96.44 | LT | 700 |
| I-90/94 | 210+14.65 | 207+49.73 | LT | 268 |
| RAMP A | 17+86.76 | 16+20.00 | RT | 134 |
| RAMP A | 17+86.70 | 16+20.00 | LT | 109 |
| TOTAL = | | | | 4141 |

BARRIER WALL REMOVAL

| LOCATION | | | | | LENGTH |
|----------|-----------|------------|-----------|-------|--------|
| ROAD | DIRECTION | STATION TO | STATION | LT/RT | FOOT |
| I-90/94 | EB | 221+25.39 | 219+90.00 | LT | 136 |
| I-90/94 | WB | 120+24.59 | 119+13.57 | LT | 112 |
| I-90/94 | WB | 119+09.77 | 117+27.29 | LT | 184 |
| I-90/94 | WB | 120+67.79 | 119+17.14 | LT | 151 |
| I-90/94 | EB | 220+27.83 | 219+40.63 | RT | 87 |
| I-90/94 | EB | 220+27.78 | 219+56.75 | LT | 71 |
| RAMP C | | 103+00.00 | 106+42.55 | RT | 344 |
| RAMP C | | 103+95.90 | 106+37.74 | LT | 242 |
| RAMP C | | 113+20.59 | 113+47.36 | LT | 27 |
| RAMP C | | 113+18.28 | 116+88.44 | RT | 374 |
| RAMP C | STG 2 MOT | | | | 40 |
| TOTAL = | | | | | 1766 |

PAVEMENT REMOVAL

| LOCATION | | | PVMT AREA |
|----------|------------|-----------|-----------|
| ROAD | STATION TO | STATION | SQ YD |
| RAMP C | 103+00.00 | 106+39.44 | 607 |
| RAMP A | 20+24.24 | 18+81.75 | 357 |
| RAMP A | 16+20.00 | 17+86.70 | 422 |
| RAMP C | 113+17.49 | 127+91.10 | 2589 |
| RAMP A | 106+29.39 | 106+95.71 | 167 |
| I-90/94 | 220+13.32 | 218+62.62 | 54 |
| TOTAL = | | | 4196 |

FILE NAME = I:\7000 - 194 at Ohio Street\CADD\CADD_SHEET\SD160663-SCHEDULES.dgn



| | | |
|----------------------------|------------|-----------|
| USER NAME = rge11 | DESIGNED - | REVISED - |
| PLOT SCALE = 2.0000' / in. | DRAWN - | REVISED - |
| PLOT DATE = 3/25/2013 | CHECKED - | REVISED - |
| | DATE - | REVISED - |

**STATE OF ILLINOIS
DEPARTMENT OF TRANSPORTATION**

**I-90/94 AT OHIO STREET
SCHEDULE OF QUANTITIES**

SCALE: SHEET NO. OF SHEETS STA. TO STA.

| | | | | |
|---|----------------------|-------------|--------------------|--------------|
| F.A.I. RE. 90/94 | SECTION 0303-474HB-R | COUNTY COOK | TOTAL SHEETS 368 | SHEET NO. 34 |
| FED. ROAD DIST. NO. 1 ILLINOIS FED. AID PROJECT | | | CONTRACT NO. 60F63 | |

EARTHWORK SCHEDULE

| STAGE 1 | | EARTH EXCAVATION CU YD | REMOVAL AND DISPOSAL OF UNSUITABLE MATERIALS CU YD | EXCAVATION TO BE USED IN EMBANKMENT (15% SHRINKAGE) CU YD | EMBANKMENT CU YD | EARTHWORK BALANCE WASTE (+) OR SHORTAGE (-) CU YD |
|-----------|-----------|---------------------------|--|---|---------------------|---|
| STA. FROM | TO STA. | | | | | |
| STAGE 1 | | | | | | |
| 204+00.00 | 204+50.00 | 52.35 | 11.22 | 44.50 | 1.07 | 43.43 |
| 204+50.00 | 205+00.00 | 113.00 | 24.93 | 96.05 | 1.83 | 94.22 |
| 205+00.00 | 205+50.00 | 88.65 | 25.66 | 75.35 | 4.20 | 71.15 |
| 205+50.00 | 206+00.00 | 32.37 | 17.56 | 27.51 | 6.33 | 21.18 |
| 213+00.00 | 213+50.00 | 10.19 | 20.44 | 8.66 | 3.34 | 5.32 |
| 213+50.00 | 214+00.00 | 13.19 | 27.62 | 11.21 | 4.47 | 6.74 |
| 214+00.00 | 214+50.00 | 16.98 | 23.89 | 14.43 | 3.37 | 11.06 |
| 214+50.00 | 215+00.00 | 26.01 | 26.51 | 22.11 | 0.99 | 21.12 |
| 215+00.00 | 215+50.00 | 30.31 | 29.56 | 25.76 | 1.96 | 23.81 |
| 215+50.00 | 216+00.00 | 38.19 | 30.80 | 32.46 | 3.63 | 28.82 |
| 216+00.00 | 216+50.00 | 37.31 | 32.68 | 31.71 | 4.53 | 27.19 |
| 216+50.00 | 217+00.00 | 40.29 | 31.46 | 34.24 | 3.49 | 30.75 |
| 217+00.00 | 217+50.00 | 73.36 | 35.79 | 62.35 | 2.15 | 60.20 |
| 217+50.00 | 218+00.00 | 116.73 | 41.71 | 99.22 | 1.44 | 97.78 |
| 218+00.00 | 218+50.00 | 133.15 | 43.41 | 113.18 | 5.45 | 107.73 |
| 218+50.00 | 219+00.00 | 96.68 | 44.43 | 82.18 | 10.84 | 71.34 |
| 219+00.00 | 219+50.00 | 37.19 | 37.91 | 31.61 | 13.50 | 18.11 |
| 219+50.00 | 220+00.00 | 6.28 | 20.86 | 5.34 | 11.17 | -5.84 |
| 220+00.00 | 220+50.00 | 0.48 | 0.00 | 0.41 | 0.00 | 0.41 |
| TOTAL | | 962.20 | 526.44 | 817.87 | 83.76 | 734.11 |

| STAGE 2 | | EARTH EXCAVATION CU YD | REMOVAL AND DISPOSAL OF UNSUITABLE MATERIALS CU YD | EXCAVATION TO BE USED IN EMBANKMENT (15% SHRINKAGE) CU YD | EMBANKMENT CU YD | EARTHWORK BALANCE WASTE (+) OR SHORTAGE (-) CU YD |
|-----------|-----------|---------------------------|--|---|---------------------|---|
| STA. FROM | TO STA. | | | | | |
| STAGE 2 | | | | | | |
| 100+50.00 | 101+00.00 | 0.26 | 2.25 | 0.22 | 1.37 | -1.14 |
| 101+00.00 | 101+50.00 | 11.38 | 14.49 | 9.68 | 4.74 | 4.94 |
| 101+50.00 | 102+00.00 | 72.74 | 35.31 | 61.83 | 4.29 | 57.54 |
| 102+00.00 | 102+50.00 | 146.83 | 47.88 | 124.81 | 2.52 | 122.29 |
| 103+00.00 | 103+50.00 | 224.89 | 54.77 | 191.16 | 2.09 | 189.07 |
| 103+50.00 | 104+00.00 | 254.90 | 66.05 | 216.66 | 3.81 | 212.85 |
| 104+00.00 | 104+50.00 | 150.19 | 59.30 | 127.66 | 6.64 | 121.01 |
| 104+50.00 | 105+00.00 | 35.38 | 29.96 | 30.07 | 8.79 | 21.29 |
| TOTAL | | 896.57 | 310.00 | 762.09 | 34.25 | 727.83 |

| STAGE 3 | | EARTH EXCAVATION CU YD | REMOVAL AND DISPOSAL OF UNSUITABLE MATERIALS CU YD | EXCAVATION TO BE USED IN EMBANKMENT (15% SHRINKAGE) CU YD | EMBANKMENT CU YD | EARTHWORK BALANCE WASTE (+) OR SHORTAGE (-) CU YD |
|-------------|-----------|---------------------------|--|---|---------------------|---|
| STA. FROM | TO STA. | | | | | |
| STAGE 3 | | | | | | |
| 302+00.00 | 302+50.00 | 12.76 | 5.42 | 10.85 | 1.76 | 9.08 |
| 302+50.00 | 303+00.00 | 30.71 | 17.30 | 26.10 | 8.01 | 18.09 |
| 303+00.00 | 303+50.00 | 18.88 | 26.06 | 16.04 | 28.76 | -12.72 |
| 303+50.00 | 304+00.00 | 0.93 | 31.59 | 0.79 | 95.76 | -94.97 |
| 304+00.00 | 304+50.00 | 0.00 | 36.66 | 0.00 | 188.84 | -188.84 |
| 304+50.00 | 305+00.00 | 0.00 | 43.46 | 0.00 | 312.74 | -312.74 |
| 305+00.00 | 305+50.00 | 0.00 | 50.69 | 0.00 | 446.70 | -446.70 |
| 305+50.00 | 306+00.00 | 0.00 | 50.44 | 0.00 | 420.01 | -420.01 |
| 306+00.00 | 306+50.00 | 0.00 | 36.00 | 0.00 | 170.44 | -170.44 |
| 316+00.00 | 316+50.00 | 0.00 | 0.00 | 0.00 | 0.00 | 0.00 |
| 316+50.00 | 317+00.00 | 0.00 | 0.00 | 0.00 | 0.00 | 0.00 |
| 317+00.00 | 317+50.00 | 0.48 | 1.31 | 0.41 | 9.10 | -8.69 |
| 317+50.00 | 318+00.00 | 0.55 | 4.36 | 0.47 | 21.81 | -21.34 |
| 318+00.00 | 318+50.00 | 0.12 | 7.58 | 0.10 | 12.70 | -12.61 |
| 318+50.00 | 319+00.00 | 0.27 | 9.31 | 0.23 | 1.17 | -0.94 |
| 319+00.00 | 319+50.00 | 0.22 | 4.79 | 0.19 | 1.17 | -0.98 |
| GRAND TOTAL | | 64.91 | 324.96 | 55.17 | 1718.97 | -1663.80 |

FILE NAME = I:\7000 - 194 at Ohio Street\CADD\CADD_SHEET\SD160663-SCHEDULES.dgn



USER NAME = rge11
 PLOT SCALE = 2.0000' / in.
 PLOT DATE = 3/25/2013

DESIGNED -
 DRAWN -
 CHECKED -
 DATE -

REVISED -
 REVISED -
 REVISED -
 REVISED -

**STATE OF ILLINOIS
 DEPARTMENT OF TRANSPORTATION**

**I-90/94 AT OHIO STREET
 SCHEDULE OF QUANTITIES**

SCALE: SHEET NO. OF SHEETS STA. TO STA.

| | | | | |
|---|--------------|--------|--------------|-----------|
| F.A.I. RTE. | SECTION | COUNTY | TOTAL SHEETS | SHEET NO. |
| 90/94 | 0303-474HB-R | COOK | 368 | 35 |
| CONTRACT NO. 60F63 | | | | |
| FED. ROAD DIST. NO. 1 ILLINOIS FED. AID PROJECT | | | | |

EARTHWORK SCHEDULE

| STA. FROM | TO STA. | EARTH EXCAVATION | REMOVAL AND DISPOSAL OF UNSUITABLE MATERIALS | EXCAVATION TO BE USED IN EMBANKMENT (15% SHRINKAGE) | EMBANKMENT | EARTHWORK BALANCE WASTE (+) OR SHORTAGE (-) |
|-----------|-----------|------------------|--|---|------------|---|
| | | CU YD | CU YD | CU YD | CU YD | CU YD |
| RAMP C | | | | | | |
| 113+50.00 | 114+00.00 | 0.97 | 37.13 | 0.83 | 200.29 | -199.46 |
| 114+00.00 | 114+50.00 | 0.94 | 30.31 | 0.79 | 165.80 | -165.01 |
| 114+50.00 | 115+00.00 | 0.60 | 25.75 | 0.51 | 136.73 | -136.22 |
| 115+00.00 | 115+50.00 | 0.26 | 25.64 | 0.22 | 127.24 | -127.02 |
| 115+50.00 | 116+00.00 | 14.56 | 28.93 | 12.38 | 109.79 | -97.41 |
| 116+00.00 | 116+50.00 | 31.36 | 33.08 | 26.65 | 94.09 | -67.43 |
| 116+50.00 | 117+00.00 | 24.62 | 34.87 | 20.93 | 85.53 | -64.60 |
| 117+00.00 | 117+50.00 | 21.68 | 48.06 | 18.42 | 98.01 | -79.58 |
| 117+50.00 | 118+00.00 | 42.16 | 63.80 | 35.84 | 113.11 | -77.27 |
| 118+00.00 | 118+50.00 | 78.80 | 71.19 | 66.98 | 106.51 | -39.53 |
| 118+50.00 | 119+00.00 | 110.16 | 78.33 | 93.63 | 109.42 | -15.79 |
| 119+00.00 | 119+50.00 | 138.23 | 79.10 | 117.50 | 109.99 | 7.51 |
| 119+50.00 | 120+00.00 | 172.00 | 110.77 | 146.20 | 73.57 | 72.62 |
| 120+00.00 | 120+50.00 | 208.97 | 148.96 | 177.63 | 79.19 | 98.44 |
| 120+50.00 | 121+00.00 | 287.30 | 150.24 | 244.21 | 92.54 | 151.67 |
| 121+00.00 | 121+50.00 | 437.10 | 145.83 | 371.54 | 49.87 | 321.67 |
| 121+50.00 | 122+00.00 | 617.43 | 143.31 | 524.81 | 17.91 | 506.90 |
| 122+00.00 | 122+50.00 | 734.95 | 139.11 | 624.71 | 3.25 | 621.47 |
| 122+50.00 | 123+00.00 | 760.19 | 133.19 | 646.17 | 1.62 | 644.54 |
| 123+00.00 | 123+50.00 | 723.16 | 126.83 | 614.68 | 1.64 | 613.04 |
| 123+50.00 | 124+00.00 | 652.09 | 133.71 | 554.27 | 3.70 | 550.57 |
| 124+00.00 | 124+50.00 | 485.96 | 130.42 | 413.06 | 6.01 | 407.06 |
| 124+50.00 | 125+00.00 | 300.29 | 123.77 | 255.25 | 6.39 | 248.86 |
| 125+00.00 | 125+50.00 | 181.08 | 97.01 | 153.92 | 3.80 | 150.12 |
| 125+50.00 | 126+00.00 | 106.06 | 61.71 | 90.16 | 1.17 | 88.98 |
| 126+00.00 | 126+50.00 | 71.15 | 57.09 | 60.48 | 1.08 | 59.40 |
| 126+50.00 | 127+00.00 | 37.94 | 49.47 | 32.25 | 0.65 | 31.60 |
| 127+00.00 | 127+50.00 | 22.75 | 43.74 | 19.34 | 0.40 | 18.94 |
| TOTAL | | 6262.76 | 2351.34 | 5323.35 | 1799.26 | 3524.08 |

| STA. FROM | TO STA. | EARTH EXCAVATION | REMOVAL AND DISPOSAL OF UNSUITABLE MATERIALS | EXCAVATION TO BE USED IN EMBANKMENT (15% SHRINKAGE) | EMBANKMENT | EARTHWORK BALANCE WASTE (+) OR SHORTAGE (-) |
|-----------|----------|------------------|--|---|------------|---|
| | | CU YD | CU YD | CU YD | CU YD | CU YD |
| RAMP B | | | | | | |
| 11+00.00 | 11+50.00 | 29.54 | 28.68 | 25.11 | 0.09 | 25.02 |
| 11+50.00 | 12+00.00 | 19.64 | 23.47 | 16.69 | 0.10 | 16.60 |
| 12+00.00 | 12+50.00 | 20.14 | 25.69 | 17.12 | 1.00 | 16.11 |
| 12+50.00 | 13+00.00 | 46.27 | 44.00 | 39.33 | 3.22 | 36.11 |
| TOTAL | | 115.59 | 121.84 | 98.25 | 4.41 | 93.84 |

| STA. FROM | TO STA. | EARTH EXCAVATION | REMOVAL AND DISPOSAL OF UNSUITABLE MATERIALS | EXCAVATION TO BE USED IN EMBANKMENT (15% SHRINKAGE) | EMBANKMENT | EARTHWORK BALANCE WASTE (+) OR SHORTAGE (-) |
|-----------|----------|------------------|--|---|------------|---|
| | | CU YD | CU YD | CU YD | CU YD | CU YD |
| RAMP D | | | | | | |
| 8+00.00 | 8+50.00 | 79.62 | 21.57 | 67.67 | 84.04 | -16.36 |
| 8+50.00 | 9+00.00 | 83.75 | 11.76 | 71.19 | 109.21 | -38.02 |
| 9+00.00 | 9+50.00 | 86.53 | 6.84 | 73.55 | 67.91 | 5.64 |
| 9+50.00 | 10+00.00 | 94.65 | 4.77 | 80.45 | 57.11 | 23.35 |
| 10+00.00 | 10+50.00 | 124.35 | 15.70 | 105.70 | 75.44 | 30.26 |
| 10+50.00 | 11+00.00 | 116.56 | 20.93 | 99.08 | 68.95 | 30.12 |
| TOTAL | | 585.45 | 81.58 | 497.64 | 462.65 | 34.99 |

| STA. FROM | TO STA. | EARTH EXCAVATION | REMOVAL AND DISPOSAL OF UNSUITABLE MATERIALS | EXCAVATION TO BE USED IN EMBANKMENT (15% SHRINKAGE) | EMBANKMENT | EARTHWORK BALANCE WASTE (+) OR SHORTAGE (-) |
|-------------|---------|------------------|--|---|------------|---|
| | | CU YD | CU YD | CU YD | CU YD | CU YD |
| RAMP C | | 6262.76 | 2351.34 | 5323.35 | 1799.26 | 3524.08 |
| RAMP B | | 115.59 | 121.84 | 98.25 | 4.41 | 93.84 |
| RAMP D | | 585.45 | 81.58 | 497.64 | 462.65 | 34.99 |
| STAGE 1 | | 962.20 | 526.44 | 817.87 | 83.76 | 734.11 |
| STAGE 2 | | 896.57 | 310.00 | 762.09 | 34.25 | 727.83 |
| STAGE 3 | | 64.91 | 324.96 | 55.17 | 1718.97 | -1663.80 |
| GRAND TOTAL | | 8887.49 | 3716.16 | 7554.36 | 4103.31 | 3451.05 |

FILE NAME = I:\7000 - 194 at Ohio Street\CADD\CADD_SHEET\SD160663-SCHEDULES.dgn



USER NAME = rge11
 PLOT SCALE = 2.0000' / 1" =
 PLOT DATE = 3/25/2013

DESIGNED -
 DRAWN -
 CHECKED -
 DATE -
 REVISED -
 REVISED -
 REVISED -
 REVISED -

STATE OF ILLINOIS
 DEPARTMENT OF TRANSPORTATION

I-90/94 AT OHIO STREET
 SCHEDULE OF QUANTITIES
 SCALE: SHEET NO. OF SHEETS STA. TO STA.

| | | | | |
|---|--------------|--------|--------------|-----------|
| F.A.I. RTE. | SECTION | COUNTY | TOTAL SHEETS | SHEET NO. |
| 90/94 | 0303-474HB-R | COOK | 368 | 36 |
| CONTRACT NO. 60F63 | | | | |
| FED. ROAD DIST. NO. 1 ILLINOIS FED. AID PROJECT | | | | |



BM01
 N. 1,903,723.174 E. 1,170,981.978 EL. 593.063
 BOLT ON TRAFFIC SIGNAL LOCATED ON THE NE CORNER OF HALTED, GRAND, AND MILWAUKEE AVE.

BM02
 N. 1,904,079.728 E. 1,170,555.042 EL. 595.399
 SE BOLT ON 3RD POST WEST OF CORNER ON CONC. WALL AT THE NORTH CORNER OF OHIO STREET AND MILWAUKEE AVENUE, +/- 30 FT WEST OF CONC. WALL CORNER.

BM03
 N. 1,904,193.065 E. 1,170,865.387 EL. 577.615
 SET "SQUARE" ON BARRIER WALL ON NORTH SIDE OF WB FEEDER RAMP ONTARIO AND SECOND SAW JOINT WEST OF HALSTED BRIDGE.


BM05
 N. 1,903,769.618 E. 1,169,707.289 EL. 576.805
 SET "SQUARE" IN BARRIER WALL END LOCATED ON RAMP END TO I-90 /94 EB BEFORE GRAND AVE. OVERPASS, +/- 10 FT WEST OF CPT 106 ON THE SOUTH SIDE OF THE RAMP.

BM08
 N. 1,904,295.536 E. 1,169,632.588 EL. 590.735
 SECOND BOLT FROM MAINTENANCE DOOR "X" MAST TOWER NO. 6 SGH3 IN INFOELD BETWEEN I-90 /94 AND OHIO FEEDER RAMP, +/- 35 FT WEST OF BRICK MAINTENANCE BUILDING.

BM09
 N. 1,904,419.272 E. 1,169,489.960 EL. 598.615
 CUT "SQUARE" ON TOP OF WALL AT TUNNEL ON EAST SIDE, SE CORNER.

BM11
 N. 1,903,803.207 E. 1,169,993.199 EL. 574.300
 CUT "SQUARE" ON TOP OF CURB AT EXIT 50B MEDIAN 18 FT S'LY OF SIGN POST, 5.35 FEET NW'LY OF CONC. PAVEMENT CORNER AND 2.20 FT. S'LY OF CPT 1007.

BM12
 N. 1,904,392.510 E. 1,168,864.965 EL. 581.496
 CUT "SQUARE" AT SW CORNER, END OF CONC. BARRIER WALL AT SW CORNER OF CONC. SUPPORT PIER FOR OHIO FEEDER TO I-90 /94 EB OVERPASS AT LEFT SHLDR FOR EB I-90 /94 EXIT 50B. AT SW CORNER, TOP OF BARRIER WALL, 8.20 FT W'LY OF SE CORNER OR PIER AND 3.20 FT S'LY OF NW CORNER OF PIER.

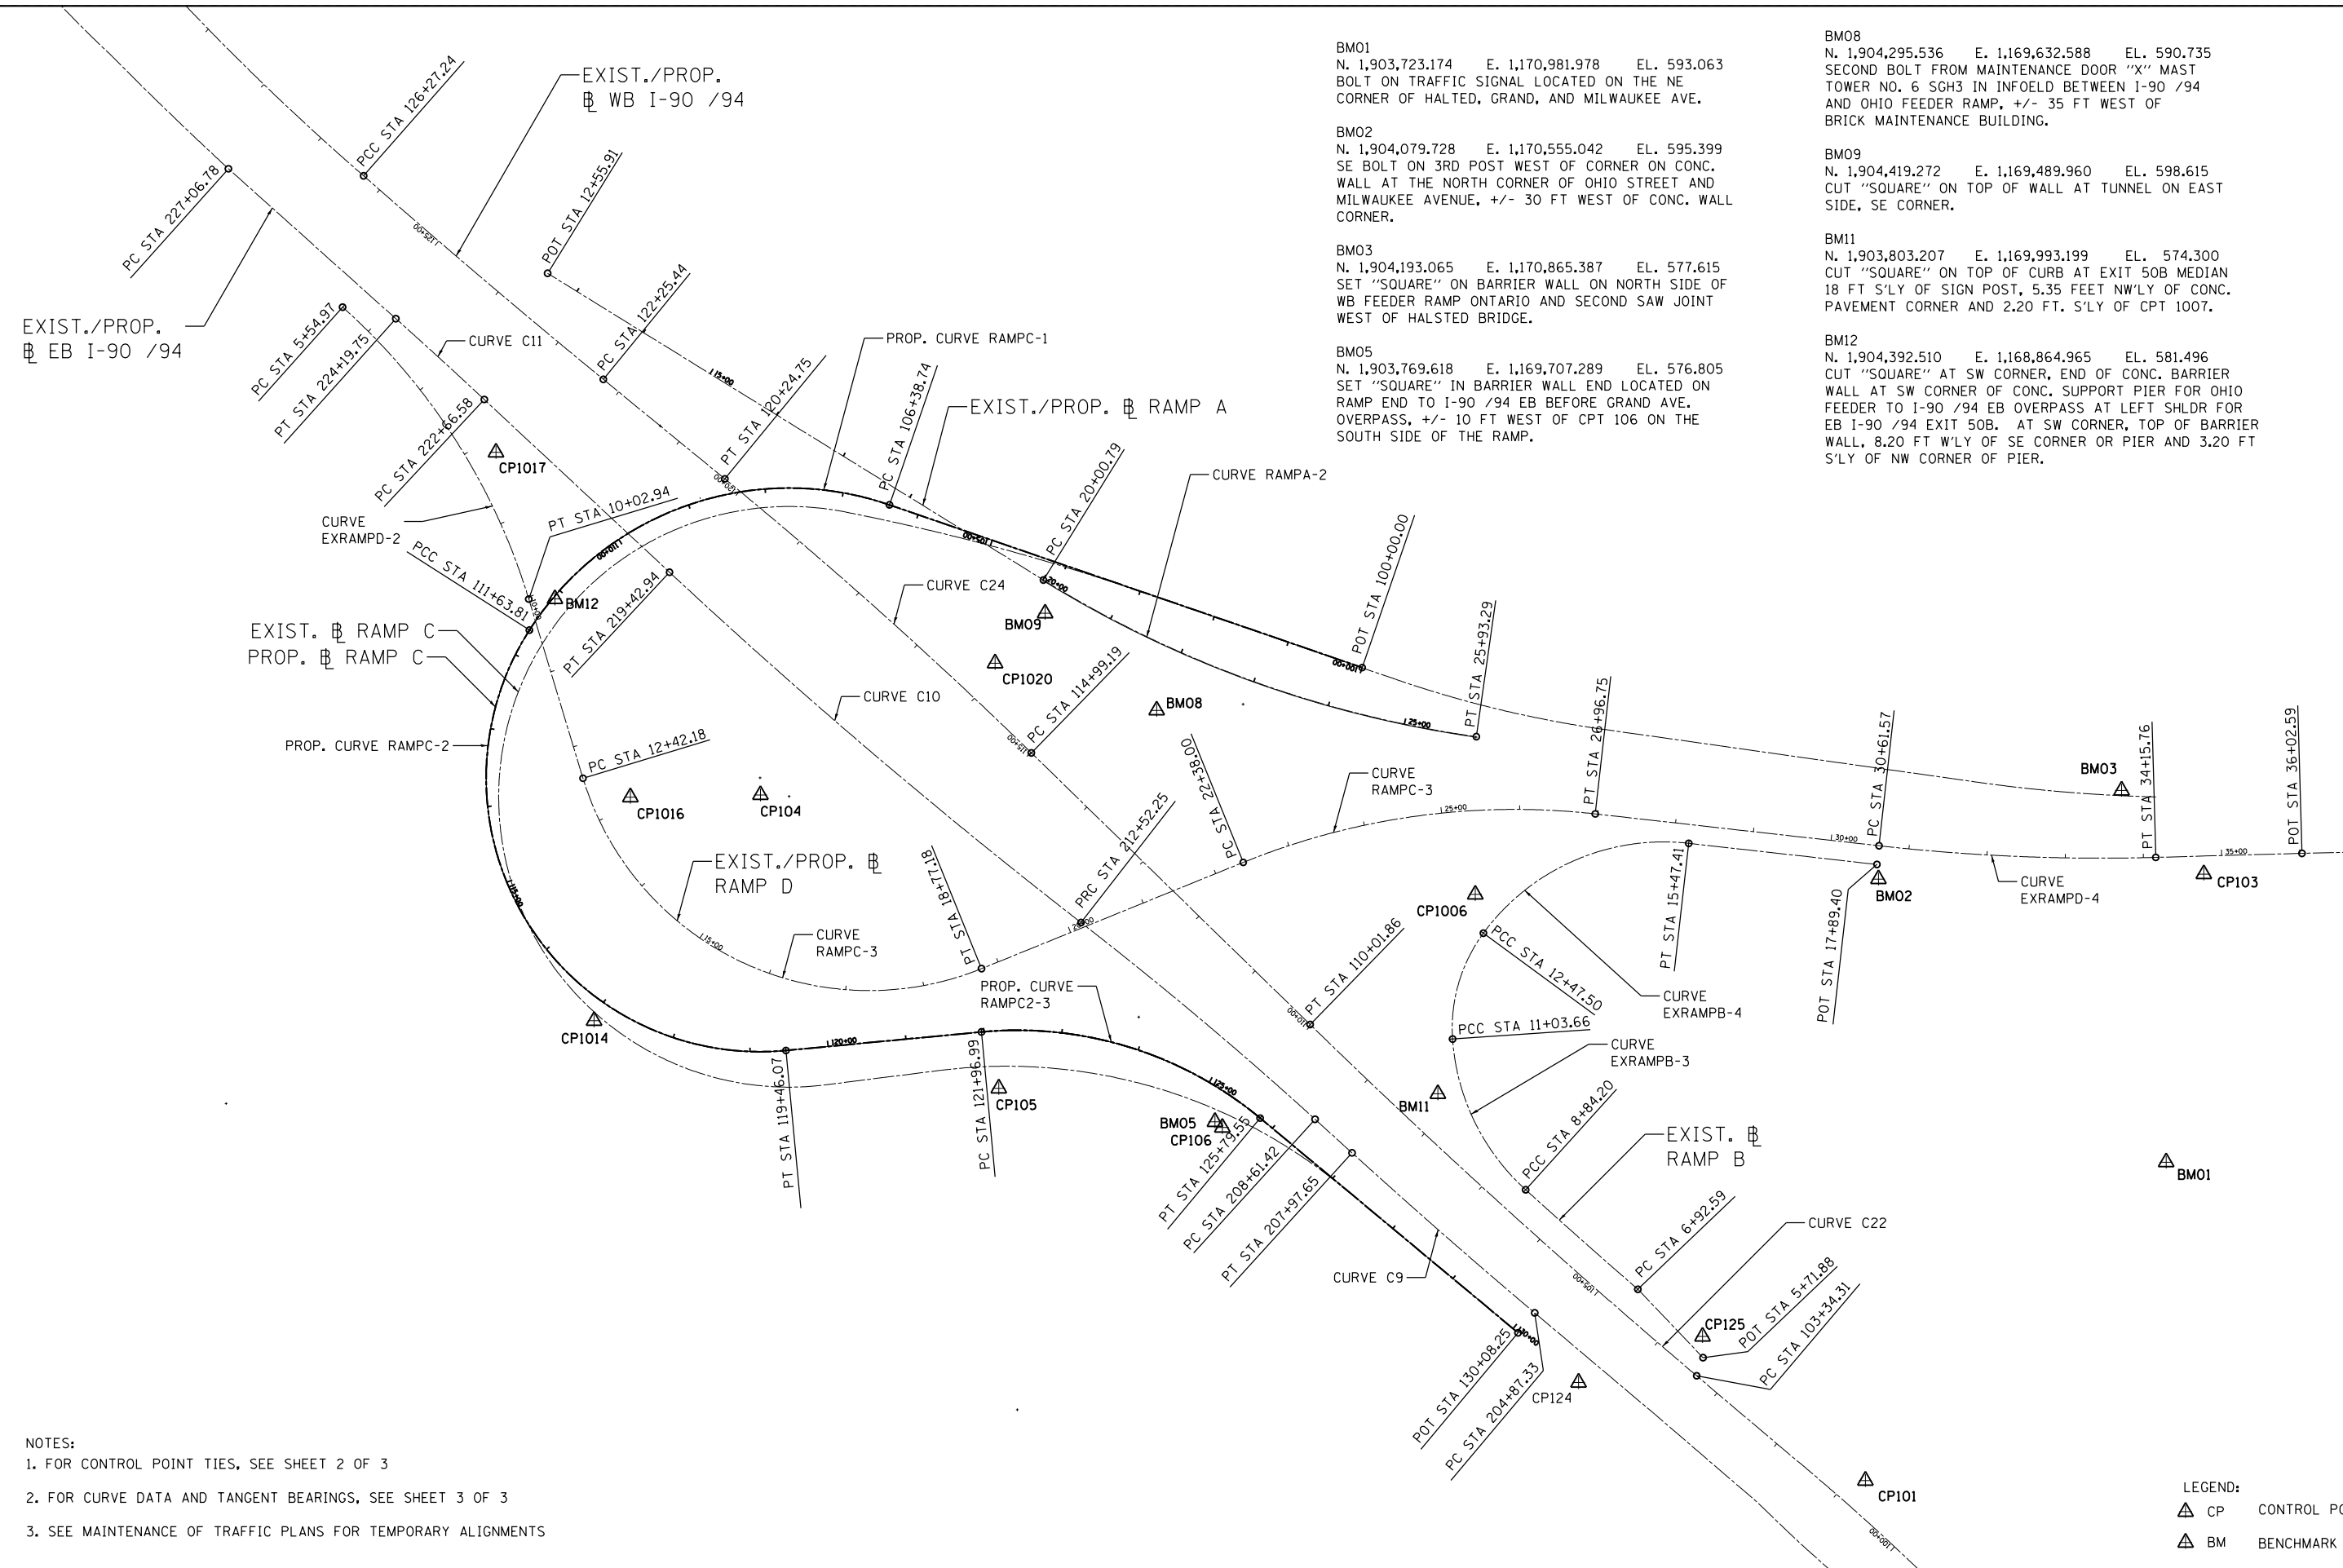

- NOTES:
1. FOR CONTROL POINT TIES, SEE SHEET 2 OF 3
 2. FOR CURVE DATA AND TANGENT BEARINGS, SEE SHEET 3 OF 3
 3. SEE MAINTENANCE OF TRAFFIC PLANS FOR TEMPORARY ALIGNMENTS

LEGEND:
 ▲ CP CONTROL POINT
 ▲ BM BENCHMARK

FILE NAME = I:\7000 - 194 at Ohio Street\CADD\CADD_SHEET\SD160663-sh1-01.dgn















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| PLOT SCALE = 200.0000' / in. | DRAWN - | REVISED - |
| PLOT DATE = 3/25/2013 | CHECKED - | REVISED - |
| | DATE - | REVISED - |

STATE OF ILLINOIS
DEPARTMENT OF TRANSPORTATION

I-90/94 AT OHIO STREET
ALIGNMENT, TIES, AND BENCHMARKS

SCALE: SHEET NO. 1 OF 3 SHEETS STA. TO STA.

| | | | | |
|---|----------------------|-------------|------------------|--------------|
| F.A.I. RE. 90/94 | SECTION 0303-474HB-R | COUNTY COOK | TOTAL SHEETS 368 | SHEET NO. 37 |
| CONTRACT NO. 60F63 | | | | |
| FED. ROAD DIST. NO. 1 ILLINOIS FED. AID PROJECT | | | | |

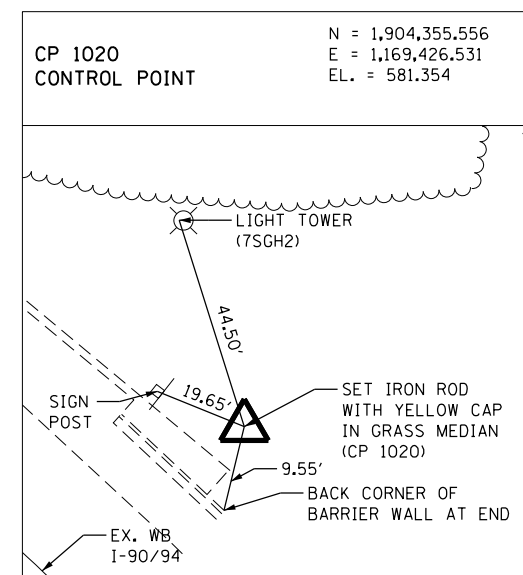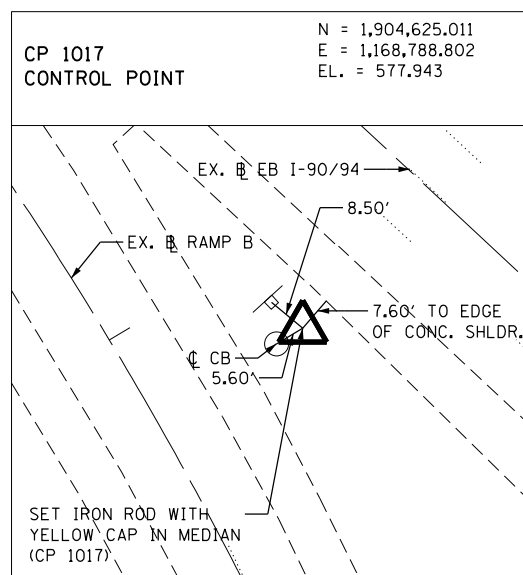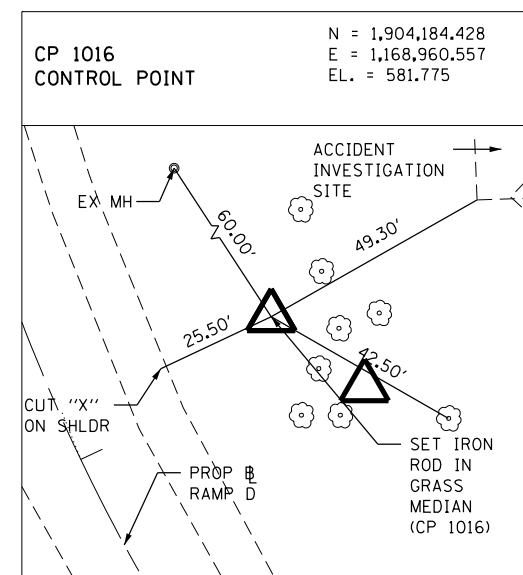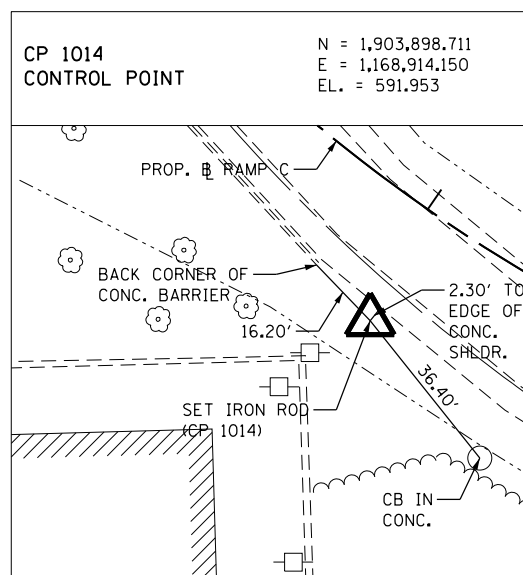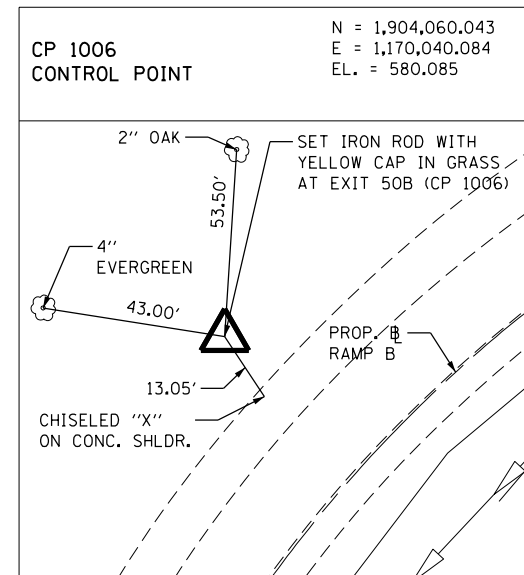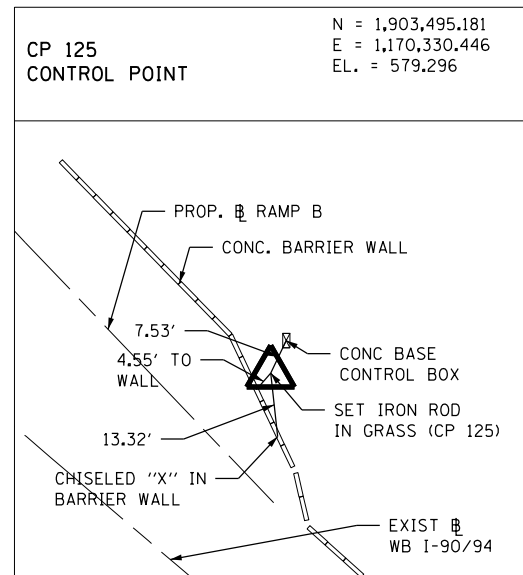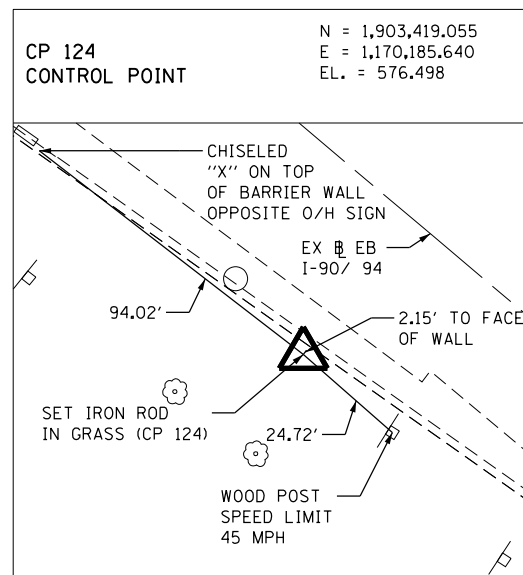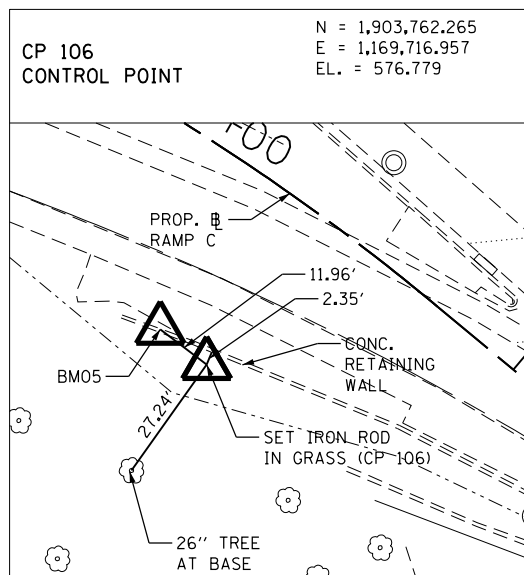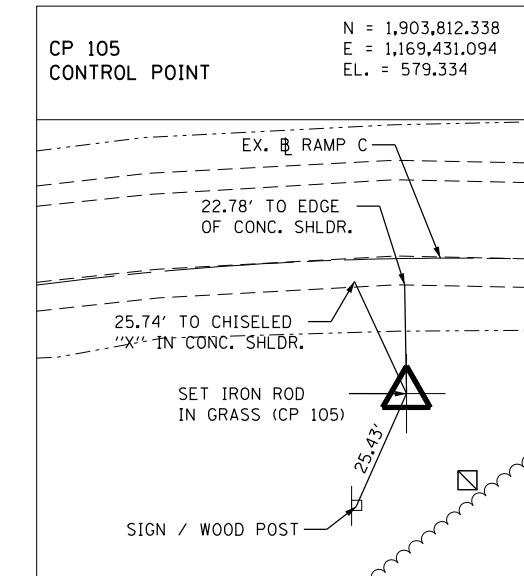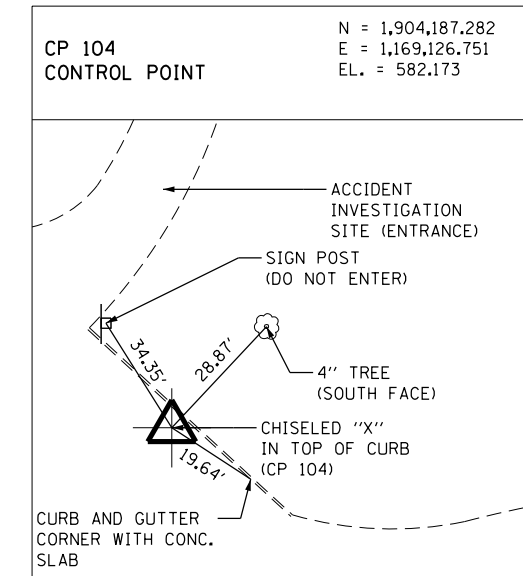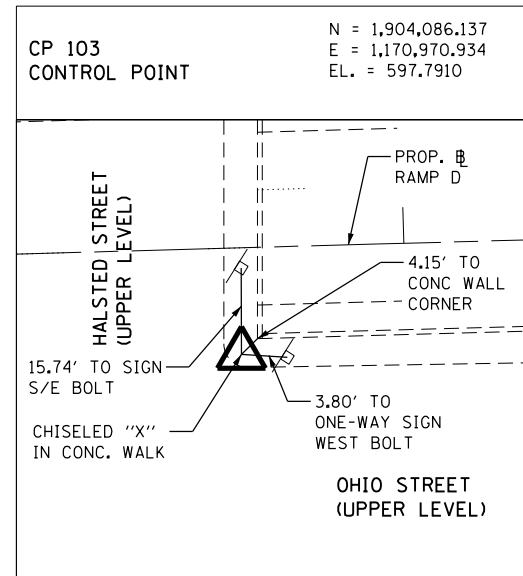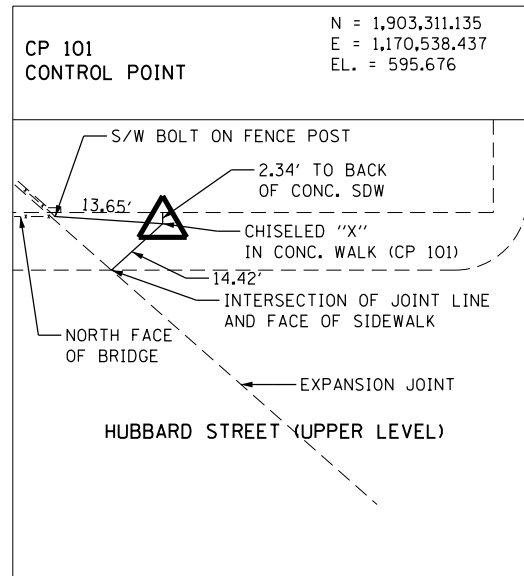

FILE NAME = I:\7000 - 194 at Ohio Street\CADD\CADD_SHEET\SD\60F63-sh1-ties.dgn



USER NAME = rge11
 PLOT SCALE = 40.0000' / in.
 PLOT DATE = 3/25/2013

DESIGNED -
 DRAWN -
 CHECKED -
 DATE -

REVISED -
 REVISED -
 REVISED -
 REVISED -

**STATE OF ILLINOIS
 DEPARTMENT OF TRANSPORTATION**

**I-90/94 AT OHIO STREET
 ALIGNMENT, TIES, AND BENCHMARKS**
 SCALE: SHEET NO. 2 OF 3 SHEETS STA. TO STA.

| | | | | |
|---|-------------------------|----------------|---------------------|-----------------|
| F.A.I. RTE. 90/94 | SECTION 0303-474HB-R | COUNTY COOK | TOTAL SHEETS 368 | SHEET NO. 38 |
| CONTRACT NO. 60F63 | | | | |
| FED. ROAD DIST. NO. 1 ILLINOIS FED. AID PROJECT | | | | |

RAMP B

Point EXRAMPB01 N 1,903,468.1520 E 1,170,331.0608 Sta 5+71.88

Curve EXRAMPB-1
 P.I. Station 7+88.40 N 1,903,618.3687 E 1,170,175.4517
 Delta = 1°09' 01.77" (RT)
 Degree = 0°36' 01.60"
 Tangent = 95.8064
 Length = 191.6064
 Radius = 9,542.2100
 External = 0.4809
 Long Chord = 191.6032
 Mid. Ord. = 0.4809
 P.C. Station 6+92.59 N 1,903,555.5039 E 1,170,247.7490
 P.T. Station 8+84.20 N 1,903,682.6724 E 1,170,104.4312
 Back = N 48°59' 31.26" W
 Ahead = N 47°50' 29.48" W
 Chord Bear = N 48°25' 00.37" W

Curve EXRAMPB-2
 P.I. Station 9+99.65 N 1,903,760.1643 E 1,170,018.8449
 Delta = 43°58' 01.21" (RT)
 Degree = 20°02' 00.56"
 Tangent = 115.4557
 Length = 219.4675
 Radius = 286.0000
 External = 22.4251
 Long Chord = 214.1222
 Mid. Ord. = 20.7946
 P.C. Station 8+84.20 N 1,903,682.6724 E 1,170,104.4312
 P.T. Station 11+03.66 N 1,903,875.3562 E 1,170,011.0434
 Back = N 47°50' 29.48" W
 Ahead = N 3°52' 28.28" W
 Chord Bear = N 25°51' 28.88" W

Curve EXRAMPB-3
 P.I. Station 11+78.69 N 1,903,950.2086 E 1,170,005.9739
 Delta = 40°12' 08.07" (RT)
 Degree = 27°56' 56.98"
 Tangent = 75.0239
 Length = 143.8406
 Radius = 205.0000
 External = 13.2970
 Long Chord = 140.9080
 Mid. Ord. = 12.4871
 P.C. Station 11+03.66 N 1,903,875.3562 E 1,170,011.0434
 P.T. Station 12+47.50 N 1,904,010.6510 E 1,170,050.4183
 Back = N 3°52' 28.28" W
 Ahead = N 36°19' 39.79" E
 Chord Bear = N 16°13' 35.76" E

Curve EXRAMPB-4
 P.I. Station 14+12.90 N 1,904,143.8966 E 1,170,148.3962
 Delta = 60°04' 50.35" (RT)
 Degree = 20°02' 00.56"
 Tangent = 165.3907
 Length = 299.9011
 Radius = 286.0000
 External = 44.3787
 Long Chord = 286.3486
 Mid. Ord. = 38.4174
 P.C. Station 12+47.50 N 1,904,010.6510 E 1,170,050.4183
 P.T. Station 15+47.41 N 1,904,125.4367 E 1,170,312.7535
 Back = N 36°19' 39.79" E
 Ahead = S 83°35' 29.86" E
 Chord Bear = N 66°22' 04.96" E

Point EXRAMPB02 N 1,904,098.4267 E 1,170,553.2353 Sta 17+89.40

RAMP A

Point 51 N 1,904,853.8190 E 1,168,854.7664 Sta 12+55.91

Course from 51 to 46 S 58°15' 16.47" E Dist 744.8796

Point 46 N 1,904,461.9036 E 1,169,488.2077 Sta 20+00.79

Curve C34
 P.I. Station 23+01.33 N 1,904,303.7716 E 1,169,743.7918
 Delta = 23°42' 00.31" (LT)
 Degree = 4°00' 00.05"
 Tangent = 300.5478
 Length = 592.5003
 Radius = 1,432.3900
 External = 31.1913
 Long Chord = 588.2853
 Mid. Ord. = 30.5265
 P.C. Station 20+00.79 N 1,904,461.9036 E 1,169,488.2077
 P.T. Station 25+93.29 N 1,904,261.7079 E 1,170,041.3815
 C.C. N 1,905,679.9998 E 1,170,241.8540
 Back = S 58°15' 16.47" E
 Ahead = S 81°57' 16.78" E
 Chord Bear = S 70°06' 16.63" E

RAMP C

Point RAMPC200 N 1,904,349.9717 E 1,169,895.5222 Sta 100+00.00

Curve RAMPC2-1
 P.I. Station 109+48.55 N 1,904,658.7814 E 1,168,998.6527
 Delta = 76°21' 26.62" (LT)
 Degree = 14°32' 31.47"
 Tangent = 309.8103
 Length = 525.0790
 Radius = 394.0000
 External = 107.2169
 Long Chord = 487.0755
 Mid. Ord. = 84.2818
 P.C. Station 106+38.74 N 1,904,557.9191 E 1,169,291.5848
 P.T. Station 111+63.81 N 1,904,397.9039 E 1,168,831.5438
 Back = N 71°00' 01.49" W
 Ahead = S 32°38' 31.89" W
 Chord Bear = S 70°49' 15.20" W

Curve RAMPC2-2
 P.I. Station 118+82.33 N 1,903,792.8734 E 1,168,443.9826
 Delta = 128°03' 25.89" (LT)
 Degree = 16°22' 12.80"
 Tangent = 718.5163
 Length = 782.2569
 Radius = 350.0000
 External = 449.2282
 Long Chord = 629.3089
 Mid. Ord. = 196.7271
 P.C. Station 111+63.81 N 1,904,397.9039 E 1,168,831.5438
 P.T. Station 119+46.07 N 1,903,860.6790 E 1,169,159.2923
 Back = S 32°38' 31.89" W
 Ahead = N 84°35' 06.00" E
 Chord Bear = S 31°23' 11.05" E

Curve RAMPC2-3
 P.I. Station 123+98.85 N 1,903,903.4069 E 1,169,610.0462
 Delta = 45°11' 34.75" (RT)
 Degree = 11°48' 48.83"
 Tangent = 201.8512
 Length = 382.5517
 Radius = 485.0000
 External = 40.3274
 Long Chord = 372.7116
 Mid. Ord. = 37.2316
 P.C. Station 121+96.99 N 1,903,884.3584 E 1,169,409.0958
 P.T. Station 125+79.55 N 1,903,774.2596 E 1,169,765.1748
 Back = N 84°35' 06.00" E
 Ahead = S 50°13' 19.25" E
 Chord Bear = S 72°49' 06.63" E

Point RAMPC204 N 1,903,499.9697 E 1,170,094.6450 Sta 130+08.25

RAMP D

Curve EXRAMPD-1
 P.I. Station 7+84.71 N 1,904,657.4188 E 1,168,764.0847
 Delta = 31°20' 21.10" (RT)
 Degree = 6°59' 44.96"
 Tangent = 229.7417
 Length = 447.9702
 Radius = 819.0000
 External = 31.6129
 Long Chord = 442.4067
 Mid. Ord. = 30.4380
 P.C. Station 5+54.97 N 1,904,810.6014 E 1,168,592.8646
 P.T. Station 10+02.94 N 1,904,437.5328 E 1,168,830.6534
 Back = S 48°10' 56.90" E
 Ahead = S 16°50' 35.80" E
 Chord Bear = S 32°30' 46.35" E

Curve EXRAMPD-2
 P.I. Station 16+60.86 N 1,903,807.8345 E 1,169,021.2897
 Delta = 95°15' 04.15" (LT)
 Degree = 15°00' 00.26"
 Tangent = 418.6857
 Length = 635.0046
 Radius = 381.9700
 External = 184.7740
 Long Chord = 564.3655
 Mid. Ord. = 124.5327
 P.C. Station 12+42.18 N 1,904,208.5590 E 1,168,899.9735
 P.T. Station 18+77.18 N 1,903,965.3165 E 1,169,409.2293
 Back = S 16°50' 35.80" E
 Ahead = N 67°54' 20.05" E
 Chord Bear = S 64°28' 07.88" E

Curve EXRAMPD-3
 P.I. Station 24+72.23 N 1,904,189.1339 E 1,169,960.5787
 Delta = 28°30' 02.82" (RT)
 Degree = 6°12' 45.87"
 Tangent = 234.2233
 Length = 458.7472
 Radius = 922.2300
 External = 29.2787
 Long Chord = 454.0321
 Mid. Ord. = 28.3777
 P.C. Station 22+38.00 N 1,904,101.0345 E 1,169,743.5556
 P.T. Station 26+96.75 N 1,904,162.9995 E 1,170,193.3394
 Back = N 67°54' 20.05" E
 Ahead = S 83°35' 37.13" E
 Chord Bear = N 82°09' 21.46" E

Curve EXRAMPD-4
 P.I. Station 32+38.95 N 1,904,102.5016 E 1,170,732.1514
 Delta = 8°00' 06.19" (LT)
 Degree = 2°15' 32.99"
 Tangent = 177.3831
 Length = 354.1894
 Radius = 2,536.1500
 External = 6.1957
 Long Chord = 353.9017
 Mid. Ord. = 6.1806
 P.C. Station 30+61.57 N 1,904,122.2938 E 1,170,555.8759
 P.T. Station 34+15.76 N 1,904,107.4401 E 1,170,909.4657
 Back = S 83°35' 37.13" E
 Ahead = N 88°24' 16.68" E
 Chord Bear = S 87°35' 40.23" E

Point EXRAMPD02 N 1,904,112.6416 E 1,171,096.2260 Sta 36+02.59

EB I-90/94

Point 14 N 1,903,525.4085 E 1,170,115.9159 Sta 204+87.33

Curve C9
 P.I. Station 206+42.50 N 1,903,625.5588 E 1,169,997.3871
 Delta = 2°04' 07.58" (RT)
 Degree = 0°40' 00.00"
 Tangent = 155.1747
 Length = 310.3156
 Radius = 8,594.3600
 External = 1.4008
 Long Chord = 310.2988
 Mid. Ord. = 1.4005
 P.C. Station 204+87.33 N 1,903,525.4085 E 1,170,115.9159
 P.T. Station 207+97.65 N 1,903,729.9227 E 1,169,882.5509
 Back = N 49°48' 14.44" W
 Ahead = N 47°44' 06.86" W
 Chord Bear = N 48°46' 10.65" W

Point 15 N 1,903,729.9227 E 1,169,882.5509 Sta 207+97.65

Course from 15 to 16 N 47°44' 06.86" W Dist 63.7749

Point 16 N 1,903,772.8150 E 1,169,835.3546 Sta 208+61.42

Curve C10
 P.I. Station 210+56.93 N 1,903,904.3071 E 1,169,690.6680
 Delta = 4°26' 26.41" (LT)
 Degree = 1°08' 10.42"
 Tangent = 195.5106
 Length = 390.8254
 Radius = 5,042.6300
 External = 3.7887
 Long Chord = 390.7276
 Mid. Ord. = 3.7859
 P.C. Station 208+61.42 N 1,903,772.8150 E 1,169,835.3546
 P.T. Station 212+52.25 N 1,904,024.2019 E 1,169,536.2348
 Back = N 47°44' 06.86" W
 Ahead = N 52°10' 33.26" W
 Chord Bear = N 49°57' 20.06" W

Curve C11
 P.I. Station 215+97.83 N 1,904,236.1261 E 1,169,263.2607
 Delta = 5°10' 48.69" (RT)
 Degree = 0°45' 00.00"
 Tangent = 345.5817
 Length = 690.6925
 Radius = 7,639.4400
 External = 7.8125
 Long Chord = 690.4573
 Mid. Ord. = 7.8045
 P.C. Station 212+52.25 N 1,904,024.2019 E 1,169,536.2348
 P.T. Station 219+42.94 N 1,904,471.8312 E 1,169,010.5359
 Back = N 52°10' 33.26" W
 Ahead = N 46°59' 44.57" W
 Chord Bear = N 49°35' 08.92" W

Point 18 N 1,904,692.5726 E 1,168,773.8552 Sta 222+66.58

Curve C12
 P.I. Station 223+43.17 N 1,904,744.8088 E 1,168,717.8471
 Delta = 1°09' 06.24" (LT)
 Degree = 0°45' 06.98"
 Tangent = 76.5868
 Length = 153.1684
 Radius = 7,619.7300
 External = 0.3849
 Long Chord = 153.1658
 Mid. Ord. = 0.3849
 P.C. Station 222+66.58 N 1,904,692.5726 E 1,168,773.8552
 P.T. Station 224+19.75 N 1,904,795.9088 E 1,168,660.8004
 Back = N 46°59' 44.57" W
 Ahead = N 48°08' 50.82" W
 Chord Bear = N 47°34' 17.69" W

WB I-90/94

Point 22 N 1,903,444.9917 E 1,170,322.9009 Sta 103+34.31

Curve C22
 P.I. Station 106+68.10 N 1,903,660.8258 E 1,170,068.1275
 Delta = 3°59' 38.42" (RT)
 Degree = 0°35' 53.93"
 Tangent = 333.9070
 Length = 667.5435
 Radius = 9,576.2100
 External = 5.8196
 Long Chord = 667.4084
 Mid. Ord. = 5.8161
 P.C. Station 103+34.19 N 1,903,444.9917 E 1,170,322.9009
 P.T. Station 110+01.74 N 1,903,893.8813 E 1,169,829.0061
 Back = N 49°43' 48.08" W
 Ahead = N 45°44' 09.66" W
 Chord Bear = N 47°43' 58.87" W

Point 23 N 1,903,893.8813 E 1,169,829.0061 Sta 110+01.74

Course from 23 to 24 N 45°44' 09.66" W Dist 497.3372

Point 24 N 1,904,241.0054 E 1,169,472.8472 Sta 114+99.07

Curve C23
 P.I. Station 117+62.01 N 1,904,424.5288 E 1,169,284.5471
 Delta = 4°55' 56.47" (LT)
 Degree = 0°56' 18.60"
 Tangent = 262.9406
 Length = 525.5565
 Radius = 6,105.0300
 External = 5.6597
 Long Chord = 525.3942
 Mid. Ord. = 5.6545
 P.C. Station 114+99.07 N 1,904,241.0054 E 1,169,472.8472
 P.T. Station 120+24.63 N 1,904,591.1827 E 1,169,081.1651
 Back = N 45°44' 09.66" W
 Ahead = N 50°40' 06.14" W
 Chord Bear = N 48°12' 07.90" W

Point 25 N 1,904,591.1827 E 1,169,081.1651 Sta 120+24.63

Course from 25 to 26 N 50°40' 06.14" W Dist 200.6878

Point 26 N 1,904,718.3803 E 1,168,925.9349 Sta 122+25.32

Curve C24
 P.I. Station 124+26.24 N 1,904,845.7266 E 1,168,770.5232
 Delta = 2°00' 32.48" (RT)
 Degree = 0°30' 00.00"
 Tangent = 200.9226
 Length = 401.8041
 Radius = 11,459.1500
 External = 1.7613
 Long Chord = 401.7835
 Mid. Ord. = 1.7611
 P.C. Station 122+25.44 N 1,904,718.3803 E 1,168,925.9349
 P.T. Station 126+27.24 N 1,904,978.4429 E 1,168,619.6714
 Back = N 50°40' 06.14" W
 Ahead = N 48°39' 33.66" W
 Chord Bear = N 49°39' 49.90" W

FILE NAME = I:\7000 - 194 at Ohio Street\CADD\CADD_SHEET\SD1606\F63-INT-01.dgn



USER NAME = rge11
 PLOT SCALE = 200.0000' / in.
 PLOT DATE = 3/25/2013

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| DESIGNED - | REVISED - |
| DRAWN - | REVISED - |
| CHECKED - | REVISED - |
| DATE - | REVISED - |

**STATE OF ILLINOIS
 DEPARTMENT OF TRANSPORTATION**

**I-90/94 AT OHIO STREET
 ALIGNMENT, TIES, AND BENCHMARKS**

SCALE: SHEET NO. 3 OF 3 SHEETS STA. TO STA.


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|---|--------------|--------|--------------|-----------|
| F.A.I. RE. | SECTION | COUNTY | TOTAL SHEETS | SHEET NO. |
| 90/94 | 0303-474HB-R | COOK | 368 | 39 |
| CONTRACT NO. 60F63 | | | | |
| FED. ROAD DIST. NO. 1 ILLINOIS FED. AID PROJECT | | | | |

REMOVAL NOTES:

1. SEE STRUCTURE PLANS FOR REMOVALS ON STRUCTURE.
2. SEE DRAINAGE AND UTILITY PLANS FOR REMOVAL OF DRAINAGE RELATED ITEMS.
3. REMOVAL OF SIGN PANEL ASSEMBLY, TYPE A OR TYPE B INCLUDES THE REMOVAL OF THE EXISTING SIGN PANEL.

ELECTRICAL NOTES:


1. THE CONTRACTOR SHALL TAKE CARE DURING PAVED SHOULDER REMOVAL, BARRIER WALL REMOVAL, AND PAVEMENT REMOVAL NOT TO DAMAGE ANY EXISTING LIGHTING RUNS WITHIN THE PROJECT LIMITS. IF THE CONTRACTOR DAMAGES ANY PART OF THE EXISTING LIGHTING SYSTEM, THE CONTRACTOR IS RESPONSIBLE FOR THE TIMELY REPAIR. THE CONTRACTOR SHALL REPLACE THE EXISTING EQUIPMENT IN KIND TO THE SATISFACTION OF THE ENGINEER AT NO EXTRA COST TO THE CONTRACT.
2. THE CONTRACTOR SHALL REMOVE THE EXISTING SIGN LUMINAIRES FROM THE EXISTING CANTILEVER SIGN SUPPORT AS PART OF THE REMOVE EXISTING OVERHEAD SIGN STRUCTURE PAY ITEM.
3. THE CONTRACTOR SHALL DISCONNECT AND REMOVE THE ELECTRIC CONNECTION TO THE SIGN STRUCTURE INCLUDING THE DISCONNECT SWITCH, JUNCTION BOX, CONDUIT, CABLE, AND FITTINGS. THIS WORK SHALL BE INCLUDED IN THE REMOVAL OF ELECTRIC CONNECTION TO SIGN STRUCTURE PAY ITEM.
4. THE CONTRACTOR SHALL ENSURE THAT THE SIGN REMOVAL WORK DOES NOT DAMAGE ANY PORTION OF THE EXISTING LIGHTING SYSTEM TO REMAIN OR CAUSE DAMAGE TO THE EXISTING REV LAC SYSTEM OR SURVEILLANCE EQUIPMENT. IF THE CONTRACTOR DAMAGES ANY PART OF THE EXISTING LIGHTING SYSTEM, REV LAC, OR SURVEILLANCE SYSTEM, THE CONTRACTOR IS RESPONSIBLE FOR THE TIMELY REPAIR. THE CONTRACTOR IS RESPONSIBLE TO REPLACE THE EQUIPMENT IN KIND TO THE SATISFACTION OF THE ENGINEER AT NO ADDITIONAL COST TO THE CONTRACT.

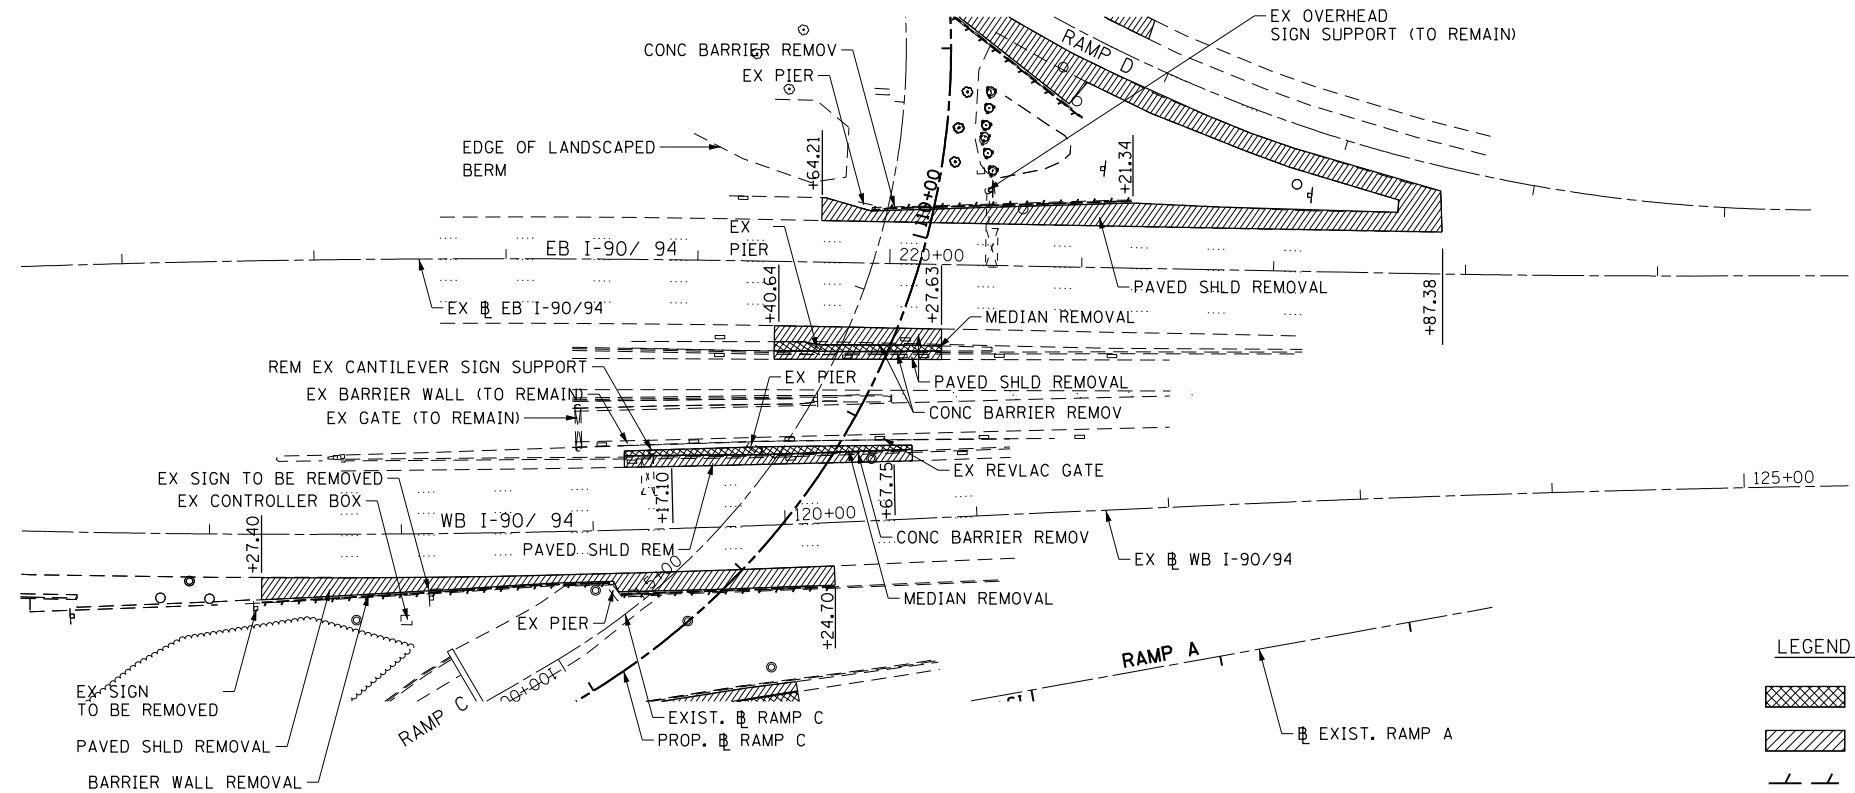

EXISTING PLAN

LEGEND - REMOVAL


- PAVEMENT REMOVAL
- MEDIAN / SHOULDER REMOVAL
- LINEAR REMOVAL
- TREE REMOVAL (SIZE IN UNITS)
- TREE TRUNK PROTECTION

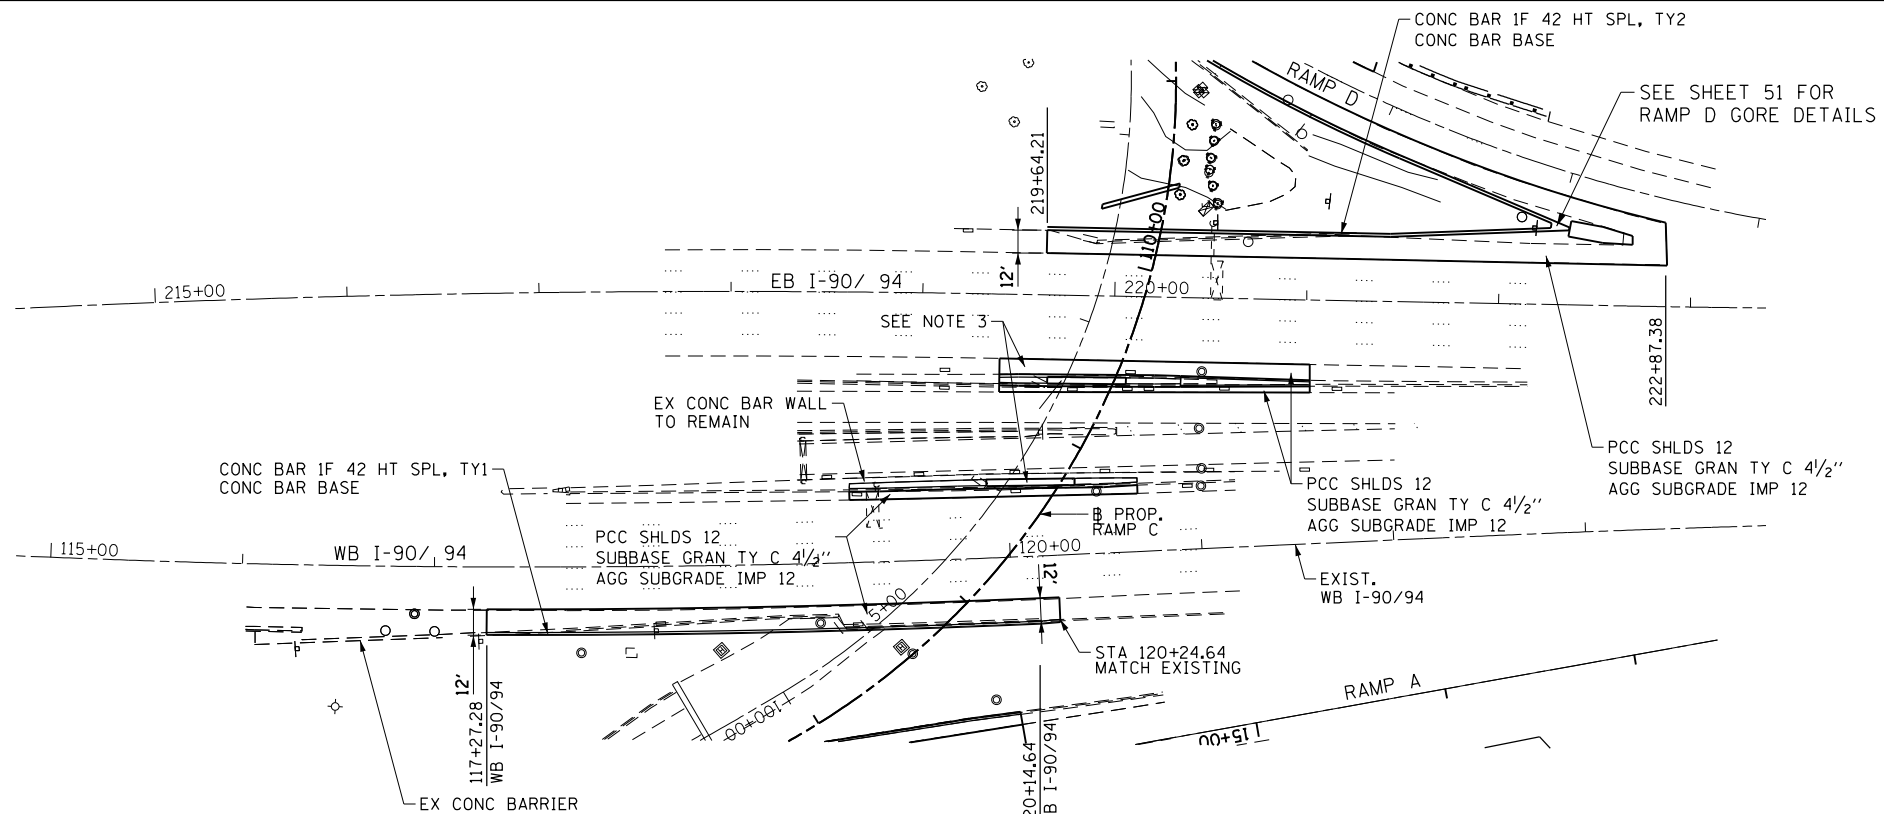

PROPOSED PLAN

NOTES:

1. DELINEATORS SHALL BE PLACED ALONG THE RAMP PER STANDARD 635001 SPACED 100 FT ON CENTERS.
2. SEE CONCRETE BARRIER TRANSITION DETAIL SHEET FOR ADDITIONAL DETAILS ADJACENT TO PIER 1 AND PIER 2.
3. SHOULDER RUMBLE STRIPS, 16" SHALL BE PLACED ALONG FAI 90/ 94 PER STANDARD 642001 ON ALL NEW SHOULDERS AND IN ALL AREAS WHERE THEY ARE REMOVED FOR MAINTENANCE OF TRAFFIC OPERATIONS. THIS WORK SHALL BE PAID FOR AS SHOULDER RUMBLE STRIPS, 16".

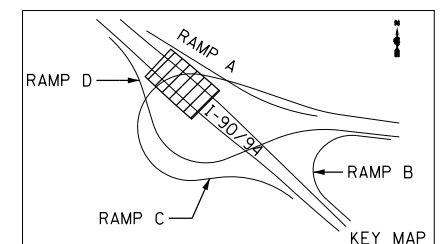

FILE NAME = I:\7000 - 194 at Ohio Street\CADD\CADD SHEETS\1160663-RMP4.dgn

COLLINS ENGINEERS

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| USER NAME = rge11 | DESIGNED - |
| PLOT SCALE = 100.000000' / in. | DRAWN - |
| PLOT DATE = 3/25/2013 | CHECKED - |
| | DATE - |

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




**STATE OF ILLINOIS
DEPARTMENT OF TRANSPORTATION**

**I-90/94 (KENNEDY EXPRESSWAY)
EXISTING AND PROPOSED PLAN**

SCALE: SHEET NO. OF SHEETS STA. TO STA.

| | | | | |
|---|----------------------|-------------|------------------|--------------|
| F.A.I. RTE. 90/94 | SECTION 0303-474HB-R | COUNTY COOK | TOTAL SHEETS 368 | SHEET NO. 40 |
| CONTRACT NO. 60F63 | | | | |
| FED. ROAD DIST. NO. 1 ILLINOIS FED. AID PROJECT | | | | |

LEGEND - REMOVAL

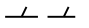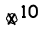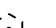-  PAVEMENT REMOVAL
-  MEDIAN / SHOULDER REMOVAL
-  LINEAR REMOVAL
-  TREE REMOVAL (SIZE IN UNITS)
-  TREE TRUNK PROTECTION

NOTES:

1. SEE STRUCTURE PLANS FOR REMOVALS ON STRUCTURE.
2. SEE DRAINAGE AND UTILITY PLANS FOR REMOVAL OF DRAINAGE RELATED ITEMS.
3. REMOVAL OF SIGN PANEL ASSEMBLY, TYPE A OR TYPE B INCLUDES THE REMOVAL OF THE EXISTING SIGN PANEL.
4. SEE EXISTING LIGHTING PLAN FOR REMOVAL OF EXISTING LIGHTING UNITS.
5. THE CONTRACTOR SHALL BE ADVISED THE INTERCHANGE CONTAINS AN EXISTING IRRIGATION SYSTEM. CARE SHALL BE TAKEN NOT TO DISTURB THE VALVES, PIPES, FITTINGS, ETC. OUTSIDE THE LIMITS OF CONSTRUCTION DURING REMOVAL OPERATIONS. SEE IRRIGATION PLANS FOR RESTORATION DETAILS.

MATCHLINE RAMP C STA 111+00
SEE SHEET 1 OF 3

MATCHLINE RAMP C STA 121+50
SEE SHEET 3 OF 3


MATCHLINE RAMP C STA 111+00
SEE SHEET 1 OF 3

MATCHLINE RAMP C STA 121+50
SEE SHEET 3 OF 3

EXISTING PLAN


PROPOSED PLAN

FILE NAME = I:\7000 - 194 at Ohio Street\CADD\CADD_SHEETS\116063-RMP2.dgn

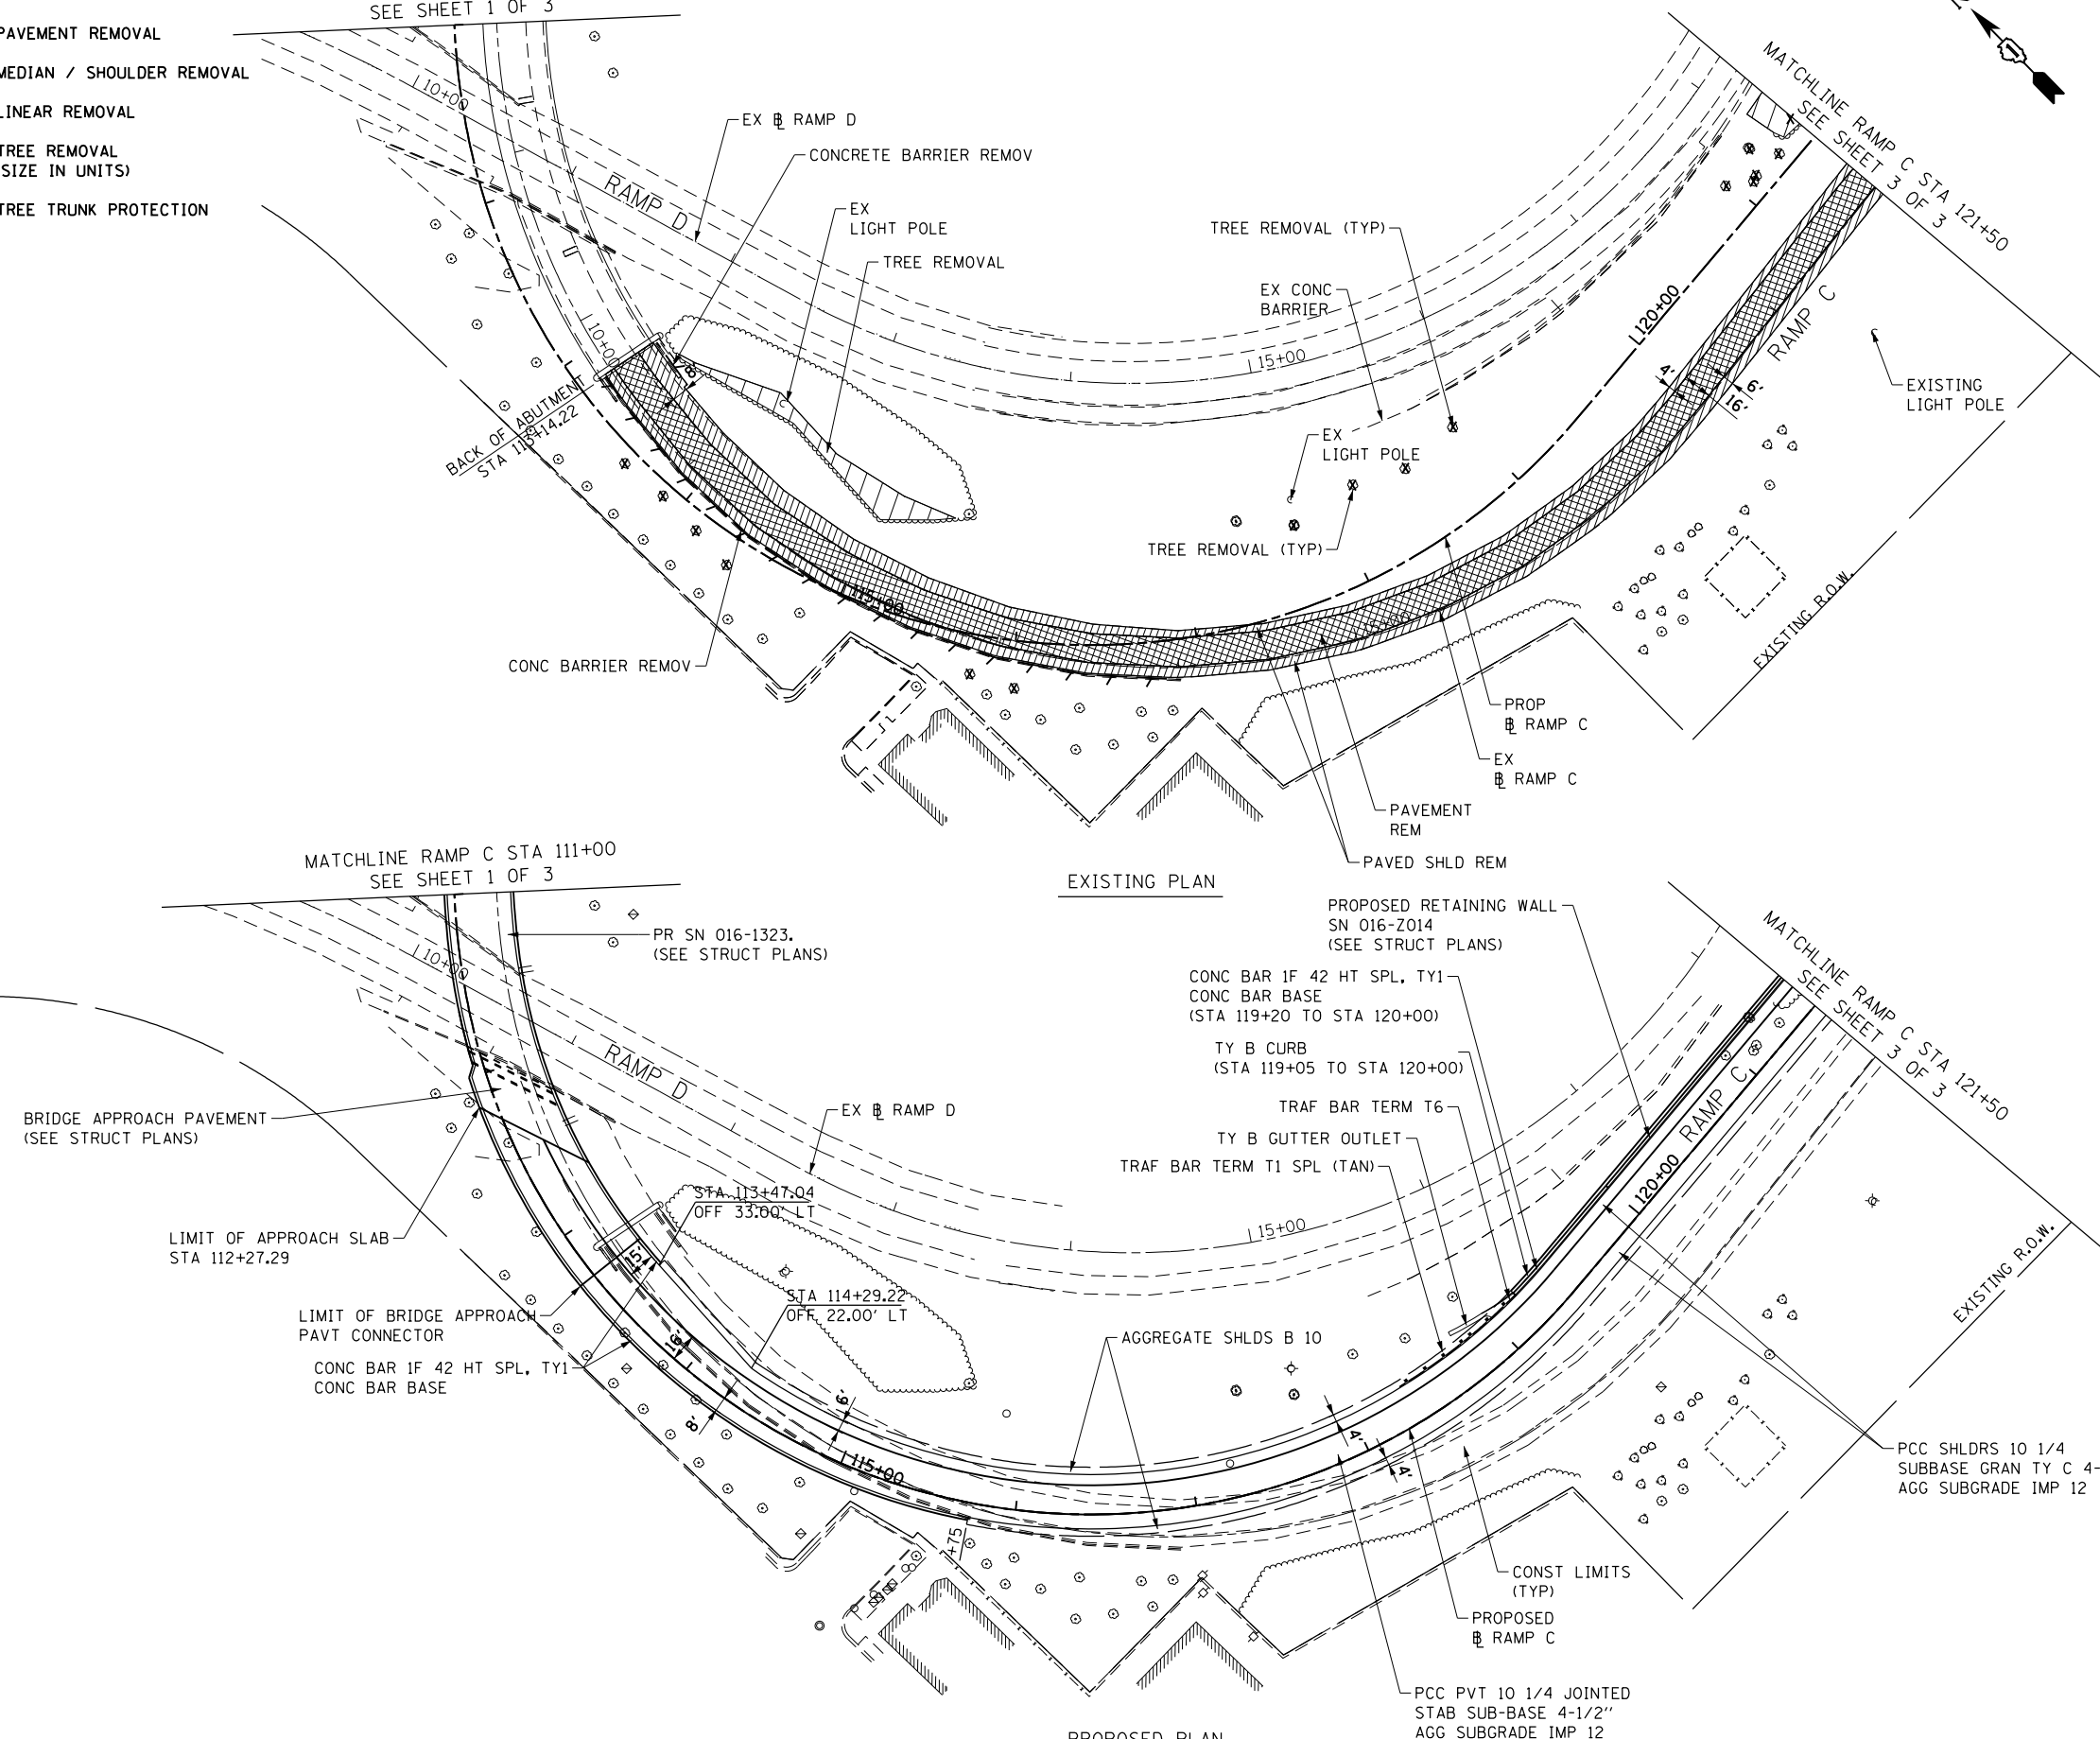

NOTES:

1. SEE PAVEMENT JOINTING PLAN FOR ADDITIONAL DETAILS.
2. DELINEATORS SHALL BE PLACED ALONG THE RAMPS PER STANDARD 635001 SPACED 100 FT ON CENTERS.
3. SEE STRUCTURAL PLANS FOR ANCHORAGE SLAB DETAILS.

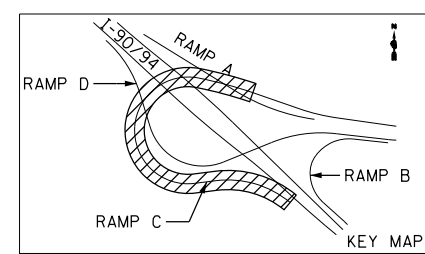

USER NAME = r9e11
 PLOT SCALE = 100.000000' / in.
 PLOT DATE = 3/25/2013

DESIGNED -
 DRAWN -
 CHECKED -
 DATE -

REVISED -
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 REVISED -


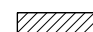
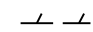
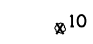

**STATE OF ILLINOIS
 DEPARTMENT OF TRANSPORTATION**


**RAMP C
 EXISTING AND PROPOSED PLAN**

SCALE: SHEET NO. OF SHEETS STA. TO STA.


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|---|--------------|--------|--------------|-----------|
| F.A.I. RTE. | SECTION | COUNTY | TOTAL SHEETS | SHEET NO. |
| 90/94 | 0303-474HB-R | COOK | 368 | 42 |
| CONTRACT NO. 60F63 | | | | |
| FED. ROAD DIST. NO. 1 ILLINOIS FED. AID PROJECT | | | | |

LEGEND - REMOVAL

-  PAVEMENT REMOVAL
-  MEDIAN / SHOULDER REMOVAL
-  LINEAR REMOVAL
-  TREE REMOVAL (SIZE IN UNITS)
-  TREE TRUNK PROTECTION

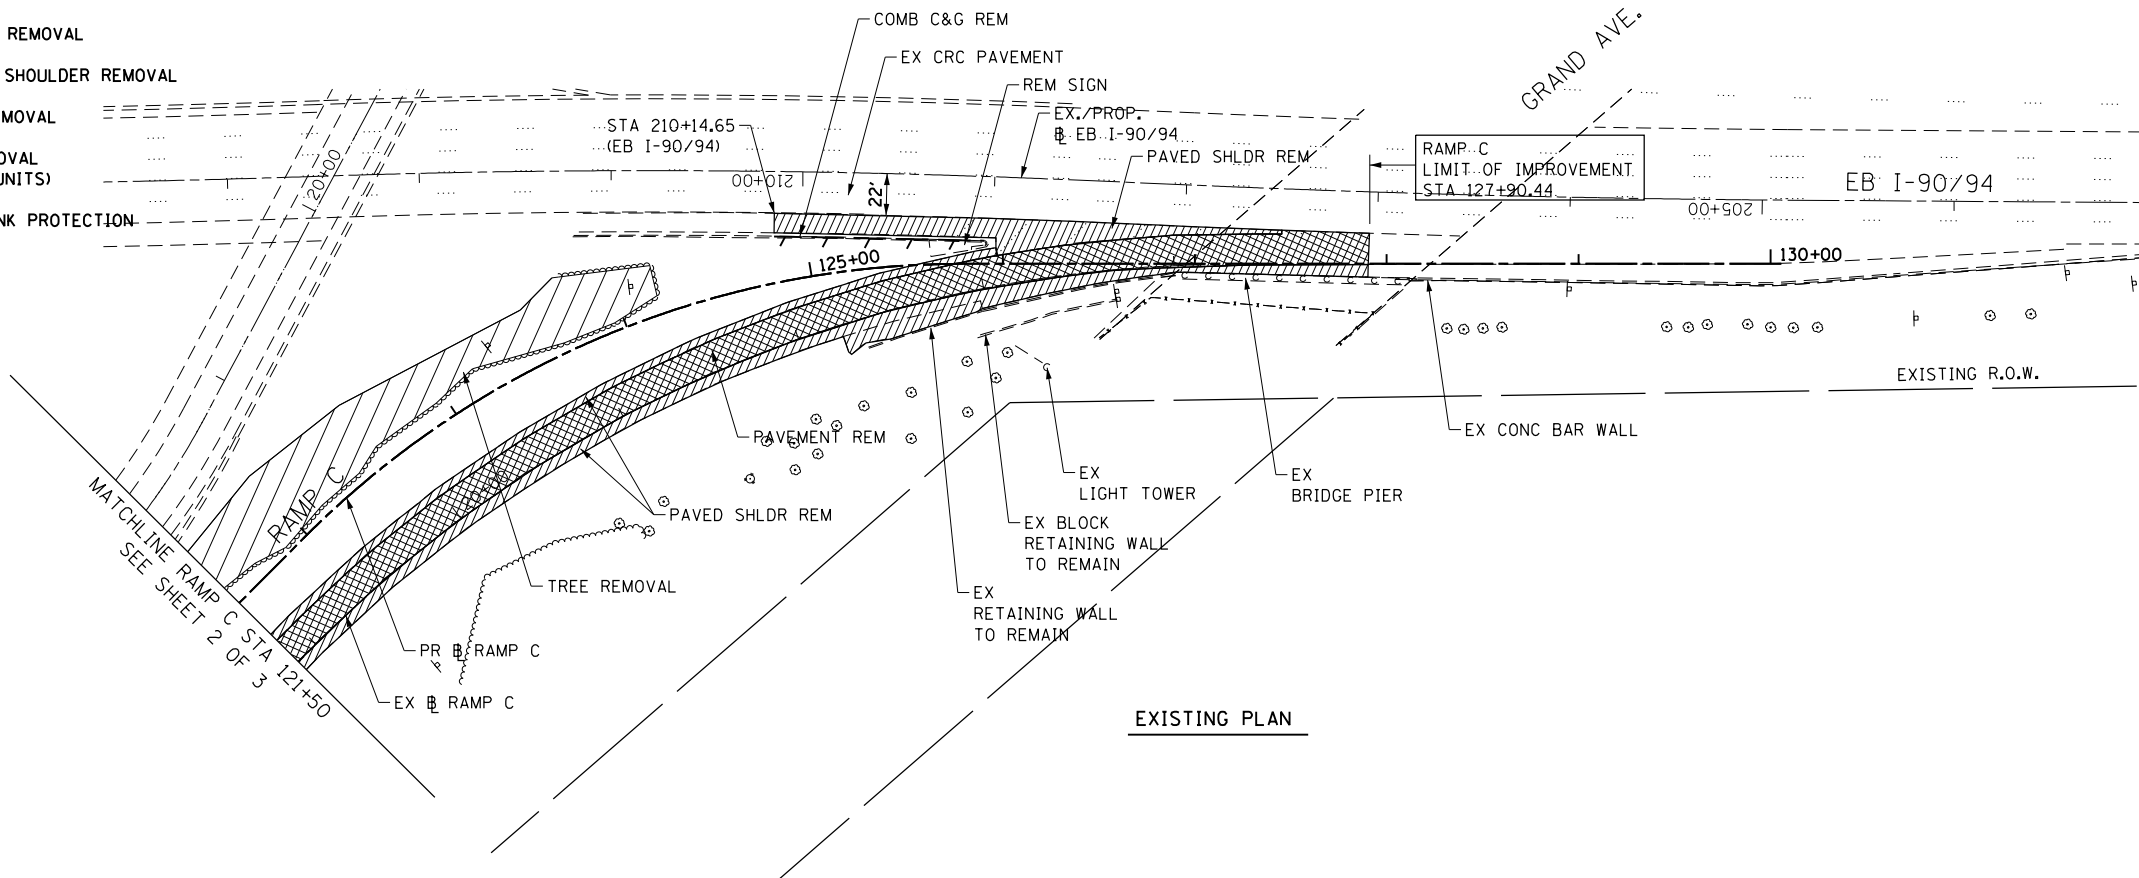



EXISTING PLAN

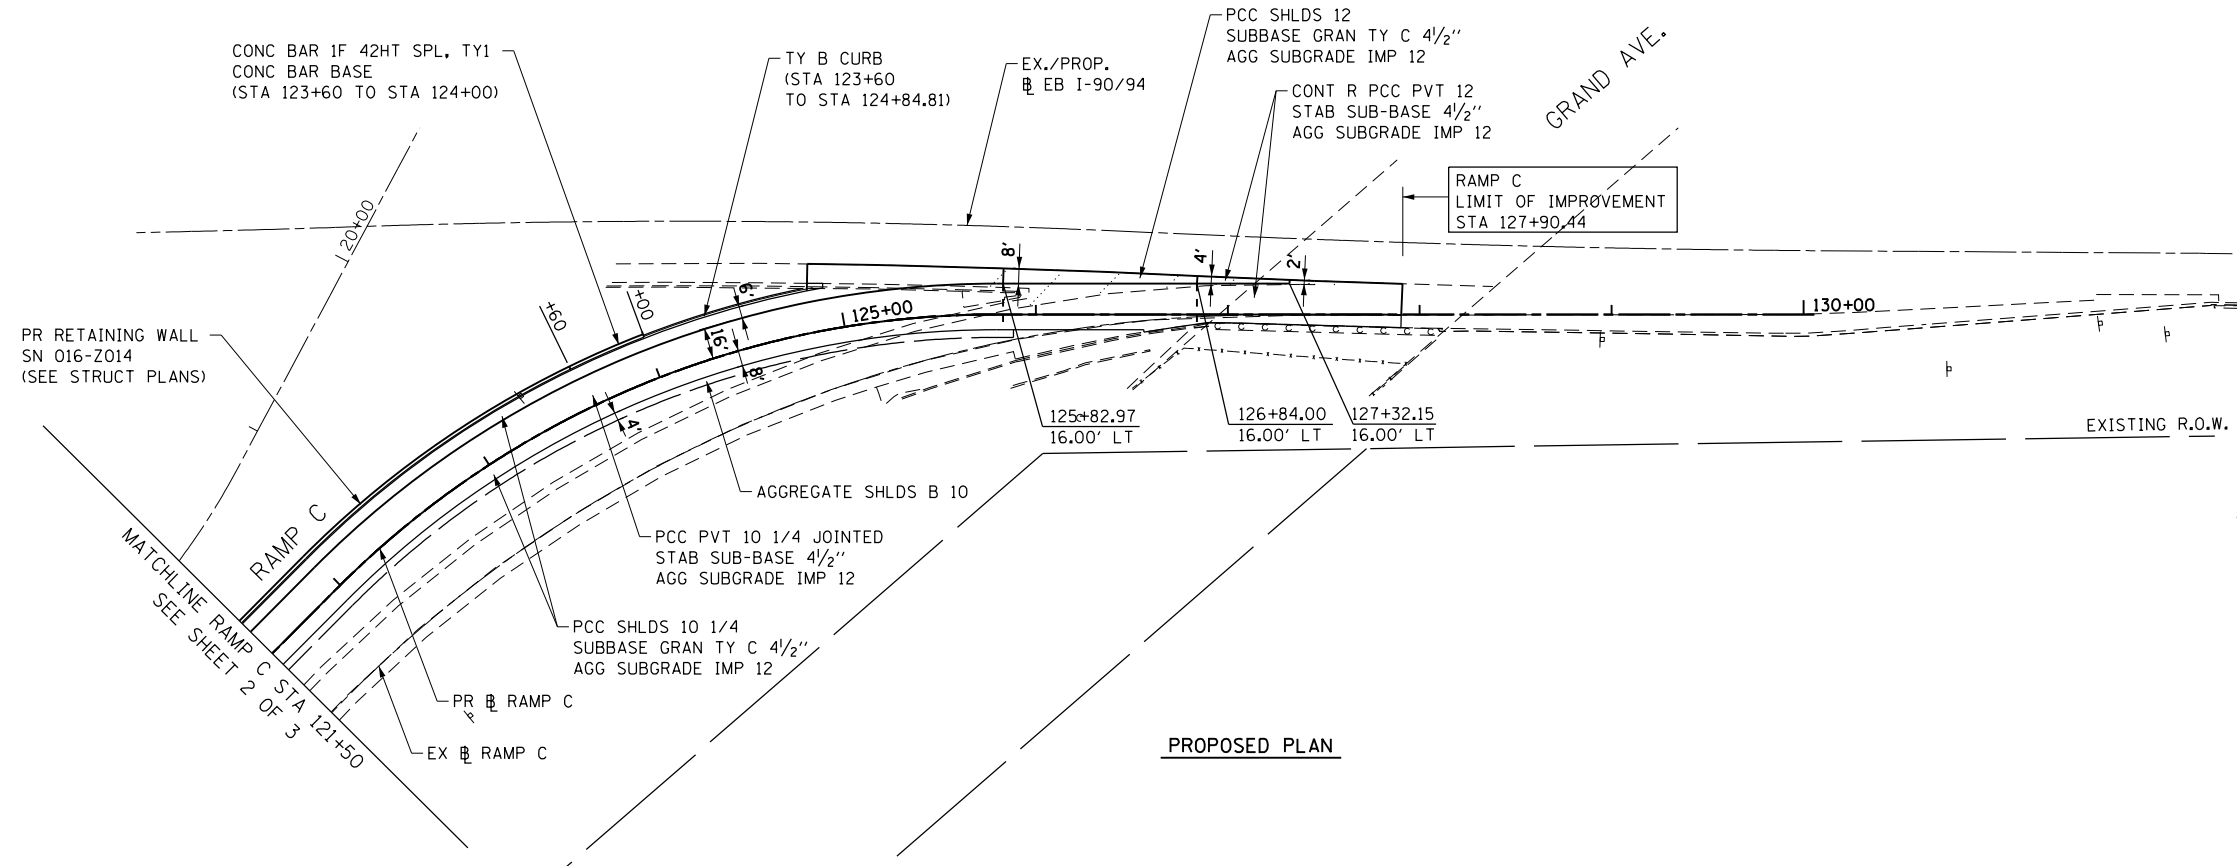

PROPOSED PLAN


NOTES:

1. SEE STRUCTURE PLANS FOR REMOVALS ON STRUCTURE.
2. SEE DRAINAGE AND UTILITY PLANS FOR REMOVAL OF DRAINAGE RELATED ITEMS.
3. REMOVAL OF SIGN PANEL ASSEMBLY, TYPE A OR TYPE B INCLUDES THE REMOVAL OF THE EXISTING SIGN PANEL.
4. SEE EXISTING LIGHTING PLAN FOR REMOVAL OF EXISTING LIGHTING UNITS.

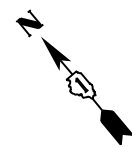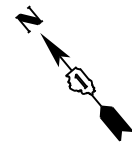

NOTES:

1. SEE PAVEMENT JOINTING PLAN FOR ADDITIONAL DETAILS.
2. DELINEATORS SHALL BE PLACED ALONG THE RAMPS PER STANDARD 635001 SPACED 100 FT ON CENTERS.
3. SEE STANDARD 420206 FOR ADDITIONAL ENTRANCE RAMP DETAILS.

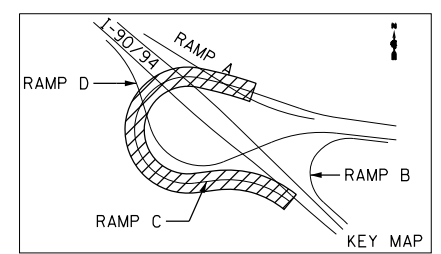

FILE NAME = I:\7000 - 194 at Ohio Street\CADD\CADD SHEETS\0160663-RMP3.dgn


COLLINS ENGINEERS

| | | |
|--------------------------------|------------|-----------|
| USER NAME = rge11 | DESIGNED - | REVISED - |
| PLOT SCALE = 100.000000' / in. | DRAWN - | REVISED - |
| PLOT DATE = 3/25/2013 | CHECKED - | REVISED - |
| | DATE - | REVISED - |

**STATE OF ILLINOIS
DEPARTMENT OF TRANSPORTATION**

| | | | |
|--|-----------|-----------|--------------|
| RAMP C EXISTING AND PROPOSED PLAN | | | |
| SCALE: | SHEET NO. | OF SHEETS | STA. TO STA. |

| | | | | |
|---|----------------------|-------------|------------------|--------------|
| F.A.I. RTE. 90/94 | SECTION 0303-474HB-R | COUNTY COOK | TOTAL SHEETS 368 | SHEET NO. 43 |
| CONTRACT NO. 60F63 | | | | |
| FED. ROAD DIST. NO. 1 ILLINOIS FED. AID PROJECT | | | | |


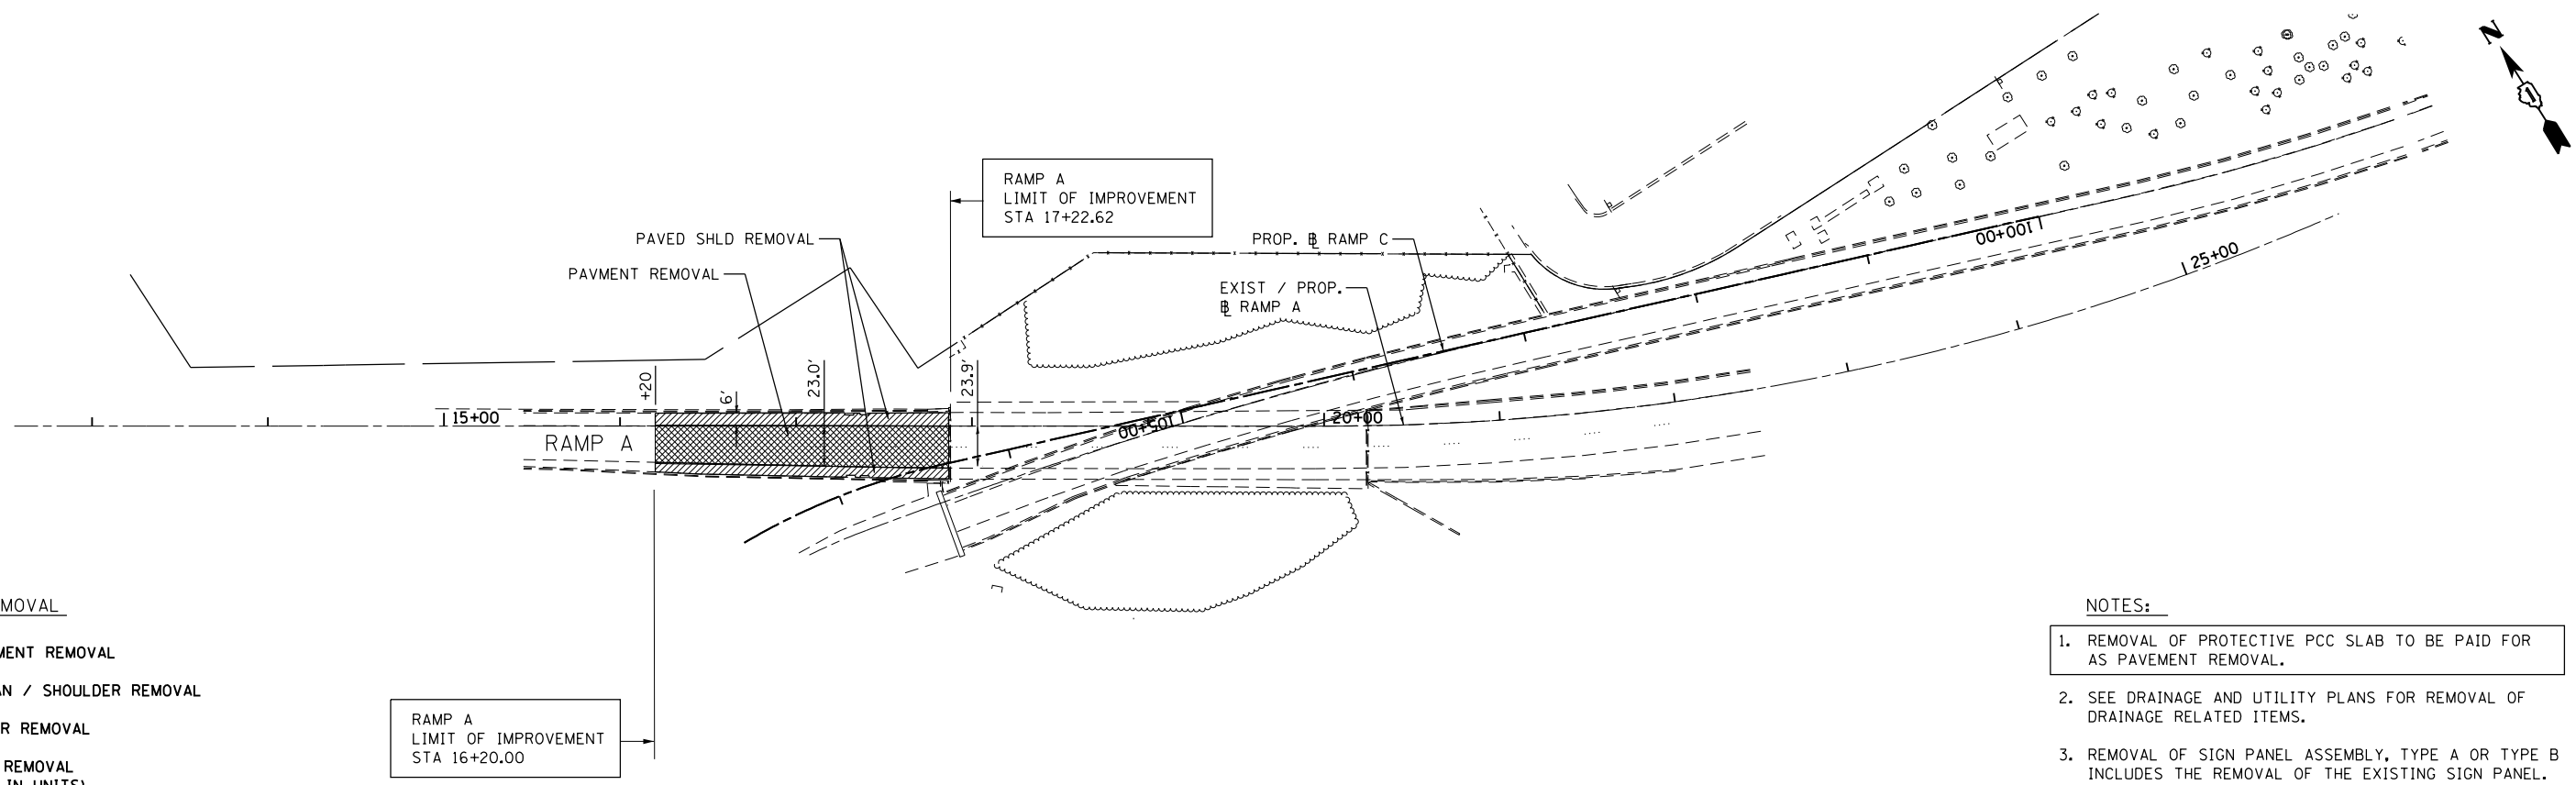


LEGEND - REMOVAL

- PAVEMENT REMOVAL
- MEDIAN / SHOULDER REMOVAL
- LINEAR REMOVAL
- TREE REMOVAL (SIZE IN UNITS)
- TREE TRUNK PROTECTION

NOTES:

1. REMOVAL OF PROTECTIVE PCC SLAB TO BE PAID FOR AS PAVEMENT REMOVAL.
2. SEE DRAINAGE AND UTILITY PLANS FOR REMOVAL OF DRAINAGE RELATED ITEMS.
3. REMOVAL OF SIGN PANEL ASSEMBLY, TYPE A OR TYPE B INCLUDES THE REMOVAL OF THE EXISTING SIGN PANEL.
4. SEE EXISTING LIGHTING PLAN FOR REMOVAL OF EXISTING LIGHTING UNITS.

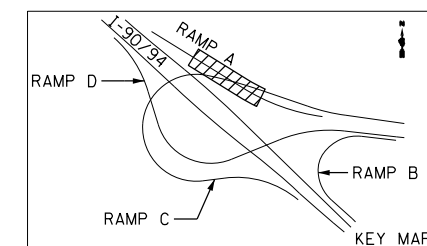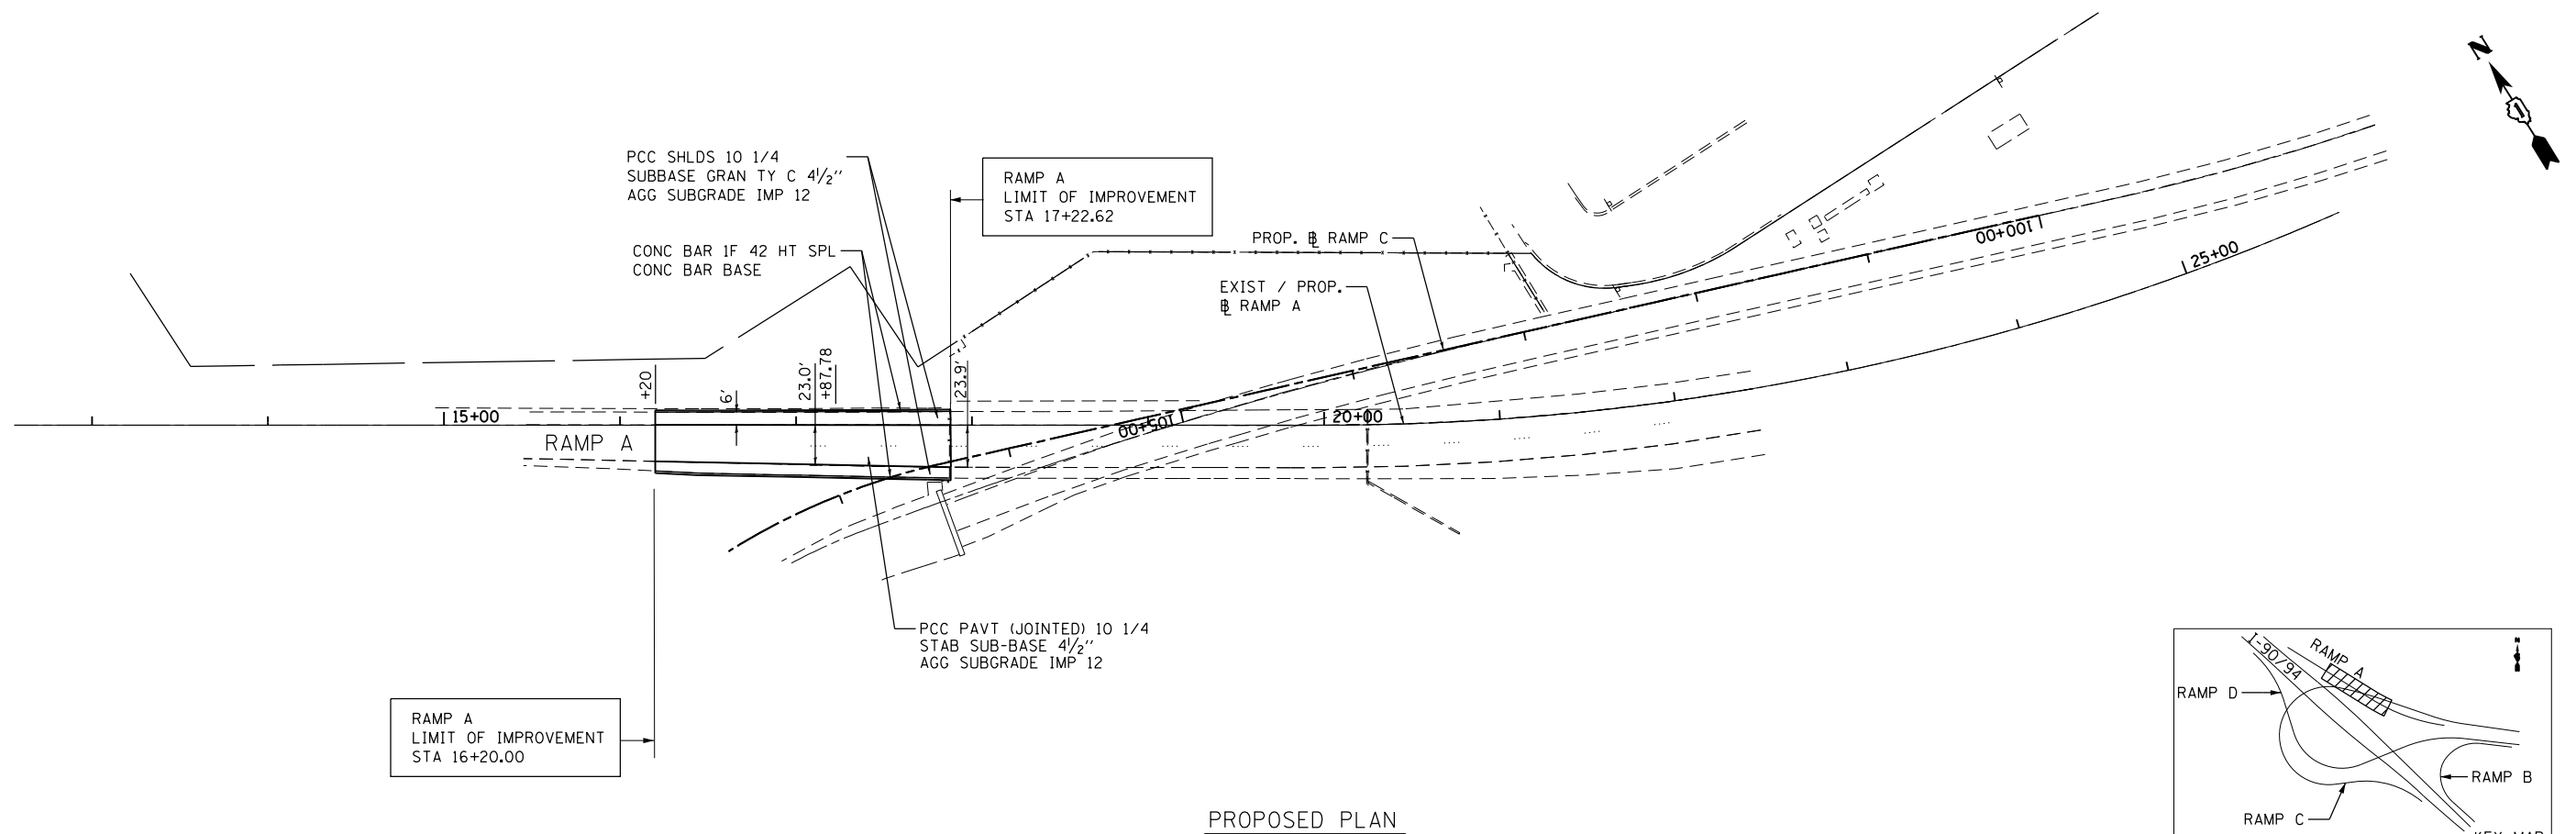

FILE NAME = I:\7000 - 194 at Ohio Street\CADD\CADD_SHEETS\0160663-RMP_Ramp_A.dgn

COLLINS ENGINEERS

| | | |
|--------------------------------|------------|-----------|
| USER NAME = rge11 | DESIGNED - | REVISED - |
| PLOT SCALE = 100.000000' / in. | DRAWN - | REVISED - |
| PLOT DATE = 3/25/2013 | CHECKED - | REVISED - |
| | DATE - | REVISED - |





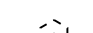
**STATE OF ILLINOIS
DEPARTMENT OF TRANSPORTATION**




**RAMP A
EXISTING AND PROPOSED PLAN**

SCALE: SHEET NO. OF SHEETS STA. TO STA.

| | | | | |
|---|----------------------|-------------|------------------|--------------|
| F.A.I. RTE. 90/94 | SECTION 0303-474HB-R | COUNTY COOK | TOTAL SHEETS 368 | SHEET NO. 44 |
| CONTRACT NO. 60F63 | | | | |
| FED. ROAD DIST. NO. 1 ILLINOIS FED. AID PROJECT | | | | |

LEGEND - REMOVAL

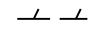-  PAVEMENT REMOVAL
-  MEDIAN / SHOULDER REMOVAL
-  LINEAR REMOVAL
-  TREE REMOVAL (SIZE IN UNITS)
-  TREE TRUNK PROTECTION

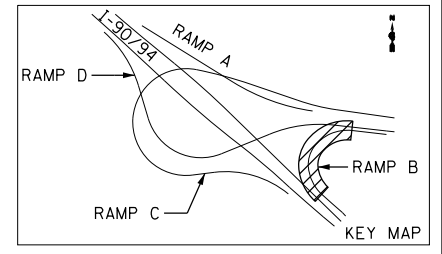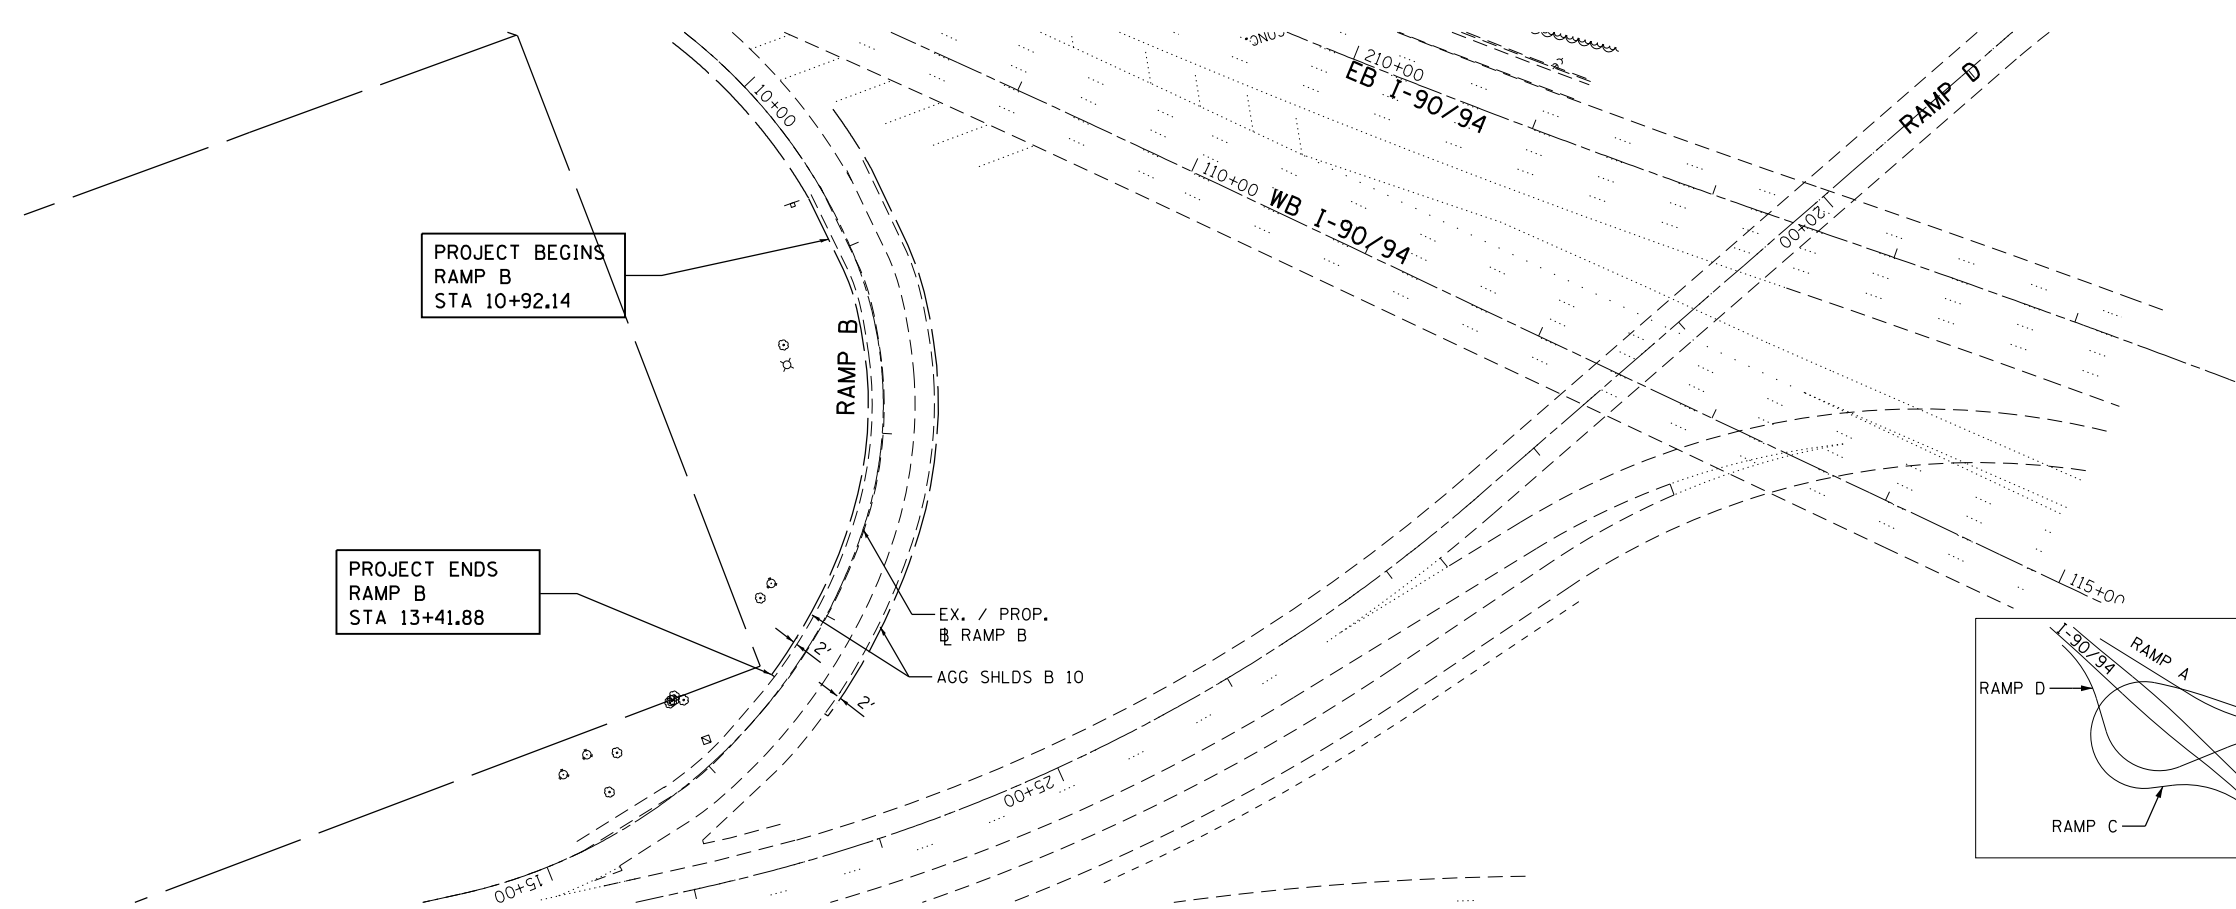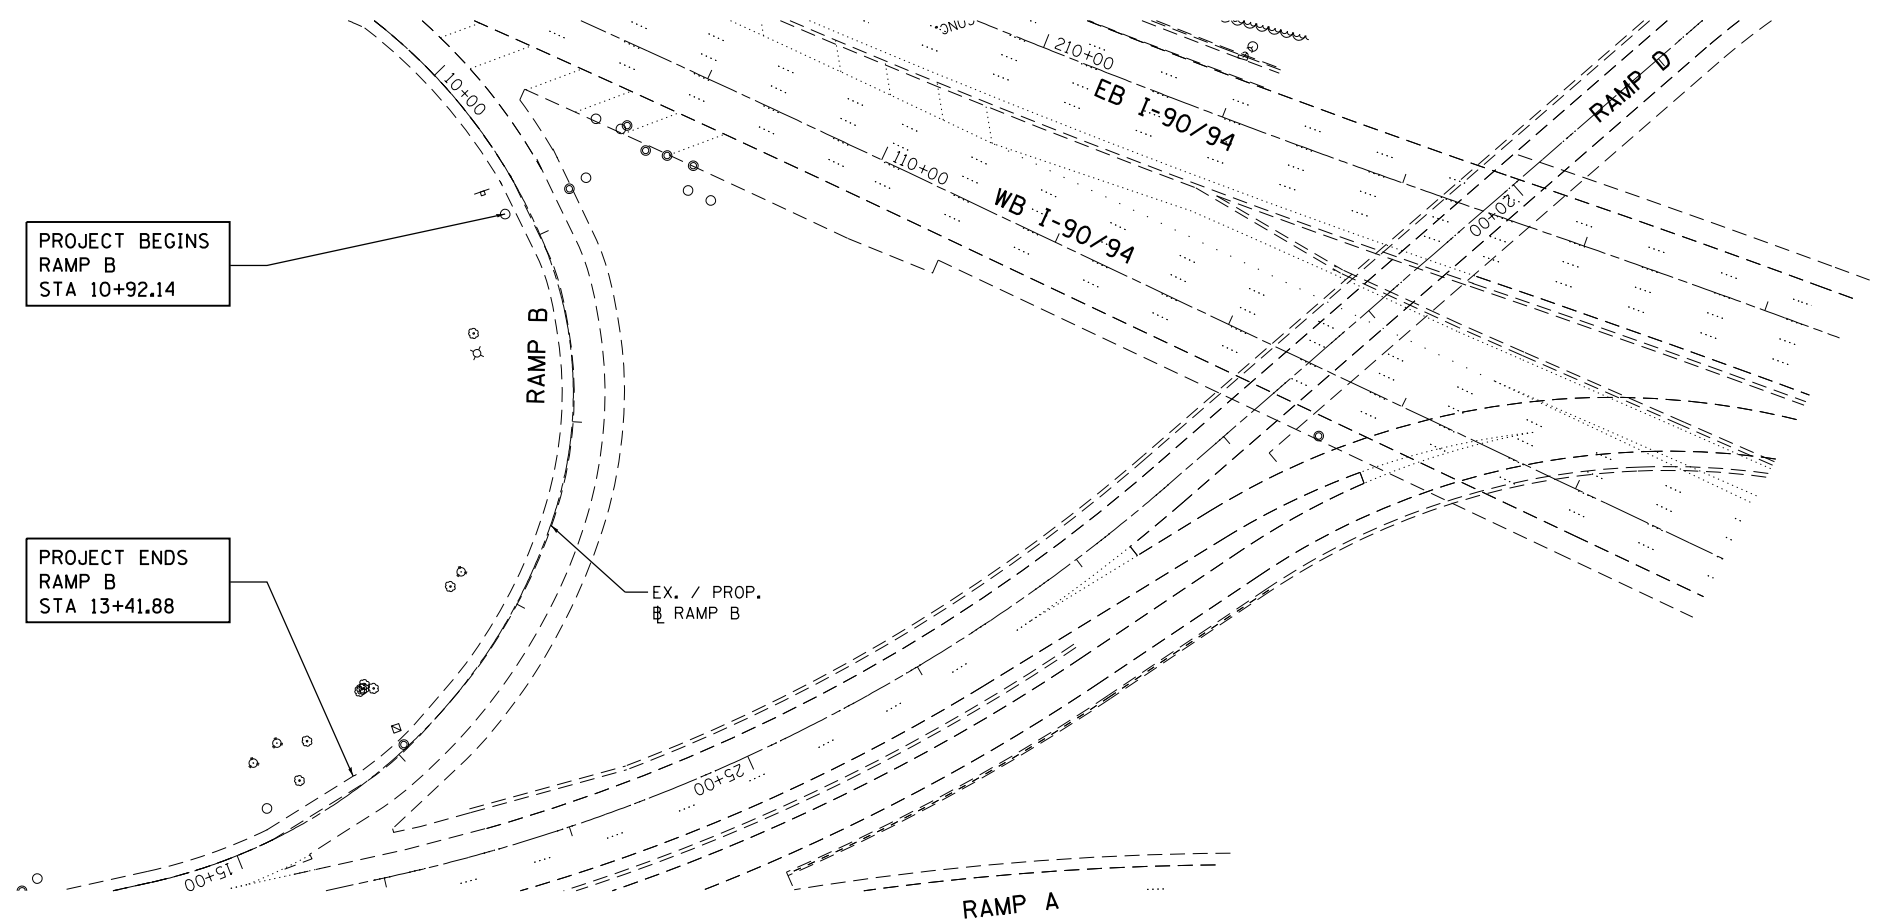

FILE NAME = I:\7000 - 194 at Ohio Street\CADD\CADD_SHEETS\DI60F63-RNP5.dgn

COLLINS ENGINEERS

| | | |
|--------------------------------|------------|-----------|
| USER NAME = rge11 | DESIGNED - | REVISED - |
| PLOT SCALE = 100.000000' / in. | DRAWN - | REVISED - |
| PLOT DATE = 3/25/2013 | CHECKED - | REVISED - |
| | DATE - | REVISED - |





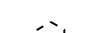
**STATE OF ILLINOIS
DEPARTMENT OF TRANSPORTATION**


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|--|-----------|-----------|--------------|
| RAMP B EXISTING AND PROPOSED PLAN | | | |
| SCALE: | SHEET NO. | OF SHEETS | STA. TO STA. |

| | | | | |
|---|-------------------------|----------------|---------------------|-----------------|
| F.A.I. RTE. 90/94 | SECTION 0303-474HB-R | COUNTY COOK | TOTAL SHEETS 368 | SHEET NO. 45 |
| FED. ROAD DIST. NO. 1 ILLINOIS FED. AID PROJECT | | | | |


CONTRACT NO. 60F63

LEGEND - REMOVAL

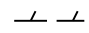-  PAVEMENT REMOVAL
-  MEDIAN / SHOULDER REMOVAL
-  LINEAR REMOVAL
-  TREE REMOVAL (SIZE IN UNITS)
-  TREE TRUNK PROTECTION

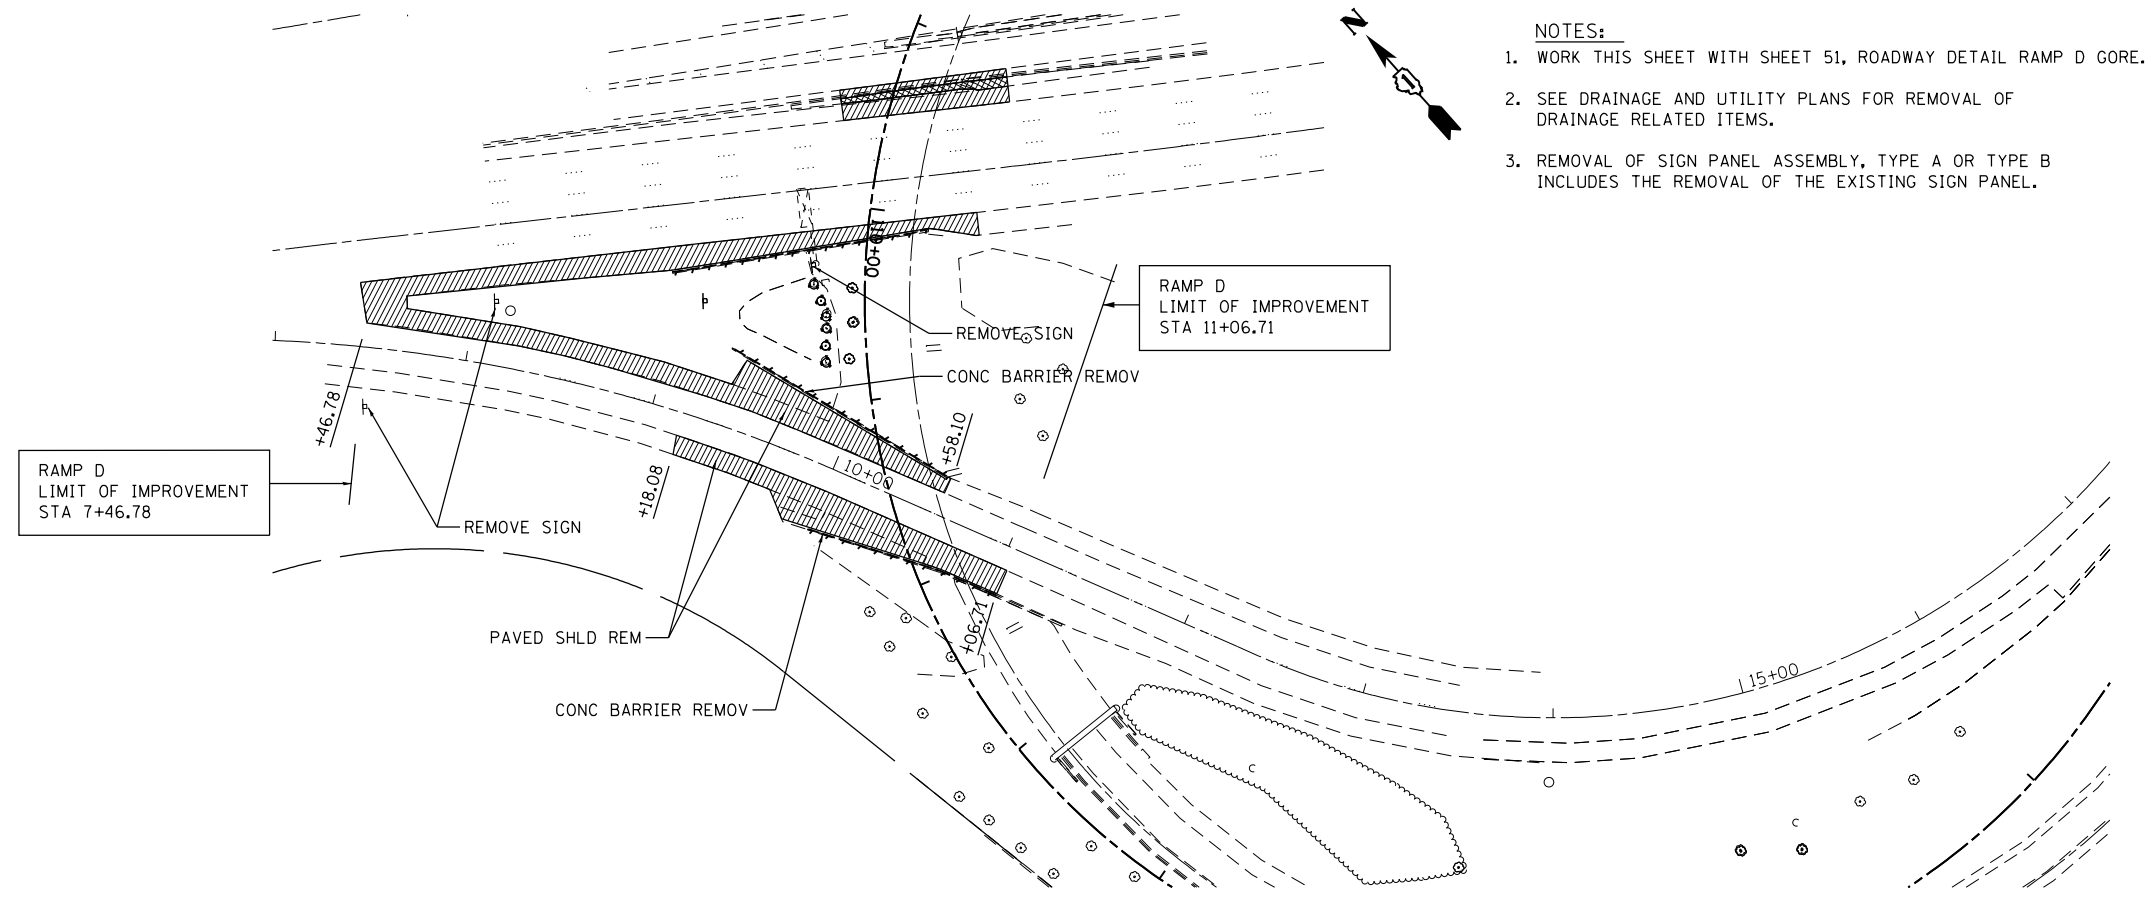

- NOTES:
1. WORK THIS SHEET WITH SHEET 51, ROADWAY DETAIL RAMP D GORE.
 2. SEE DRAINAGE AND UTILITY PLANS FOR REMOVAL OF DRAINAGE RELATED ITEMS.
 3. REMOVAL OF SIGN PANEL ASSEMBLY, TYPE A OR TYPE B INCLUDES THE REMOVAL OF THE EXISTING SIGN PANEL.

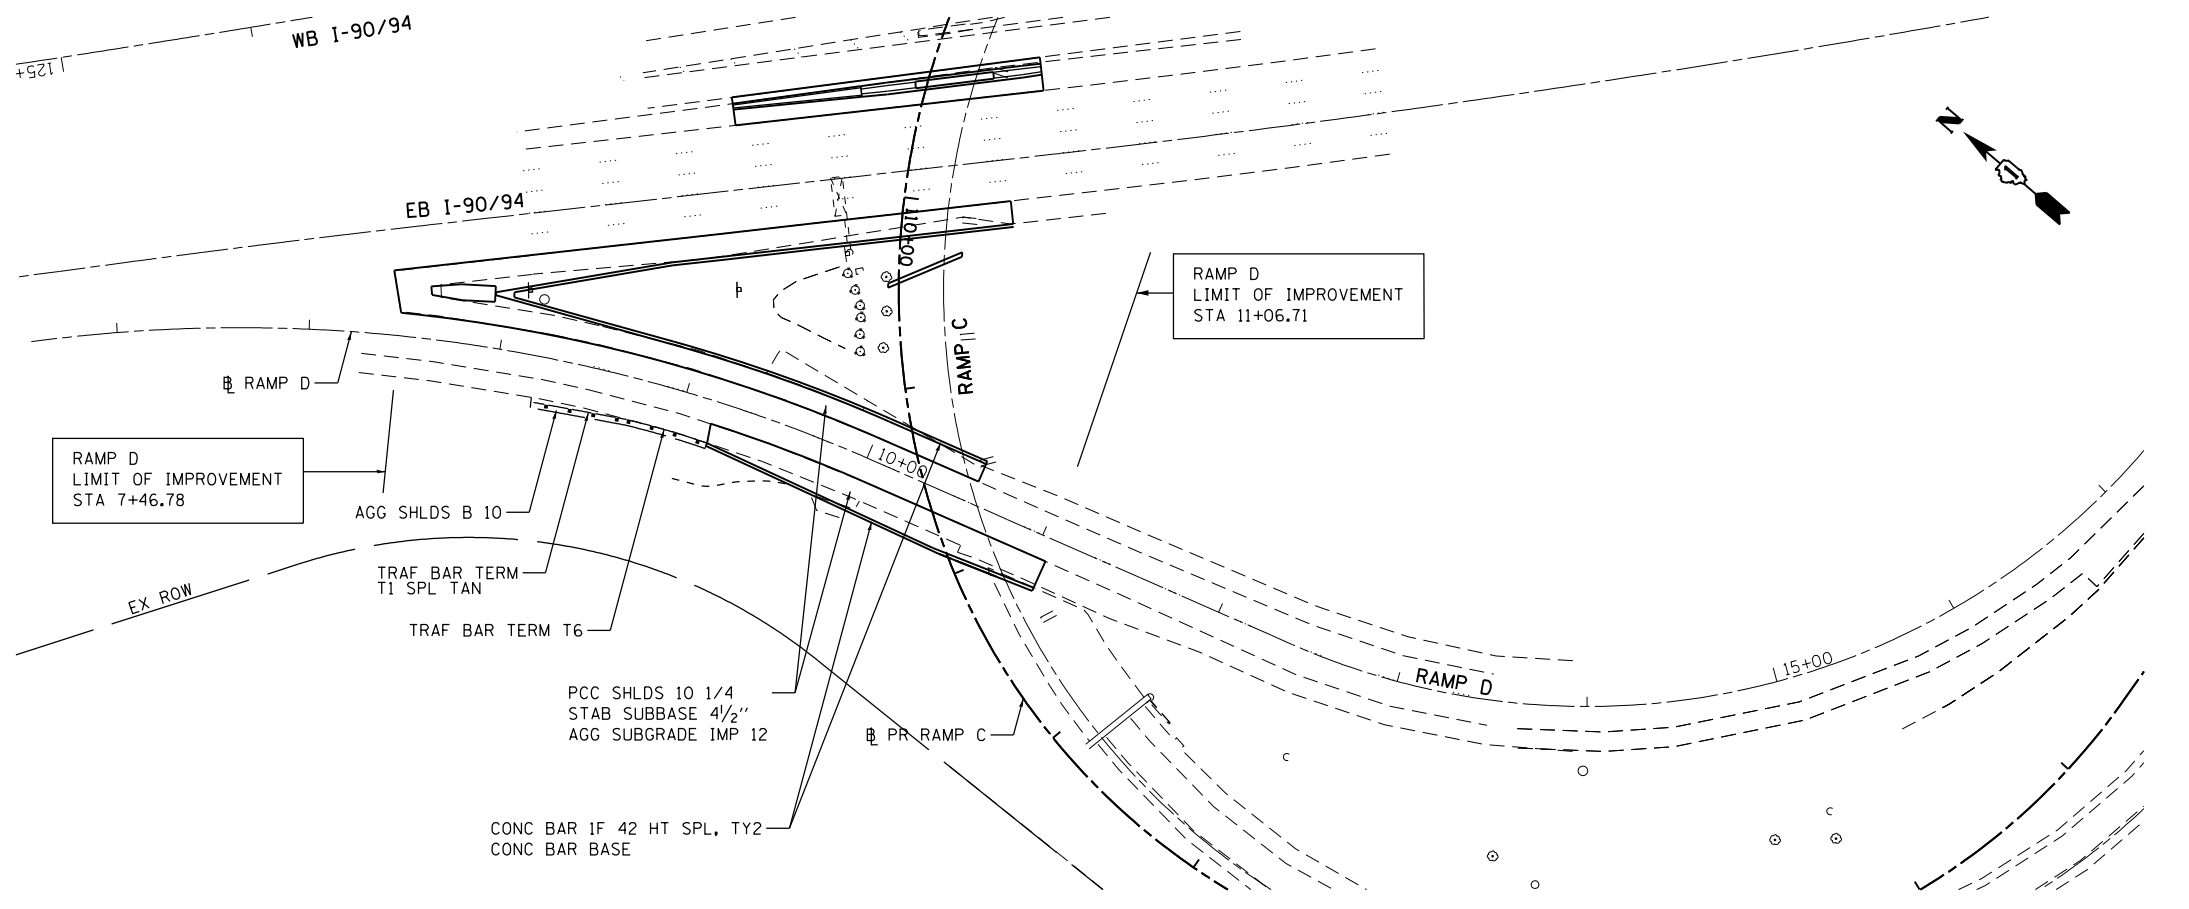

FILE NAME = 8FILES



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|-----------------------------|------------|-----------|
| USER NAME = rge11 | DESIGNED - | REVISED - |
| PLOT SCALE = 100.000' / in. | DRAWN - | REVISED - |
| PLOT DATE = 3/25/2013 | CHECKED - | REVISED - |
| | DATE - | REVISED - |



**STATE OF ILLINOIS
DEPARTMENT OF TRANSPORTATION**

**RAMP D
EXISTING AND PROPOSED PLAN**

SCALE: SHEET NO. OF SHEETS STA. TO STA.

| | | | | |
|---|--------------|--------|--------------|-----------|
| F.A.I. RTE. | SECTION | COUNTY | TOTAL SHEETS | SHEET NO. |
| 90/94 | 0303-474HB-R | COOK | 368 | 46 |
| CONTRACT NO. 60F63 | | | | |
| FED. ROAD DIST. NO. 1 ILLINOIS FED. AID PROJECT | | | | |

FILE NAME = I:\7000 - 194 at Ohio Street\CADD\CADD_SHEET\SD1606\63-PRF2.dgn

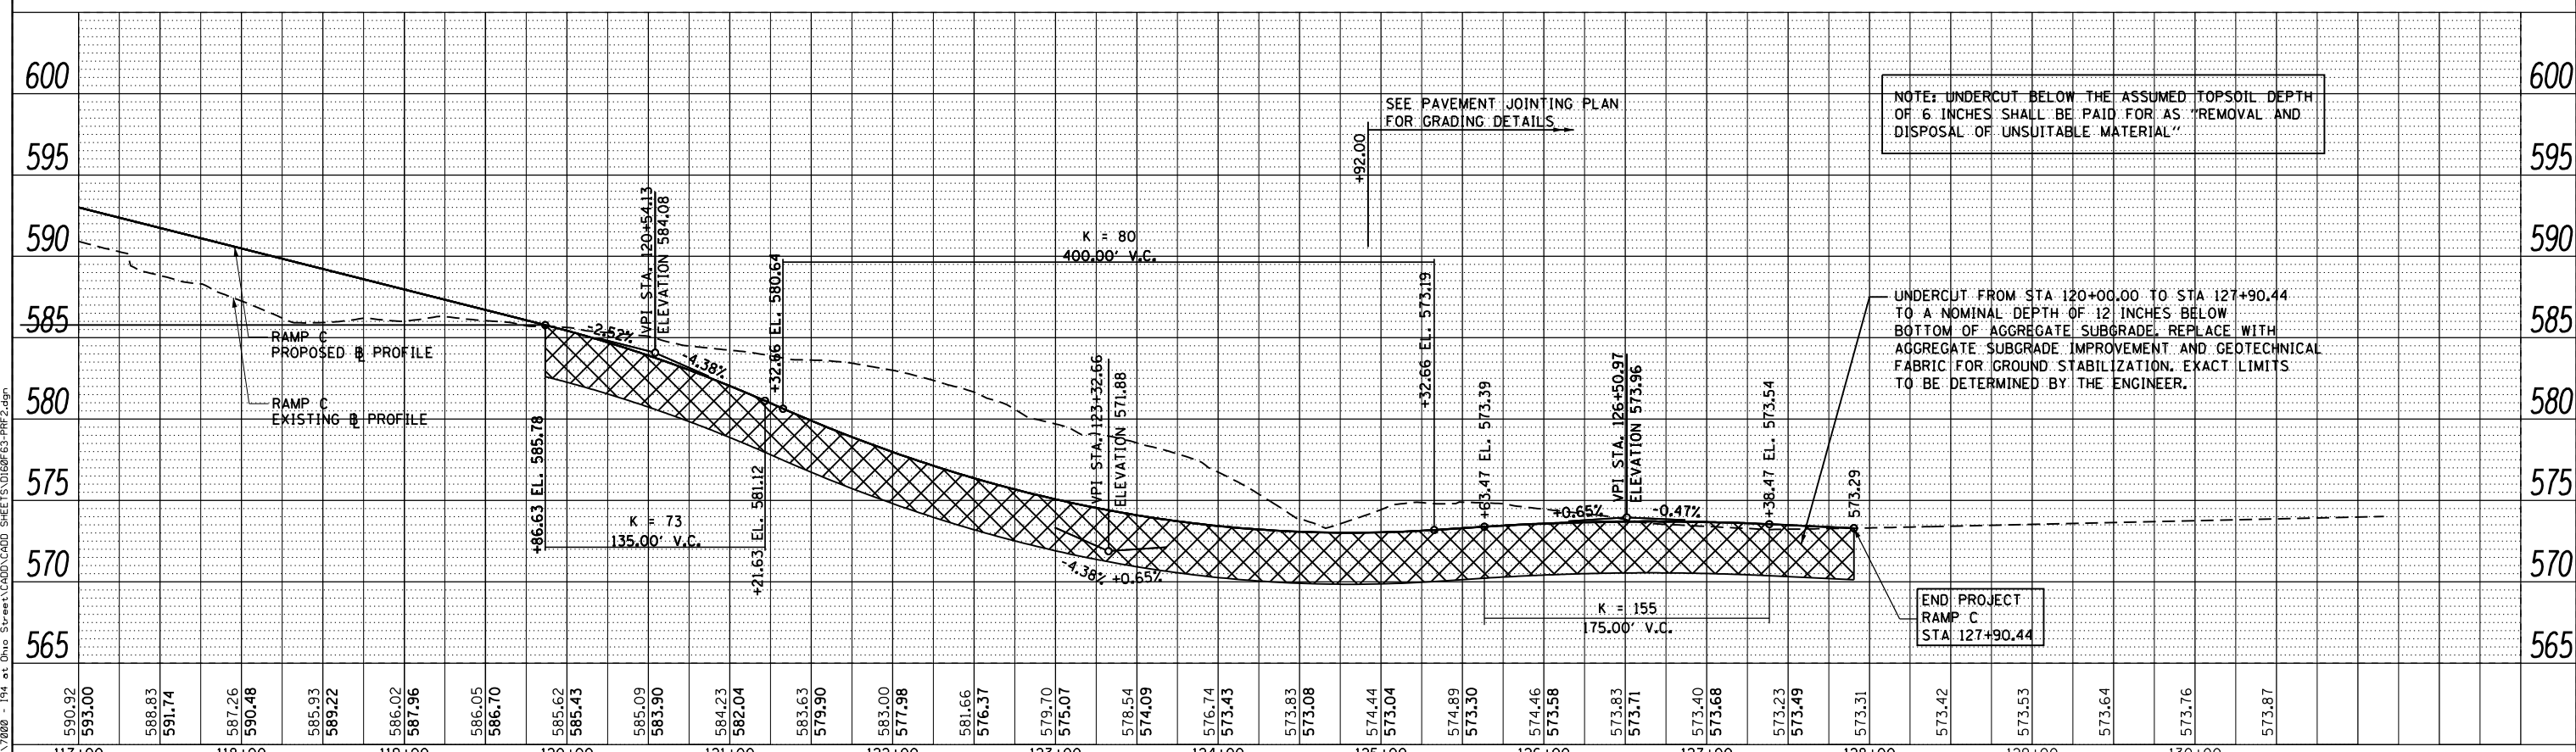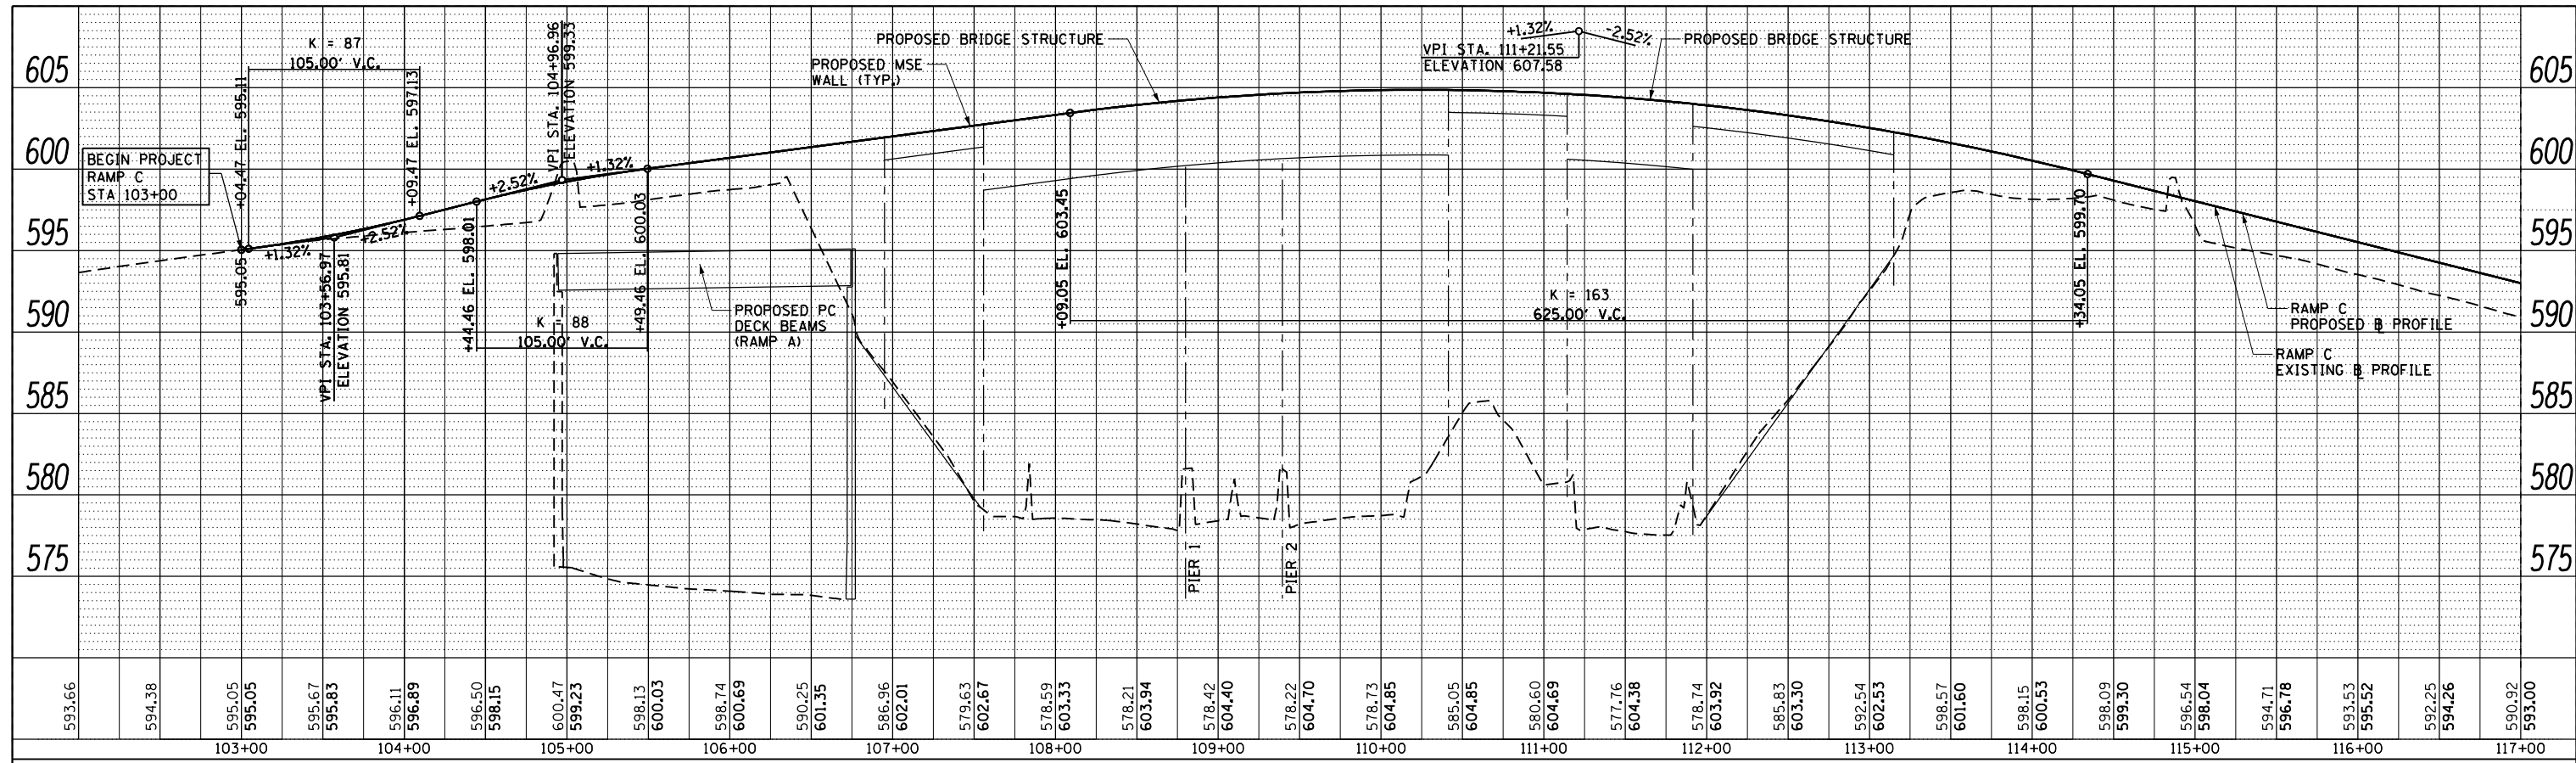

NOTE: UNDERCUT BELOW THE ASSUMED TOPSOIL DEPTH OF 6 INCHES SHALL BE PAID FOR AS "REMOVAL AND DISPOSAL OF UNSUITABLE MATERIAL"

UNDERCUT FROM STA 120+00.00 TO STA 127+90.44 TO A NOMINAL DEPTH OF 12 INCHES BELOW BOTTOM OF AGGREGATE SUBGRADE. REPLACE WITH AGGREGATE SUBGRADE IMPROVEMENT AND GEOTECHNICAL FABRIC FOR GROUND STABILIZATION. EXACT LIMITS TO BE DETERMINED BY THE ENGINEER.

COLLINS ENGINEERS

USER NAME = r9a11
 PLOT SCALE = 100.000' / 1" / in.
 PLOT DATE = 3/25/2013

DESIGNED -
 DRAWN -
 CHECKED -
 DATE -

REVISED -
 REVISED -
 REVISED -
 REVISED -

**STATE OF ILLINOIS
 DEPARTMENT OF TRANSPORTATION**

**PROPOSED ROADWAY PROFILE
 RAMP C**

SCALE: SHEET NO. OF SHEETS STA. TO STA.


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| F.A.I. RTE. | SECTION | COUNTY | TOTAL SHEETS | SHEET NO. |
| 90/94 | 0303-474H-R | COOK | 368 | 47 |
| CONTRACT NO. 60F63 | | | | |

FED. ROAD DIST. NO. 1 ILLINOIS FED. AID PROJECT

| | | | |
|------|-----------------------------|----|------|
| PLAN | SURVEYED | BY | DATE |
| | PLOTTED | | |
| | GRADES CHECKED | | |
| | STRUCTURE NOTATIONS CHECKED | | |
| | NOTE BOOK NO. | | |
| | CADD FILE NAME | | |

| | | | |
|---------|-----------------------------|----|------|
| PROFILE | SURVEYED | BY | DATE |
| | PLOTTED | | |
| | GRADES CHECKED | | |
| | STRUCTURE NOTATIONS CHECKED | | |
| | NOTE BOOK NO. | | |
| | CADD FILE NAME | | |

FILE NAME = \\collinsengr.com\1\update\1\Posanden\DDCS\7000 - 194.ctb Div: Street\CADD\SHETS\DI6063-PRF3.dgn

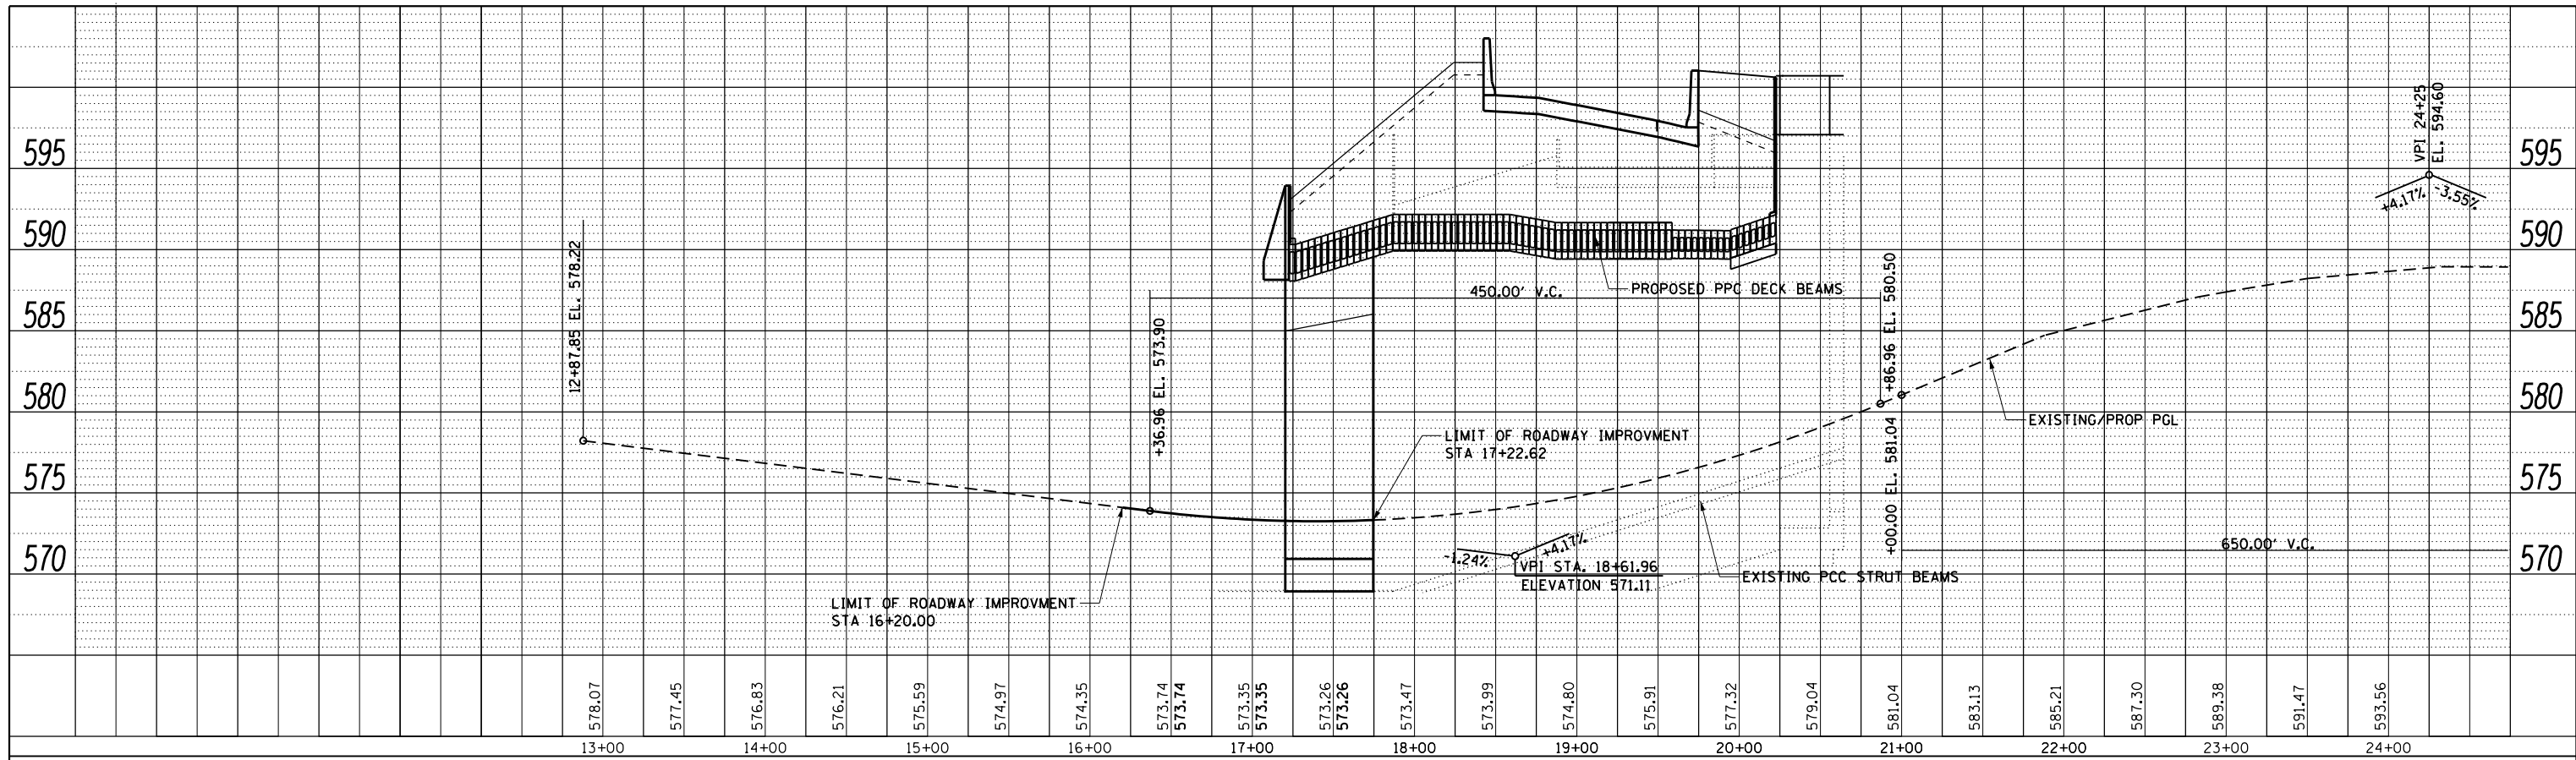

| | |
|--------|-------|
| 578.07 | 13+00 |
| 577.45 | 14+00 |
| 576.83 | 15+00 |
| 576.21 | 16+00 |
| 575.59 | 17+00 |
| 574.97 | 18+00 |
| 574.35 | 19+00 |
| 573.74 | 20+00 |
| 573.35 | 21+00 |
| 573.26 | 22+00 |
| 573.26 | 23+00 |
| 573.47 | 24+00 |
| 573.99 | |
| 574.80 | |
| 575.91 | |
| 577.32 | |
| 579.04 | |
| 581.04 | |
| 583.13 | |
| 585.21 | |
| 587.30 | |
| 589.38 | |
| 591.47 | |
| 593.56 | |



USER NAME = rge11
 PLOT SCALE = 100.000' / in.
 PLOT DATE = 3/25/2013



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| DESIGNED - | REVISED - |
| DRAWN - | REVISED - |
| CHECKED - | REVISED - |
| DATE - | REVISED - |

STATE OF ILLINOIS
 DEPARTMENT OF TRANSPORTATION


PROPOSED ROADWAY PROFILE
 RAMP A

SCALE: SHEET NO. OF SHEETS STA. TO STA.


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| F.A.I. RTE. | SECTION | COUNTY | TOTAL SHEETS | SHEET NO. |
| 90/94 | 0303-474HB-R | COOK | 368 | 48 |
| | | | | CONTRACT NO. 60F63 |
| ILLINOIS FED. AID PROJECT | | | | |

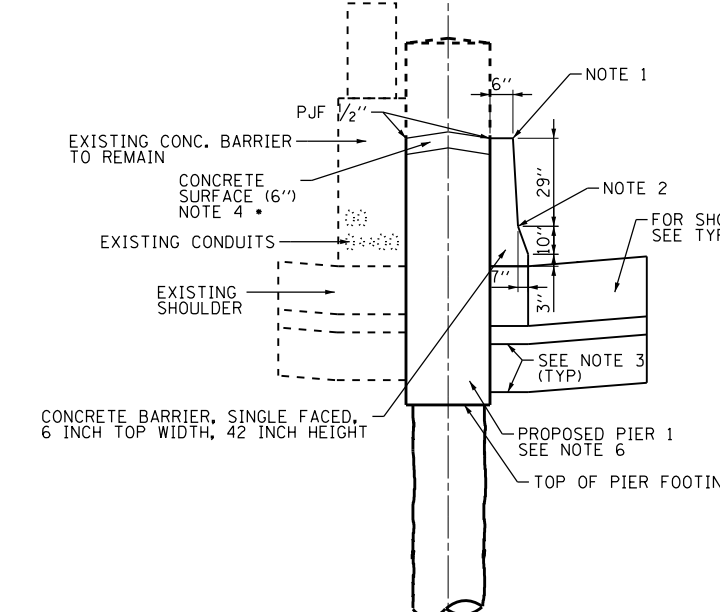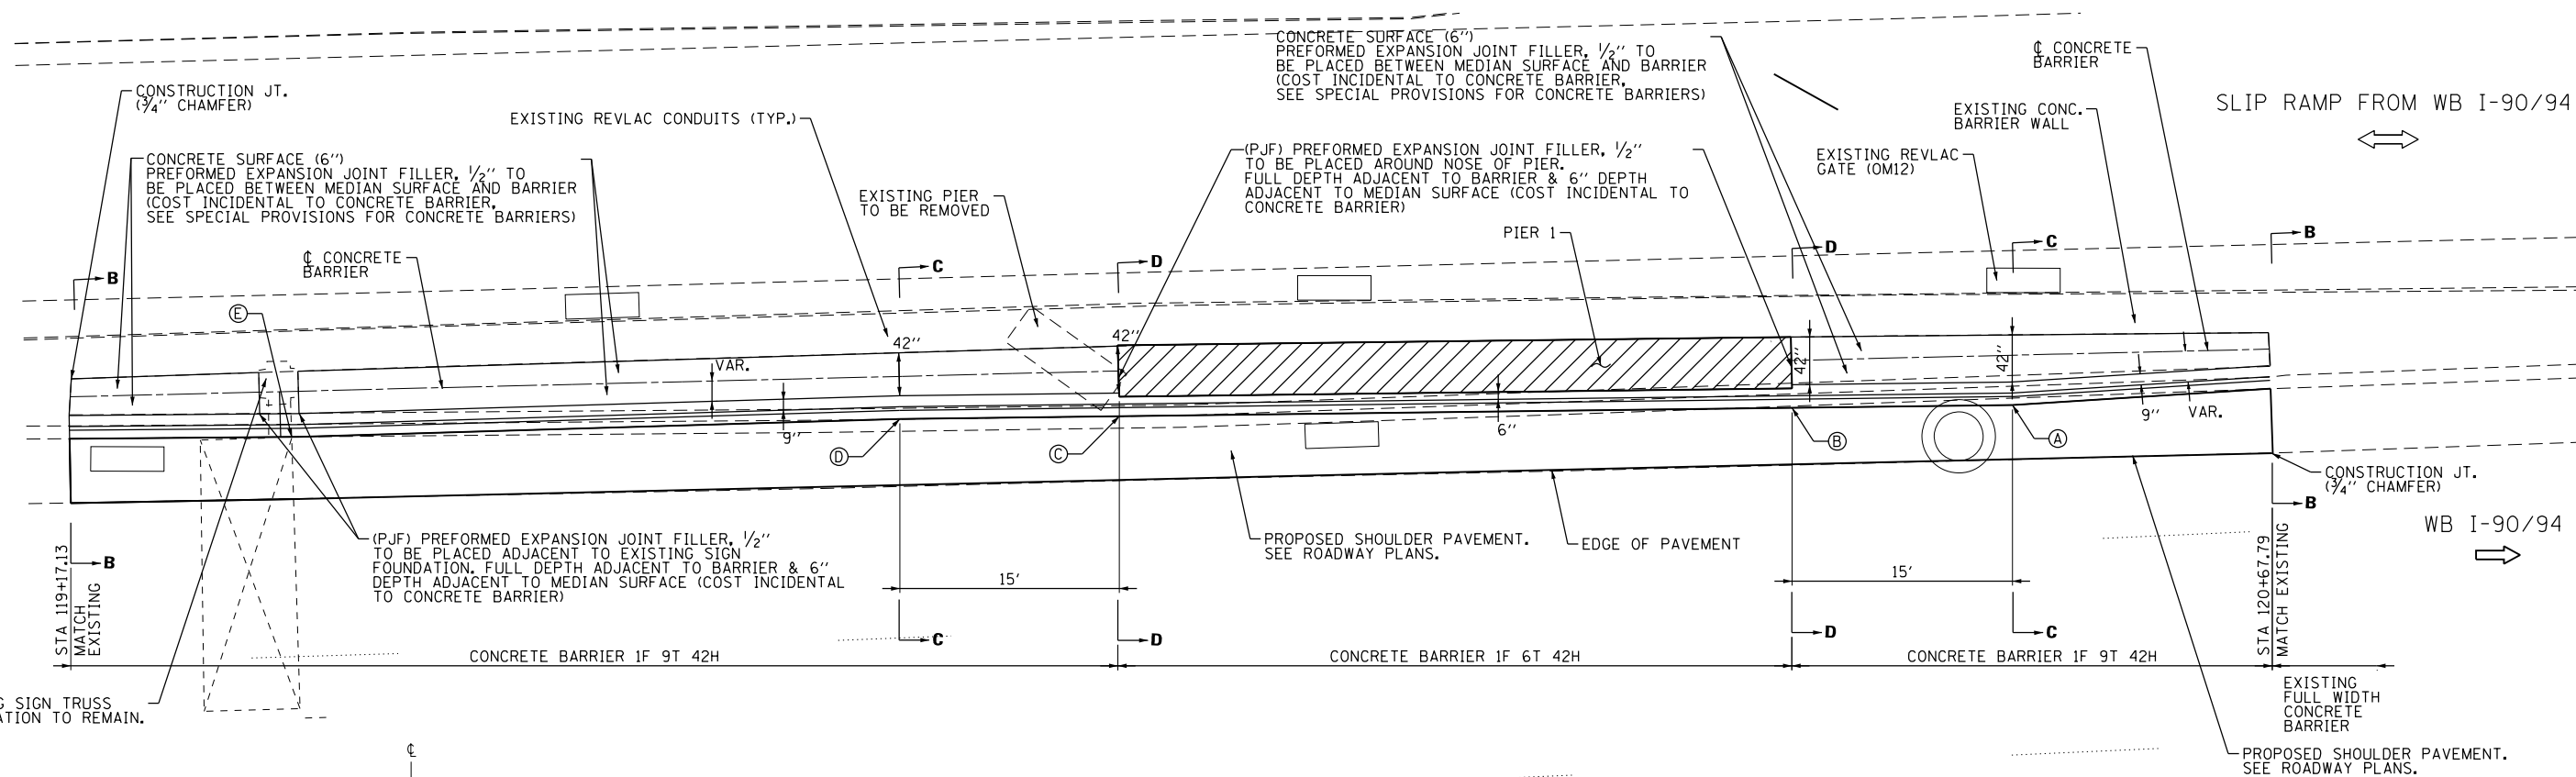

**SECT D-D
CONCRETE BARRIER**

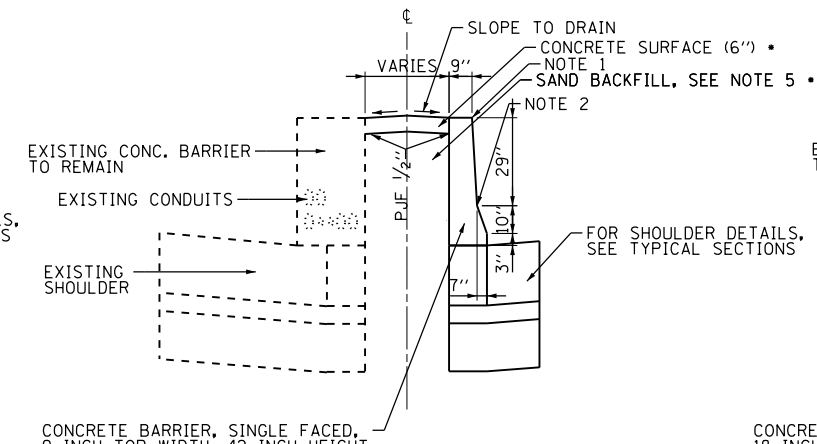

**SECT C-C
CONCRETE BARRIER**

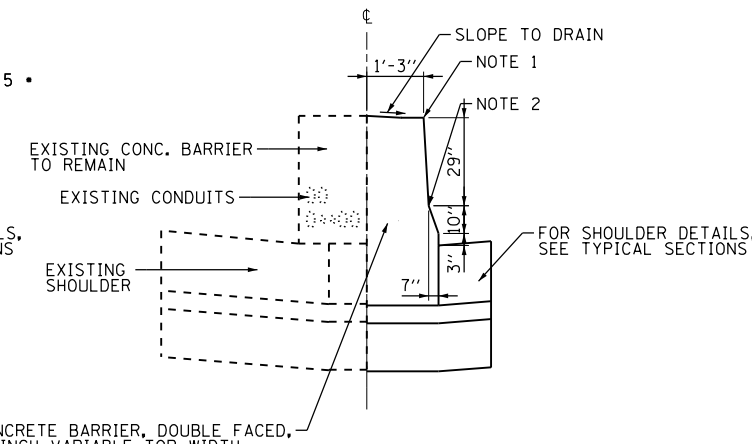


**SECT B-B
CONCRETE BARRIER**

| STATION | OFFSET |
|---------------|--------|
| (A) 120+50.17 | 34.28 |
| (B) 120+35.15 | 34.77 |
| (C) 119+89.12 | 36.15 |
| (D) 119+74.07 | 36.53 |
| (E) 119+32.35 | 36.70 |

GENERAL NOTES - FOR UNDERDRAIN DETAILS SEE TYPICAL SECTIONS
 - PREFORMED JOINT FILLER SHALL BE INCIDENTAL TO THE CONCRETE BARRIER OF THE TYPE INVOLVED.

NOTE 1 - 3/4" CHAMFER OR 1" RADIUS (OPTIONAL)
NOTE 2 - 10" RADIUS (OPTIONAL)
NOTE 3 - EXTEND BOTTOM OF BARRIER TO FOOTING ONLY WHEN DEPTH IS 6" OR LESS, OTHERWISE MAINTAIN SAME DEPTH AS BOTTOM OF SHOULDER
NOTE 4 - PIER FILLER MATERIAL TO BE CONCRETE IF MINIMUM 6" THICKNESS WILL BE MAINTAINED. IF 6" THICKNESS CANNOT BE MAINTAINED USE ASPHALT FILLER MATERIAL AS DIRECTED BY THE ENGINEER.

NOTE 5 - SAND BACKFILL AND CONCRETE SURFACE WILL BE REQUIRED. FILLING WITH CONCRETE WILL NOT BE ALLOWED.
NOTE 6 - IF PIER IS NEW CONSTRUCTION BARRIER WALL MAY BE MONOLITHIC
 ** MAINTAIN SLOPE OF FACE AS SHOWN ON DETAIL. HEIGHT AND WIDTH OF BARRIER INCREASE WHERE A DIFFERENCE IN MEDIAN EDGE-OF-PAVEMENT GRADE ELEVATION EXISTS.
 * COST OF SAND BACKFILL AND PIER FILLER MATERIAL TO BE INCLUDED IN THE COST OF CONCRETE MEDIAN SURFACE, 6".

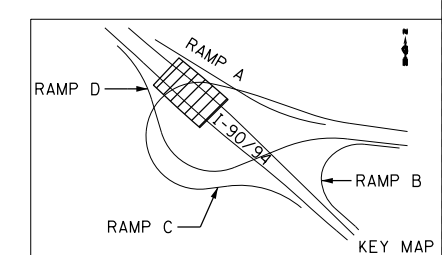

FILE NAME = I:\7000 - 194 at Ohio Street\CADD\CADD_SHEET\SD1606\63-Detail Barrier.kib.dgn

COLLINS ENGINEERS



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| PLOT SCALE = 12.0000000' / in. | DRAWN - | REVISED - |
| PLOT DATE = 3/25/2013 | CHECKED - | REVISED - |
| | DATE - | REVISED - |

**STATE OF ILLINOIS
DEPARTMENT OF TRANSPORTATION**


| | | | |
|---|-----------|-----------|--------------|
| WB I-90 /94 (KENNEDY EXPRESSWAY) CONCRETE BARRIER TRANSITIONS PIER 1 | | | |
| SCALE: | SHEET NO. | OF SHEETS | STA. TO STA. |

| | | | | |
|---|--------------|--------|--------------|-----------|
| F.A.I. RTE. | SECTION | COUNTY | TOTAL SHEETS | SHEET NO. |
| 90/94 | 0303-474HB-R | COOK | 368 | 49 |
| CONTRACT NO. 60F63 | | | | |
| FED. ROAD DIST. NO. 1 ILLINOIS FED. AID PROJECT | | | | |


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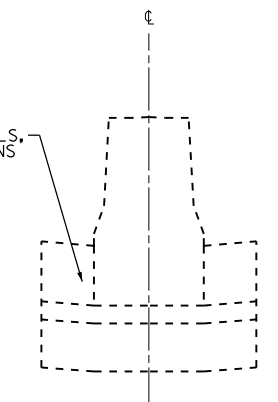
**SECT D-D
CONCRETE BARRIER**

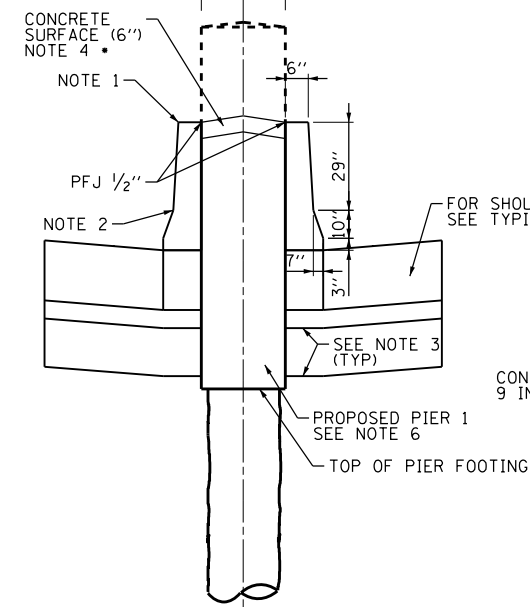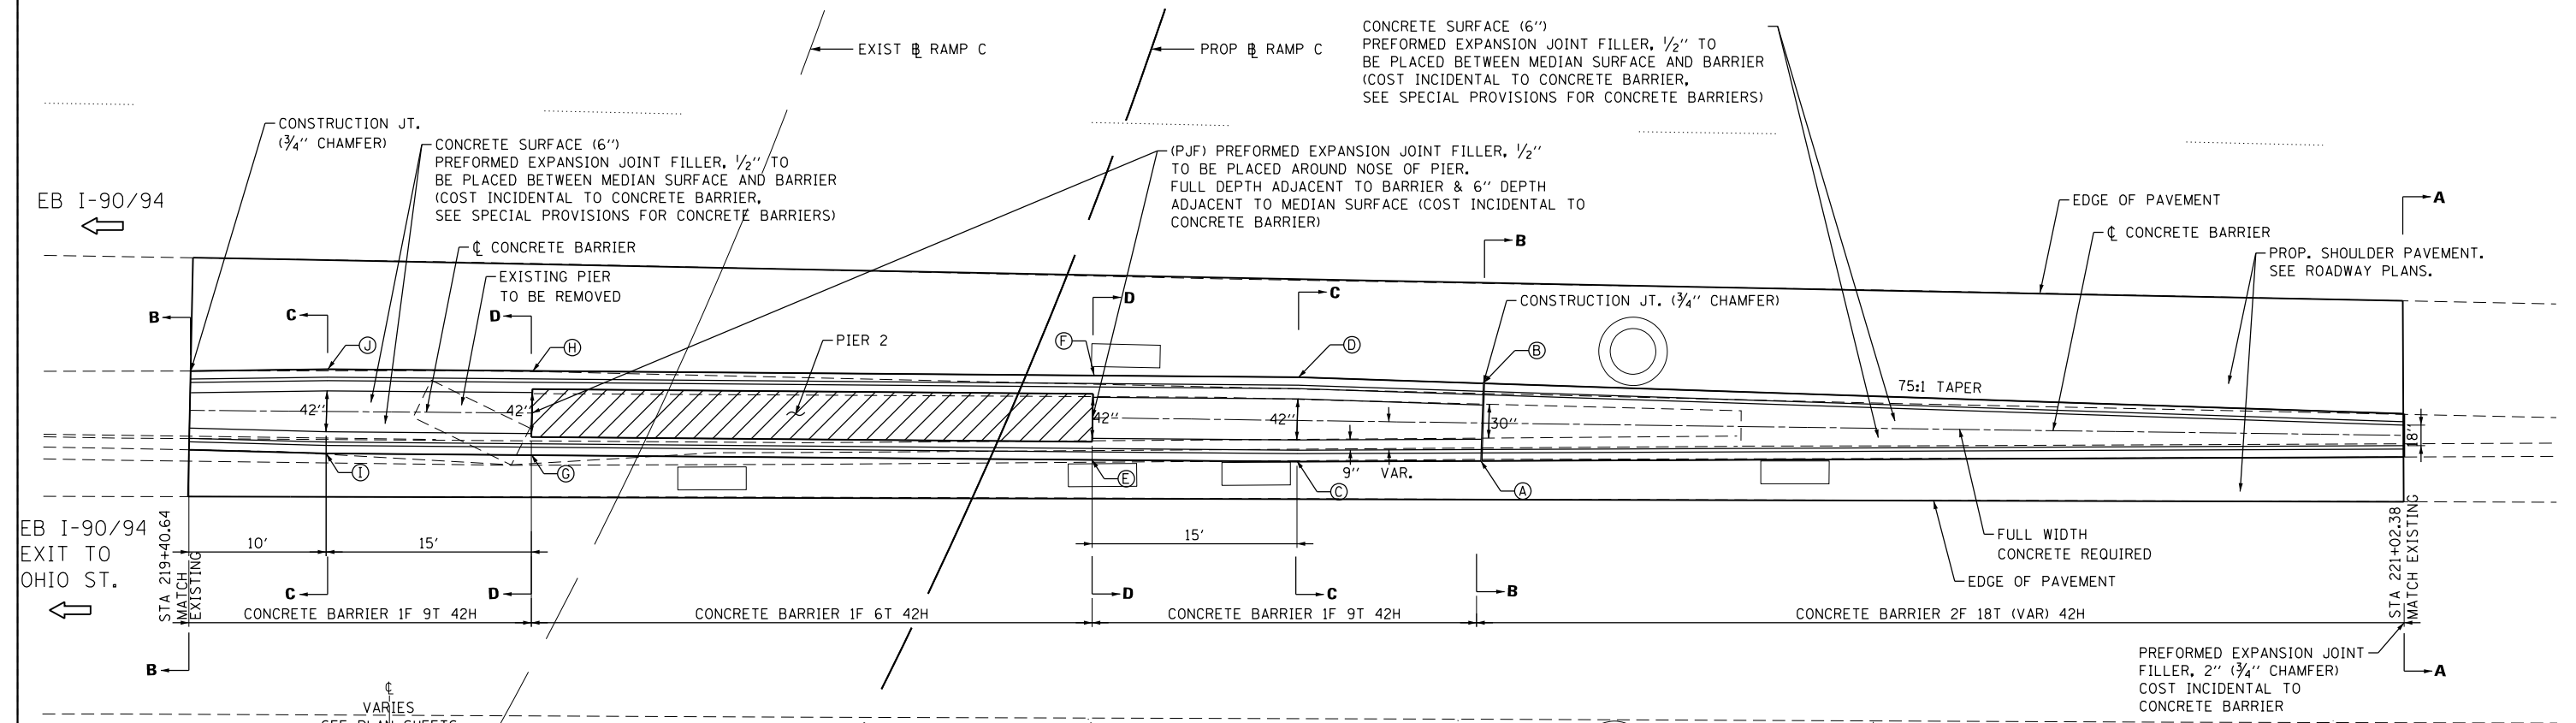

**SECT C-C
CONCRETE BARRIER**

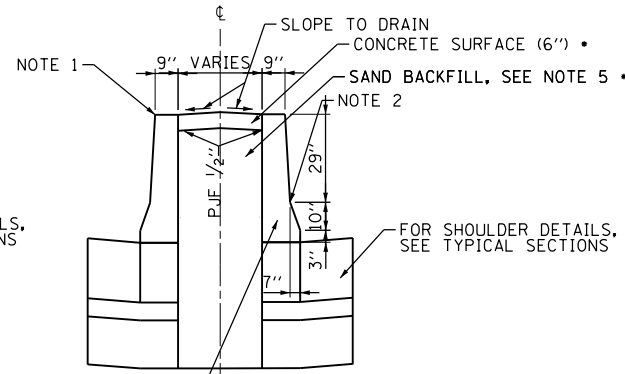

**SECT B-B
CONCRETE BARRIER**

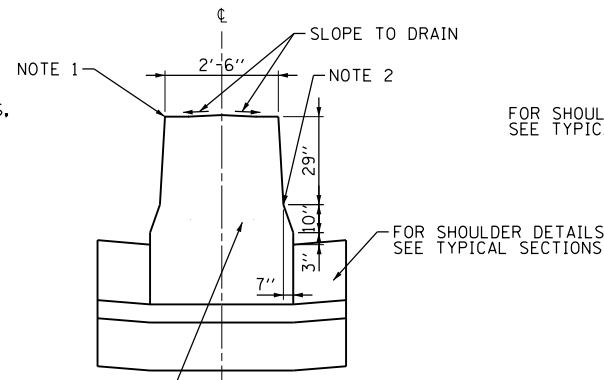


**SECT A-A
CONCRETE BARRIER**

GENERAL NOTES - FOR UNDERDRAIN DETAILS SEE TYPICAL SECTIONS
 - PREFORMED JOINT FILLER SHALL BE INCIDENTAL TO THE CONCRETE BARRIER OF THE TYPE INVOLVED.

NOTE 1 - 3/4" CHAMFER OR 1" RADIUS (OPTIONAL)
NOTE 2 - 10" RADIUS (OPTIONAL)
NOTE 3 - EXTEND BOTTOM OF BARRIER TO FOOTING ONLY WHEN DEPTH IS 6" OR LESS, OTHERWISE MAINTAIN SAME DEPTH AS BOTTOM OF SHOULDER
NOTE 4 - PIER FILLER MATERIAL TO BE CONCRETE IF MINIMUM 6" THICKNESS WILL BE MAINTAINED. IF 6" THICKNESS CANNOT BE MAINTAINED USE ASPHALT FILLER MATERIAL AS DIRECTED BY THE ENGINEER.

NOTE 5 - SAND BACKFILL AND CONCRETE SURFACE WILL BE REQUIRED. FILLING WITH CONCRETE WILL NOT BE ALLOWED.
NOTE 6 - IF PIER IS NEW CONSTRUCTION BARRIER WALL MAY BE MONOLITHIC
 ** MAINTAIN SLOPE OF FACE AS SHOWN ON DETAIL. HEIGHT AND WIDTH OF BARRIER INCREASE WHERE A DIFFERENCE IN MEDIAN EDGE-OF-PAVEMENT GRADE ELEVATION EXISTS.
 * COST OF SAND BACKFILL AND PIER FILLER MATERIAL TO BE INCLUDED IN THE COST OF CONCRETE MEDIAN SURFACE, 6".

| | STATION | OFFSET |
|-----|-----------|--------|
| (A) | 220+35.04 | 46.58 |
| (B) | 220+35.12 | 40.91 |
| (C) | 220+21.61 | 46.89 |
| (D) | 220+21.61 | 40.72 |
| (E) | 220+06.64 | 47.05 |
| (F) | 220+06.68 | 40.88 |
| (G) | 219+65.67 | 47.49 |
| (H) | 219+65.63 | 41.32 |
| (I) | 219+50.67 | 47.65 |
| (J) | 219+50.66 | 41.49 |

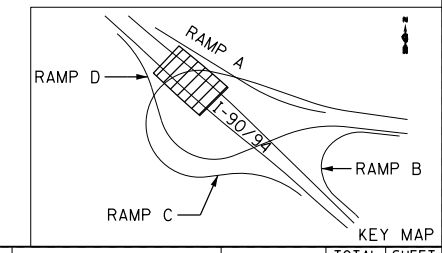

COLLINS ENGINEERS


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| PLOT SCALE = 12,000,000 / 1" | DRAWN - | REVISED - |
| PLOT DATE = 3/25/2013 | CHECKED - | REVISED - |
| | DATE - | REVISED - |

**STATE OF ILLINOIS
DEPARTMENT OF TRANSPORTATION**




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|---|-----------|-----------|--------------|
| EB I-90 /94 (KENNEDY EXPRESSWAY) CONCRETE BARRIER TRANSITIONS PIER 2 | | | |
| SCALE: | SHEET NO. | OF SHEETS | STA. TO STA. |

| | | | | |
|---|--------------|--------|--------------|-----------|
| F.A.I. RTE. | SECTION | COUNTY | TOTAL SHEETS | SHEET NO. |
| 90/94 | 0303-474HB-R | COOK | 368 | 50 |
| CONTRACT NO. 60F63 | | | | |
| FED. ROAD DIST. NO. 1 ILLINOIS FED. AID PROJECT | | | | |

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NOTES:
1. FOR PROPOSED DRAINAGE DETAILS SEE DRAINAGE PLAN

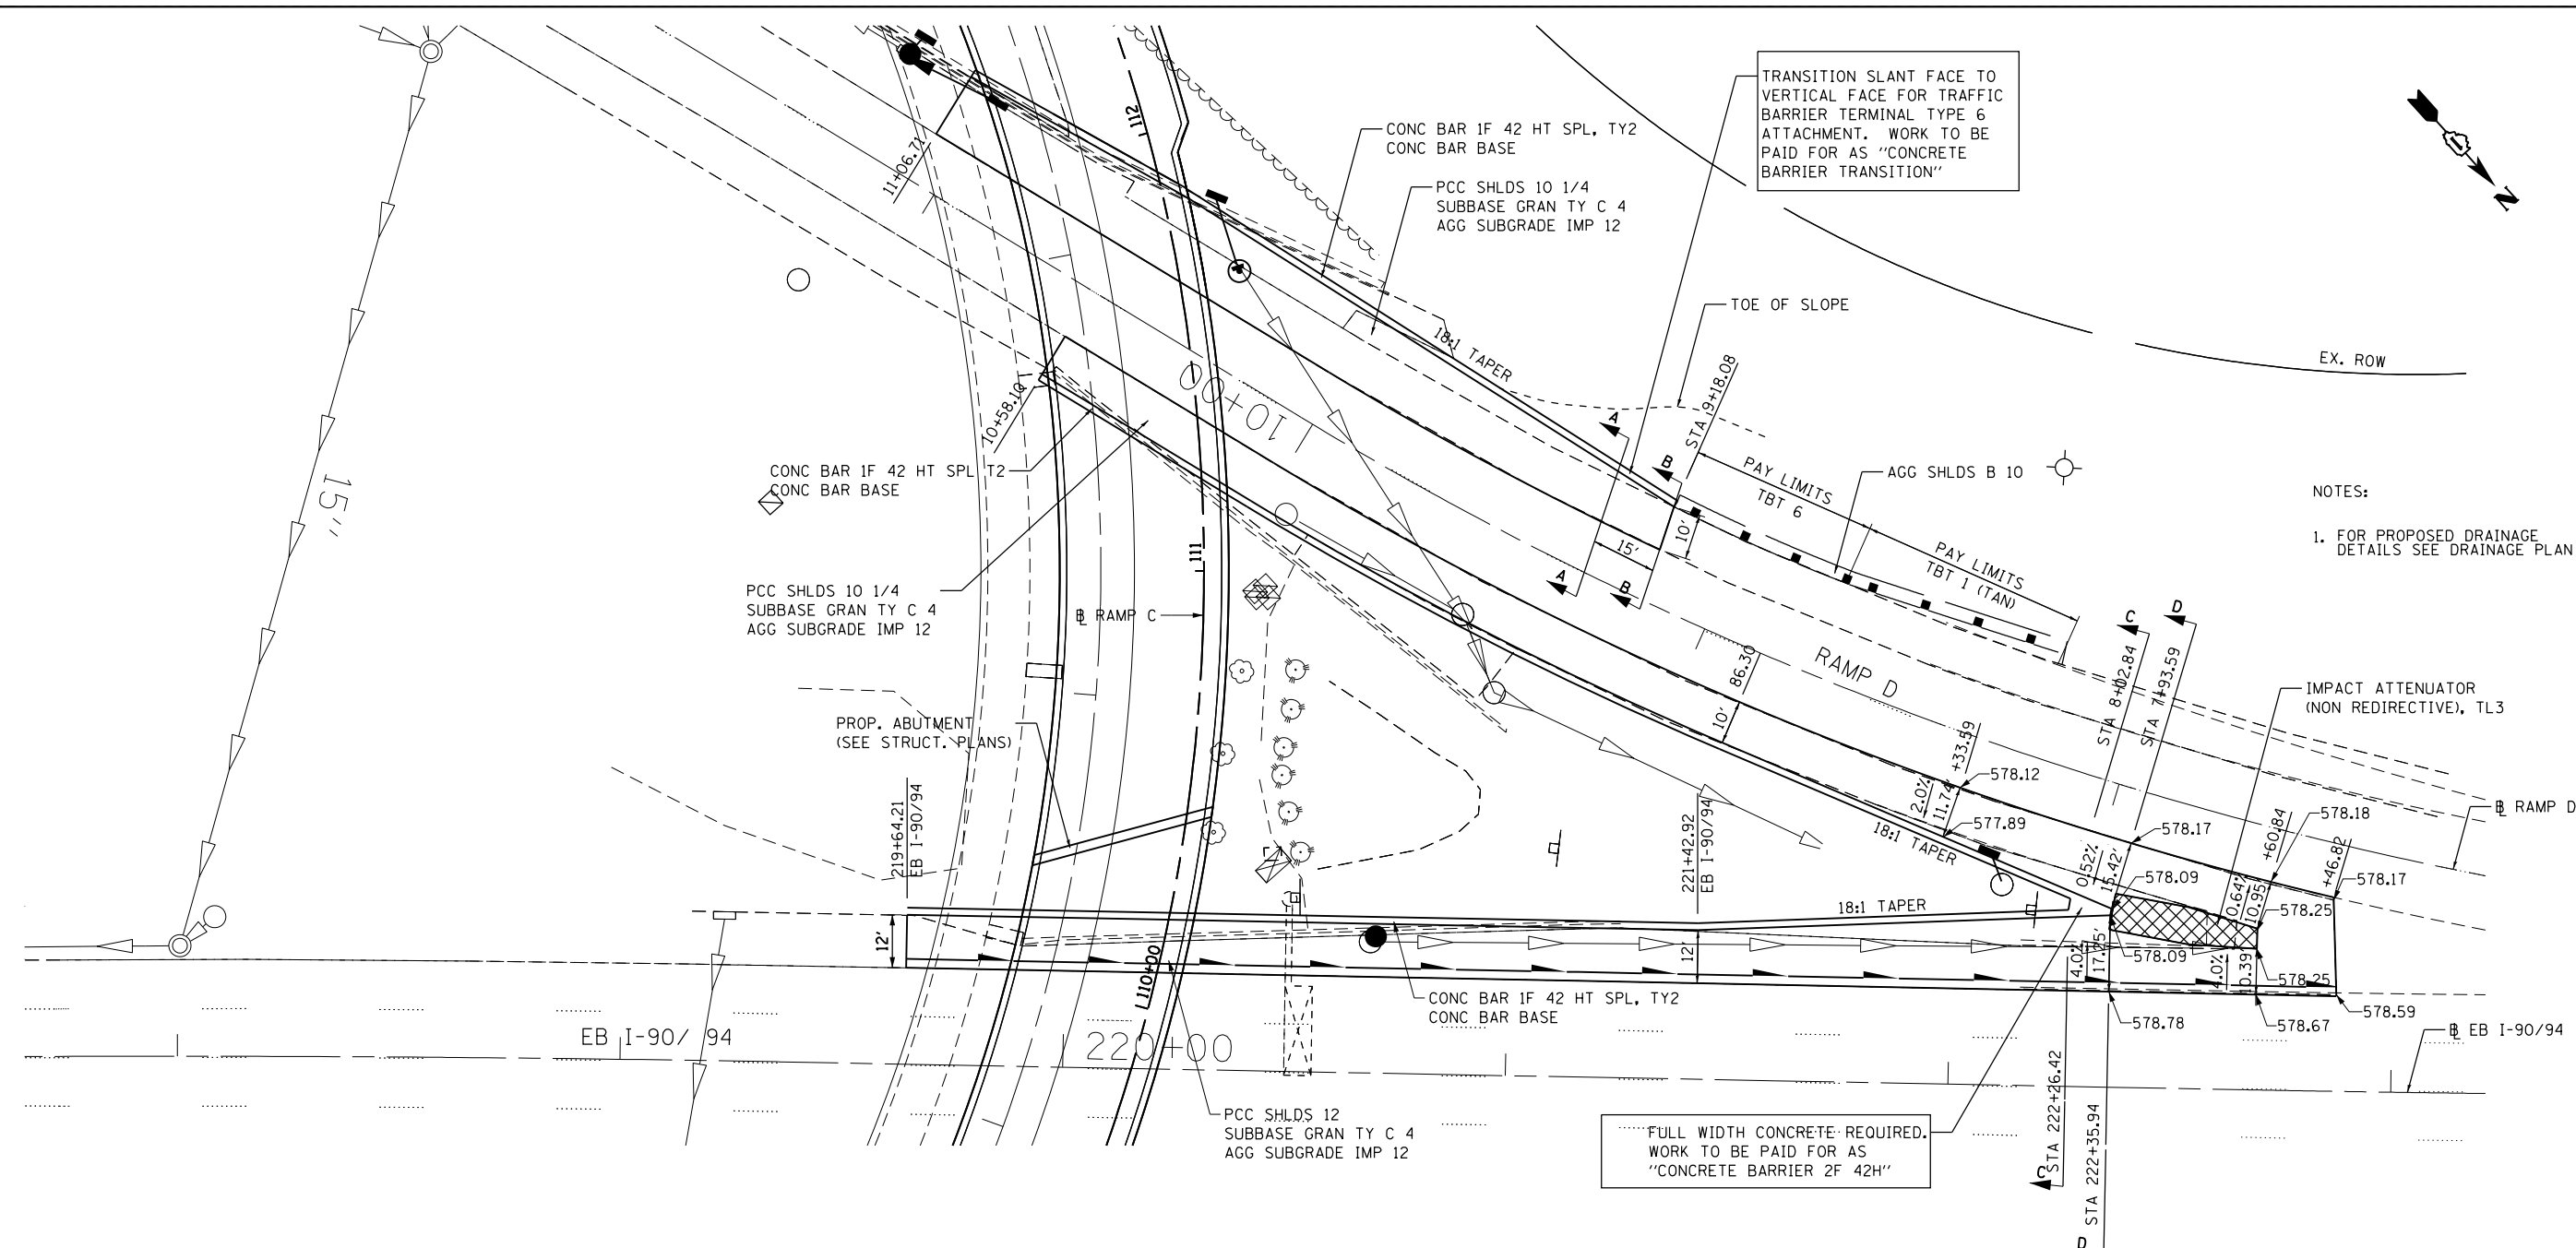

NOTES:
1. 3/4" CHAMFER OR 1" RADIUS (OPTIONAL)
2. 10" RADIUS (OPTIONAL)

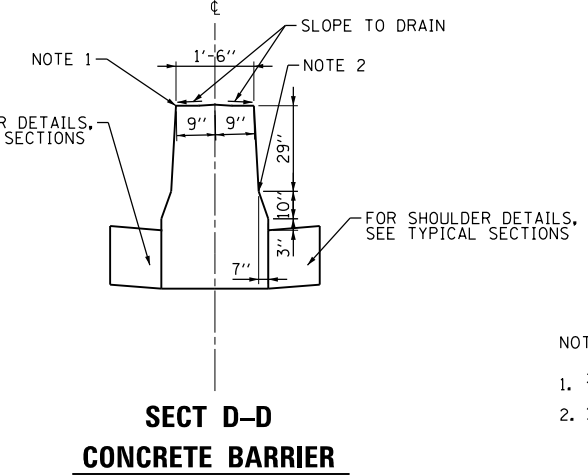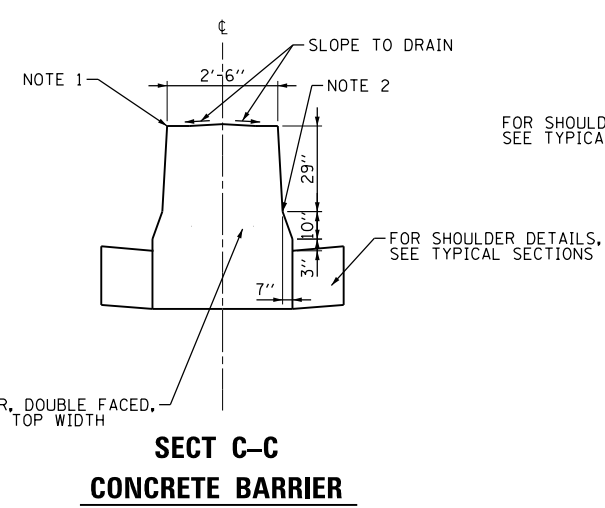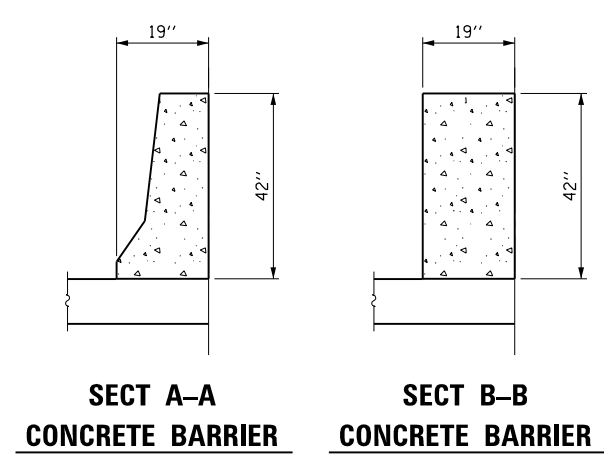COLLINS ENGINEERS

USER NAME = r9e11
PLOT SCALE = 40.000000' / 1"
PLOT DATE = 3/25/2013

DESIGNED -
DRAWN -
CHECKED -
DATE -

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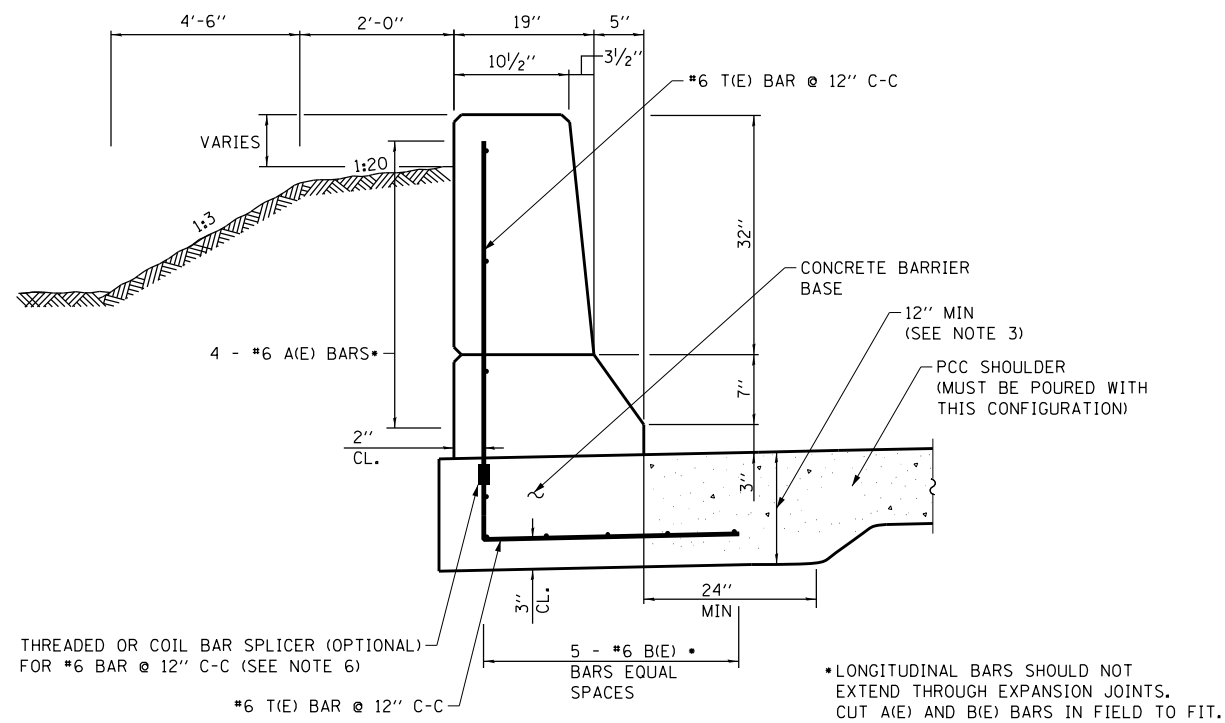
STATE OF ILLINOIS
DEPARTMENT OF TRANSPORTATION

ROADWAY DETAILS
RAMP D GORE

SCALE: SHEET NO. OF SHEETS STA. TO STA.

| | | | | |
|--------------------|--------------|--------|--------------|-----------|
| F.A.I. RTE. | SECTION | COUNTY | TOTAL SHEETS | SHEET NO. |
| 90/94 | 0303-474HB-R | COOK | 368 | 51 |
| CONTRACT NO. 60F63 | | | | |


FED. ROAD DIST. NO. 1 ILLINOIS FED. AID PROJECT



CONCRETE BARRIER, SINGLE FACE, 42" HEIGHT (SPECIAL), TYPE 1

N.T.S.


STA 117+27.40 TO STA 119+32.83 (WB I-90/94, RT SIDE)
 STA 113+47.04 TO STA 115+75.00 (RAMP C, RT SIDE)
 STA 123+60.00 TO STA 124+00.00 (RAMP C, LT SIDE)
 STA 9+18.08 TO STA 11+06.71 (RAMP D, RT SIDE)

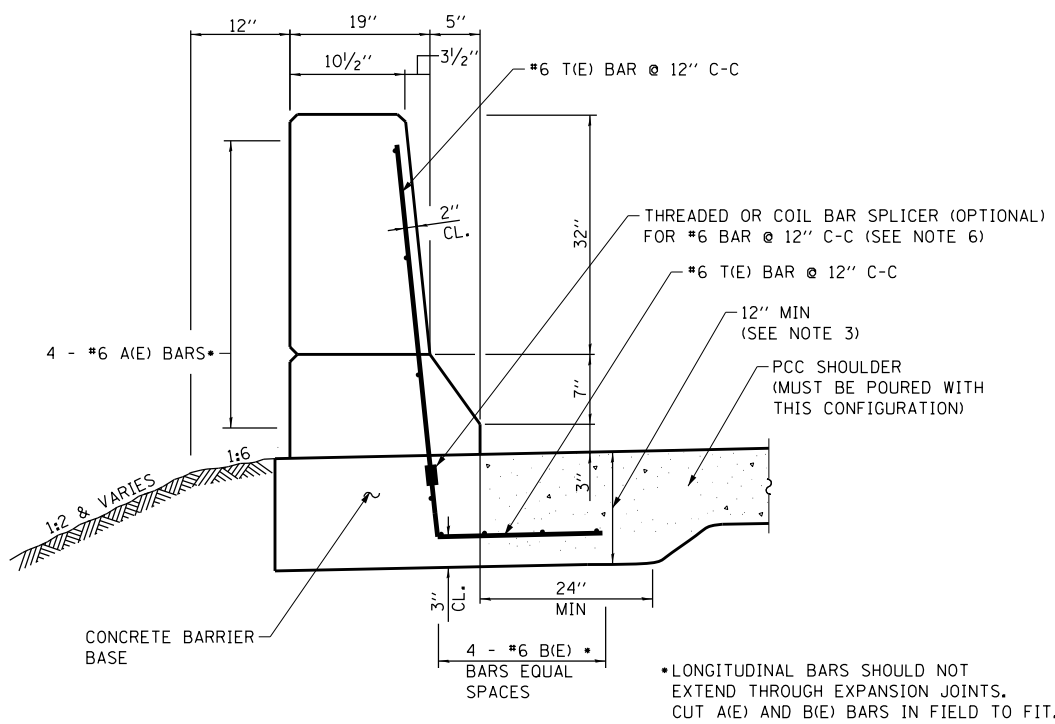

CONCRETE BARRIER, SINGLE FACE, 42" HEIGHT (SPECIAL), TYPE 1


N.T.S.

STA 119+32.83 TO STA 120+24.70 (WB I-90/94, RT SIDE)
 STA 103+00.00 TO STA 107+21.79 (RAMP C, RT SIDE)
 STA 103+94.65 TO STA 106+70.26 (RAMP C, LT SIDE)
 STA 113+14.95 TO STA 113+47.04 (RAMP C, LT SIDE)

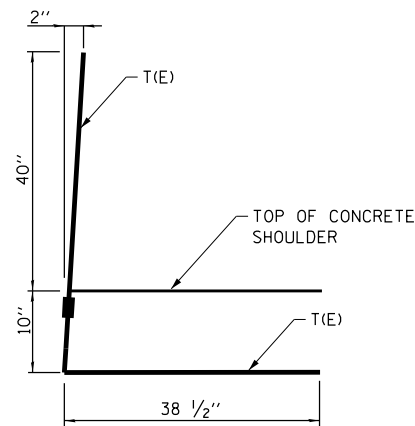

T(E) BAR DETAIL FILL SECTION


N.T.S.

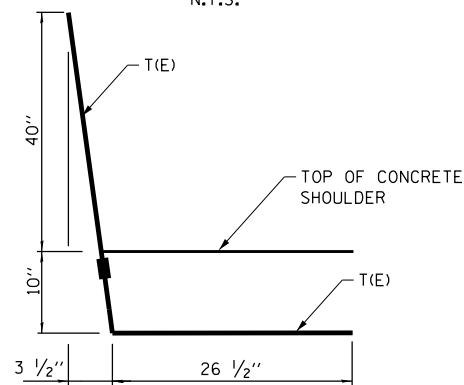

T(E) BAR DETAIL CUT SECTION

N.T.S.

LEGEND:

 PCC SHOULDER

NOTES:

- FOR ADDITIONAL SHOULDER DETAILS, SEE TYPICAL SECTIONS AND STANDARDS 482006, 483001, & 601001 AS APPLICABLE.
- A 1" RADIUS CAN BE SUBSTITUTED FOR THE 1/2" CHAMFER AT THE TOP OF THE BARRIER WALL.
- THE THICKENED PCC SHOULDER FOR THE REINFORCED CONCRETE BARRIER SECTION SHALL BE INCLUDED IN THE COST OF THE CONCRETE BARRIER OF THE TYPE AND HEIGHT SPECIFIED.
- ALL REINFORCING BARS, BAR SPLICERS TIE BARS AND DOWEL BARS SHALL BE EPOXY COATED AND SHALL BE SEATED IN THE FINAL POSITION PRIOR TO THE CONCRETE OPERATIONS. BARS SHALL NOT BE MUCKED INTO PLACE.
- THE BAR SPLICER SHALL BE CAPABLE OF DEVELOPING A MINIMUM OF 125% OF THE YIELD STRENGTH OF A #6 BAR.
- THE FURNISHING AND PLACING OF OPTIONAL BAR SPLICERS SHALL BE INCLUDED IN THE CONTRACT UNIT PRICE FOR CONCRETE BARRIER OF THE TYPE AND HEIGHT SPECIFIED.
- TRANSVERSE CONTRACTION AND EXPANSION JOINTS SHALL BE CONSTRUCTED IN LINE WITH THE CONTRACTION AND EXPANSION JOINTS IN THE ADJACENT SHOULDER.
- THE MINIMUM LAP FOR A(E) AND B(E) BARS SHALL BE 3'-6".
- THE COST OF FABRICATION AND INSTALLATION OF REINFORCEMENT BARS IS INCLUDED IN THE PAYMENT FOR CONCRETE BARRIER OF THE TYPE AND HEIGHT SPECIFIED.

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COLLINS ENGINEERS

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 PLOT SCALE = 40.000000' / 1"
 PLOT DATE = 3/25/2013

DESIGNED -
 DRAWN -
 CHECKED -
 DATE -


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STATE OF ILLINOIS DEPARTMENT OF TRANSPORTATION

ROADWAY DETAILS CONCRETE BARRIER, SINGLE FACE


SCALE: SHEET NO. OF SHEETS STA. TO STA.

| | | | | |
|---|--------------|--------|--------------|-----------|
| F.A.I. RTE. | SECTION | COUNTY | TOTAL SHEETS | SHEET NO. |
| 90/94 | 0303-474HB-R | COOK | 368 | 52 |
| CONTRACT NO. 60F63 | | | | |
| FED. ROAD DIST. NO. 1 ILLINOIS FED. AID PROJECT | | | | |

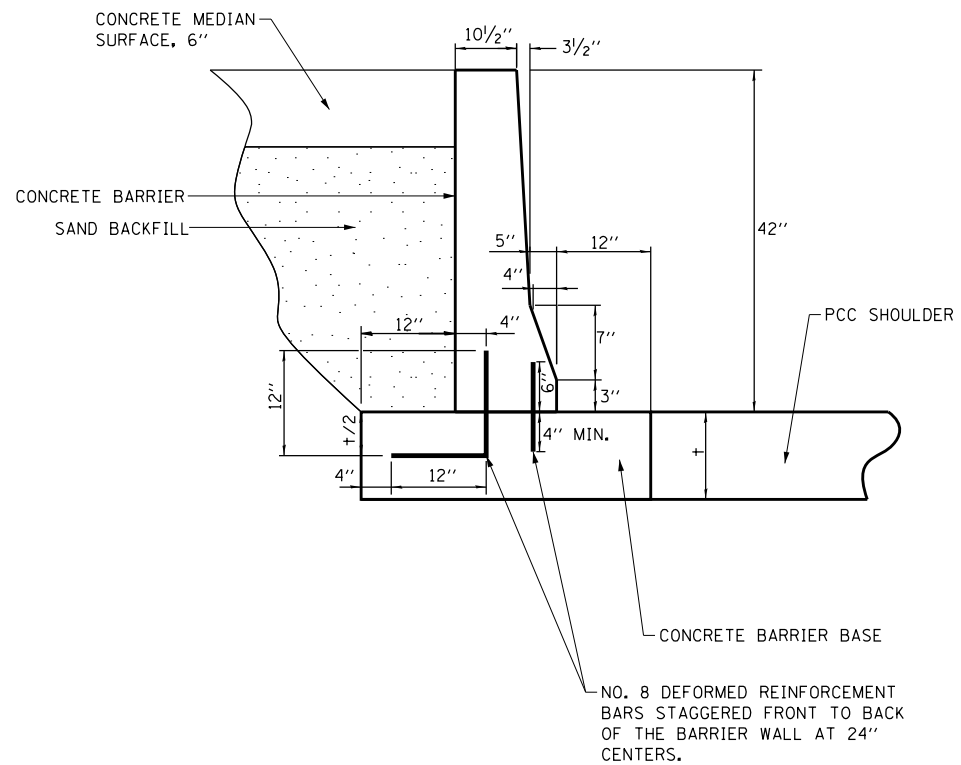

**CONCRETE BARRIER BASE DETAIL
ADJACENT TO CONCRETE MEDIAN SURFACE**

N.T.S.

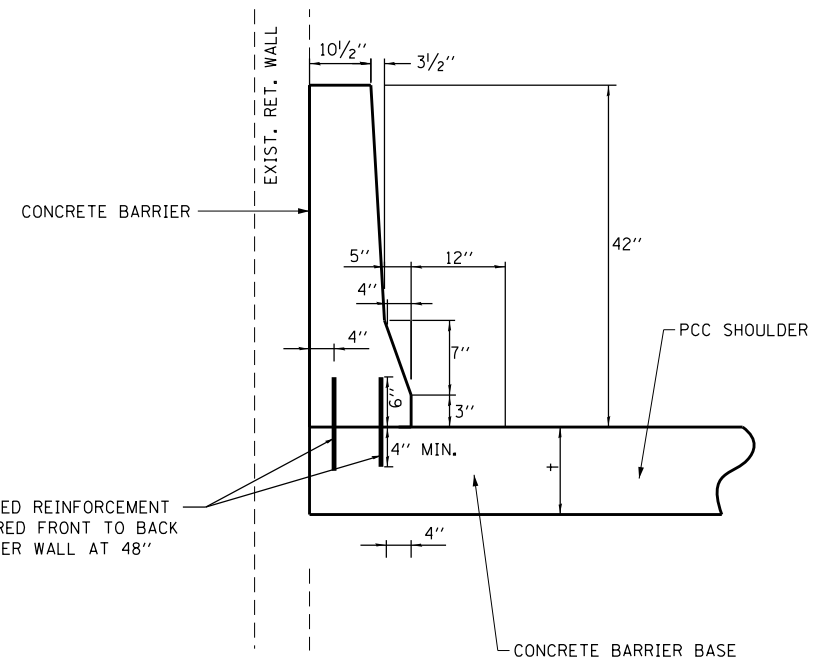


**CONCRETE BARRIER BASE DETAIL
ADJACENT TO RAMPS/PIERS**

N.T.S.

NOTES:

1. THE COST OF REINFORCEMENT BARS AND THEIR INSTALLATION SHALL BE CONSIDERED INCLUDED IN THE COST OF THE CONCRETE BARRIER.

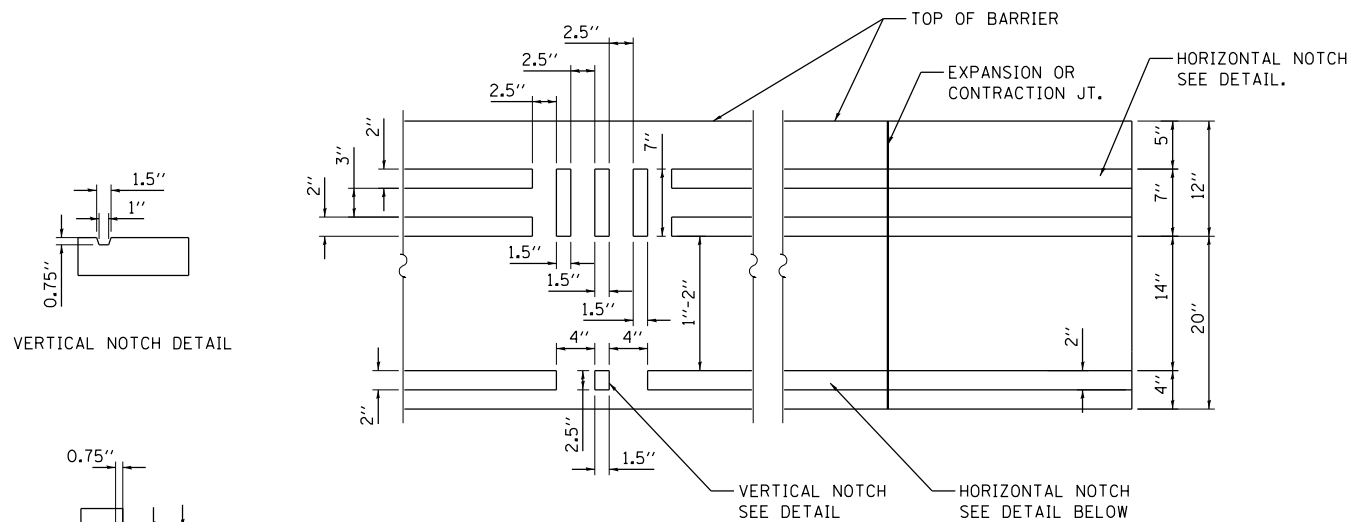

**CONCRETE BARRIER, SINGLE FACE, 42" HEIGHT (SPECIAL), TYPE 2.
NOTCH LAYOUT DETAILS**

N.T.S.

STA 219.64.21 TO STA 222+87.38 (EB I-90/94, RT SIDE)
STA 7+93.59 TO STA 10+58.10 (RAMP D, LT SIDE)

NOTES:

1. 20 FT BETWEEN CONTRACTION JOINTS AND 100 FT BETWEEN EXPANSION JOINTS.
2. NOTCHES CONTINUOUS THROUGH THE JOINT.
3. JOINTS INCIDENTAL TO THE COST OF THE WALL.

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**COLLINS
ENGINEERS**

USER NAME = rge11
PLOT SCALE = 40.000000' / 1"
PLOT DATE = 3/25/2013

DESIGNED -
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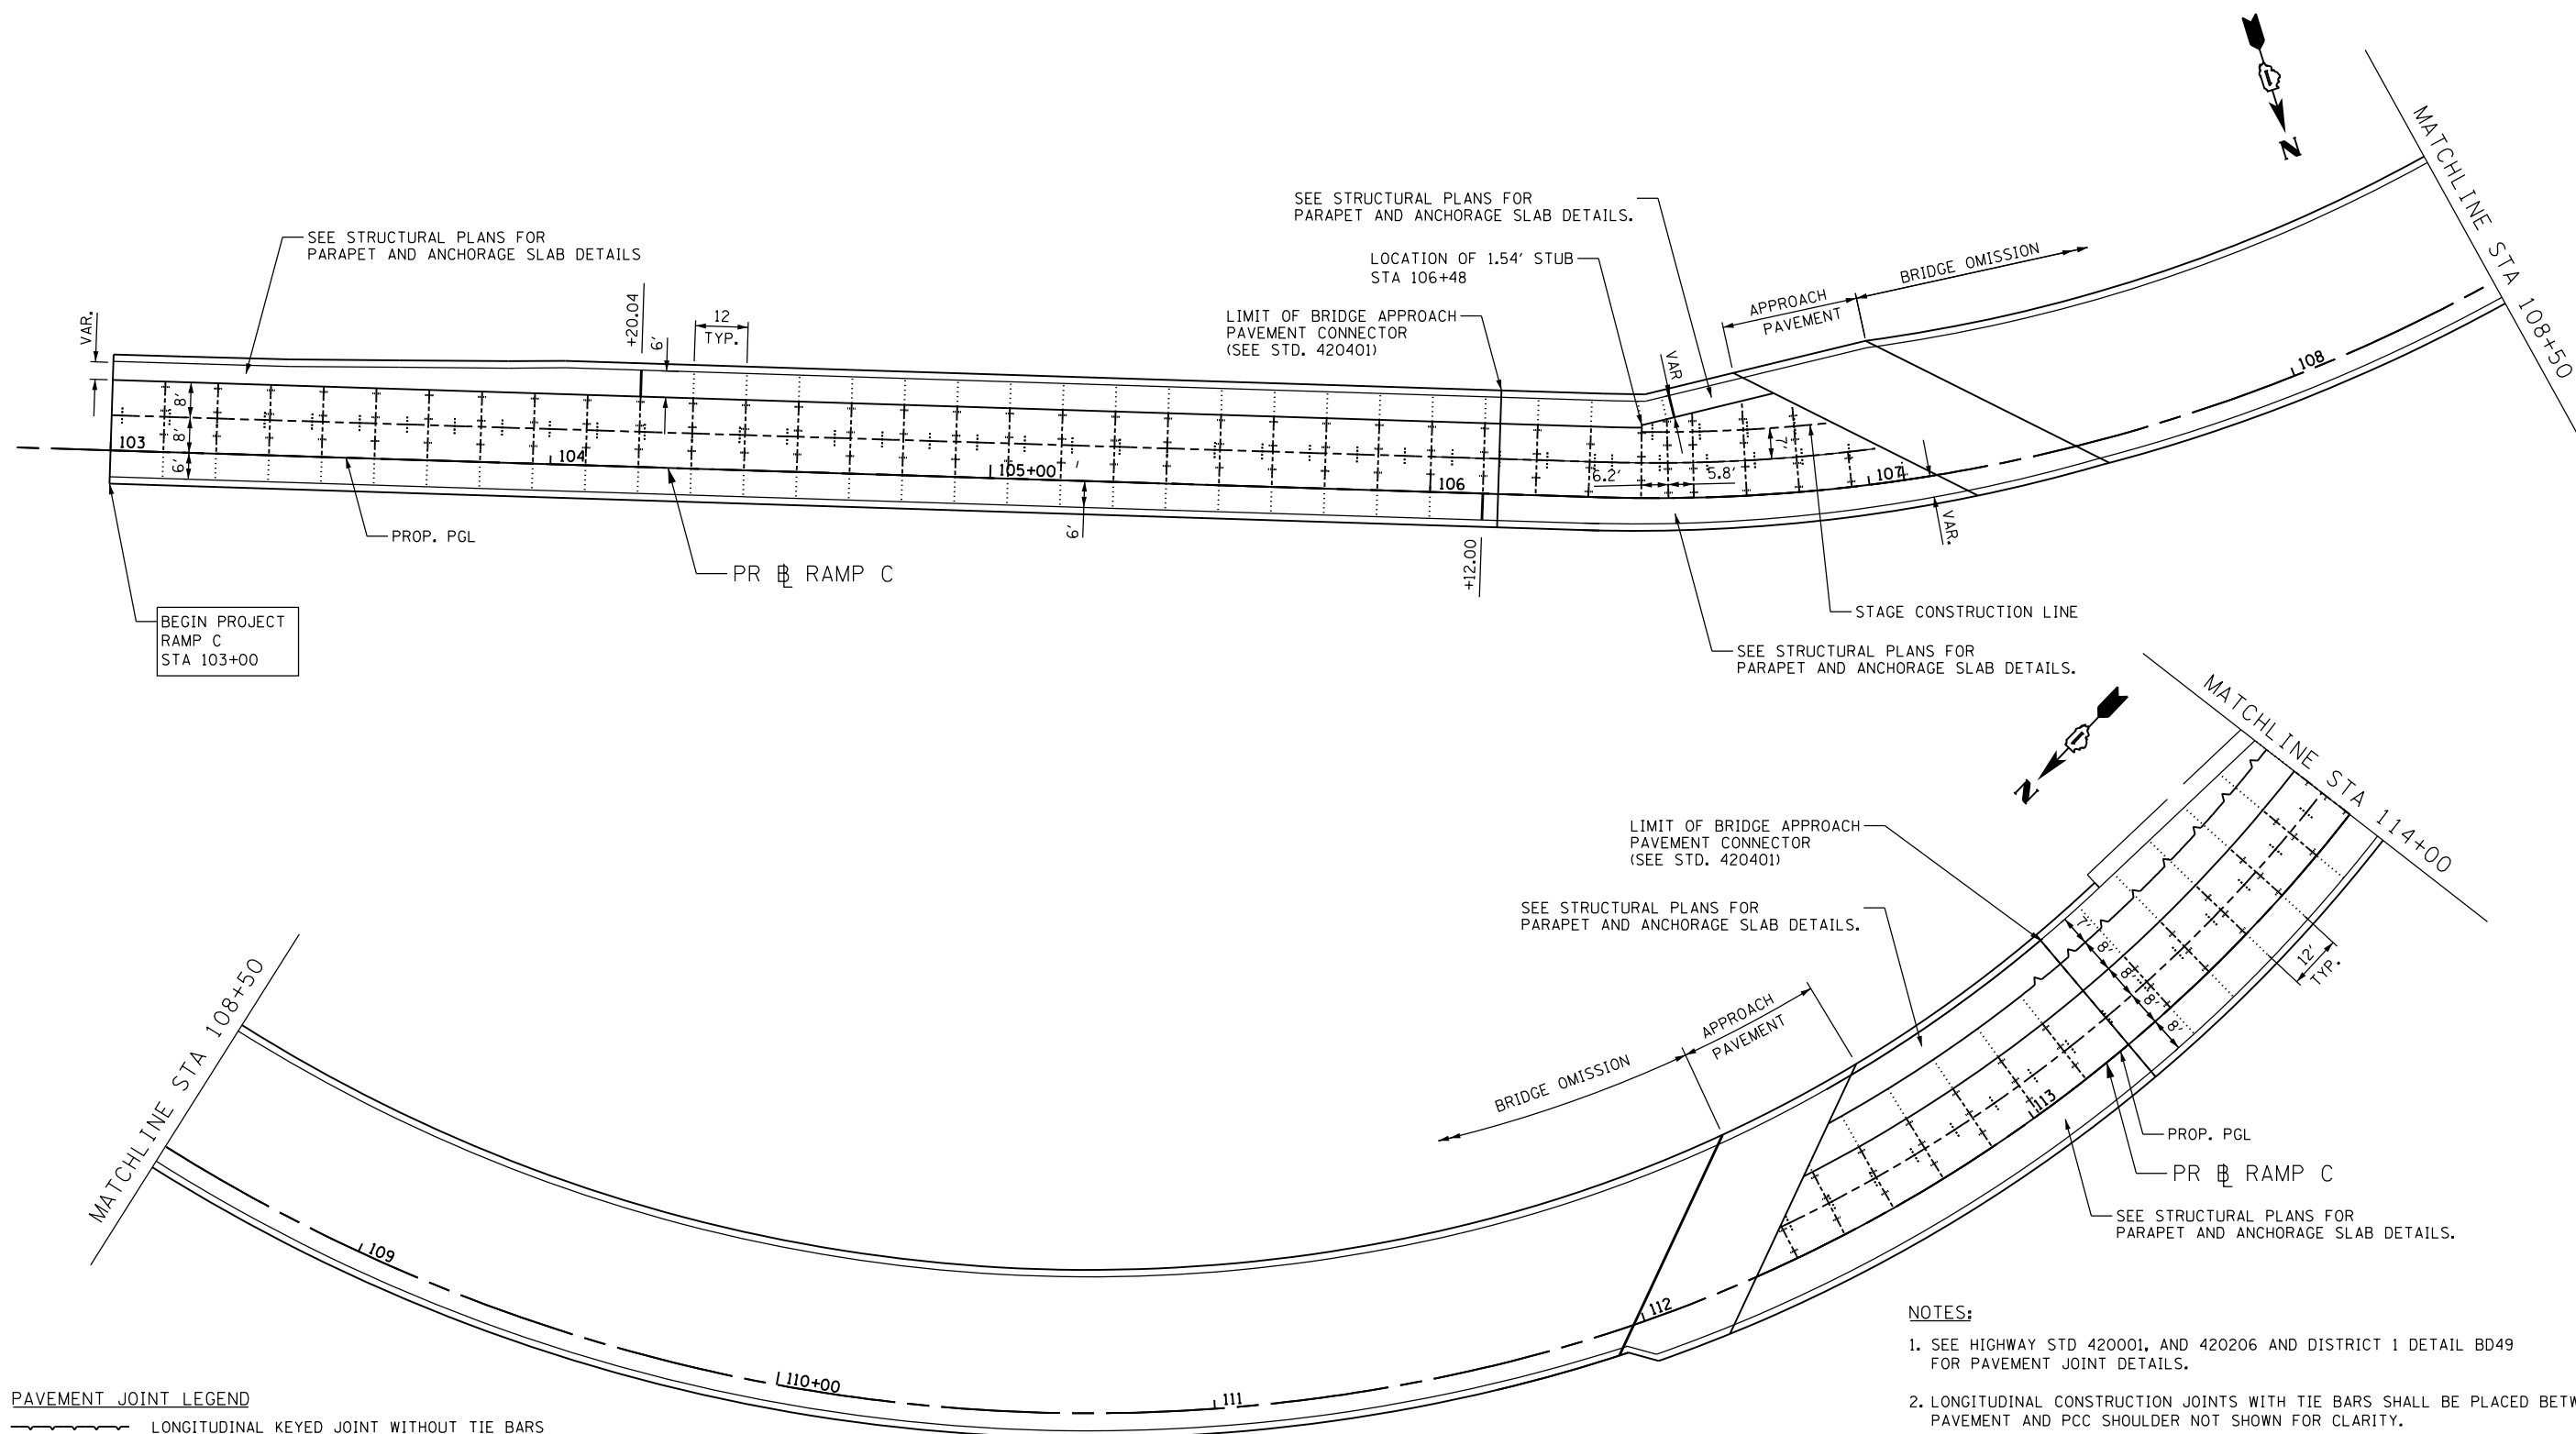
**STATE OF ILLINOIS
DEPARTMENT OF TRANSPORTATION**

**ROADWAY DETAILS
CONCRETE BARRIER, SINGLE FACE**

SCALE: SHEET NO. OF SHEETS STA. TO STA.

| | | | | |
|---|--------------|--------|--------------|-----------|
| F.A.I. RTE. | SECTION | COUNTY | TOTAL SHEETS | SHEET NO. |
| 90/94 | 0303-474HB-R | COOK | 368 | 53 |
| CONTRACT NO. 60F63 | | | | |
| FED. ROAD DIST. NO. 1 ILLINOIS FED. AID PROJECT | | | | |

FILE NAME = I:\7000 - 194 at Ohio Street\CADD\CADD_SHEETS\DI60F63-sh1-INT.dwg



PAVEMENT JOINT LEGEND

| | |
|--|--|
| | LONGITUDINAL KEYED JOINT WITHOUT TIE BARS |
| | LONGITUDINAL CONSTRUCTION JOINT WITH TIE BARS |
| | SAWED TRANSVERSE CONTRACTION JOINT |
| | SAWED LONGITUDINAL JOINT |
| | SAWED TRANSVERSE CONTRACTION JOINT WITHIN PCC SHLD |
| | TRANSVERSE EXPANSION JOINT |

- NOTES:**
- SEE HIGHWAY STD 420001, AND 420206 AND DISTRICT 1 DETAIL BD49 FOR PAVEMENT JOINT DETAILS.
 - LONGITUDINAL CONSTRUCTION JOINTS WITH TIE BARS SHALL BE PLACED BETWEEN PCC PAVEMENT AND PCC SHOULDER NOT SHOWN FOR CLARITY.
 - MAINLINE AND RAMP CRCP PAVEMENT AND REINFORCEMENT AND JOINTS ARE NOT SHOWN FOR CLARITY. SEE STANDARD 420206 FOR DETAILS.
 - GORE NOSE LOCATIONS SHALL BE ALIGNED WITH MAINLINE SHOULDER TRANSVERSE JOINTS.
 - ADDITIONAL SAWED TRANSVERSE CONTRACTION JOINTS MAY BE REQUIRED IN THE FIELD. EXACT LOCATIONS TO BE VERIFIED AND APPROVED BY THE ENGINEER.
 - CONCRETE STUBS SHALL HAVE A 1 FOOT MINIMUM WIDTH.



| | | |
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| USER NAME = rge11 | DESIGNED - | REVISED - |
| PLOT SCALE = 40.0000' / in. | DRAWN - | REVISED - |
| PLOT DATE = 3/25/2013 | CHECKED - | REVISED - |
| | DATE - | REVISED - |



**STATE OF ILLINOIS
DEPARTMENT OF TRANSPORTATION**

**RAMP C
PAVEMENT JOINTING PLAN**

SCALE: SHEET NO. OF SHEETS STA. TO STA.

| | | | | |
|---|----------------------|-------------|------------------|--------------|
| F.A.I. RTE. 90/94 | SECTION 0303-474HB-R | COUNTY COOK | TOTAL SHEETS 368 | SHEET NO. 54 |
| CONTRACT NO. 60F63 | | | | |
| FED. ROAD DIST. NO. 1 ILLINOIS FED. AID PROJECT | | | | |

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PAVEMENT JOINT LEGEND

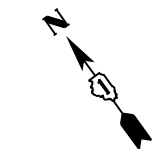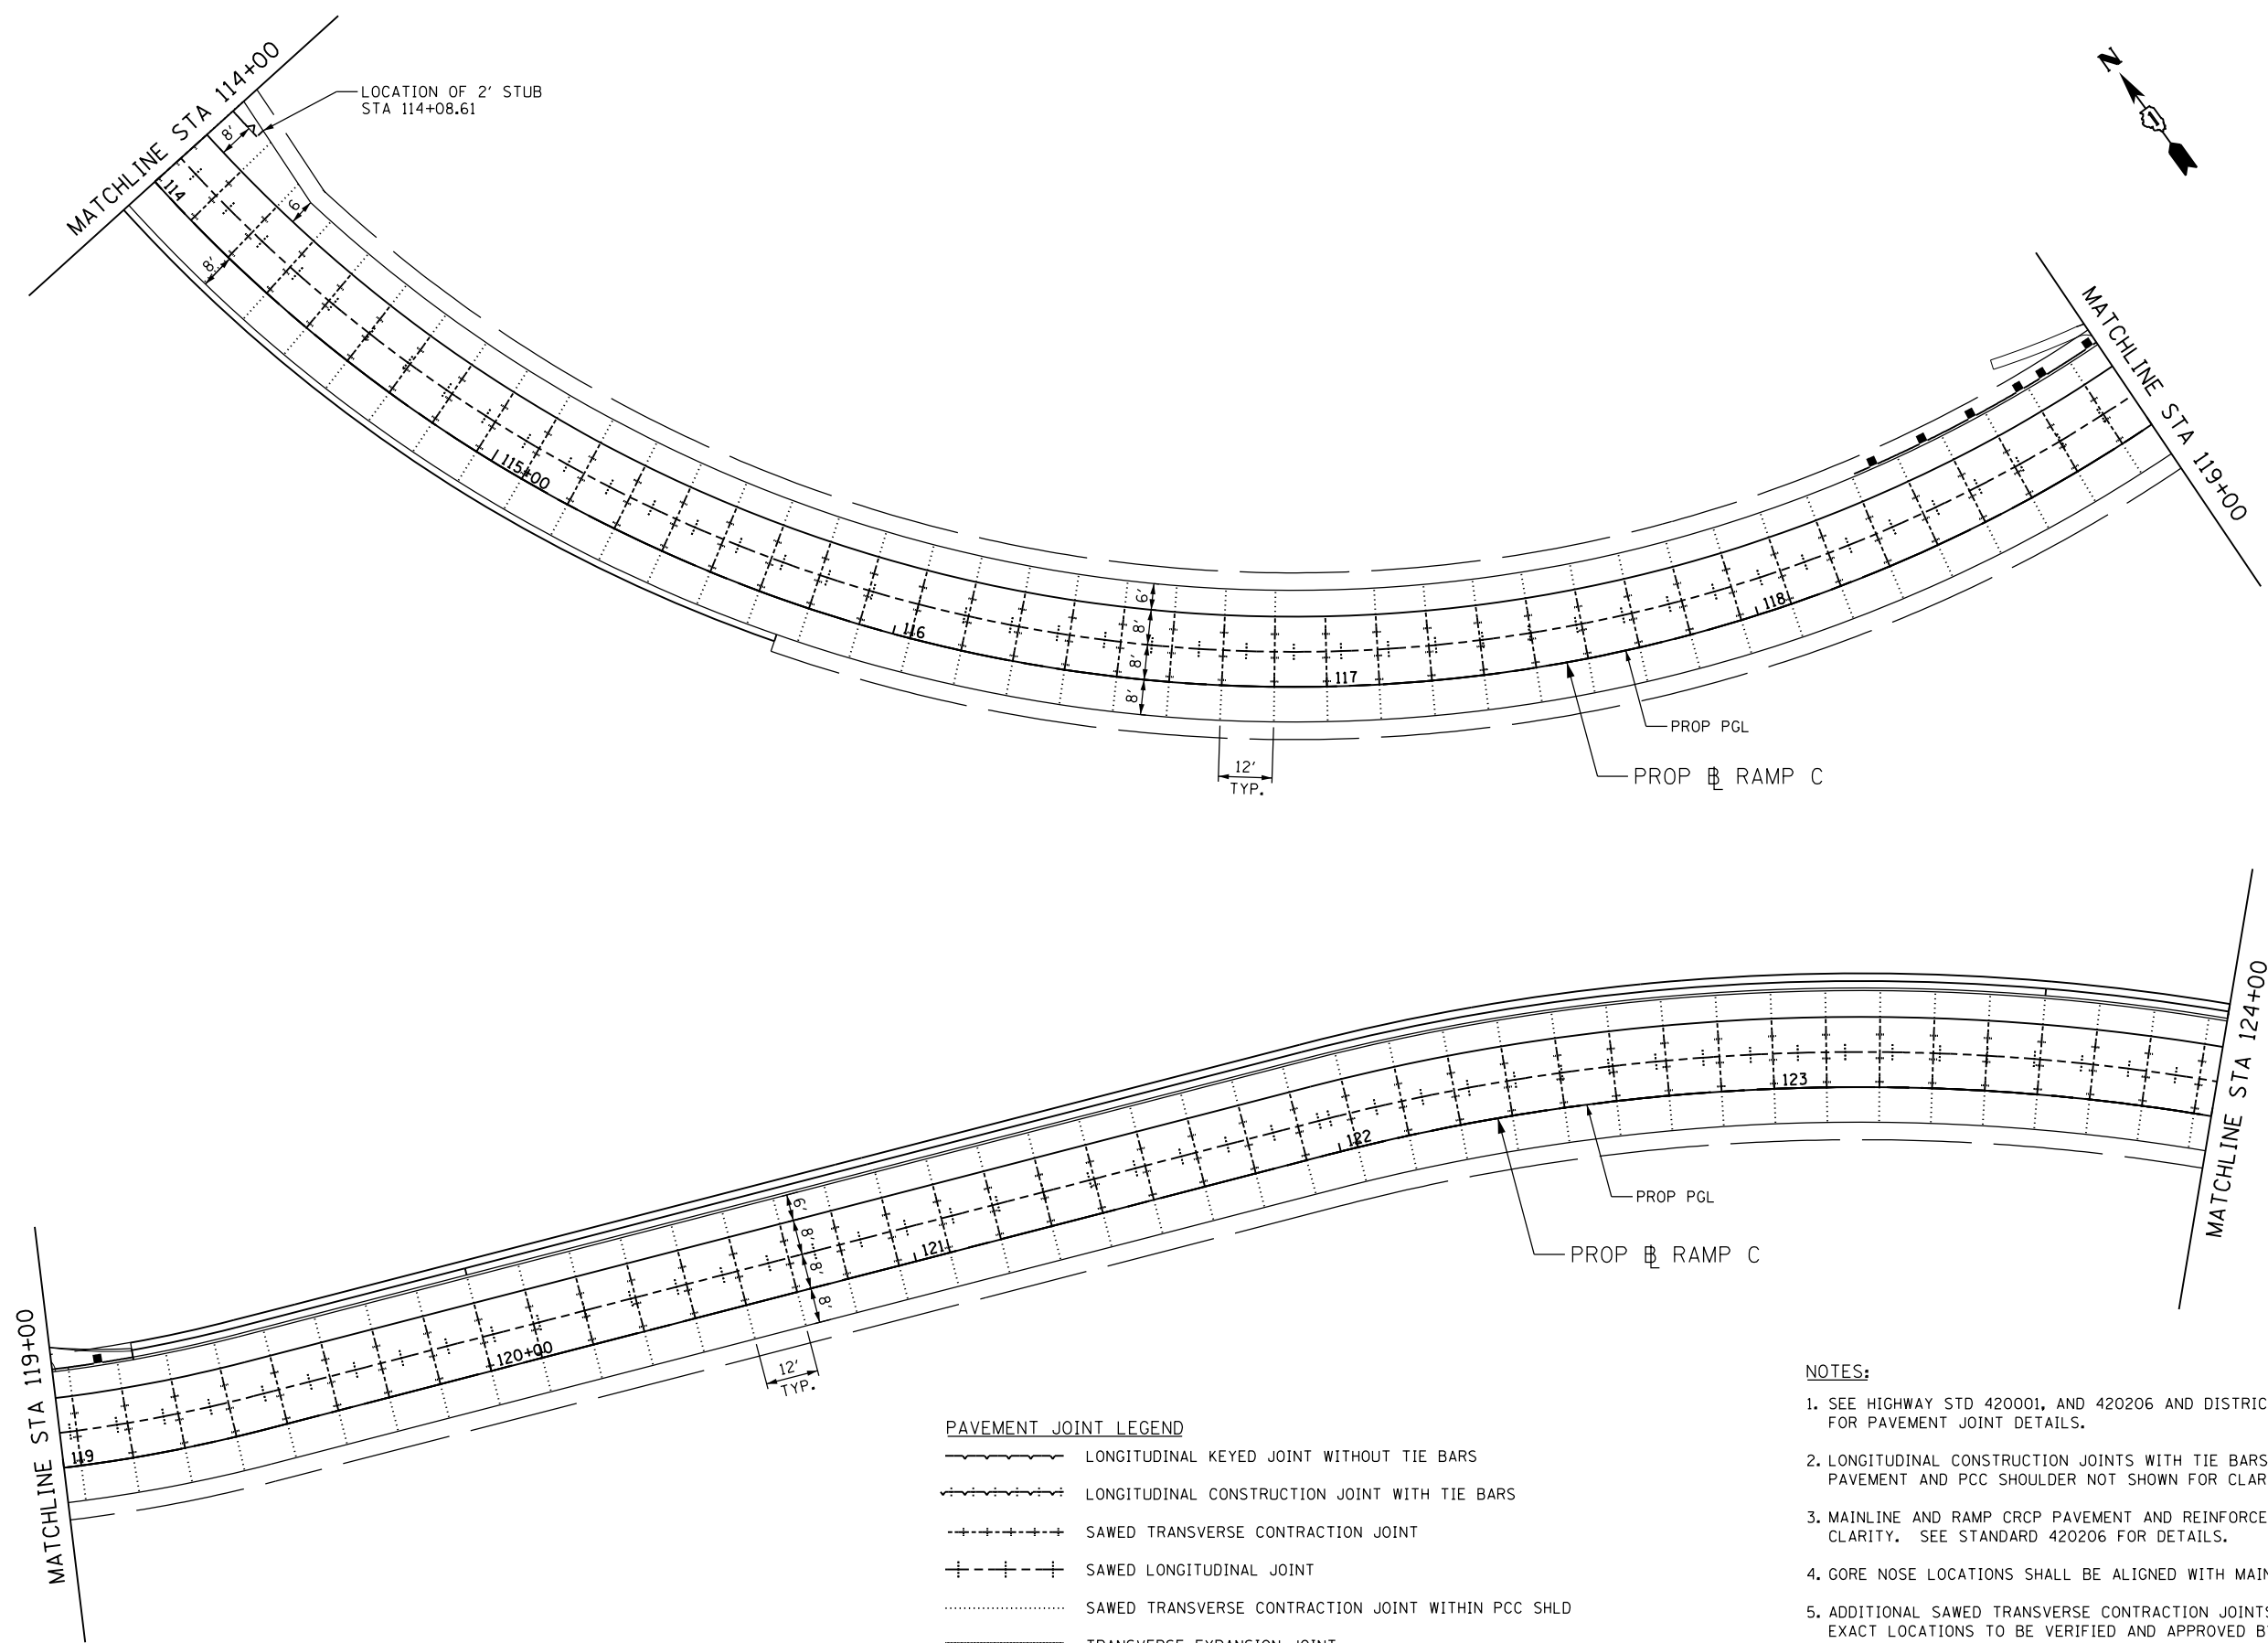- — — — — LONGITUDINAL KEYED JOINT WITHOUT TIE BARS
- - - - - LONGITUDINAL CONSTRUCTION JOINT WITH TIE BARS
- + - + - + - SAWED TRANSVERSE CONTRACTION JOINT
- | - | - | - SAWED LONGITUDINAL JOINT
- SAWED TRANSVERSE CONTRACTION JOINT WITHIN PCC SHLD
- ===== TRANSVERSE EXPANSION JOINT

NOTES:

1. SEE HIGHWAY STD 420001, AND 420206 AND DISTRICT 1 DETAIL BD49 FOR PAVEMENT JOINT DETAILS.
2. LONGITUDINAL CONSTRUCTION JOINTS WITH TIE BARS SHALL BE PLACED BETWEEN PCC PAVEMENT AND PCC SHOULDER NOT SHOWN FOR CLARITY.
3. MAINLINE AND RAMP CRCP PAVEMENT AND REINFORCEMENT AND JOINTS ARE NOT SHOWN FOR CLARITY. SEE STANDARD 420206 FOR DETAILS.
4. GORE NOSE LOCATIONS SHALL BE ALIGNED WITH MAINLINE SHOULDER TRANSVERSE JOINTS.
5. ADDITIONAL SAWED TRANSVERSE CONTRACTION JOINTS MAY BE REQUIRED IN THE FIELD. EXACT LOCATIONS TO BE VERIFIED AND APPROVED BY THE ENGINEER.
6. CONCRETE STUBS SHALL HAVE A 1 FOOT MINIMUM WIDTH.



| | | |
|-----------------------------|------------|-----------|
| USER NAME = rge11 | DESIGNED - | REVISED - |
| PLOT SCALE = 40.0000' / in. | DRAWN - | REVISED - |
| PLOT DATE = 3/25/2013 | CHECKED - | REVISED - |
| | DATE - | REVISED - |



**STATE OF ILLINOIS
DEPARTMENT OF TRANSPORTATION**

**RAMP C
PAVEMENT JOINTING PLAN**

SCALE: SHEET NO. OF SHEETS STA. TO STA.

| | | | | |
|---|--------------|--------|--------------------|-----------|
| F.A.I. RTE. | SECTION | COUNTY | TOTAL SHEETS | SHEET NO. |
| 90/94 | 0303-474HB-R | COOK | 368 | 55 |
| FED. ROAD DIST. NO. 1 ILLINOIS FED. AID PROJECT | | | CONTRACT NO. 60F63 | |

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SUPERELEVATION DIAGRAM
RAMP C: CURVE RAMP C-1
DESIGN SPEED = 45 mph
R = 394'
SE = 6.0%

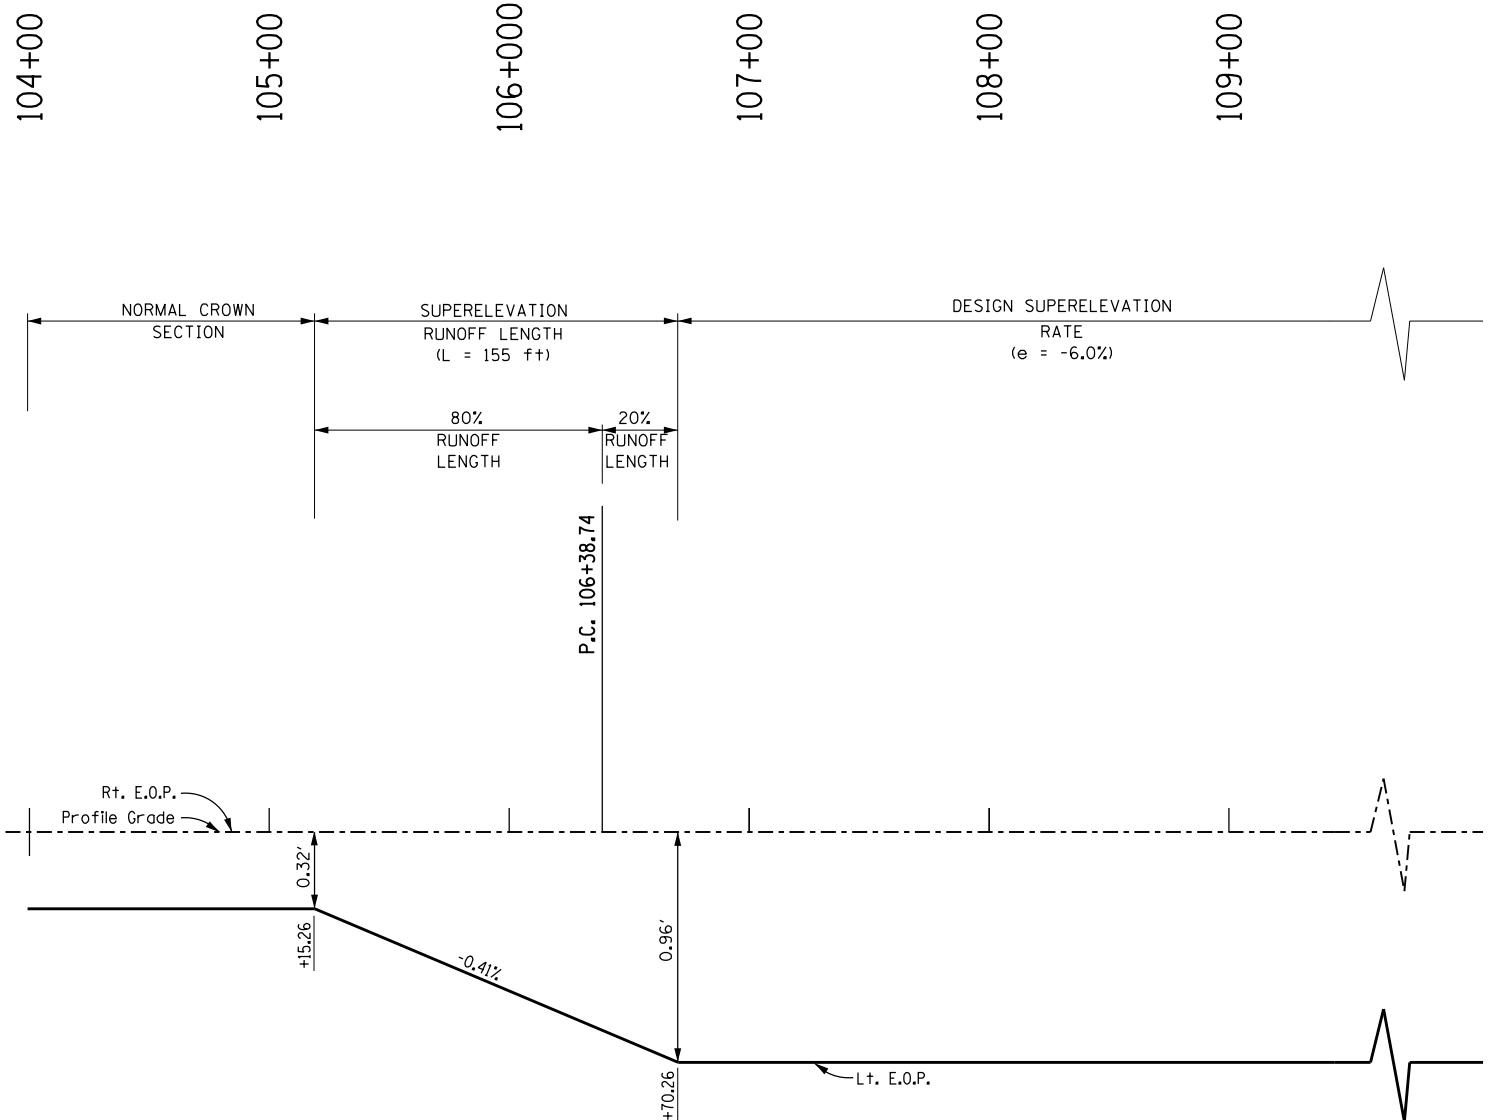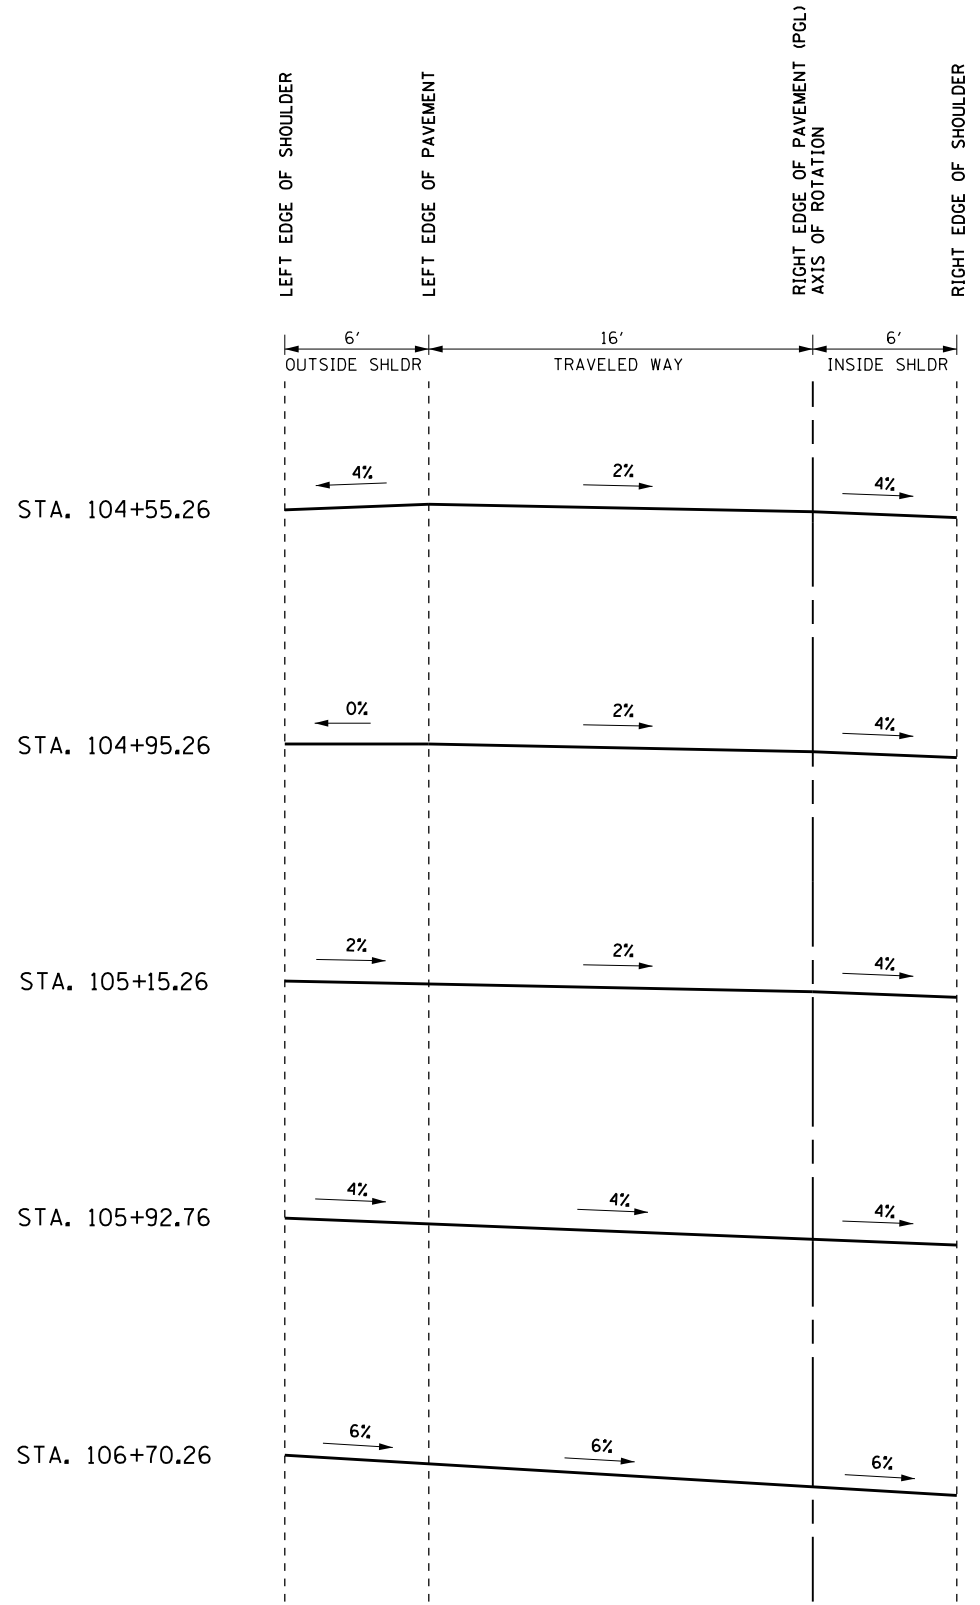



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| PLOT SCALE = 8.0000' / in. | DRAWN - | REVISED - |
| PLOT DATE = 3/25/2013 | CHECKED - | REVISED - |
| | DATE - | REVISED - |

STATE OF ILLINOIS
DEPARTMENT OF TRANSPORTATION

| | | | |
|-------------------------------|-----------|-----------|--------------|
| I-90/94 AT OHIO STREET | | | |
| SUPERELEVATION DIAGRAM | | | |
| SCALE: | SHEET NO. | OF SHEETS | STA. TO STA. |

| | | | | |
|---|--------------|--------|--------------|-----------|
| F.A.I. RTE. | SECTION | COUNTY | TOTAL SHEETS | SHEET NO. |
| 90/94 | 0303-474HB-R | COOK | 368 | 57 |
| CONTRACT NO. 60F63 | | | | |
| FED. ROAD DIST. NO. 1 ILLINOIS FED. AID PROJECT | | | | |

FILE NAME = I:\7000 - 194 at Ohio Street\CADD\CADD SHEETS\DI60F63-SUPER.dgn

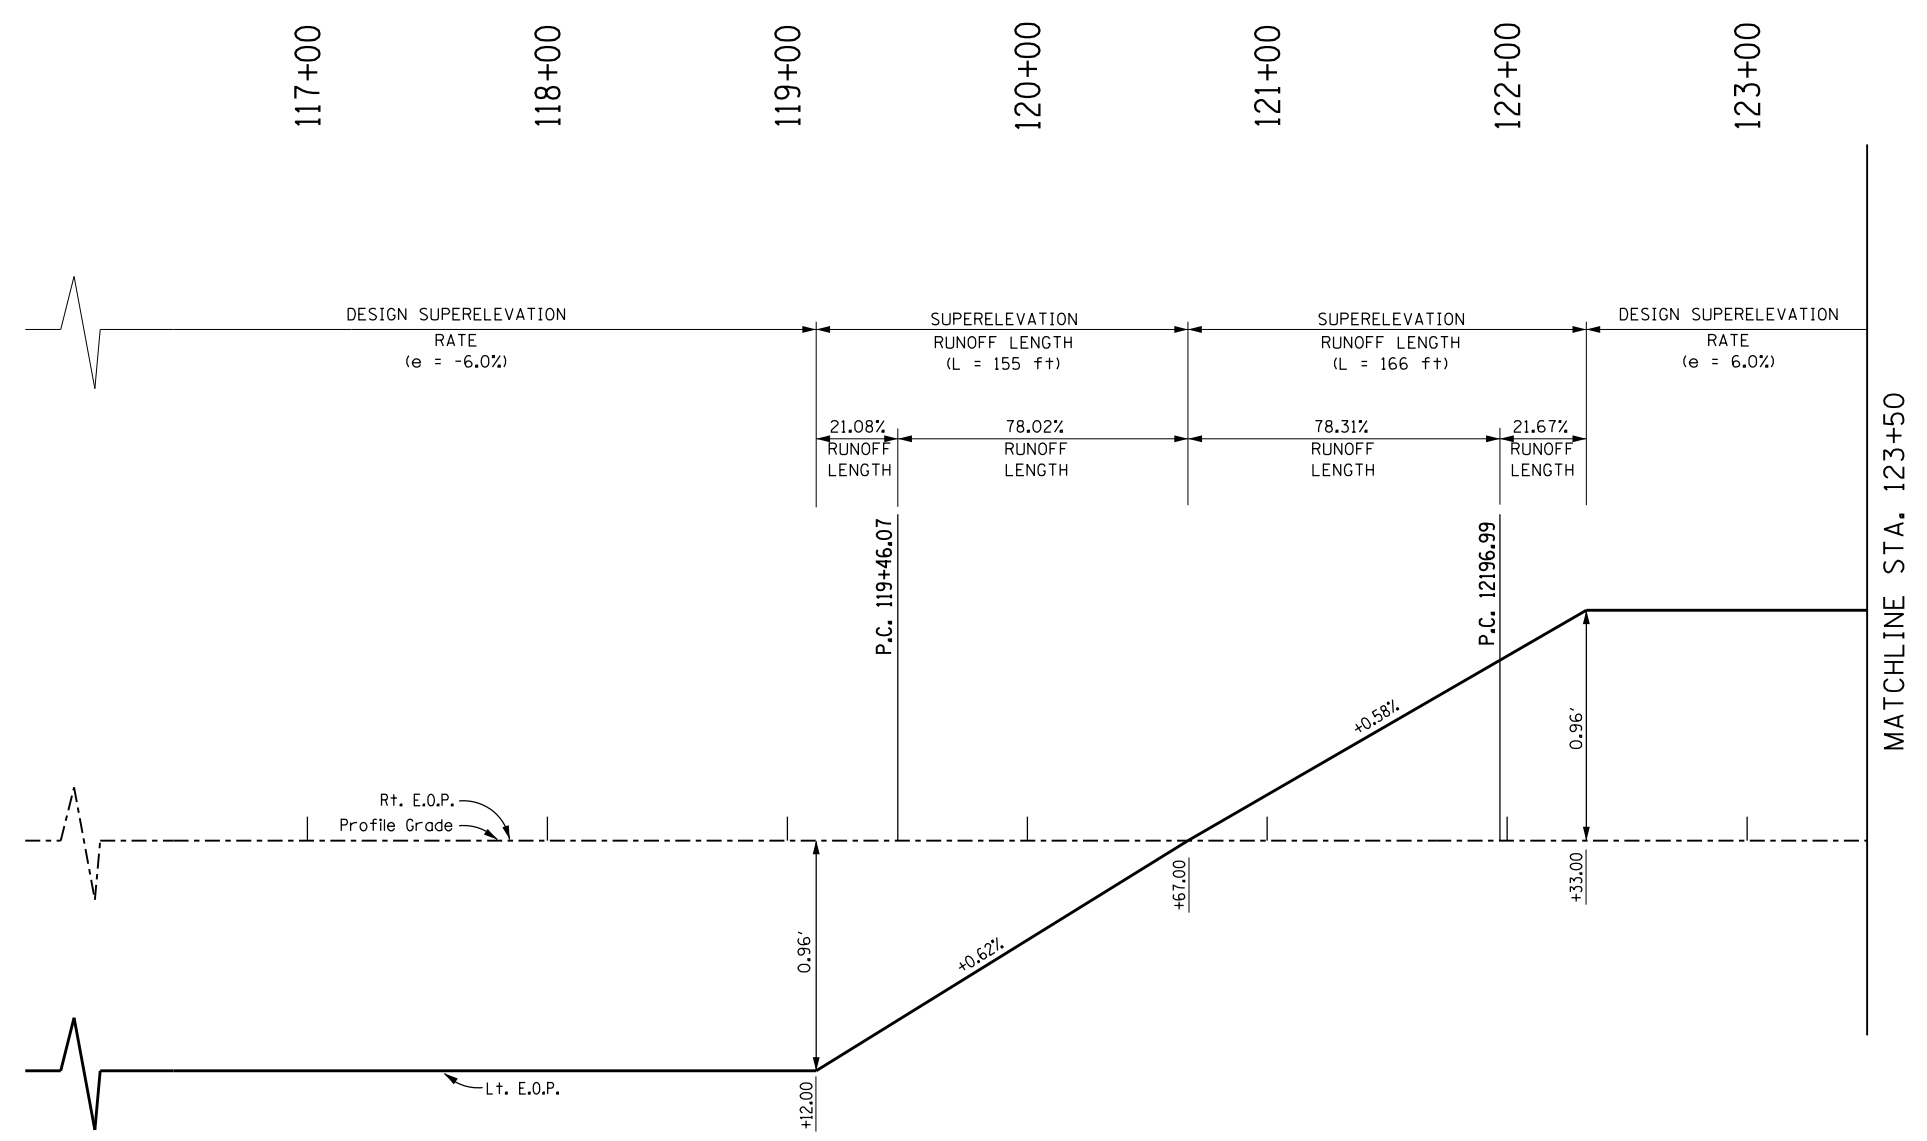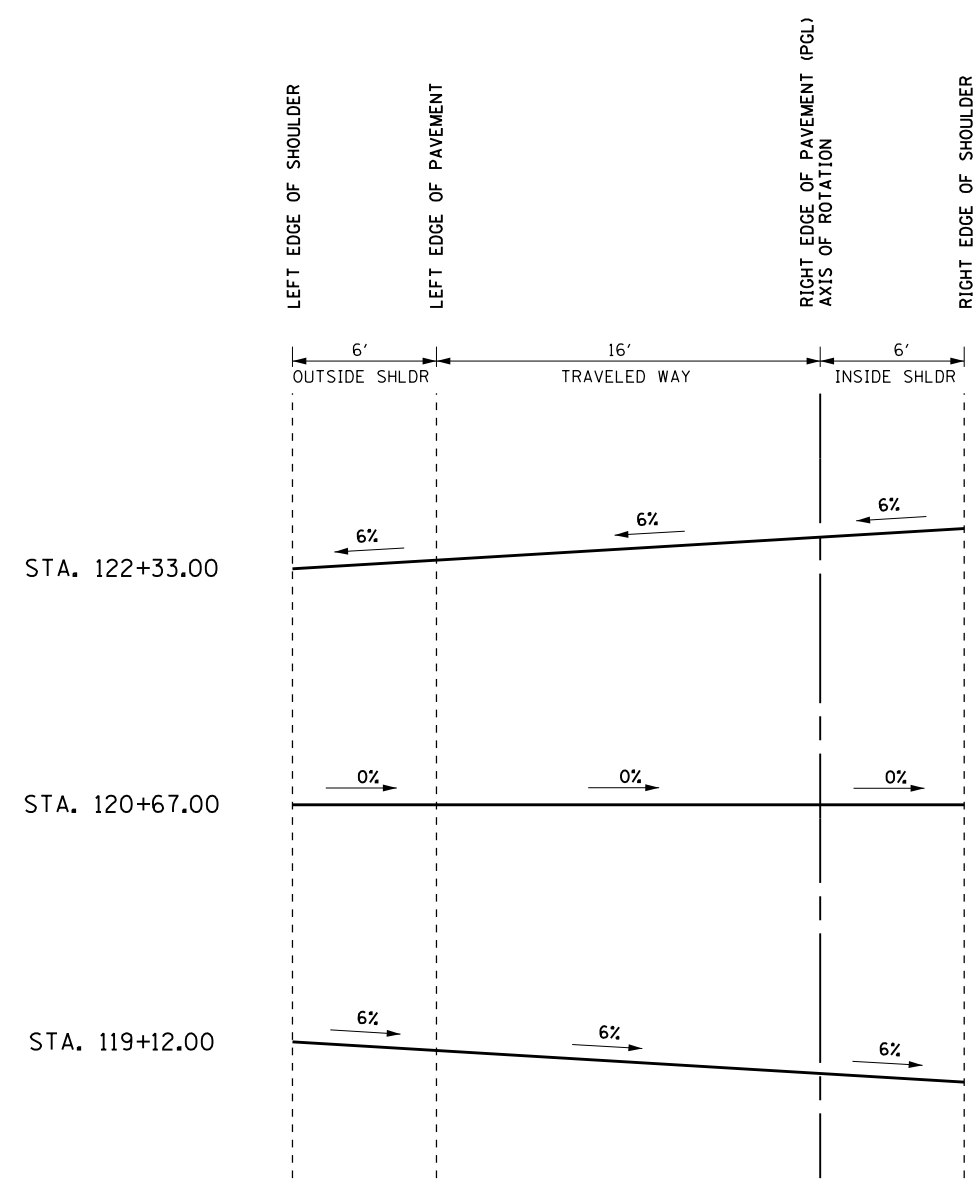

SUPERELEVATION DIAGRAM
RAMP C: CURVE RAMP C-2.3
 DESIGN SPEED = 45 mph
 R = 350'
 SE = 6.0%

MATCHLINE STA. 123+50



USER NAME = r9e11
 PLOT SCALE = 8.0000' / in.
 PLOT DATE = 3/25/2013


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 DATE -

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STATE OF ILLINOIS
DEPARTMENT OF TRANSPORTATION

I-90/94 AT OHIO STREET
SUPERELEVATION DIAGRAM
 SCALE: SHEET NO. OF SHEETS STA. TO STA.

| | | | | |
|---|--------------|--------|--------------|-----------|
| F.A.I. RTE. | SECTION | COUNTY | TOTAL SHEETS | SHEET NO. |
| 90/94 | 0303-474HB-R | COOK | 368 | 58 |
| CONTRACT NO. 60F63 | | | | |
| FED. ROAD DIST. NO. 1 ILLINOIS FED. AID PROJECT | | | | |

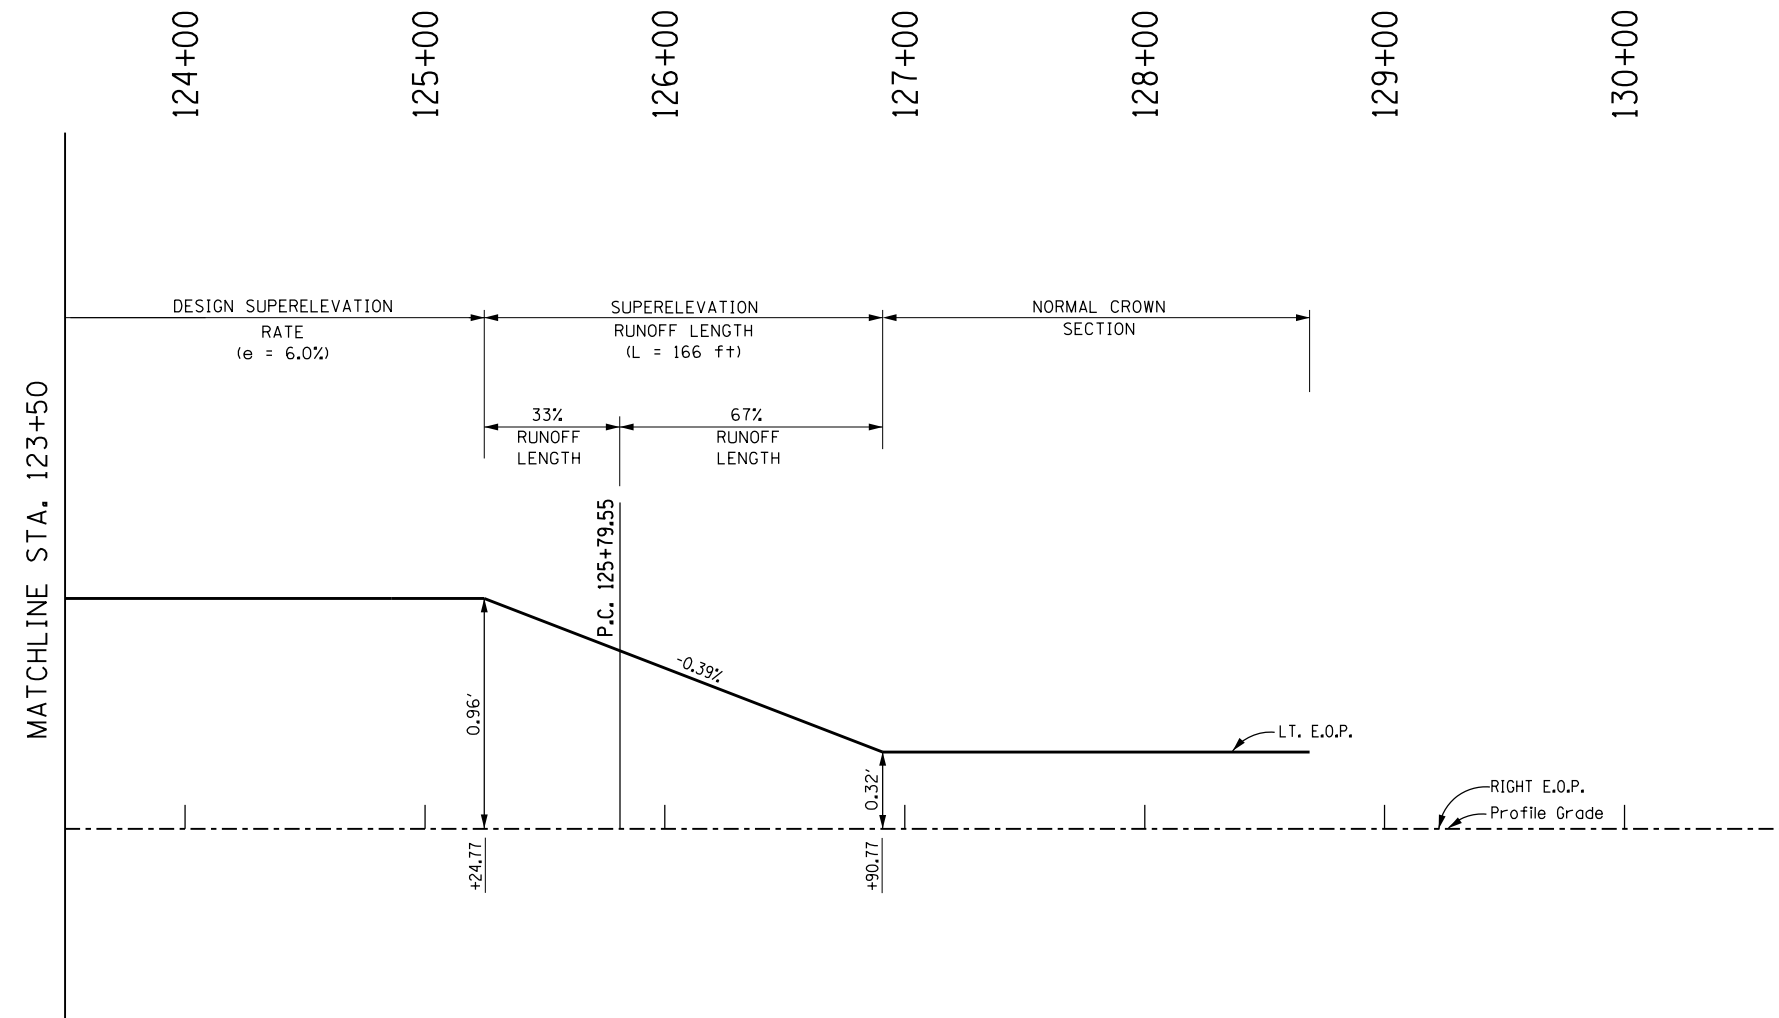

SUPERELEVATION DIAGRAM
 RAMP C: CURVE RAMP C-3
 DESIGN SPEED = 45 mph
 R = 485'
 SE = 6.0%

- NOTES:
- SEE RAMP C PAVEMENT JOINTING PLAN FOR ADDITIONAL PAVEMENT TRANSITIONS DETAILS

FILE NAME = I:\7000 - 194 at Ohio Street\CADD\CADD_SHEETS\DI60663-SUPER.dgn



| | | |
|----------------------------|------------|-----------|
| USER NAME = rge11 | DESIGNED - | REVISED - |
| PLOT SCALE = 8.0000' / in. | DRAWN - | REVISED - |
| PLOT DATE = 3/25/2013 | CHECKED - | REVISED - |
| | DATE - | REVISED - |

**STATE OF ILLINOIS
 DEPARTMENT OF TRANSPORTATION**

**I-90/94 AT OHIO STREET
 SUPERELEVATION DIAGRAM**

SCALE: SHEET NO. OF SHEETS STA. TO STA.

| | | | | |
|---|--------------|--------|--------------------|-----------|
| F.A.I. RE. | SECTION | COUNTY | TOTAL SHEETS | SHEET NO. |
| 90/94 | 0303-474HB-R | COOK | 368 | 59 |
| FED. ROAD DIST. NO. 1 ILLINOIS FED. AID PROJECT | | | CONTRACT NO. 60F63 | |

MAINTENANCE OF TRAFFIC - GENERAL NOTES

1. SEE SPECIAL PROVISIONS TITLED TRAFFIC CONTROL AND PROTECTION (SPECIAL) AND TRAFFIC CONTROL AND PROTECTION (EXPRESSWAYS).
2. THE CONTRACTOR SHALL REMOVE AND SAFELY STORE (FREE FROM THEFT OR DAMAGE) OR COVER ALL CONFLICTING EXISTING SIGNS FOR THE DURATION OF THE CONSTRUCTION. ALL SIGNS SHALL BE RESTORED TO THEIR ORIGINAL CONDITION AT THE END OF CONSTRUCTION.
3. THE FOLLOWING APPLY TO CONSTRUCTION SIGNS:
 - A) THE CONTRACTOR SHALL FURNISH ALL SIGNS.
 - B) THE CONTRACTOR SHALL BE RESPONSIBLE FOR AND REPLACE ANY SIGNS THAT ARE SUPPLIED BY OTHERS AND DAMAGED BY THE CONTRACTOR'S WORK FORCE OR SUBCONTRACTORS DURING RELOCATION OR CONSTRUCTION OPERATIONS.
 - C) ALL SIGNS AND ASSEMBLIES SHALL BE CERTIFIED BY THE CONTRACTOR AS MEETING THE APPLICABLE REQUIREMENTS OF NCHRP REPORT 350. TEST LEVEL 3.
 - D) ALL SIGNS SHALL BE CONSIDERED INCLUDED IN THE COST OF THE TRAFFIC CONTROL AND PROTECTION (EXPRESSWAYS) PAY ITEM, EXCEPT FOR TEMPORARY INFORMATIONAL SIGNING AS NOTED ON THE PLANS.
4. OPENINGS THROUGH THE BARRIER FOR CONTRACTOR'S ACCESS TO THE WORK ZONE SHALL BE PROVIDED AS APPROVED BY THE ENGINEER.
5. ANY RAISED REFLECTIVE PAVEMENT MARKERS THAT CONFLICT WITH THE TEMPORARY TRAFFIC LANES MUST HAVE THE REFLECTIVE LENSES REMOVED AS DIRECTED BY THE ENGINEER.
6. ALL TEMPORARY PAVEMENT MARKINGS ALONG I-90/94 AND RAMPS DURING STAGED CONSTRUCTION SHALL BE WET REFLECTIVE TAPE, TYPE III OF THE WIDTH AND COLOR SPECIFIED ON THE PLAN SHEETS.
7. MONO-DIRECTIONAL PRISMATIC BARRIER REFLECTORS WILL BE PLACED AT 25' CENTERS ON TOP AND SIDE OF TEMPORARY CONCRETE BARRIER FACING TRAFFIC.
8. A CHANGEABLE MESSAGE SIGN SHALL BE LOCATED ON I-90/94 EASTBOUND AND I-90/94 WESTBOUND, AS WELL AS LOCATIONS SPECIFIED ON THE PLANS.
9. NO TRAFFIC STAGES SHALL OVERLAP WITHOUT PRIOR WRITTEN APPROVAL FROM THE ENGINEER.

I-90/94, STAGING NOTES: STAGE IA

SEE SPECIAL PROVISIONS FOR STAGING AND LANE CLOSURE RESTRICTIONS.

WORK IN THIS STAGE CONSISTS OF CONSTRUCTING PORTIONS OF PIER 1 AND PIER 2 FOR SN 016-1322/SN 016-1323 IN THE MEDIAN OF I-90/94.

INSTALL STAGE I TEMPORARY SIGNAGE.

CLOSE THE INSIDE LANE OF WB I-90/94 IN ACCORDANCE WITH STD. 701400 AND 701401.

INSTALL BARRICADES ALONG THE SLIP RAMP EXITING THE EXPRESS LANES AND CLOSE THE INSIDE LANE OF EB I-90/94.

SHIFT EB AND WB I-90/94 TRAFFIC INTO THE STAGE I CONFIGURATION AS SHOWN ON THE PLANS INCLUDING INSTALLATION OF MOVEABLE TRAFFIC BARRIER AND TEMPORARY ATTENUATORS ADJACENT TO THE WORK ZONE IN ACCORDANCE WITH DISTRICT DETAIL TC-17.

I-90/94, STAGING NOTES: STAGE IB

ALL TRAFFIC CONTROL DEVICES, INCLUDING MOVEABLE TRAFFIC BARRIER SHALL BE RELOCATED OUT OF THE TRAVEL LANES, TO THE LOCATIONS SHOWN ON THE STAGING TYPICAL SECTIONS, AND ALL LANES OPENED BACK TO TRAFFIC.

I-90/94, STAGING NOTES: STAGE IC

WORK IN THIS STAGE CONSISTS OF SETTING THE BEAMS FOR SN 016-1322/ SN 016-1323.

TEMPORARY CLOSURES OF EB I-90/94 AND WB I-90/94 TRAFFIC DURING THE HOURS SPECIFIED IN THE SPECIAL PROVISIONS WILL BE PERMITTED.

RAMP C, STAGING NOTES: STAGE I

INSTALL CHANGEABLE MESSAGE SIGNS AND SIGN PANEL OVERLAYS PRIOR TO START OF CONSTRUCTION ACTIVITY ON I-90/94 AND THE RAMPS.

WORK IN THIS STAGE CONSISTS OF CONSTRUCTING TEMPORARY PAVEMENT ALONG RAMP C, REMOVING PORTIONS OF EXISTING RAMP C PAVEMENT AND CONSTRUCTING PORTIONS OF PROPOSED RAMP C AS SHOWN IN THE PLANS AND TYPICAL SECTIONS.

PRIOR TO SHIFTING RAMP C TRAFFIC INTO TEMPORARY LANE CONFIGURATION, TEMPORARY PAVEMENT SHALL BE CONSTRUCTED TO THE ALIGNMENT SHOWN ON THE PLANS. TRAFFIC DURING THIS STAGE SHALL REMAIN ON EXISTING RAMP C ALIGNMENT AND WORK SHALL BE DONE ON ACCORDANCE WITH DETAIL TC-17, PARTIAL RAMP CLOSURES, MAINTAINING A MINIMUM OF A 12' TRAFFIC LANE AT ALL TIMES.

WORK IN THIS STAGE CONSISTS OF CONSTRUCTING THE SUBSTRUCTURE FOR SN 016-1322 AND SN 016-1323, INCLUDING GROUND IMPROVEMENTS (INSTALLATION OF AGGREGATE PIERS), PORTIONS OF THE APPROACH MSE WALLS AND TEMPORARY GEOTEXTILE WALL, AS SHOWN IN THE PLANS.

SHIFT RAMP C TRAFFIC INTO THE STAGE I CONFIGURATION AS SHOWN ON THE PLANS INCLUDING INSTALLATION OF THE TEMPORARY CONCRETE BARRIER ADJACENT TO THE TEMPORARY RAMP C PAVEMENT.

SEE ELECTRICAL PLANS FOR TEMPORARY LIGHTING PLANS ALONG RAMP C

GROUND IMPROVEMENTS (AGGREGATE PIERS) FOR MSE WALL CONSTRUCTION REQUIRE SETTLEMENT PERIOD. SEE STRUCTURAL PLANS AND SPECIAL PROVISIONS.

RAMP A, STAGING NOTES: STAGE IA

WORK IN THIS STAGE CONSISTS OF CONSTRUCTING THE SUBSTRUCTURE FOR SN 016-2573, INCLUDING INSTALLING TEMPORARY LIGHTING, CONSTRUCTION OF THE TEMPORARY SOIL RETENTION SYSTEM, ALL PROPOSED WORK ALONG THE SOUTH HALF OF THE UNDERPASS, INCLUDING CONSTRUCTION OF THE ABUTMENT EXTENSION, ABUTMENT REPAIRS, AND REPLACEMENT OF THE SOUTH HALF OF RAMP A PAVEMENT AS SHOWN IN THE PLANS AND TYPICAL SECTIONS.

SHIFT RAMP A TRAFFIC INTO THE SUBSTAGE A CONFIGURATION AS SHOWN ON THE PLANS INCLUDING THE TEMPORARY CONCRETE BARRIER ADJACENT TO RAMP TRAFFIC.

RAMP A, STAGING NOTES: STAGE IB

WORK IN THIS STAGE CONSISTS OF CONSTRUCTING THE SUBSTRUCTURE FOR SN 016-2573, INCLUDING INSTALLING TEMPORARY LIGHTING, CONSTRUCTION OF THE TEMPORARY SOIL RETENTION SYSTEM, ALL PROPOSED WORK ALONG THE NORTH HALF OF THE UNDERPASS, INCLUDING CONSTRUCTION OF THE ABUTMENT EXTENSION, ABUTMENT REPAIRS, AND REPLACEMENT OF THE NORTH HALF OF RAMP A PAVEMENT AS SHOWN IN THE PLANS AND TYPICAL SECTIONS.

SHIFT RAMP A TRAFFIC INTO THE SUBSTAGE B CONFIGURATION AS SHOWN ON THE PLANS INCLUDING THE TEMPORARY CONCRETE BARRIER ADJACENT TO RAMP TRAFFIC.

RAMP A, STAGING NOTES: STAGE IC

SEE SPECIAL PROVISIONS FOR STAGING AND LANE CLOSURE RESTRICTIONS.

WORK IN THIS STAGE CONSISTS OF REPLACEMENT OF THE EXISTING PPC DECK BEAMS ALONG SN-016-2573 UP TO THE STAGE I CONSTRUCTION LINE.

RAMP A TRAFFIC WILL BE CLOSED TO TRAFFIC DURING THE HOURS SPECIFIED IN THE SPECIAL PROVISIONS. ALL RAMP A TRAFFIC WILL BE DETOURED AS SHOWN IN DETOUR ROUTING "A".

RAMP D, STAGING NOTES: STAGE IA

WORK IN THIS STAGE CONSISTS OF CONSTRUCTING THE SUBSTRUCTURE FOR SN 016-1323, INCLUDING GROUND IMPROVEMENTS (INSTALLATION OF AGGREGATE PIERS), PORTIONS OF THE APPROACH MSE WALL AND TEMPORARY GEOTEXTILE WALL ALONG THE EAST SIDE OF RAMP D AS SHOWN IN THE PLANS.

SHIFT THE 2-LANE RAMP D TRAFFIC INTO THE STAGE IA LANE CONFIGURATION AS SHOWN ON THE PLANS INCLUDING INSTALLATION OF TEMPORARY CONCRETE BARRIER ADJACENT TO RAMP TRAFFIC.

RAMP D, STAGING NOTES: STAGE IB

WORK IN THIS STAGE CONSISTS OF CONSTRUCTING THE SUBSTRUCTURE FOR SN 016-1323, INCLUDING PORTIONS OF THE APPROACH MSE WALL AND TEMPORARY GEOTEXTILE WALL ALONG THE WEST SIDE OF RAMP D AS SHOWN IN THE PLANS.

SHIFT THE 2-LANE RAMP D TRAFFIC INTO THE STAGE IB LANE CONFIGURATION AS SHOWN ON THE PLANS INCLUDING RELOCATION OF TEMPORARY CONCRETE BARRIER ADJACENT TO RAMP TRAFFIC.

RAMP D, STAGING NOTES: STAGE IC

WORK IN THIS STAGE CONSISTS OF SETTING THE BEAMS FOR SN 016-1323.

TEMPORARY CLOSURES OF EB I-90/94, WB I-90/94 AND THE RAMPS DURING THE HOURS SPECIFIED IN THE SPECIAL PROVISIONS WILL BE PERMITTED.

FILE NAME = 8FILES



| | | |
|-------------------------------|------------|-----------|
| USER NAME = r9e11 | DESIGNED - | REVISED - |
| PLOT SCALE = 200.0000' / 1in. | DRAWN - | REVISED - |
| PLOT DATE = 3/25/2013 | CHECKED - | REVISED - |
| | DATE - | REVISED - |

**STATE OF ILLINOIS
DEPARTMENT OF TRANSPORTATION**

**STAGING AND TRAFFIC CONTROL
STAGING NOTES**

SCALE: SHEET NO. OF SHEETS STA. TO STA.

| | | | | |
|---|--------------|--------|--------------|-----------|
| F.A.I. RTÉ. | SECTION | COUNTY | TOTAL SHEETS | SHEET NO. |
| 90/94 | 0303-474HB-R | COOK | 368 | 60 |
| CONTRACT NO. 60F63 | | | | |
| FED. ROAD DIST. NO. 1 ILLINOIS FED. AID PROJECT | | | | |

I-90/94, STAGING NOTES: WINTER SHUTDOWN

REMOVE ALL PAVEMENT MARKINGS THAT CONFLICT WITH WINTER SHUTDOWN TRAFFIC LANES. APPLY PAVEMENT MARKINGS AS DESCRIBED HEREIN.

RAMP A NO LANE RESTRICTIONS. RESTORE EXISTING PAVEMENT MARKINGS.
RAMP D NO LANE RESTRICTIONS. RESTORE EXISTING PAVEMENT MARKINGS.
I-90/94 NO LANE RESTRICTIONS. RESTORE EXISTING PAVEMENT MARKINGS.
RAMP C REMAIN IN STAGE I LANE CONFIGURATION

NO DROP OFFS SHALL BE ALLOWED DURING WINTER SHUTDOWN EXCEPT AS APPROVED BY THE ENGINEER AND WHICH ARE PROTECTED BY BARRIERS AS APPROPRIATE.

I-90/94, STAGING NOTES: STAGE 2 - PRE-STAGE

"CHANGEABLE MESSAGE SIGNS" SHALL BE INSTALLED, AS SHOWN ON THE PLANS. THE LOCATIONS SHALL BE DETERMINED BY THE ENGINEER.

CONSTRUCT TEMPORARY PAVEMENT ALONG RAMP D, AS SHOWN IN THE PLANS.

I-90/94, STAGING NOTES: STAGE 2A

SEE SPECIAL PROVISIONS FOR STAGING AND LANE CLOSURE RESTRICTIONS.

INSTALL SIGN PANEL OVERLAYS PRIOR TO THE START OF CONSTRUCTION ACTIVITIES.

WORK IN THIS STAGE CONSISTS OF REMOVING SN 016-1003 SUPERSTRUCTURE UNIT 2 OVER THE REVERSIBLE LANES AND EB I-90/94.

LOCAL TRAFFIC WILL BE DETOURED USING DETOUR ROUTING "B", AS SHOWN IN THE PLANS.

RESTRICT ALL EB I-90/94 TRAFFIC TO 2 LANES, PER STD. 701400 AND 701446, AND AS SHOWN IN THE PLANS.

ALL EB MAINLINE I-90/94 TRAFFIC AND THE REVERSIBLES WILL BE CLOSED AT THE 2-LANE EXIT TO EB OHIO STREET. TWO (2) LANES OF TRAFFIC WILL BE DIVERTED ONTO THE EB OHIO STREET EXIT RAMP (RAMP D) AND ONTO TEMPORARY PAVEMENT CONSTRUCTED TO FACILITATE A 2-LANE CROSSOVER TO THE EXISTING ONTARIO STREET ENTRANCE RAMP I-90/94.

SUPERSTRUCTURE UNIT 2 WILL BE MOVED VIA SELF-PROPELLED MOBILE TRANSPORT (SPMT) EQUIPMENT, OR OTHER MEANS TO A LOCATION ALONG THE EB LANES, AS SHOWN ON THE PLANS. THE STRUCTURE WILL BE LOCATED OFF THE PAVEMENT ALLOWING FOR FURTHER DEMOLITION WHILE ALL LANES OF TRAFFIC ARE REOPENED. SEE SPECIAL PROVISIONS FOR RESTRICTIONS ON DEMOLITION.

I-90/94, STAGING NOTES: STAGE 2B

SEE SPECIAL PROVISIONS FOR STAGING AND LANE CLOSURE RESTRICTIONS.

INSTALL SIGN PANEL OVERLAYS PRIOR TO THE START OF CONSTRUCTION ACTIVITIES.

WORK IN THIS STAGE CONSISTS OF REMOVING SN 016-1003 SUPERSTRUCTURE UNIT 1 OVER THE EXPRESS LANES AND WB I-90/94.

LOCAL TRAFFIC WILL BE DETOURED USING DETOUR ROUTING "B", AS SHOWN IN THE PLANS.

WORK IN THIS STAGE CONSISTS OF TEMPORARILY RESTRIPING N. ORLEANS STREET AS SHOWN IN THE PLANS.

ALL WB MAINLINE I-90/94 TRAFFIC WILL BE REDUCED TO 2 LANES, PER STD. 701400 AND 701446, AS SHOWN ON THE PLANS. ALL WB MAINLINE LANES AND THE REVERSIBLES WILL BE CLOSED AT THE EXIT TO EB OHIO STREET. TWO (2) LANES OF TRAFFIC WILL BE DIVERTED ONTO EB OHIO STREET, AS SHOWN IN THE PLANS.

AT THE CONCLUSION OF THE STAGE, N. ORLEANS STREET SHALL BE RESTORED TO THE ORIGINAL STRIPING CONFIGURATION AND OPENED TO TRAFFIC.

I-90/94, STAGING NOTES: STAGE 2C

SEE SPECIAL PROVISIONS FOR STAGING AND LANE CLOSURE RESTRICTIONS.

INSTALL SIGN PANEL OVERLAYS PRIOR TO THE START OF CONSTRUCTION ACTIVITIES.

WORK IN THIS STAGE CONSISTS OF REMOVING SN 016-1003 SUPERSTRUCTURE UNIT 3 OVER RAMP D.

LOCAL TRAFFIC WILL BE DETOURED USING DETOUR ROUTING "B", AS SHOWN IN THE PLANS.

ALL MAINLINE I-90/94 TRAFFIC WILL BE OPEN AND THE EXIT TO EB OHIO STREET CLOSED, AS SHOWN IN THE PLANS.

SUPERSTRUCTURE UNIT 3 WILL BE MOVED VIA SELF-PROPELLED MOBILE TRANSPORT (SPMT) EQUIPMENT, OR OTHER MEANS TO A LOCATION ALONG RAMP D, AS SHOWN ON THE PLANS. THE STRUCTURE WILL BE LOCATED OFF THE PAVEMENT ALLOWING FOR FURTHER DEMOLITION WHILE ALL LANES OF TRAFFIC ARE REOPENED. SEE SPECIAL PROVISIONS FOR RESTRICTIONS ON DEMOLITION.

I-90/94, STAGING NOTES: STAGE IIIA

SEE SPECIAL PROVISIONS FOR STAGING AND LANE CLOSURE RESTRICTIONS.

WORK IN THIS STAGE CONSISTS OF CONSTRUCTING THE REMAINING PORTIONS OF PIER 1 AND PIER 2 FOR SN 016-1322 IN THE MEDIAN OF I-90/94.

CLOSE THE INSIDE LANE OF WB I-90/94 IN ACCORDANCE WITH STD. 701400 AND 701446.

INSTALL BARRICADES ALONG THE SLIP RAMP EXITING THE EXPRESS LANES AND CLOSE THE INSIDE LANE OF EB I-90/94.

SHIFT EB AND WB I-90/94 TRAFFIC INTO THE STAGE III CONFIGURATION AS SHOWN ON THE PLANS INCLUDING INSTALLATION OF TEMPORARY CONCRETE BARRIER AND TEMPORARY ATTENUATORS ADJACENT TO THE WORK ZONE IN ACCORDANCE WITH DISTRICT DETAIL TC-17.

I-90/94, STAGING NOTES: STAGE IIIB

SEE SPECIAL PROVISIONS FOR STAGING AND LANE CLOSURE RESTRICTIONS.

ALL TRAFFIC CONTROL DEVICES, INCLUDING TEMPORARY CONCRETE BARRIER SHALL BE RELOCATED OUT OF THE TRAVEL LANES TO THE LOCATIONS SHOWN ON THE STAGING TYPICAL SECTIONS, AND ALL LANES OPENED BACK TO TRAFFIC.

I-90/94, STAGING NOTES: STAGE IIIC

INSTALL SUBSTAGE IIIC SIGN PANEL OVERLAYS.

WORK IN THIS STAGE CONSISTS OF CONSTRUCTING THE EB AND WB I-90/94 SHOULDERS AND PORTIONS OF THE RAMP C ENTRANCE RAMP GORE.

SHIFT ALL WB I-90/94 TRAFFIC LANES IN 11 FOOT LANES TO LOCATIONS AS SHOWN IN THE PLANS.

CLOSE THE INSIDE LANE OF THE 2-LANE EXIT RAMP FROM EB I-90/94 TO EB OHIO STREET AND THE OUTSIDE LANE OF EB I-90/94. SHIFT ALL EB I-90/94 TRAFFIC LANES IN 11 FOOT LANES TO LOCATIONS AS SHOWN IN THE PLANS.

INSTALL TEMPORARY BARRIER WALL ALONG THE EB AND WB I-90/94 OUTSIDE SHOULDER IN ACCORDANCE WITH TC-17, STAGING TYPICAL SECTIONS, AND THE PLANS.

I-90/94, STAGING NOTES: STAGE IIID

WORK IN THIS STAGE CONSISTS OF CONSTRUCTING THE NORTH HALF OF THE RAMP C ENTRANCE RAMP GORE AND SETTING THE REMAINING BEAMS FOR SN 016-1322.

RELOCATE THE TEMPORARY BARRIER WALL TO THE LOCATIONS SHOWN ON THE STAGING TYPICAL SECTIONS AND PLANS.

SHIFT ALL EB AND WB I-90/94 TRAFFIC INTO THE ORIGINAL CONFIGURATION. TEMPORARY LANES CLOSURES ALONG EB I-90/94 AND WB I-90/94 WILL BE PERMITTED DURING THE HOURS SPECIFIED IN THE SPECIAL PROVISIONS.

I-90/94, STAGING NOTES: STAGE IIIE

WORK IN THIS STAGE CONSISTS OF CONSTRUCTING THE SOUTH HALF OF THE THE RAMP C ENTRANCE RAMP GORE.

INSTALL THE RAMP C TEMPORARY BARRIER WALL TO THE LOCATIONS SHOWN ON THE STAGING TYPICAL SECTIONS AND PLANS.

CLOSE LANE 5 (OUTSIDE LANE) OF EB I-90/94 AS SHOWN ON THE PLANS. LANES 1-4 WILL REMAIN IN THEIR ORIGINAL CONFIGURATION.

CONSTRUCT THE REMAINDER THE REMAINDER OF THE RAMP C ENTRANCE RAMP GORE.

RAMP C, STAGING NOTES: STAGE III

INSTALL CHANGEABLE MESSAGE SIGNS AND SIGN PANEL OVERLAYS PRIOR TO START OF CONSTRUCTION ACTIVITY ON I-90/94 AND ONTARIO STREET.

WORK IN THIS STAGE CONSISTS OF CONSTRUCTING TEMPORARY PAVEMENT ALONG RAMP C, REMOVING PORTIONS OF EXISTING RAMP C PAVEMENT AND CONSTRUCTING PORTIONS OF PROPOSED RAMP C AS SHOWN IN THE PLANS AND TYPICAL SECTIONS.

WORK IN THIS STAGE CONSISTS OF CONSTRUCTING THE REMAINDER OF THE SUBSTRUCTURE FOR SN 016-1322, INCLUDING GROUND IMPROVEMENTS (INSTALLATION OF AGGREGATE PIERS), PORTIONS OF THE EAST APPROACH MSE WALL AND TEMPORARY GEOTEXTILE WALL, AS SHOWN IN THE PLANS.

PRIOR TO SHIFTING RAMP C TRAFFIC INTO TEMPORARY LANE CONFIGURATION, TEMPORARY PAVEMENT SHALL BE CONSTRUCTED TO THE ALIGNMENT SHOWN ON THE PLANS. TRAFFIC DURING THIS STAGE SHALL REMAIN ON EXISTING RAMP C ALIGNMENT AND WORK SHALL BE DONE ON ACCORDANCE WITH DETAIL TC-17, PARTIAL RAMP CLOSURES, MAINTAINING A MINIMUM OF A 12' TRAFFIC LANE AT ALL TIMES.

SHIFT RAMP C TRAFFIC INTO THE STAGE III CONFIGURATION AS SHOWN ON THE PLANS INCLUDING INSTALLATION OF THE TEMPORARY CONCRETE BARRIER ADJACENT TO THE TEMPORARY RAMP C PAVEMENT.

SEE ELECTRICAL PLANS FOR TEMPORARY LIGHTING PLANS ALONG RAMP C

GROUND IMPROVEMENTS (AGGREGATE PIERS) FOR MSE WALL CONSTRUCTION REQUIRE SETTLEMENT PERIOD. SEE STRUCTURAL PLANS.

RAMP A, STAGING NOTES: STAGE IIIA

WORK IN THIS STAGE CONSISTS OF CONSTRUCTING ALL REMAINING WORK FOR SN 016-2573, ALONG THE SOUTH HALF OF THE UNDERPASS, INCLUDING ABUTMENT REPAIRS AS SHOWN IN THE PLANS AND TYPICAL SECTIONS.

SHIFT RAMP A TRAFFIC INTO THE SUBSTAGE A CONFIGURATION AS SHOWN ON THE PLANS INCLUDING THE TEMPORARY CONCRETE BARRIER ADJACENT TO RAMP TRAFFIC.

RAMP A, STAGING NOTES: STAGE IIIB

WORK IN THIS STAGE CONSISTS OF CONSTRUCTING ALL REMAINING WORK FOR SN 016-2573, ALONG THE NORTH HALF OF THE UNDERPASS, INCLUDING ABUTMENT REPAIRS AS SHOWN IN THE PLANS AND TYPICAL SECTIONS.

SHIFT RAMP A TRAFFIC INTO THE SUBSTAGE B CONFIGURATION AS SHOWN ON THE PLANS INCLUDING THE TEMPORARY CONCRETE BARRIER ADJACENT TO RAMP TRAFFIC.

RAMP A, STAGING NOTES: STAGE IIIC

WORK IN THIS STAGE CONSISTS OF REPLACEMENT OF THE REMAINING EXISTING PPC DECK BEAMS ALONG SN-016-2573.

RAMP A TRAFFIC WILL BE CLOSED TO TRAFFIC DURING THE HOURS SPECIFIED IN THE SPECIAL PROVISIONS. ALL RAMP A TRAFFIC WILL BE DETOURED AS SHOWN IN THE PLANS. SEE LOCAL DETOUR ROUTING.

RAMP D, STAGING NOTES: STAGE IIIA

WORK IN THIS STAGE CONSISTS OF CONSTRUCTING THE REMAINDER OF THE SUBSTRUCTURE FOR SN 016-1323 ON THE EAST SIDE OF RAMP D, INCLUDING PORTIONS OF THE APPROACH MSE WALL AND TEMPORARY GEOTEXTILE WALL AS SHOWN IN THE PLANS.

SHIFT THE 2-LANE RAMP D TRAFFIC INTO 11 FOOT LANES INTO THE STAGE IIIA LANE CONFIGURATION AS SHOWN ON THE PLANS INCLUDING INSTALLATION OF TEMPORARY CONCRETE BARRIER ADJACENT TO RAMP TRAFFIC.

RAMP D, STAGING NOTES: STAGE IIIB

WORK IN THIS STAGE CONSISTS OF CONSTRUCTING THE REMAINDER OF THE SUBSTRUCTURE FOR SN 016-1323 ON THE WEST SIDE OF RAMP D, INCLUDING PORTIONS OF THE APPROACH MSE WALL AND TEMPORARY GEOTEXTILE WALL AS SHOWN IN THE PLANS.

SHIFT THE 2-LANE RAMP D TRAFFIC INTO 11 FOOT LANES INTO THE STAGE IIIB LANE CONFIGURATION AS SHOWN ON THE PLANS INCLUDING RELOCATION OF TEMPORARY CONCRETE BARRIER ADJACENT TO RAMP TRAFFIC.

RAMP D, STAGING NOTES: STAGE IIIC

WORK IN THIS STAGE CONSISTS OF SETTING THE BEAMS FOR SN 016-1323.

A FULL CLOSURE OF RAMP D TRAFFIC DURING THE HOURS SPECIFIED IN THE SPECIAL PROVISIONS WILL BE PERMITTED.

RAMP C, STAGING NOTES: STAGE IV

WORK IN THIS STAGE CONSISTS OF CONSTRUCTING THE REMAINDER OF THE PROPOSED EMBANKMENT OVER SN 016-2573 AND CONSTRUCT THE PROTECTIVE CONCRETE SURFACE.

ALL TRAFFIC WILL BE IN THE ULTIMATE LANE CONFIGURATION

FILE NAME = 8FILES



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| USER NAME = rge11 | DESIGNED - | REVISED - |
| PLOT SCALE = 200.0000' / 1" = | DRAWN - | REVISED - |
| PLOT DATE = 3/25/2013 | CHECKED - | REVISED - |
| | DATE - | REVISED - |


STATE OF ILLINOIS
DEPARTMENT OF TRANSPORTATION

| STAGING AND TRAFFIC CONTROL STAGING NOTES | | | | |
|--|-----------|----|--------|--------------|
| SCALE: | SHEET NO. | OF | SHEETS | STA. TO STA. |

| F.A.I. RTÉ. | SECTION | COUNTY | TOTAL SHEETS | SHEET NO. |
|--------------------|--------------|--------|---|-----------|
| 90/94 | 0303-474HB-R | COOK | 368 | 61 |
| CONTRACT NO. 60F63 | | | FED. ROAD DIST. NO. 1 ILLINOIS FED. AID PROJECT | |




| TEMP RAMP D | TEMP RAMP C (STG 1) | TEMP RAMP C (STG 2) |
|--|--|--|
| PROP. CURVE PR.MOT2B1-1 PI STA. = 103+43.25 $\Delta = 62^\circ 54' 36''$ (LT) D = 17° 06' 12" R = 335.00' T = 204.93' L = 367.83' E = 57.71' e = ----- T.R. = ----- S.E. RUN = ----- P.C. STA = 101+38.32 P.T. STA = 105+06.15 | PROP. CURVE PR.MOT1-1 PI STA. = 204+07.64 $\Delta = 19^\circ 35' 58''$ (LT) D = 19° 02' 07" R = 301.00' T = 51.99' L = 102.97' E = 4.46' e = ----- T.R. = ----- S.E. RUN = ----- P.C. STA = 203+55.65 P.T. STA = 204+58.62 | PROP. CURVE PR.MOT2-1 PI STA. = 302+20.91 $\Delta = 18^\circ 40' 21''$ (RT) D = 20° 06' 14" R = 285.00' T = 46.86' L = 92.88' E = 3.83' e = ----- T.R. = ----- S.E. RUN = ----- P.C. STA = 301+74.05 P.T. STA = 302+66.93 |
| | PROP. CURVE PR.MOT1-2 PI STA. = 205+27.30 $\Delta = 27^\circ 06' 01''$ (RT) D = 20° 06' 14" R = 285.00' T = 68.69' L = 134.80' E = 8.16' e = ----- T.R. = ----- S.E. RUN = ----- P.C. STA = 204+58.62 P.T. STA = 205+93.42 | PROP. CURVE PR.MOT2-2 PI STA. = 305+07.64 $\Delta = 47^\circ 08' 49''$ (LT) D = 19° 02' 07" R = 301.00' T = 131.34' L = 247.68' E = 27.41' e = ----- T.R. = ----- S.E. RUN = ----- P.C. STA = 303+76.30 P.T. STA = 306+23.99 |
| | PROP. CURVE PR.MOT1-3 PI STA. = 206+81.09 $\Delta = 26^\circ 52' 14''$ (LT) D = 15° 36' 43" R = 367.00' T = 87.67' L = 172.12' E = 10.33' e = ----- T.R. = ----- S.E. RUN = ----- P.C. STA = 205+93.42 P.T. STA = 207+65.53 | PROP. CURVE PR.MOT2-3 PI STA. = 306+69.12 $\Delta = 17^\circ 59' 56''$ (RT) D = 20° 06' 14" R = 285.00' T = 45.14' L = 89.53' E = 3.55' e = ----- T.R. = ----- S.E. RUN = ----- P.C. STA = 306+23.99 P.T. STA = 307+13.52 |
| | PROP. CURVE PR.MOT1-4 PI STA. = 209+58.93 $\Delta = 55^\circ 34' 35''$ (LT) D = 15° 36' 43" R = 367.00' T = 193.40' L = 355.99' E = 47.84' e = ----- T.R. = ----- S.E. RUN = ----- P.C. STA = 207+65.53 P.T. STA = 211+21.52 | PROP. CURVE PR.MOT2-4 PI STA. = 309+35.64 $\Delta = 54^\circ 20' 08''$ (LT) D = 14° 25' 56" R = 397.00' T = 203.75' L = 376.49' E = 49.23' e = ----- T.R. = ----- S.E. RUN = ----- P.C. STA = 307+31.89 P.T. STA = 311+08.38 |
| | PROP. CURVE PR.MOT1-5 PI STA. = 215+12.59 $\Delta = 100^\circ 53' 27''$ (LT) D = 17° 44' 19" R = 323.00' T = 391.07' L = 568.76' E = 184.21' e = ----- T.R. = ----- S.E. RUN = ----- P.C. STA = 211+21.52 P.T. STA = 216+90.28 | PROP. CURVE C31 PI STA. = 314+11.90 $\Delta = 81^\circ 13' 10''$ (LT) D = 16° 11' 07" R = 354.00' T = 303.52' L = 501.81' E = 112.30' e = ----- T.R. = ----- S.E. RUN = ----- P.C. STA = 311+08.38 P.T. STA = 316+10.19 |
| | PROP. CURVE PR.MOT1-6 PI STA. = 218+93.67 $\Delta = 25^\circ 22' 33''$ (LT) D = 11° 14' 04" R = 510.00' T = 114.82' L = 225.87' E = 12.77' e = ----- T.R. = ----- S.E. RUN = ----- P.C. STA = 217+78.85 P.T. STA = 220+04.72 | PROP. CURVE C32 PI STA. = 318+72.80 $\Delta = 61^\circ 38' 13''$ (LT) D = 16° 22' 13" R = 350.00' T = 208.79' L = 376.52' E = 57.55' e = ----- T.R. = ----- S.E. RUN = ----- P.C. STA = 316+64.01 P.T. STA = 320+40.52 |

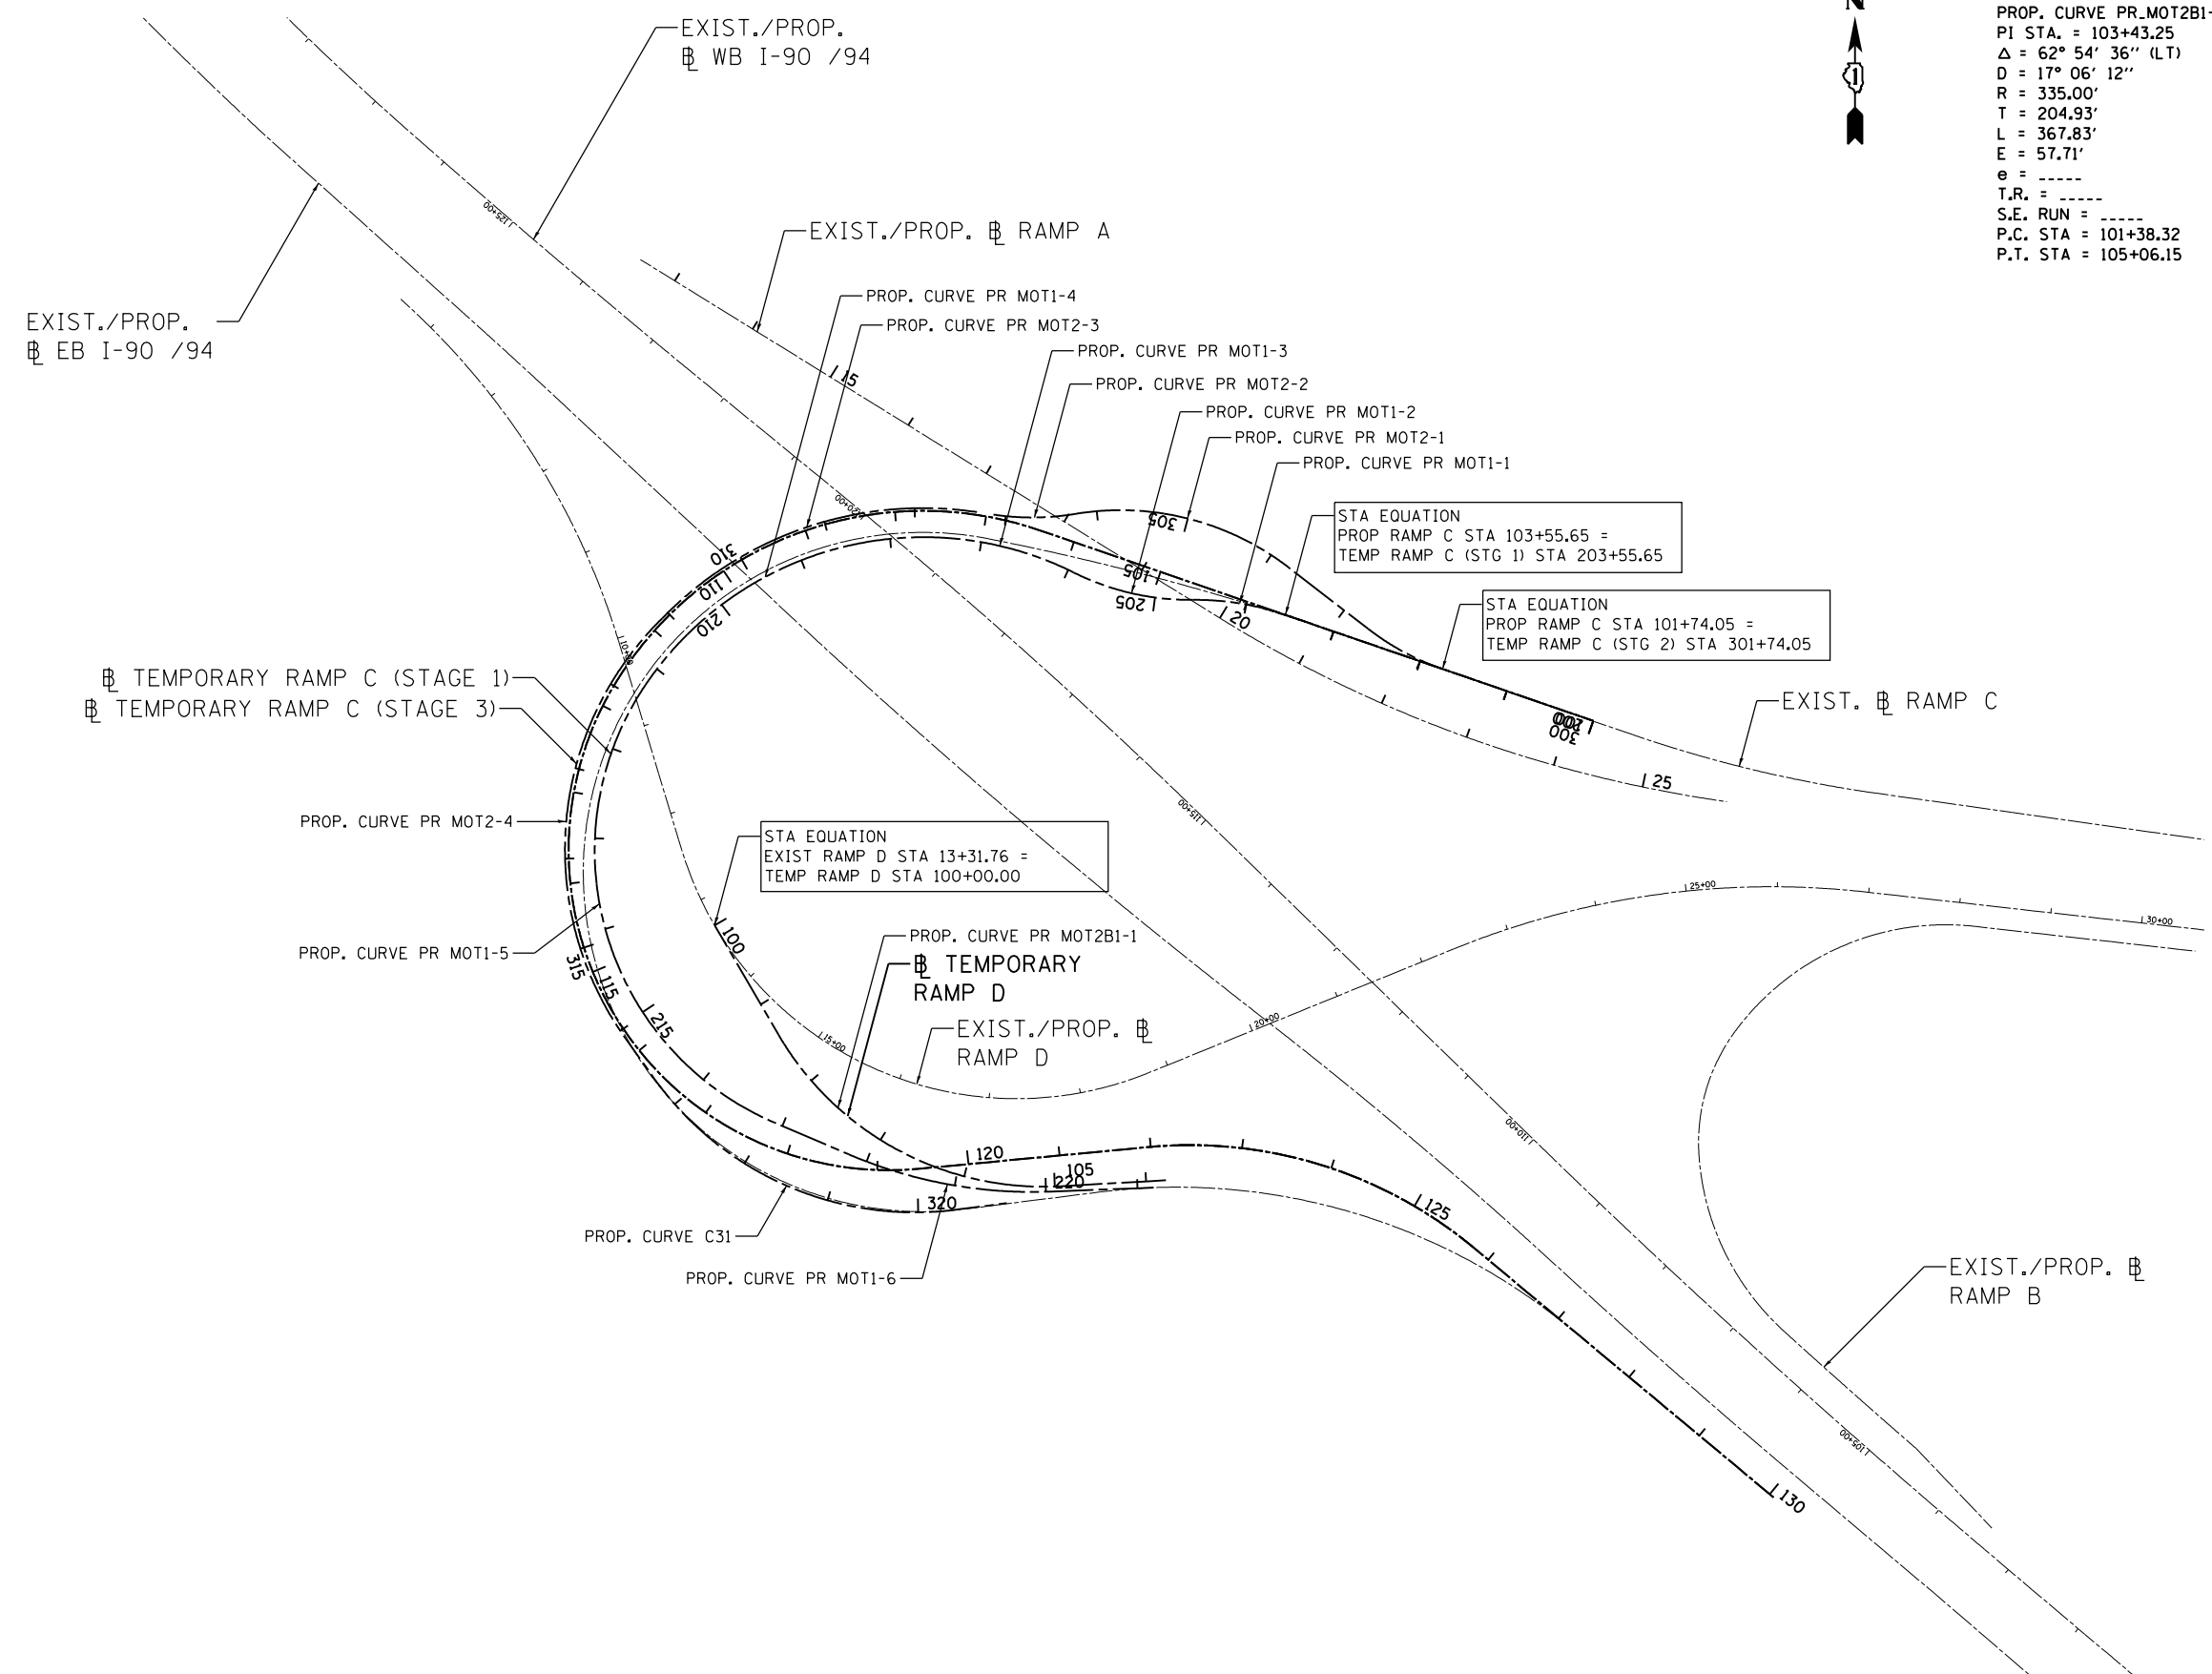

NOTES:
1. SEE ALIGNMENT AND TIES SHEETS FOR ADDITIONAL DETAILS.

FILE NAME = I:\7000 - 194 at Ohio Street\CADD\CADD_SHEETS\MOT\0160F63-ht-MOT-align.dgn

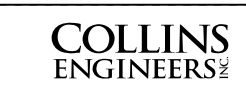

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| USER NAME = rge11 | DESIGNED - | REVISED - |
| PLOT SCALE = 200.0000' / in. | DRAWN - | REVISED - |
| PLOT DATE = 3/25/2013 | CHECKED - | REVISED - |
| | DATE - | REVISED - |


**STATE OF ILLINOIS
DEPARTMENT OF TRANSPORTATION**

**I-90/94 AT OHIO STREET
TEMPORARY RAMP ALIGNMENTS**

| | | | | | | |
|--------|-----------|----|--------|------|----|------|
| SCALE: | SHEET NO. | OF | SHEETS | STA. | TO | STA. |
|--------|-----------|----|--------|------|----|------|

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|---|--------------|--------|--------------|-----------|
| F.A.I. RTE. | SECTION | COUNTY | TOTAL SHEETS | SHEET NO. |
| 90/94 | 0303-474HB-R | COOK | 368 | 62 |
| CONTRACT NO. 60F63 | | | | |
| FED. ROAD DIST. NO. 1 ILLINOIS FED. AID PROJECT | | | | |

FILE NAME = \\collinsengr.com\1\data\1\posanden\1\posanden\DDCS\72000 - 134.ctb\Ohio Street\CAD\GADD SHEETS\MOT\DI60F63-ph-tt-stgprog-13g2b-detour.dgn

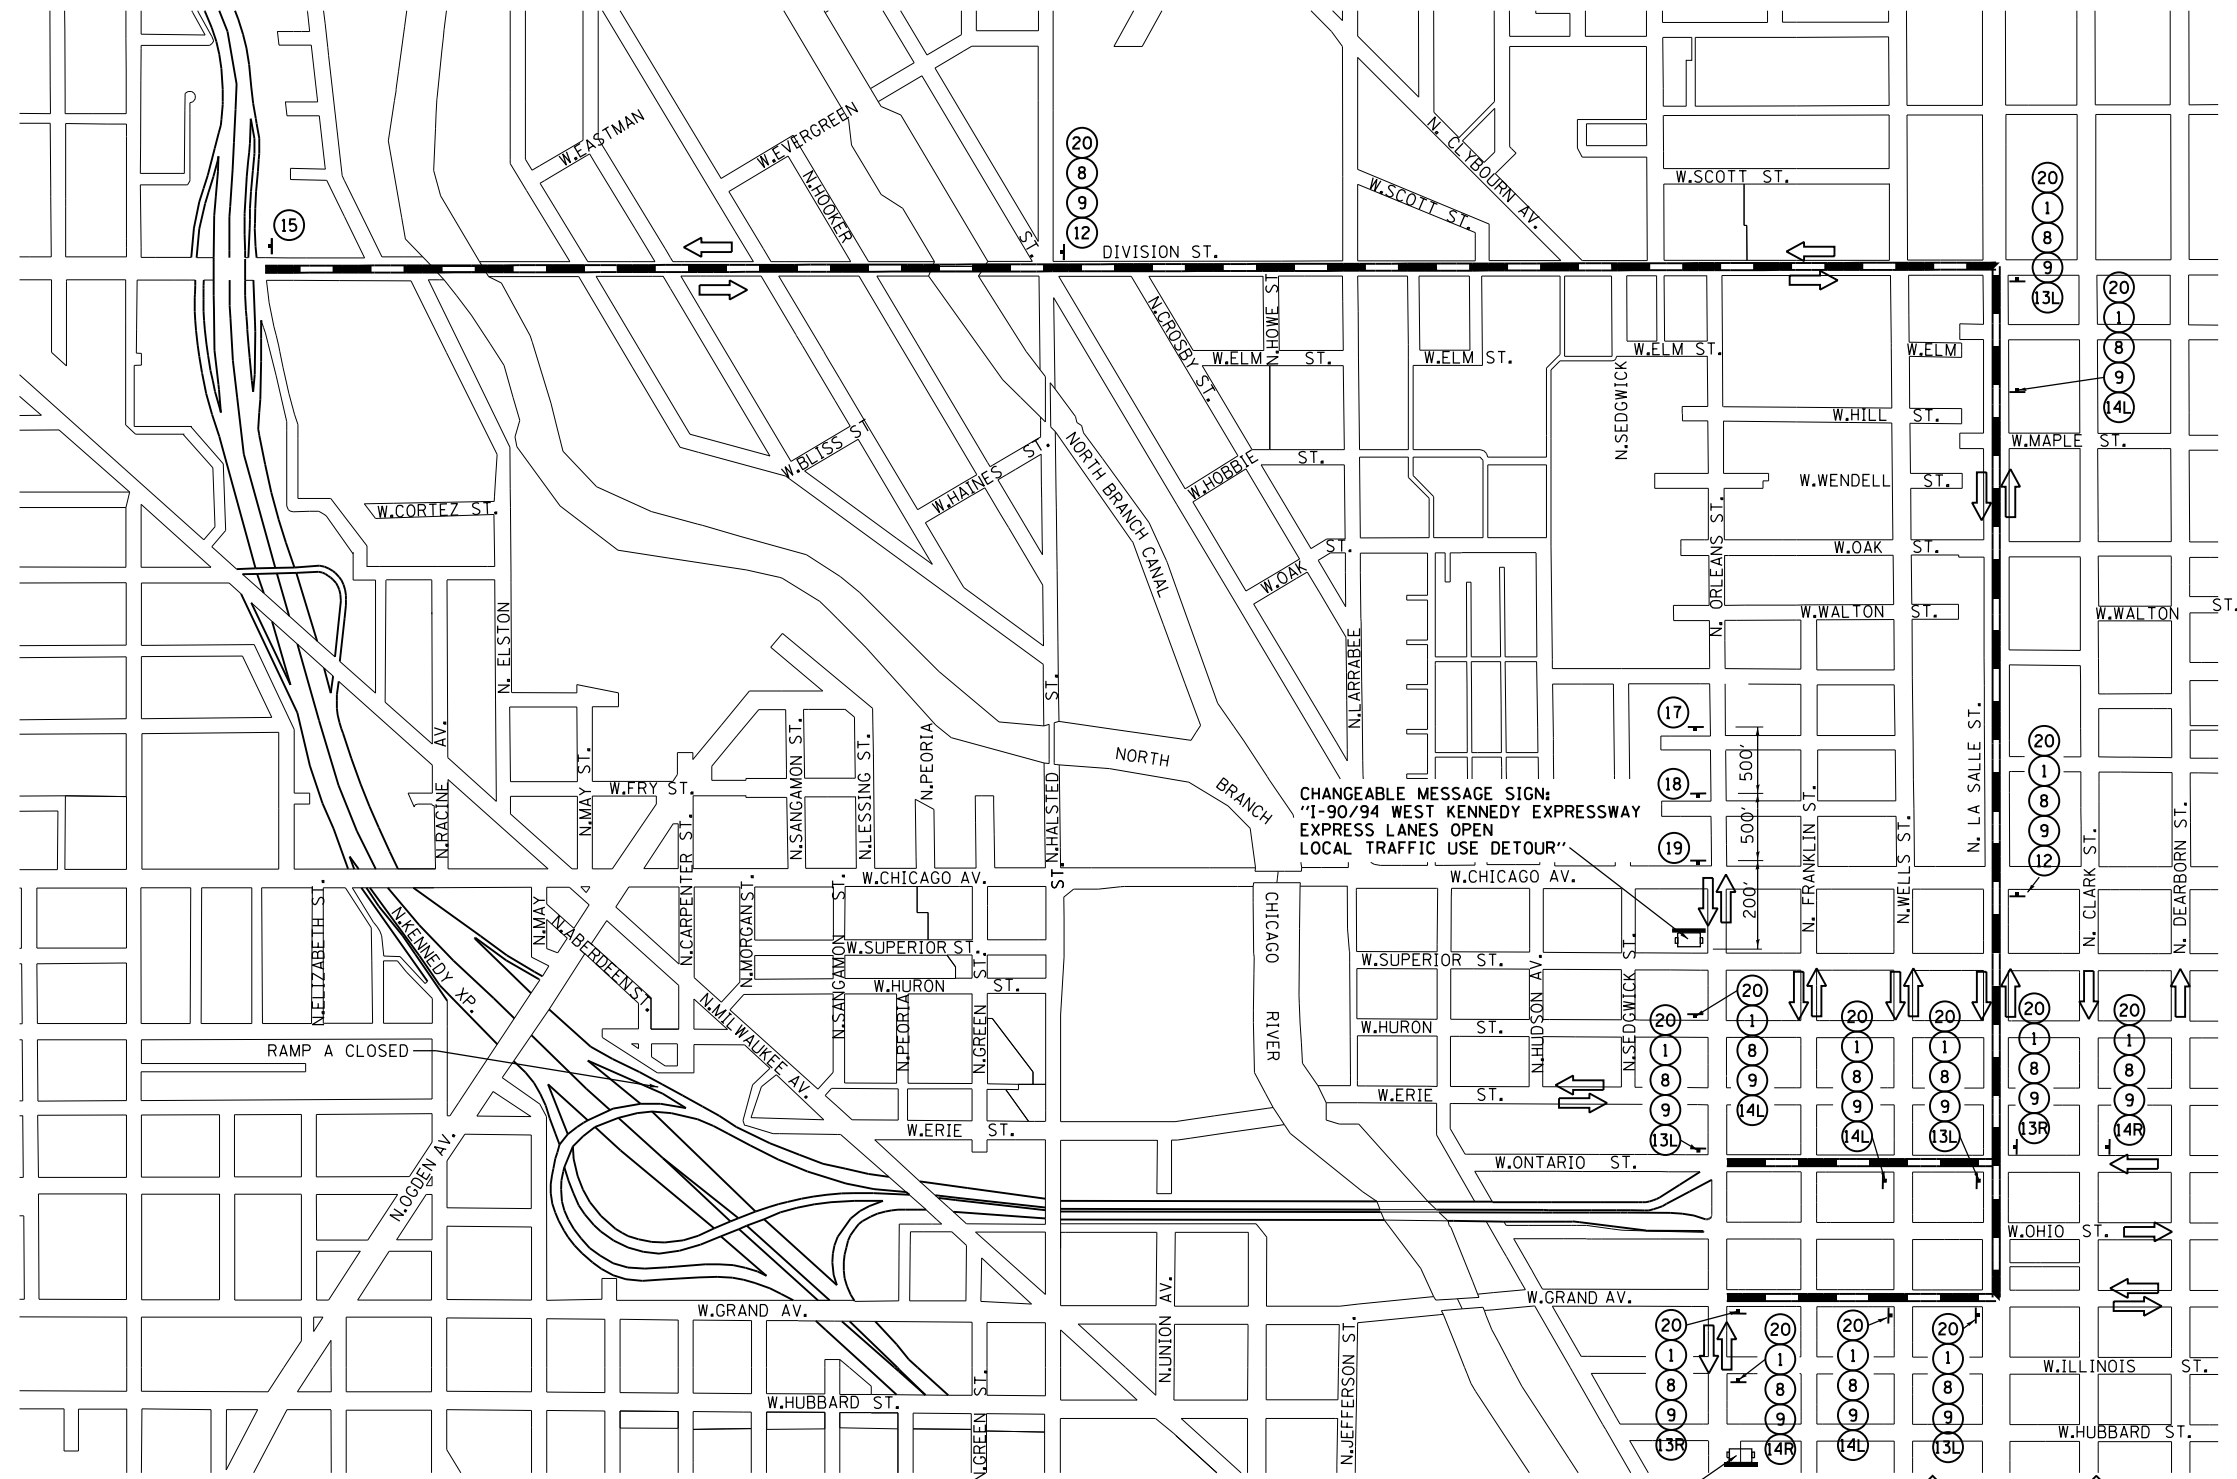

NOTES:

1. SEE STAGING NOTES AND SPECIAL PROVISIONS FOR DESCRIPTION OF WHEN THE DETOUR ROUTING SHALL BE IN EFFECT.
2. PLACEMENT AND SPACING OF SIGNS AND BARRICADES SHALL BE IN ACCORDANCE WITH TC-21 (TYPICAL MARKING FOR CLOSING STATE HIGHWAYS).
3. THE COST OF SUPPLYING, ERECTING AND MAINTAINING BARRICADES, WARNING LIGHTS AND SIGNS ALONG ALL DETOUR ROUTES SHALL BE INCLUDED IN THE CONTRACT COST OF TRAFFIC CONTROL AND PROTECTION (SPECIAL).
4. ALL DETOUR SIGNS SHALL HAVE AN ORANGE BACKGROUND WITH BLACK LETTERS.

CHANGEABLE MESSAGE SIGN:
"I-90/94 WEST KENNEDY EXPRESSWAY
EXPRESS LANES OPEN
LOCAL TRAFFIC USE DETOUR"

LOCAL
20 2412

NORTH
1 M3-1-2412

WEST
4 M3-4-2412

DETOUR
8 M4-8-2412

ROAD CLOSED TO THRU TRAFFIC
16

END DETOUR
15 M4-8A (24" x 18")

INTERSTATE 90 M1-40-2424

INTERSTATE 94 M1-40-2424

9

N ORLEANS STREET
10 M4-8-2412

W ONTARIO STREET
11 M6-3-2115

ROAD CLOSED AHEAD
12 M6-3-2115

DETOUR AHEAD
13L M6-1L-2115 13R M6-1R-2115


END DETOUR
14R M5-1R-2115 14L M5-1L-2115

LEGEND:

DETOUR ROUTE

TYPE III BARRICADE

| | | | | |
|---|--------------|--------|--------------|-----------|
| F.A.I. RTE. | SECTION | COUNTY | TOTAL SHEETS | SHEET NO. |
| 90/94 | 0303-474HB-R | COOK | 368 | 63 |
| CONTRACT NO. 60F63 | | | | |
| FED. ROAD DIST. NO. 1 ILLINOIS FED. AID PROJECT | | | | |

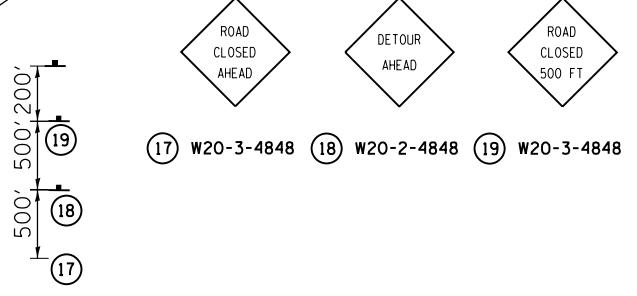


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PLOT SCALE = 100.0000' / 1" =
PLOT DATE = 3/25/2013

| | |
|------------|-----------|
| DESIGNED - | REVISED - |
| DRAWN - | REVISED - |
| CHECKED - | REVISED - |
| DATE - | REVISED - |

**STATE OF ILLINOIS
DEPARTMENT OF TRANSPORTATION**

**I-90/94 AT OHIO STREET
DETOUR ROUTE A**

SCALE: SHEET NO. OF SHEETS STA. TO STA.

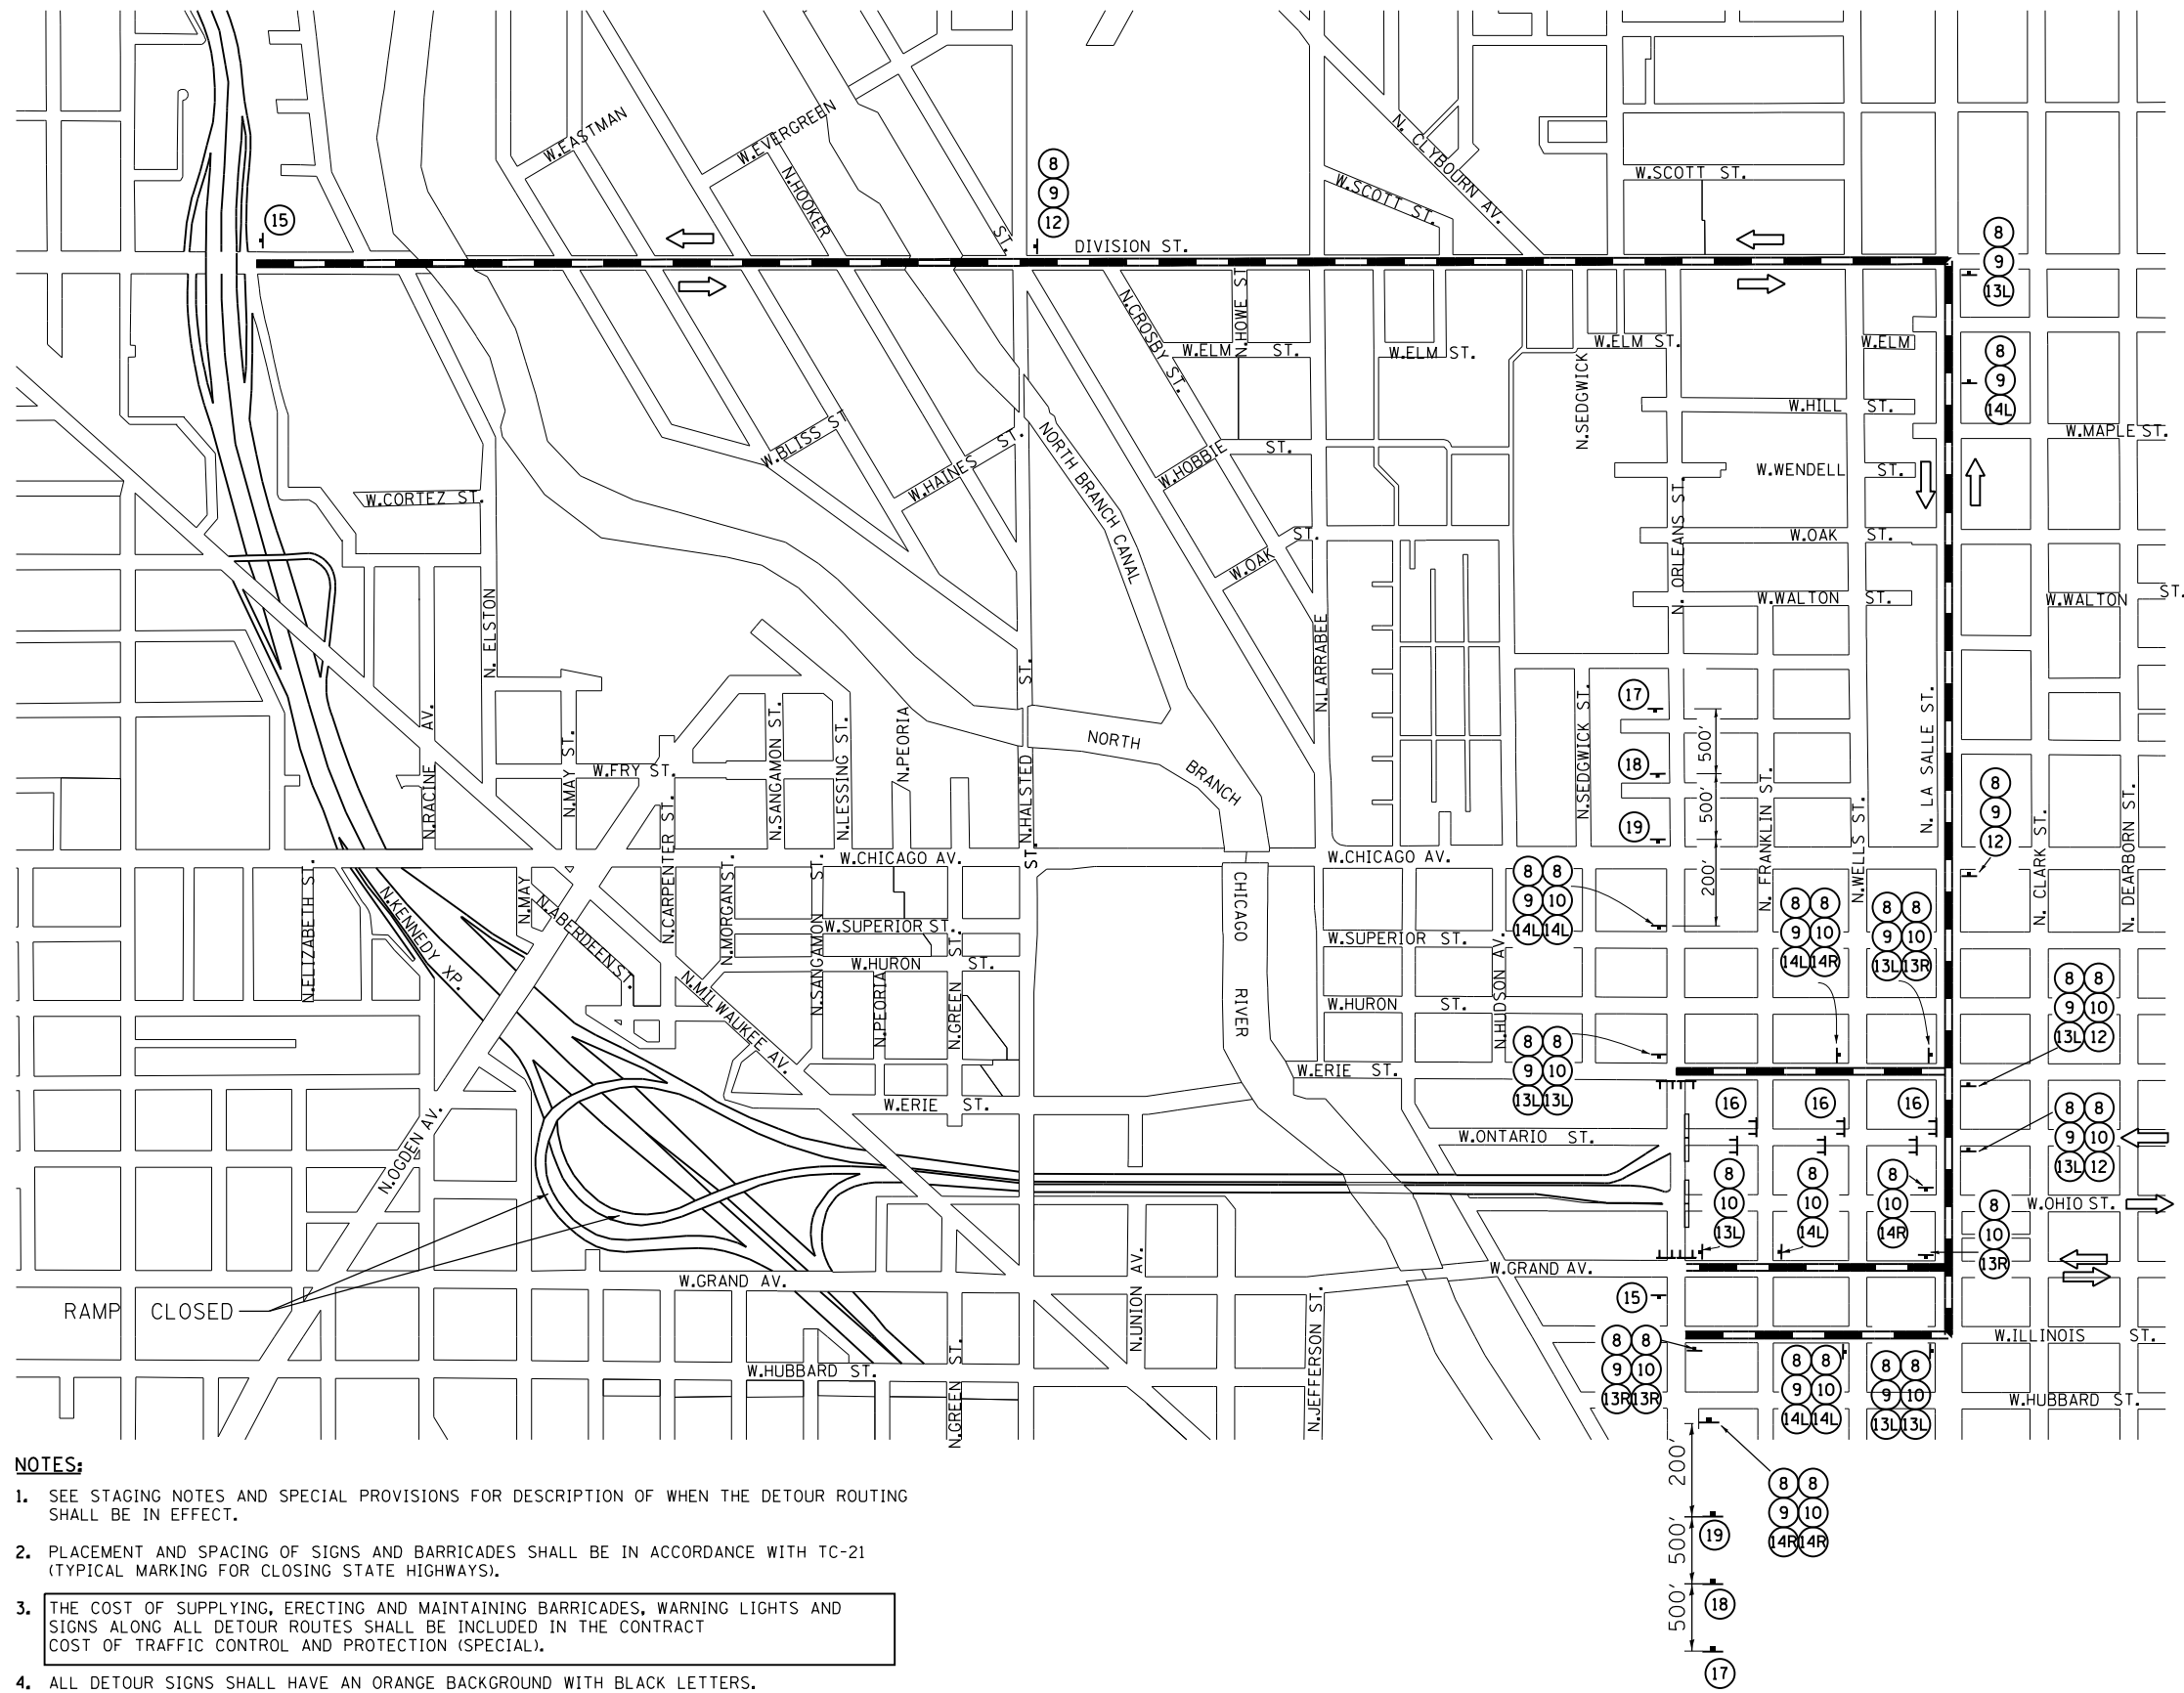

NORTH
 1 M3-1-2412

WEST
 4 M3-4-2412

DETOUR
 8 M4-8-2412

↑
 12 M6-3-2115

←
 13L M6-1L-2115

↶
 14R M5-1R-2115

ROAD CLOSED TO THRU TRAFFIC
 16

ROAD CLOSED AHEAD
 17 W20-3-4848

DETOUR AHEAD
 18 W20-2-4848

ROAD CLOSED 500 FT
 19 W20-3-4848

INTERSTATE 90 M1-40-2424
 INTERSTATE 94 M1-40-2424
 9

N ORLEANS STREET
 10 M4-8-2412

W ONTARIO STREET
 11 M6-3-2115

↷
 13R M6-1R-2115

↶
 14L M5-1L-2115

END DETOUR
 15 M4-8A (24" x 18")

- NOTES:**
- SEE STAGING NOTES AND SPECIAL PROVISIONS FOR DESCRIPTION OF WHEN THE DETOUR ROUTING SHALL BE IN EFFECT.
 - PLACEMENT AND SPACING OF SIGNS AND BARRICADES SHALL BE IN ACCORDANCE WITH TC-21 (TYPICAL MARKING FOR CLOSING STATE HIGHWAYS).
 - THE COST OF SUPPLYING, ERECTING AND MAINTAINING BARRICADES, WARNING LIGHTS AND SIGNS ALONG ALL DETOUR ROUTES SHALL BE INCLUDED IN THE CONTRACT COST OF TRAFFIC CONTROL AND PROTECTION (SPECIAL).
 - ALL DETOUR SIGNS SHALL HAVE AN ORANGE BACKGROUND WITH BLACK LETTERS.

LEGEND:

— DETOUR ROUTE

1 TYPE III BARRICADE

FILE NAME = 8FILES




COLLINS ENGINEERS

| | | |
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| USER NAME = r9e11 | DESIGNED - | REVISED - |
| PLOT SCALE = 100.0000' / 1" | DRAWN - | REVISED - |
| PLOT DATE = 3/25/2013 | CHECKED - | REVISED - |
| | DATE - | REVISED - |

**STATE OF ILLINOIS
 DEPARTMENT OF TRANSPORTATION**


| | | | |
|---|-----------|-----------|--------------|
| I-90/94 AT OHIO STREET DETOUR ROUTE B | | | |
| SCALE: | SHEET NO. | OF SHEETS | STA. TO STA. |

| | | | | |
|---|--------------|--------|--------------|-----------|
| F.A.I. RTE. | SECTION | COUNTY | TOTAL SHEETS | SHEET NO. |
| 90/94 | 0303-474HB-R | COOK | 368 | 64 |
| CONTRACT NO. 60F63 | | | | |
| FED. ROAD DIST. NO. 1 ILLINOIS FED. AID PROJECT | | | | |

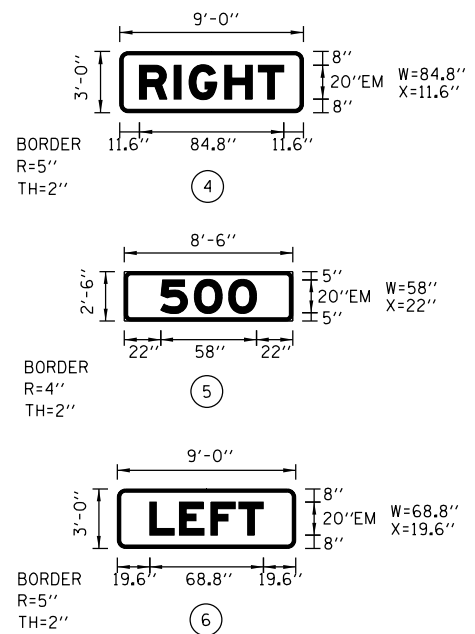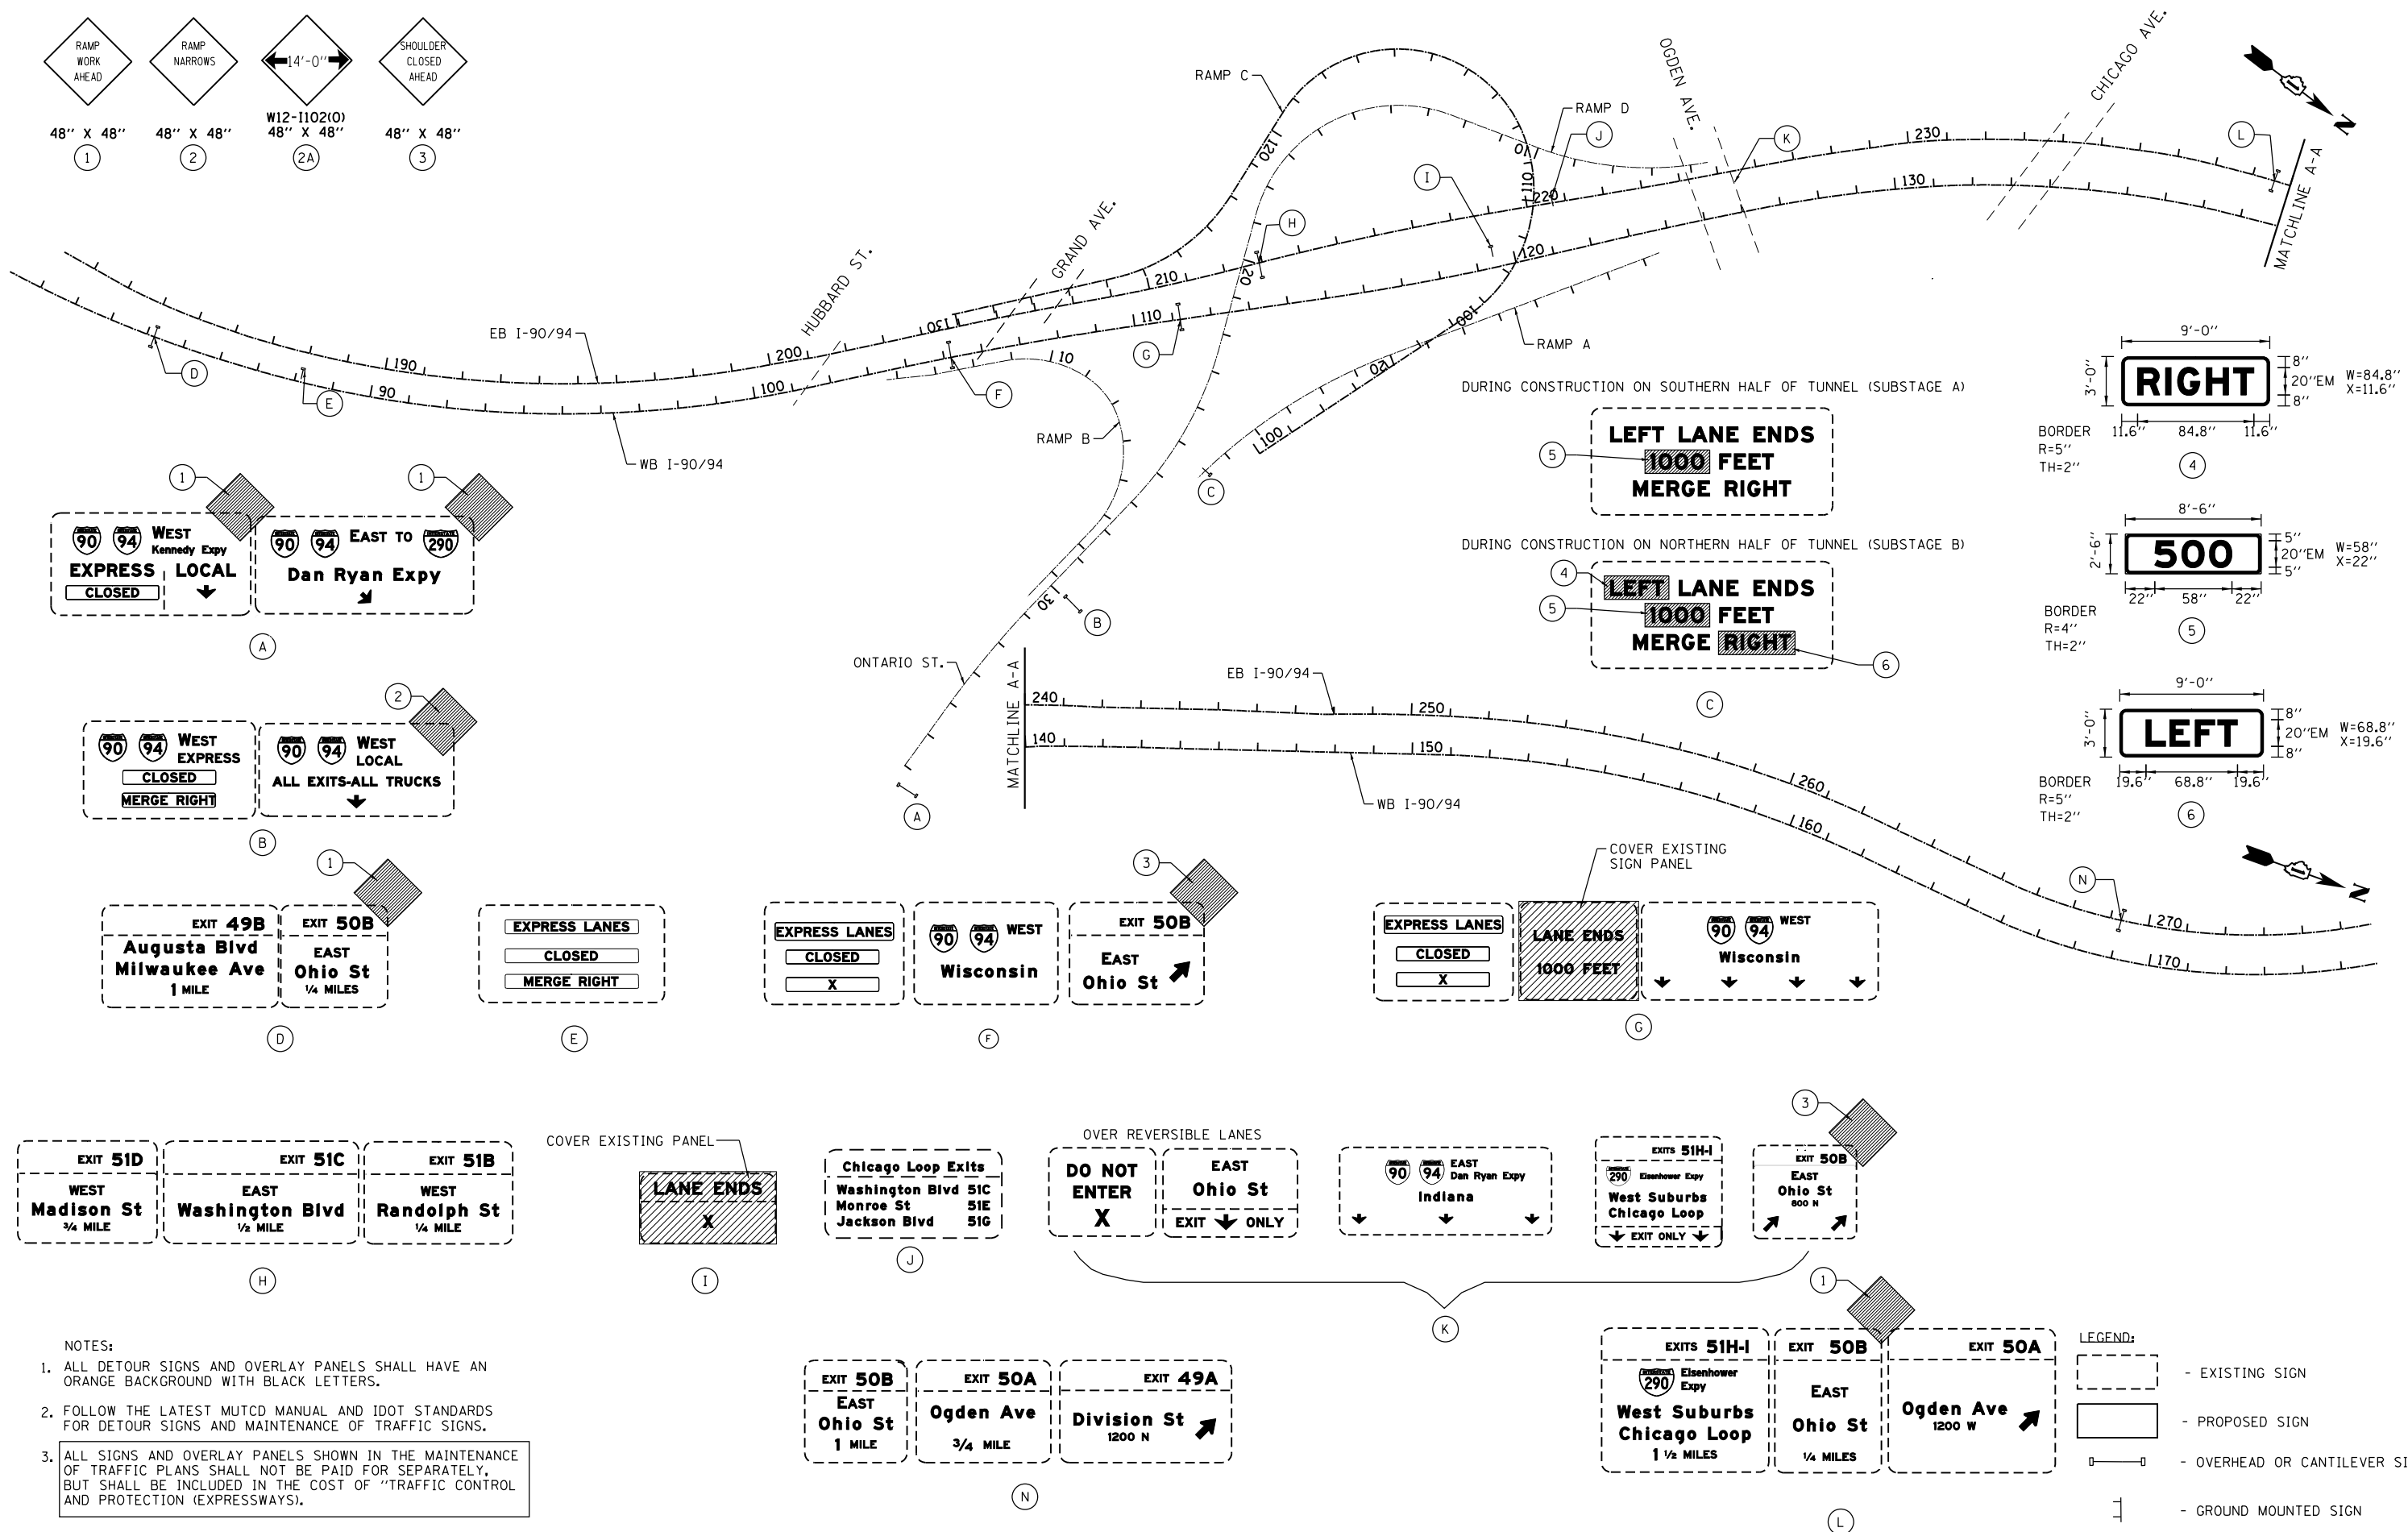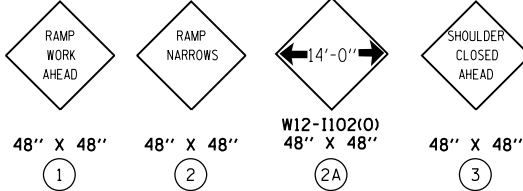

NOTES:

- ALL DETOUR SIGNS AND OVERLAY PANELS SHALL HAVE AN ORANGE BACKGROUND WITH BLACK LETTERS.
- FOLLOW THE LATEST MUTCD MANUAL AND IDOT STANDARDS FOR DETOUR SIGNS AND MAINTENANCE OF TRAFFIC SIGNS.
- ALL SIGNS AND OVERLAY PANELS SHOWN IN THE MAINTENANCE OF TRAFFIC PLANS SHALL NOT BE PAID FOR SEPARATELY, BUT SHALL BE INCLUDED IN THE COST OF "TRAFFIC CONTROL AND PROTECTION (EXPRESSWAYS).

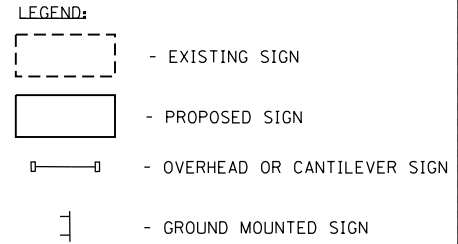

FILE NAME = I:\7000 - 194 at Ohio Street\CADD\CADD_SHEETS\MOT\1160F63-ht-staging-temp-sign-stage1.dgn

COLLINS ENGINEERS

USER NAME = rge11
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 PLOT DATE = 3/25/2013


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| DESIGNED - | REVISED - |
| DRAWN - | REVISED - |
| CHECKED - | REVISED - |
| DATE - | REVISED - |

**STATE OF ILLINOIS
 DEPARTMENT OF TRANSPORTATION**


**STAGING AND TRAFFIC CONTROL
 TEMPORARY SIGNING PLAN
 STAGE I**

SCALE: SHEET NO. OF SHEETS STA. TO STA.

| | | | | |
|---|----------------------|-------------|------------------|--------------|
| F.A.I. R.T.E. 90/94 | SECTION 0303-474HB-R | COUNTY COOK | TOTAL SHEETS 368 | SHEET NO. 65 |
| CONTRACT NO. 60F63 | | | | |
| FED. ROAD DIST. NO. 1 ILLINOIS FED. AID PROJECT | | | | |

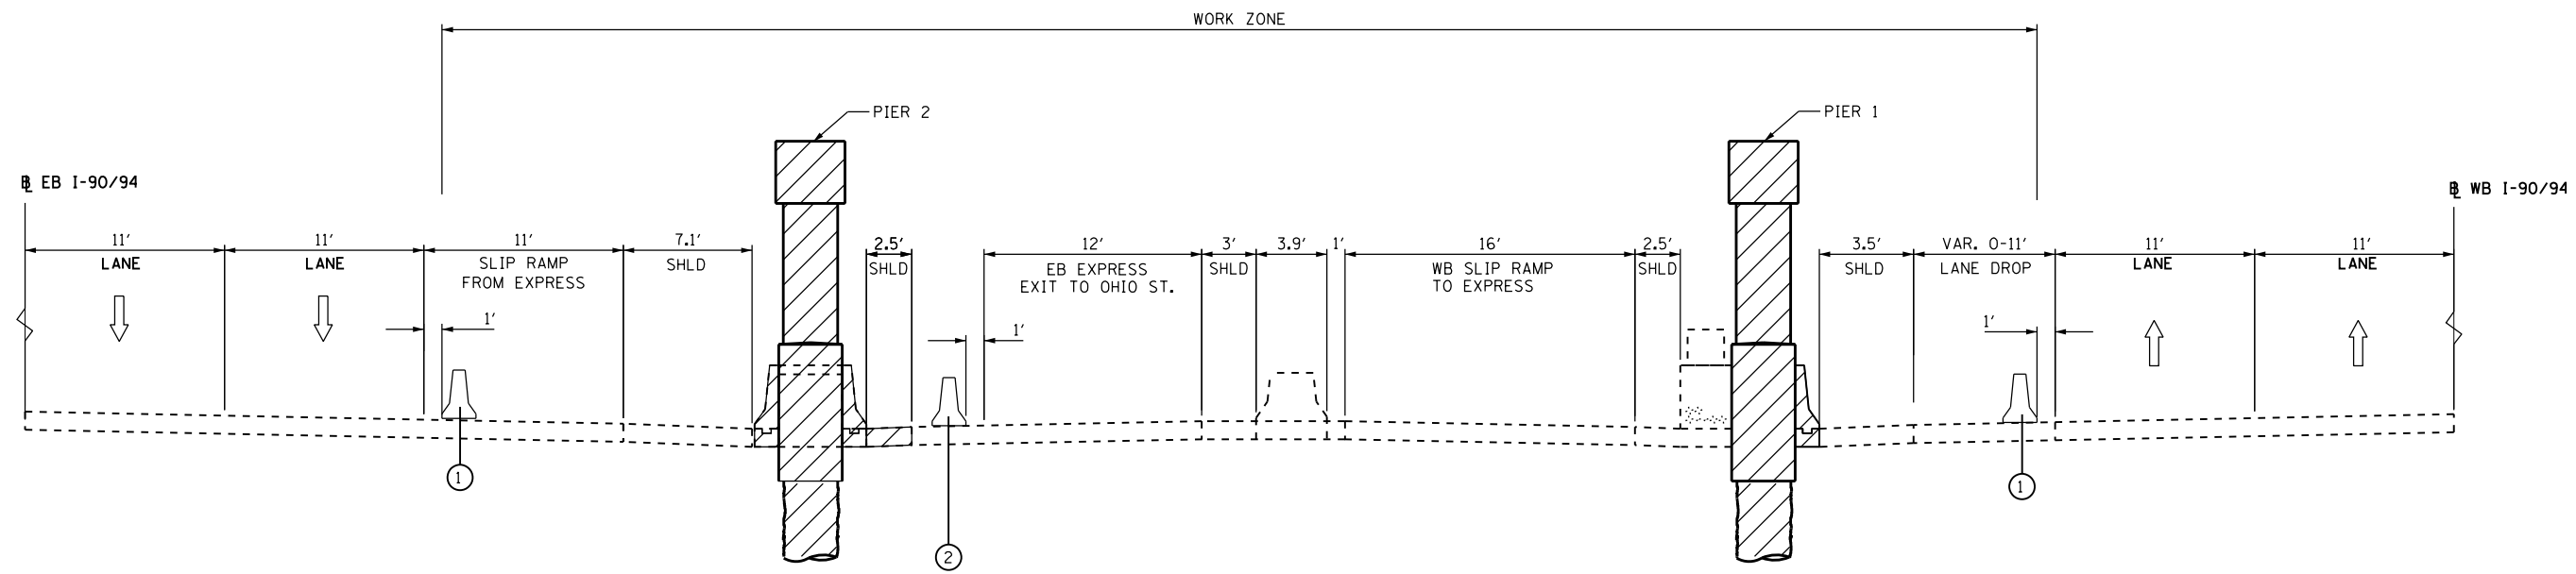

TYPICAL SECTION - SUBSTAGE 1A (WORK ACTIVITIES)
I-90/ 94 (KENNEDY EXPRESSWAY)

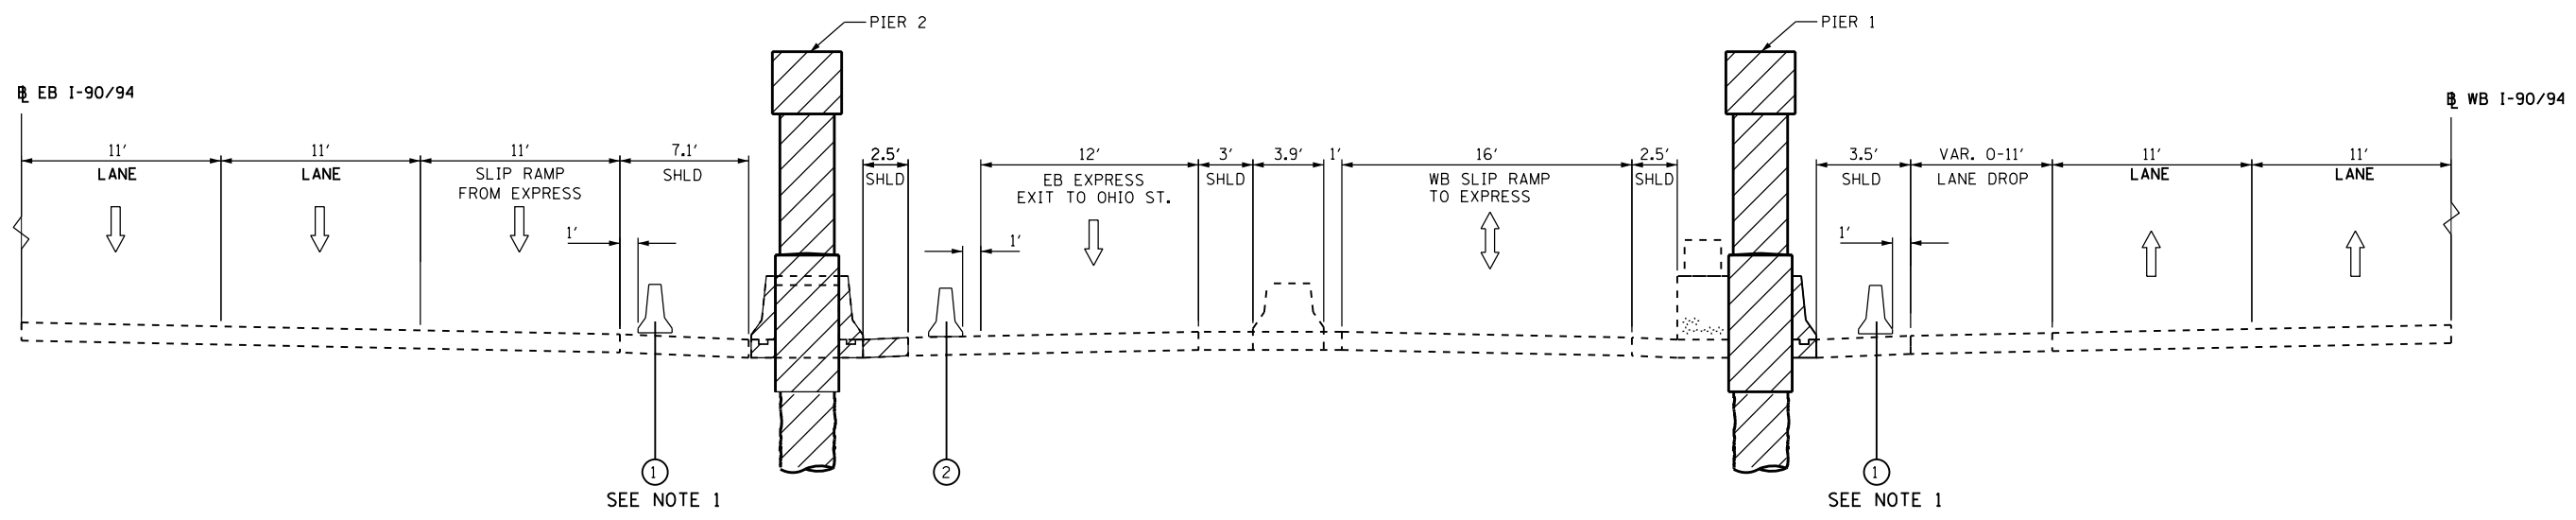

TYPICAL SECTION - SUBSTAGE 1B (NON-WORK ACTIVITIES)
I-90/ 94 (KENNEDY EXPRESSWAY)

NOTES:

- MOVABLE TRAFFIC BARRIER TO BE RELOCATED AS SHOWN IN SUBSTAGE 1B DURING NON-WORK ACTIVITIES. SEE SPECIAL PROVISION FOR WORK RESTRICTION HOURS.

PROPOSED LEGEND:

- ① MOVEABLE TRAFFIC BARRIER
- ② TEMPORARY CONCRETE BARRIER

FILE NAME = I:\7000 - 194 at Ohio Street\CADD\CADD_SHEETS\MOT\160663-hst-staging_tup-stg1-90-94.dgn



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|-----------------------------|------------|-----------|
| USER NAME = rge11 | DESIGNED - | REVISED - |
| PLOT SCALE = 10.0000' / in. | DRAWN - | REVISED - |
| PLOT DATE = 3/25/2013 | CHECKED - | REVISED - |
| | DATE - | REVISED - |

STATE OF ILLINOIS
DEPARTMENT OF TRANSPORTATION




STAGING AND TRAFFIC CONTROL
I-90/94 TYPICAL SECTIONS
STAGE I

| | | | | |
|--------|-----------|-----------|------|---------|
| SCALE: | SHEET NO. | OF SHEETS | STA. | TO STA. |
|--------|-----------|-----------|------|---------|

| F.A.I. RTE. | SECTION | COUNTY | TOTAL SHEETS | SHEET NO. |
|---|--------------|--------|--------------|-----------|
| 90/94 | 0303-474HB-R | COOK | 368 | 66 |
| CONTRACT NO. 60F63 | | | | |
| FED. ROAD DIST. NO. 1 ILLINOIS FED. AID PROJECT | | | | |

PROPOSED LEGEND:

- ① TEMPORARY PAVEMENT, 8"
- ② AGGREGATE SUBGRADE IMPROVEMENT, 4"
- ③ AGGREGATE SHOULDERS, TYPE B, 6"
- ④ TEMPORARY EROSION CONTROL SEEDING
- ⑤ TEMPORARY CONCRETE BARRIER
- ⑥ TEMPORARY CONCRETE BARRIER, RELOCATE
- ⑦ WET REFLECTIVE TEMPORARY TAPE TYPE III - LINE 4" WHITE
- ⑧ WET REFLECTIVE TEMPORARY TAPE TYPE III - LINE 4" YELLOW
- ⑨ WET REFLECTIVE TEMPORARY TAPE TYPE III - LINE 4" WHITE (2' DASH - 6' SKIP)
- ⑩ WET REFLECTIVE TEMPORARY TAPE TYPE III - LINE 8" WHITE

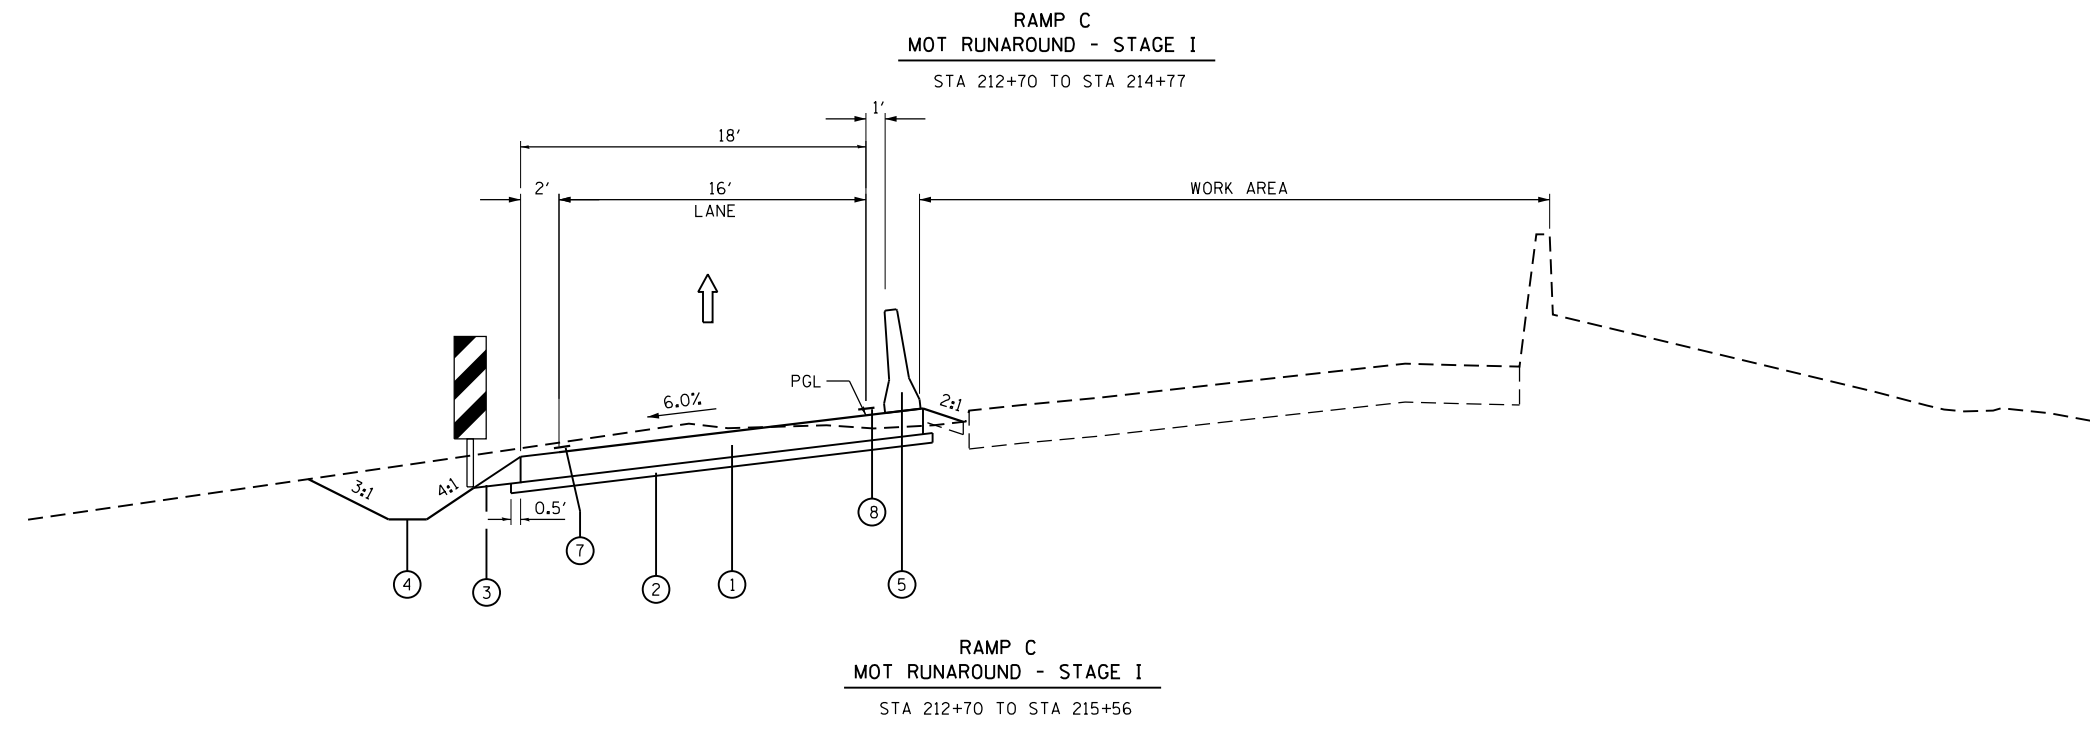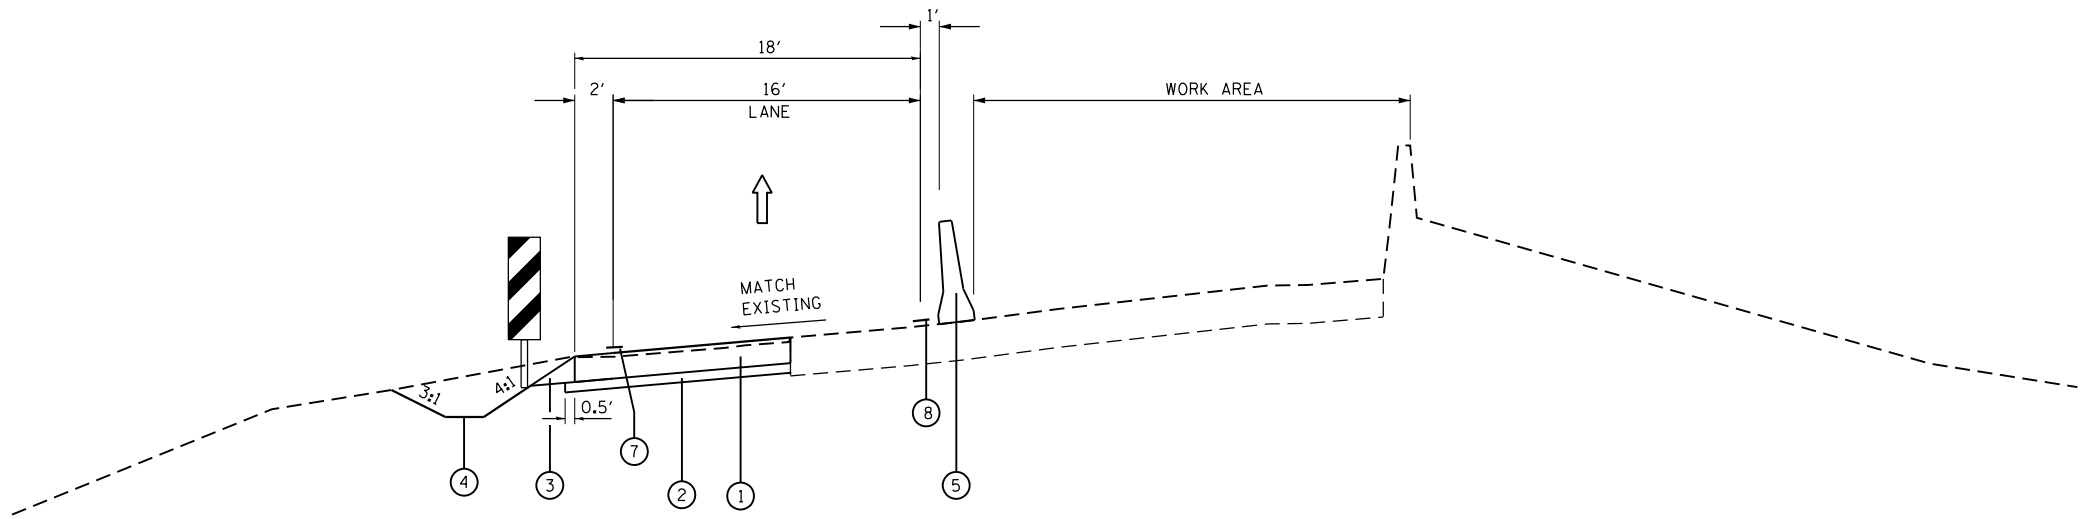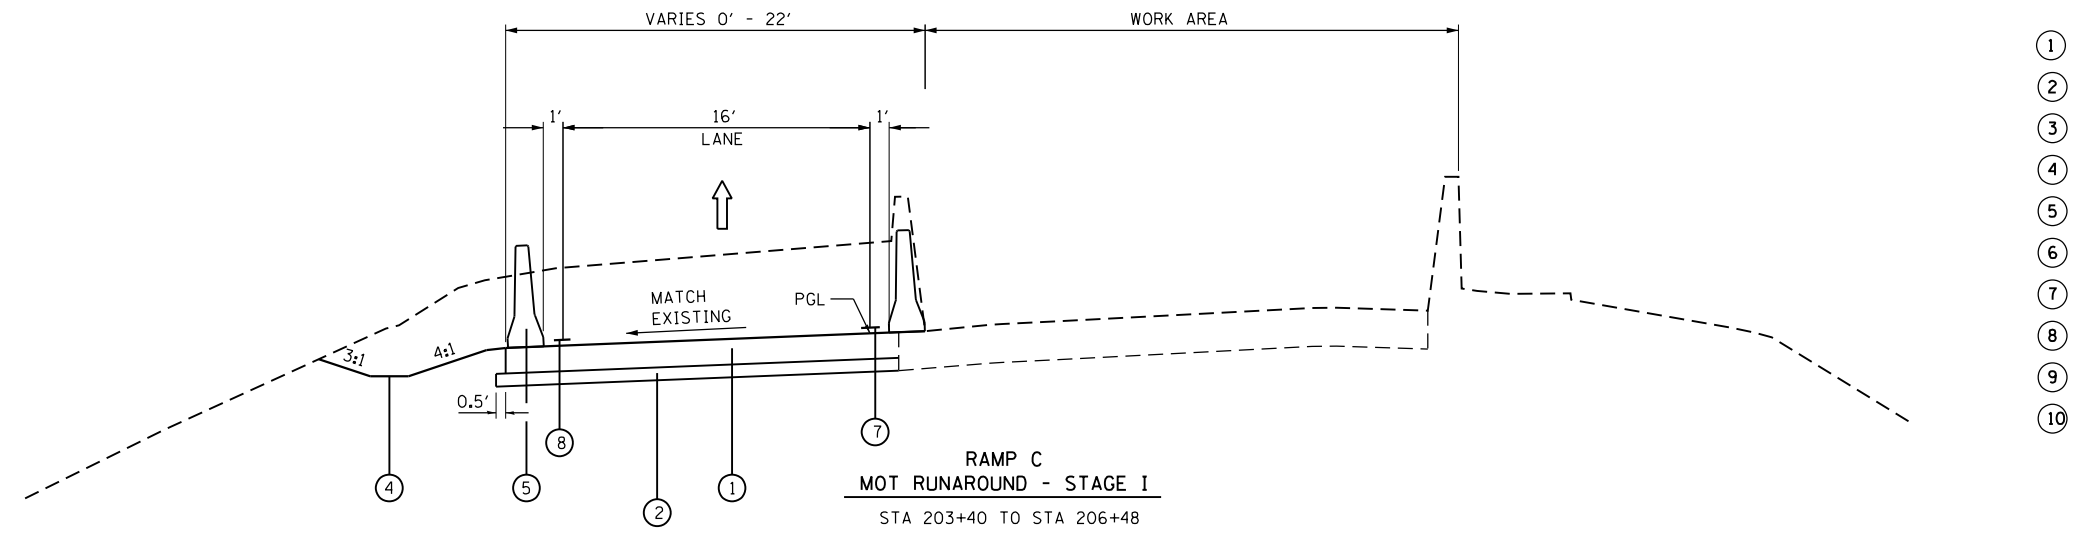

- NOTES:**
- SEE STRUCTURAL PLANS FOR STAGE I TYPICAL CROSS SECTIONS FROM STA 206+48 TO STA 212+70.
 - TEMPORARY PAVEMENT ON RAMP C SHALL BE ACCORDING TO THE PAVEMENT STRUCTURE DETAILS AND MIX DESIGN REQUIREMENTS ON THE TYPICAL SECTIONS
 - THE TEMPORARY CONCRETE BARRIER SHALL BE SECURED TO THE PAVEMENT USING THREE (3) ANCHORING PINS ON THE TRAFFIC SIDE OF THE BARRIER AT LOCATIONS WHERE A HAZARD OR SLOPE STEEPER THAN 1V:10H EXISTS WITHIN 3 FEET TO THE BARRIER. THE COST OF THIS WORK SHALL BE INCLUDED IN THE CONTRACT UNIT PRICE FOR "TEMPORARY CONCRETE BARRIER", OR "RELOCATE TEMPORARY CONCRETE BARRIER", AS APPLICABLE.
 - THE PAY ITEM, TEMPORARY PAVEMENT, 8 INCH, INCLUDES BOTH TEMPORARY PAVEMENT AND TEMPORARY SHOULDERS.

FILE NAME = I:\7000 - 194 at Ohio Street\ROAD\CADD SHEETS\MOT\160663-hst-staging_ttp-stg1-temp-runaround.dgn

COLLINS ENGINEERS

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|-----------------------------|------------|-----------|
| USER NAME = rge11 | DESIGNED - | REVISED - |
| PLOT SCALE = 10.0000' / in. | DRAWN - | REVISED - |
| PLOT DATE = 3/25/2013 | CHECKED - | REVISED - |
| | DATE - | REVISED - |

**STATE OF ILLINOIS
DEPARTMENT OF TRANSPORTATION**


**STAGING AND TRAFFIC CONTROL
RAMP C TYPICAL SECTIONS
STAGE I**

SCALE: SHEET NO. OF SHEETS STA. TO STA.


| F.A.I. RTE. | SECTION | COUNTY | TOTAL SHEETS | SHEET NO. |
|---|--------------|--------|--------------|-----------|
| 90/94 | 0303-474HB-R | COOK | 368 | 67 |
| CONTRACT NO. 60F63 | | | | |
| FED. ROAD DIST. NO. 1 ILLINOIS FED. AID PROJECT | | | | |

PROPOSED LEGEND:

- ① TEMPORARY PAVEMENT, 8"
- ② AGGREGATE SUBGRADE IMPROVEMENT, 4"
- ③ AGGREGATE SHOULDERS, TYPE B, 6"
- ④ TEMPORARY EROSION CONTROL SEEDING
- ⑤ TEMPORARY CONCRETE BARRIER
- ⑥ TEMPORARY CONCRETE BARRIER, RELOCATE
- ⑦ WET REFLECTIVE TEMPORARY TAPE TYPE III - LINE 4" WHITE
- ⑧ WET REFLECTIVE TEMPORARY TAPE TYPE III - LINE 4" YELLOW
- ⑨ WET REFLECTIVE TEMPORARY TAPE TYPE III - LINE 4" WHITE (2' DASH - 6' SKIP)
- ⑩ WET REFLECTIVE TEMPORARY TAPE TYPE III - LINE 8" WHITE

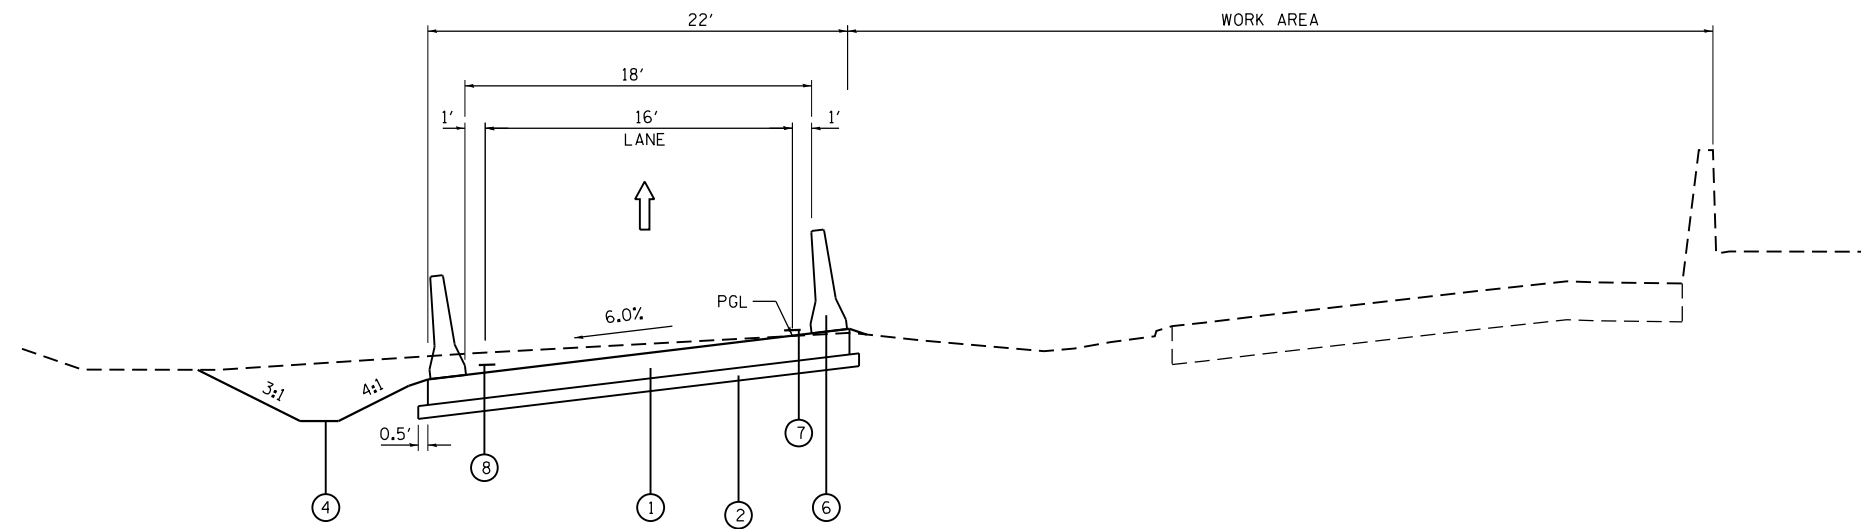

MOT RUNAROUND - STAGE I
STA 215+56 TO STA 216+96

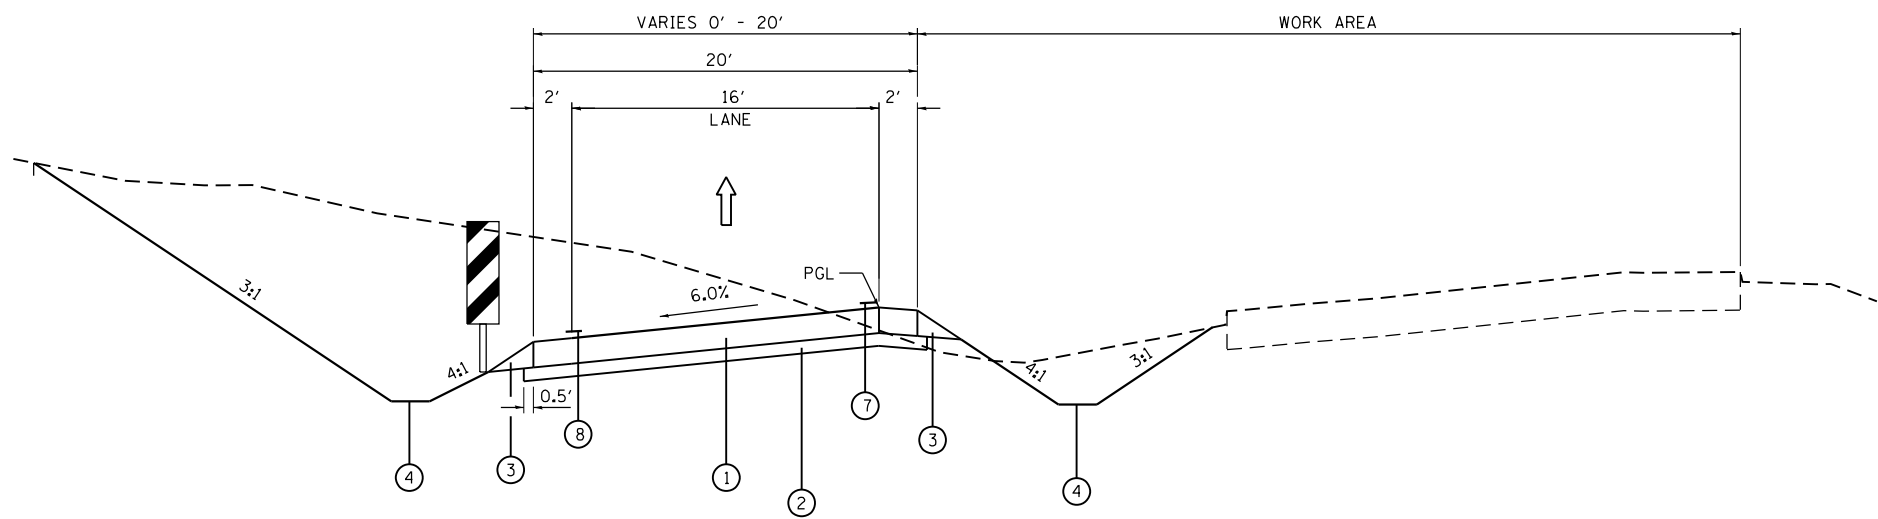

MOT RUNAROUND - STAGE I
STA 216+96 TO STA 221+18

NOTES:

1. SEE STRUCTURAL PLANS FOR STAGE I TYPICAL CROSS SECTIONS FROM STA 206+48 TO STA 212+70.
2. TEMPORARY PAVEMENT ON RAMP C SHALL BE ACCORDING TO THE PAVEMENT STRUCTURE DETAILS AND MIX DESIGN REQUIREMENTS ON THE TYPICAL SECTIONS
3. THE TEMPORARY CONCRETE BARRIER SHALL BE SECURED TO THE PAVEMENT USING THREE (3) ANCHORING PINS ON THE TRAFFIC SIDE OF THE BARRIER AT LOCATIONS WHERE A HAZARD OR SLOPE STEEPER THAN 1V:10H EXISTS WITHIN 3 FEET TO THE BARRIER. THE COST OF THIS WORK SHALL BE INCLUDED IN THE CONTRACT UNIT PRICE FOR "TEMPORARY CONCRETE BARRIER", OR "RELOCATE TEMPORARY CONCRETE BARRIER", AS APPLICABLE.
4. THE PAY ITEM, TEMPORARY PAVEMENT, 8 INCH, INCLUDES BOTH TEMPORARY PAVEMENT AND TEMPORARY SHOULDERS.

FILE NAME = I:\7000 - 194 at Ohio Street\CADD\CADD SHEETS\MOT\160663-ht-staging_ttp-stg1-temp-runaround.dgn



USER NAME = rge11
PLOT SCALE = 10.0000' / 1" IN.
PLOT DATE = 3/25/2013

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| DESIGNED - | REVISED - |
| DRAWN - | REVISED - |
| CHECKED - | REVISED - |
| DATE - | REVISED - |

STATE OF ILLINOIS
DEPARTMENT OF TRANSPORTATION


STAGING AND TRAFFIC CONTROL
RAMP C TYPICAL SECTIONS
STAGE I

SCALE: SHEET NO. OF SHEETS STA. TO STA.


| F.A.I. RTE. | SECTION | COUNTY | TOTAL SHEETS | SHEET NO. |
|--|--------------|--------|--------------|-----------|
| 90/94 | 0303-474HB-R | COOK | 368 | 68 |
| CONTRACT NO. 60F63 | | | | |
| <small>FED. ROAD DIST. NO. 1 ILLINOIS FED. AID PROJECT</small> | | | | |

PROPOSED LEGEND:

- ① TEMPORARY PAVEMENT, 8"
- ② AGGREGATE SUBGRADE IMPROVEMENT, 4"
- ③ AGGREGATE SHOULDERS, TYPE B, 6"
- ④ TEMPORARY EROSION CONTROL SEEDING
- ⑤ TEMPORARY CONCRETE BARRIER
- ⑥ TEMPORARY CONCRETE BARRIER, RELOCATE
- ⑦ WET REFLECTIVE TEMPORARY TAPE TYPE III - LINE 4" WHITE
- ⑧ WET REFLECTIVE TEMPORARY TAPE TYPE III - LINE 4" YELLOW
- ⑨ WET REFLECTIVE TEMPORARY TAPE TYPE III - LINE 4" WHITE (2' DASH - 6' SKIP)
- ⑩ WET REFLECTIVE TEMPORARY TAPE TYPE III - LINE 8" WHITE
- ⑪ TEMPORARY SOIL RETENTION

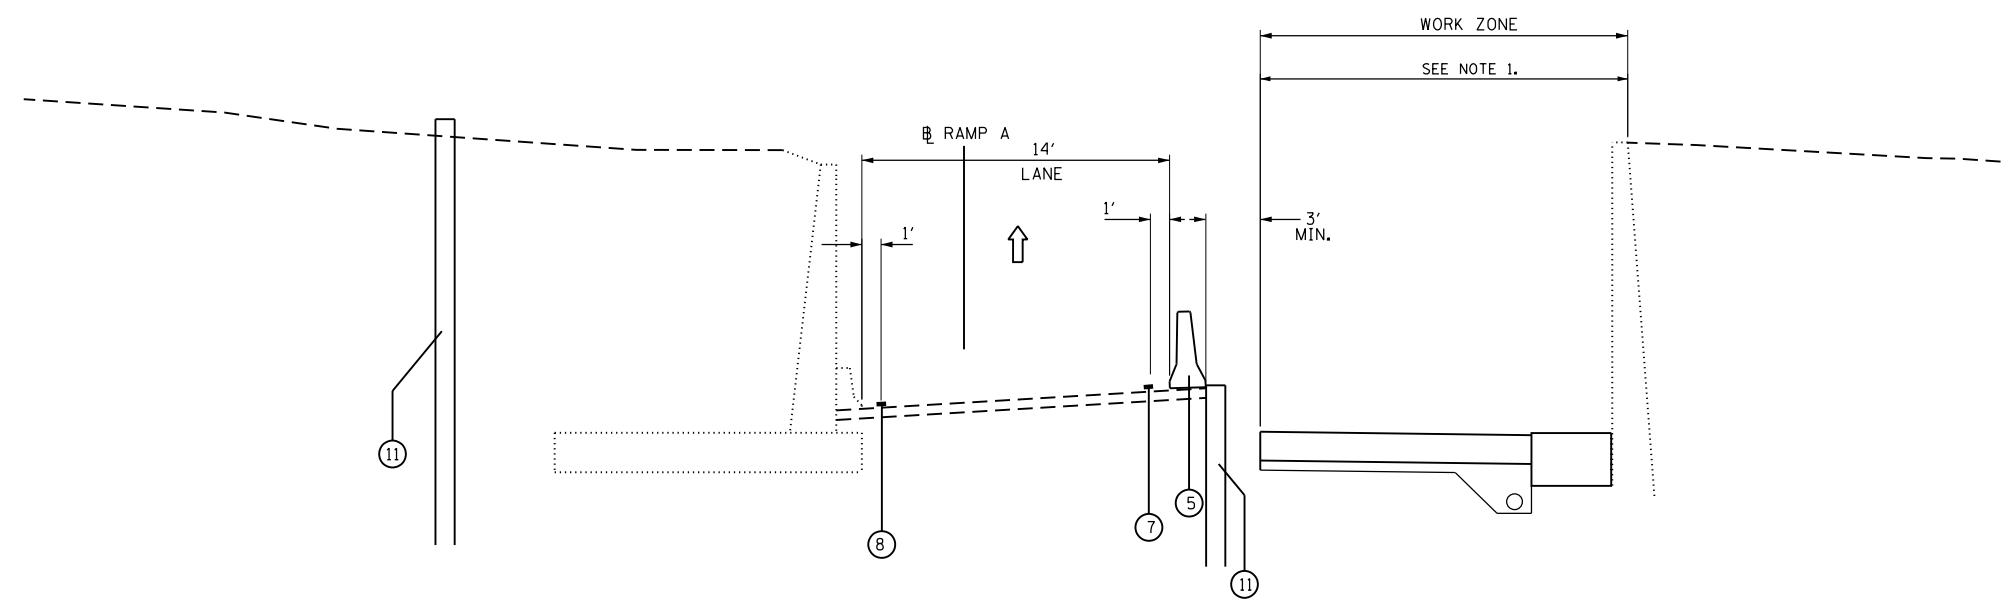

TYPICAL SECTION - SUBSTAGE A
RAMP A

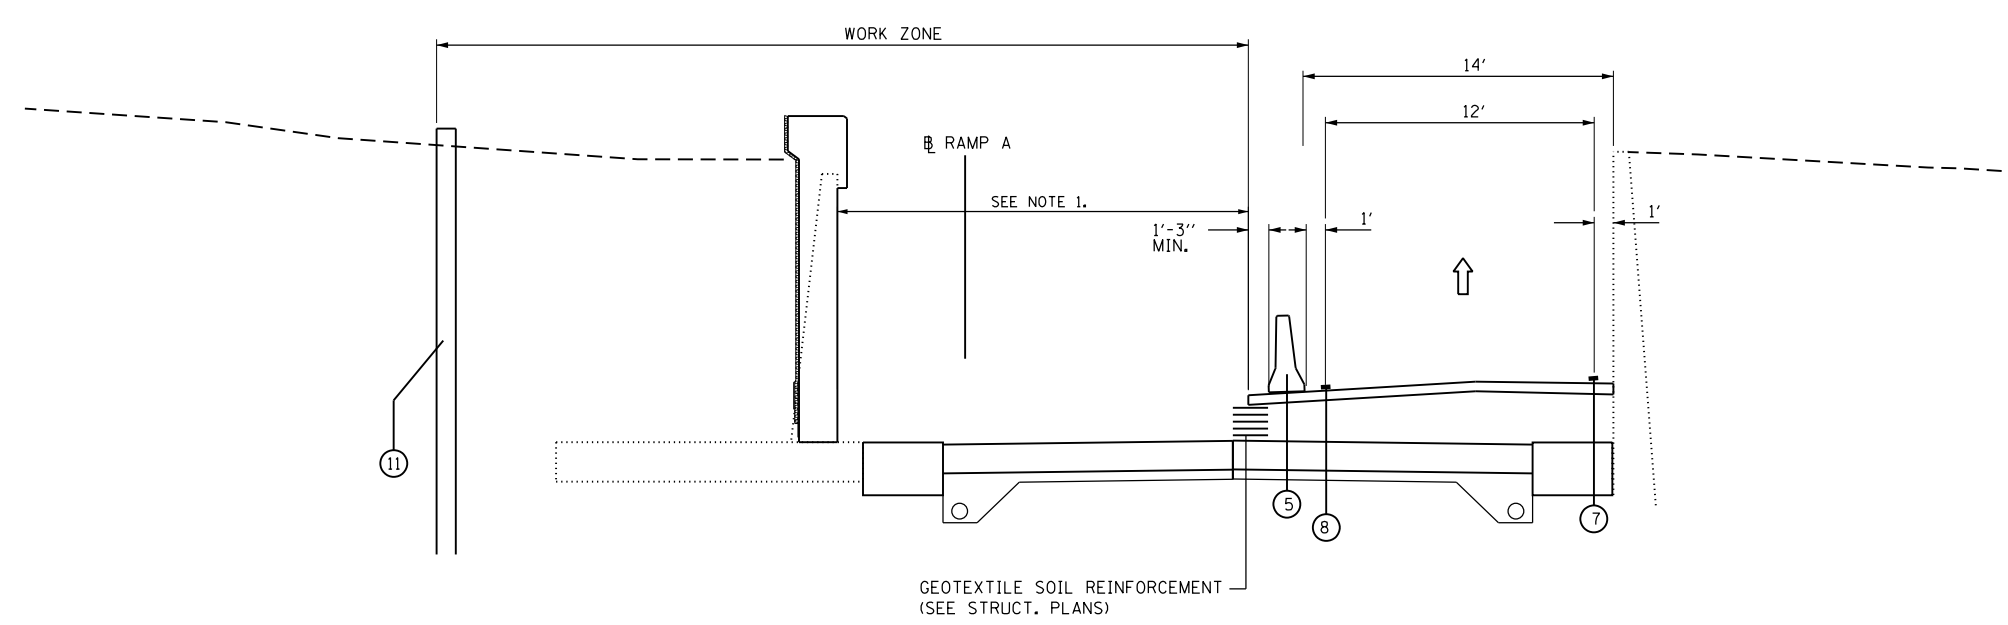

TYPICAL SECTION - SUBSTAGE B
RAMP A

NOTES:

1. SEE STRUCTURAL PLANS FOR LOCATION OF STAGE CONSTRUCTION LINE AND TEMP. SOIL RETENTION DETAILS.
2. RAMP C PAVEMENT AND SN 016-2573 SUPERSTRUCTURE OMITTED FOR CLARITY.
3. THE TEMPORARY CONCRETE BARRIER SHALL BE SECURED TO THE PAVEMENT USING THREE (3) ANCHORING PINS ON THE TRAFFIC SIDE OF THE BARRIER AT LOCATIONS WHERE A HAZARD OR SLOPE STEEPER THAN 1V:10H EXISTS WITHIN 3 FEET TO THE BARRIER. THE COST OF THIS WORK SHALL BE INCLUDED IN THE CONTRACT UNIT PRICE FOR "TEMPORARY CONCRETE BARRIER", OR "RELOCATE TEMPORARY CONCRETE BARRIER", AS APPLICABLE.
4. PRISMATIC BARRIER WALL REFLECTORS SHALL BE INSTALLED ON BOTH THE FACE AND THE TOP OF THE WALL ADJACENT TO TRAFFIC. THE COLOR OF THE REFLECTORS SHALL MATCH THE COLOR OF THE EDGELINES. SEE TRAFFIC CONTROL AND PROTECTION (EXPRESSWAY) SPECIAL PROVISION.

FILE NAME = I:\7000 - 194 at Ohio Street\CADD\CADD SHEETS\MOT\01606F63-ht-staging-tp-stg1-tunnel.dgn



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|-----------------------------|------------|-----------|
| USER NAME = rge11 | DESIGNED - | REVISED - |
| PLOT SCALE = 10.0000' / in. | DRAWN - | REVISED - |
| PLOT DATE = 3/25/2013 | CHECKED - | REVISED - |
| | DATE - | REVISED - |

**STATE OF ILLINOIS
DEPARTMENT OF TRANSPORTATION**



**STAGING AND TRAFFIC CONTROL
RAMP A TYPICAL SECTIONS
STAGE I**

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|--------|-----------|----|--------|------|---------|
| SCALE: | SHEET NO. | OF | SHEETS | STA. | TO STA. |
|--------|-----------|----|--------|------|---------|

| | | | | |
|---|--------------|--------|--------------------|-----------|
| F.A.I. RTE. | SECTION | COUNTY | TOTAL SHEETS | SHEET NO. |
| 90/94 | 0303-474HB-R | COOK | 368 | 69 |
| FED. ROAD DIST. NO. 1 ILLINOIS FED. AID PROJECT | | | CONTRACT NO. 60F63 | |

PROPOSED LEGEND:

- ① TEMPORARY PAVEMENT, 8"
- ② AGGREGATE SUBGRADE IMPROVEMENT, 4"
- ③ AGGREGATE SHOULDERS, TYPE B, 6"
- ④ TEMPORARY EROSION CONTROL SEEDING
- ⑤ TEMPORARY CONCRETE BARRIER
- ⑥ TEMPORARY CONCRETE BARRIER, RELOCATE
- ⑦ WET REFLECTIVE TEMPORARY TAPE TYPE III - LINE 4" WHITE
- ⑧ WET REFLECTIVE TEMPORARY TAPE TYPE III - LINE 4" YELLOW
- ⑨ WET REFLECTIVE TEMPORARY TAPE TYPE III - LINE 4" WHITE (2' DASH - 6' SKIP)
- ⑩ WET REFLECTIVE TEMPORARY TAPE TYPE III - LINE 8" WHITE
- ⑪ TEMPORARY SOIL RETENTION. SEE STRUCTURAL PLANS.

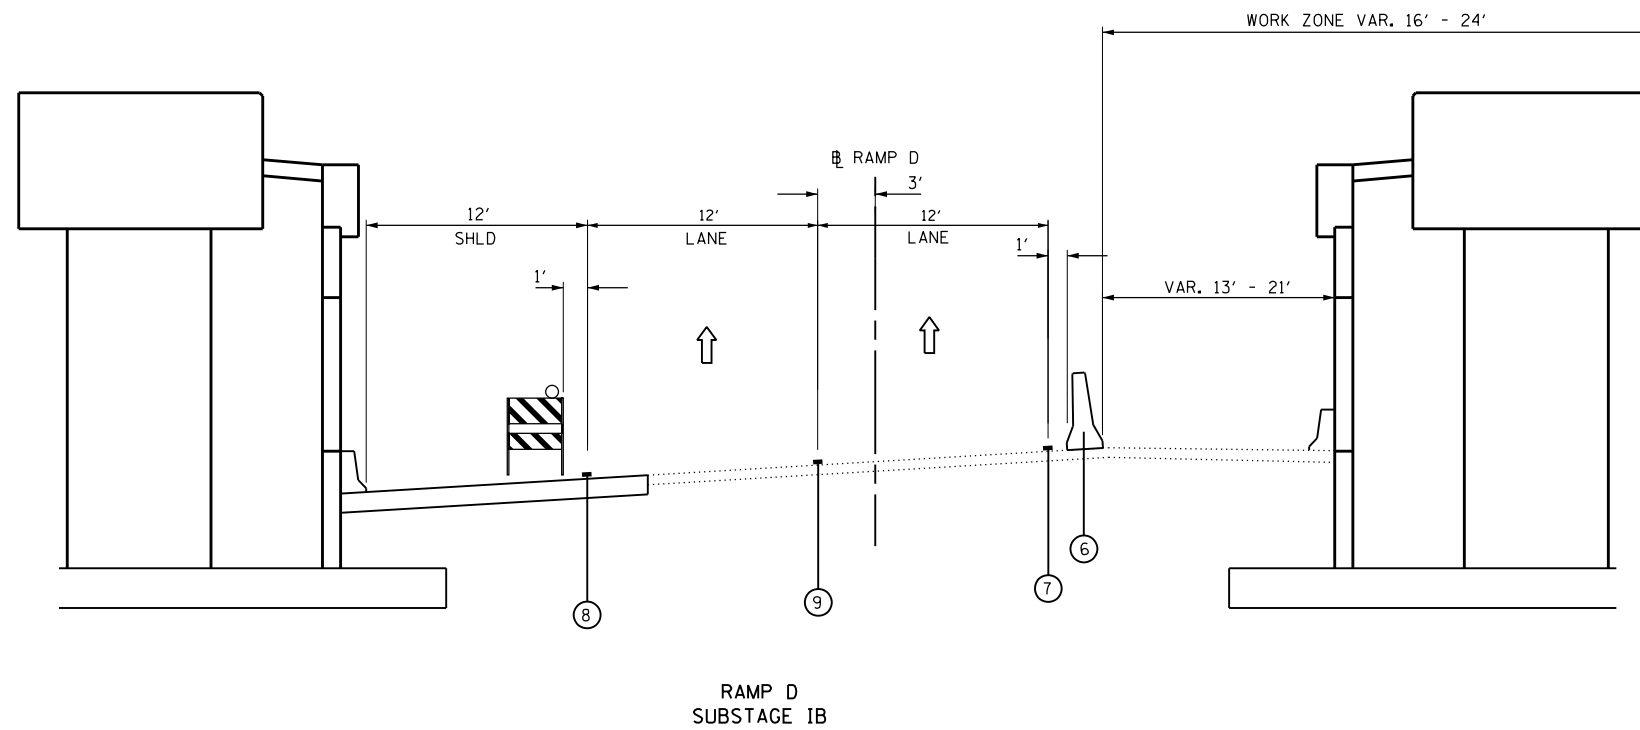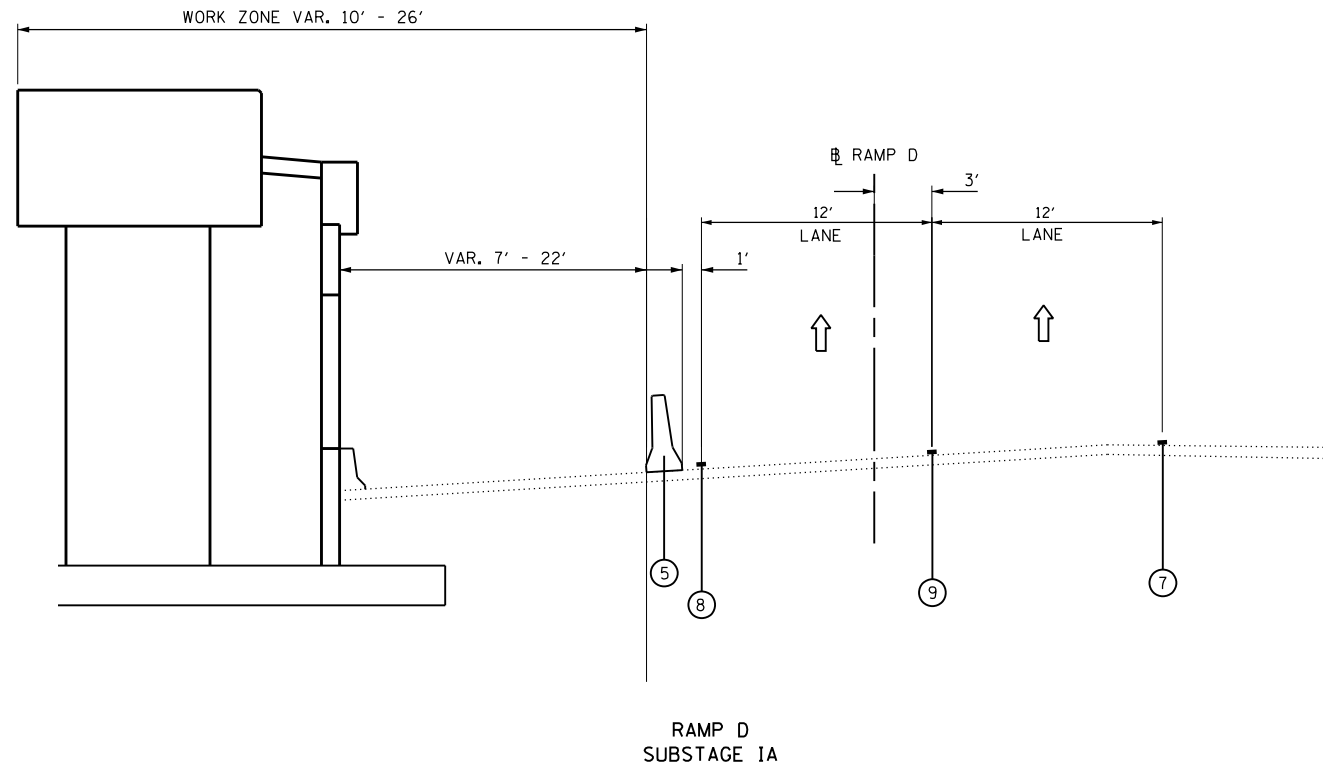

NOTES:

1. SEE STRUCTURAL PLANS FOR ADDITIONAL DETAILS
2. THE TEMPORARY CONCRETE BARRIER SHALL BE SECURED TO THE PAVEMENT USING THREE (3) ANCHORING PINS ON THE TRAFFIC SIDE OF THE BARRIER AT LOCATIONS WHERE A HAZARD OR SLOPE STEEPER THAN 1V:10H EXISTS WITHIN 3 FEET TO THE BARRIER. THE COST OF THIS WORK SHALL BE INCLUDED IN THE CONTRACT UNIT PRICE FOR "TEMPORARY CONCRETE BARRIER", OR "RELOCATE TEMPORARY CONCRETE BARRIER", AS APPLICABLE.
3. PRISMATIC BARRIER WALL REFLECTORS SHALL BE INSTALLED ON BOTH THE FACE AND THE TOP OF THE WALL ADJACENT TO TRAFFIC. THE COLOR OF THE REFLECTORS SHALL MATCH THE COLOR OF THE EDGELINES. SEE TRAFFIC CONTROL AND PROTECTION (EXPRESSWAY) SPECIAL PROVISION.

FILE NAME = I:\7000 - 194 at Ohio Street\CADD\CADD SHEETS\MOT\0160F63-ht-staging-tpj-stg1-RampD.dgn



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|-----------------------------|------------|-----------|
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| PLOT SCALE = 10.0000' / in. | DRAWN - | REVISED - |
| PLOT DATE = 3/25/2013 | CHECKED - | REVISED - |
| | DATE - | REVISED - |



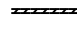
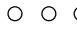

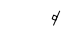






**STATE OF ILLINOIS
DEPARTMENT OF TRANSPORTATION**









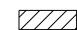


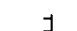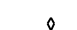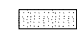


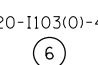
**STAGING AND TRAFFIC CONTROL
RAMP D TYPICAL SECTIONS
STAGE I**



SCALE: SHEET NO. OF SHEETS STA. TO STA.

| F.A.I. RTE. | SECTION | COUNTY | TOTAL SHEETS | SHEET NO. |
|---|--------------|--------|--------------|-----------|
| 90/94 | 0303-474HB-R | COOK | 368 | 70 |
| CONTRACT NO. 60F63 | | | | |
| FED. ROAD DIST. NO. 1 ILLINOIS FED. AID PROJECT | | | | |

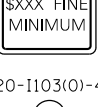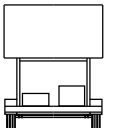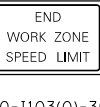LEGEND

-  WORK AREA
-  IMPACT ATTENUATOR
-  TEMPORARY CONCRETE BARRIER
-  TYPE II BARRICADES OR DRUMS WITH STEADY BURN MONODIRECTIONAL LIGHT (AT SPECIFIED SPACING)
-  DIRECTION OF TRAFFIC FLOW
-  SIGN
-  VERTICAL PANELS WITH STEADY BURNING LIGHTS (AT SPECIFIED SPACING)
-  ARROW BOARD
-  TYPE III BARRICADE
-  BARRIER WALL MARKERS (AT SPECIFIED SPACING)
-  TEMPORARY PAVEMENT, CURRENT STAGE
-  TEMPORARY PAVEMENT, PREVIOUS STAGE

| | | | | | | | | |
|---|--|--|---|---|--|---|--|--|
|  W20-1103(O)-48 ① |  W20-5(O)-48 ②L |  W20-5(O)-48 ②R |  WORK ZONE PUBLIC INFORMATION SIGN (AS SPECIFIED BY THE DEPARTMENT) ④ |  W2-1115(O)-361B SPEED LIMIT 45 R2-1-3648 |  R10-19aP-3618 |  R2-1106-3618 |  PORTABLE CHANGEABLE MESSAGE SIGN ⑦ |  G20-1103(O)-3660 ⑧ |
|  W16-3A(O)-3612 ①A |  W20-5(O)-48 ③L |  W20-5(O)-48 ③R |  W4-2R(O)-48 ⑤R |  W4-2R(O)-48 ⑤L |  W20-1103(O)-48 ⑥ | | | |

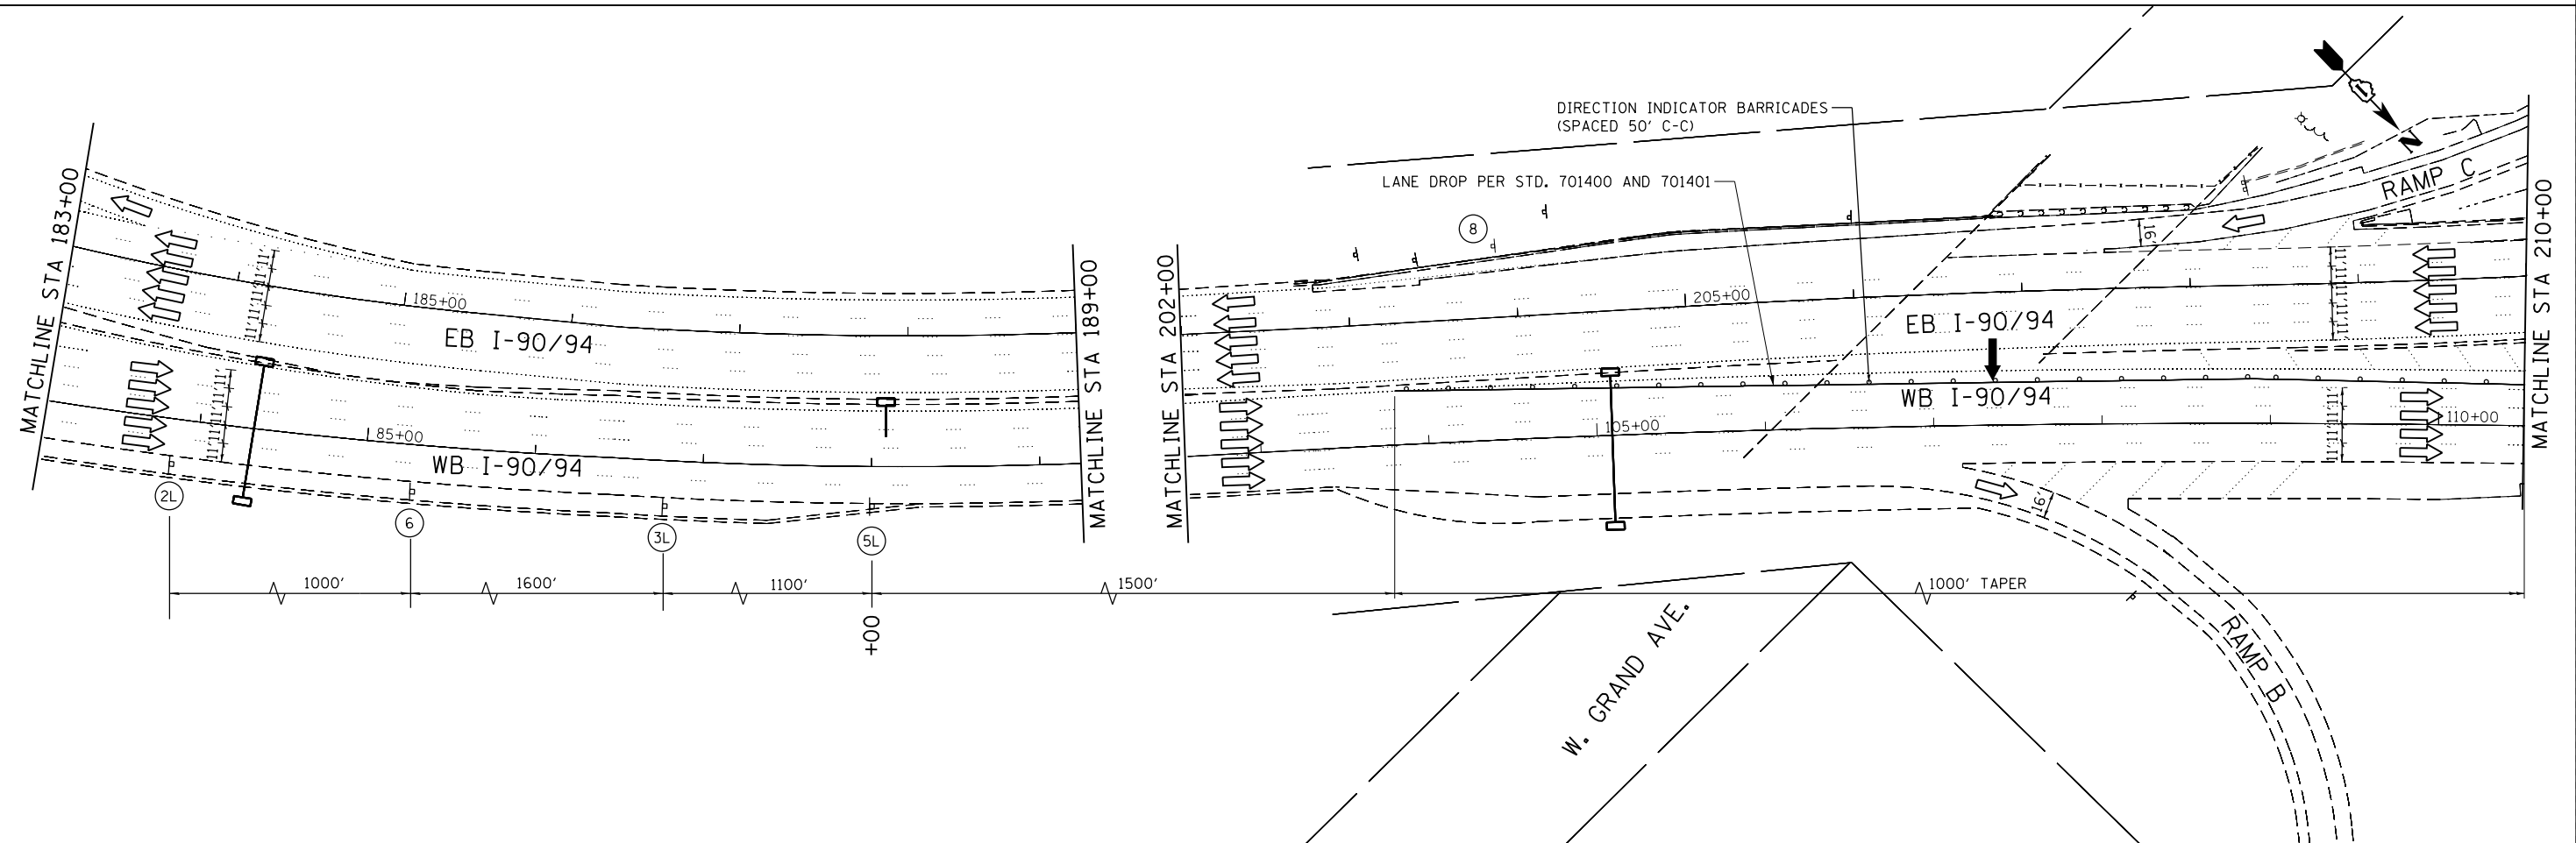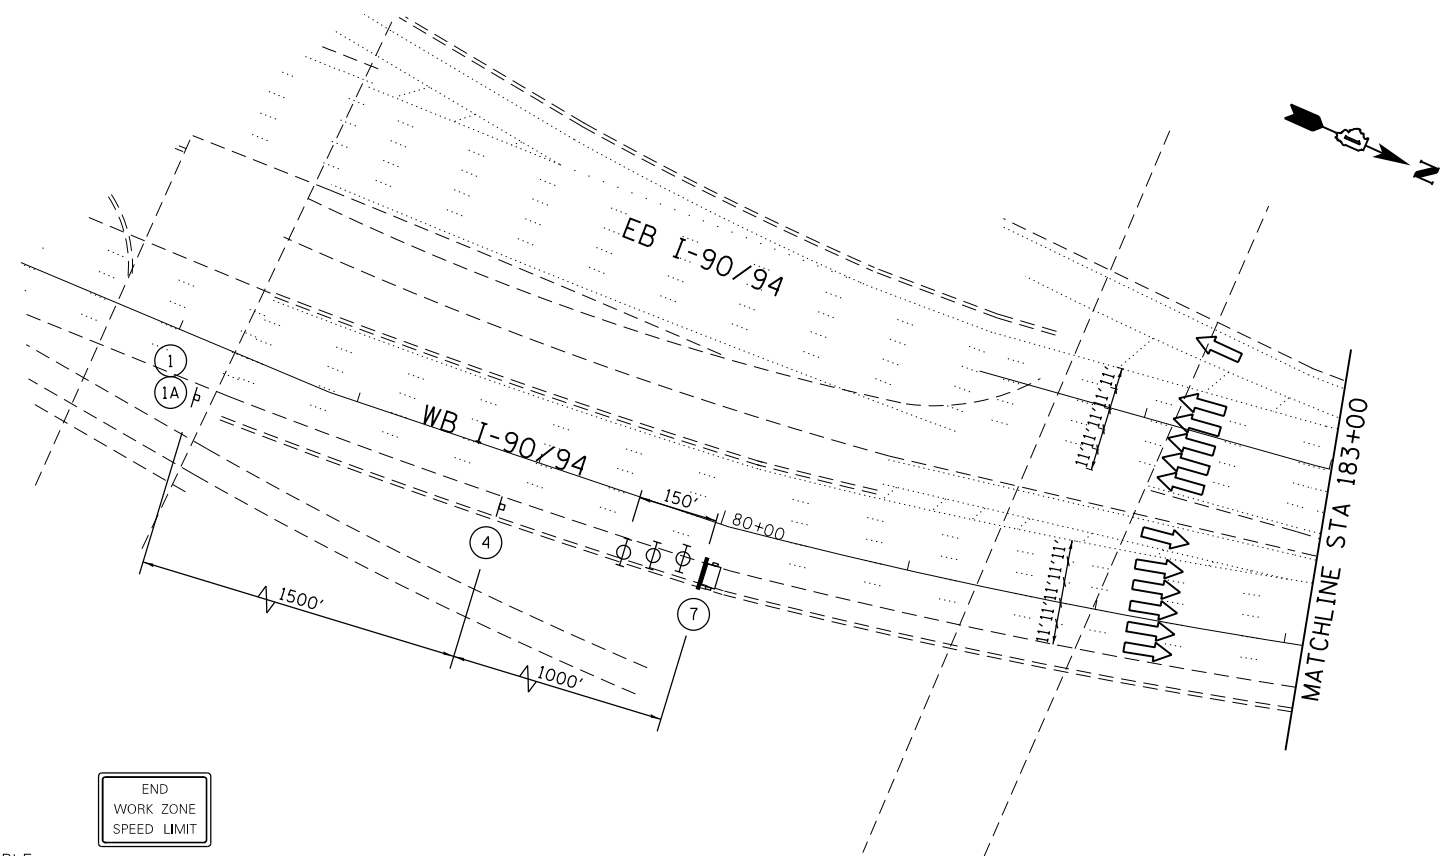

FILE NAME = I:\7000 - 194 at Ohio Street\CADD\CADD SHEETS\MOT\1160663-ht-transport\sgl-98_94.dgn

COLLINS ENGINEERS


| | | |
|--------------------------------|------------|-----------|
| USER NAME = rge11 | DESIGNED - | REVISED - |
| PLOT SCALE = 100.000000' / in. | DRAWN - | REVISED - |
| PLOT DATE = 3/25/2013 | CHECKED - | REVISED - |
| | DATE - | REVISED - |

**STATE OF ILLINOIS
DEPARTMENT OF TRANSPORTATION**


**STAGING AND TRAFFIC CONTROL
I-90/94 (KENNEDY EXPRESSWAY)
STAGE I**

SCALE: SHEET NO. OF SHEETS STA. TO STA.

| F.A.I. RTE. | SECTION | COUNTY | TOTAL SHEETS | SHEET NO. |
|---|--------------|--------|--------------|-----------|
| 90/94 | 0303-474HB-R | COOK | 368 | 71 |
| CONTRACT NO. 60F63 | | | | |
| FED. ROAD DIST. NO. 1 ILLINOIS FED. AID PROJECT | | | | |

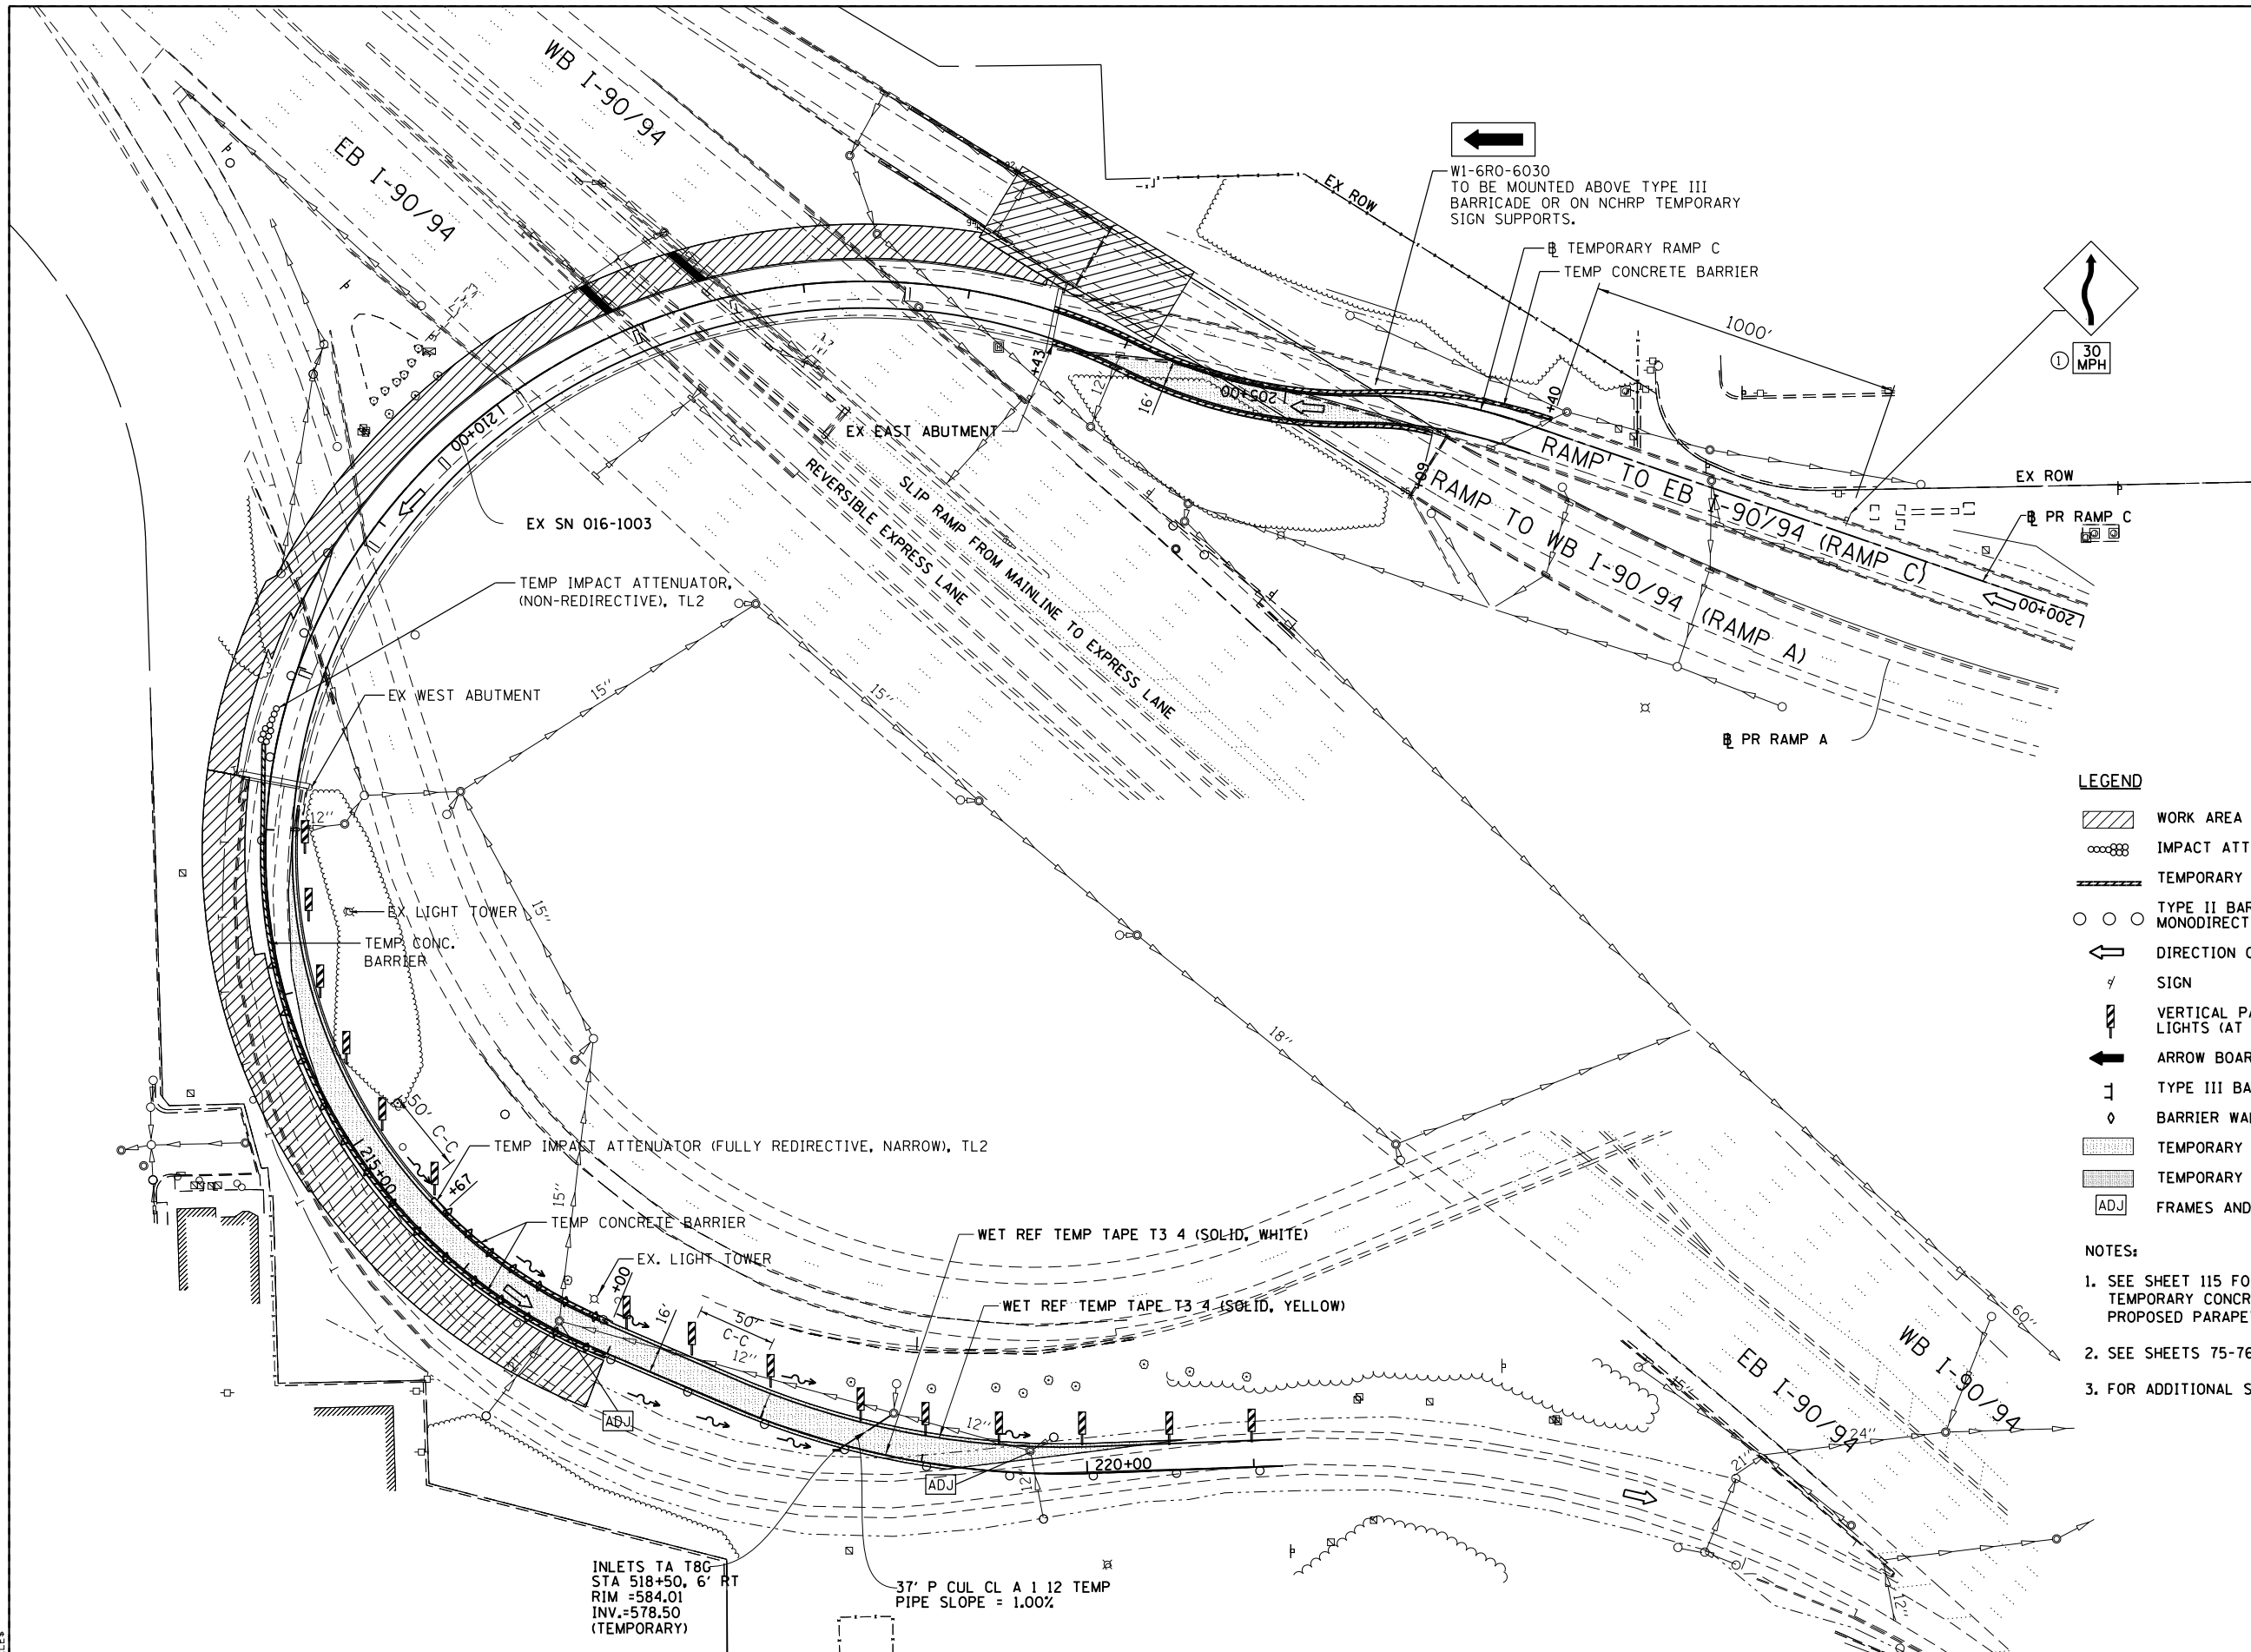

W1-6R0-6030
TO BE MOUNTED ABOVE TYPE III
BARRICADE OR ON NCHRP TEMPORARY
SIGN SUPPORTS.

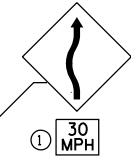


LEGEND

- WORK AREA
- IMPACT ATTENUATOR
- TEMPORARY CONCRETE BARRIER
- TYPE II BARRICADES OR DRUMS WITH STEADY BURN MONODIRECTIONAL LIGHT (AT SPECIFIED SPACING)
- DIRECTION OF TRAFFIC FLOW
- SIGN
- VERTICAL PANELS WITH STEADY BURNING LIGHTS (AT SPECIFIED SPACING)
- ARROW BOARD
- TYPE III BARRICADE
- BARRIER WALL MARKERS (AT SPECIFIED SPACING)
- TEMPORARY PAVEMENT, CURRENT STAGE
- TEMPORARY PAVEMENT, PREVIOUS STAGE
- FRAMES AND LIDS TO BE ADJUSTED

NOTES:

1. SEE SHEET 115 FOR CONNECTION DETAIL BETWEEN TEMPORARY CONCRETE BARRIER AND EXISTING / PROPOSED PARAPET.
2. SEE SHEETS 75-76 FOR RAMP A MAINTENANCE OF TRAFFIC.
3. FOR ADDITIONAL SIGNING DETAILS, SEE SHEETS 65

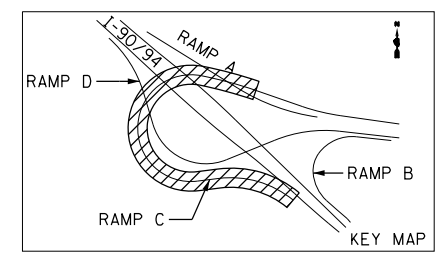

FILE NAME = 8FILES

COLLINS ENGINEERS

| | | |
|-----------------------------|----------------------|-----------|
| USER NAME = r9e11 | DESIGNED - NJH | REVISED - |
| PLOT SCALE = 100.0000' / 1" | DRAWN - NJH | REVISED - |
| PLOT DATE = 3/25/2013 | CHECKED - SWANG | REVISED - |
| | DATE - JUNE 21, 2010 | REVISED - |


**STATE OF ILLINOIS
DEPARTMENT OF TRANSPORTATION**

**STAGING PLAN
I-90/94 (RAMP C) - STAGE I**


SCALE: 1"=50' SHEET NO. 1 OF 3 SHEETS STA. TO STA.

| | | | | |
|---|----------------------|-------------|------------------|--------------|
| F.A.I. RTE. 90/94 | SECTION 0303-474HB-R | COUNTY COOK | TOTAL SHEETS 368 | SHEET NO. 73 |
| CONTRACT NO. 60F63 | | | | |
| FED. ROAD DIST. NO. 1 ILLINOIS FED. AID PROJECT | | | | |

| | | | |
|------|-----------------------------|----|------|
| PLAN | SURVEYED | BY | DATE |
| | PLOTTED | | |
| | GRADES CHECKED | | |
| | ALIGNMENT CHECKED | | |
| | STRUCTURE NOTATIONS CHECKED | | |
| | NOTE BOOK NO. | | |
| | CADD FILE NAME | | |

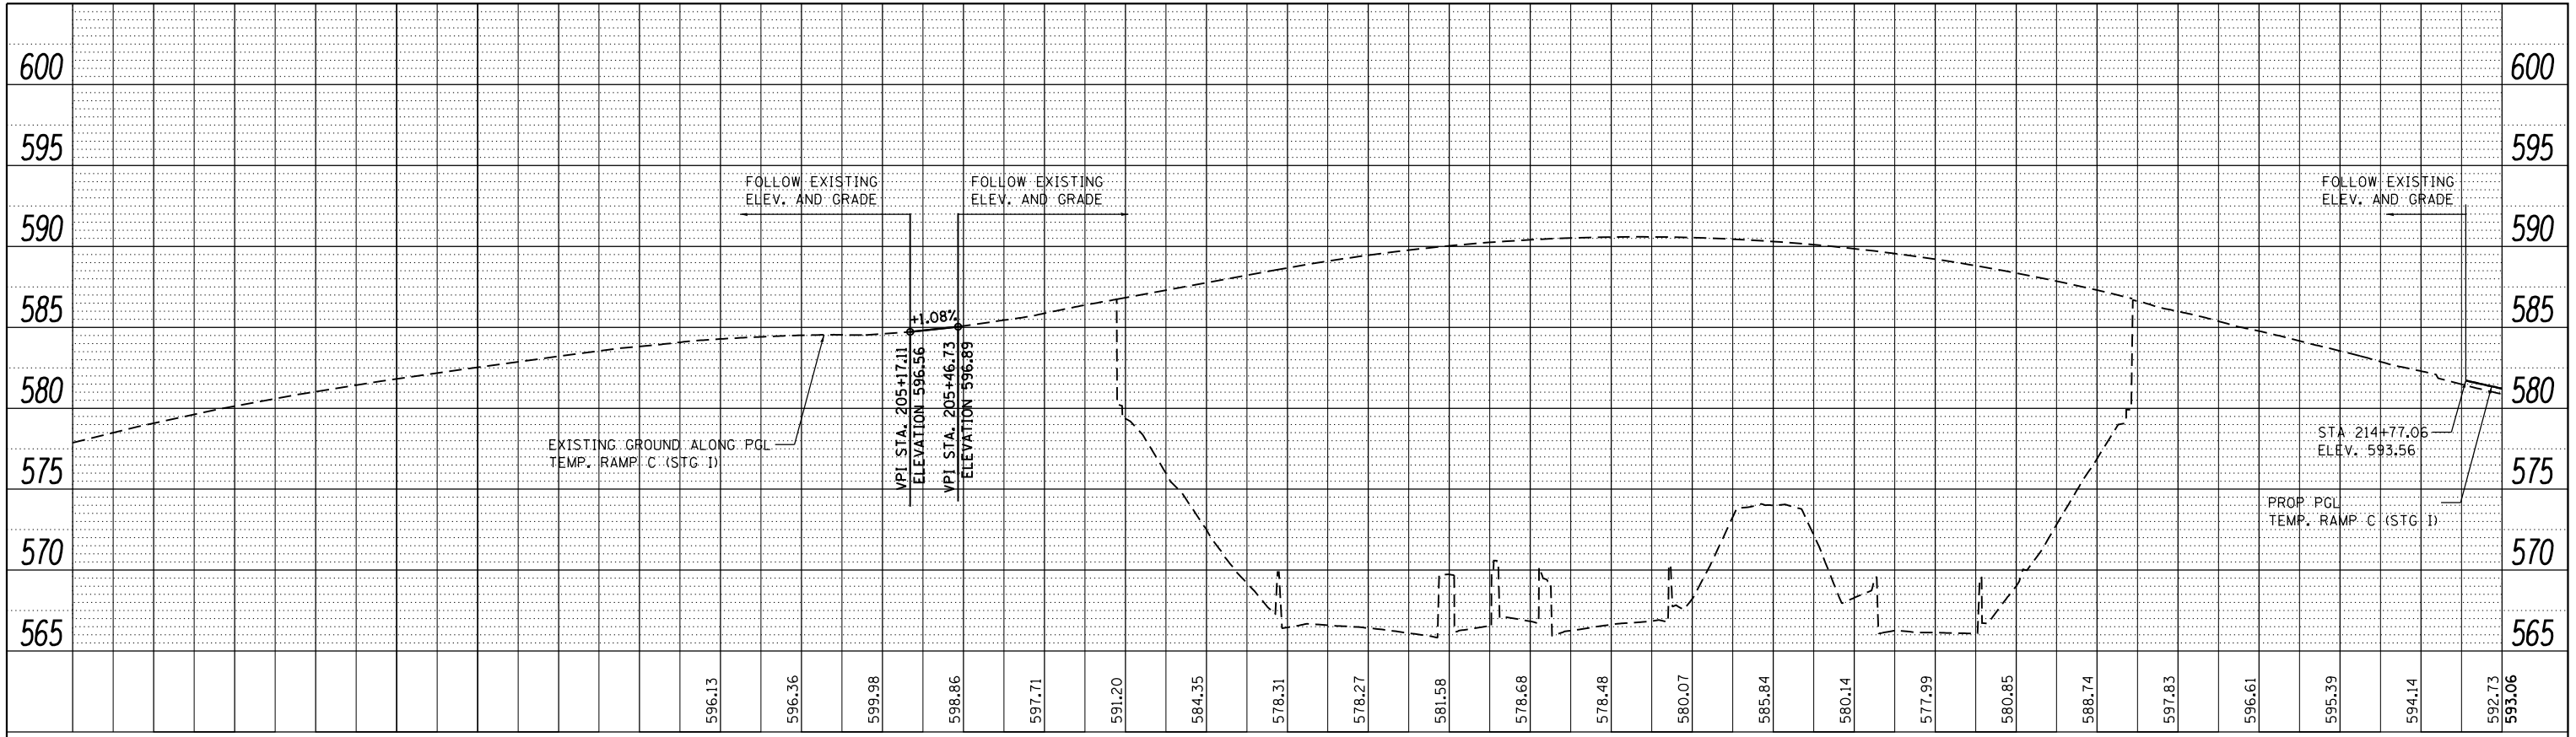

| | | | |
|---------|-----------------------------|----|------|
| PROFILE | SURVEYED | BY | DATE |
| | PLOTTED | | |
| | GRADES CHECKED | | |
| | STRUCTURE NOTATIONS CHECKED | | |
| | NOTE BOOK NO. | | |
| | CADD FILE NAME | | |

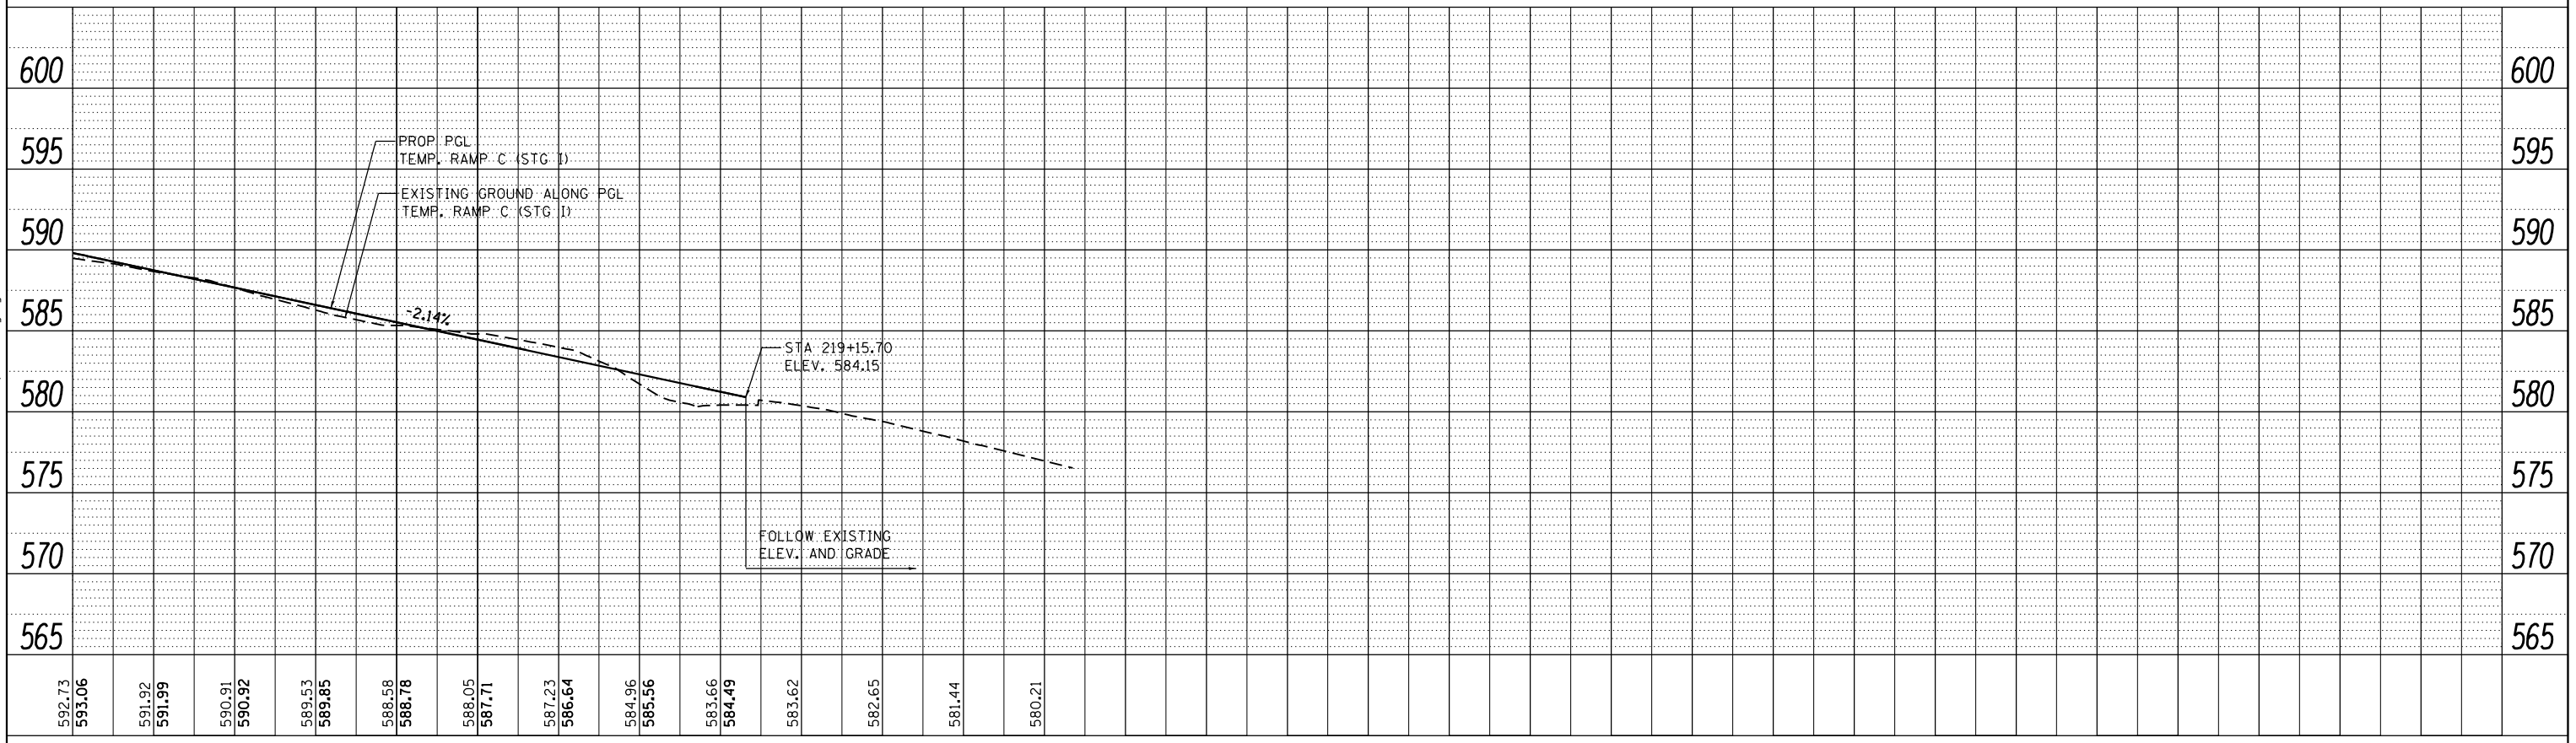

FILE NAME = I:\7000 - 194 at Ohio Street\CADD\CADD SHEETS\MOT\0160F63\stg-profile-ramp-c.dgn





| | | |
|--------------------------------|------------|-----------|
| USER NAME = r9e11 | DESIGNED - | REVISED - |
| PLOT SCALE = 100.000000' / in. | DRAWN - | REVISED - |
| PLOT DATE = 3/25/2013 | CHECKED - | REVISED - |
| | DATE - | REVISED - |


STATE OF ILLINOIS
DEPARTMENT OF TRANSPORTATION

| | | | |
|--|-----------|-----------|--------------|
| STAGING AND TRAFFIC CONTROL TEMPORARY RAMP C PROFILE STAGE I | | | |
| SCALE: | SHEET NO. | OF SHEETS | STA. TO STA. |

| | | | | |
|---------------------------|--------------|--------|--------------|-----------|
| F.A.I. RTE. | SECTION | COUNTY | TOTAL SHEETS | SHEET NO. |
| 90/94 | 0303-474HB-R | COOK | 368 | 74 |
| CONTRACT NO. 60F63 | | | | |
| ILLINOIS FED. AID PROJECT | | | | |

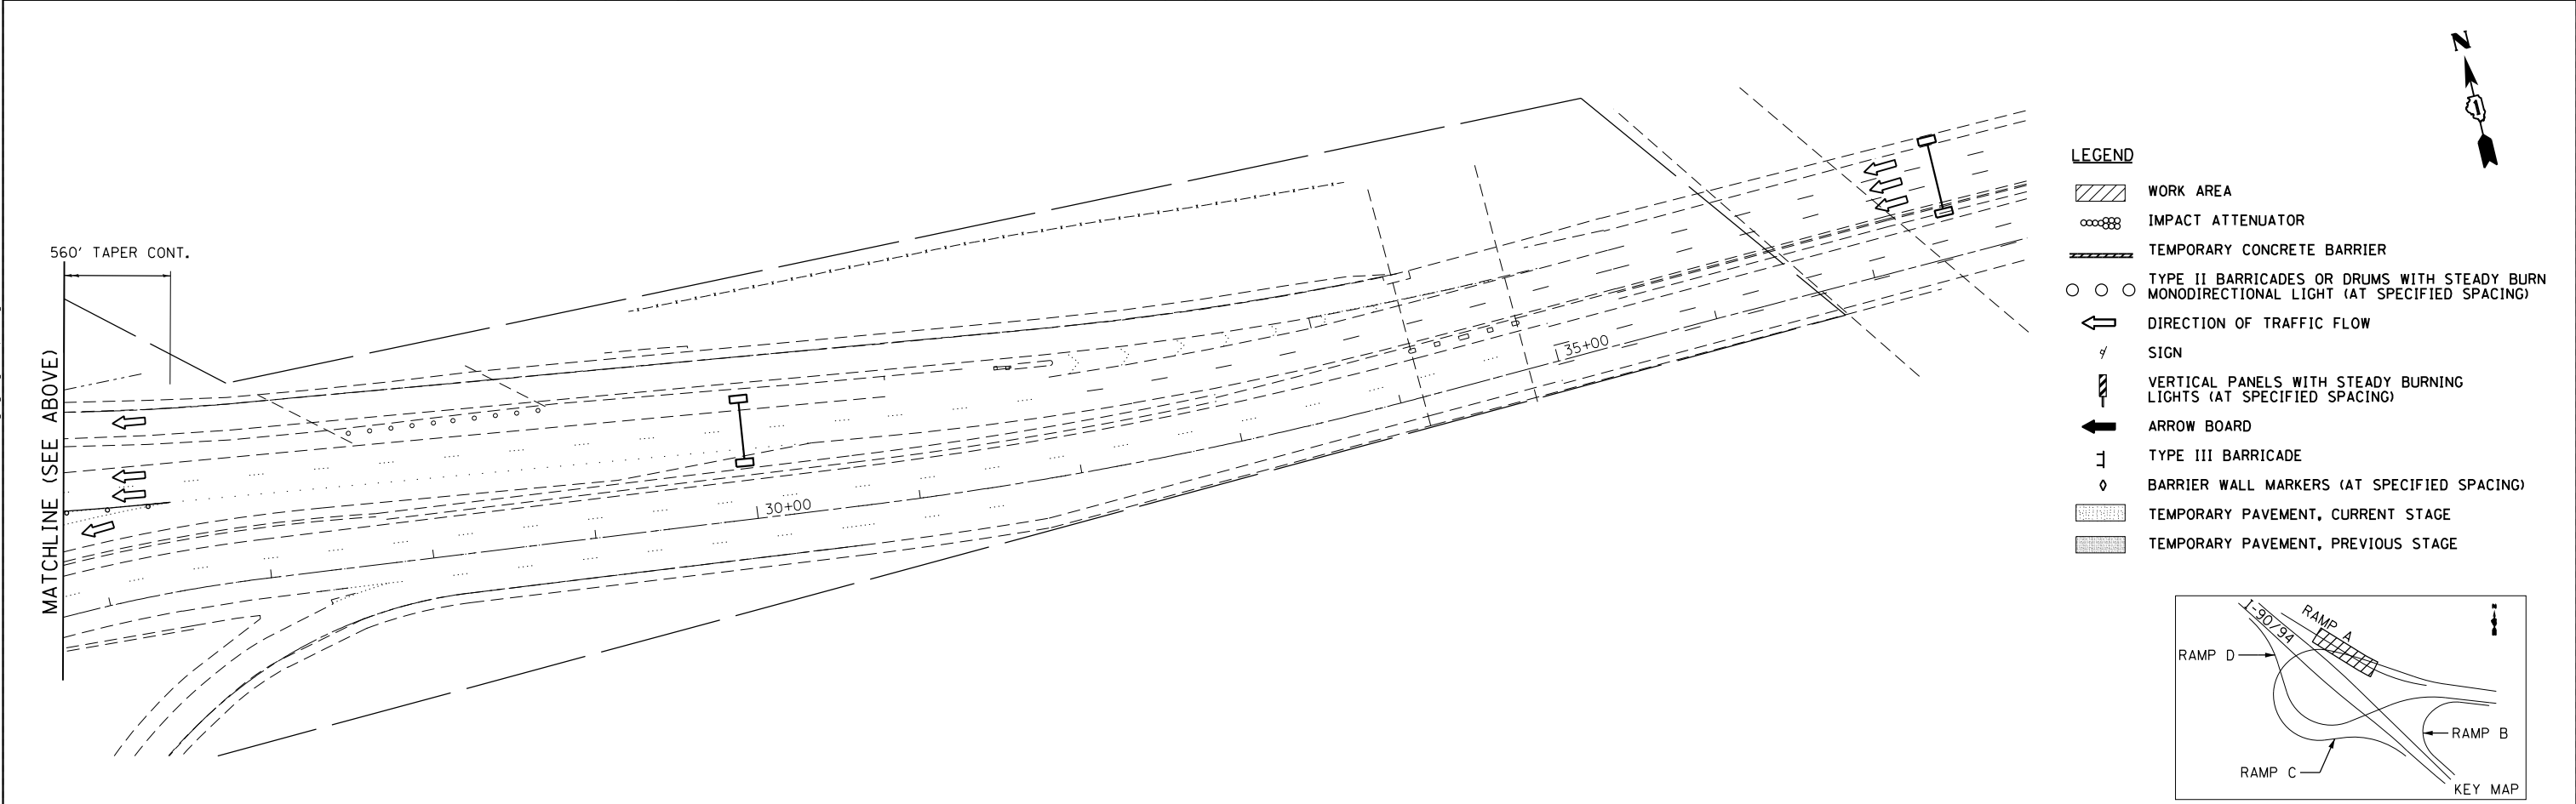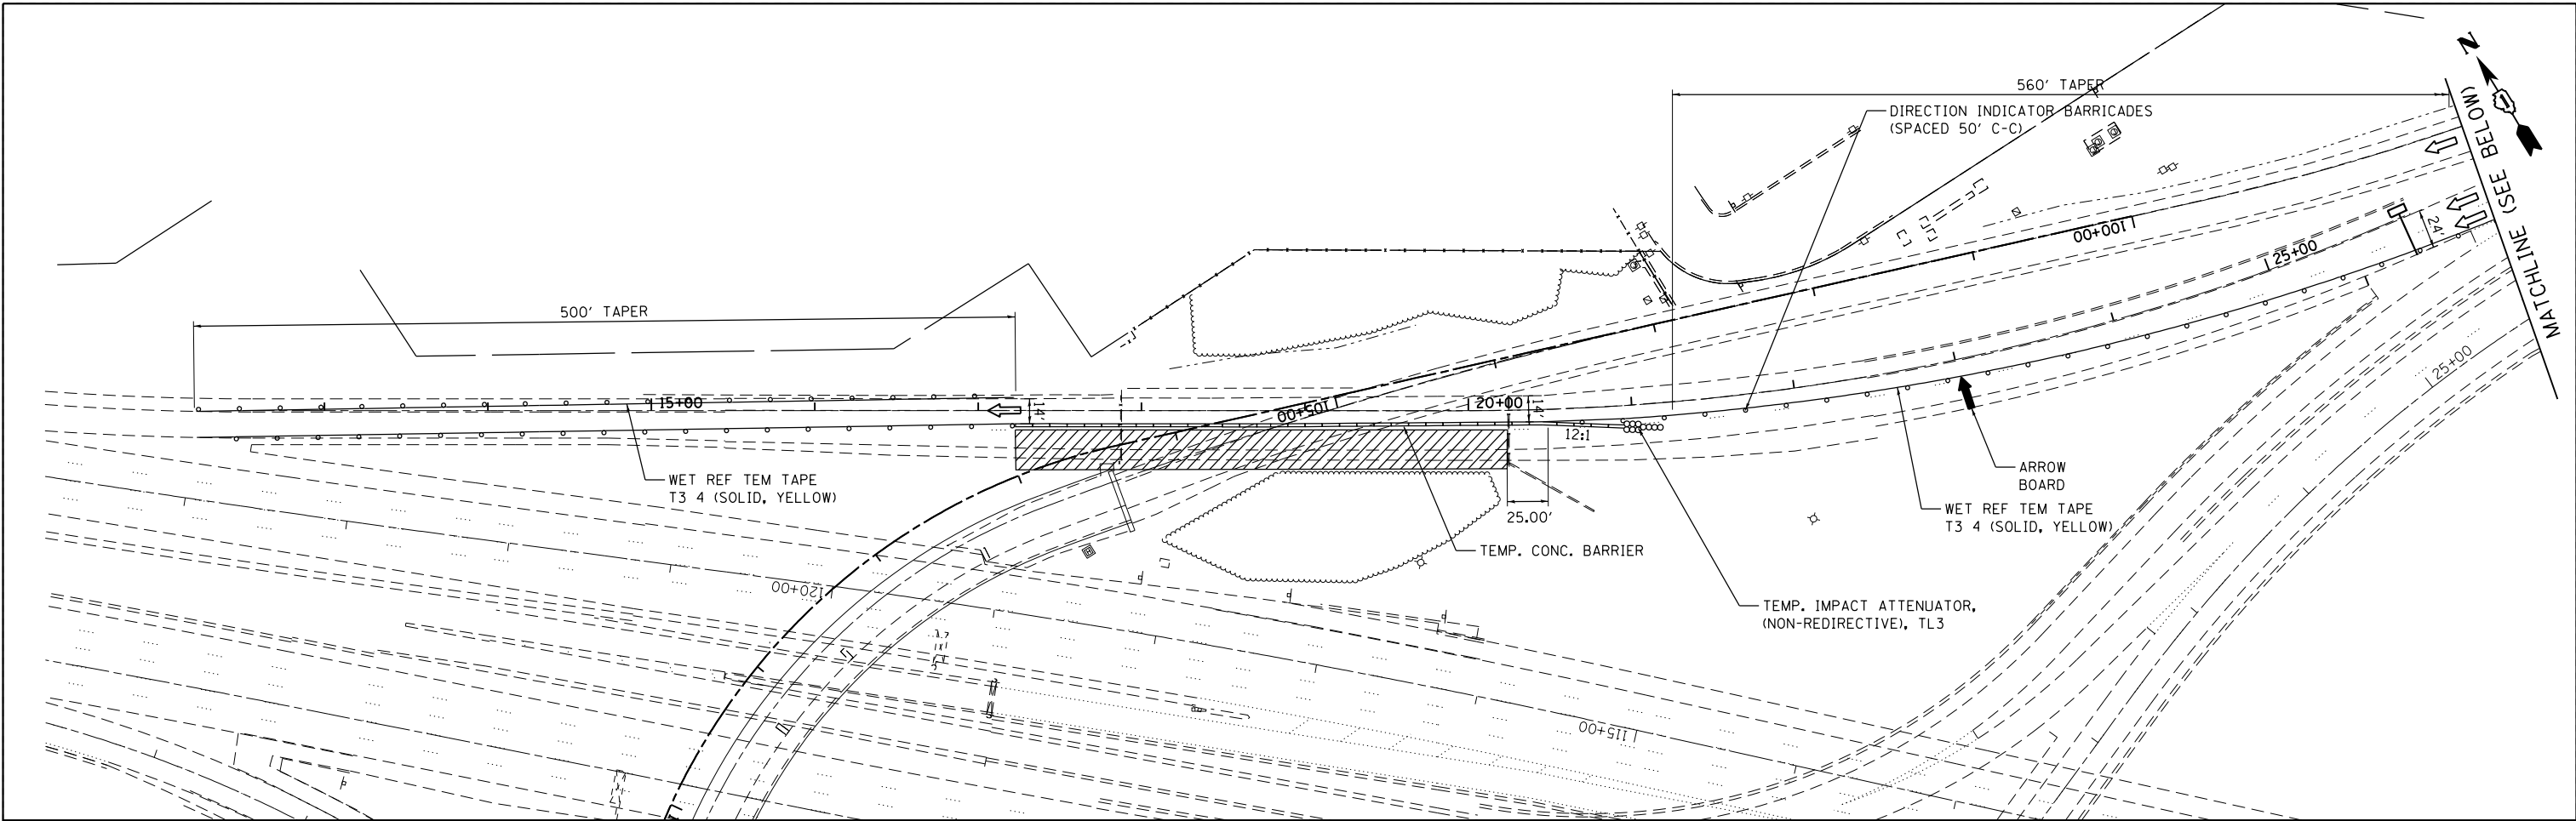

- LEGEND**
- WORK AREA
 - IMPACT ATTENUATOR
 - TEMPORARY CONCRETE BARRIER
 - TYPE II BARRICADES OR DRUMS WITH STEADY BURN MONODIRECTIONAL LIGHT (AT SPECIFIED SPACING)
 - DIRECTION OF TRAFFIC FLOW
 - SIGN
 - VERTICAL PANELS WITH STEADY BURNING LIGHTS (AT SPECIFIED SPACING)
 - ARROW BOARD
 - TYPE III BARRICADE
 - BARRIER WALL MARKERS (AT SPECIFIED SPACING)
 - TEMPORARY PAVEMENT, CURRENT STAGE
 - TEMPORARY PAVEMENT, PREVIOUS STAGE

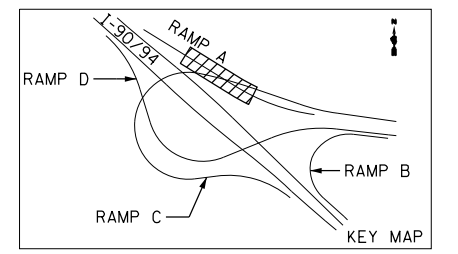

FILE NAME = I:\7000 - 194 at Ohio Street\CADD\CADD_SHEETS\MOT\0160F63-ht-staging-spl-RampA.dgn

COLLINS ENGINEERS



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|--------------------------------|------------|-----------|
| USER NAME = rge11 | DESIGNED - | REVISED - |
| PLOT SCALE = 100.000000' / in. | DRAWN - | REVISED - |
| PLOT DATE = 3/25/2013 | CHECKED - | REVISED - |
| | DATE - | REVISED - |

**STATE OF ILLINOIS
DEPARTMENT OF TRANSPORTATION**


**STAGING AND TRAFFIC CONTROL
RAMP A STAGE I
SUBSTAGE A**

SCALE: SHEET NO. OF SHEETS STA. TO STA.

| | | | | |
|---|----------------------|-------------|------------------|--------------|
| F.A.I. RT. 90/94 | SECTION 0303-474HB-R | COUNTY COOK | TOTAL SHEETS 368 | SHEET NO. 75 |
| CONTRACT NO. 60F63 | | | | |
| FED. ROAD DIST. NO. 1 ILLINOIS FED. AID PROJECT | | | | |

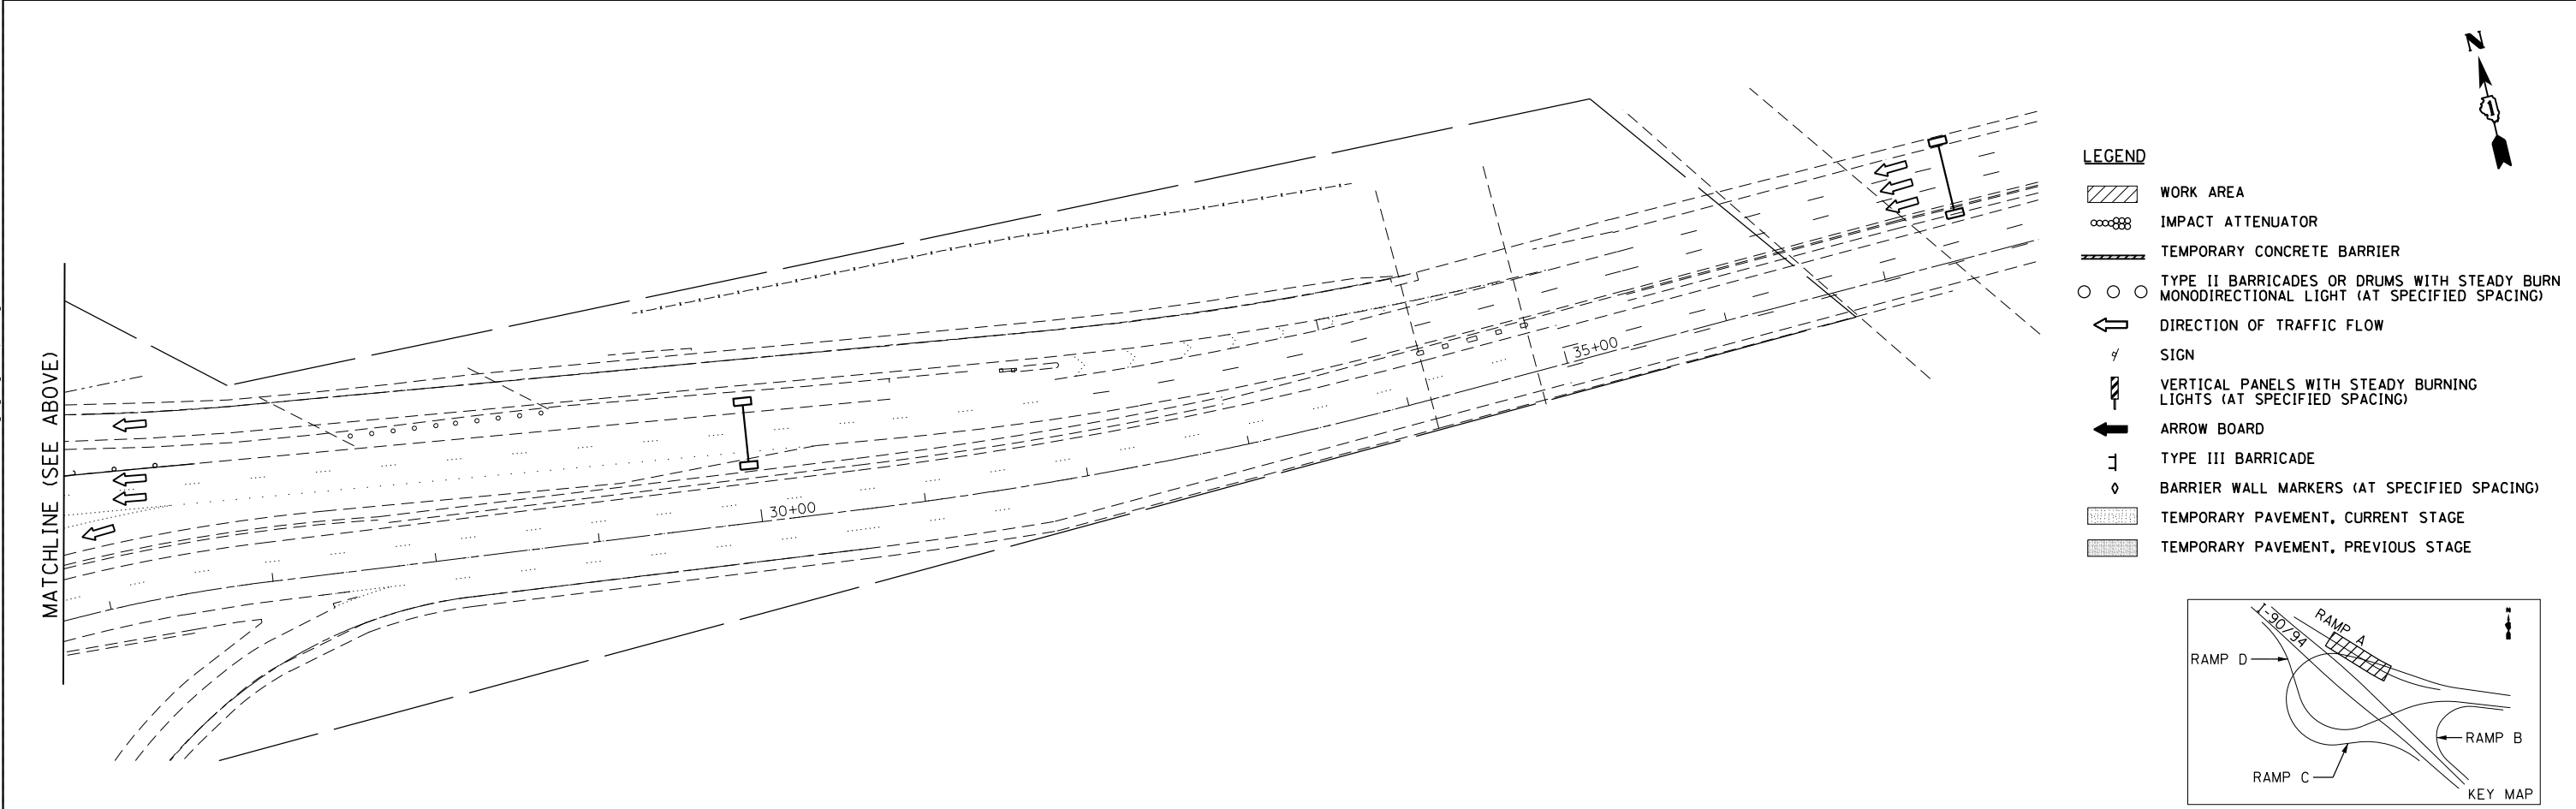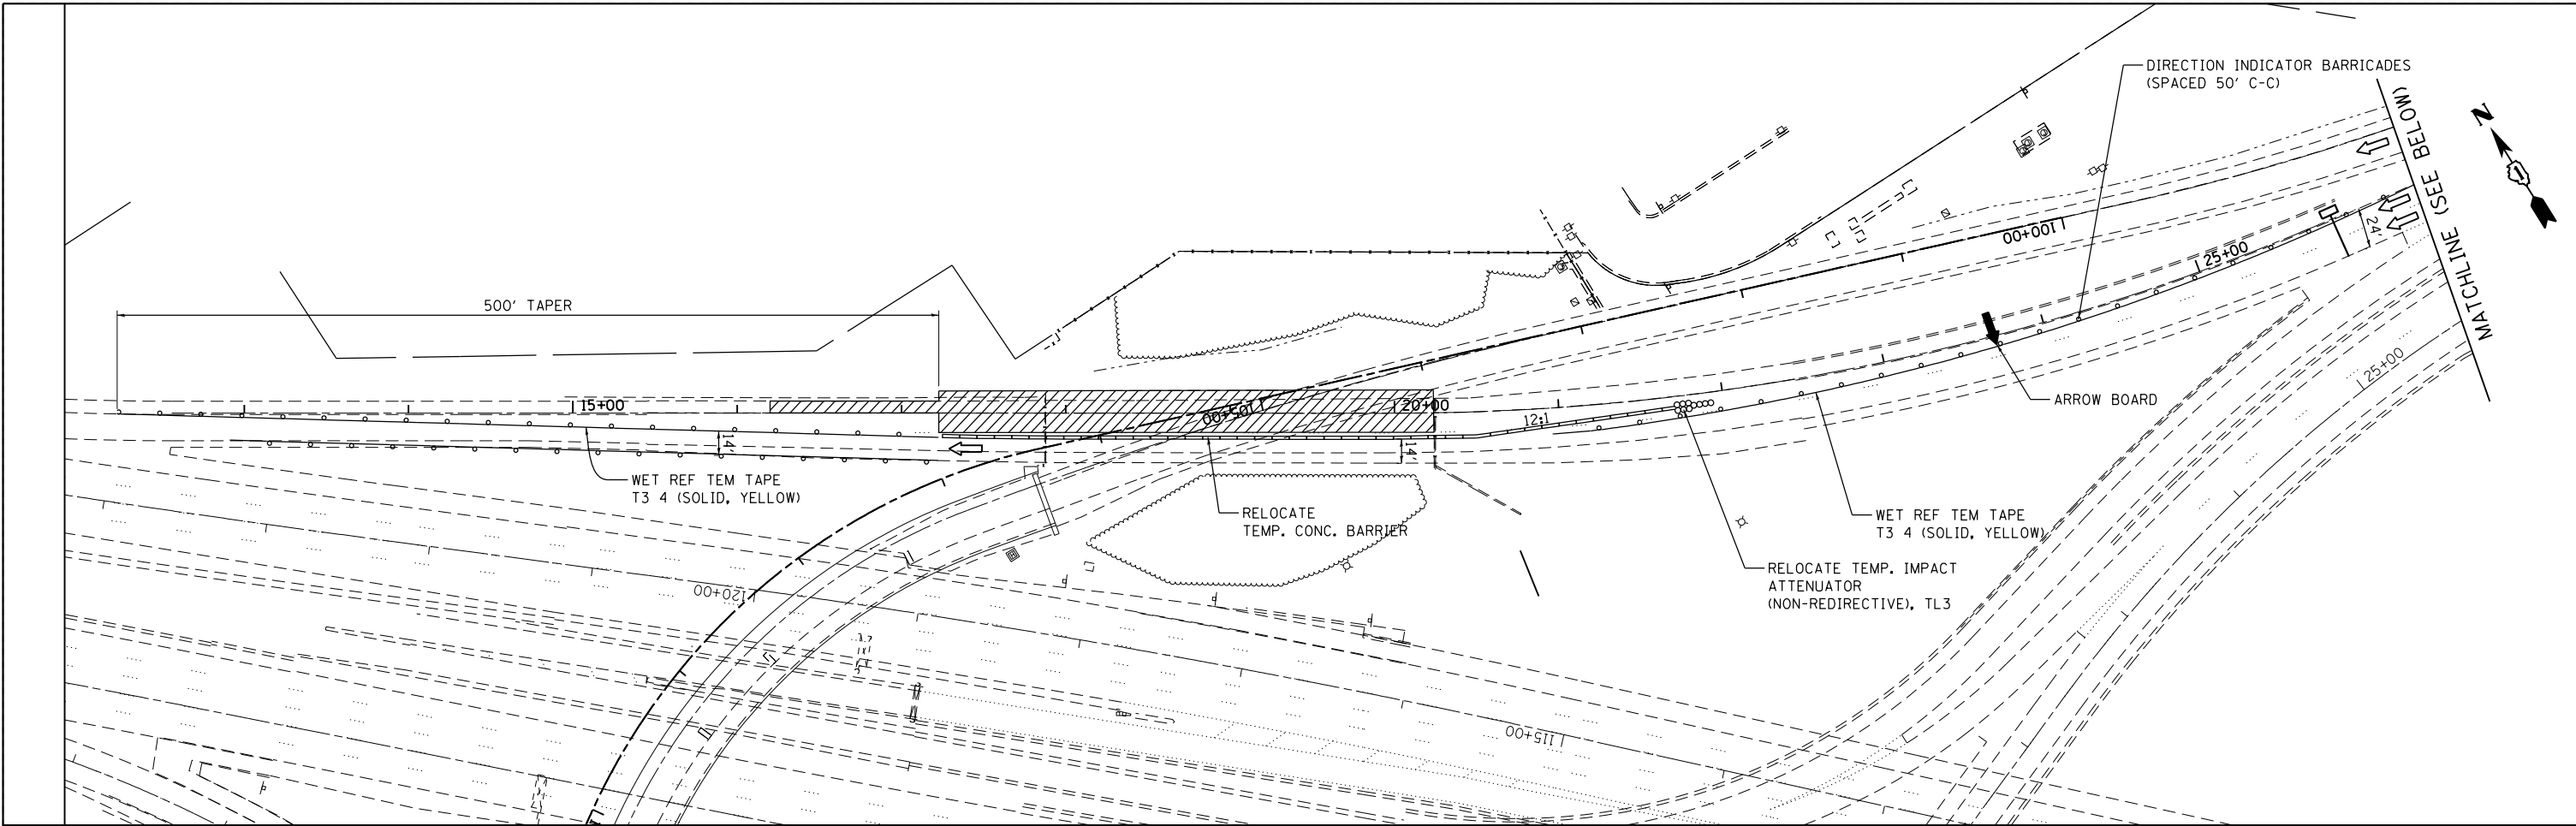

- LEGEND**
- WORK AREA
 - IMPACT ATTENUATOR
 - TEMPORARY CONCRETE BARRIER
 - TYPE II BARRICADES OR DRUMS WITH STEADY BURN MONODIRECTIONAL LIGHT (AT SPECIFIED SPACING)
 - DIRECTION OF TRAFFIC FLOW
 - SIGN
 - VERTICAL PANELS WITH STEADY BURNING LIGHTS (AT SPECIFIED SPACING)
 - ARROW BOARD
 - TYPE III BARRICADE
 - BARRIER WALL MARKERS (AT SPECIFIED SPACING)
 - TEMPORARY PAVEMENT, CURRENT STAGE
 - TEMPORARY PAVEMENT, PREVIOUS STAGE

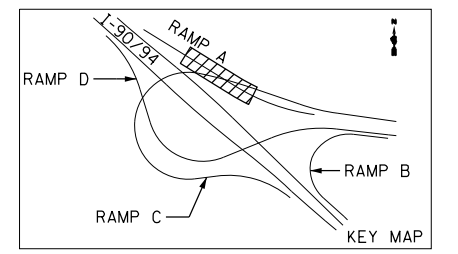

FILE NAME = I:\7000 - 194 at Ohio Street\CADD\CADD_SHEETS\MOT\0160F63-ht-staging-spl-RampA_2.dgn

COLLINS ENGINEERS

| | | |
|--------------------------------|------------|-----------|
| USER NAME = rge11 | DESIGNED - | REVISED - |
| PLOT SCALE = 100.000000' / in. | DRAWN - | REVISED - |
| PLOT DATE = 3/25/2013 | CHECKED - | REVISED - |
| | DATE - | REVISED - |


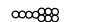



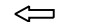
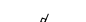



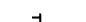

**STATE OF ILLINOIS
DEPARTMENT OF TRANSPORTATION**



**STAGING AND TRAFFIC CONTROL
RAMP A STAGE I
SUBSTAGE B**

SCALE: SHEET NO. OF SHEETS STA. TO STA.

| | | | | |
|---|----------------------|-------------|------------------|--------------|
| F.A.I. RTE. 90/94 | SECTION 0303-474HB-R | COUNTY COOK | TOTAL SHEETS 368 | SHEET NO. 76 |
| CONTRACT NO. 60F63 | | | | |
| FED. ROAD DIST. NO. 1 ILLINOIS FED. AID PROJECT | | | | |

LEGEND

-  WORK AREA
-  IMPACT ATTENUATOR
-  TEMPORARY CONCRETE BARRIER
-  TYPE II BARRICADES OR DRUMS WITH STEADY BURN MONODIRECTIONAL LIGHT (AT SPECIFIED SPACING)
-  DIRECTION OF TRAFFIC FLOW
-  SIGN
-  VERTICAL PANELS WITH STEADY BURNING LIGHTS (AT SPECIFIED SPACING)
-  ARROW BOARD
-  TYPE III BARRICADE
-  BARRIER WALL MARKERS (AT SPECIFIED SPACING)
-  TEMPORARY PAVEMENT, CURRENT STAGE
-  TEMPORARY PAVEMENT, PREVIOUS STAGE

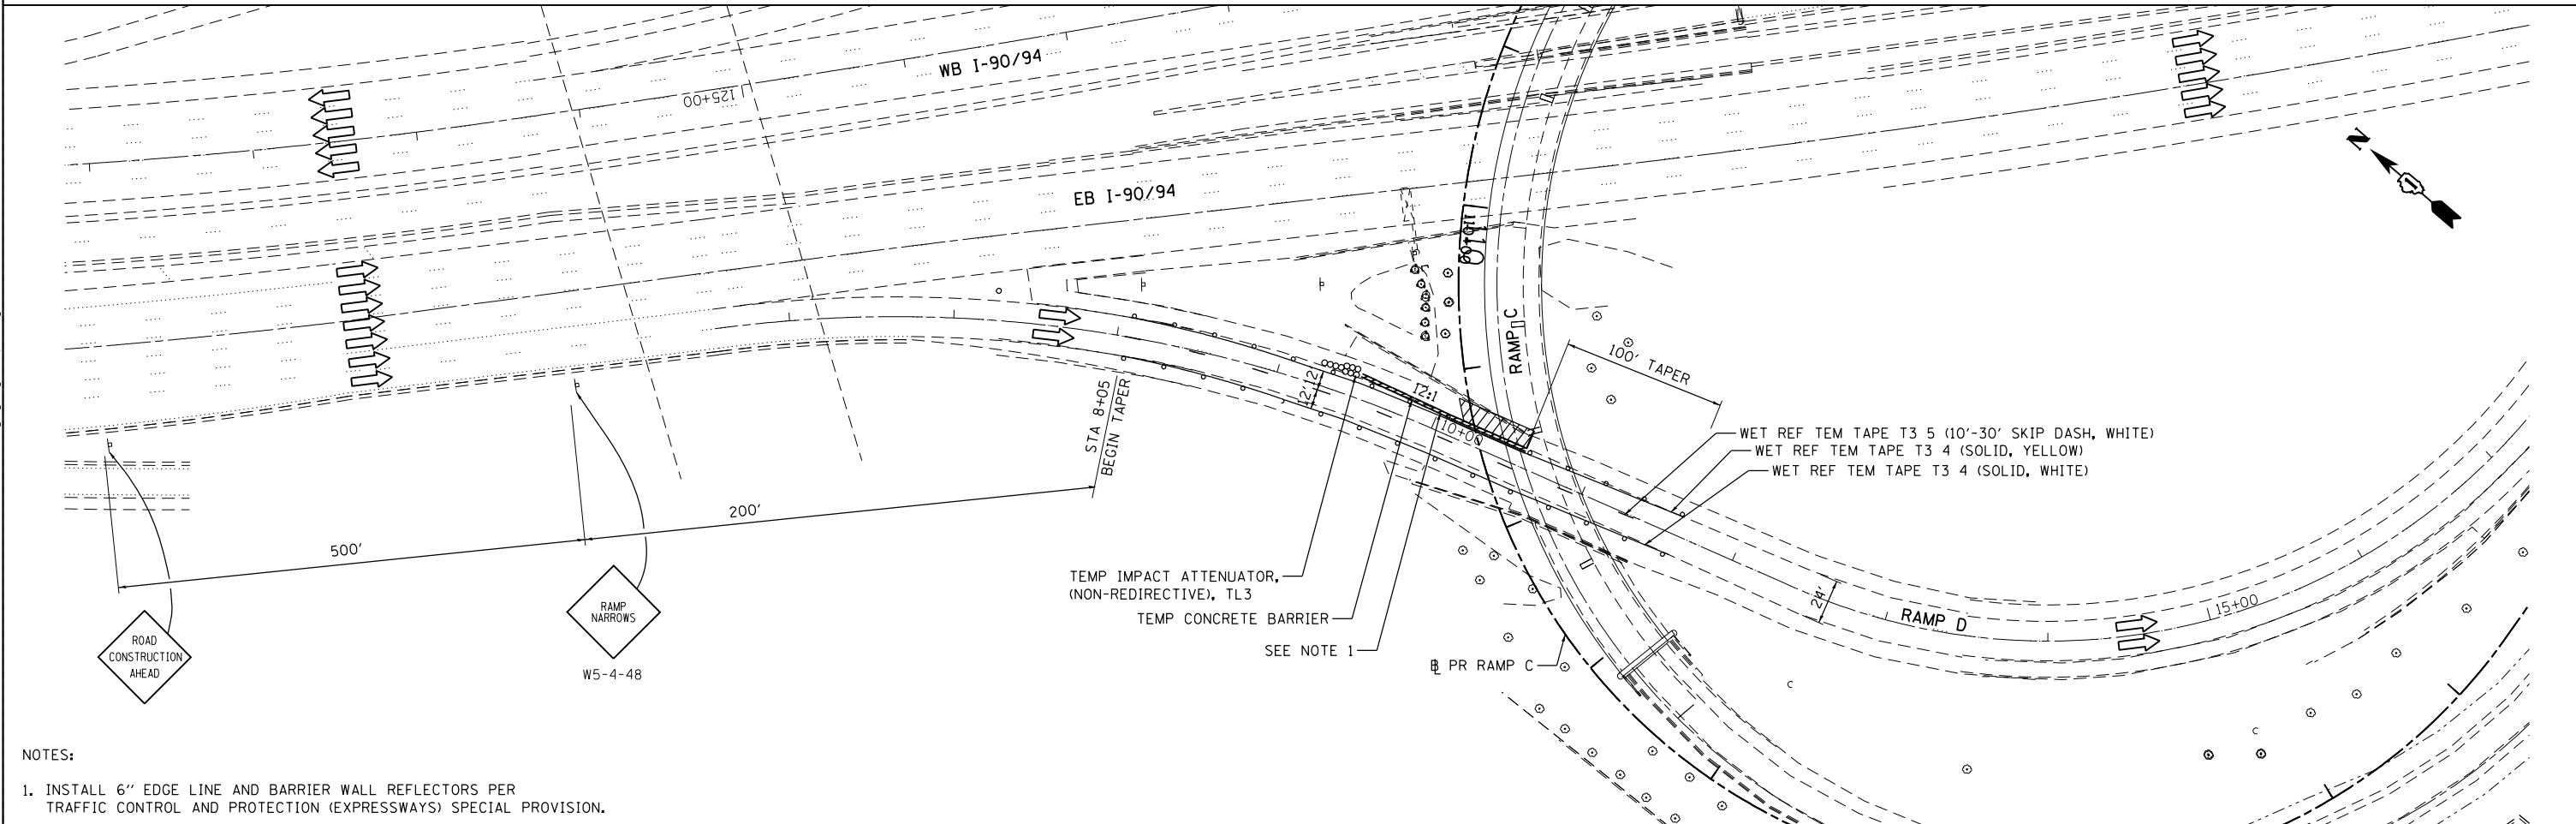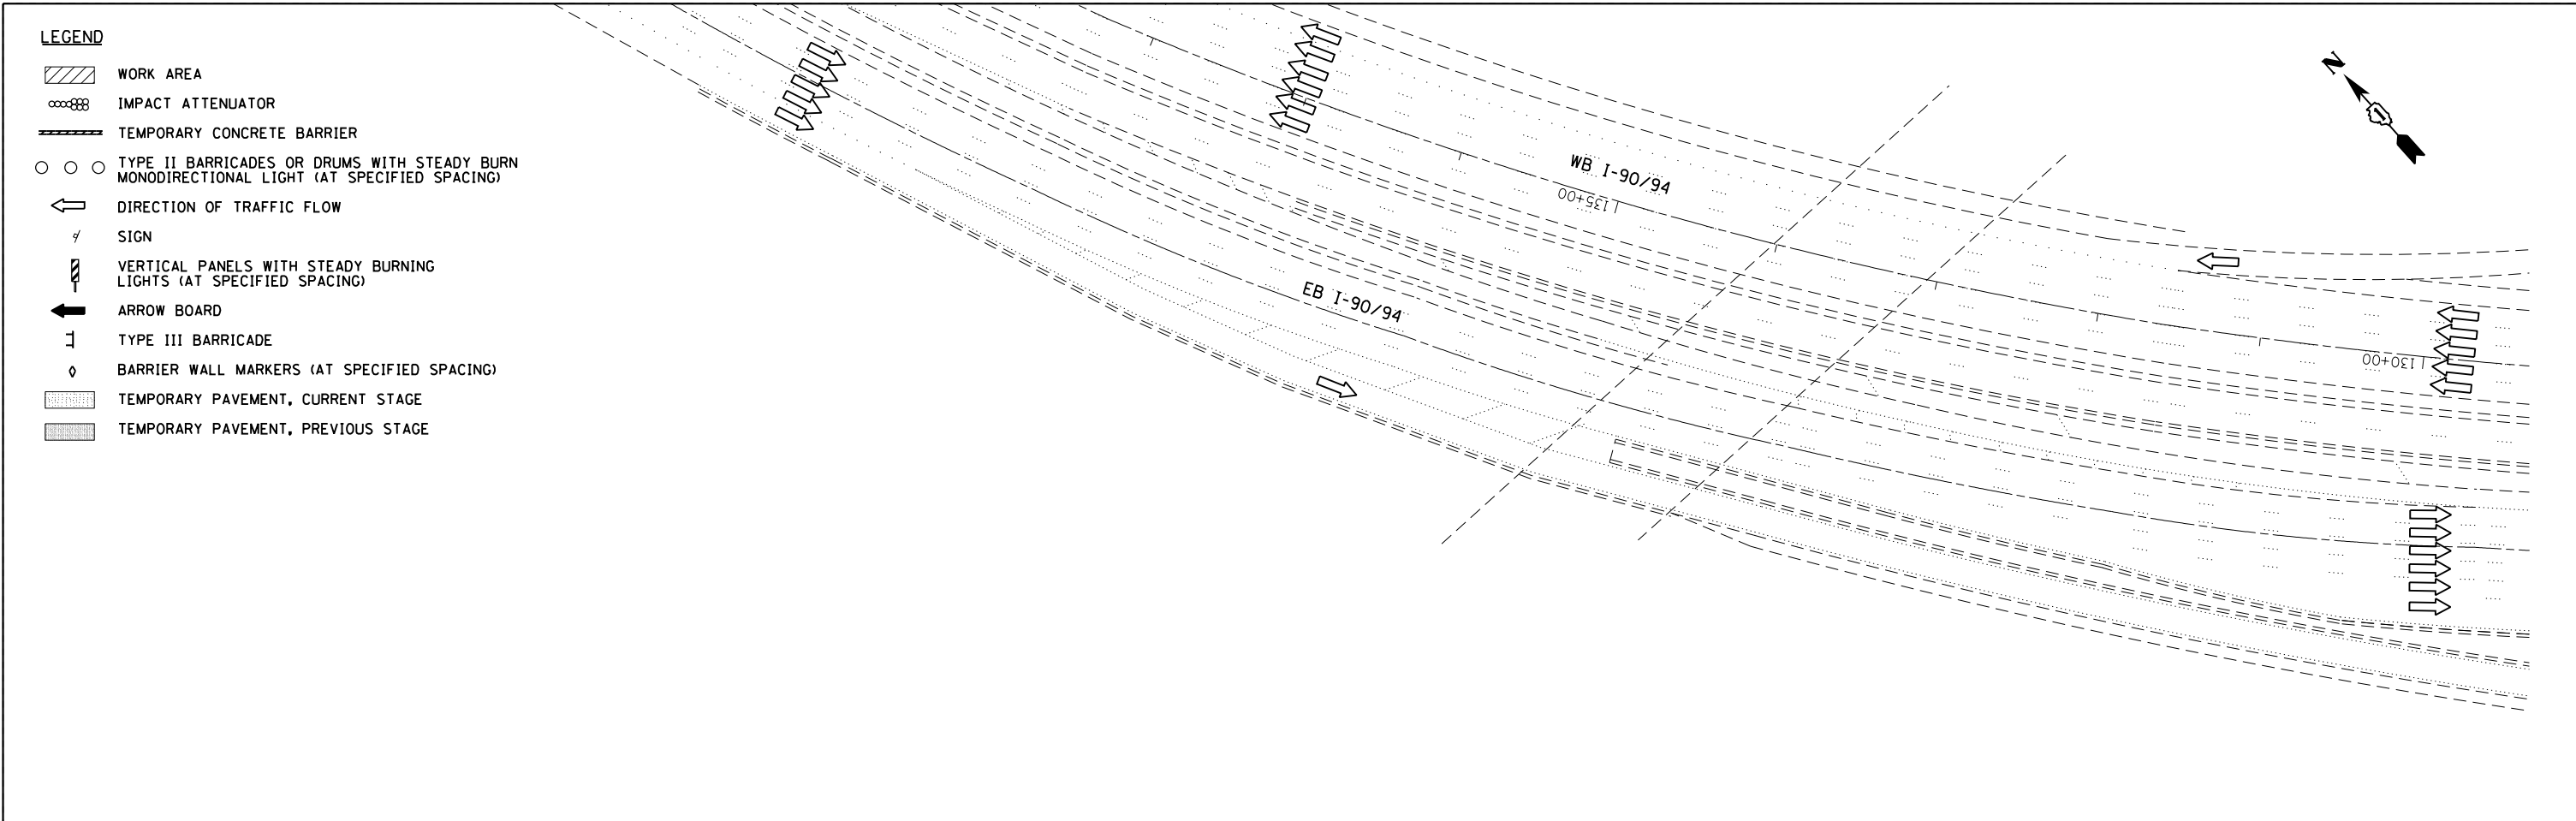

NOTES:

1. INSTALL 6" EDGE LINE AND BARRIER WALL REFLECTORS PER TRAFFIC CONTROL AND PROTECTION (EXPRESSWAYS) SPECIAL PROVISION.

FILE NAME = I:\7000 - 194 at Ohio Street\CADD\CADD SHEETS\MOT\1160663-ht-staging-spl-RampD_2.dgn

COLLINS ENGINEERS

| | | |
|-----------------------------|------------|-----------|
| USER NAME = rge11 | DESIGNED - | REVISED - |
| PLOT SCALE = 100.000' / in. | DRAWN - | REVISED - |
| PLOT DATE = 3/25/2013 | CHECKED - | REVISED - |
| | DATE - | REVISED - |


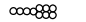



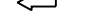






**STATE OF ILLINOIS
DEPARTMENT OF TRANSPORTATION**


**STAGING AND TRAFFIC CONTROL
RAMP D STAGE I
SUBSTAGE A**

SCALE: SHEET NO. OF SHEETS STA. TO STA.

| F.A.I. RTE. | SECTION | COUNTY | TOTAL SHEETS | SHEET NO. |
|---|--------------|--------|--------------|-----------|
| 90/94 | 0303-474HB-R | COOK | 368 | 77 |
| CONTRACT NO. 60F63 | | | | |
| FED. ROAD DIST. NO. 1 ILLINOIS FED. AID PROJECT | | | | |

LEGEND

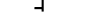-  WORK AREA
-  IMPACT ATTENUATOR
-  TEMPORARY CONCRETE BARRIER
-  TYPE II BARRICADES OR DRUMS WITH STEADY BURN MONODIRECTIONAL LIGHT (AT SPECIFIED SPACING)
-  DIRECTION OF TRAFFIC FLOW
-  SIGN
-  VERTICAL PANELS WITH STEADY BURNING LIGHTS (AT SPECIFIED SPACING)
-  ARROW BOARD
-  TYPE III BARRICADE
-  BARRIER WALL MARKERS (AT SPECIFIED SPACING)
-  TEMPORARY PAVEMENT, CURRENT STAGE
-  TEMPORARY PAVEMENT, PREVIOUS STAGE

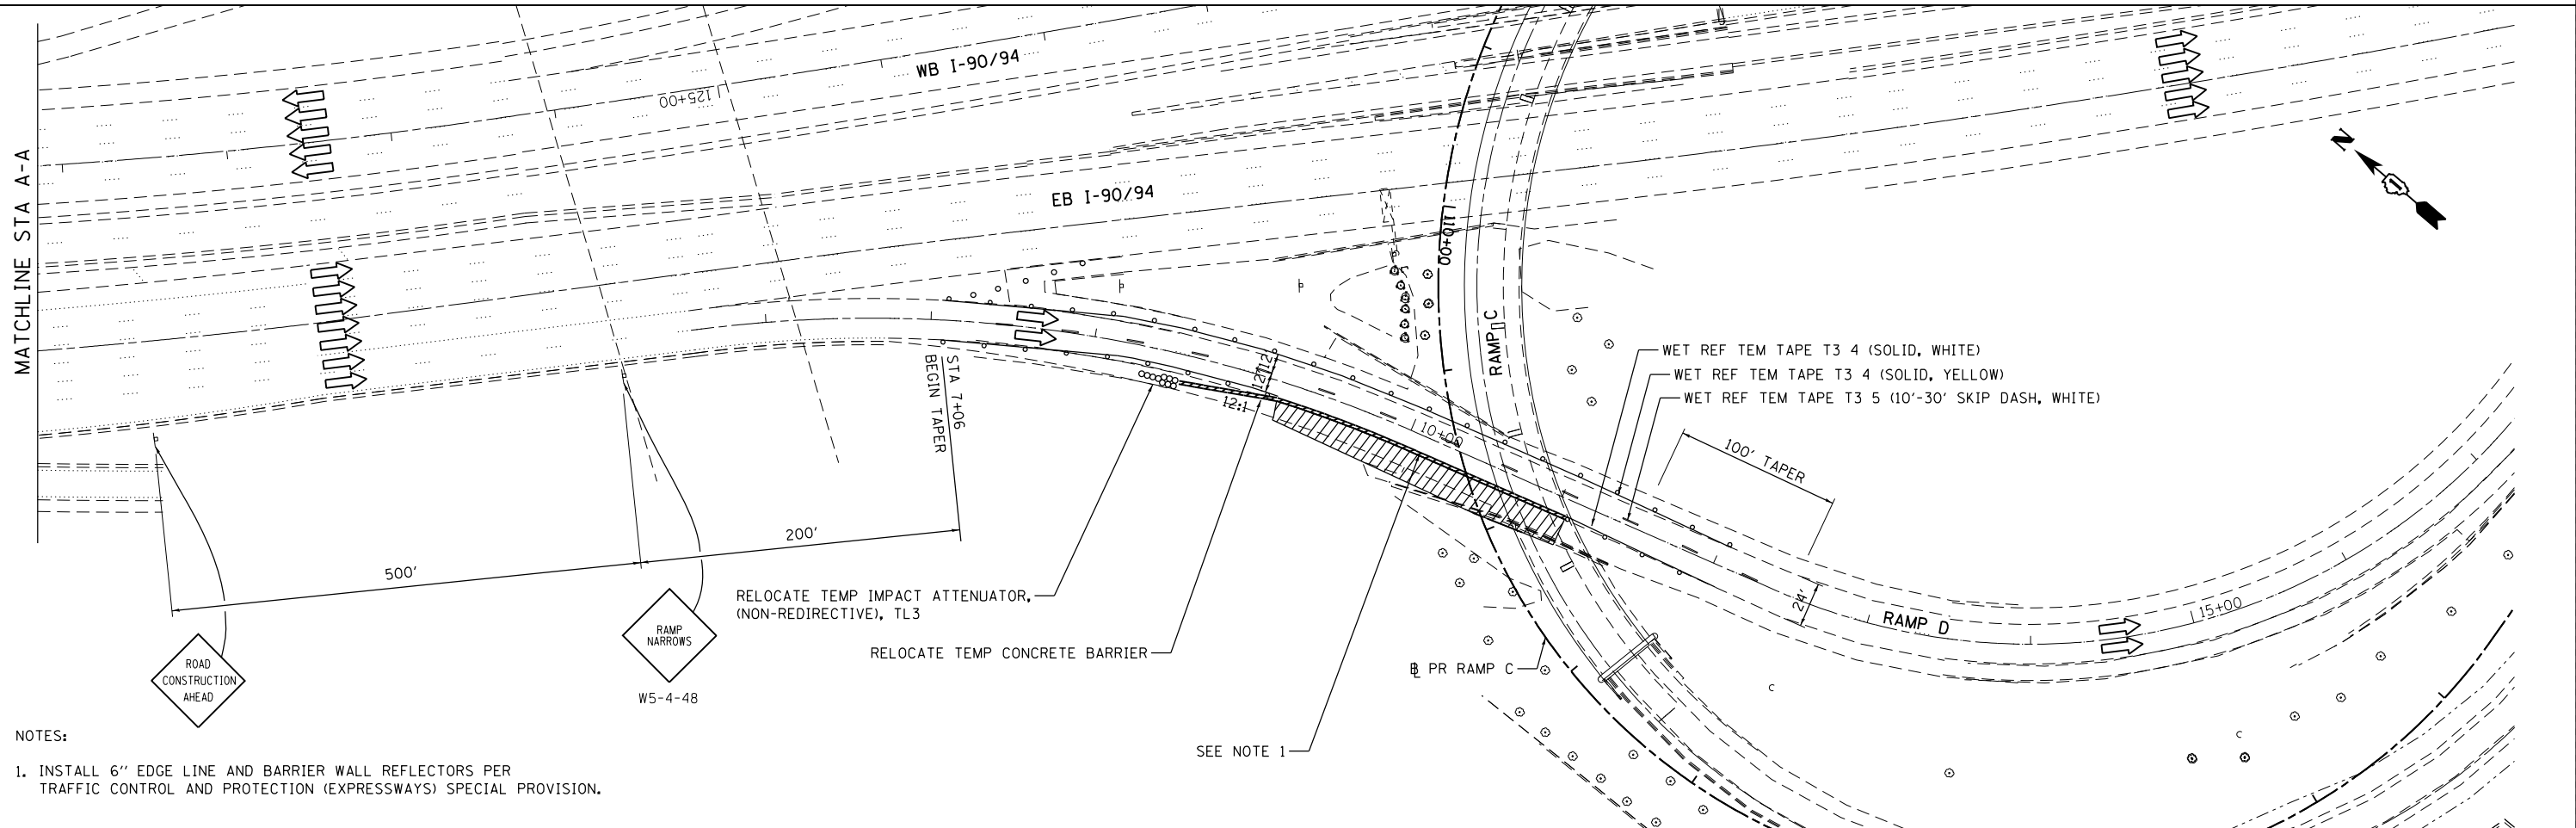

NOTES:
 1. INSTALL 6" EDGE LINE AND BARRIER WALL REFLECTORS PER TRAFFIC CONTROL AND PROTECTION (EXPRESSWAYS) SPECIAL PROVISION.

FILE NAME = I:\7000 - 194 at Ohio Street\CADD\CADD_SHEETS\MOT\1160F63-ht-staging-spl-RampD.dgn



| | | |
|-----------------------------|------------|-----------|
| USER NAME = rge11 | DESIGNED - | REVISED - |
| PLOT SCALE = 100.000' / in. | DRAWN - | REVISED - |
| PLOT DATE = 3/25/2013 | CHECKED - | REVISED - |
| | DATE - | REVISED - |



**STATE OF ILLINOIS
DEPARTMENT OF TRANSPORTATION**

**STAGING AND TRAFFIC CONTROL
RAMP D STAGE I
SUBSTAGE B**

SCALE: SHEET NO. OF SHEETS STA. TO STA.

| | | | | |
|---|-------------------------|----------------|---------------------|-----------------|
| F.A.I. RTE. 90/94 | SECTION 0303-474HB-R | COUNTY COOK | TOTAL SHEETS 368 | SHEET NO. 78 |
| CONTRACT NO. 60F63 | | | | |
| FED. ROAD DIST. NO. 1 ILLINOIS FED. AID PROJECT | | | | |

FILE NAME = \\collinsengr.com\1\adator\1\Posanden\DDCS\Y2000 - I94 at Ohio Street\ACADD\CADD SHEETS\MOT\DI60F63-ph-tt-staging-stg\C-RampD.dgn

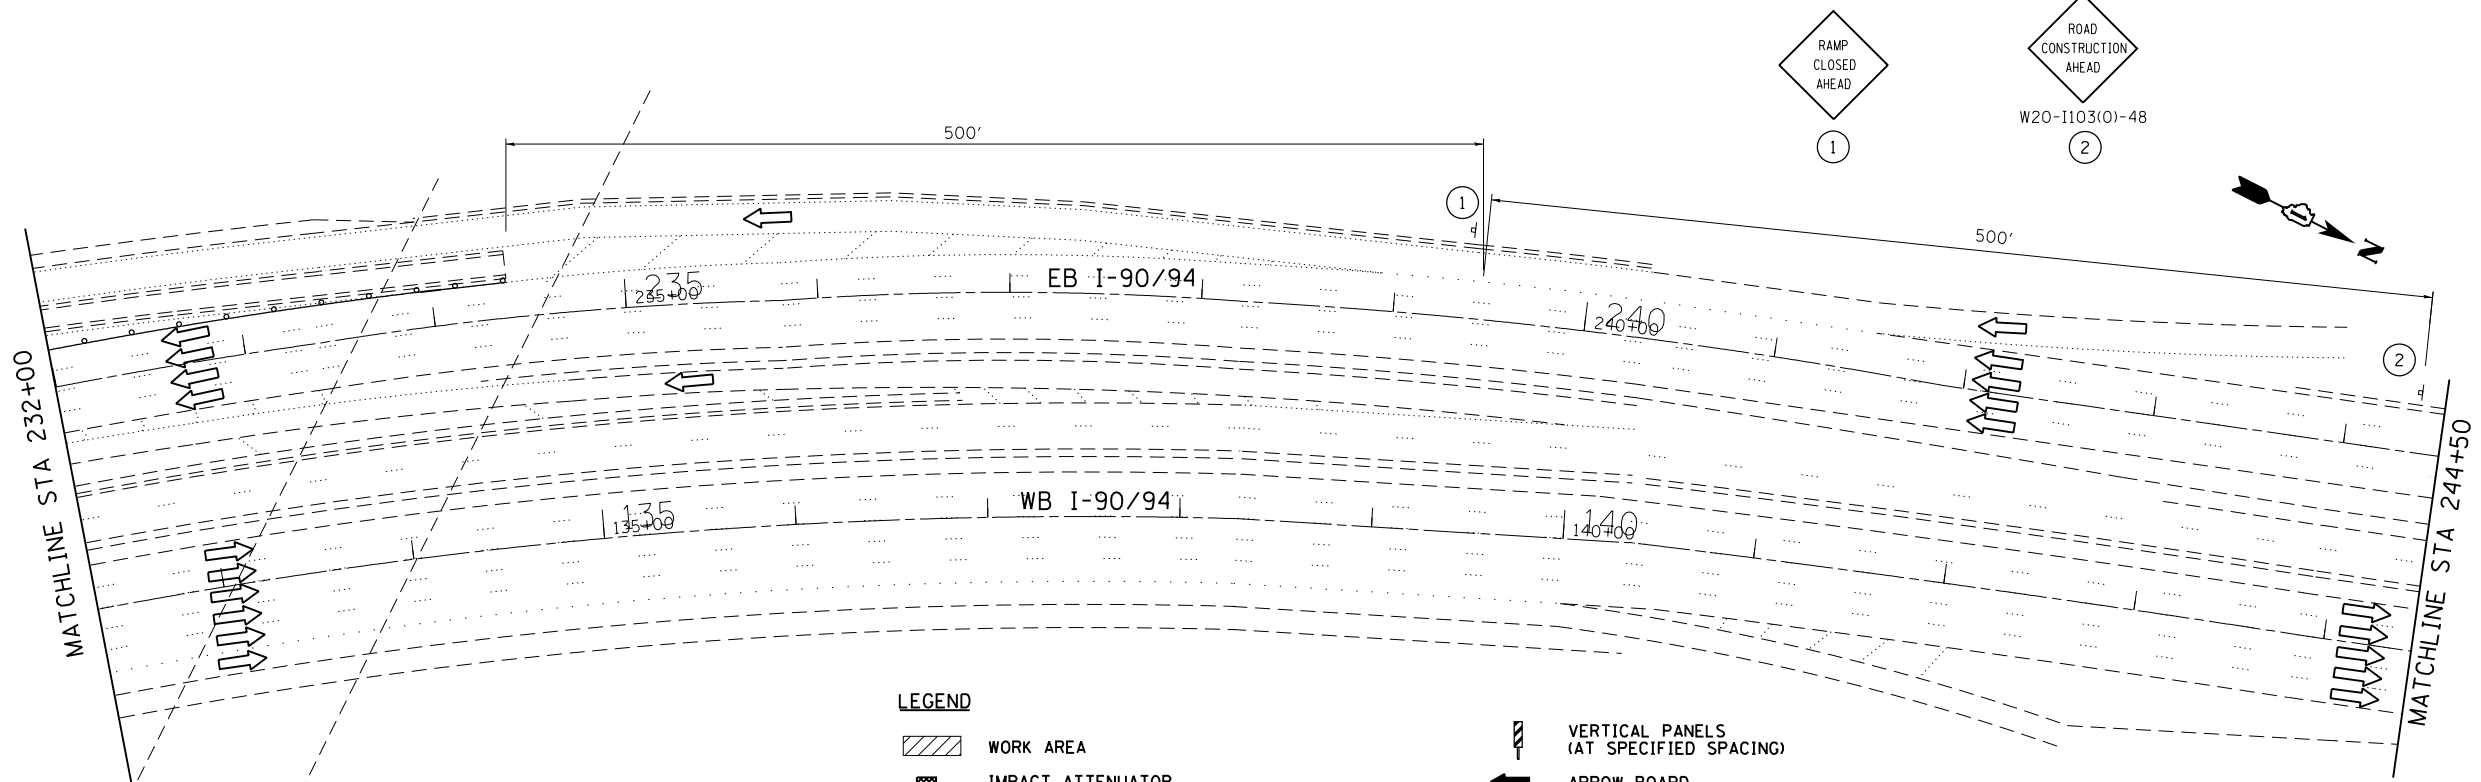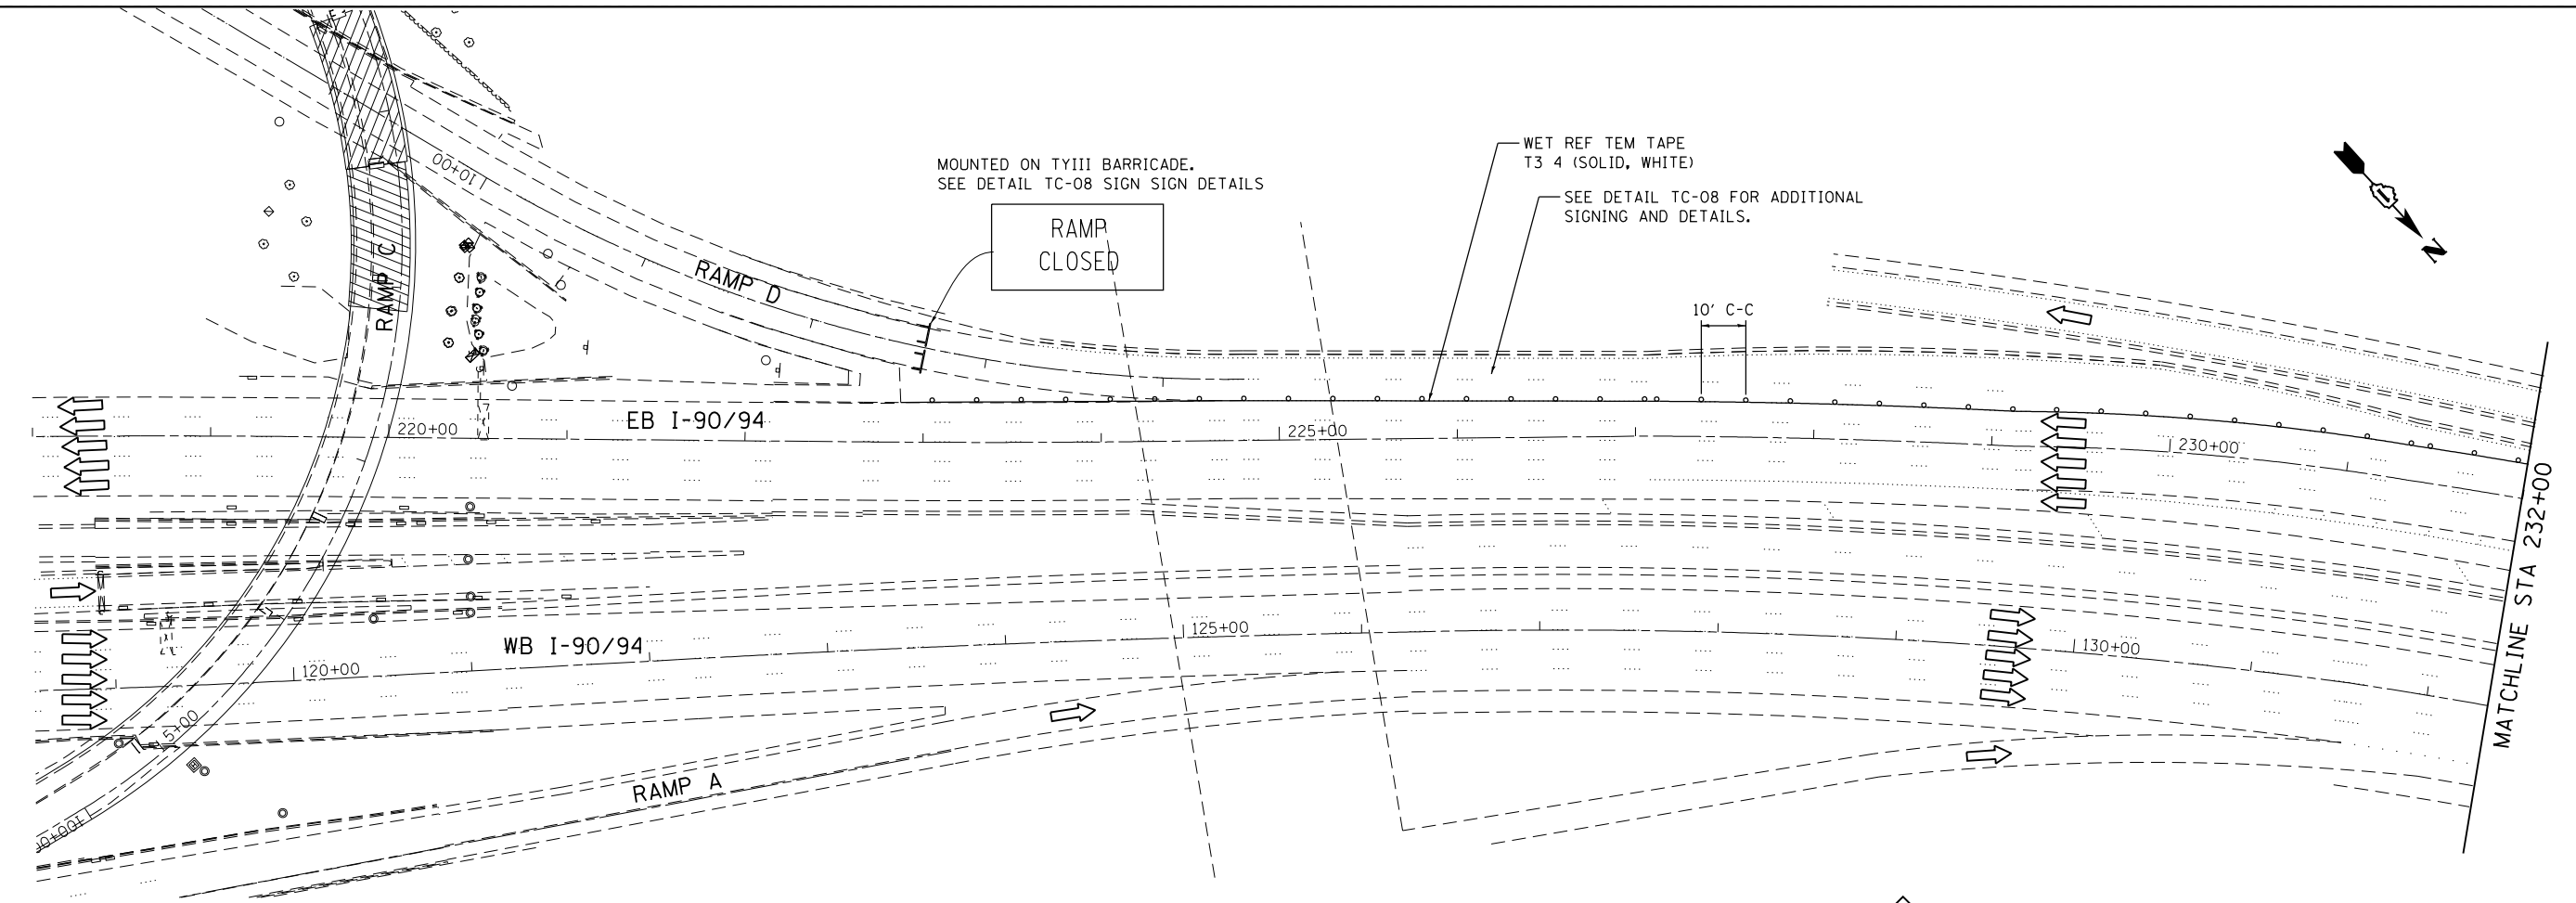

- LEGEND**
- WORK AREA
 - IMPACT ATTENUATOR
 - TEMPORARY CONCRETE BARRIER
 - TYPE II BARRICADES OR DRUMS WITH STEADY BURN MONODIRECTIONAL LIGHT (AT SPECIFIED SPACING)
 - DIRECTION OF TRAFFIC FLOW
 - SIGN
 - VERTICAL PANELS (AT SPECIFIED SPACING)
 - ARROW BOARD
 - TYPE III BARRICADE
 - BARRIER WALL MARKERS (AT SPECIFIED SPACING)
 - TEMPORARY PAVEMENT, CURRENT STAGE
 - TEMPORARY PAVEMENT, PREVIOUS STAGE

COLLINS ENGINEERS

| | | |
|--------------------------------|------------|-----------|
| USER NAME = r9e11 | DESIGNED - | REVISED - |
| PLOT SCALE = 100.000000' / in. | DRAWN - | REVISED - |
| PLOT DATE = 3/25/2013 | CHECKED - | REVISED - |
| | DATE - | REVISED - |


**STATE OF ILLINOIS
DEPARTMENT OF TRANSPORTATION**

**STAGING AND TRAFFIC CONTROL
RAMP D STAGE I
SUBSTAGE C**


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|--------|-----------|-----------|------|---------|
| SCALE: | SHEET NO. | OF SHEETS | STA. | TO STA. |
|--------|-----------|-----------|------|---------|

| | | | | |
|---|--------------|--------|--------------|-----------|
| F.A.I. RE. | SECTION | COUNTY | TOTAL SHEETS | SHEET NO. |
| 90/94 | 0303-474HB-R | COOK | 368 | 79 |
| CONTRACT NO. 60F63 | | | | |
| FED. ROAD DIST. NO. 1 ILLINOIS FED. AID PROJECT | | | | |

FILE NAME = \\collinsengr.com\1\pawarden\DDCS\72000 - I34 at Ohio St\west\400D\CADD_SHEETS\MOT\DD60F63-ph-tt-stage2\temp\sign_stage2.dgn

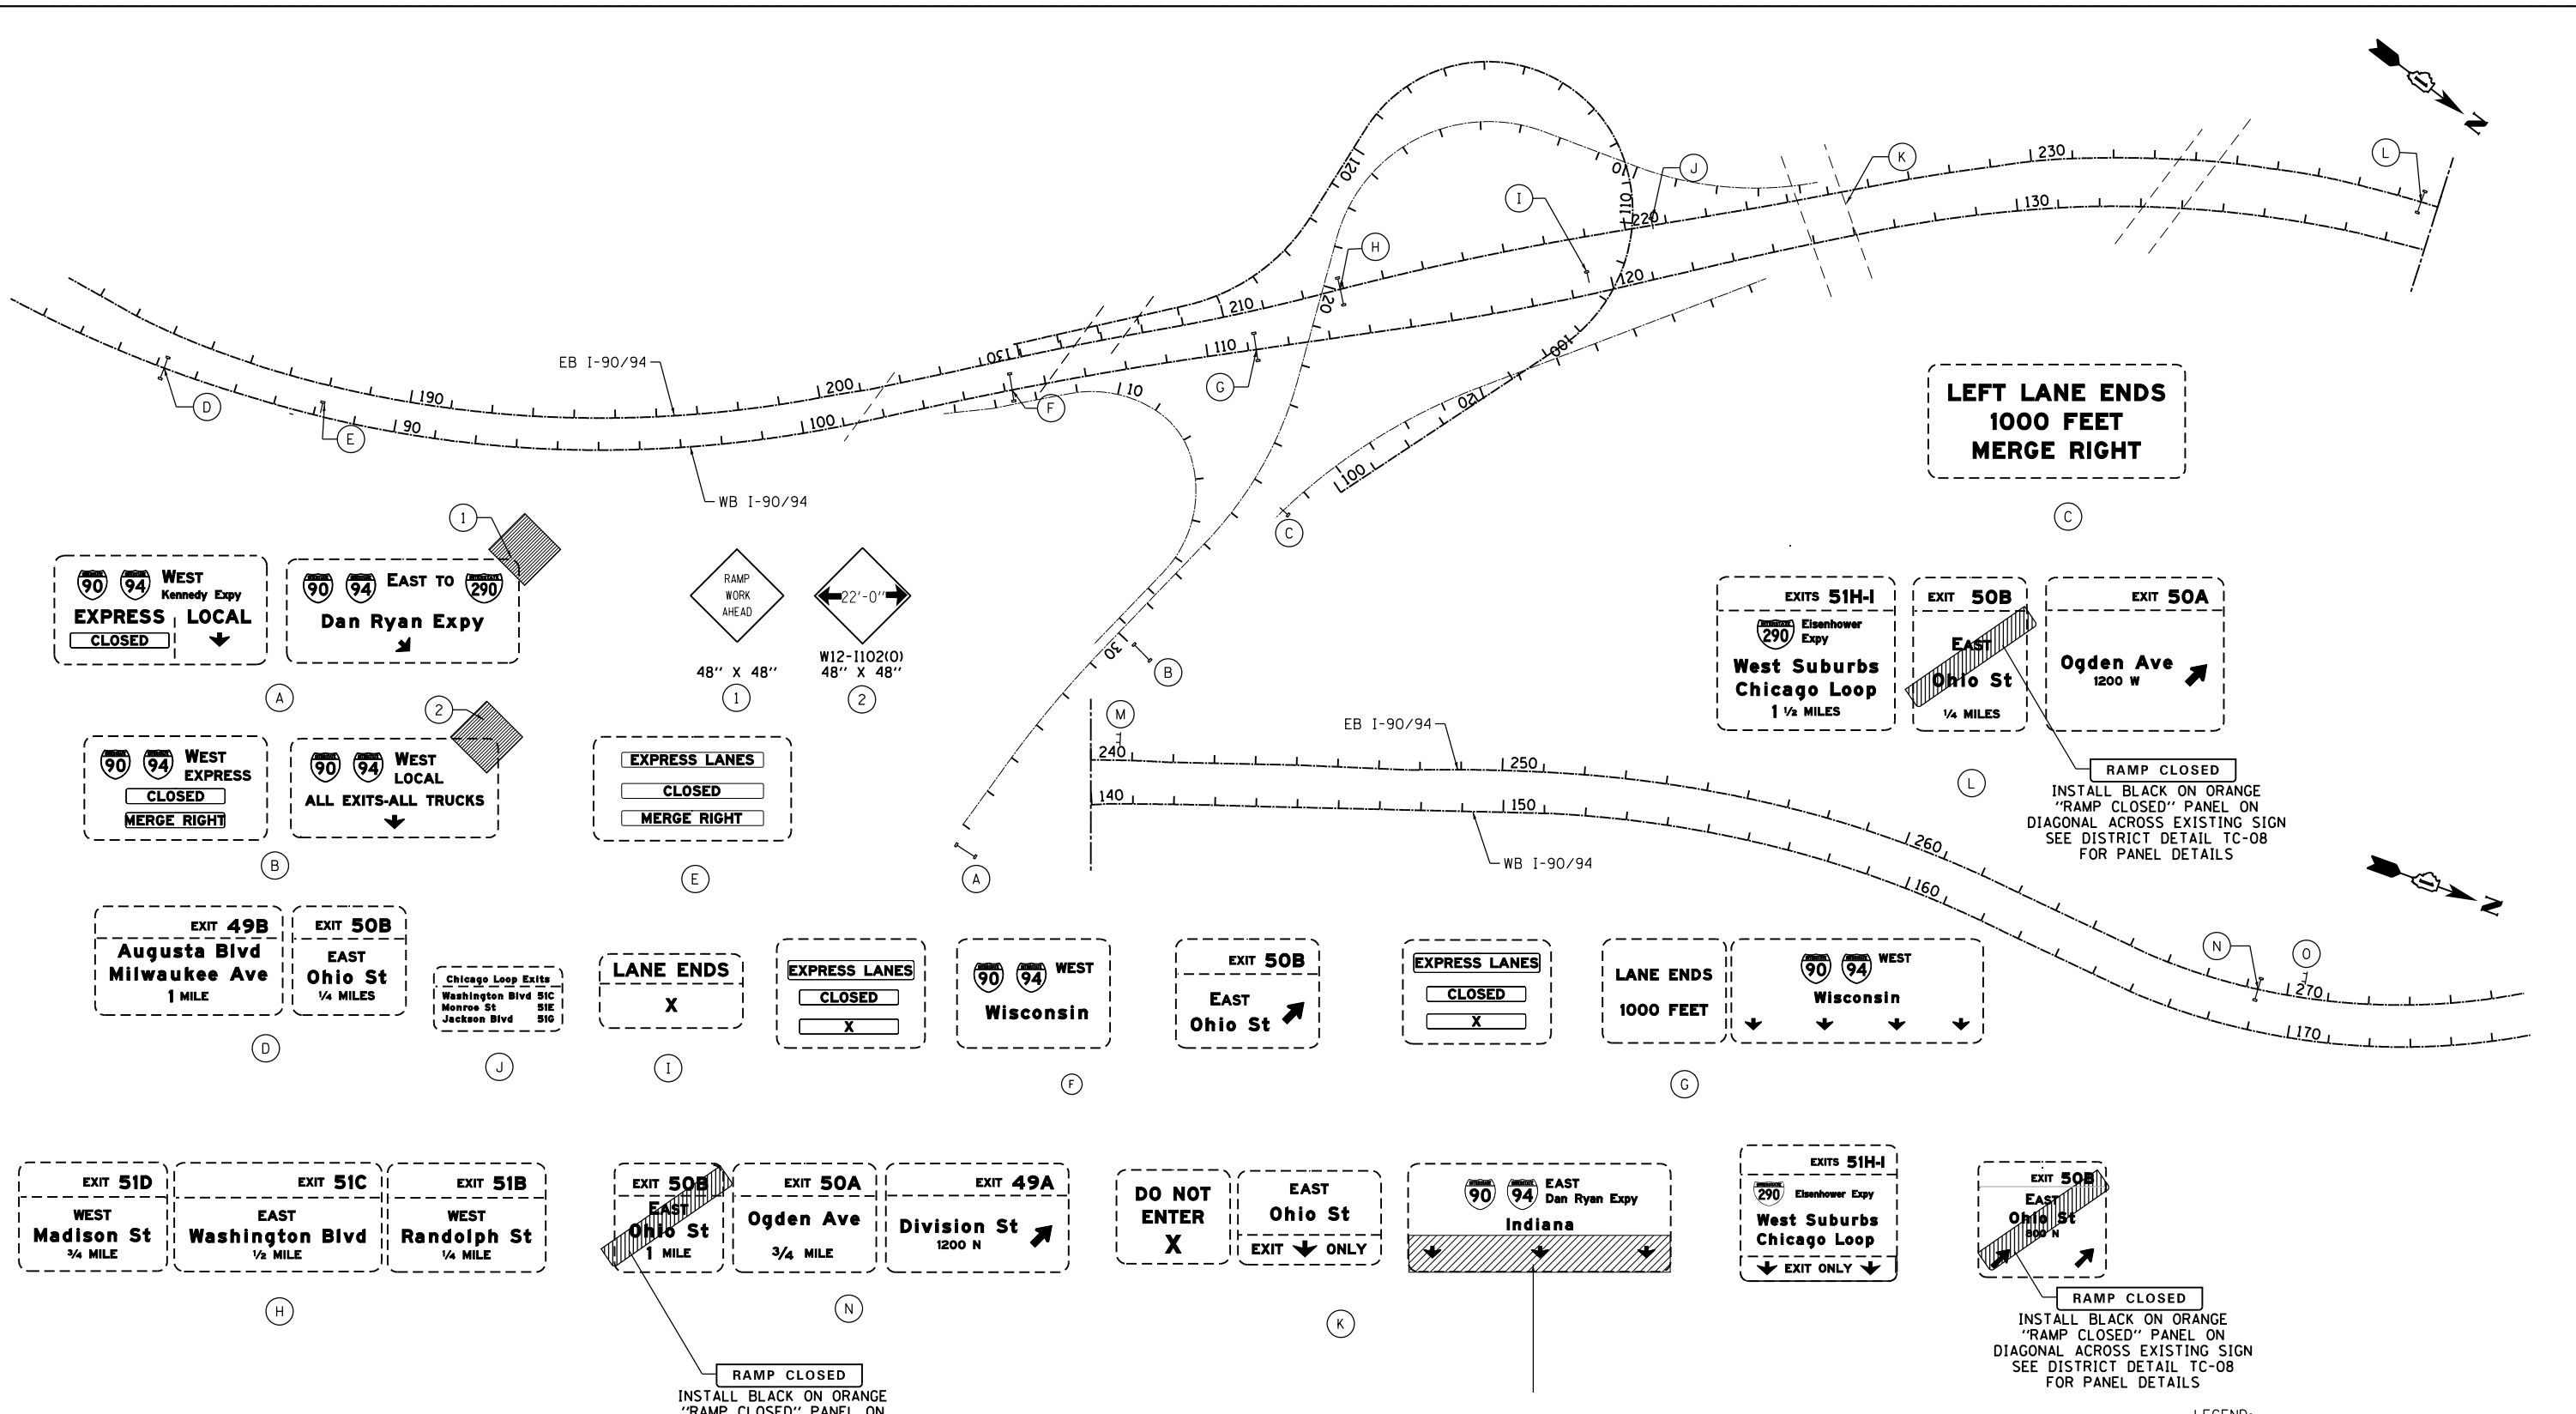

NOTES:
 1. CONTRACTOR SHALL FIELD VERIFY EXISTING SIGN PANEL DIMENSIONS BEFORE ORDERING AND FABRICATING TEMPORARY SIGN PANELS AND OVERLAYS.

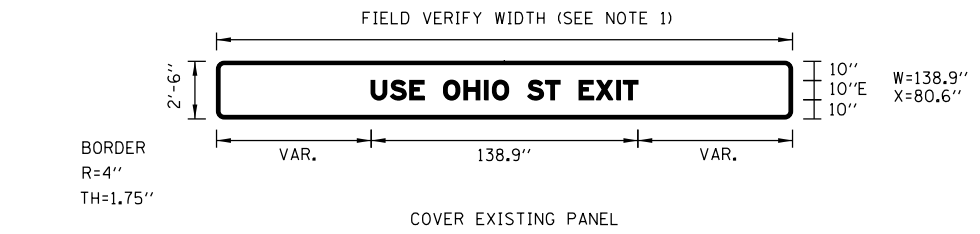

COLLINS ENGINEERS


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|--------------------------------|------------|-----------|
| USER NAME = rge11 | DESIGNED - | REVISED - |
| PLOT SCALE = 400.000000' / in. | DRAWN - | REVISED - |
| PLOT DATE = 3/25/2013 | CHECKED - | REVISED - |
| | DATE - | REVISED - |

**STATE OF ILLINOIS
 DEPARTMENT OF TRANSPORTATION**

**TEMPORARY SIGNING PLAN
 STAGE II - SUBSTAGE A & B**


SCALE: SHEET NO. OF SHEETS STA. TO STA.

| | | | | |
|---|----------------------|-------------|------------------|--------------|
| F.A.I. R.E. 90/94 | SECTION 0303-474HB-R | COUNTY COOK | TOTAL SHEETS 368 | SHEET NO. 80 |
| CONTRACT NO. 60F63 | | | | |
| FED. ROAD DIST. NO. 1 ILLINOIS FED. AID PROJECT | | | | |

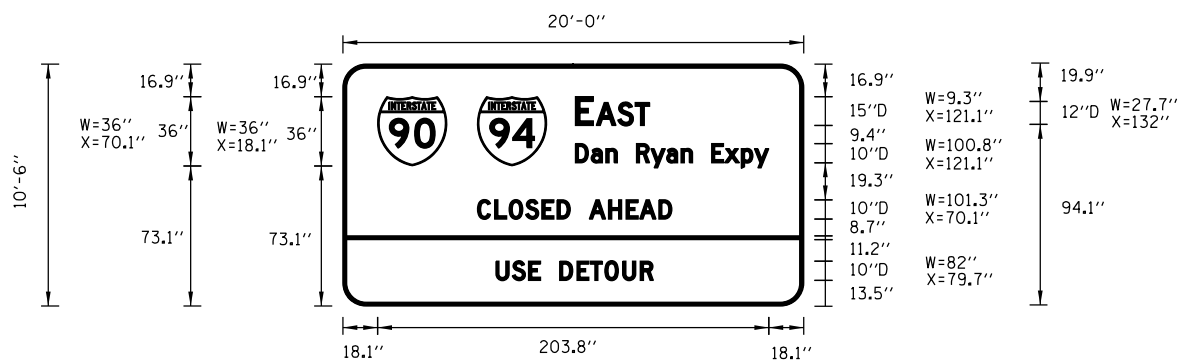

BORDER
 R=12"
 TH=2"
 BLACK LETTERING ON ORANGE BACKGROUND

(O)

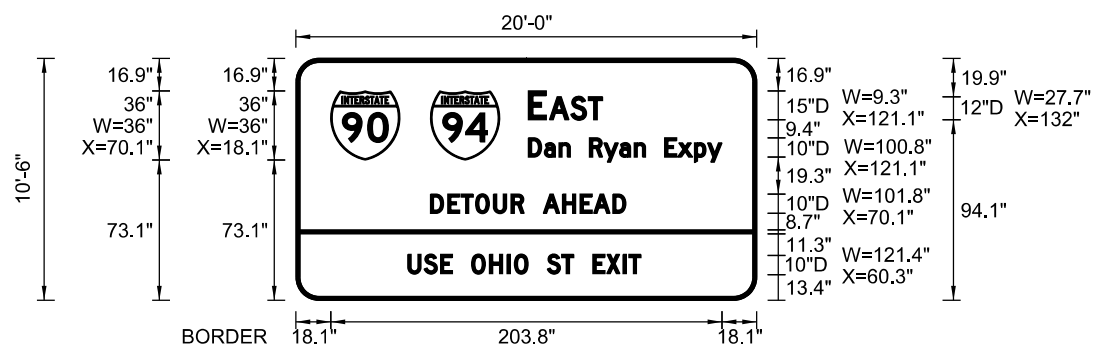

BORDER
 R=12"
 TH=2"
 BLACK LETTERING ON ORANGE BACKGROUND

(M)

FILE NAME = \\collinsengr.com\1\adate\1\Posarden\DDCS\7000 - I94 at Ohio Street\CA00\CADD SHEETS\MOT\060663-ph-t-staging-temp\sign_stage2.dgn




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|--------------------------------|------------|-----------|
| USER NAME = rge11 | DESIGNED - | REVISED - |
| PLOT SCALE = 400.000000' / in. | DRAWN - | REVISED - |
| PLOT DATE = 3/25/2013 | CHECKED - | REVISED - |
| | DATE - | REVISED - |

STATE OF ILLINOIS
 DEPARTMENT OF TRANSPORTATION

TEMPORARY SIGNING PLAN
 STAGE II - SUBSTAGE A & B

SCALE: SHEET NO. OF SHEETS STA. TO STA.


| F.A.I. RTE. | SECTION | COUNTY | TOTAL SHEETS | SHEET NO. |
|---|--------------|--------|--------------|-----------|
| 90/94 | 0303-474HB-R | COOK | 368 | 81 |
| CONTRACT NO. 60F63 | | | | |
| FED. ROAD DIST. NO. 1 ILLINOIS FED. AID PROJECT | | | | |

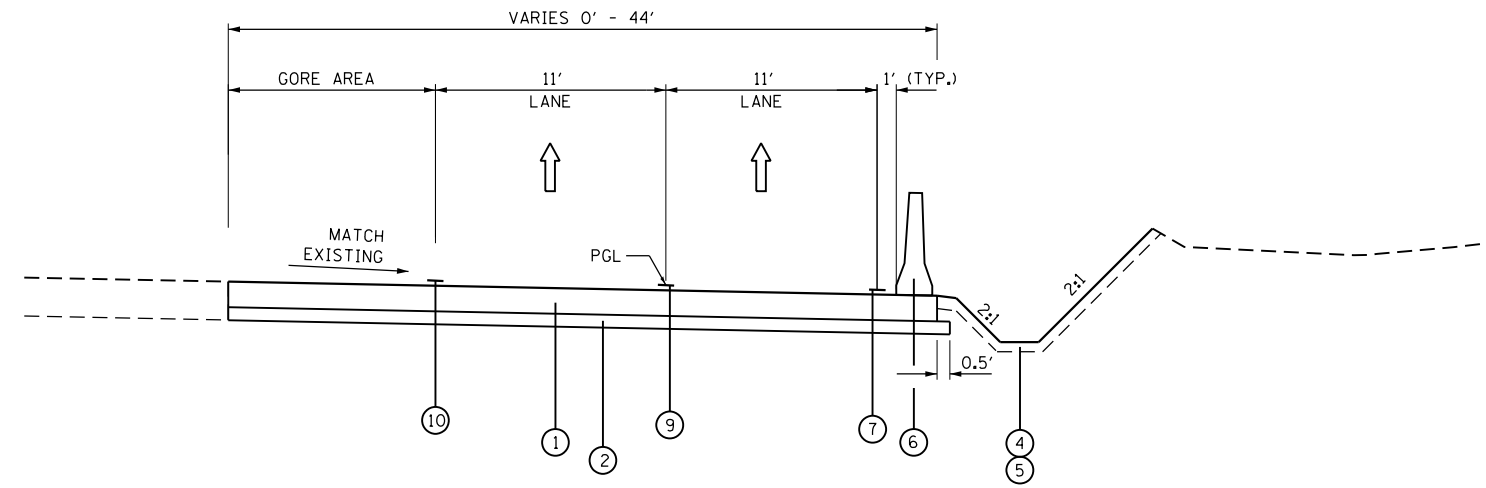

MOT RUNAROUND - STAGE II SUBSTAGE A
STA 100+00 TO STA 102+26

PROPOSED LEGEND:

- ① TEMPORARY PAVEMENT, 8"
- ② AGGREGATE SUBGRADE IMPROVEMENT, 4"
- ③ AGGREGATE SHOULDERS, TYPE B, 6"
- ④ TEMPORARY EROSION CONTROL SEEDING
- ⑤ TEMPORARY CONCRETE BARRIER
- ⑥ TEMPORARY CONCRETE BARRIER, RELOCATE
- ⑦ WET REFLECTIVE TEMPORARY TAPE TYPE III - LINE 4" WHITE
- ⑧ WET REFLECTIVE TEMPORARY TAPE TYPE III - LINE 4" YELLOW
- ⑨ WET REFLECTIVE TEMPORARY TAPE TYPE III - LINE 4" WHITE (2' DASH - 6' SKIP)
- ⑩ WET REFLECTIVE TEMPORARY TAPE TYPE III - LINE 8" WHITE
- ⑪ TEMPORARY SOIL RETENTION. SEE STRUCTURAL PLANS.

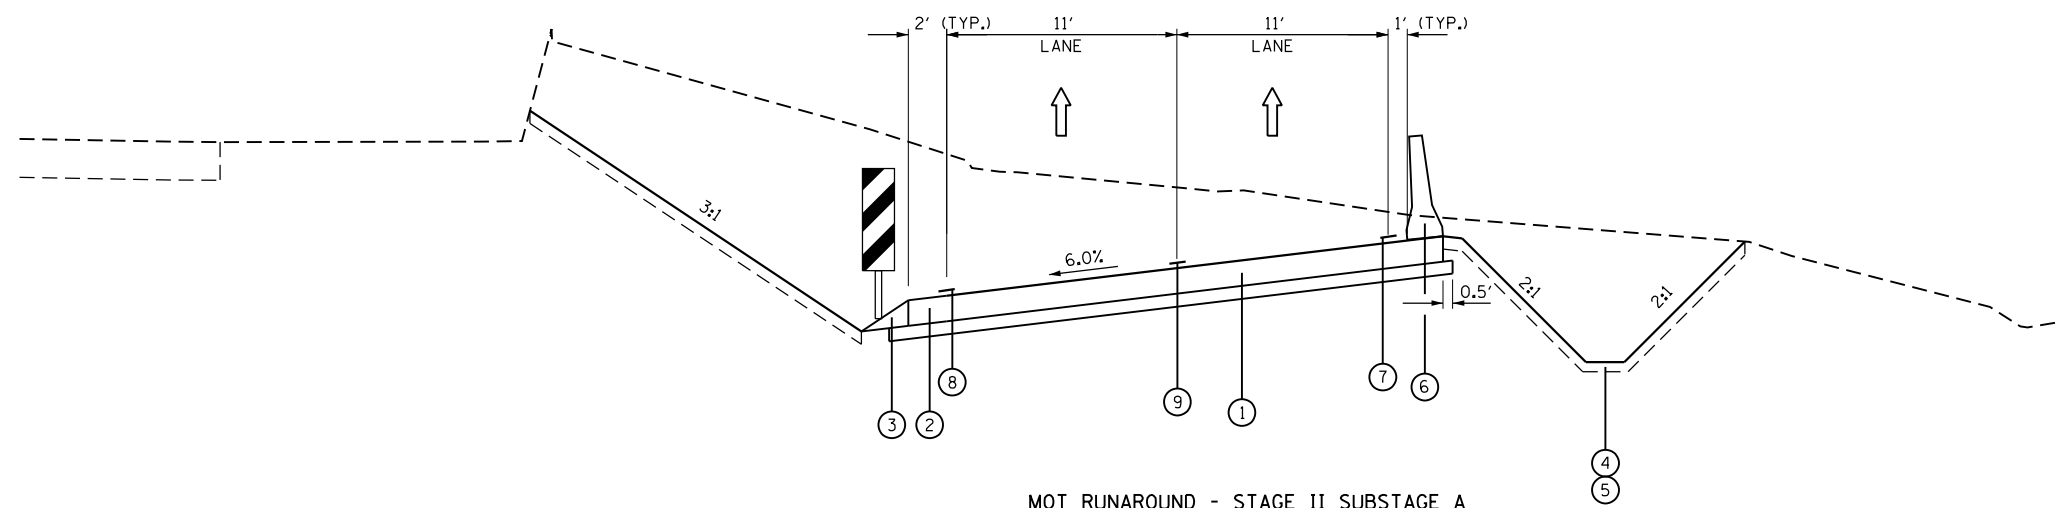

MOT RUNAROUND - STAGE II SUBSTAGE A
STA 102+26 TO STA 102+50

FILE NAME = I:\7000 - 194 at Ohio Street\CADD\CADD_SHEETS\MOT\0160F63-ht-staging-tp-stg2-temp-runaround.dgn




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|-----------------------------|------------|-----------|
| USER NAME = rge11 | DESIGNED - | REVISED - |
| PLOT SCALE = 10.0000' / in. | DRAWN - | REVISED - |
| PLOT DATE = 3/25/2013 | CHECKED - | REVISED - |
| | DATE - | REVISED - |

**STATE OF ILLINOIS
DEPARTMENT OF TRANSPORTATION**

**STAGING AND TRAFFIC CONTROL
I-90/94 TEMPORARY RUNAROUND
TYPICAL SECTIONS STAGE II**

SCALE: SHEET NO. OF SHEETS STA. TO STA.

| F.A.I. RTE. | SECTION | COUNTY | TOTAL SHEETS | SHEET NO. |
|---|--------------|--------|--------------|-----------|
| 90/94 | 0303-474HB-R | COOK | 368 | 82 |
| CONTRACT NO. 60F63 | | | | |
| FED. ROAD DIST. NO. 1 ILLINOIS FED. AID PROJECT | | | | |

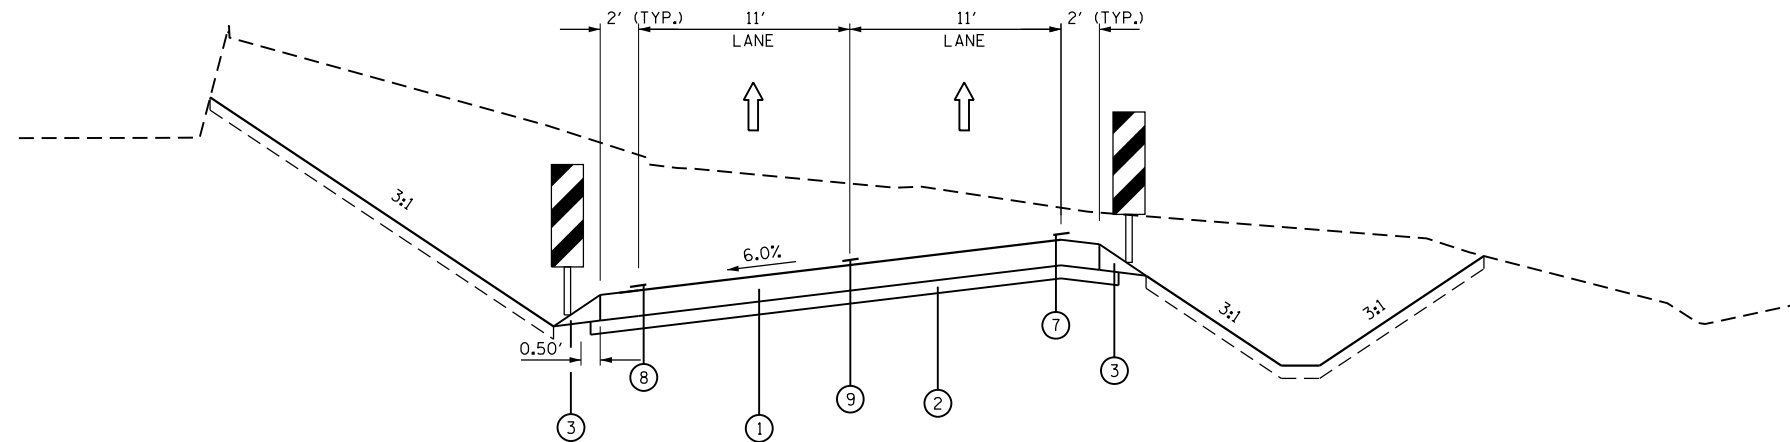


MOT RUNAROUND - STAGE II SUBSTAGE A

STA 102+50 TO STA 103+87

PROPOSED LEGEND:

- ① TEMPORARY PAVEMENT, 8"
- ② AGGREGATE SUBGRADE IMPROVEMENT, 4"
- ③ AGGREGATE SHOULDERS, TYPE B, 6"
- ④ TEMPORARY EROSION CONTROL SEEDING
- ⑤ TEMPORARY CONCRETE BARRIER
- ⑥ TEMPORARY CONCRETE BARRIER, RELOCATE
- ⑦ WET REFLECTIVE TEMPORARY TAPE TYPE III - LINE 4" WHITE
- ⑧ WET REFLECTIVE TEMPORARY TAPE TYPE III - LINE 4" YELLOW
- ⑨ WET REFLECTIVE TEMPORARY TAPE TYPE III - LINE 4" WHITE (2' DASH - 6' SKIP)
- ⑩ WET REFLECTIVE TEMPORARY TAPE TYPE III - LINE 8" WHITE
- ⑪ TEMPORARY SOIL RETENTION. SEE STRUCTURAL PLANS.

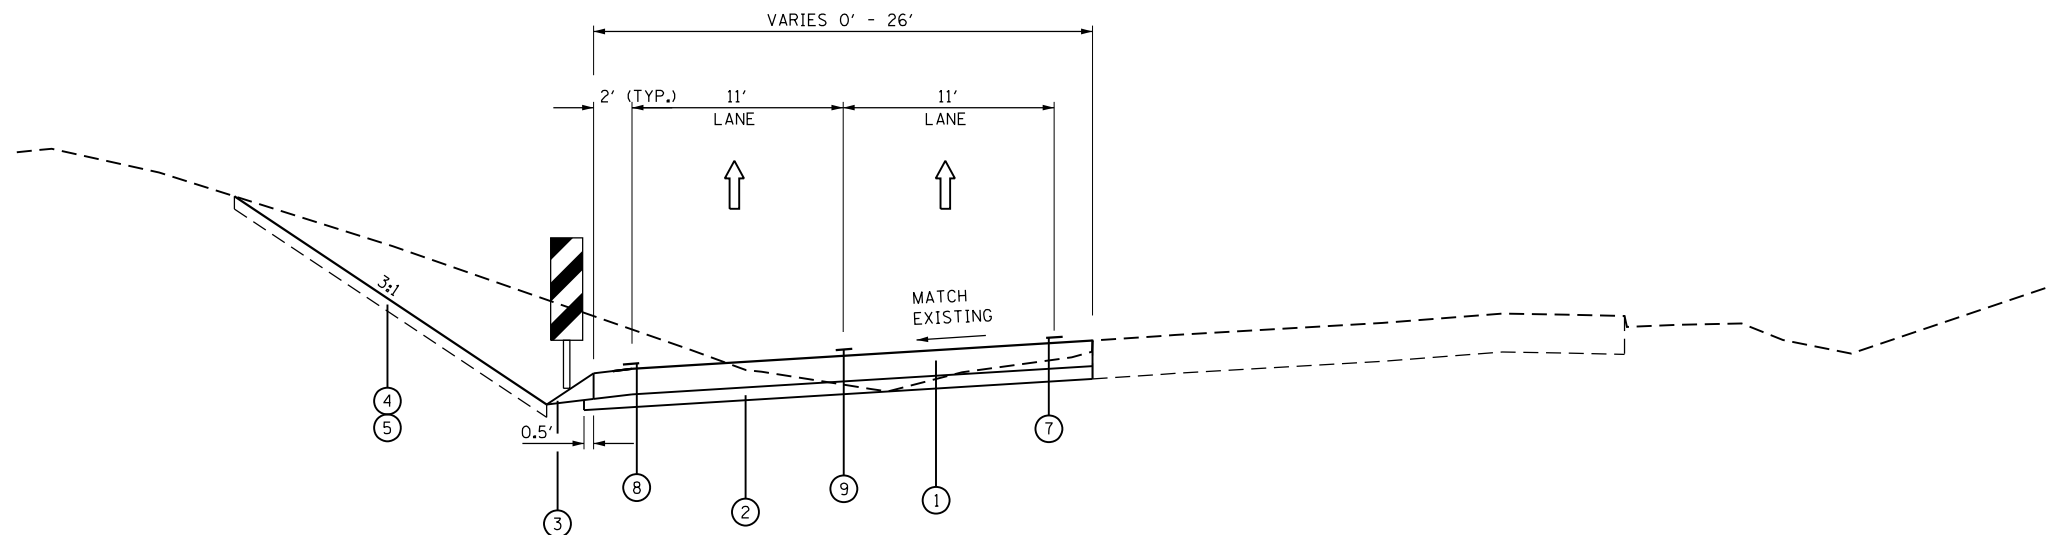

MOT RUNAROUND - STAGE II SUBSTAGE A

STA 103+87 TO STA 106+22

FILE NAME = I:\7000 - 194 at Ohio Street\CADD\CADD_SHEETS\MOT\0160F63-ht-staging_tfp-stg-temp-runaround.dgn



| | | |
|-----------------------------|------------|-----------|
| USER NAME = rge11 | DESIGNED - | REVISED - |
| PLOT SCALE = 10.0000' / in. | DRAWN - | REVISED - |
| PLOT DATE = 3/25/2013 | CHECKED - | REVISED - |
| | DATE - | REVISED - |


**STATE OF ILLINOIS
DEPARTMENT OF TRANSPORTATION**

**STAGING AND TRAFFIC CONTROL
I-90/94 TEMPORARY RUNAROUND
TYPICAL SECTIONS STAGE II**

SCALE: SHEET NO. OF SHEETS STA. TO STA.

| | | | | |
|---|--------------|--------|--------------|-----------|
| F.A.I. RTE. | SECTION | COUNTY | TOTAL SHEETS | SHEET NO. |
| 90/94 | 0303-474HB-R | COOK | 368 | 83 |
| CONTRACT NO. 60F63 | | | | |
| FED. ROAD DIST. NO. 1 ILLINOIS FED. AID PROJECT | | | | |

FILE NAME = I:\7000 - 194 at Ohio Street\CADD\CADD_SHEETS\MOT\DI60F63-ht-staging-194-94.dgn

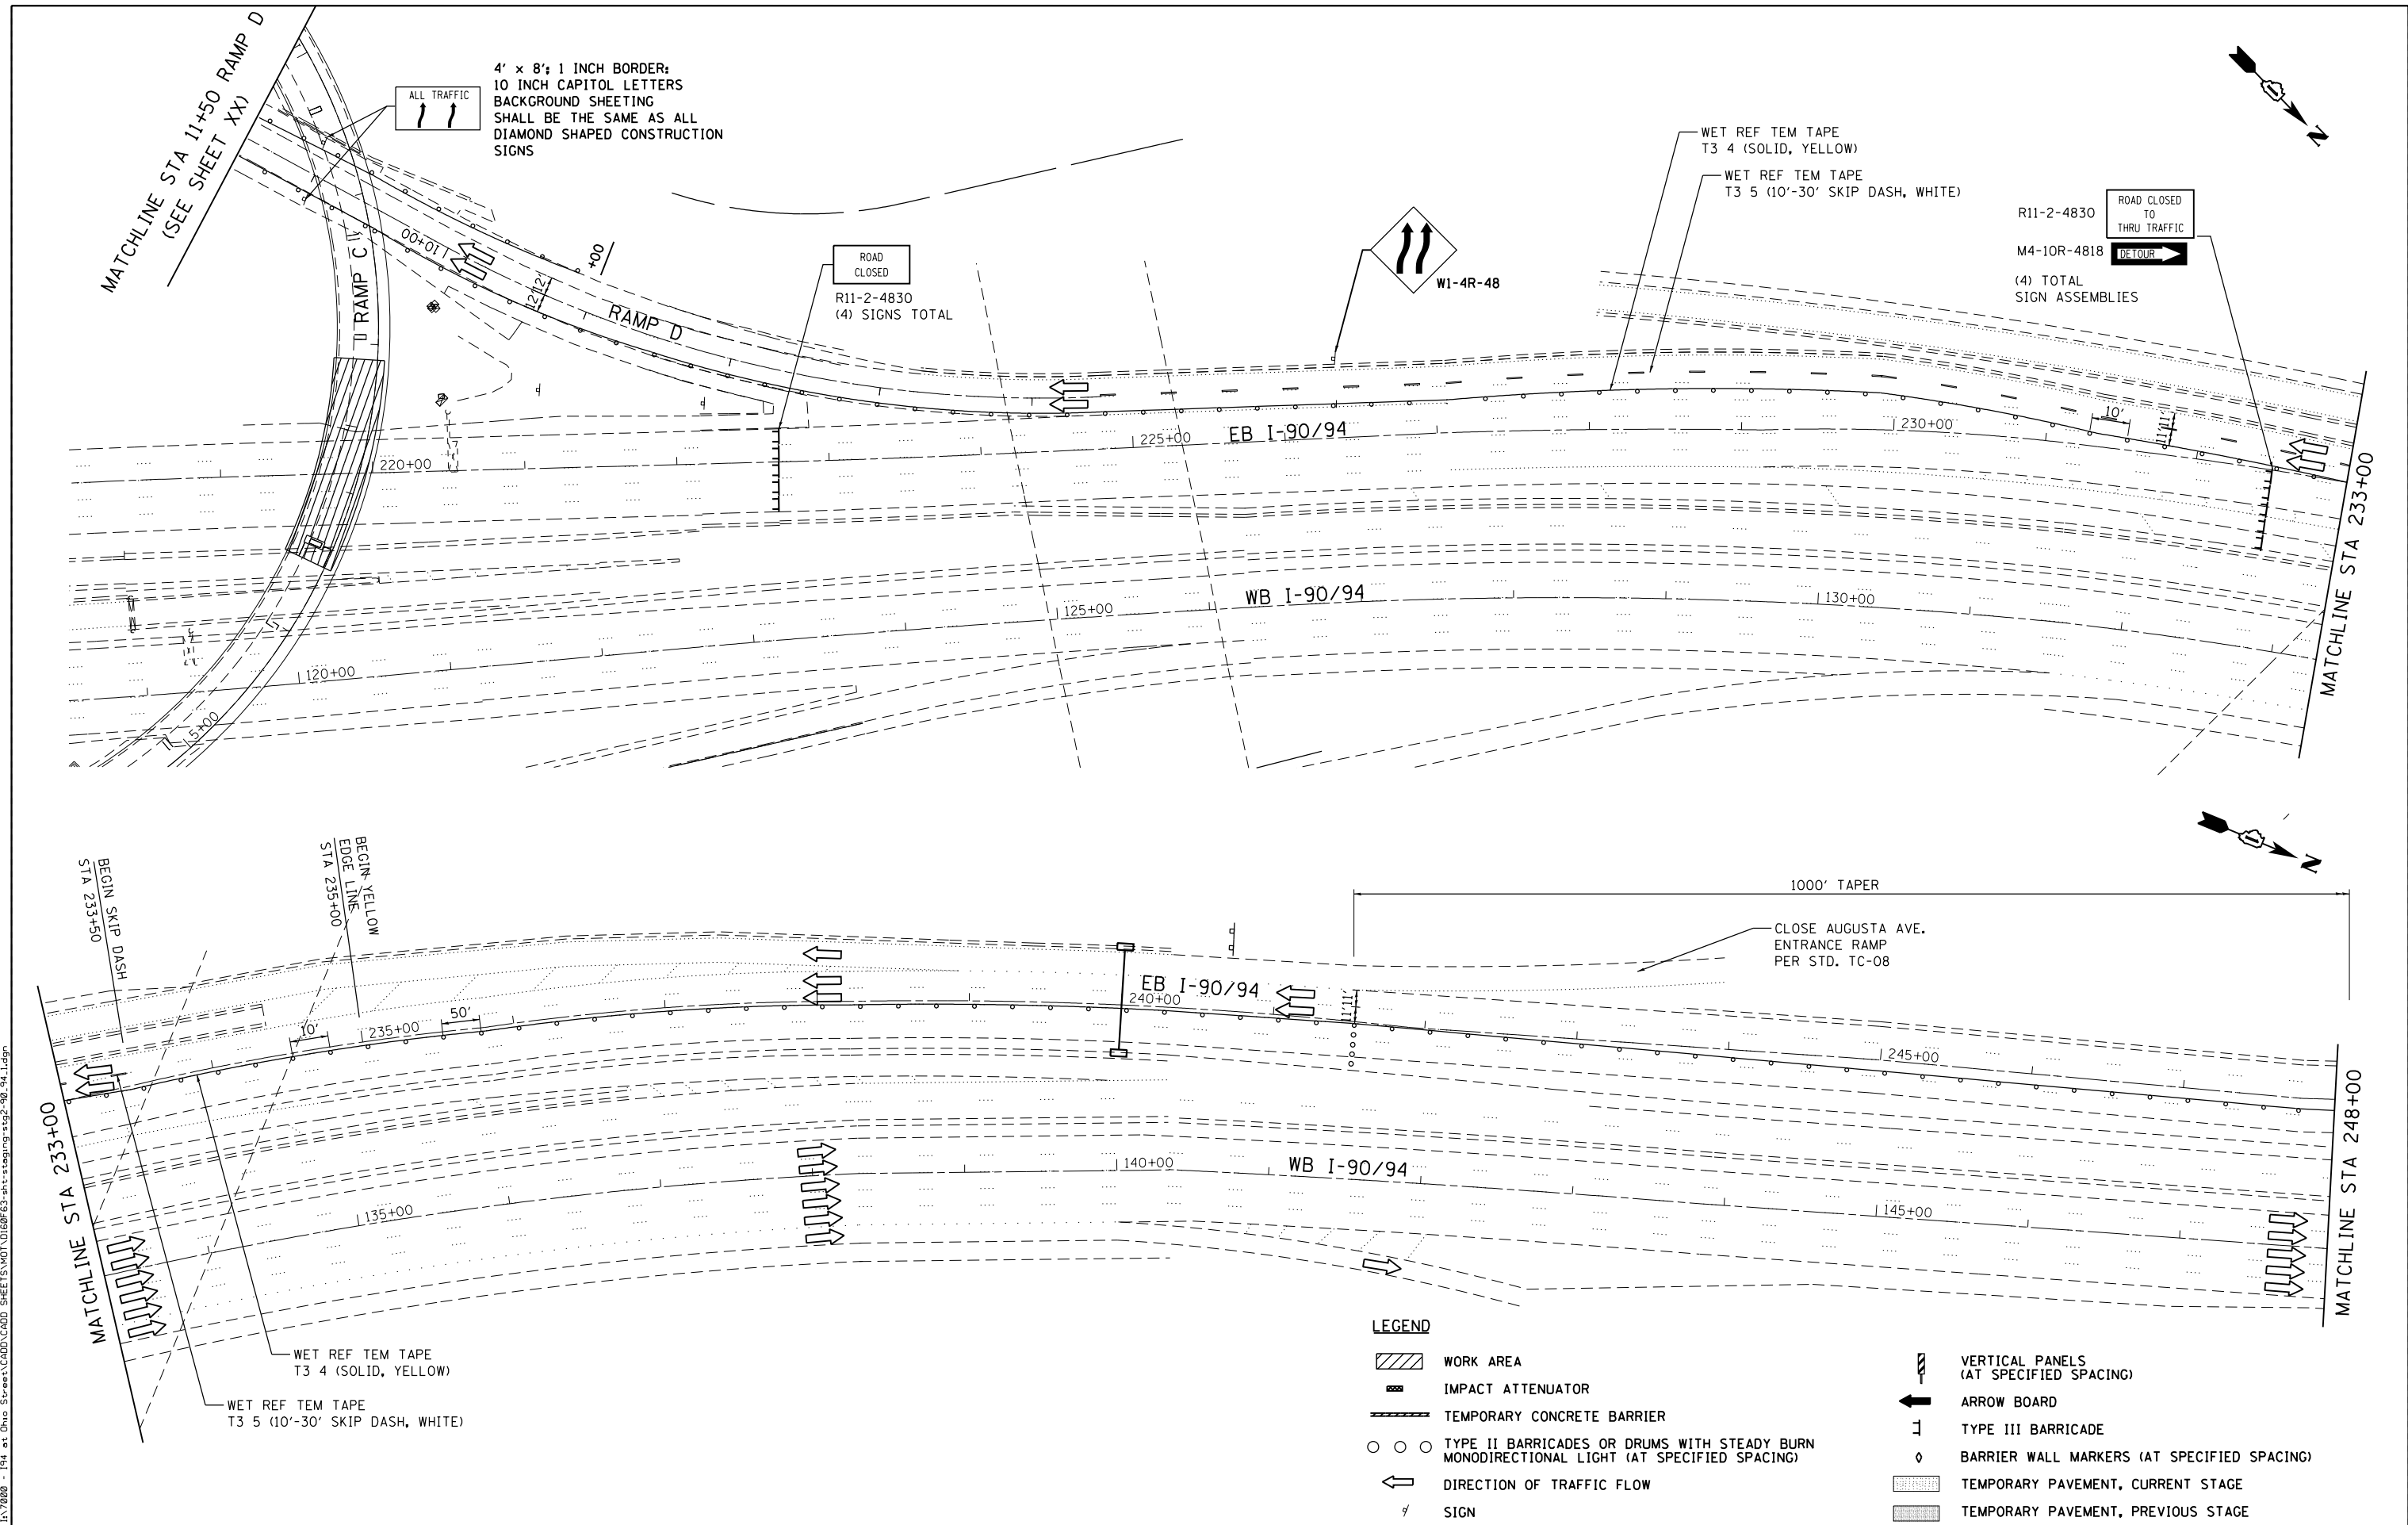

4' x 8' 1 INCH BORDER;
10 INCH CAPITAL LETTERS
BACKGROUND SHEETING
SHALL BE THE SAME AS ALL
DIAMOND SHAPED CONSTRUCTION
SIGNS



ROAD
CLOSED
R11-2-4830
(4) SIGNS TOTAL



WET REF TEM TAPE
T3 4 (SOLID, YELLOW)

WET REF TEM TAPE
T3 5 (10'-30' SKIP DASH, WHITE)

R11-2-4830
ROAD CLOSED
THRU TRAFFIC
M4-10R-4818
DETOUR
(4) TOTAL
SIGN ASSEMBLIES

1000' TAPER

CLOSE AUGUSTA AVE.
ENTRANCE RAMP
PER STD. TC-08

WET REF TEM TAPE
T3 4 (SOLID, YELLOW)

WET REF TEM TAPE
T3 5 (10'-30' SKIP DASH, WHITE)

LEGEND

- WORK AREA
- IMPACT ATTENUATOR
- TEMPORARY CONCRETE BARRIER
- TYPE II BARRICADES OR DRUMS WITH STEADY BURN MONODIRECTIONAL LIGHT (AT SPECIFIED SPACING)
- DIRECTION OF TRAFFIC FLOW
- SIGN
- VERTICAL PANELS (AT SPECIFIED SPACING)
- ARROW BOARD
- TYPE III BARRICADE
- BARRIER WALL MARKERS (AT SPECIFIED SPACING)
- TEMPORARY PAVEMENT, CURRENT STAGE
- TEMPORARY PAVEMENT, PREVIOUS STAGE

COLLINS ENGINEERS

USER NAME = r9e11
PLOT SCALE = 100.000000' / in.
PLOT DATE = 3/25/2013

| | |
|------------|-----------|
| DESIGNED - | REVISED - |
| DRAWN - | REVISED - |
| CHECKED - | REVISED - |
| DATE - | REVISED - |





**STATE OF ILLINOIS
DEPARTMENT OF TRANSPORTATION**

**STAGING AND TRAFFIC CONTROL
I-90/94 STAGE II
SUBSTAGE A**

SCALE: SHEET NO. OF SHEETS STA. TO STA.

| F.A.I. RTE. | SECTION | COUNTY | TOTAL SHEETS | SHEET NO. |
|---|--------------|--------|--------------|-----------|
| 90/94 | 0303-474HB-R | COOK | 368 | 84 |
| CONTRACT NO. 60F63 | | | | |
| FED. ROAD DIST. NO. 1 ILLINOIS FED. AID PROJECT | | | | |

FILE NAME = I:\7000 - 194 at Ohio Street\CADD\CADD_SHEETS\MOT\1160F63-ht-staging-194.dgn

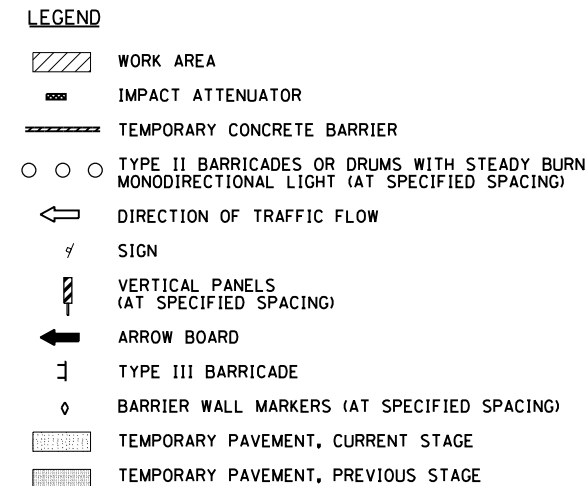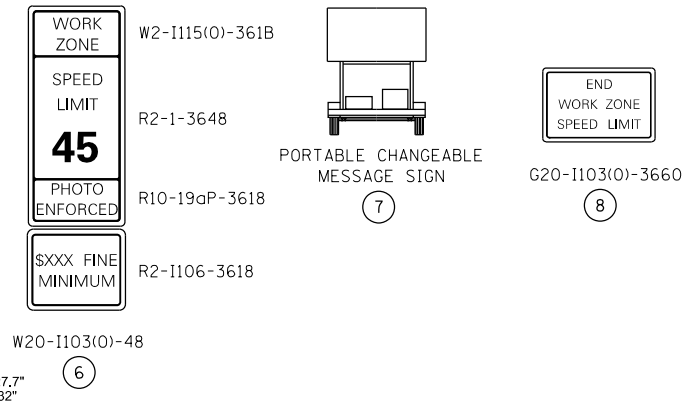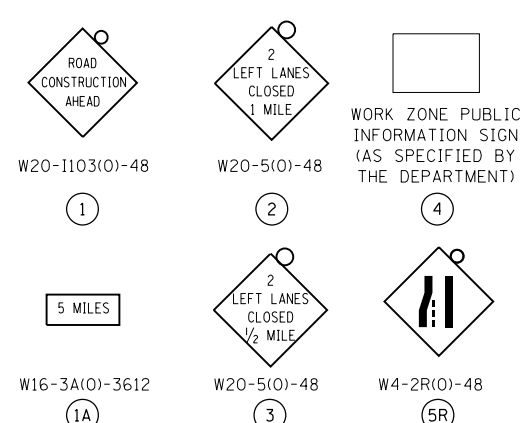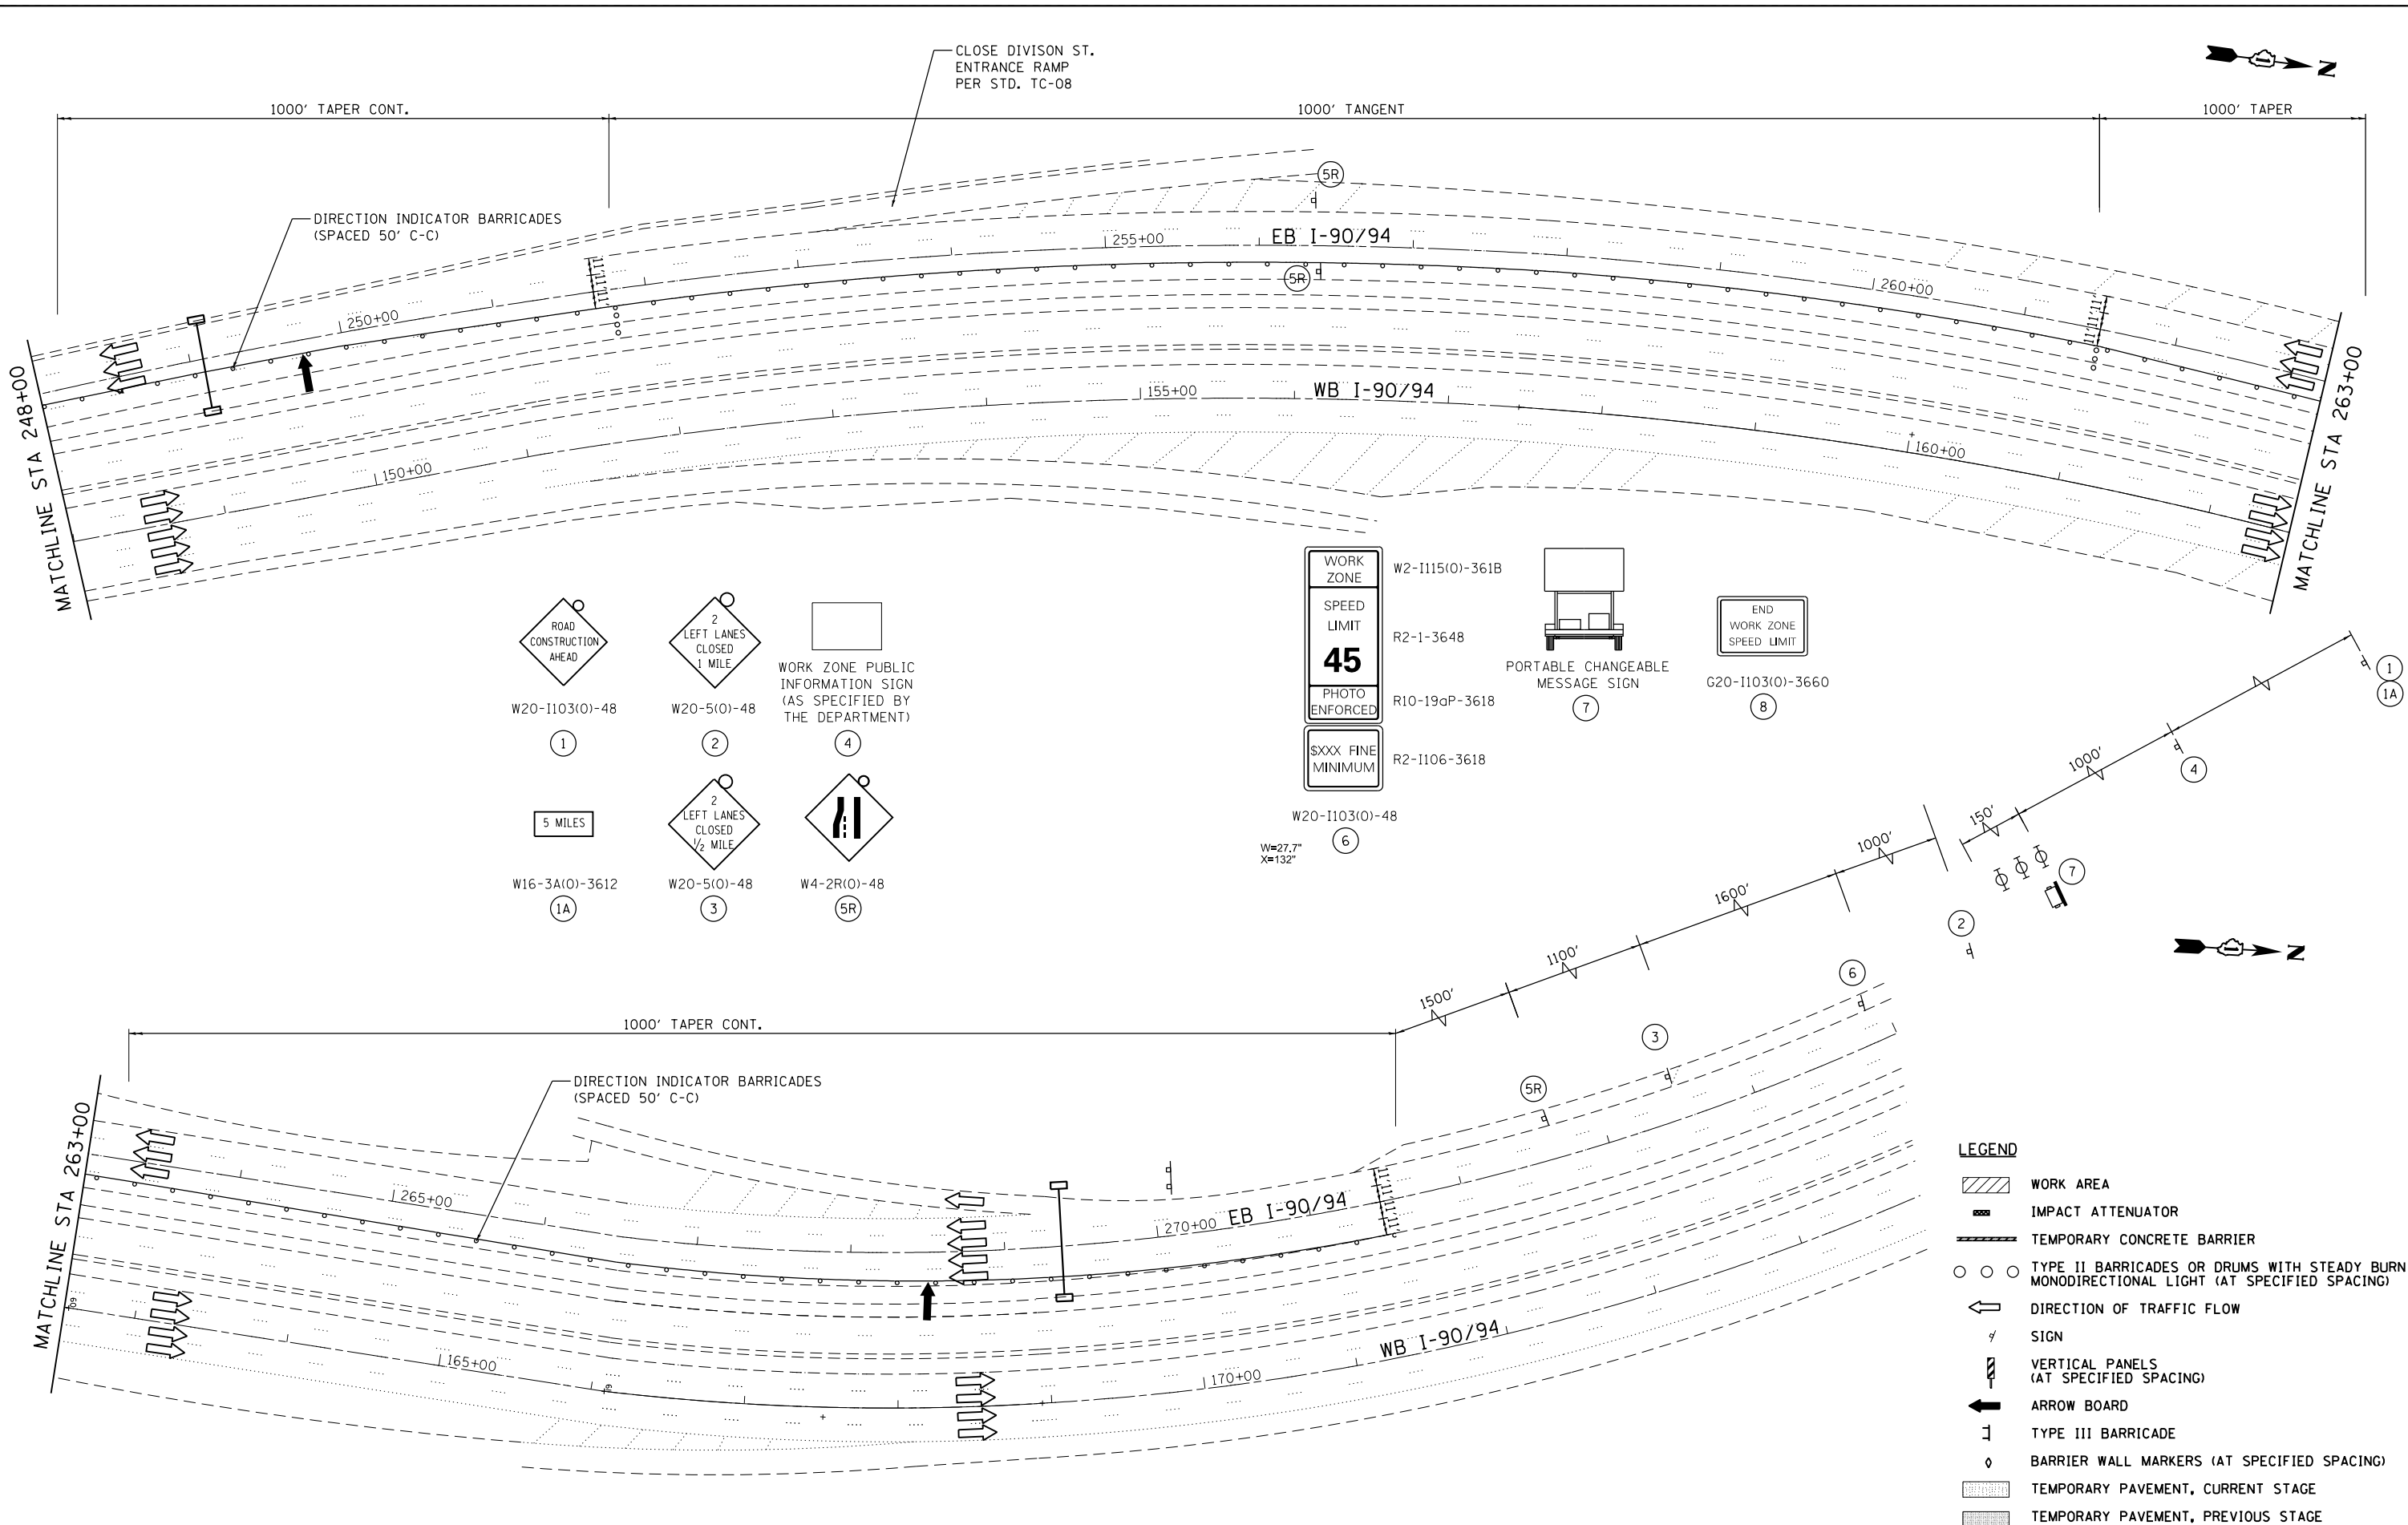

COLLINS ENGINEERS



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|--------------------------------|------------|-----------|
| USER NAME = rge11 | DESIGNED - | REVISED - |
| PLOT SCALE = 100.000000' / in. | DRAWN - | REVISED - |
| PLOT DATE = 3/25/2013 | CHECKED - | REVISED - |
| | DATE - | REVISED - |

**STATE OF ILLINOIS
DEPARTMENT OF TRANSPORTATION**


**STAGING AND TRAFFIC CONTROL
I-90/94 STAGE II
SUBSTAGE A**

SCALE: SHEET NO. OF SHEETS STA. TO STA.



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|---|----------------------|-------------|------------------|--------------|
| F.A.I. RE. 90/94 | SECTION 0303-474HB-R | COUNTY COOK | TOTAL SHEETS 368 | SHEET NO. 85 |
| CONTRACT NO. 60F63 | | | | |
| FED. ROAD DIST. NO. 1 ILLINOIS FED. AID PROJECT | | | | |

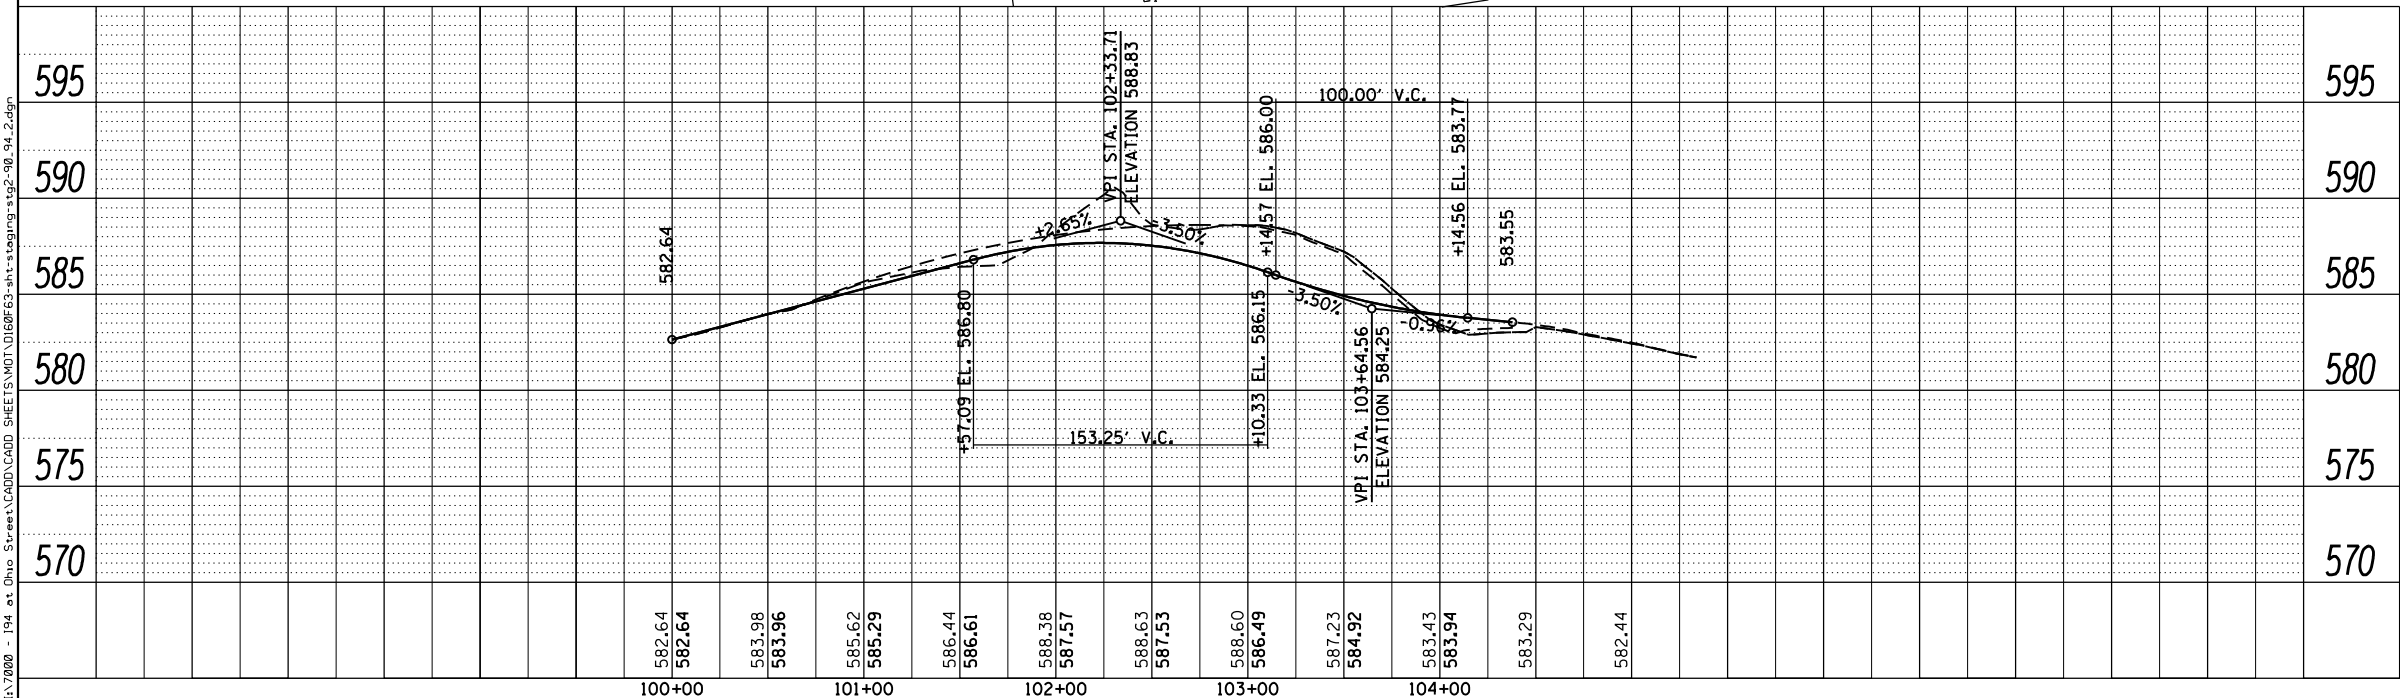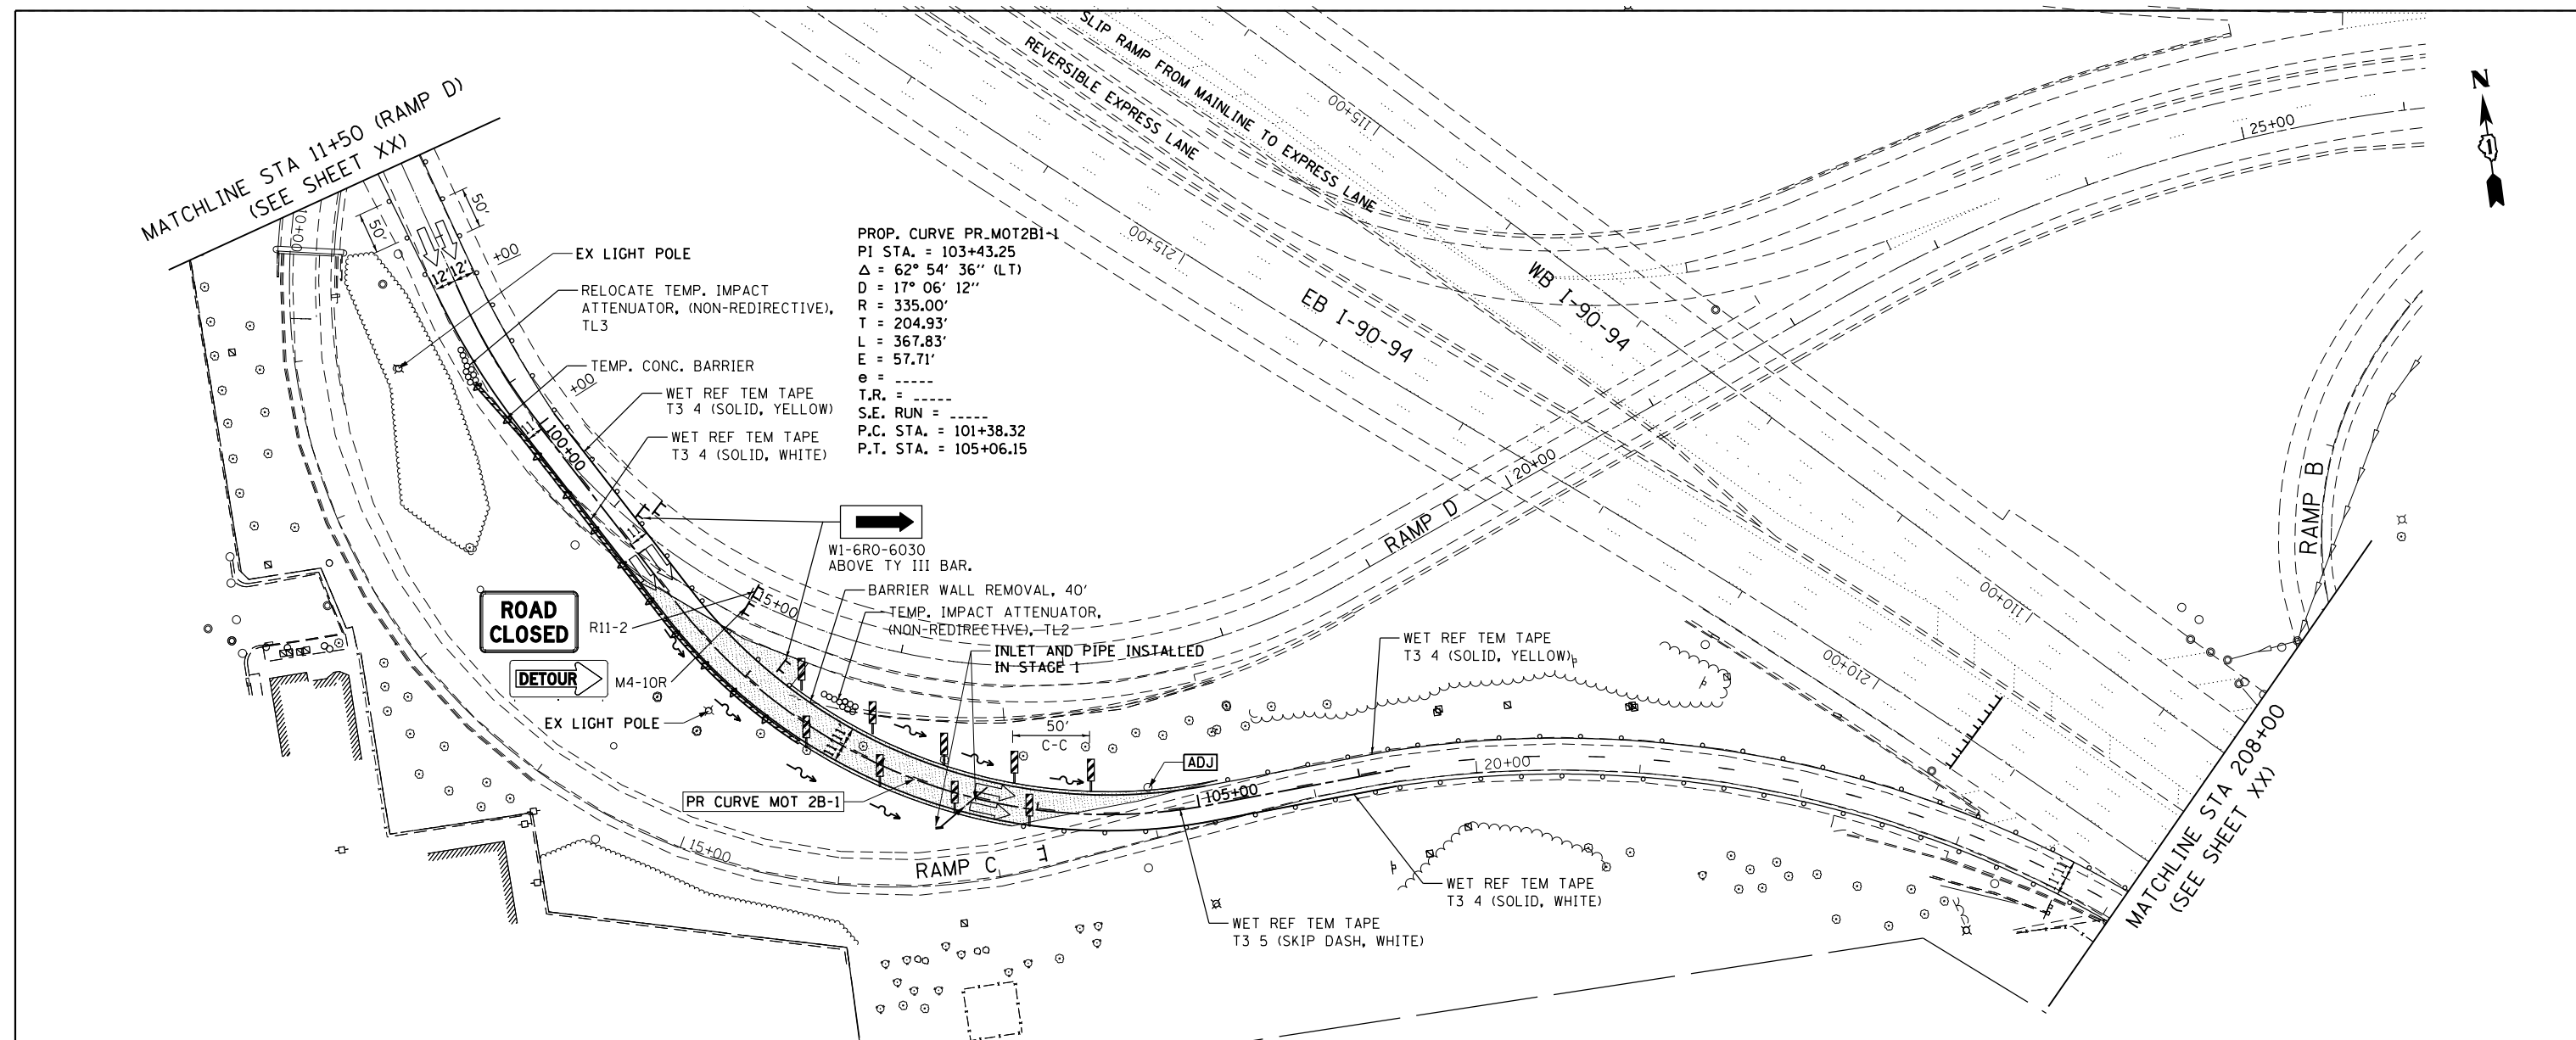

- LEGEND**
- WORK AREA
 - IMPACT ATTENUATOR
 - TEMPORARY CONCRETE BARRIER
 - TYPE II BARRICADES OR DRUMS WITH STEADY BURN MONODIRECTIONAL LIGHT (AT SPECIFIED SPACING)
 - DIRECTION OF TRAFFIC FLOW
 - SIGN
 - VERTICAL PANELS (AT SPECIFIED SPACING)
 - ARROW BOARD
 - TYPE III BARRICADE
 - BARRIER WALL MARKERS (AT SPECIFIED SPACING)
 - TEMPORARY PAVEMENT, CURRENT STAGE
 - TEMPORARY PAVEMENT, PREVIOUS STAGE

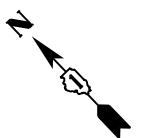

MATCHLINE STA 208+00 (SEE SHEET XX)

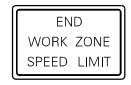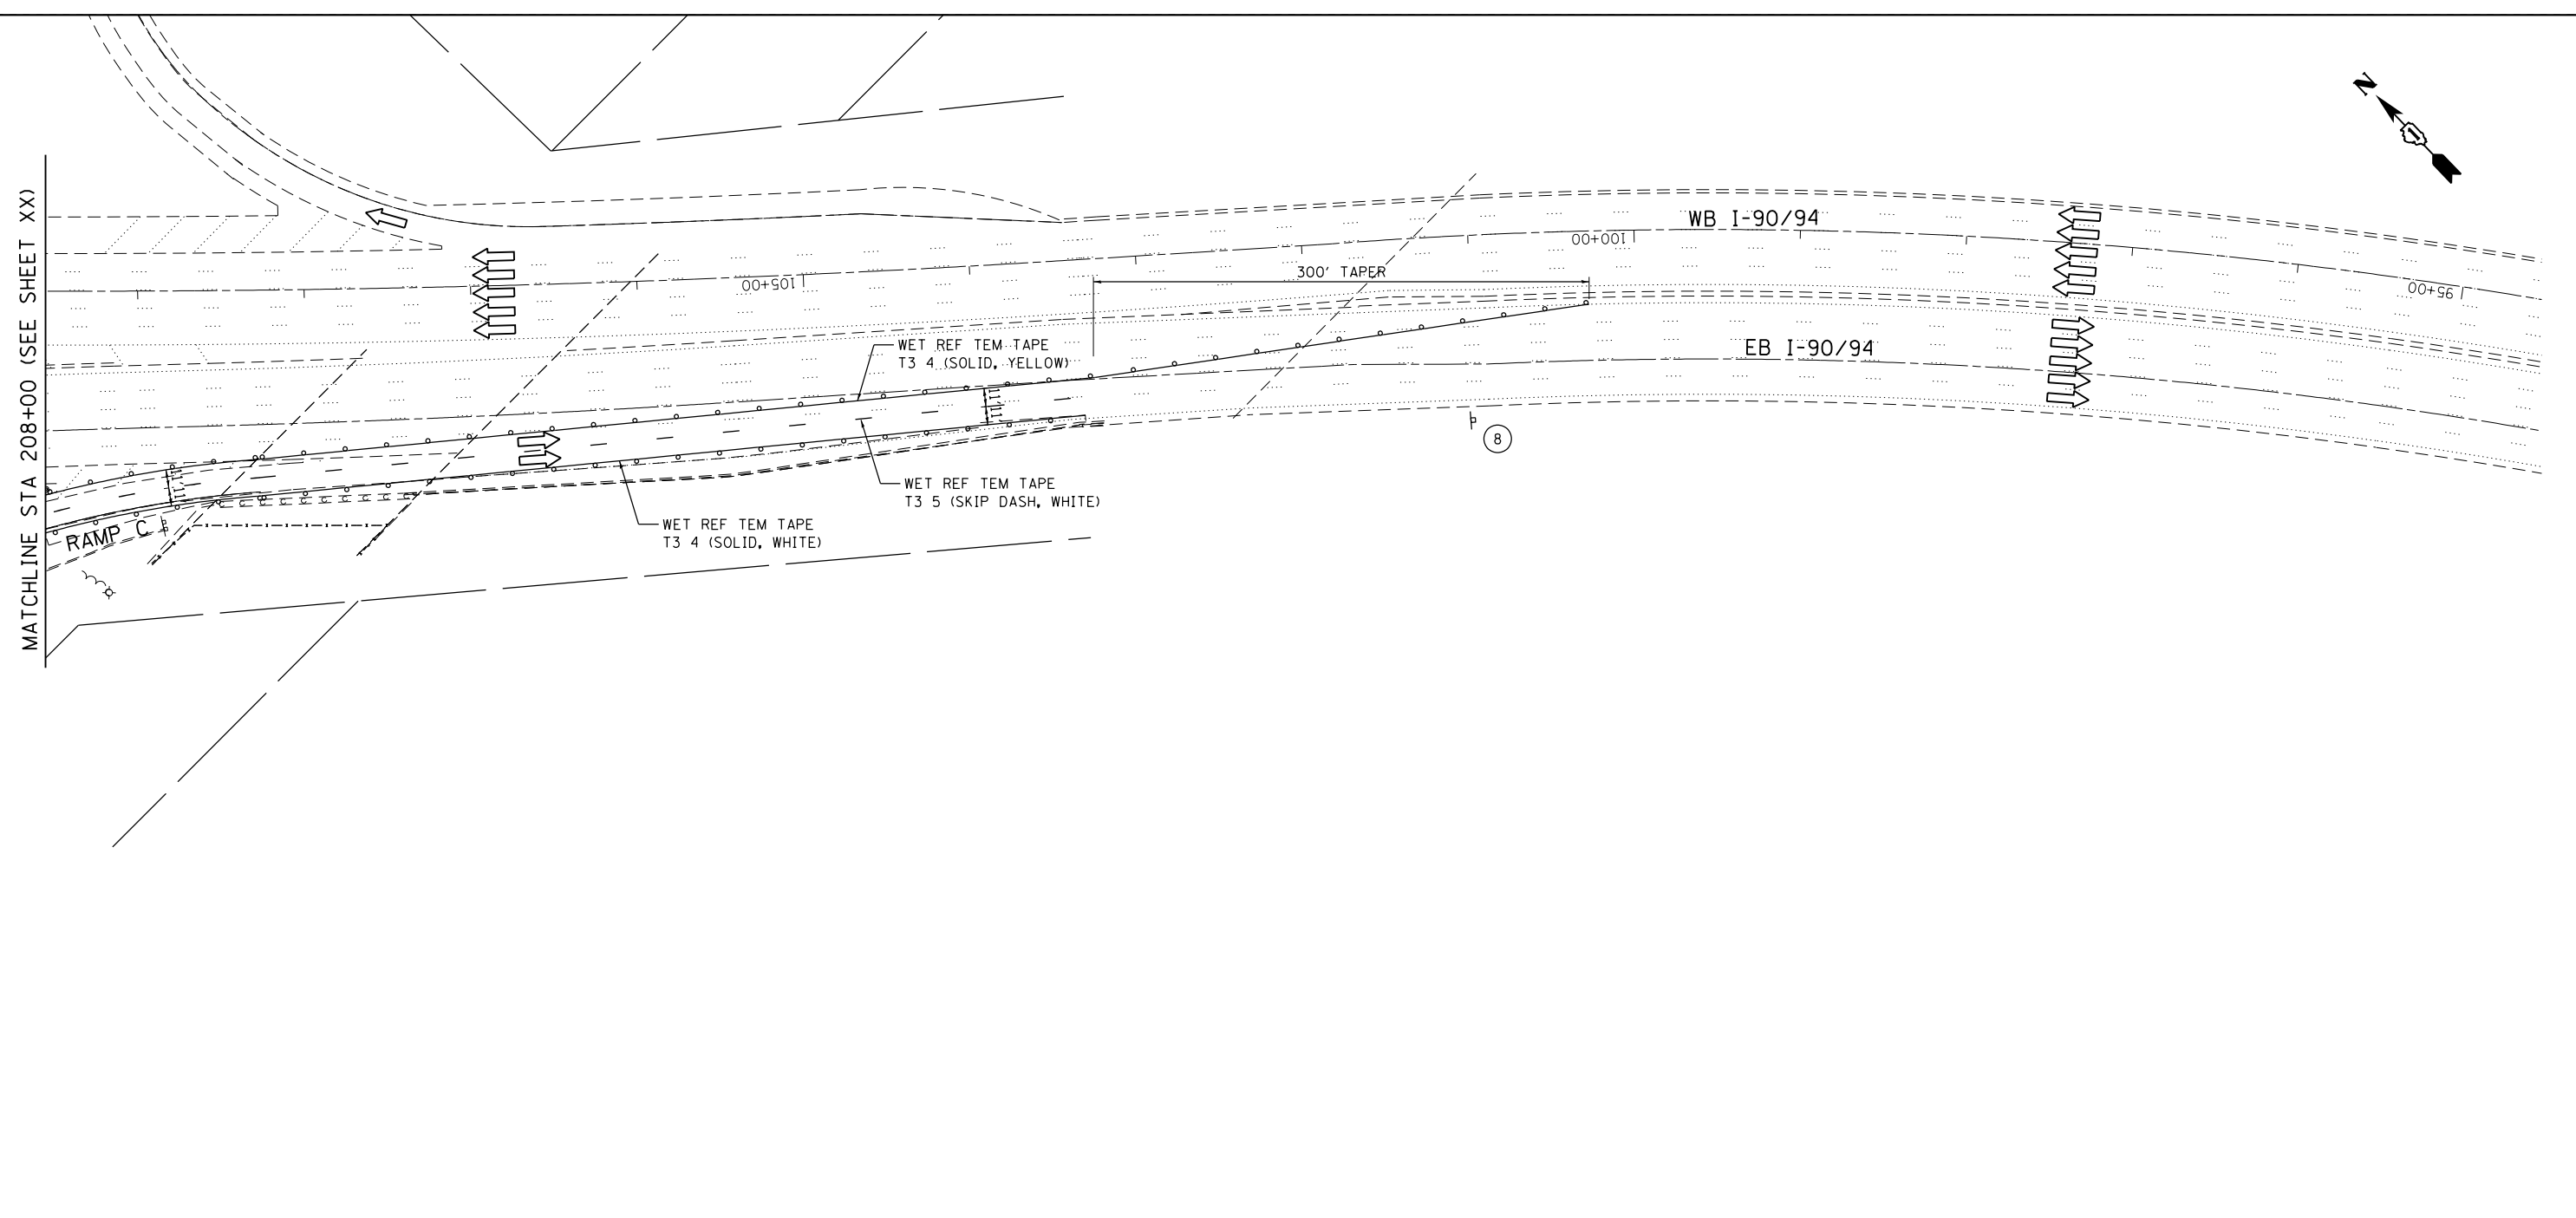

G20-1103(0)-3660
8

LEGEND

- WORK AREA
- IMPACT ATTENUATOR
- TEMPORARY CONCRETE BARRIER
- TYPE II BARRICADES OR DRUMS WITH STEADY BURN MONODIRECTIONAL LIGHT (AT SPECIFIED SPACING)
- DIRECTION OF TRAFFIC FLOW SIGN
- VERTICAL PANELS WITH STEADY BURNING LIGHTS (AT SPECIFIED SPACING)
- ARROW BOARD
- TYPE III BARRICADE
- BARRIER WALL MARKERS (AT SPECIFIED SPACING)
- TEMPORARY PAVEMENT, CURRENT STAGE
- TEMPORARY PAVEMENT, PREVIOUS STAGE

FILE NAME = I:\7000 - 194 at Ohio Street\CADD\CADD_SHEETS\MOT\DI60F63-hst-staging-stg2-90_94_3.dgn



| | | |
|-----------------------------|------------|-----------|
| USER NAME = rge11 | DESIGNED - | REVISED - |
| PLOT SCALE = 100.000' / in. | DRAWN - | REVISED - |
| PLOT DATE = 3/25/2013 | CHECKED - | REVISED - |
| | DATE - | REVISED - |

**STATE OF ILLINOIS
DEPARTMENT OF TRANSPORTATION**



**STAGING AND TRAFFIC CONTROL
I-90/94 STAGE II
SUBSTAGE A**

| F.A.I. RTE. | SECTION | COUNTY | TOTAL SHEETS | SHEET NO. |
|--------------------|--------------|--------|--------------|-----------|
| 90/94 | 0303-474HB-R | COOK | 368 | 87 |
| CONTRACT NO. 60F63 | | | | |

SCALE: SHEET NO. OF SHEETS STA. TO STA.

FED. ROAD DIST. NO. 1 ILLINOIS FED. AID PROJECT

FILE NAME = I:\7000 - 194 at Ohio Street\CADD\CADD_SHEETS\MOT\0160F63-ht-staging\stag2-RampD.dgn

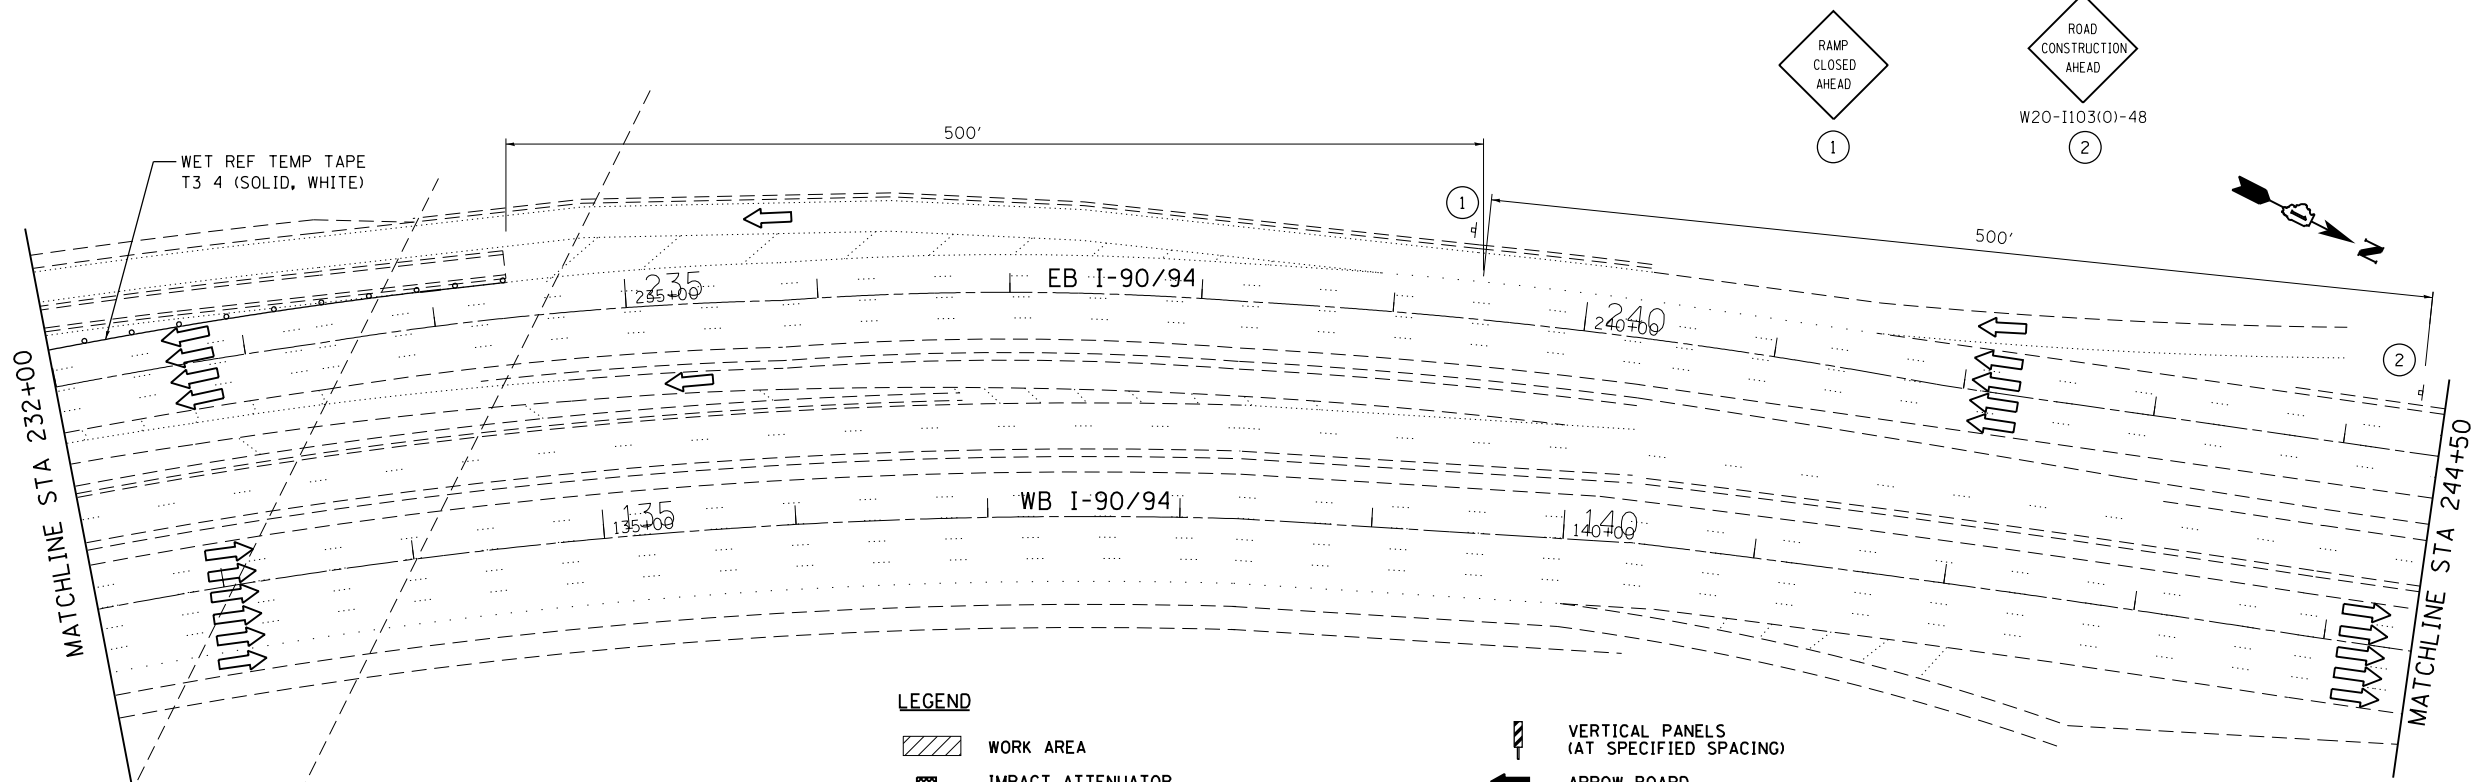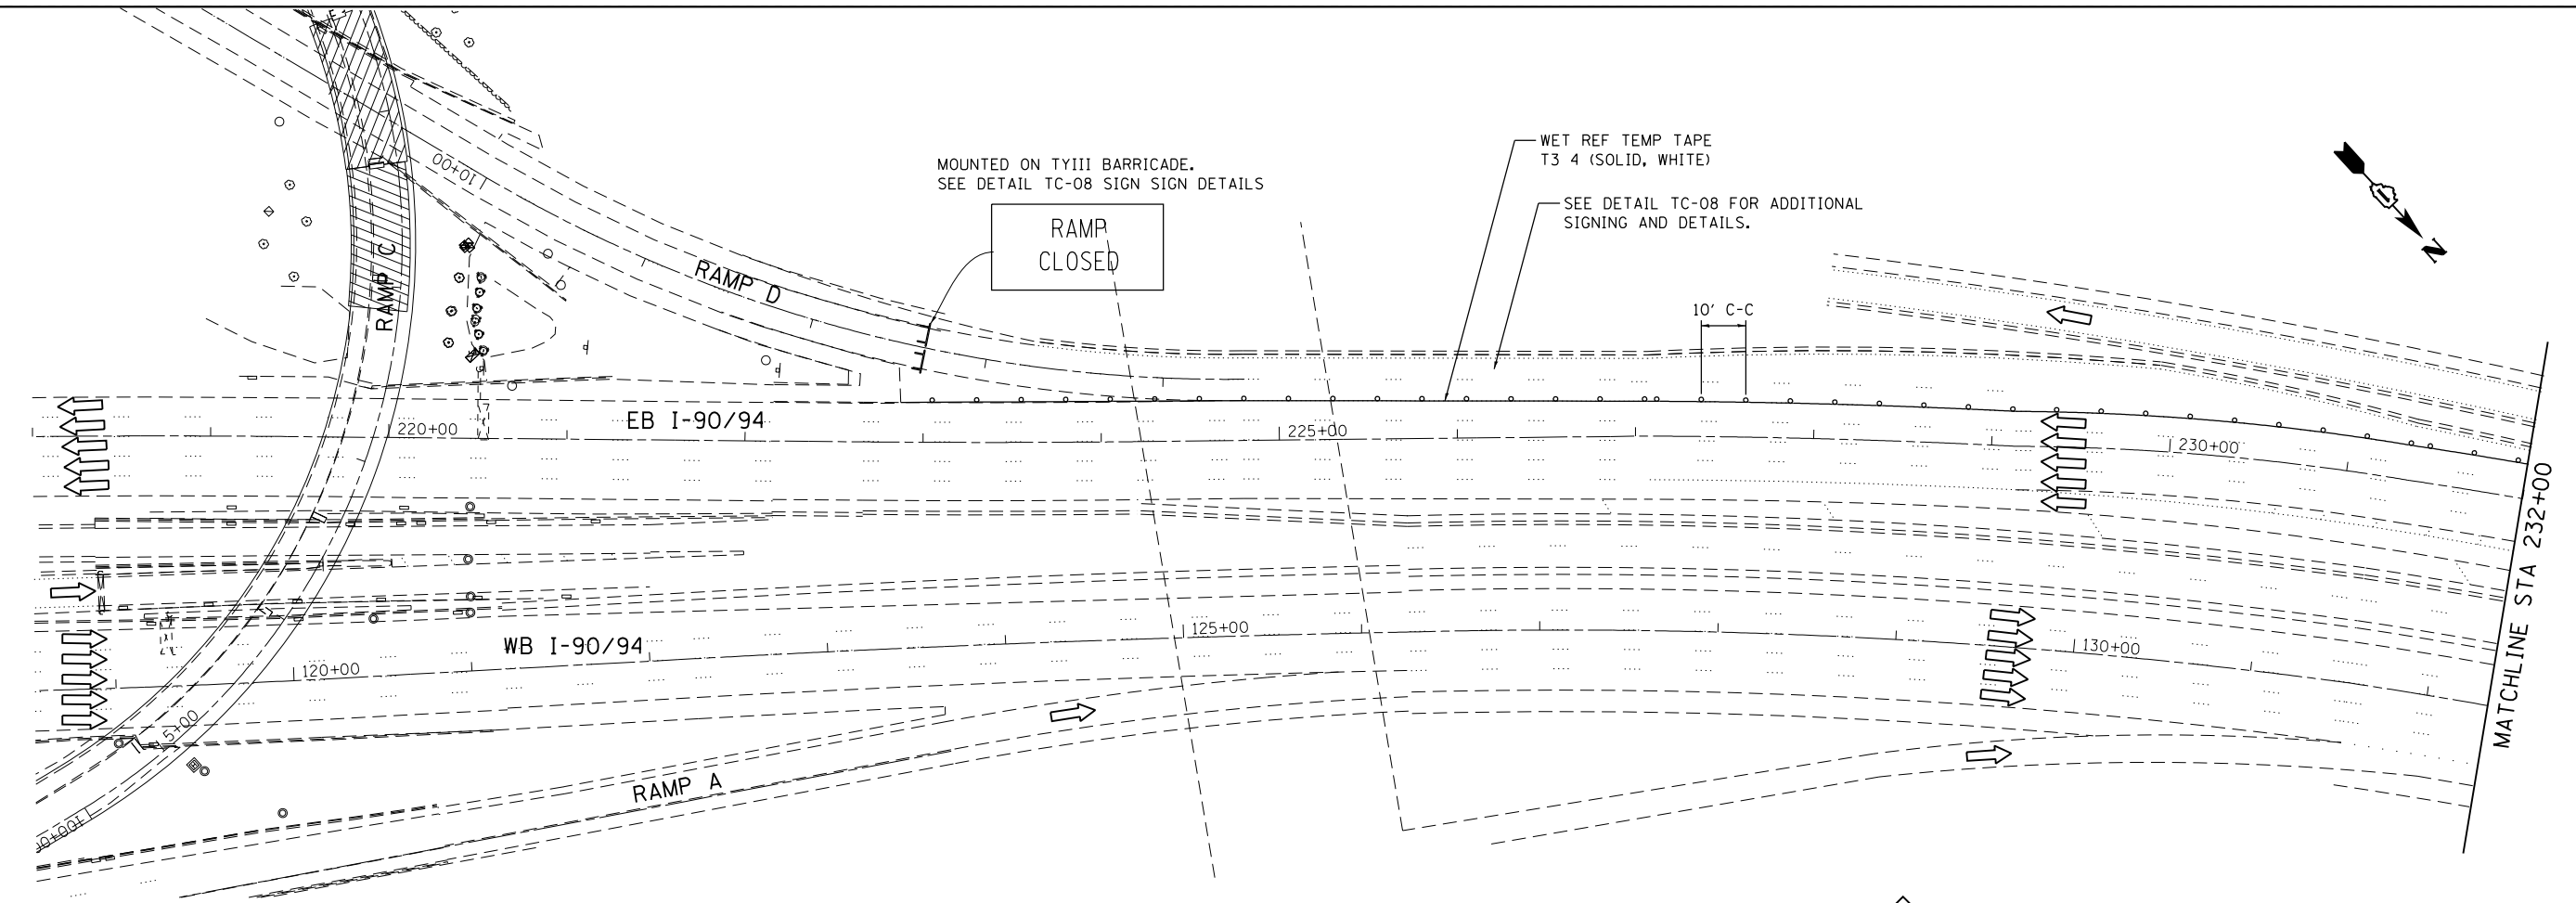

- LEGEND**
- WORK AREA
 - IMPACT ATTENUATOR
 - TEMPORARY CONCRETE BARRIER
 - TYPE II BARRICADES OR DRUMS WITH STEADY BURN MONODIRECTIONAL LIGHT (AT SPECIFIED SPACING)
 - DIRECTION OF TRAFFIC FLOW
 - SIGN
 - VERTICAL PANELS (AT SPECIFIED SPACING)
 - ARROW BOARD
 - TYPE III BARRICADE
 - BARRIER WALL MARKERS (AT SPECIFIED SPACING)
 - TEMPORARY PAVEMENT, CURRENT STAGE
 - TEMPORARY PAVEMENT, PREVIOUS STAGE

COLLINS ENGINEERS

| | | |
|--------------------------------|------------|-----------|
| USER NAME = rge11 | DESIGNED - | REVISED - |
| PLOT SCALE = 100.000000' / in. | DRAWN - | REVISED - |
| PLOT DATE = 3/25/2013 | CHECKED - | REVISED - |
| | DATE - | REVISED - |


**STATE OF ILLINOIS
DEPARTMENT OF TRANSPORTATION**

**STAGING AND TRAFFIC CONTROL
RAMP D STAGE II
SUBSTAGE B**

SCALE: SHEET NO. OF SHEETS STA. TO STA.


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|---|--------------|--------|--------------|-----------|
| F.A.I. RE. | SECTION | COUNTY | TOTAL SHEETS | SHEET NO. |
| 90/94 | 0303-474HB-R | COOK | 368 | 88 |
| CONTRACT NO. 60F63 | | | | |
| FED. ROAD DIST. NO. 1 ILLINOIS FED. AID PROJECT | | | | |

FILE NAME = \\collinsengr.com\1\adator\1\Posanden\DDCS\Y2000 - 134 ot Ohio St\west\400D\CADD SHEETS\MOT\DI60F63-ph-tt-stage\temp\sign_stage2c.dgn

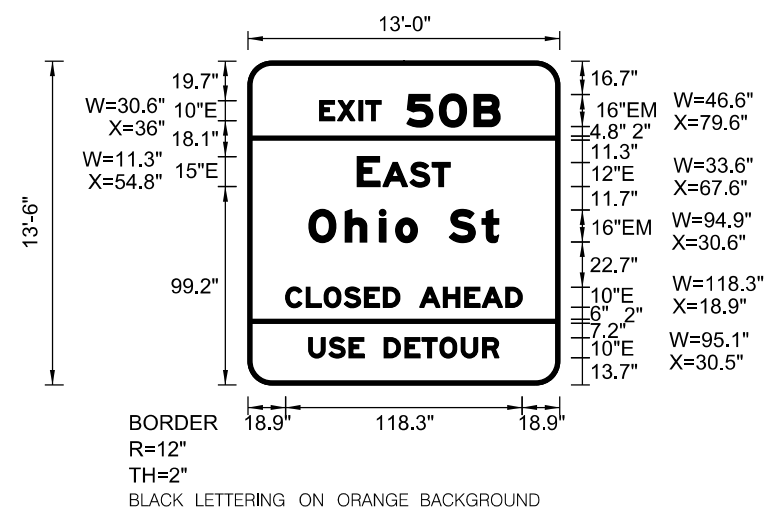


BORDER
R=12"
TH=2"
BLACK LETTERING ON ORANGE BACKGROUND

O

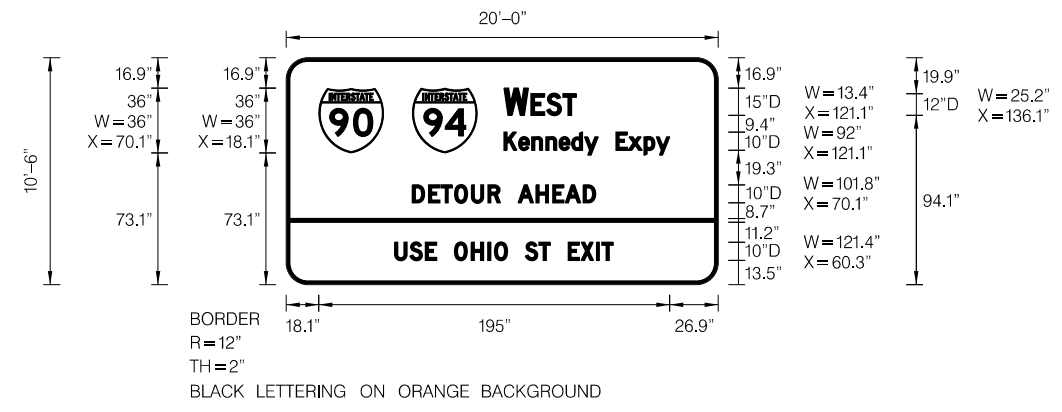


BORDER
R=12"
TH=2"
BLACK LETTERING ON ORANGE BACKGROUND

Q

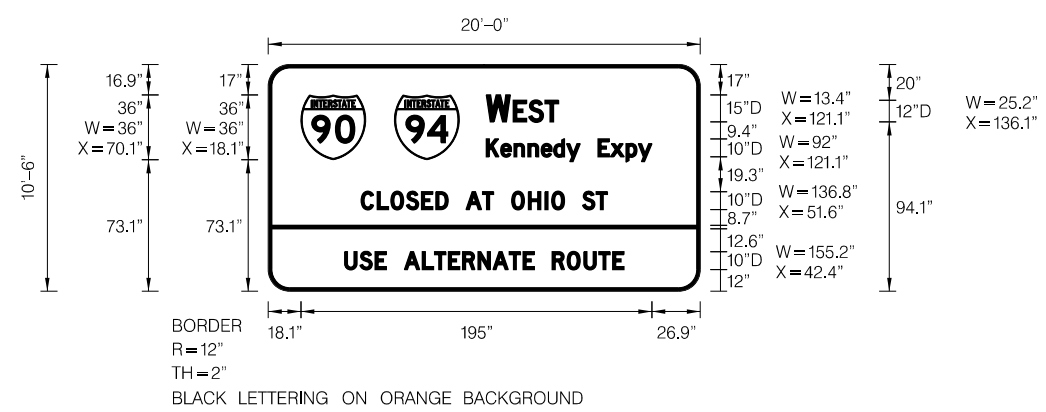

BORDER
R=12"
TH=2"
BLACK LETTERING ON ORANGE BACKGROUND

P

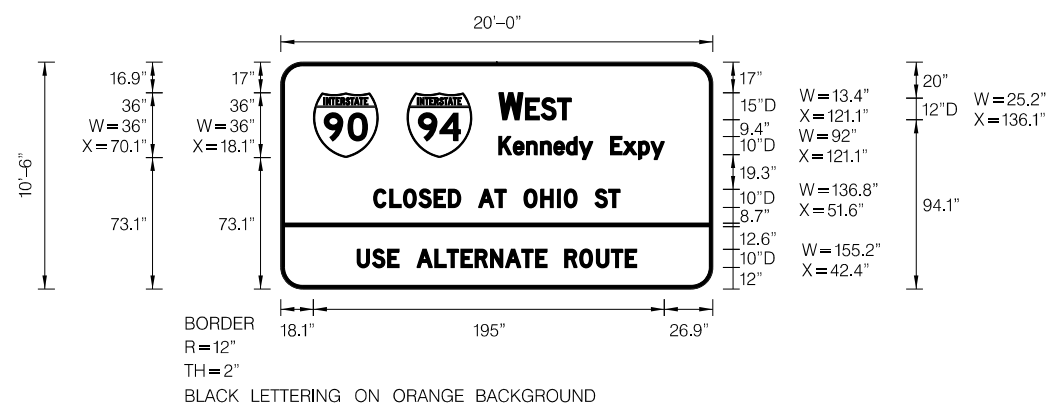

BORDER
R=12"
TH=2"
BLACK LETTERING ON ORANGE BACKGROUND

R



| | | |
|--------------------------------|------------|-----------|
| USER NAME = rge11 | DESIGNED - | REVISED - |
| PLOT SCALE = 400.000000' / in. | DRAWN - | REVISED - |
| PLOT DATE = 3/25/2013 | CHECKED - | REVISED - |
| | DATE - | REVISED - |


STATE OF ILLINOIS
DEPARTMENT OF TRANSPORTATION

TEMPORARY SIGNING PLAN
STAGE II - SUBSTAGE 2C

| | | | | |
|--------|-----------|-----------|------|---------|
| SCALE: | SHEET NO. | OF SHEETS | STA. | TO STA. |
|--------|-----------|-----------|------|---------|

| | | | | |
|---|--------------|--------|--------------|-----------|
| F.A.I. RTE. | SECTION | COUNTY | TOTAL SHEETS | SHEET NO. |
| 90/94 | 0303-474HB-R | COOK | 368 | 90 |
| CONTRACT NO. 60F63 | | | | |
| FED. ROAD DIST. NO. 1 ILLINOIS FED. AID PROJECT | | | | |

FILE NAME = \\collinsengr.com\1\Adator\1\Posarden\DDCS\72000 - I94.ctb; User: Street\CADD\CADD_SHEETS\MOT\DI60F63-ph-tt-staging-stg2-RampB.dgn

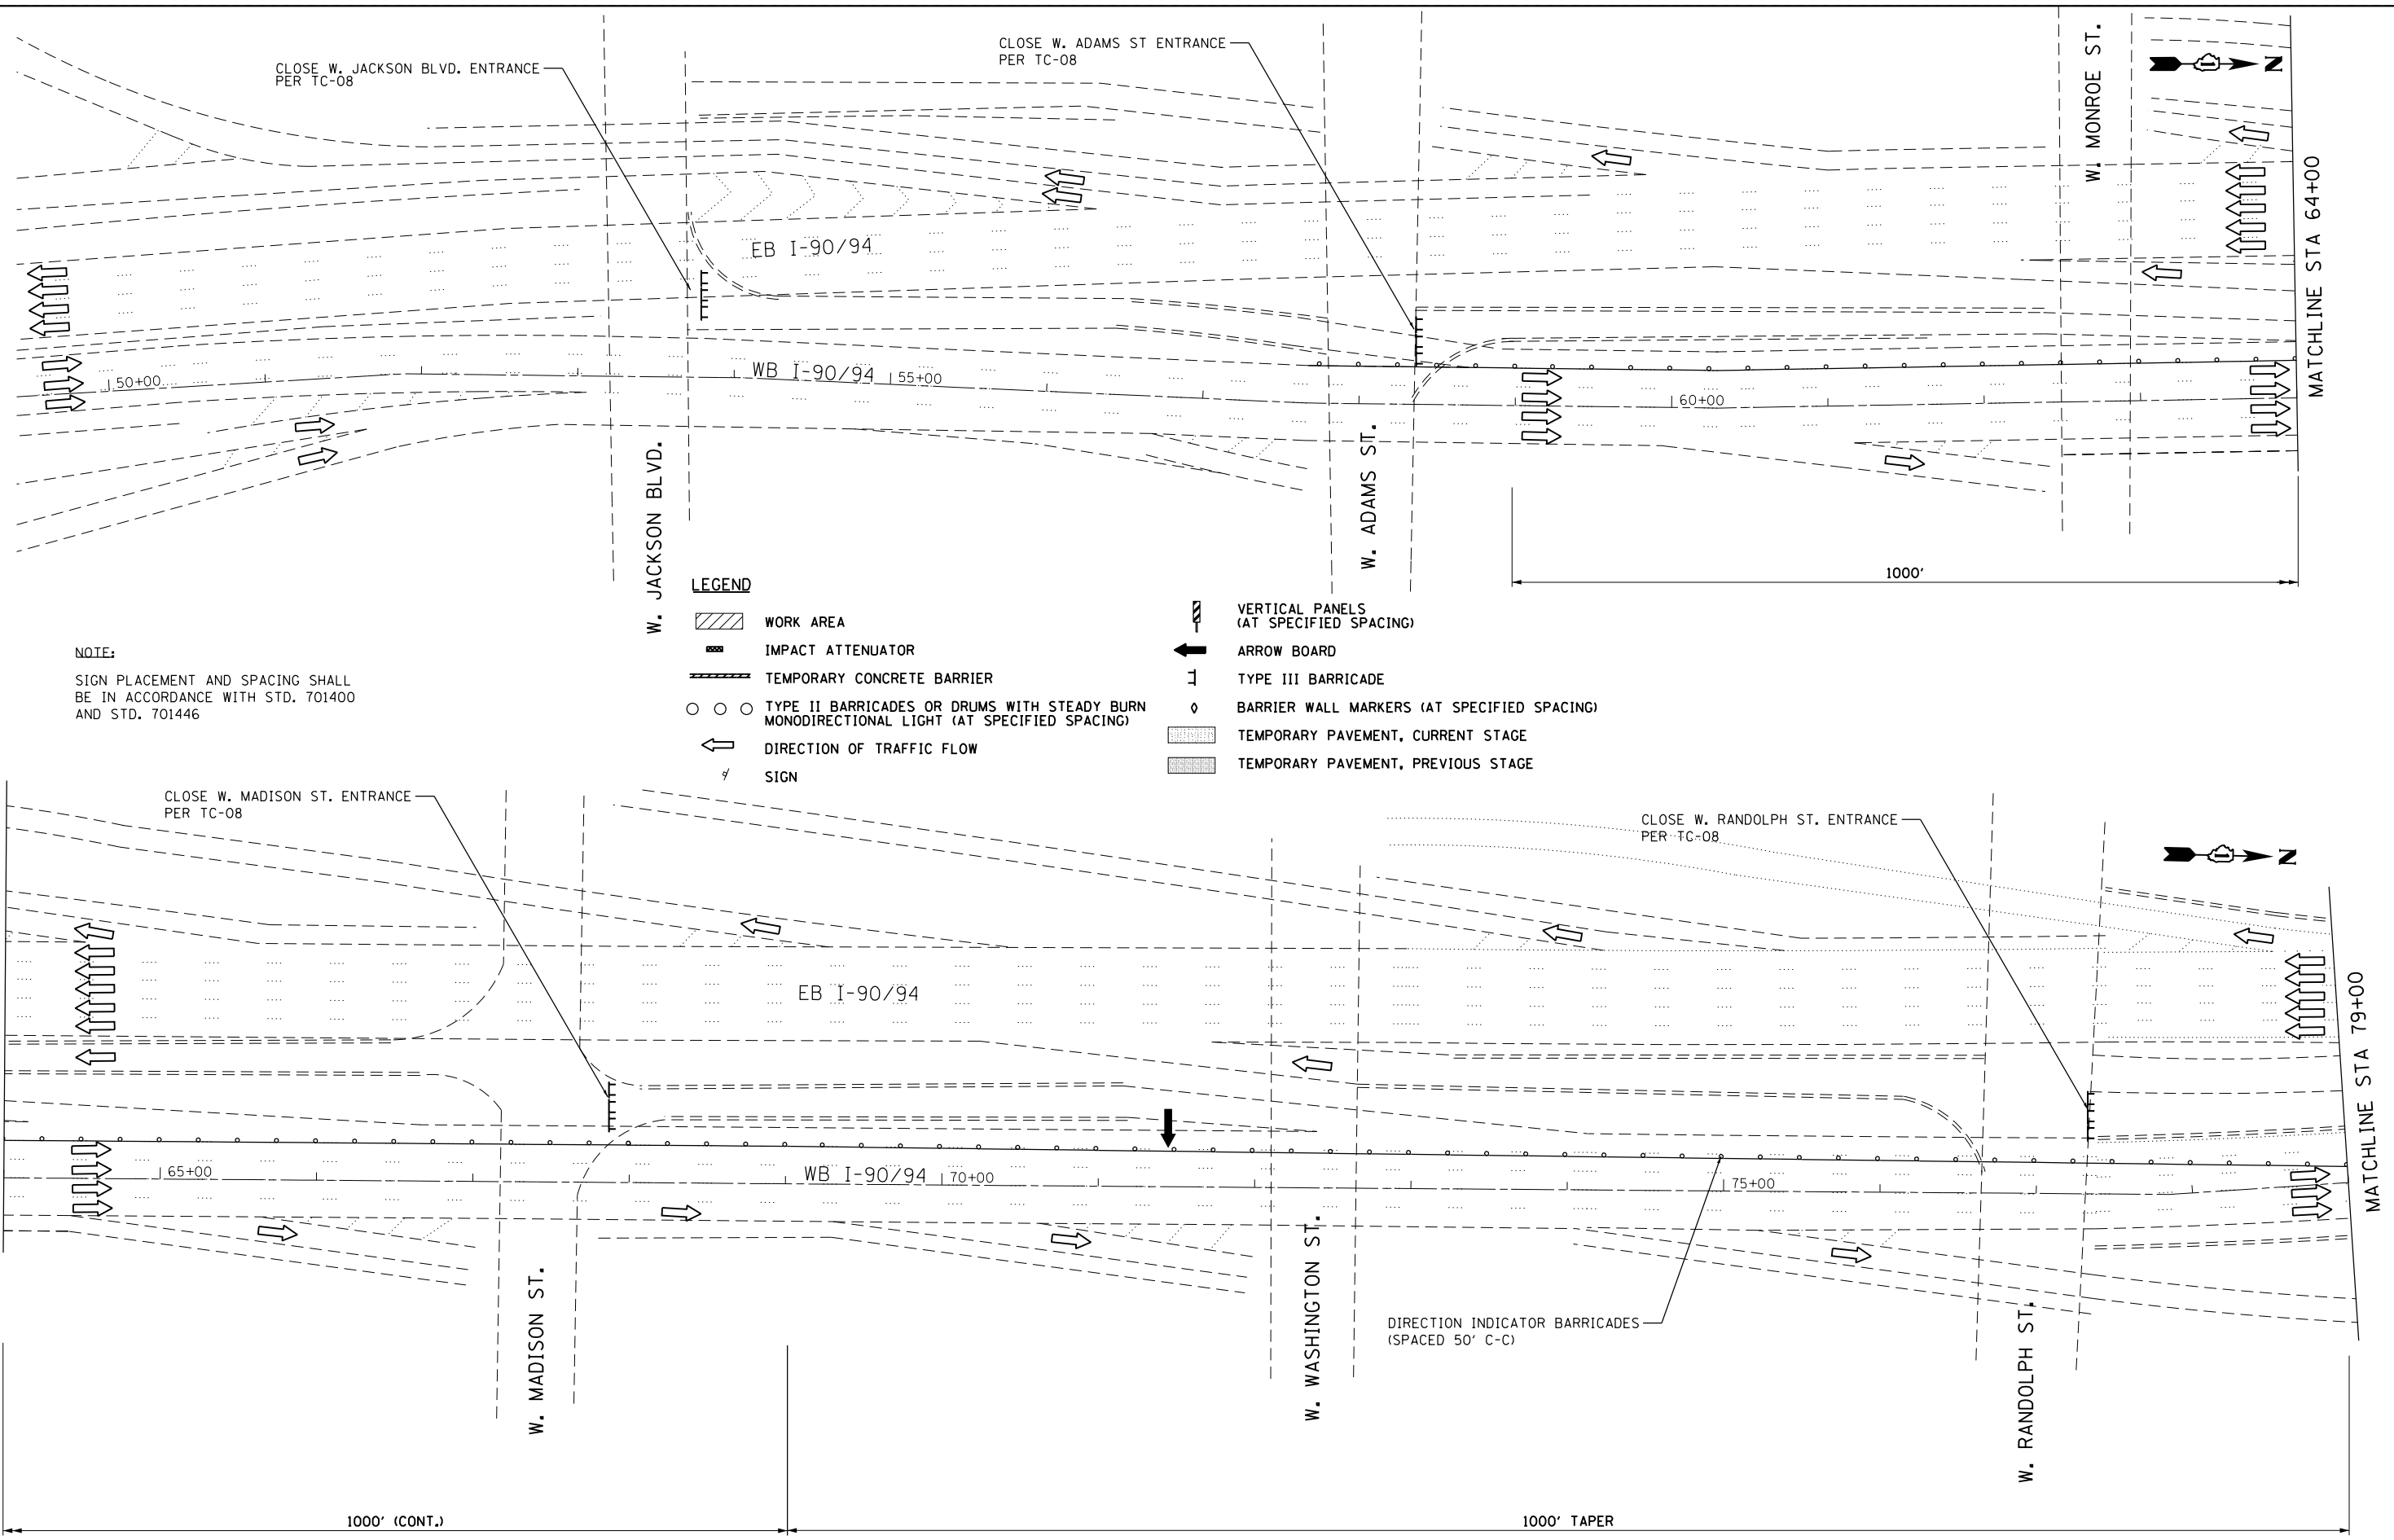

NOTE:
SIGN PLACEMENT AND SPACING SHALL BE IN ACCORDANCE WITH STD. 701400 AND STD. 701446

LEGEND

- WORK AREA
- IMPACT ATTENUATOR
- TEMPORARY CONCRETE BARRIER
- TYPE II BARRICADES OR DRUMS WITH STEADY BURN MONODIRECTIONAL LIGHT (AT SPECIFIED SPACING)
- DIRECTION OF TRAFFIC FLOW
- SIGN
- VERTICAL PANELS (AT SPECIFIED SPACING)
- ARROW BOARD
- TYPE III BARRICADE
- BARRIER WALL MARKERS (AT SPECIFIED SPACING)
- TEMPORARY PAVEMENT, CURRENT STAGE
- TEMPORARY PAVEMENT, PREVIOUS STAGE



USER NAME = rge11
PLOT SCALE = 100.000' / in.
PLOT DATE = 3/25/2013

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DATE -

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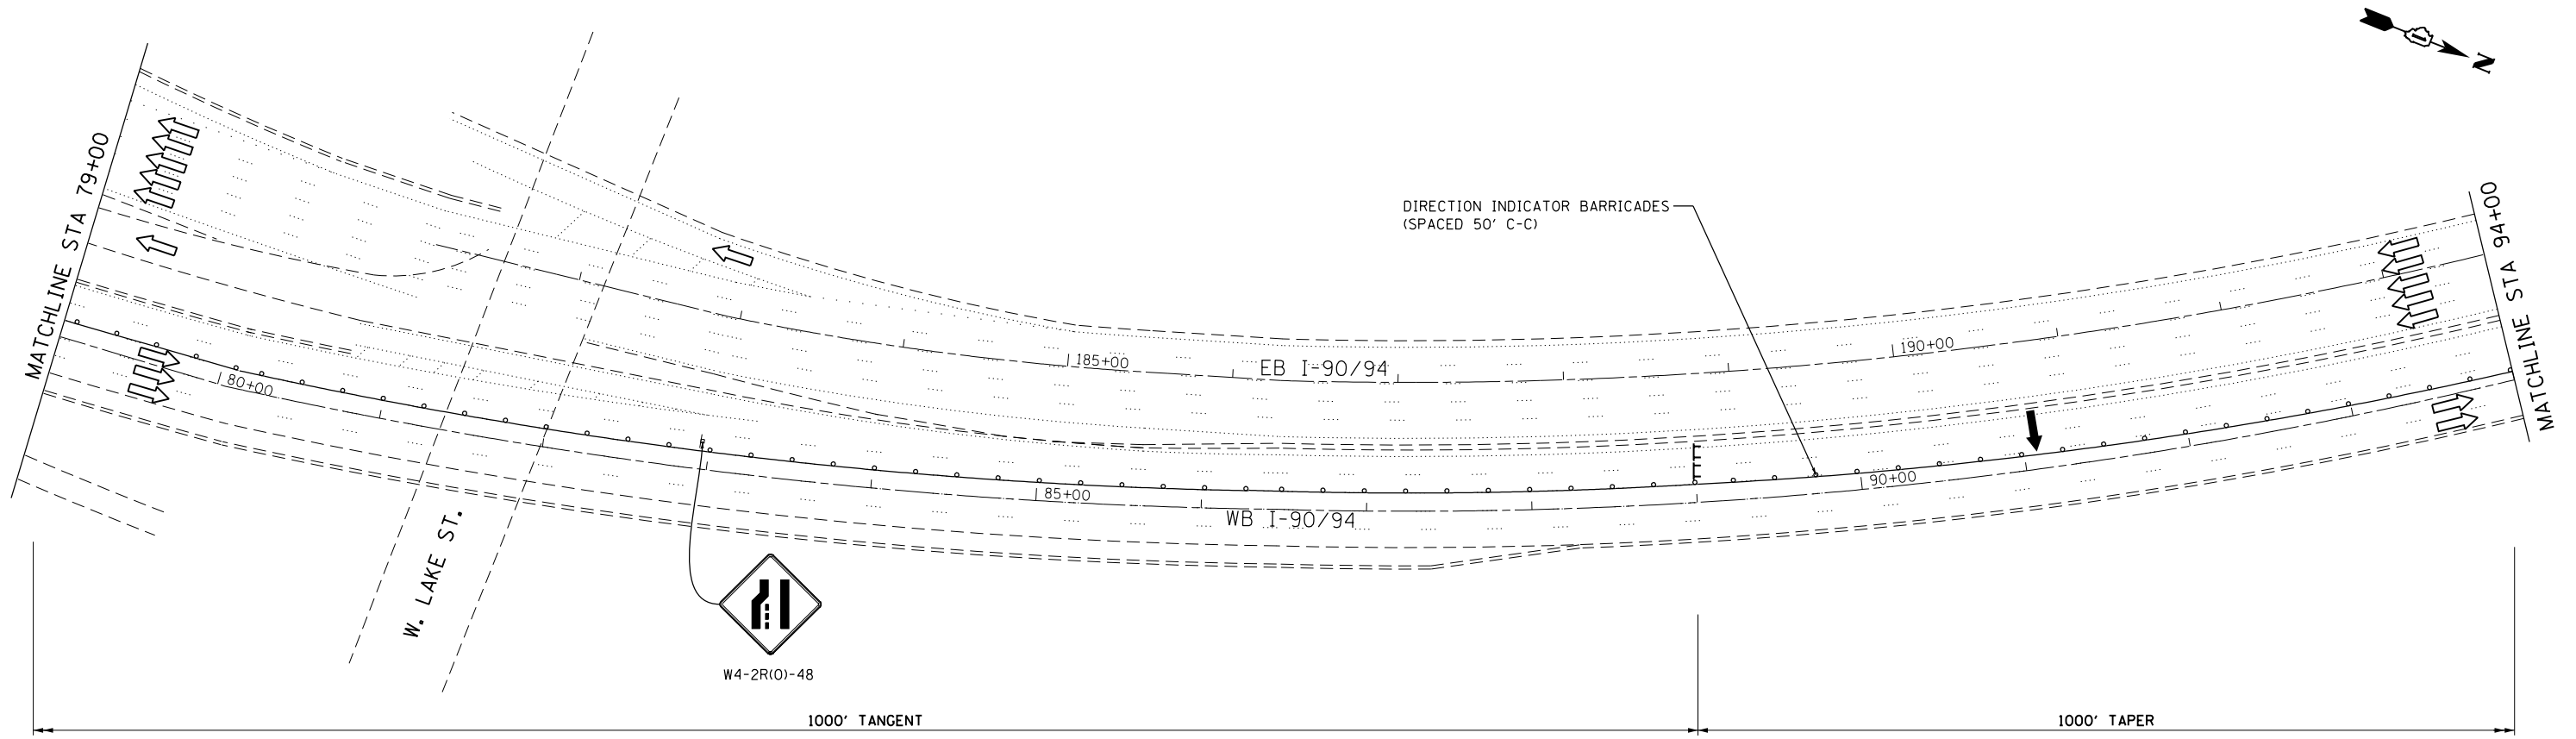
**STATE OF ILLINOIS
DEPARTMENT OF TRANSPORTATION**

**STAGING AND TRAFFIC CONTROL
I-90/94 STAGE II
SUBSTAGE C**


SCALE: SHEET NO. OF SHEETS STA. TO STA.

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| F.A.I. RTE. 90/94 | SECTION 0303-474HB-R | COUNTY COOK | TOTAL SHEETS 368 | SHEET NO. 91 |
| CONTRACT NO. 60F63 | | | | |
| FED. ROAD DIST. NO. 1 ILLINOIS FED. AID PROJECT | | | | |

FILE NAME = \\collinsengr.com\1\adator\1\posanden\DDCS\72000 - I94.ct.0\ho. Street\CADD\CADD SHEETS\MOT\DD60F63-ht-staging-stg2-RampB.dgn



- LEGEND**
- WORK AREA
 - IMPACT ATTENUATOR
 - TEMPORARY CONCRETE BARRIER
 - TYPE II BARRICADES OR DRUMS WITH STEADY BURN MONODIRECTIONAL LIGHT (AT SPECIFIED SPACING)
 - DIRECTION OF TRAFFIC FLOW
 - SIGN
 - VERTICAL PANELS (AT SPECIFIED SPACING)
 - ARROW BOARD
 - TYPE III BARRICADE
 - BARRIER WALL MARKERS (AT SPECIFIED SPACING)
 - TEMPORARY PAVEMENT, CURRENT STAGE
 - TEMPORARY PAVEMENT, PREVIOUS STAGE

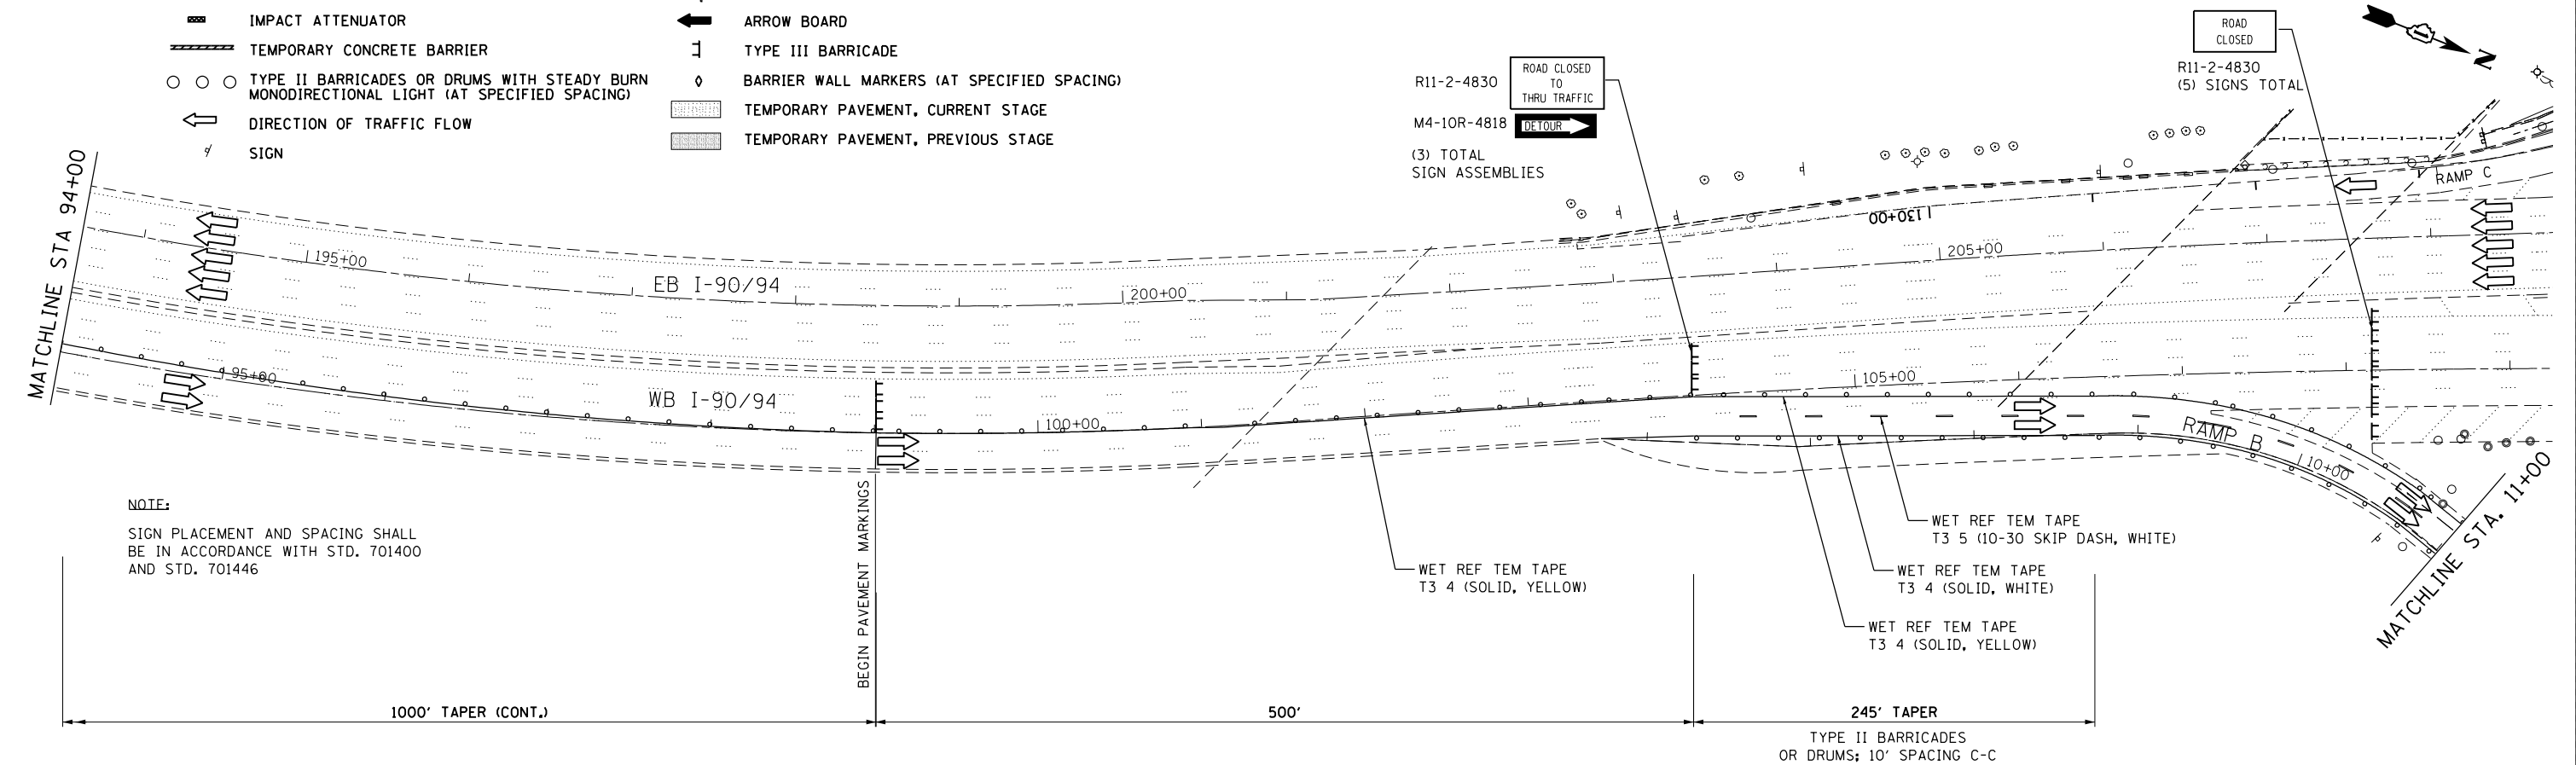

NOTE:
SIGN PLACEMENT AND SPACING SHALL BE IN ACCORDANCE WITH STD. 701400 AND STD. 701446

COLLINS ENGINEERS


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| PLOT DATE = 3/25/2013 | CHECKED - | REVISED - |
| | DATE - | REVISED - |

**STATE OF ILLINOIS
DEPARTMENT OF TRANSPORTATION**

**STAGING AND TRAFFIC CONTROL
I-90/94 STAGE II
SUBSTAGE C**


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| CONTRACT NO. 60F63 | | | | |
| FED. ROAD DIST. NO. 1 ILLINOIS FED. AID PROJECT | | | | |

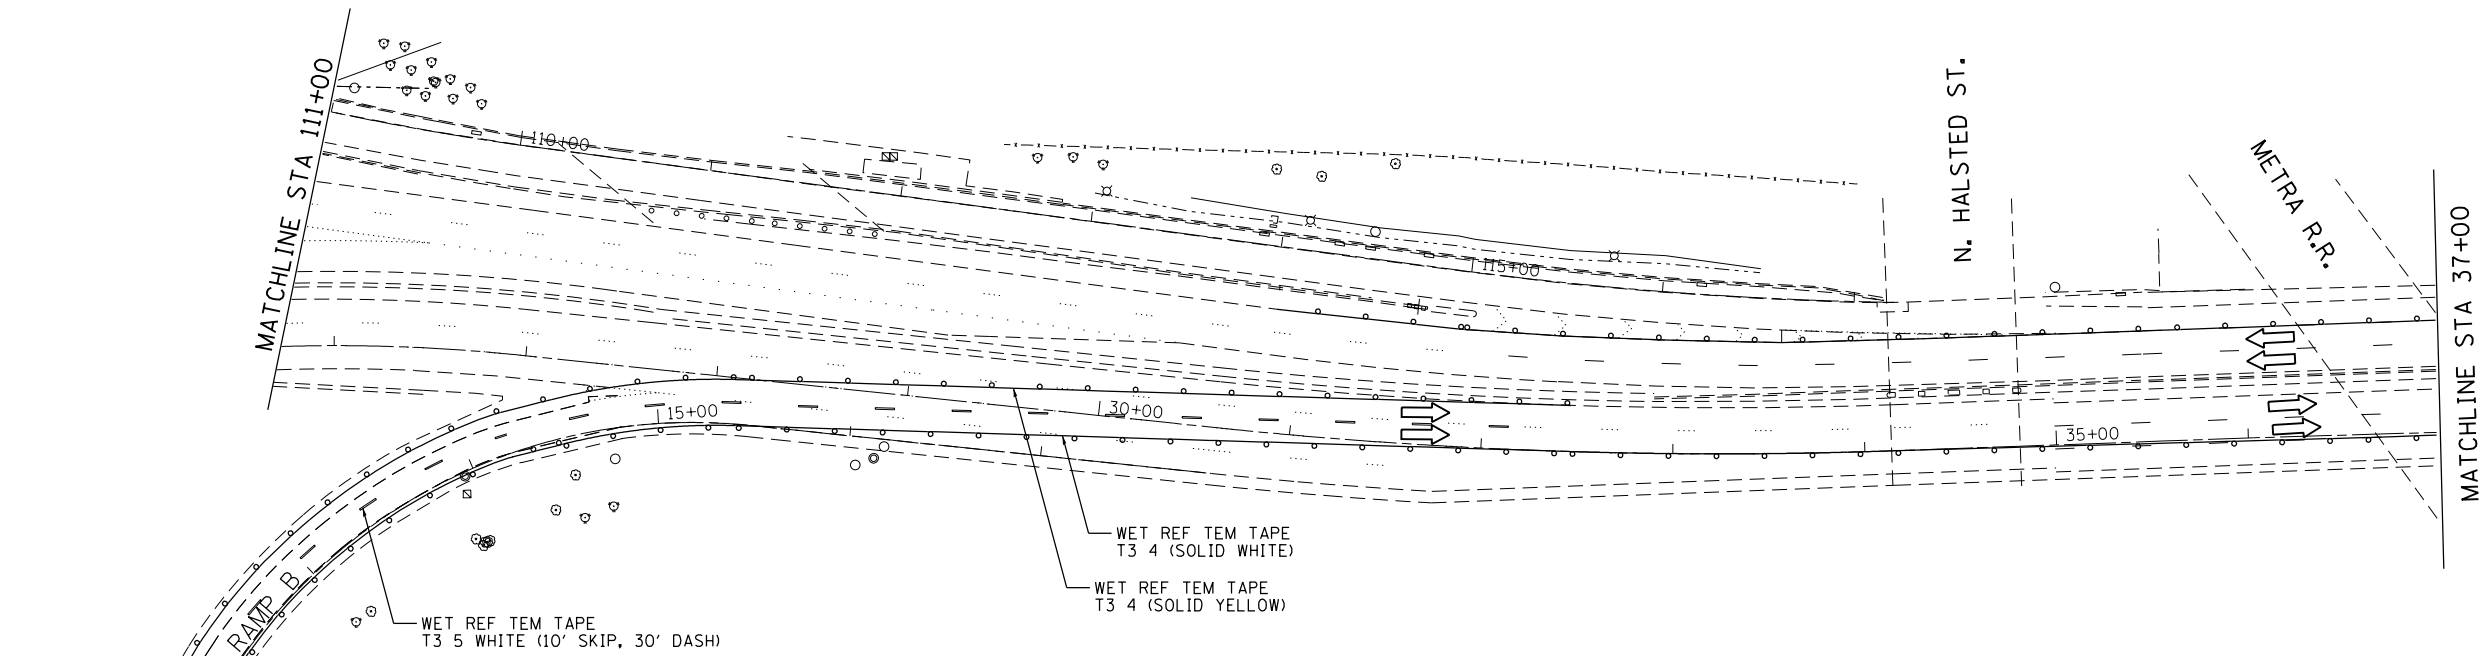


- LEGEND**
- WORK AREA
 - IMPACT ATTENUATOR
 - TEMPORARY CONCRETE BARRIER
 - TYPE II BARRICADES OR DRUMS WITH STEADY BURN MONODIRECTIONAL LIGHT (AT SPECIFIED SPACING)
 - DIRECTION OF TRAFFIC FLOW
 - SIGN
 - VERTICAL PANELS (AT SPECIFIED SPACING)
 - ARROW BOARD
 - TYPE III BARRICADE
 - BARRIER WALL MARKERS (AT SPECIFIED SPACING)
 - TEMPORARY PAVEMENT, CURRENT STAGE
 - TEMPORARY PAVEMENT, PREVIOUS STAGE
 - CHANGEABLE MESSAGE SIGN

MATCHLINE STA. 11+00

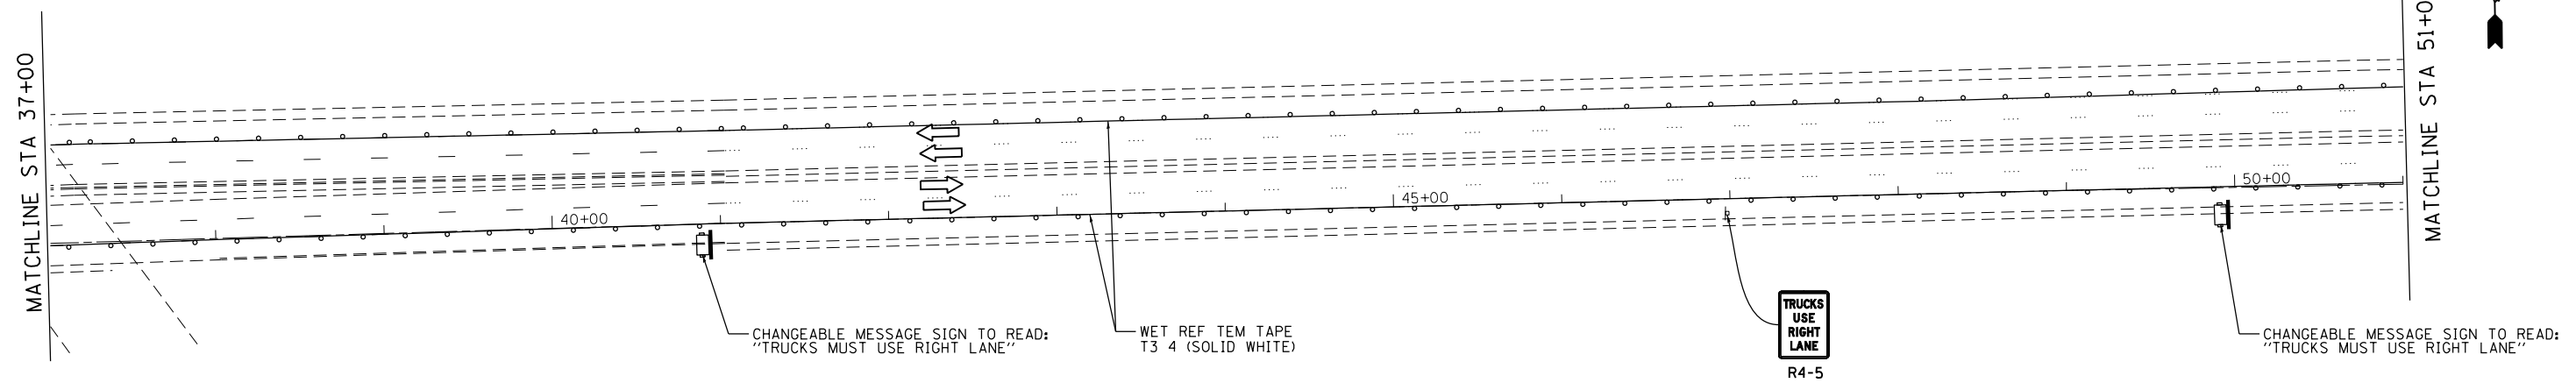

NOTES:
 1. MOUNT EXISTING SIGNS TO EXISTING HALSTED STREET BRIDGE.
 THE MOUNTING DETAIL SHALL BE APPROVED BY THE ENGINEER.

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| PLOT SCALE = 100.000' / 1" = | DRAWN - | REVISED - |
| PLOT DATE = 3/25/2013 | CHECKED - | REVISED - |
| | DATE - | REVISED - |

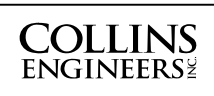**STATE OF ILLINOIS
 DEPARTMENT OF TRANSPORTATION**

**STAGING AND TRAFFIC CONTROL
 I-90/94 STAGE II
 SUBSTAGE C**




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|---|--------------|--------|--------------|-----------|
| F.A.I. RTE. | SECTION | COUNTY | TOTAL SHEETS | SHEET NO. |
| 90/94 | 0303-474HB-R | COOK | 343 | 93 |
| CONTRACT NO. 60F63 | | | | |
| FED. ROAD DIST. NO. 1 ILLINOIS FED. AID PROJECT | | | | |

LEGEND

- WORK AREA
- IMPACT ATTENUATOR
- TEMPORARY CONCRETE BARRIER
- TYPE II BARRICADES OR DRUMS WITH STEADY BURN MONODIRECTIONAL LIGHT (AT SPECIFIED SPACING)
- DIRECTION OF TRAFFIC FLOW
- SIGN

- VERTICAL PANELS (AT SPECIFIED SPACING)
- ARROW BOARD
- TYPE III BARRICADE
- BARRIER WALL MARKERS (AT SPECIFIED SPACING)
- TEMPORARY PAVEMENT, CURRENT STAGE
- TEMPORARY PAVEMENT, PREVIOUS STAGE

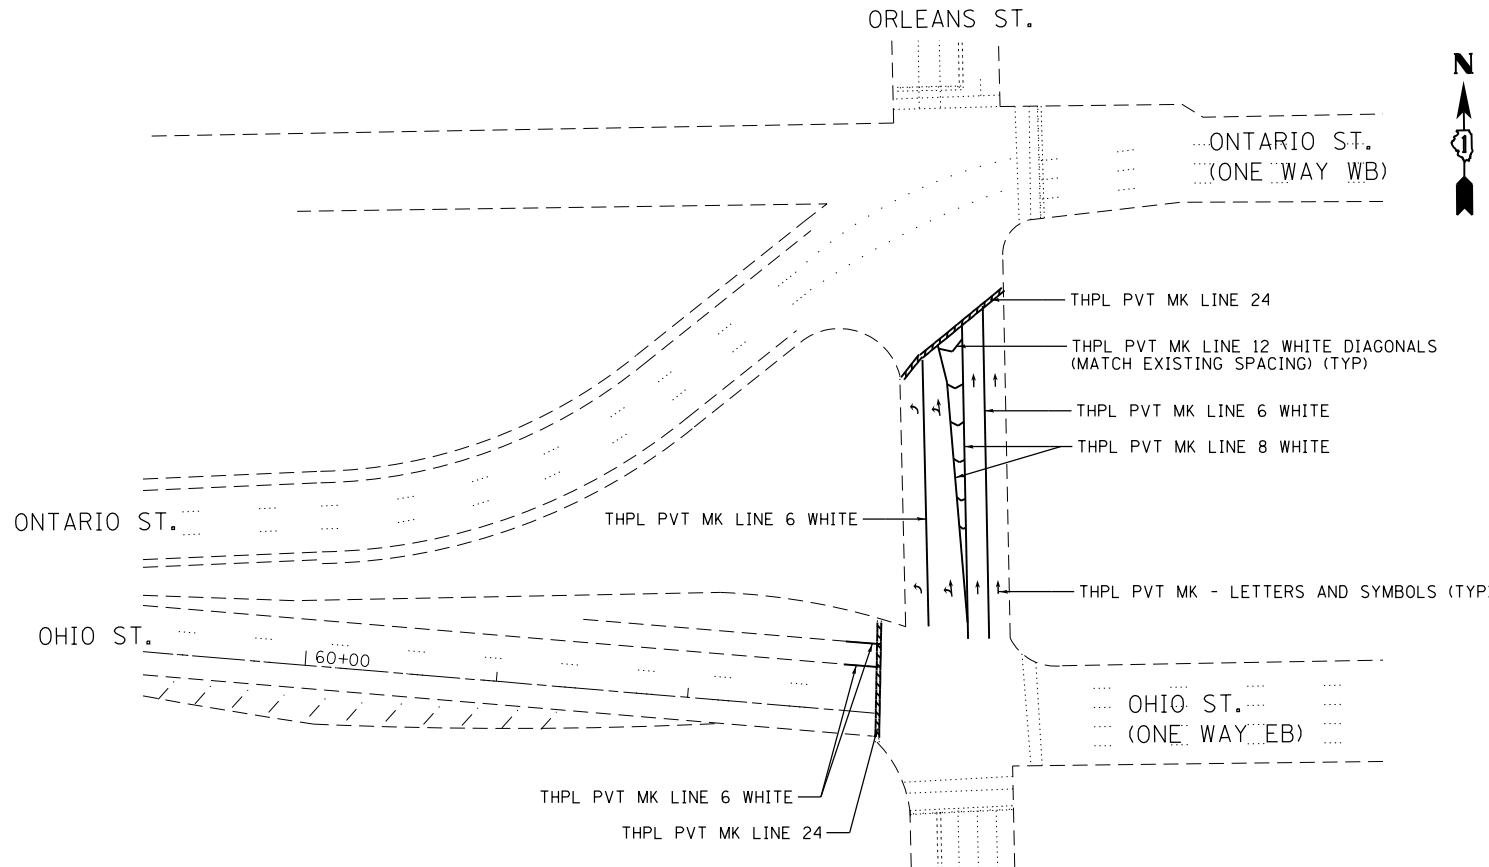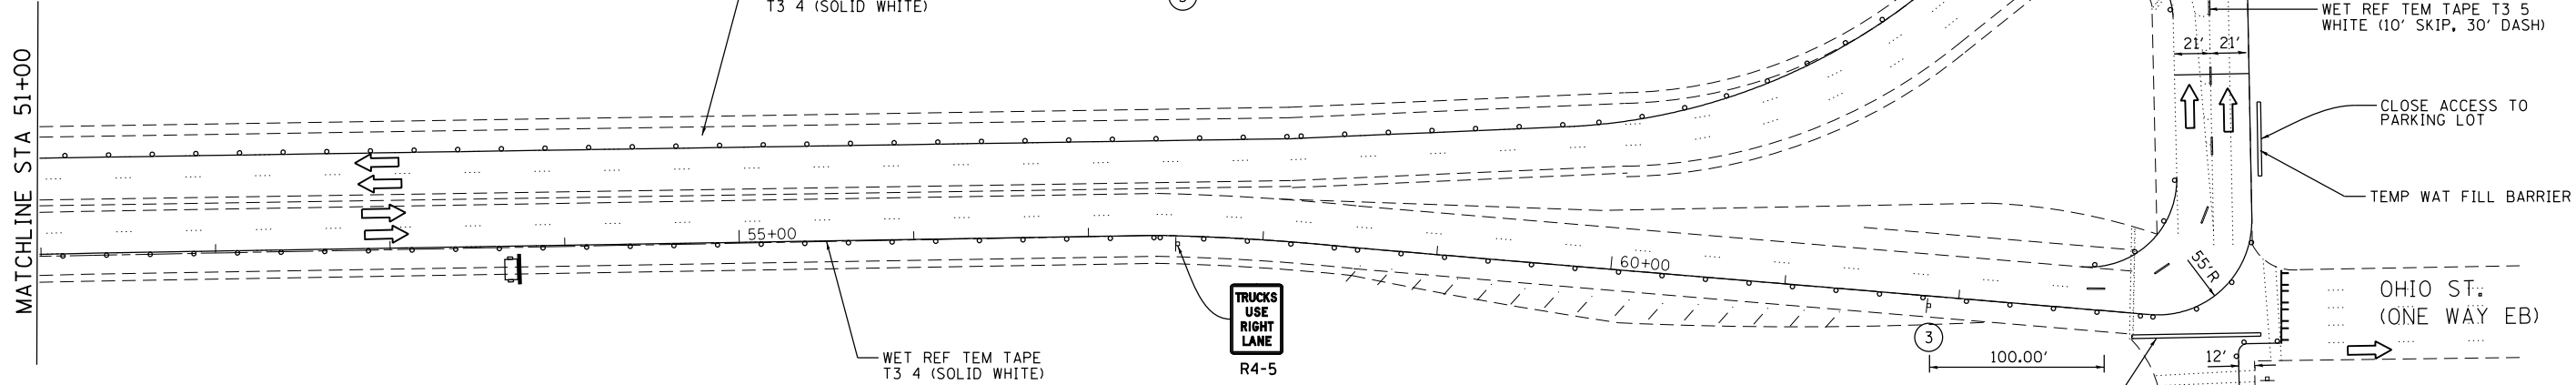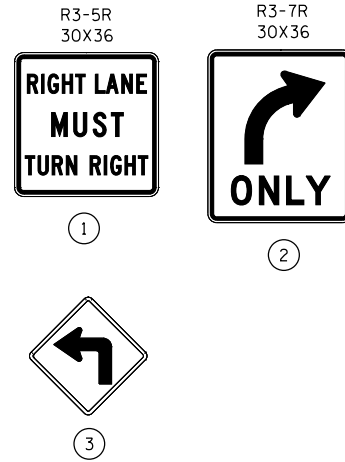

- NOTES:**
- REMOVE EXISTING CONFLICTING PAVEMENT MARKINGS.
 - SEE DETOUR ROUTE A FOR ADDITIONAL SIGNAGE
 - PRIOR TO REMOVAL OF ANY PAVEMENT MARKINGS, THE CONTRACTOR SHALL RETAIN AND RECORD FOR FUTURE REFERENCE ALL EXISTING PAVEMENT MARKING LINES, SYMBOLS, AND LETTERS (AND RAISED REFLECTIVE MARKERS) IN ORDER THAT THESE LOCATIONS CAN BE RE-ESTABLISHED FOR STRIPING. EXACT LOCATIONS OF ALL PAVEMENT MARKINGS AND RAISED REFLECTIVE PAVEMENT MARKERS SHALL BE AS DIRECTED BY THE ENGINEER.
 - SEE DISTRICT DETAIL TC-24 FOR ADDITIONAL DETAILS.
 - TRAFFIC SIGNALS AT ORLEANS ST./OHIO ST. AND AT ORLEANS ST./ONTARIO ST. SHALL BE BAGGED WILE DETOUR IS IN EFFECT. THE COST OF THIS WORK SHALL BE INCLUDED IN THE COST OF TRAFFIC CONTROL AND PROTECTION (SPECIAL).

PAVEMENT MARKING RESTORATION PLAN

FILE NAME = 8FILES




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| PLOT SCALE = 100.000' / in. | DRAWN - | REVISED - |
| PLOT DATE = 3/25/2013 | CHECKED - | REVISED - |
| | DATE - | REVISED - |

**STATE OF ILLINOIS
DEPARTMENT OF TRANSPORTATION**

**STAGING AND TRAFFIC CONTROL
I-90/94 STAGE II
SUBSTAGE C**


SCALE: SHEET NO. OF SHEETS STA. TO STA.

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| F.A.I. RTE. 90/94 | SECTION 0303-474HB-R | COUNTY COOK | TOTAL SHEETS 343 | SHEET NO. 94 |
| CONTRACT NO. 60F63 | | | | |
| FED. ROAD DIST. NO. 1 ILLINOIS FED. AID PROJECT | | | | |

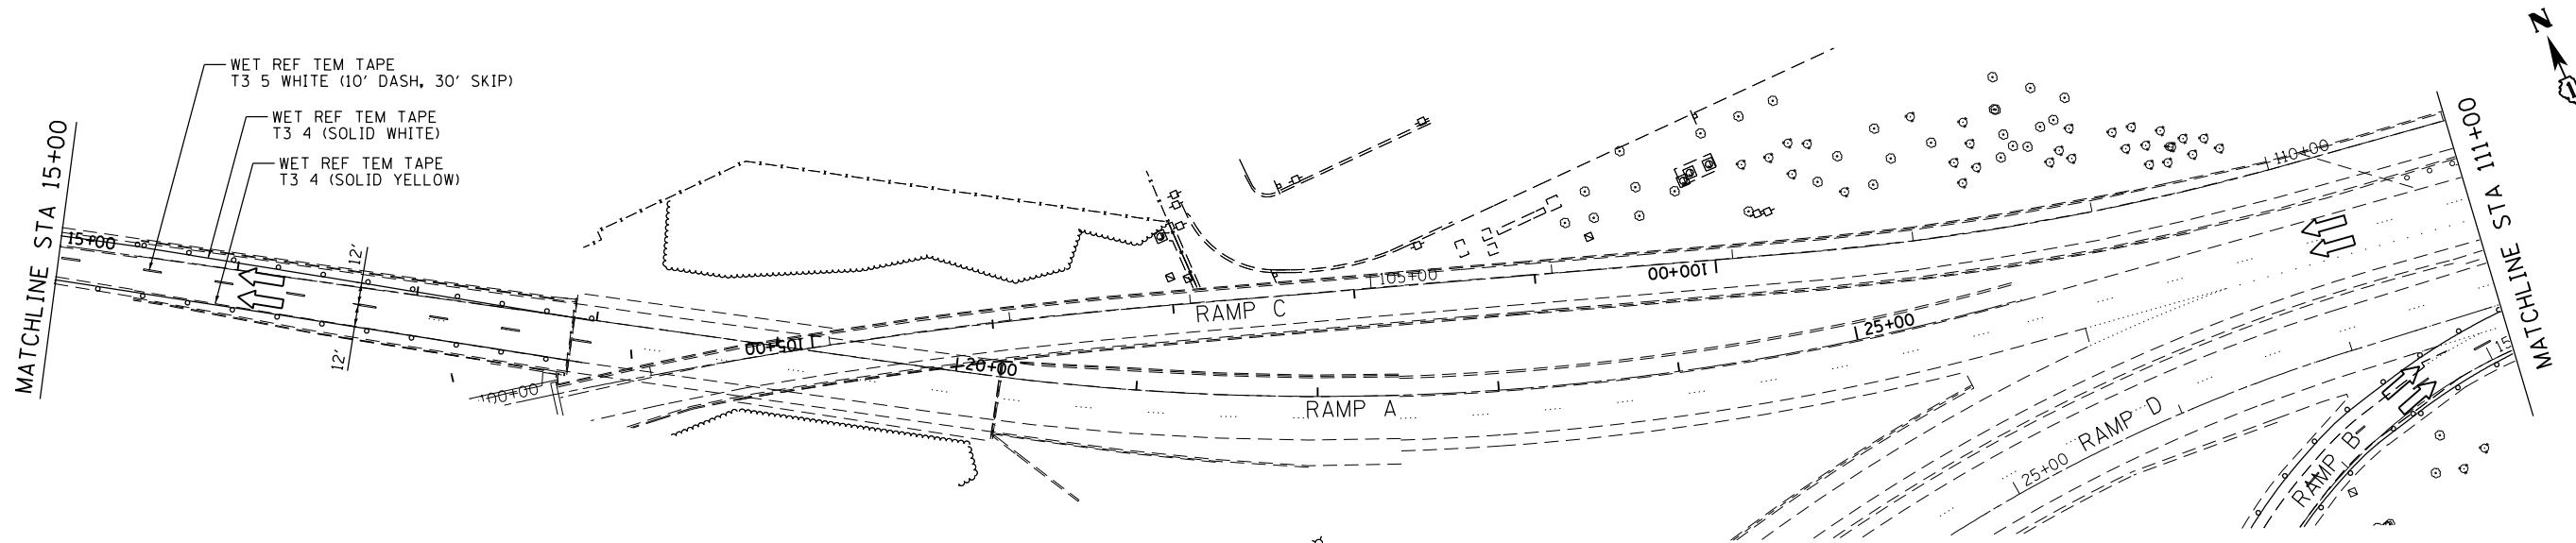

LEGEND

- WORK AREA
- IMPACT ATTENUATOR
- TEMPORARY CONCRETE BARRIER
- TYPE II BARRICADES OR DRUMS WITH STEADY BURN MONODIRECTIONAL LIGHT (AT SPECIFIED SPACING)
- DIRECTION OF TRAFFIC FLOW
- SIGN
- VERTICAL PANELS (AT SPECIFIED SPACING)
- ARROW BOARD
- TYPE III BARRICADE
- BARRIER WALL MARKERS (AT SPECIFIED SPACING)
- TEMPORARY PAVEMENT, CURRENT STAGE
- TEMPORARY PAVEMENT, PREVIOUS STAGE

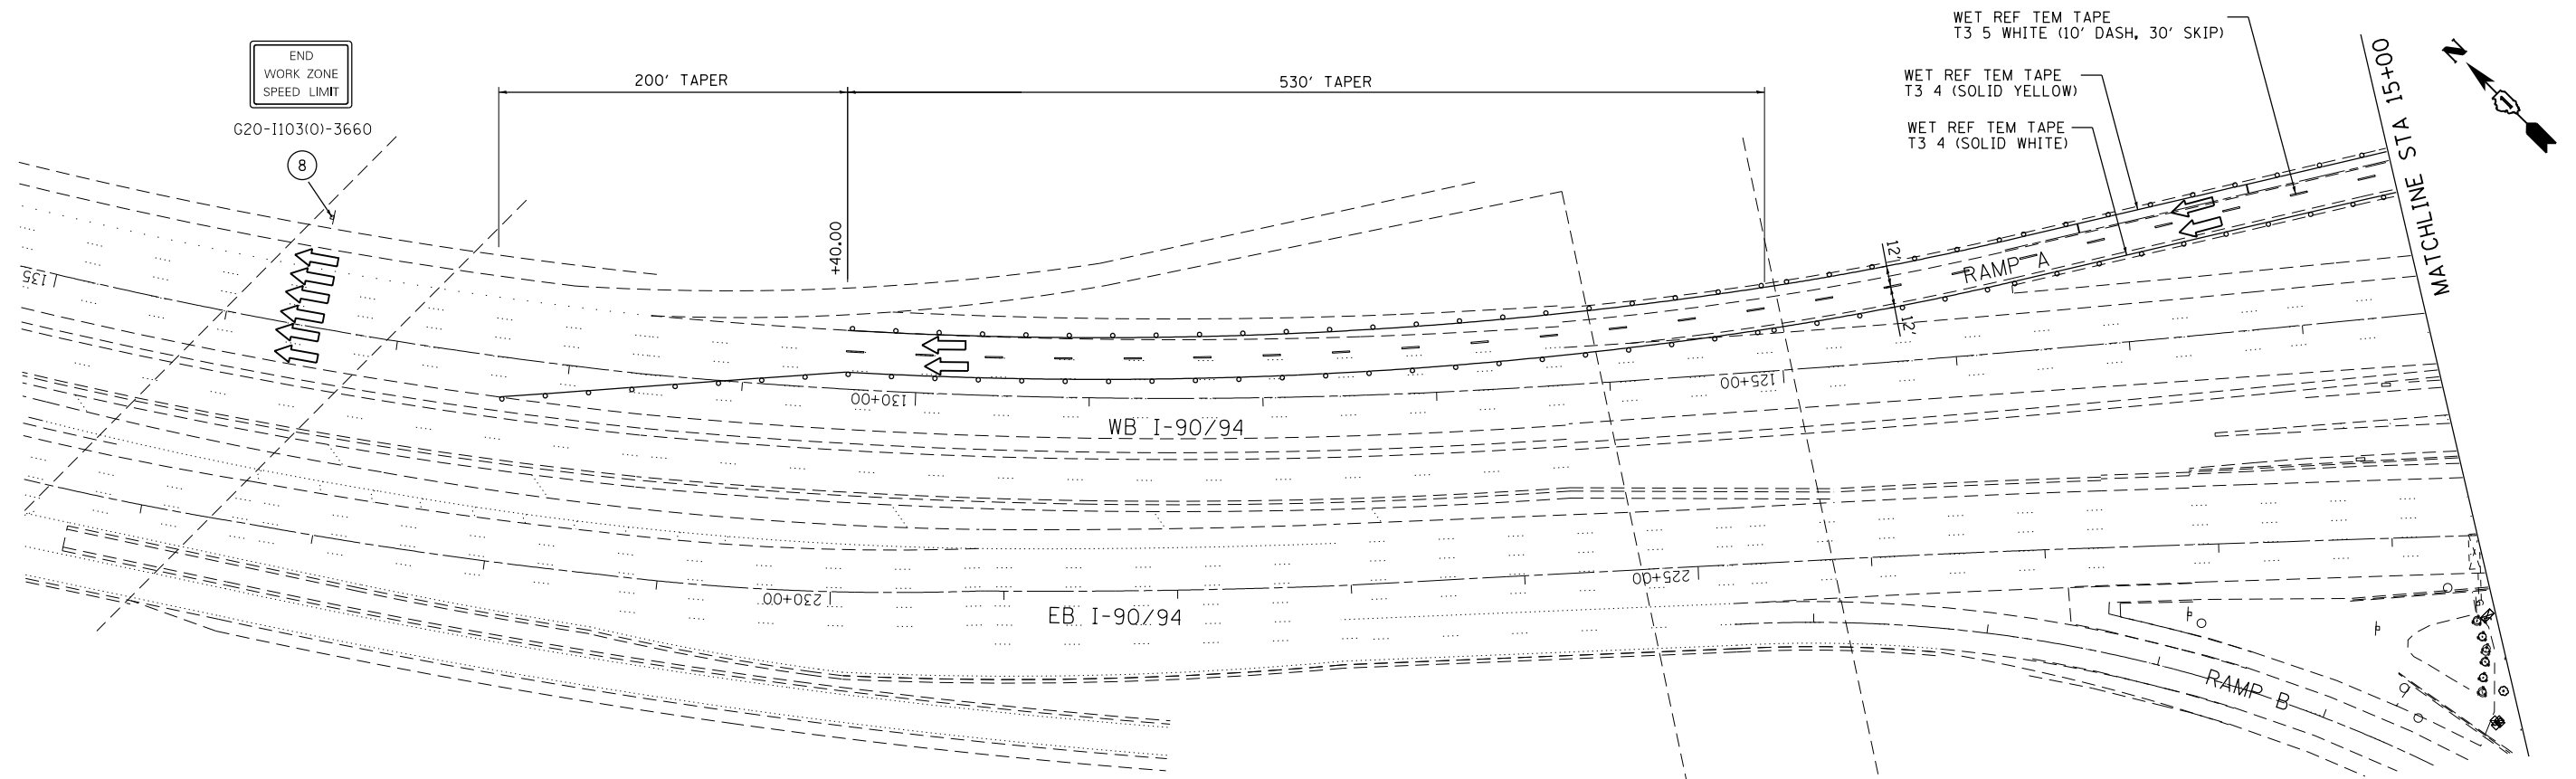

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| | DATE - | REVISED - |








**STATE OF ILLINOIS
DEPARTMENT OF TRANSPORTATION**

**STAGING AND TRAFFIC CONTROL
I-90/94 STAGE II
SUBSTAGE C**

SCALE: SHEET NO. OF SHEETS STA. TO STA.

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|--------------------|----------------------|-------------|------------------|--------------|
| F.A.I. RE. 90/94 | SECTION 0303-474HB-R | COUNTY COOK | TOTAL SHEETS 368 | SHEET NO. 95 |
| CONTRACT NO. 60F63 | | | | |

FED. ROAD DIST. NO. 1 ILLINOIS FED. AID PROJECT

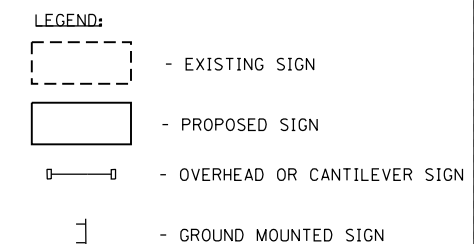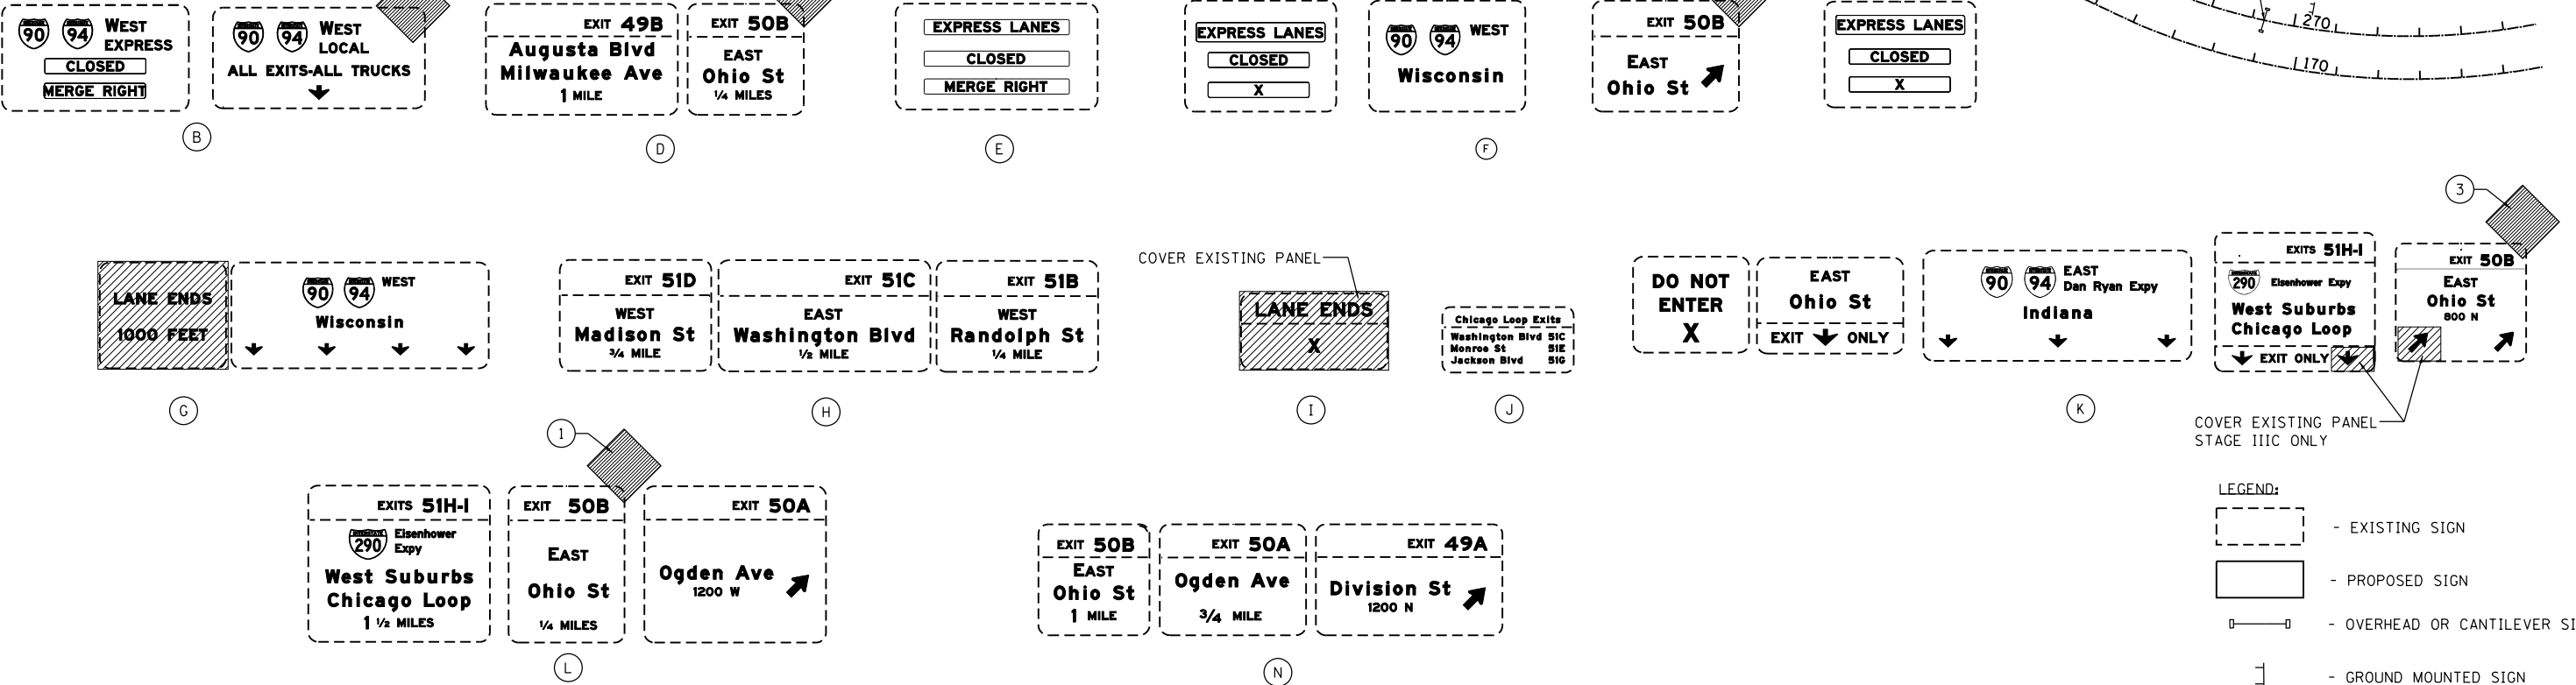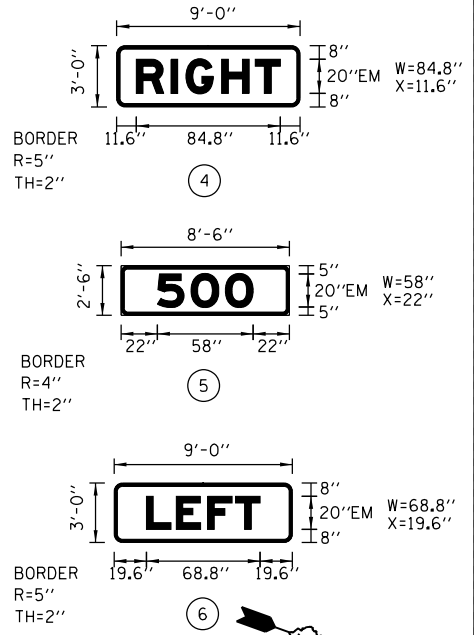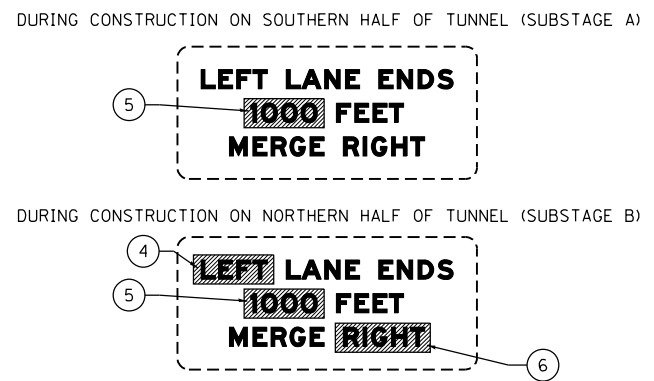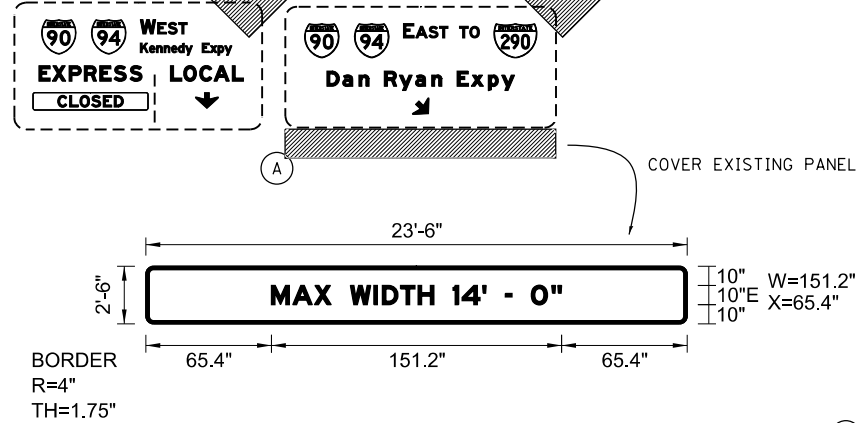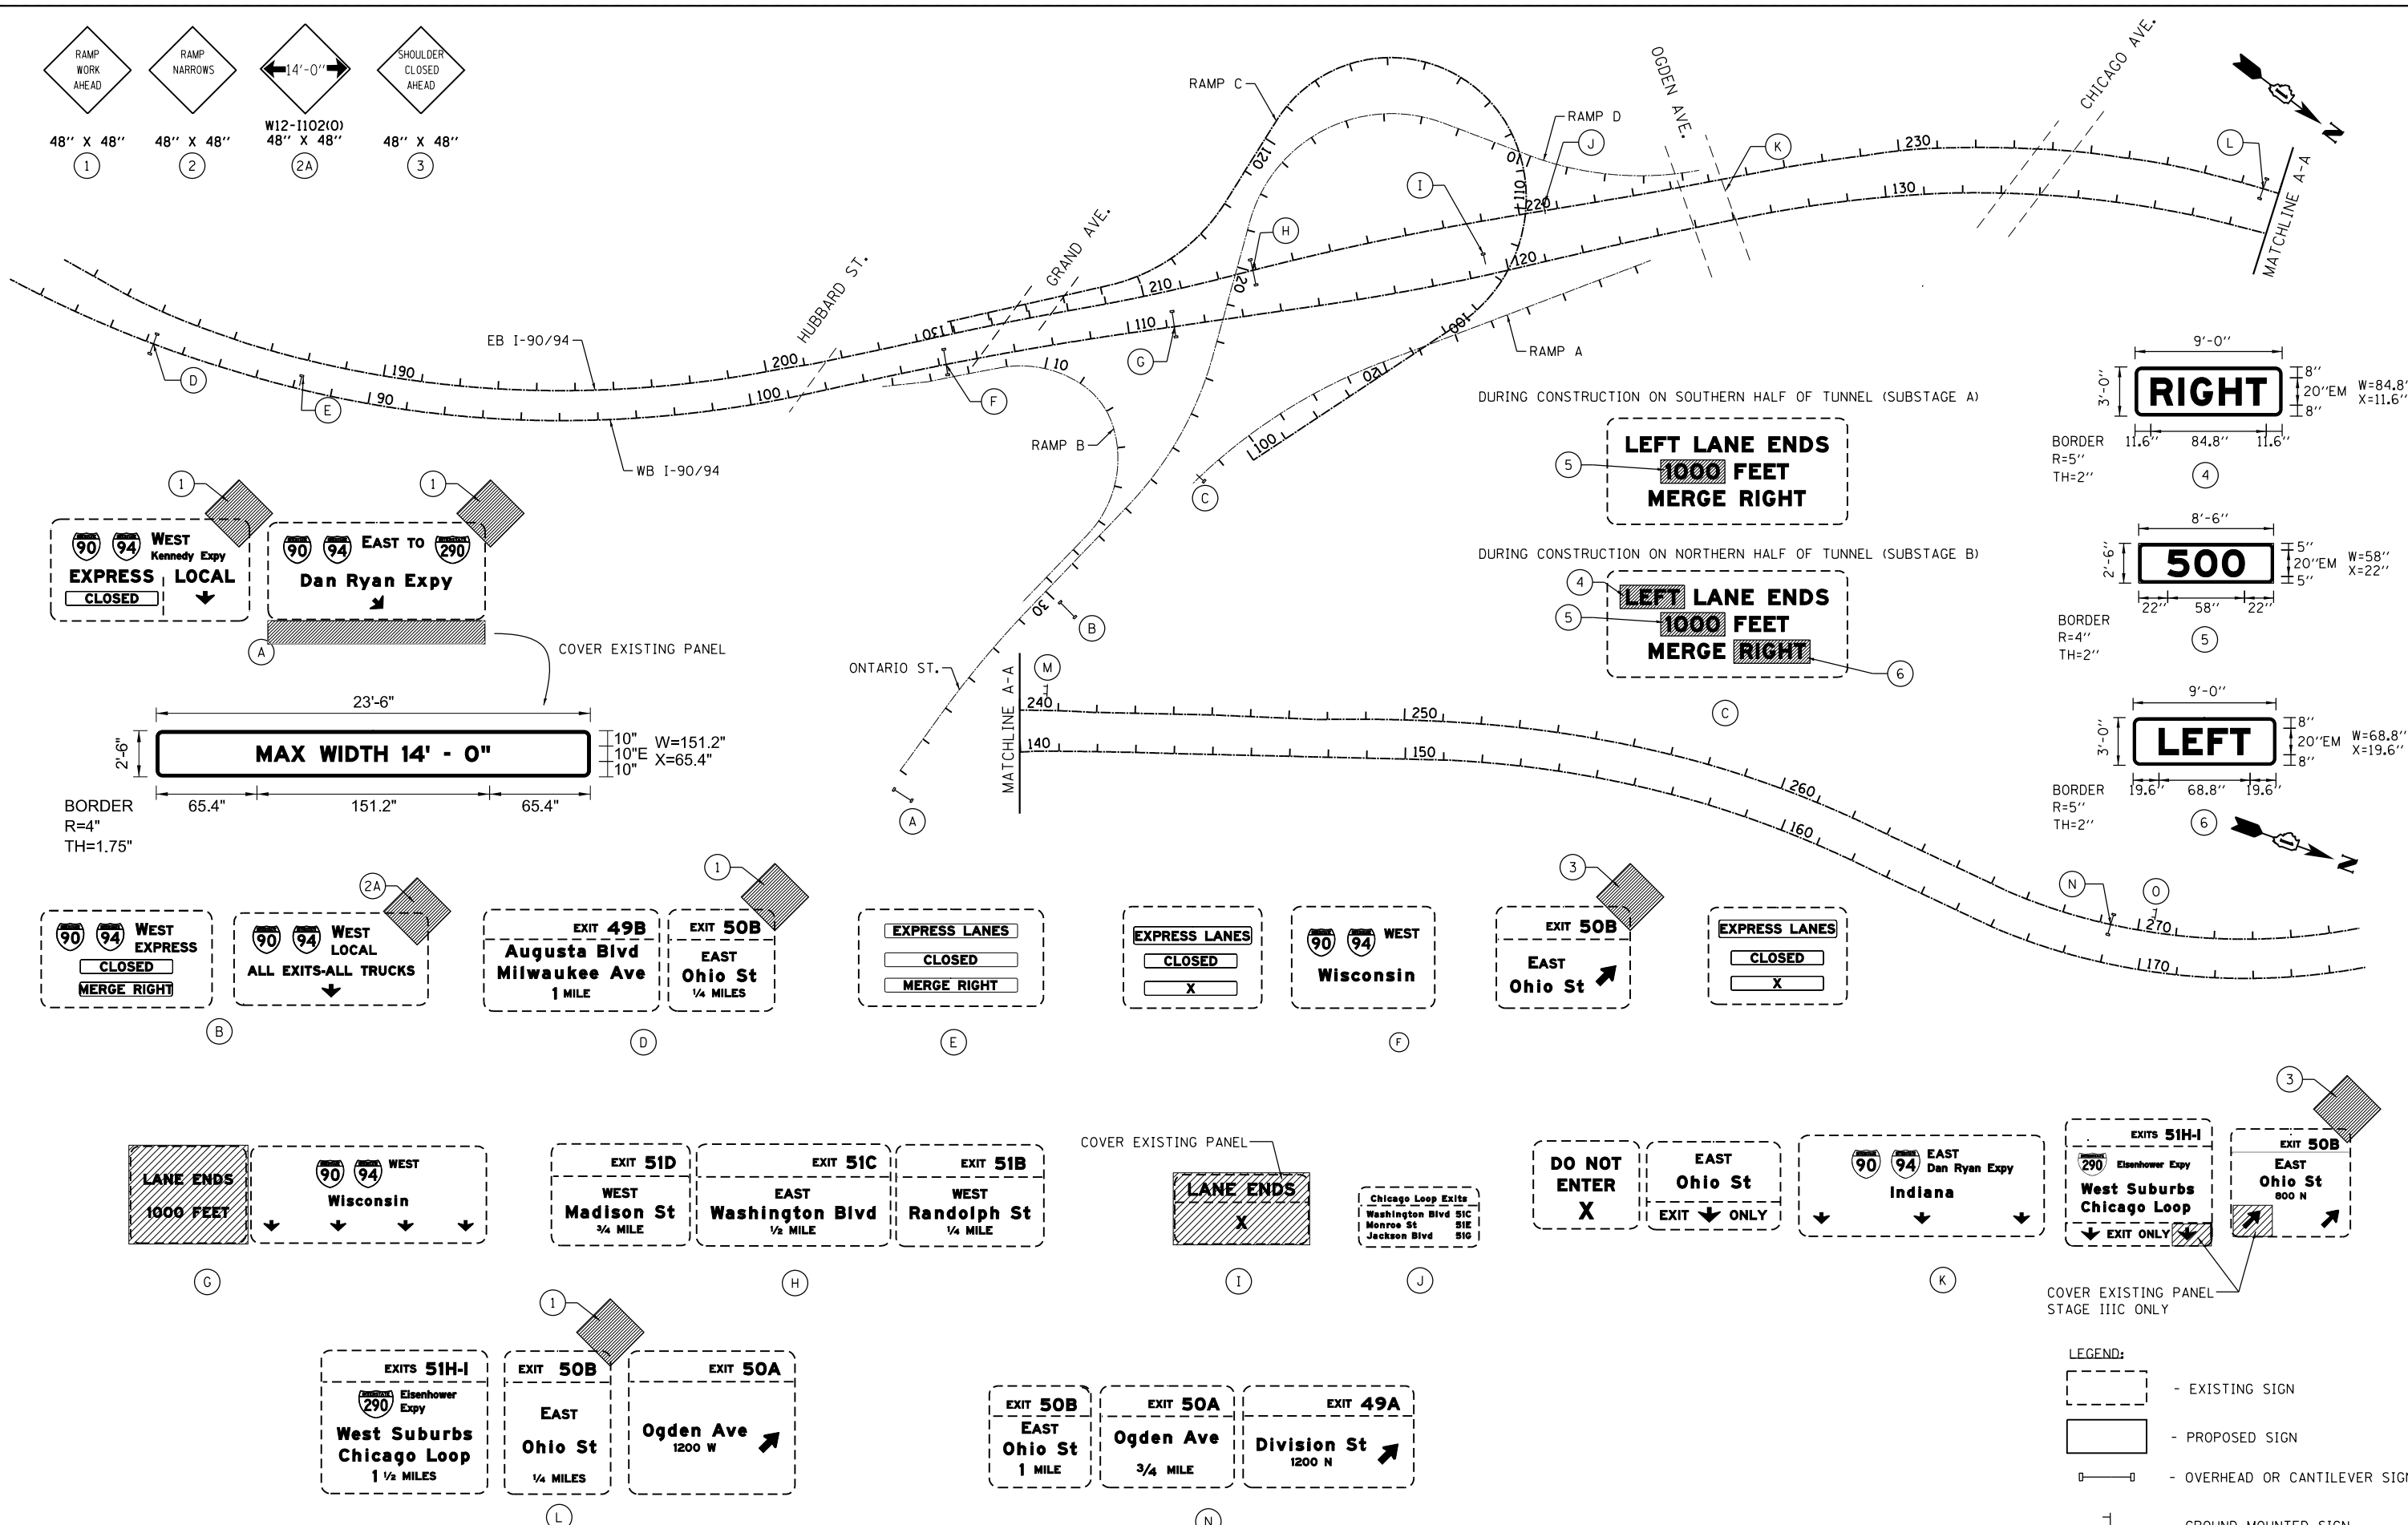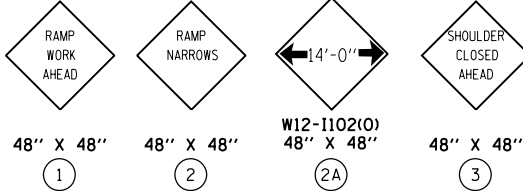

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COLLINS ENGINEERS


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| DATE - | DATE - | REVISED - |

**STATE OF ILLINOIS
DEPARTMENT OF TRANSPORTATION**


**STAGING AND TRAFFIC CONTROL
TEMPORARY SIGNING PLAN
STAGE III**

SCALE: SHEET NO. OF SHEETS STA. TO STA.

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|---|----------------------|-------------|------------------|--------------|
| F.A.I. RTE. 90/94 | SECTION 0303-474HB-R | COUNTY COOK | TOTAL SHEETS 368 | SHEET NO. 96 |
| CONTRACT NO. 60F63 | | | | |
| FED. ROAD DIST. NO. 1 ILLINOIS FED. AID PROJECT | | | | |

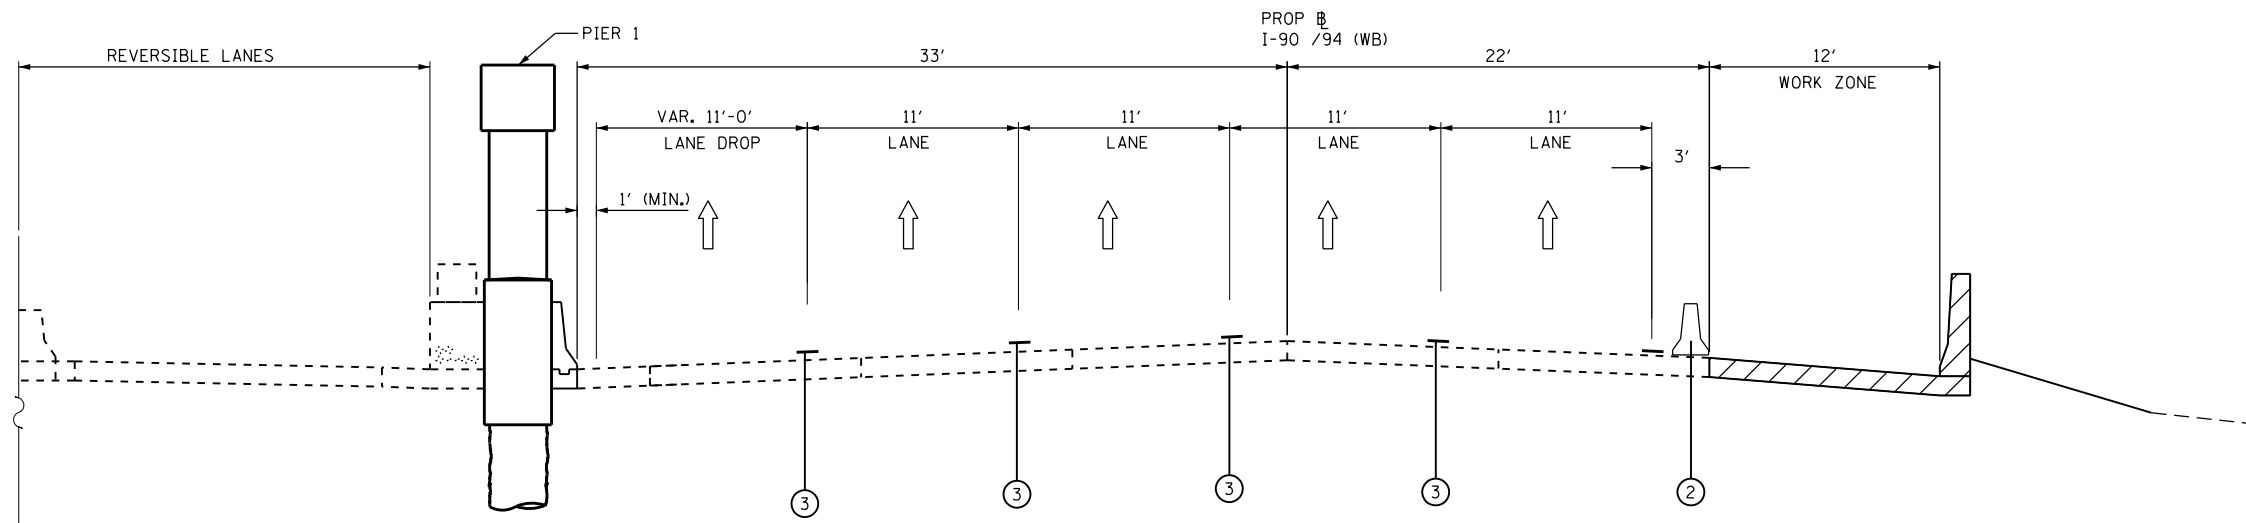

TYPICAL SECTION - SUBSTAGE IIIC
I-90/ 94 (KENNEDY EXPRESSWAY)
WESTBOUND LANES

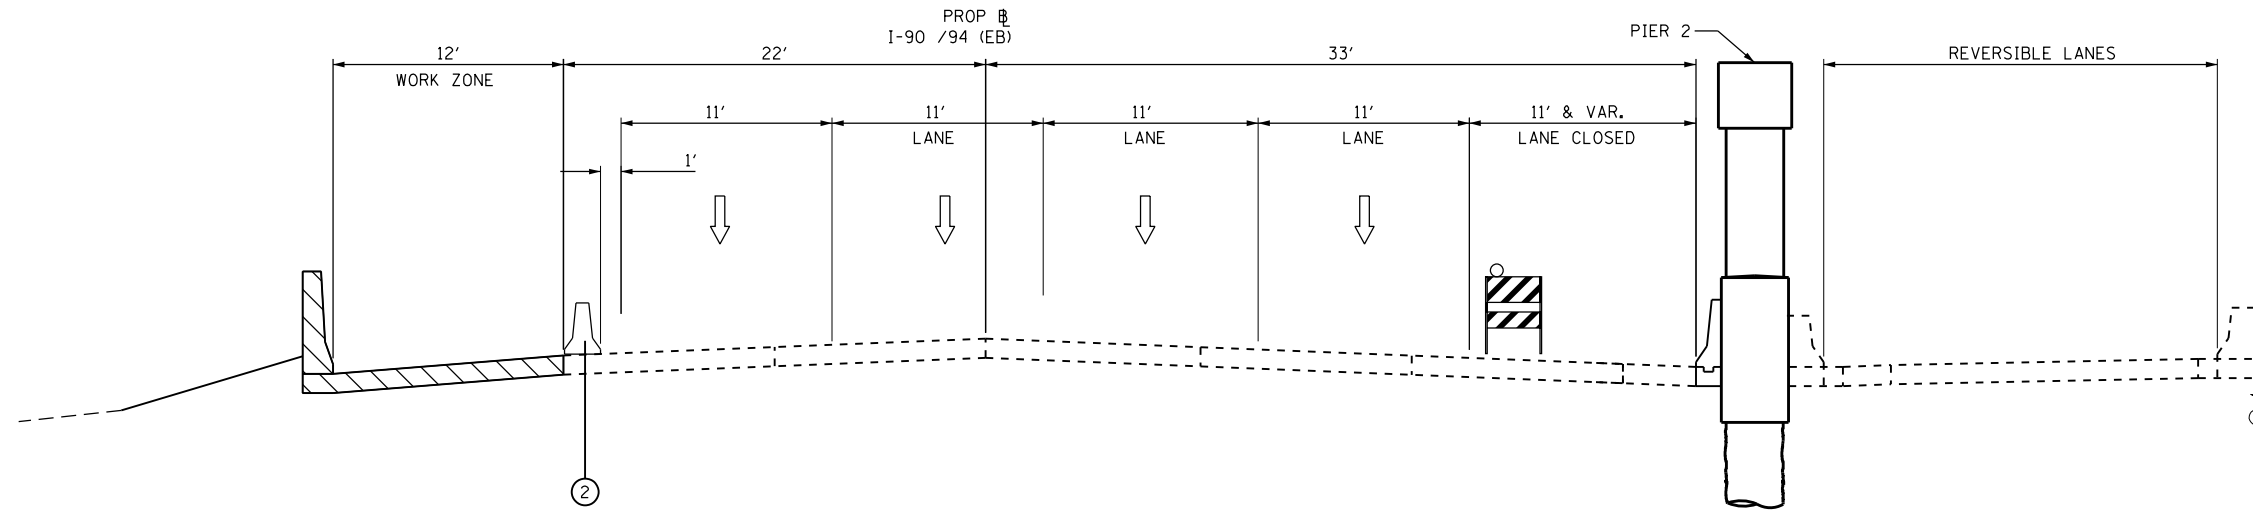

TYPICAL SECTION - SUBSTAGE IIIC
I-90/ 94 (KENNEDY EXPRESSWAY)
EASTBOUND LANES

PROPOSED LEGEND:

- ① MOVEABLE TRAFFIC BARRIER
- ② TEMPORARY CONCRETE BARRIER
- ③ WET REFLECTIVE TEMPORARY TAPE TYPE III - LINE 5" WHITE (10' DASH, 30' SKIP)

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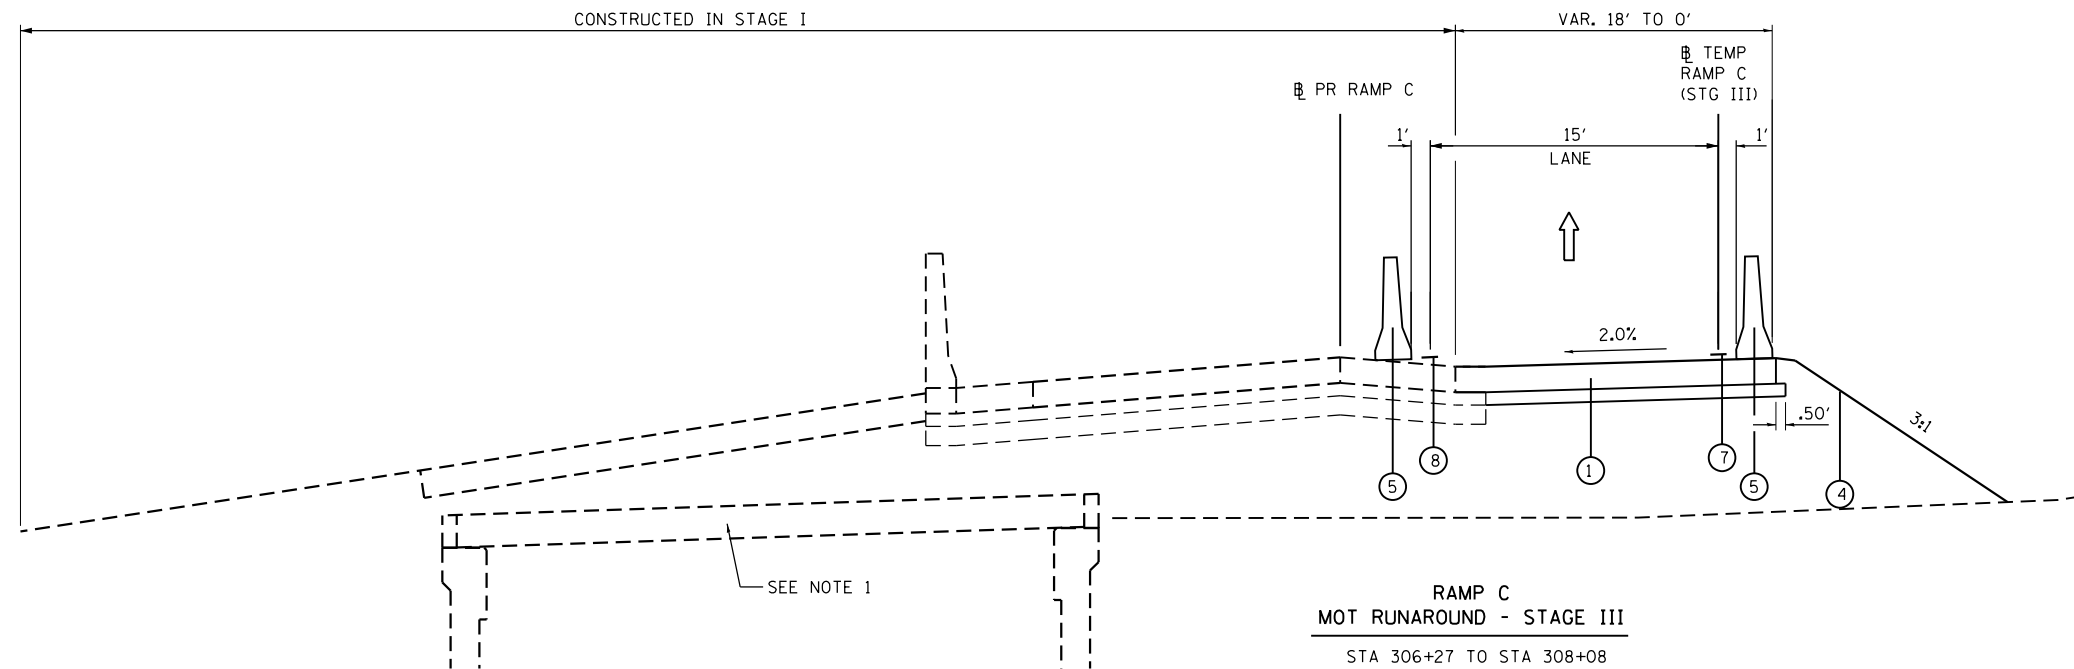
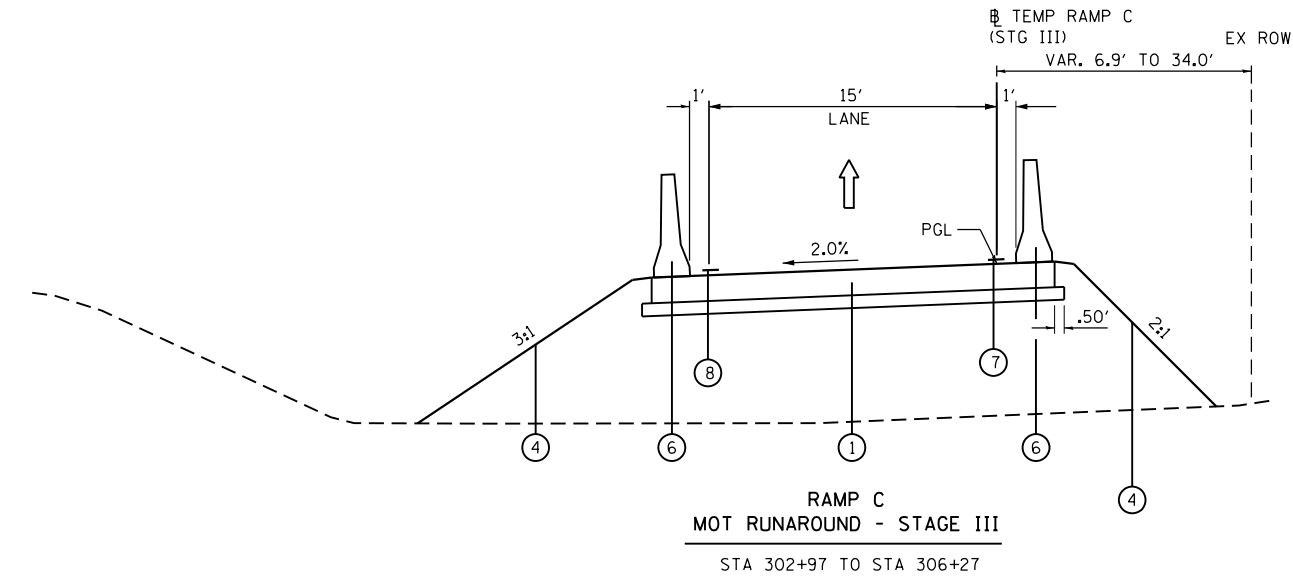
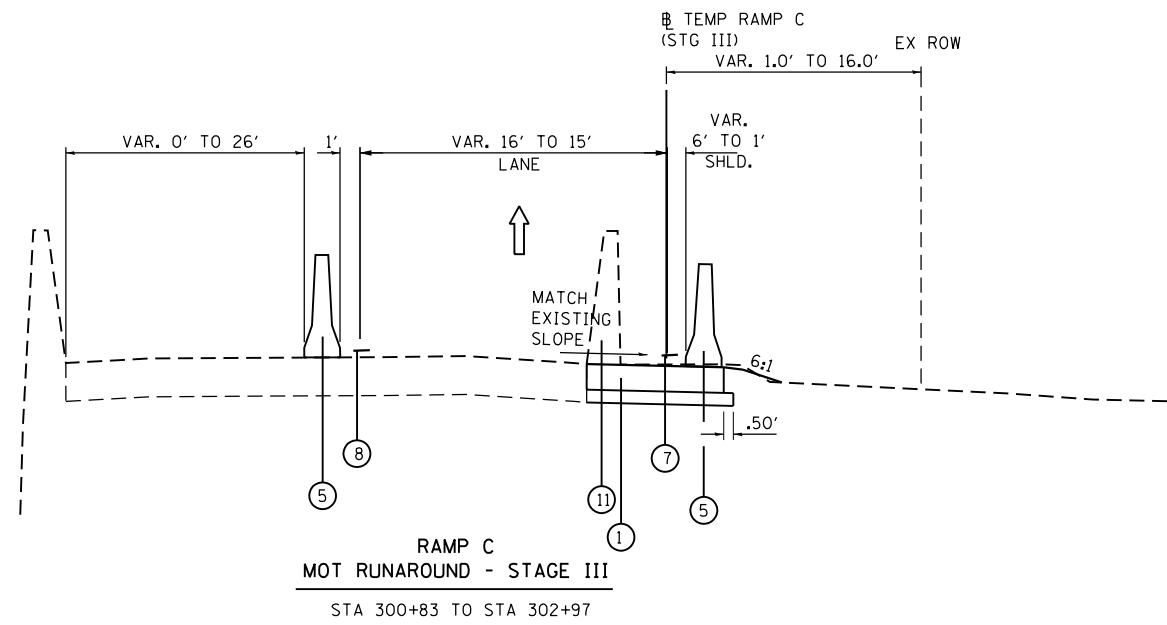
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| PLOT DATE = 3/25/2013 | CHECKED - | REVISED - |
| | DATE - | REVISED - |

STATE OF ILLINOIS
DEPARTMENT OF TRANSPORTATION

STAGING AND TRAFFIC CONTROL
I-90/94 TYPICAL SECTIONS
STAGE III

SCALE: SHEET NO. OF SHEETS STA. TO STA.

| F.A.I. RTE. | SECTION | COUNTY | TOTAL SHEETS | SHEET NO. |
|---|--------------|--------|--------------------|-----------|
| 90/94 | 0303-474HB-R | COOK | 368 | 98 |
| FED. ROAD DIST. NO. 1 ILLINOIS FED. AID PROJECT | | | CONTRACT NO. 60F63 | |



PROPOSED LEGEND:

- ① TEMPORARY PAVEMENT, 8"
- ② AGGREGATE SUBGRADE IMPROVEMENT, 4"
- ③ AGGREGATE SHOULDERS, TYPE B, 6"
- ④ TEMPORARY EROSION CONTROL SEEDING
- ⑤ TEMPORARY CONCRETE BARRIER
- ⑥ TEMPORARY CONCRETE BARRIER, RELOCATE
- ⑦ WET REFLECTIVE TEMPORARY TAPE TYPE III - LINE 4" WHITE
- ⑧ WET REFLECTIVE TEMPORARY TAPE TYPE III - LINE 4" YELLOW
- ⑨ WET REFLECTIVE TEMPORARY TAPE TYPE III - LINE 4" WHITE (2' DASH - 6' SKIP)
- ⑩ WET REFLECTIVE TEMPORARY TAPE TYPE III - LINE 8" WHITE

NOTES:

1. SEE STRUCTURAL PLANS FOR STAGE III TYPICAL CROSS SECTIONS FROM STA 308+08 TO STA 313+42 AND TUNNEL ROOF DETAILS.
2. TEMPORARY PAVEMENT ON RAMP C SHALL BE ACCORDING TO THE PAVEMENT STRUCTURE DETAILS AND MIX DESIGN REQUIREMENTS ON THE TYPICAL SECTIONS
3. THE TEMPORARY CONCRETE BARRIER SHALL BE SECURED TO THE PAVEMENT USING THREE (3) ANCHORING PINS ON THE TRAFFIC SIDE OF THE BARRIER AT LOCATIONS WHERE A HAZARD OR SLOPE STEEPER THAN 1V:10H EXISTS WITHIN 3 FEET TO THE BARRIER. THE COST OF THIS WORK SHALL BE INCLUDED IN THE CONTRACT UNIT PRICE FOR "TEMPORARY CONCRETE BARRIER", OR "RELOCATE TEMPORARY CONCRETE BARRIER", AS APPLICABLE.
4. THE PAY ITEM, TEMPORARY PAVEMENT, 8 INCH, INCLUDES BOTH TEMPORARY PAVEMENT AND TEMPORARY SHOULDERS.

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COLLINS ENGINEERS




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| | DATE - | REVISED - |

**STATE OF ILLINOIS
DEPARTMENT OF TRANSPORTATION**

**STAGING AND TRAFFIC CONTROL
RAMP C TYPICAL SECTIONS
STAGE III**

SCALE: SHEET NO. OF SHEETS STA. TO STA.

| | | | | |
|---|--------------|--------|--------------|-----------|
| F.A.I. RE. | SECTION | COUNTY | TOTAL SHEETS | SHEET NO. |
| 90/94 | 0303-474HB-R | COOK | 368 | 99 |
| CONTRACT NO. 60F63 | | | | |
| FED. ROAD DIST. NO. 1 ILLINOIS FED. AID PROJECT | | | | |

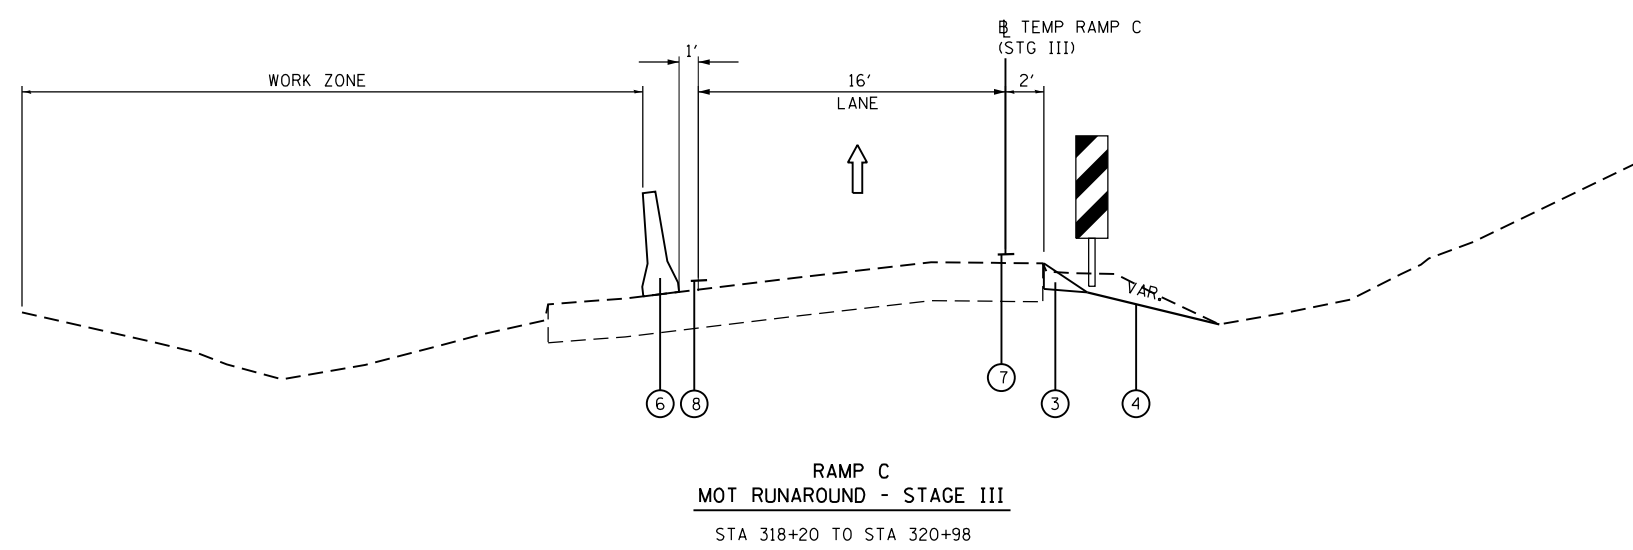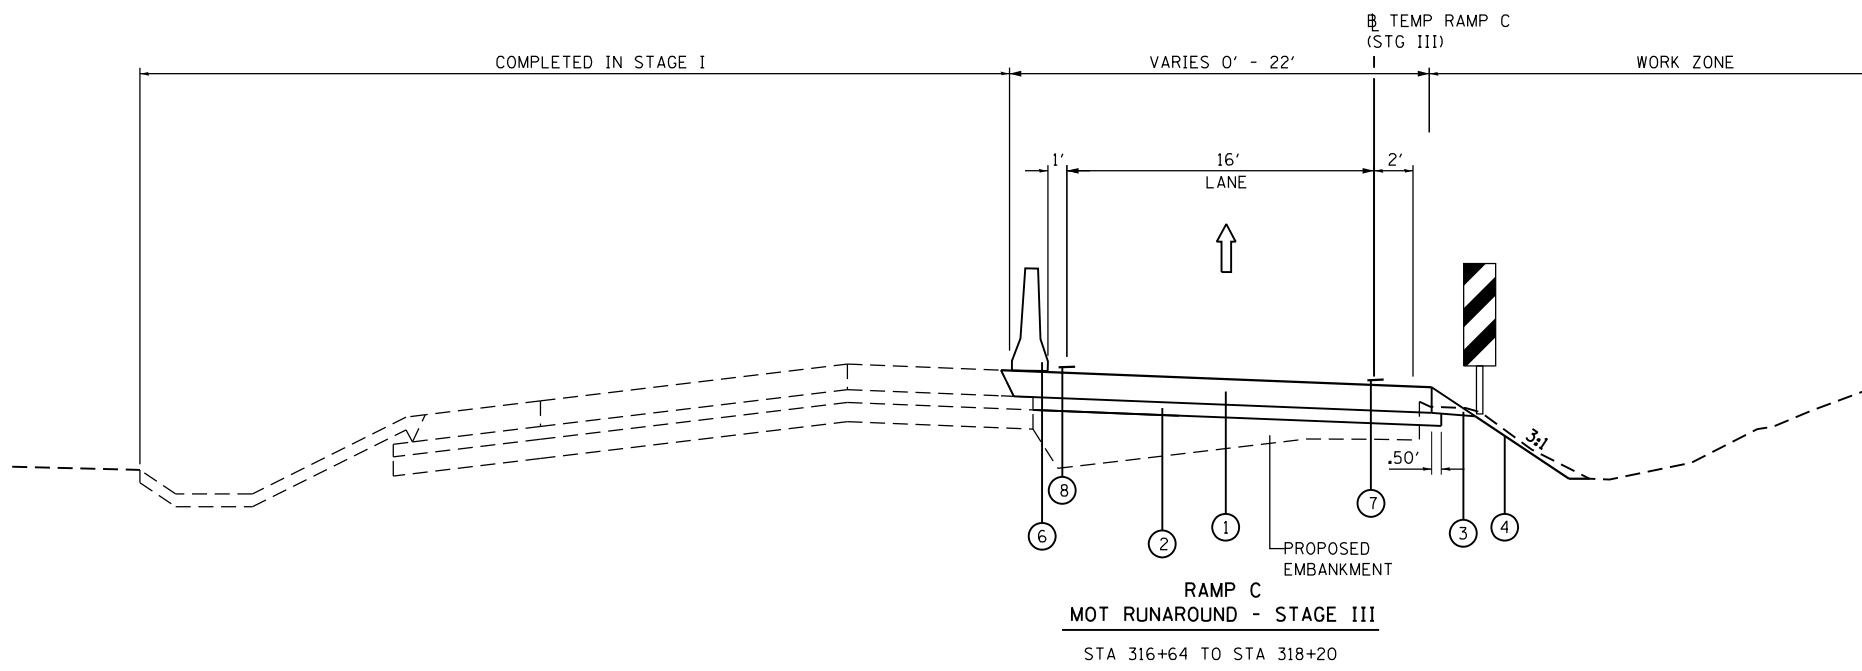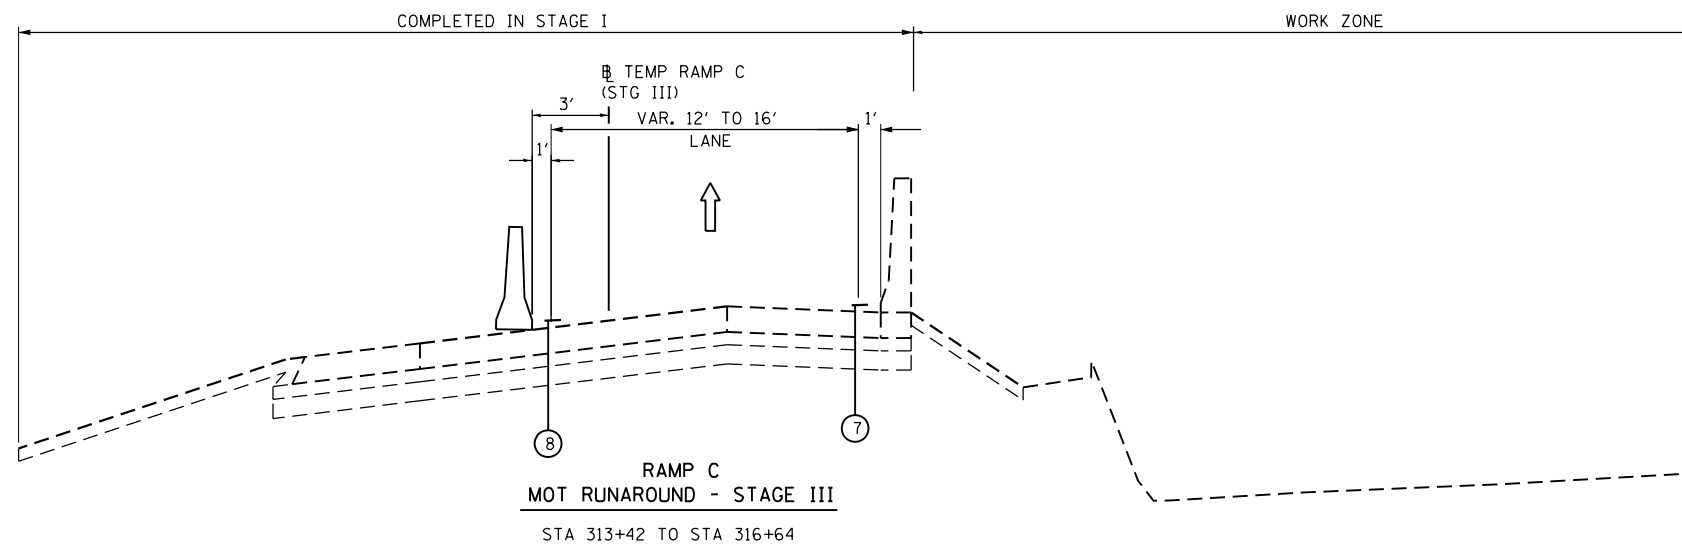

PROPOSED LEGEND:

- ① TEMPORARY PAVEMENT, 8"
- ② AGGREGATE SUBGRADE IMPROVEMENT, 4"
- ③ AGGREGATE SHOULDERS, TYPE B, 6"
- ④ TEMPORARY EROSION CONTROL SEEDING
- ⑤ TEMPORARY CONCRETE BARRIER
- ⑥ TEMPORARY CONCRETE BARRIER, RELOCATE
- ⑦ WET REFLECTIVE TEMPORARY TAPE TYPE III - LINE 4" WHITE
- ⑧ WET REFLECTIVE TEMPORARY TAPE TYPE III - LINE 4" YELLOW
- ⑨ WET REFLECTIVE TEMPORARY TAPE TYPE III - LINE 4" WHITE (2' DASH - 6' SKIP)
- ⑩ WET REFLECTIVE TEMPORARY TAPE TYPE III - LINE 8" WHITE

NOTES:

1. SEE STRUCTURAL PLANS FOR STAGE III TYPICAL CROSS SECTIONS FROM STA 308+08 TO STA 313+42 AND TUNNEL ROOF DETAILS.
2. TEMPORARY PAVEMENT ON RAMP C SHALL BE ACCORDING TO THE PAVEMENT STRUCTURE DETAILS AND MIX DESIGN REQUIREMENTS ON THE TYPICAL SECTIONS
3. THE TEMPORARY CONCRETE BARRIER SHALL BE SECURED TO THE PAVEMENT USING THREE (3) ANCHORING PINS ON THE TRAFFIC SIDE OF THE BARRIER AT LOCATIONS WHERE A HAZARD OR SLOPE STEEPER THAN 1V:10H EXISTS WITHIN 3 FEET TO THE BARRIER. THE COST OF THIS WORK SHALL BE INCLUDED IN THE CONTRACT UNIT PRICE FOR "TEMPORARY CONCRETE BARRIER", OR "RELOCATE TEMPORARY CONCRETE BARRIER", AS APPLICABLE.
4. THE PAY ITEM, TEMPORARY PAVEMENT, 8 INCH, INCLUDES BOTH TEMPORARY PAVEMENT AND TEMPORARY SHOULDERS.

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| PLOT SCALE = 10.0000' / 1" | DRAWN - | REVISED - |
| PLOT DATE = 3/25/2013 | CHECKED - | REVISED - |
| | DATE - | REVISED - |

**STATE OF ILLINOIS
DEPARTMENT OF TRANSPORTATION**

**STAGING AND TRAFFIC CONTROL
RAMP C TYPICAL SECTIONS
STAGE III**

SCALE: SHEET NO. OF SHEETS STA. TO STA.

| | | | | |
|---|--------------|--------|--------------|-----------|
| F.A.I. RTE. | SECTION | COUNTY | TOTAL SHEETS | SHEET NO. |
| 90/94 | 0303-474HB-R | COOK | 368 | 100 |
| CONTRACT NO. 60F63 | | | | |
| FED. ROAD DIST. NO. 1 ILLINOIS FED. AID PROJECT | | | | |