
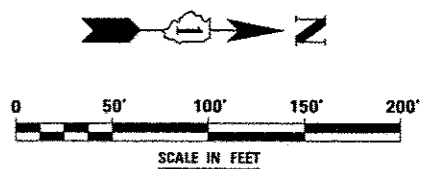


- NOTES:**
- COORDINATE REMOVAL OF EXISTING UNDERPASS LIGHTING WITH THE REMOVAL OF THE STRUCTURE.
 - EXISTING LIGHTING CONTROLLER SHALL REMAIN ACTIVE UNTIL ALL LIGHTING IS TRANSFERRED TO THE NEW CONTROLLER. COORDINATE THE REMOVAL OF EXISTING CONTROLLER WITH ALL TRADES.
 - FOR SYMBOL LIST AND GENERAL ELECTRICAL NOTES, SEE SHEET LT-6.
 - NEW TOLLWAY LIGHTING CONTROLLER SHALL BE INSTALLED AND TEMPORARY AERIAL CONNECTIONS SHALL BE PROVIDED TO ALL TEMPORARY AND EXISTING TO REMAIN LIGHTING UNITS. AERIAL CABLES SHALL BE RUN DOWN THE TEMPORARY WOOD POLE UNDERGROUND AND THROUGH THE CONDUIT ELBOWS IN THE CONTROLLER FOUNDATION TO THE PROPER CIRCUIT BREAKERS. AERIAL CONNECTIONS SHALL BE REMOVED AFTER ALL NEW LIGHTING UNITS AND WIRING BECOME FUNCTIONAL.
 - FOR COMED SERVICE TO NEW LIGHTING CONTROLLER, SEE DETAIL ON SHEET LT-19.

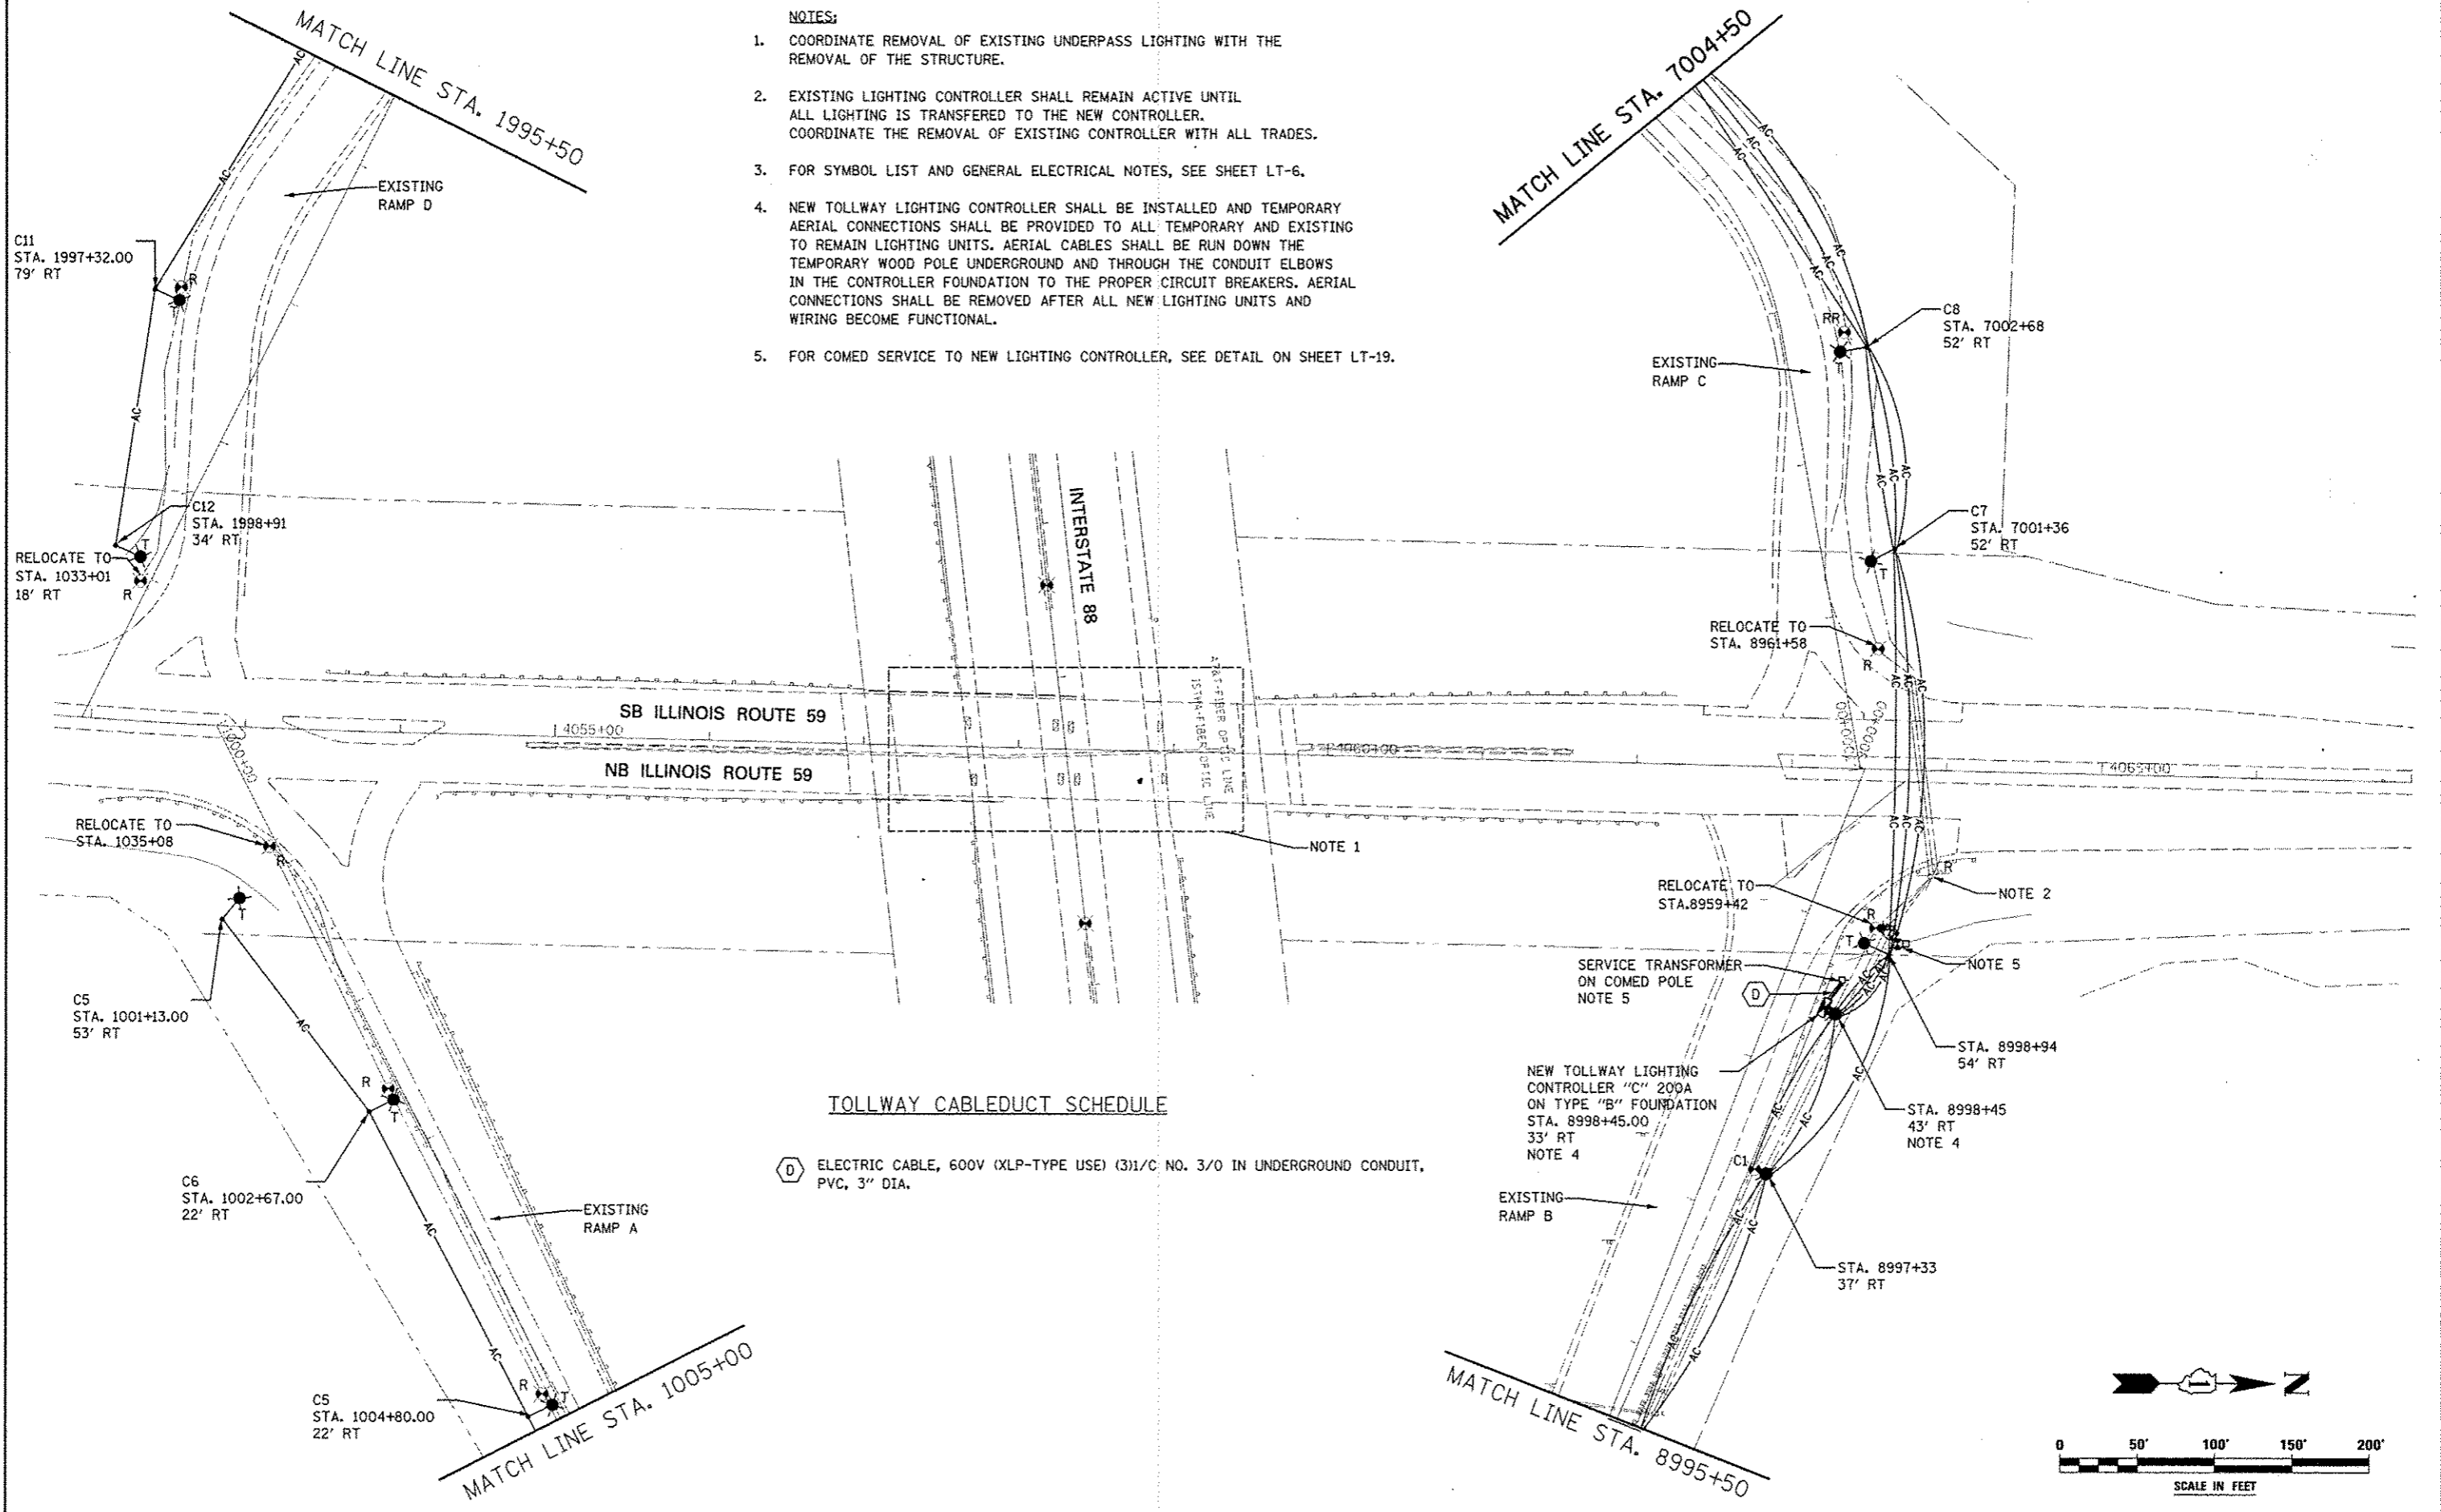

FILE NAME: 41111111	USER NAME: MUSER	DESIGNED: MCP	REVISED: -	STATE OF ILLINOIS DEPARTMENT OF TRANSPORTATION	TOLLWAY DEMOLITION AND TEMPORARY LIGHTING PLAN ILLINOIS ROUTE 59 AT INTERSTATE 88	F.A.P. RTE.:	SECTION:	COUNTY:	TOTAL SHEETS:	SHEET NO.:	
DESIGNED: MCP	DRAWN: MLB	CHECKED: MCP	DATE: 10/15/2012			338	(112 & 113) WRS-5	DUPAGE	963	562	
PLLOT SCALE: 1/8"=1'-0"	PLLOT DATE: 10/15/2012					LT-07		CONTRACT NO. 60131		ILLINOIS FED. AID PROJECT	
						SCALE: AS SHOWN SHEET NO. 1 OF 5 SHEETS STA. 4051+75 TO STA. 4067+00					