FOR QUAD CITY ROCK ISLAND COUNTY SRE BUILDING **RAMP IMPROVEMENTS**

CONSTRUCTION PLANS INTERNATIONAL AIRPORT

INDEX OF	SHEETS	
1	COVER SHEET & INDEX OF SHEETS	
2	SAFETY PLAN	
3	SUMMARY OF QUANTITIES AND GENERAL NOTES	
4	TYPICAL SECTIONS & LEGEND	
5-7	CONSTRUCTION DETAILS	
8	OVERALL STAGING PLAN	
9-12	CONSTRUCTION STAGING PLANS - (STAGE $1-4$)	
13	ACCESS AND STAGING AREA PLAN	
14-15	REMOVALS PLAN - (WEST & EAST)	
16	OVERALL SITE PLAN	
17-18	SITE PLAN – (WEST & EAST)	
19	STORM SEWER PLAN & PROFILES	
20	OVERALL GRADING PLAN	I I I
21	GRADING PLAN - NORTHEAST	
22-23	PAVEMENT JOINT ELEVATION PLAN - (WEST & EAST)	AIP
24-25	PAVEMENT JOINT PLAN - (WEST & EAST)	
26	WATER MAIN LOOPING PLAN	PORT
27	ADA RAMP	
28	ELECTRICAL SITE PLAN	LATITUDE
SUMMARY	7 OF QUANTITIES	
•	SEE SHEET 3	
idot higi	HWAY STANDARDS (INCLUDED BY REFER	SMCC)
	TEMPORARY EROSION CONTROL SYSTEMS	
	INLET- TYPE A	
	MANHOLE- TYPE A	
	FRAME AND LIDS TYPE 1	
	GRATE TYPE 8	
	TRAFFIC CONTROL DEVICES	
	TELESCOPING STEEL SIGN SUPPORT	
	DETECTOR LOOP INSTALLATIONS	
886006-01	TYPICAL LAYOUTS FOR DETECTION LOOPS	

24A




LINOIS PROJECT MLI-3896 PROJECT NO. 3-17-0068-XX T CLASSIFICATION - AIR CARRIER

)E 41°26'51.4", LONGITUDE 91°31'41.6", ELEVATION 589 M.S.L. AIRCRAFT APPROACH CATEGORY - D AIRCRAFT DESIGN GROUP - IV

> MAY 10, 2013 OFFICIAL DATE OF PLANS

Me	etrop	olitaı utho
OF	ROCK	
Bruce	Carter	
May 1	0,201	3
		· · · · · · · · · · · ·

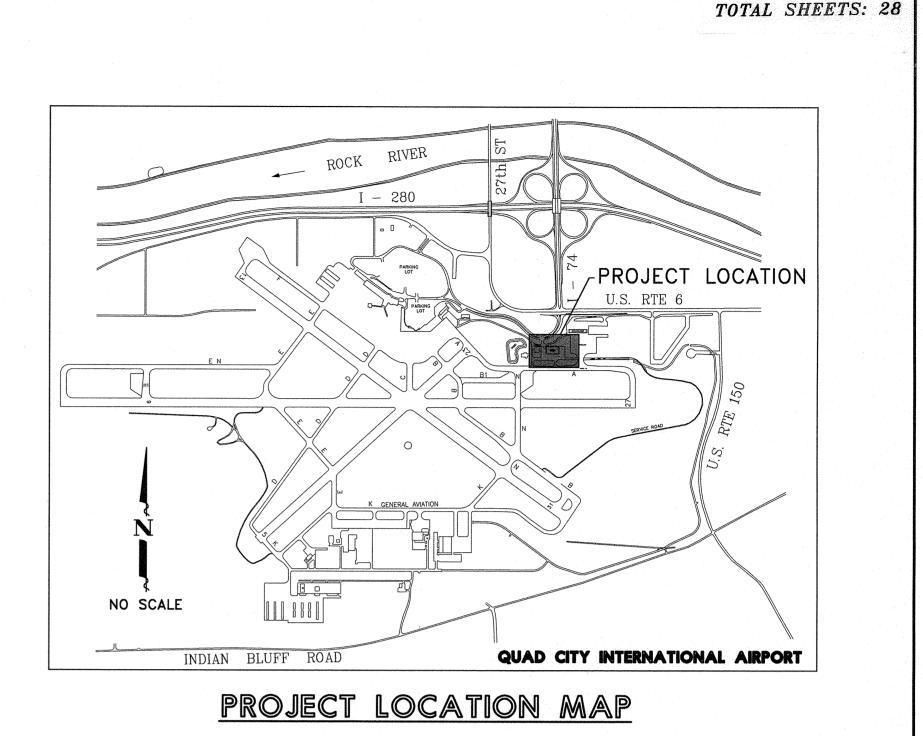

UTILITY NOTE

OF UNDERGROUND UTILITIES AS INDICAT ACCURACY OR SUFFICIENCY OF THE INFORMATION AND EXPRESSED OR IMPLIED. THE EXACT LOCATION AND ELEVATION OF ALL UTILITIES AND TO ASCERTAIN WHETHER ANY ADDITIONAL FACILITIES OTHER THAN THOSE SHOWN ON THE PLAN MAY BE PRESENT. GIVE FORTY-EIGHT HOURS NOTICE TO ALL UTILITY COMPANIES PRIOR TO STARTING CONSTRUCTION OPERATIONS, INCLUDING QUAD CITY INTERNATIONAL AIRPORT & F.A.A. FACILITIES NOT ON J.U.L.I.E.

BEFORE YOU DIG CALL J.U.L.I.E.

1-800-892-0123

BEFORE YOU DIG CALL QUAD CITY INTERNATIONAL AIRPORT 1-309-764-9621

> **BEFORE YOU DIG CALL F.A.A.** 1-309-793-5832





QUAD CITY OFFICE 4700 Kennedy Drive (309) 792-9350

> SCOTT A. STEPHENSON 062-055600

East Moline, Illinois 61244 Fax (309) 792-8974


QU009

I hereby certify that this engineering document was prepared by me or under my direct personal supervision and that I am a duly licensed Professional Engineer under the laws of the State of Illinois.

in Airport ority AND COUNTY

DATE APPROVED

My License renewal date is November 30, 2013. Pages or sheets covered by this seal: 1-27

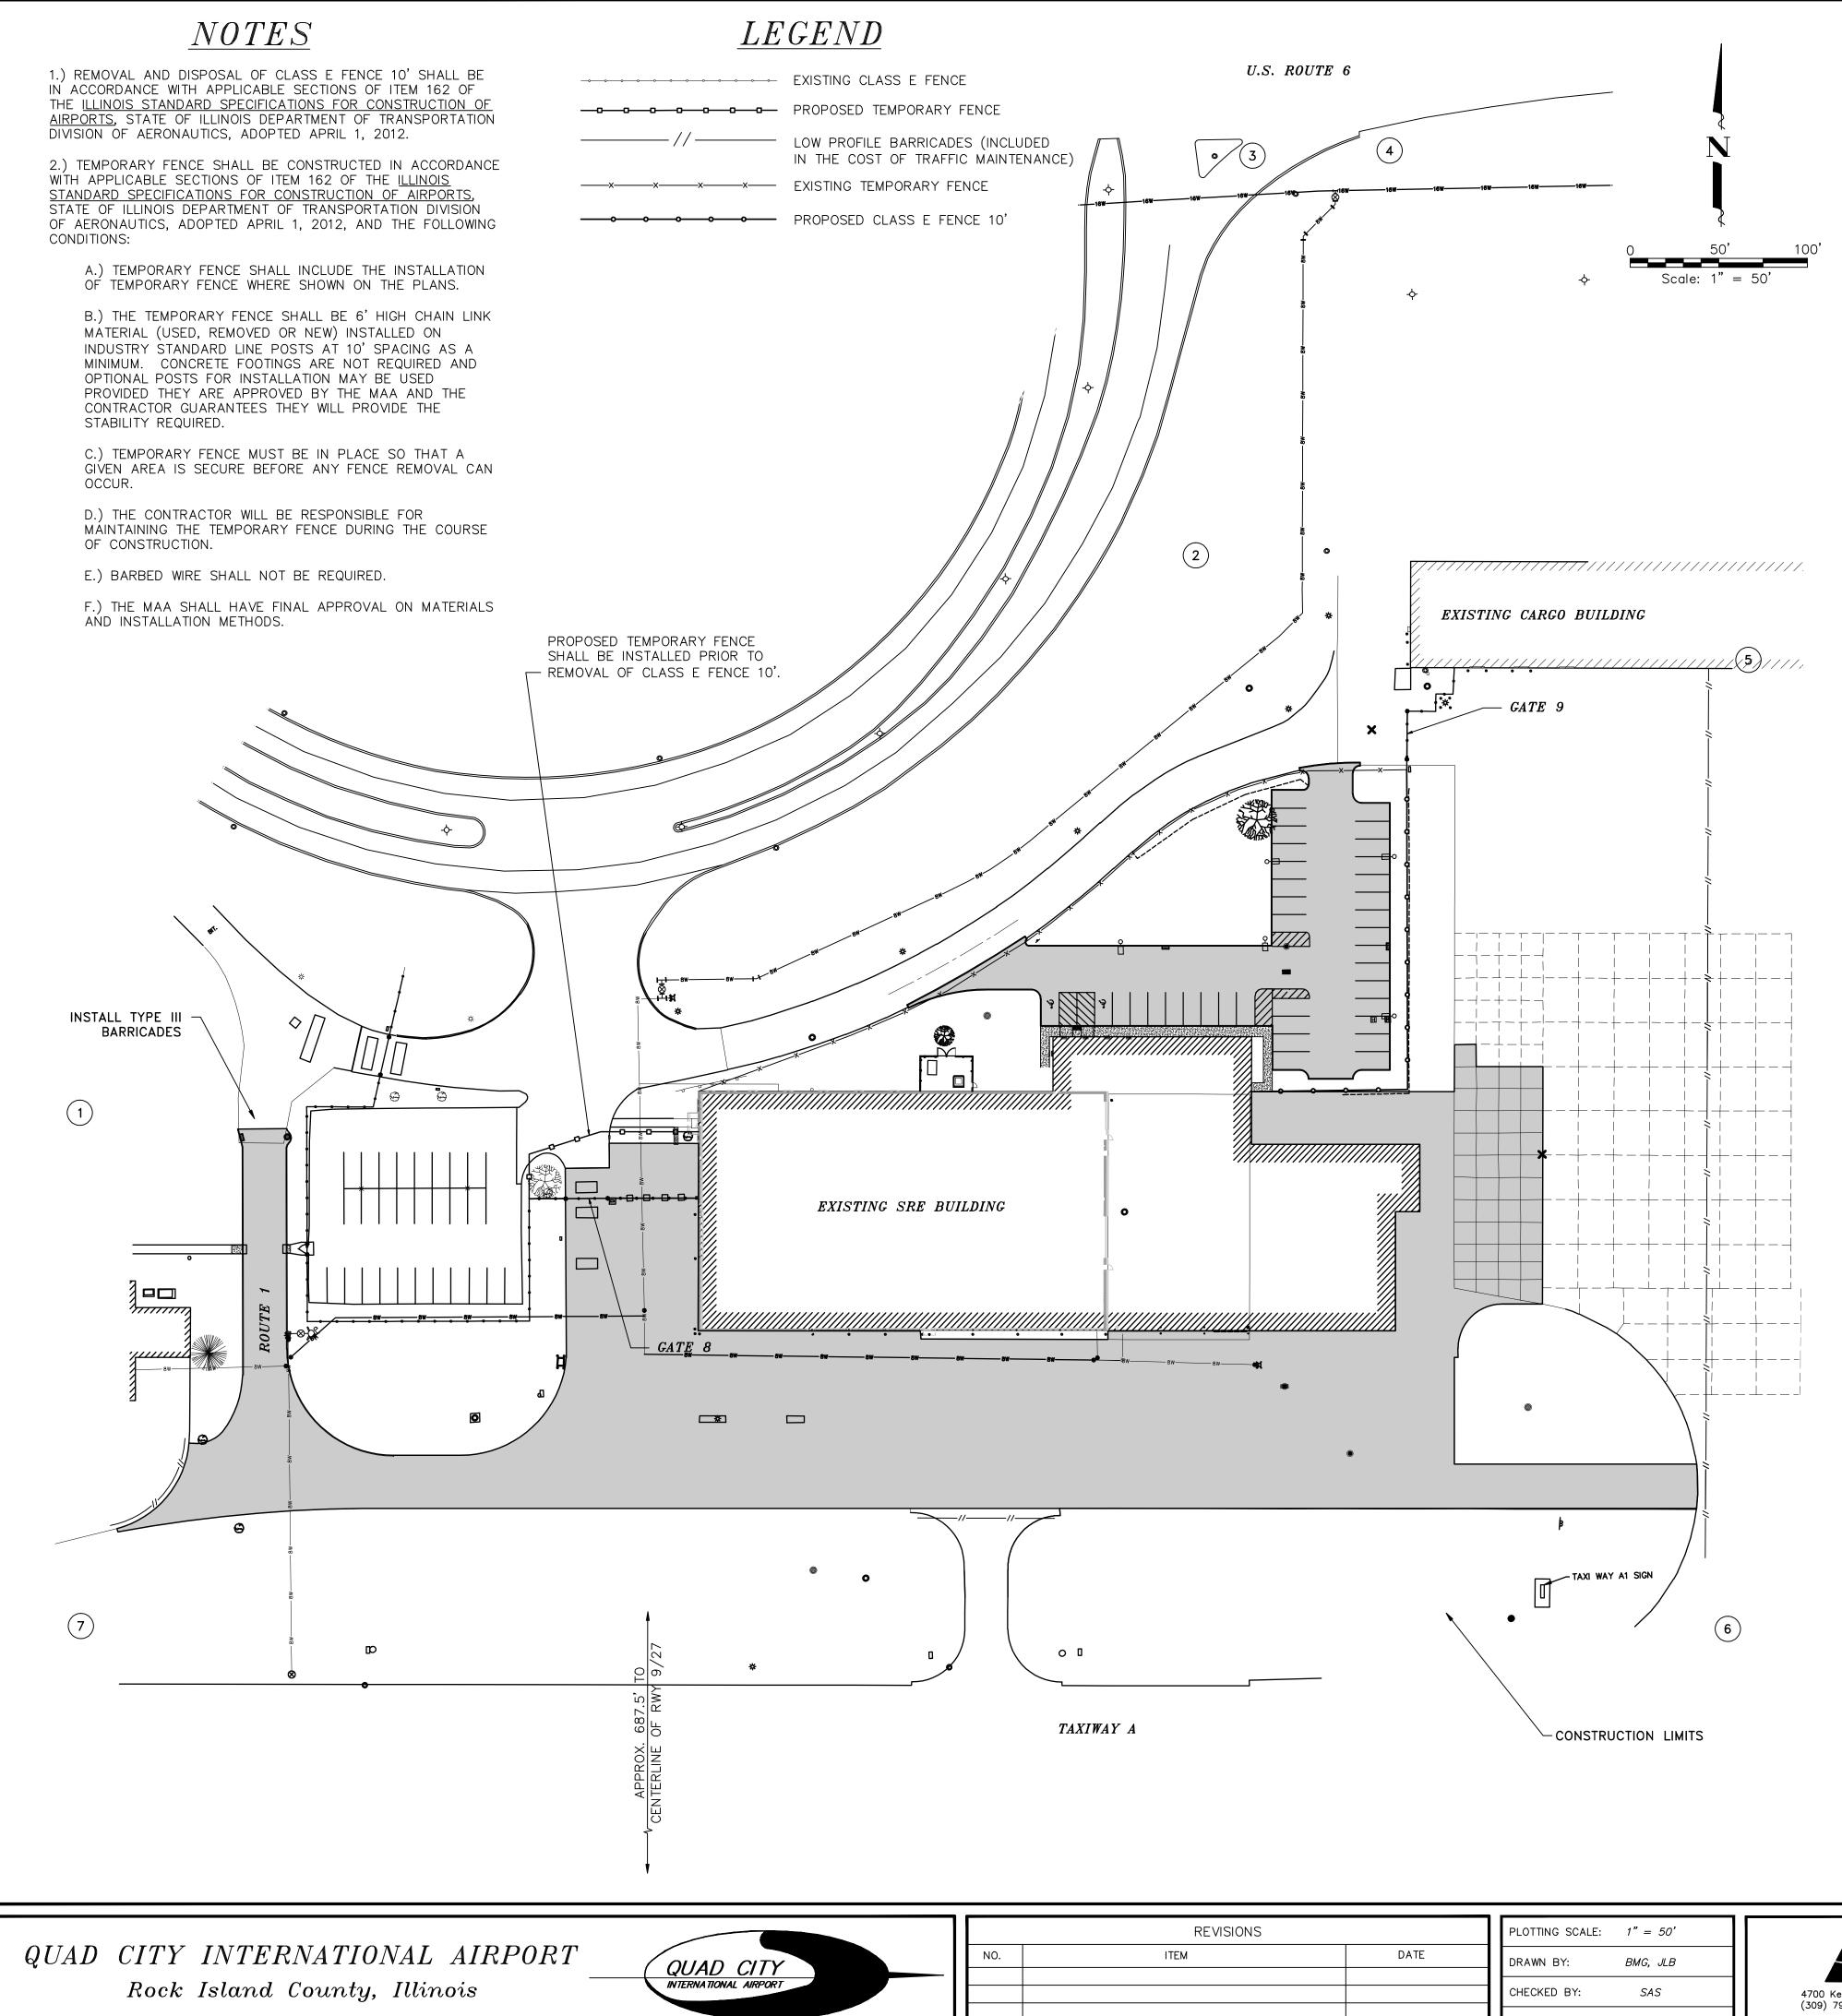

1.) IT SHALL BE THE CONTRACTOR'S RESPONSIBILITY TO COORDINATE ALL CONSTRUCTION ACTIVITIES AND SCHEDULES WITH THE METROPOLITAN AIRPORT AUTHORITY (MAA) AND THE ENGINEER. A.) FAA AIR TRAFFIC ORGANIZATION (ATO)- NO COORDINATION ANTICIPATED. IF REQUIRED ALL COORDINATION SHALL BE DONE THROUGH THE MAA.

- OTHER SECURITY RELATED ACTIVITIES.
- 3.) PROTECTION OF NAVIGATION AIDS (NAVAIDS) A.) NO IMPACT TO NAVAIDS IS ANTICIPATED.
- CONNECTION WITH THE PROJECT. A.) THE CONTRACTOR SHALL PROCURE ENOUGH SECURITY/IDENTIFICATION BADGES.
- THE START OF CONSTRUCTION.
- MAINTENANCE OF SIGNS/BARRICADES, ETC.
- PREVENT DAMAGE, INJURY, OR LOSS TO: MAY BE AFFECTED.
- DURING CONSTRUCTION.
- ENGINEER/MAA.
- PLANS AS THE STAGING AREA.
- DUE TO THE CONTRACTOR'S NEGLIGENCE.
- TAXIWAYS.
- BY THE ENGINEER.

STRUCT. NO.	LATITUDE	LONGITUDE	ELEVATION OF SITE	STRUCTURE HEIGHT	OVERALL HEIGHT
1	41°27'04.80"	90°29'50.48"	573.2	20'	593.2
2	41°27'07.78"	90°29'42.05"	579.1	20'	599.1
3	41°27'10.01"	90°29'41.98"	582.5	20'	602.5
4	41°27'09.99"	90°29'40.88"	580.2	20'	600.2
5	41°27'07.20"	90°29'38.44"	575.1	20'	595.1
6	41°27'01.93"	90°29'38.59"	573.8	20'	593.8
7	41°27'02.11"	90°29'50.55"	575.1	20'	595.1

REVISIONS			PLOTTING SCALE: $1'' = 50'$	MoClure
).	ITEM	DATE	DRAWN BY: BMG, JLB	
			CHECKED BY: SAS	4700 Kennedy Drive East Moline, Illin
			DATE: MAY 10, 2013	(309) 792–9350

SAFETY PLAN NOTES:

2.) THE MAA SHALL RETAIN THE RIGHT TO RESTRICT ACCESS TO THE CONSTRUCTION AREA DURING EMERGENCY SITUATIONS, OR PERIODS OF INCLEMENT WEATHER REQUIRING SPECIAL AIRCRAFT HANDLING CONDITIONS. OR DURING VISITS BY HIGH RANKING DIGNITARIES OR

4.) THE CONTRACTOR SHALL BE RESPONSIBLE FOR MAINTAINING AND SUPERVISING ALL SAFETY PRECAUTIONS AND PROGRAMS IN

> SECURITY/IDENTIFICATION BADGES FOR HIS EMPLOYEES AND SUBCONTRACTOR'S EMPLOYEES TO GUARANTEE AT LEAST ONE MEMBER OF EACH CONSTRUCTION CREW WILL HAVE A BADGE. ANY CONSTRUCTION CREW WITHOUT A BADGED MEMBER SHALL NOT BE ALLOWED ON THE AIRFIELD SITE. BADGES MAY BE OBTAINED, AFTER MEETING SECURITY REQUIREMENTS, FROM THE SECURITY OFFICE AT THE MAA. THE CONTRACTOR WILL BE RESPONSIBLE FOR ALL FEES ASSOCIATED WITH OBTAINING

B.) ALL AIR TRAFFIC AREAS ADJACENT TO CONSTRUCTION MUST BE MAINTAINED FREE OF DEBRIS AT ALL TIMES. SWEEPERS MUST BE PROVIDED BY THE CONTRACTOR FOR THE ENTIRE LENGTH OF THE CONTRACT AND SHALL BE OF A VACUUM AND DUSTLESS TYPE CAPABLE OF REMOVING ALL DEBRIS TO THE SATISFACTION OF THE MAA. SWEEPERS MUST BE COMMERCIAL STREET SWEEPER QUALITY AND APPROVED BY THE ENGINEER AND MAA PRIOR TO

C.) A 24 HOUR LOCAL TELEPHONE NUMBER SHALL BE ESTABLISHED AND MANNED AT ALL TIMES BY THE CONTRACTOR TO PROVIDE INSTANT RESPONSE TO BREACHES OF SAFETY/SECURITY AND

5.) THE CONTRACTOR SHALL TAKE ALL REASONABLE PRECAUTIONS FOR THE SAFETY OF AND SHALL PROVIDE ALL REASONABLE PROTECTION TO A.) ALL EMPLOYEES ON THE PROJECT AND ALL OTHER PERSONS WHO

B.) ALL THE WORK AND ALL MATERIALS AND EQUIPMENT TO BE INCORPORATED UNDER THE CARE, CUSTODY, OR CONTROL OF THE CONTRACTOR OR ANY OF HIS SUBCONTRACTORS.

C.) ALL EXISTING FACILITIES THAT ARE TO REMAIN IN PLACE.

6.) ALL OPERATIONS SHALL BE IN CONFORMANCE WITH FAA ADVISORY CIRCULAR (AC) 150/5370-2F OPERATIONAL SAFETY ON AIRPORTS

7.) ALL CONSTRUCTION VEHICLES, EQUIPMENT AND PERSONNEL SHALL REMAIN CLEAR OF THE AIRFIELD SAFETY AREA LIMITS.

8.) ALL CONSTRUCTION VEHICLES AND EQUIPMENT, SHALL BE PARKED IN THE STAGING AREA DURING NON-WORKING HOURS UNLESS PRIOR ARRANGEMENTS ARE APPROVED. ALL CONSTRUCTION VEHICLES AND EQUIPMENT SHALL PROMINENTLY DISPLAY 3'X3' ORANGE AND WHITE CHECKERED FLAGS. NO PERSONAL VEHICLES SHALL BE ALLOWED ON THE CONSTRUCTION SITE. ALL VEHICULAR TRAFFIC SHALL BE KEPT TO A MINIMUM. WHERE TRAFFIC CANNOT BE AVOIDED, IT SHALL BE KEPT WITHIN THE CONSTRUCTION LIMITS OR TO AND FROM THE STAGING AREA. ALL VEHICLES ON THE AIRFIELD REQUIRE APPROVAL OF THE

9.) THE CONTRACTOR SHALL LOCATE HIS TRAILER, LONG TERM STORAGE MATERIALS, AND OTHER FACILITIES IN THE AREA INDICATED ON THE

10.) CONSTRUCTION GATES SHALL BE LOCKED AT ALL TIMES THE CONTRACTOR IS NOT ON SITE. VIOLATIONS ARE SUBJECT TO FINES/PENALTIES AND THE CONTRACTOR SHALL PAY ANY FINES INCURRED, INCLUDING FINES INCURRED BY THE ENGINEER AND/OR MAA

11.) NO CONSTRUCTION ACTIVITIES SHALL TAKE PLACE WITHIN 250' OF THE CENTER LINE OF RUNWAYS AND WITHIN 130' OF THE CENTER LINE OF

12.) THE CONTRACTOR SHALL USE THE DESIGNATED HAUL ROUTES, CONSTRUCTION STAGING AREA, AND AIRPORT GATE NO. 9 TO ACCESS THE CONSTRUCTION SITE AS SHOWN ON THE SAFETY PLAN. NO CONSTRUCTION TRAFFIC SHALL BE ALLOWED ON THE AIRFIELD OUTSIDE THE HAUL ROUTES AND WORK AREAS UNLESS OTHERWISE AUTHORIZED

- 13.) WILDLIFE MANAGEMENT
- A.) TRASH THE CONTRACTOR SHALL BE RESPONSIBLE FOR CLEANING UP TRASH AND CONSTRUCTION MATERIALS AT THE END OF THE WORKDAY THAT ARE LEFT ON THE JOBSITE TO KEEP FROM ATTRACTING ANIMALS ONTO THE AIRPORT PROPERTY.
- B.) STANDING WATER THE CONTRACTOR SHALL MAINTAIN POSITIVE DRAINAGE AS ABLE IN THE WORK AREA TO KEEP RAINWATER AND OTHER SOURCES OF WATER FROM PONDING ON THE AIRPORT PROPERTY.
- C.) TALL GRASS AND WEEDS THE CONTRACTOR SHALL KEEP GRASS AND WEEDS MOWED AROUND THE CONSTRUCTION SITE AS NECESSARY.
- D.) POORLY MAINTAINED FENCING AND GATES THE CONTRACTOR SHALL MAINTAIN TEMPORARY FENCES AND GATES TO KEEP NON-CONSTRUCTION RELATED PERSONNEL OUT OF THE CONSTRUCTION SITE.
- 14.) IT WILL BE THE CONTRACTOR'S RESPONSIBILITY TO RESTORE THE CONSTRUCTION STAGING AREA TO ITS ORIGINAL CONDITION FOLLOWING COMPLETION OF CONSTRUCTION. THIS MAY INCLUDE, BUT NOT BE LIMITED TO, REGRADING, FERTILIZING, SEEDING, AND MULCHING OF EARTH SURFACES TO THE SATISFACTION OF THE ENGINEER. ALL GROUND SURFACES, PAVEMENTS, AND FACILITIES DAMAGED BY THE CONTRACTOR WHILE COMPLETING THE PROPOSED WORK SHALL BE REPAIRED OR RETURNED TO ITS ORIGINAL STATE. COST TO BE INCIDENTAL TO CONTRACT.
- 15.) FOREIGN OBJECT DEBRIS (FOD) MANAGEMENT. A.) THE CONTRACTOR SHALL KEEP THE CONSTRUCTION SITE CLEAN OF ALL DEBRIS AND SHALL PERFORM ALL CONSTRUCTION OPERATIONS IN A MANNER THAT WILL NOT INTRODUCE ANY FOREIGN OBJECTS ONTO ADJACENT RUNWAYS. TAXIWAYS OR APRONS.
- 16.) DUST ABATEMENT MEASURES WILL BE REQUIRED, WHEN, IN THE OPINION OF THE ENGINEER, A HAZARD TO AIR TRAFFIC, LOCAL RESIDENTS, OR CONSTRUCTION PROJECT PERSONNEL EXISTS. PREVENTATIVE MEASURES CAN INCLUDE, BUT ARE NOT LIMITED TO, WATERING AND TREATMENT WITH CALCIUM CHLORIDE.
- 17.) UNLESS OTHERWISE DIRECTED, ALL MATERIALS NOT TO BE INCORPORATED IN EACH CONTRACT SHALL BE DISPOSED OF OFF-SITE AT THE CONTRACTOR'S EXPENSE. NOTHING MOUNDED HIGHER THAN 3" ABOVE EXISTING SURFACE WILL BE PERMITTED ON THE AIRFIELD AT ANY TIME.

18.) SEQUENCE OF CONSTRUCTION

- A.) ALL STAGES OF CONSTRUCTION MUST BE COORDINATED WITH THE MAA AND THE ENGINEER.
- B.) MAA RESERVES THE RIGHT TO CHANGE OR ADJUST ANY SEQUENCE OF CONSTRUCTION.
- 19.) INSPECTION REQUIREMENTS
- A.) DAILY (OR MORE FREQUENT) INSPECTIONS THE ENGINEER AND CONSTRUCTION CONTRACTOR SHALL DAILY OR MORE FREQUENTLY AS DICTATED BY CONSTRUCTION ACTIVITIES, PERFORM INSPECTIONS TO ENSURE AIRFIELD SAFETY COMPLIANCE. IF DEFICIENCIES ARE NOTED, CORRECTIVE ACTION SHALL BE TAKEN IMMEDIATELY TO REMEDY SAID DEFICIENCY.
- B.) FINAL INSPECTIONS THE ENGINEER AND THE MAA SHALL PERFORM A FINAL WALK THROUGH INSPECTION PRIOR TO AN AREA BEING REOPENED TO AIRCRAFT OPERATIONS.

20.) PENALTIES

- A.) ANY VIOLATIONS TO THE PROVISIONS OF THE SAFETY PLAN ARE SUBJECT TO PENALTY. EXAMPLES OF VIOLATIONS MAY INCLUDE BUT ARE NOT LIMITED TO: VEHICLE TRANSGRESSION INTO THE RUNWAY SAFETY AREA (RSA) WITHOUT AUTHORIZATION; FAILURE TO MAINTAIN SAFETY CONTROLS (BARRIERS, BARRICADES) IN PROPER WORKING ORDER AND ALIGNMENT; FAILURE TO CONDUCT DAILY SAFETY INSPECTION AT THE END OF THE DAY TO ENSURE ALL SAFETY CONTROLS ARE IN PLACE.
- B.) THE PROGRESSION OF PENALTIES SHOULD THEY BE INCURRED SHALL BE
 - VERBAL WARNING.
 - WRITTEN WARNING
 - iii. BARRING AN EMPLOYEE FROM CONSTRUCTION SITE UNTIL REMEDIAL ACTIONS ARE ACCOMPLISHED TO THE SATISFACTION OF THE SPONSOR.
 - iv. BARRING OF THE CONTRACTOR FROM CONSTRUCTION SITE UNTIL REMEDIAL ACTIONS ARE ACCOMPLISHED TO THE SATISFACTION OF THE MAA.

21.) OTHER LIMITATIONS ON CONSTRUCTION

- A.) THE CONTRACTOR SHALL NOT USE OPEN FLAME WELDING OR TORCHES UNLESS ADEQUATE FIRE SAFETY PRECAUTIONS ARE
- PROVIDED AND THE MAA HAS APPROVED THEIR USE.
- B.) NO FLARE POTS SHALL BE USED WITHIN THE AIRCRAFT OPERATIONS AREA (AOA) AT ANY TIME.
- C.) NO ELECTRICAL BLASTING CAPS SHALL BE USED ON OR WITHIN 1,000 FT OF THE AIRPORT PROPERTY.

SRE BUILDING RAMP CONSTRUCTION COORDINATES

inois 61244 792-8974

SAFETY PLAN

ILLINOIS PROJECT MLI-3896

SHEET NO. \bigcirc of 28

AIP PROJECT NO. 3-17-0068-XX

FILE NAME: T: \M0108.128 \DWG \2012 PLANS \08128-MDL.DWG

SRE BUILDING RAMP IMPROVEMENTS

JOB NUMBER: 01-29-08-128

	SUMMARY C	PF QL	JANTIT	IES	
ITEM NO.	ITEM DESCRIPTION	UNIT	TOTAL QUANTITY	bid quantity	FINAL QUANTITY
AR110610	ELECTRICAL HANDHOLE	EACH	1		
AR110906	REMOVE ELECTRICAL HANDHOLE	EACH	1		
AR150530	TRAFFIC MAINTENANCE	L.S.	1		
AR151430	CLEARING TREES, 2.5'-5' BUTT DIA.	EACH	1		
AR152410	UNCLASSIFIED EXCAVATION	C.Y.	595		
AR152440	BORROW EXCAVATION	C.Y.	1,886		
AR156500	TEMPORARY EROSION CONTROL	L.S.	1		
AR156513	SEPARATION FABRIC	S.Y.	12,115		
AR161980	REHANG GATE	EACH	1		
AR162510	CLASS E FENCE 10'	L.F.	270		
AR162908	REMOVE ELECTRIC GATE	EACH	1		
AR163510	TEMPORARY FENCE	L.F.	121		
AR209510	CRUSHED AGGREGATE BASE COURSE	TON	3,955		
AR401900	REMOVE BITUMINOUS PAVEMENT	S.Y.	5,614		
AR501508	8" PCC PAVEMENT	S.Y.	11,757		
AR501530	PCC TEST BATCH	EACH	1		
AR501604	4" PCC SIDEWALK	S.F.	1101		
AR501690	PCC SIDEWALK REMOVAL	S.F.	64		
AR501900	REMOVE PCC PAVEMENT	S.Y.	2,962		
AR620520	PAVEMENT MARKING - WATERBORNE	S.F.	370		
AR701412 AR701415	12" RCP, CLASS III 15" RCP, CLASS III	L.F.	334 30		
AR701413	24" RCP, CLASS III	L.F.	20		
AR705504	4" PERFORATED UNDERDRAIN	L.F.	1,950		
AR751410	INLET	EACH	3		
AR751415	INLET-SPECIAL	EACH	3		
AR751540	MANHOLE 4'	EACH	1		
AR751550	MANHOLE 5'	EACH	2		
AR751900	REMOVE INLET	EACH	2		
AR751943	ADJUST MANHOLE	EACH	1		
AR760508	8" DUCTILE IRON WATER MAIN	L.F.	680		
AR760838	WATER VALVE – 8"	EACH	2		
AR760864	16"x8" TAPPING TEE	EACH	1		
AR760908	REMOVE FIRE HYDRANT & VALVE	EACH	1		
AR760947	ADJUST WATER VALVE	EACH	4		
AR760965	RELOCATE FIRE HYDRANT	EACH	1		
AR760938	ABANDON 8" WATER MAIN	L.F.	90		
AR801579	SITE SIGNS	EACH	2		
AR801580 AR801599	DETECTOR LOOP, TYPE 1 CARD READER/ KEY PAD PEDESTAL	L.F. EACH	130		
AR801581	CLEAN CULVERT	EACH	1		
AR901510	SEEDING	AC.	1.5		
AR908510	MULCHING	AC.	1.5		
AR801568	F11 LIGHT FIXTURE	EACH	5		
AR801569	CONCRETE LIGHT BASE	EACH	5		
AR801570	2 - #10s & 1 - #10 GRND IN 1" CONDUIT	L.F.	425		
AR801571	3 – #10 CONDUCTORS IN EXIST. CONDUIT	L.F.	130		
AR801572	5 – #10s IN CONDUIT FROM TMS TO PANEL	L.F.	25		
AR801573	DISCONNECT OLD LOOP SENSOR	EACH	3		
AR801574	LOOP SENSOR CABLE & HOMERUN	EACH	2		
AR801575	CARD READER DATA CABLE IN 1" PVC	L.F.	25		
AR801576	DATA CABLE FROM HH TO CONTROLLER	L.F.	120		
					1
					

QUAD CITY INTERNATIONAL AIRPORT Rock Island County, Illinois




PLOTTING SCALE: 1:1	REVISIONS		
ATE DRAWN BY: BMG, JLB	DATE	ITEM	NO.
CHECKED BY: SAS			
DATE: MAY 10, 2013			

GENERAL NOTES

- 1.) THE CONTRACTOR SHALL NOTIFY THE METROPOLITAN AIRPORT AUTHORITY (MAA) AND ALL UTILITY COMPANIES AT LEAST 48 HOURS PRIOR TO THE START OF CONSTRUCTION.
- 2.) IT SHALL BE THE RESPONSIBILITY OF THE CONTRACTOR TO PROTECT ALL EXISTING UTILITIES AND PAVED STREETS, INCLUDING ANY NOT SHOWN ON THESE DRAWINGS. THE CONTRACTOR SHALL VERIFY ALL EXISTING UTILITIES PRIOR TO CONSTRUCTION AND NOTIFY THE ENGINEER IF ANY CONFLICTS WITH THE DRAWINGS OCCUR. ANY DAMAGE TO EXISTING UTILITIES CAUSED BY TRENCHING AND GRADING OPERATIONS SHALL BE REPAIRED AT THE CONTRACTOR'S EXPENSE. EXISTING UTILITY LOCATIONS SHOWN ON THE DRAWINGS ARE APPROXIMATE.
- 3.) THE CONTRACTOR MUST SUBMIT A SCHEDULE OF WORK PRIOR TO BEGINNING ANY CONSTRUCTION.
- 4.) ALL DEBRIS RESULTING FROM CONSTRUCTION OPERATIONS SHALL BE PROPERLY DISPOSED OF OFF-SITE.
- 5.) PROVIDE POSITIVE DRAINAGE AT ALL TIMES WITHIN THE CONSTRUCTION AREAS. DO NOT ALLOW WATER TO POND OR TO DRAIN ONTO PRIVATE PROPERTY.
- 6.) EROSION CONTROL FEATURES AS NEEDED SHALL BE INCORPORATED INTO THE CONSTRUCTION AT THE EARLIEST POSSIBLE TIME TO LIMIT EROSION AND STREAM POLLUTION AND SHALL BE MAINTAINED UNTIL ACCEPTANCE OF THE PROJECT BY THE AIRPORT.
- 7.) THE CONTRACTOR SHALL NOTIFY THE ENGINEER IMMEDIATELY IF ANY DISCREPANCIES ARE ENCOUNTERED BETWEEN THE PLANS AND SPECIFICATIONS AND THE EXISTING FIELD CONDITIONS.
- 8.) THE FINAL TOP 4" OF SOIL IN ANY AREA DISTURBED BY THE CONTRACTOR THAT IS NOT PAVED AS PART OF THIS PROJECT SHALL BE CAPABLE OF SUPPORTING VEGETATION.
- 9.) FOR STABILIZATION, ALL TYPE III BARRICADES SHALL REQUIRE A MINIMUM OF FOUR SANDBAGS PER BARRICADE.
- 10.) MAXIMUM PAY WIDTH FOR CRUSHED AGGREGATE BASE COURSE SHALL BE 12 INCHES BEYOND THE BACK OF CURB. IF THE CONTRACTOR REQUIRES ADDITIONAL WIDTH FOR PAVING, THE ADDITIONAL MATERIALS SHALL MEET THE SAME SPECIFICATION BUT WILL BE CONSIDERED INCIDENTAL.
- 11.) AFTER CONSTRUCTION HAS BEEN COMPLETED, THE CONTRACTOR SHALL SEED ALL DISTURBED AREAS PER ITEM 901. ONLY SEED AREAS WITHIN THE LIMITS OF CONSTRUCTION/SEEDING WILL BE ELIGIBLE FOR PAYMENT UNDER THE CONTRACT PAY ITEM. AREAS OUTSIDE THE LIMITS OF CONSTRUCTION/SEEDING SHALL BE SEEDED BY THE CONTRACTOR PER ITEM 901, BUT SHALL NOT BE MEASURED FOR PAYMENT.
- 12.) SEEDING SHALL NOT BE PERMITTED AT ANYTIME WHEN THE GROUND IS FROZEN, WET, OR IN AN UNTILLABLE CONDITION.

ILLINOIS PROJECT MLI-3896 AIP PROJECT NO. 3-17-0068-XX SHEET NO. SUMMARY OF QUANTITIES AND GENERAL NOTES es, Inc. J SRE BUILDING RAMP IMPROVEMENTS llinois 61244) 792-8974 of 28JOB NUMBER: 01-29-08-128 FILE NAME: T: \M0108.128 \DWG \2012 PLANS \08128-MDL.DWG

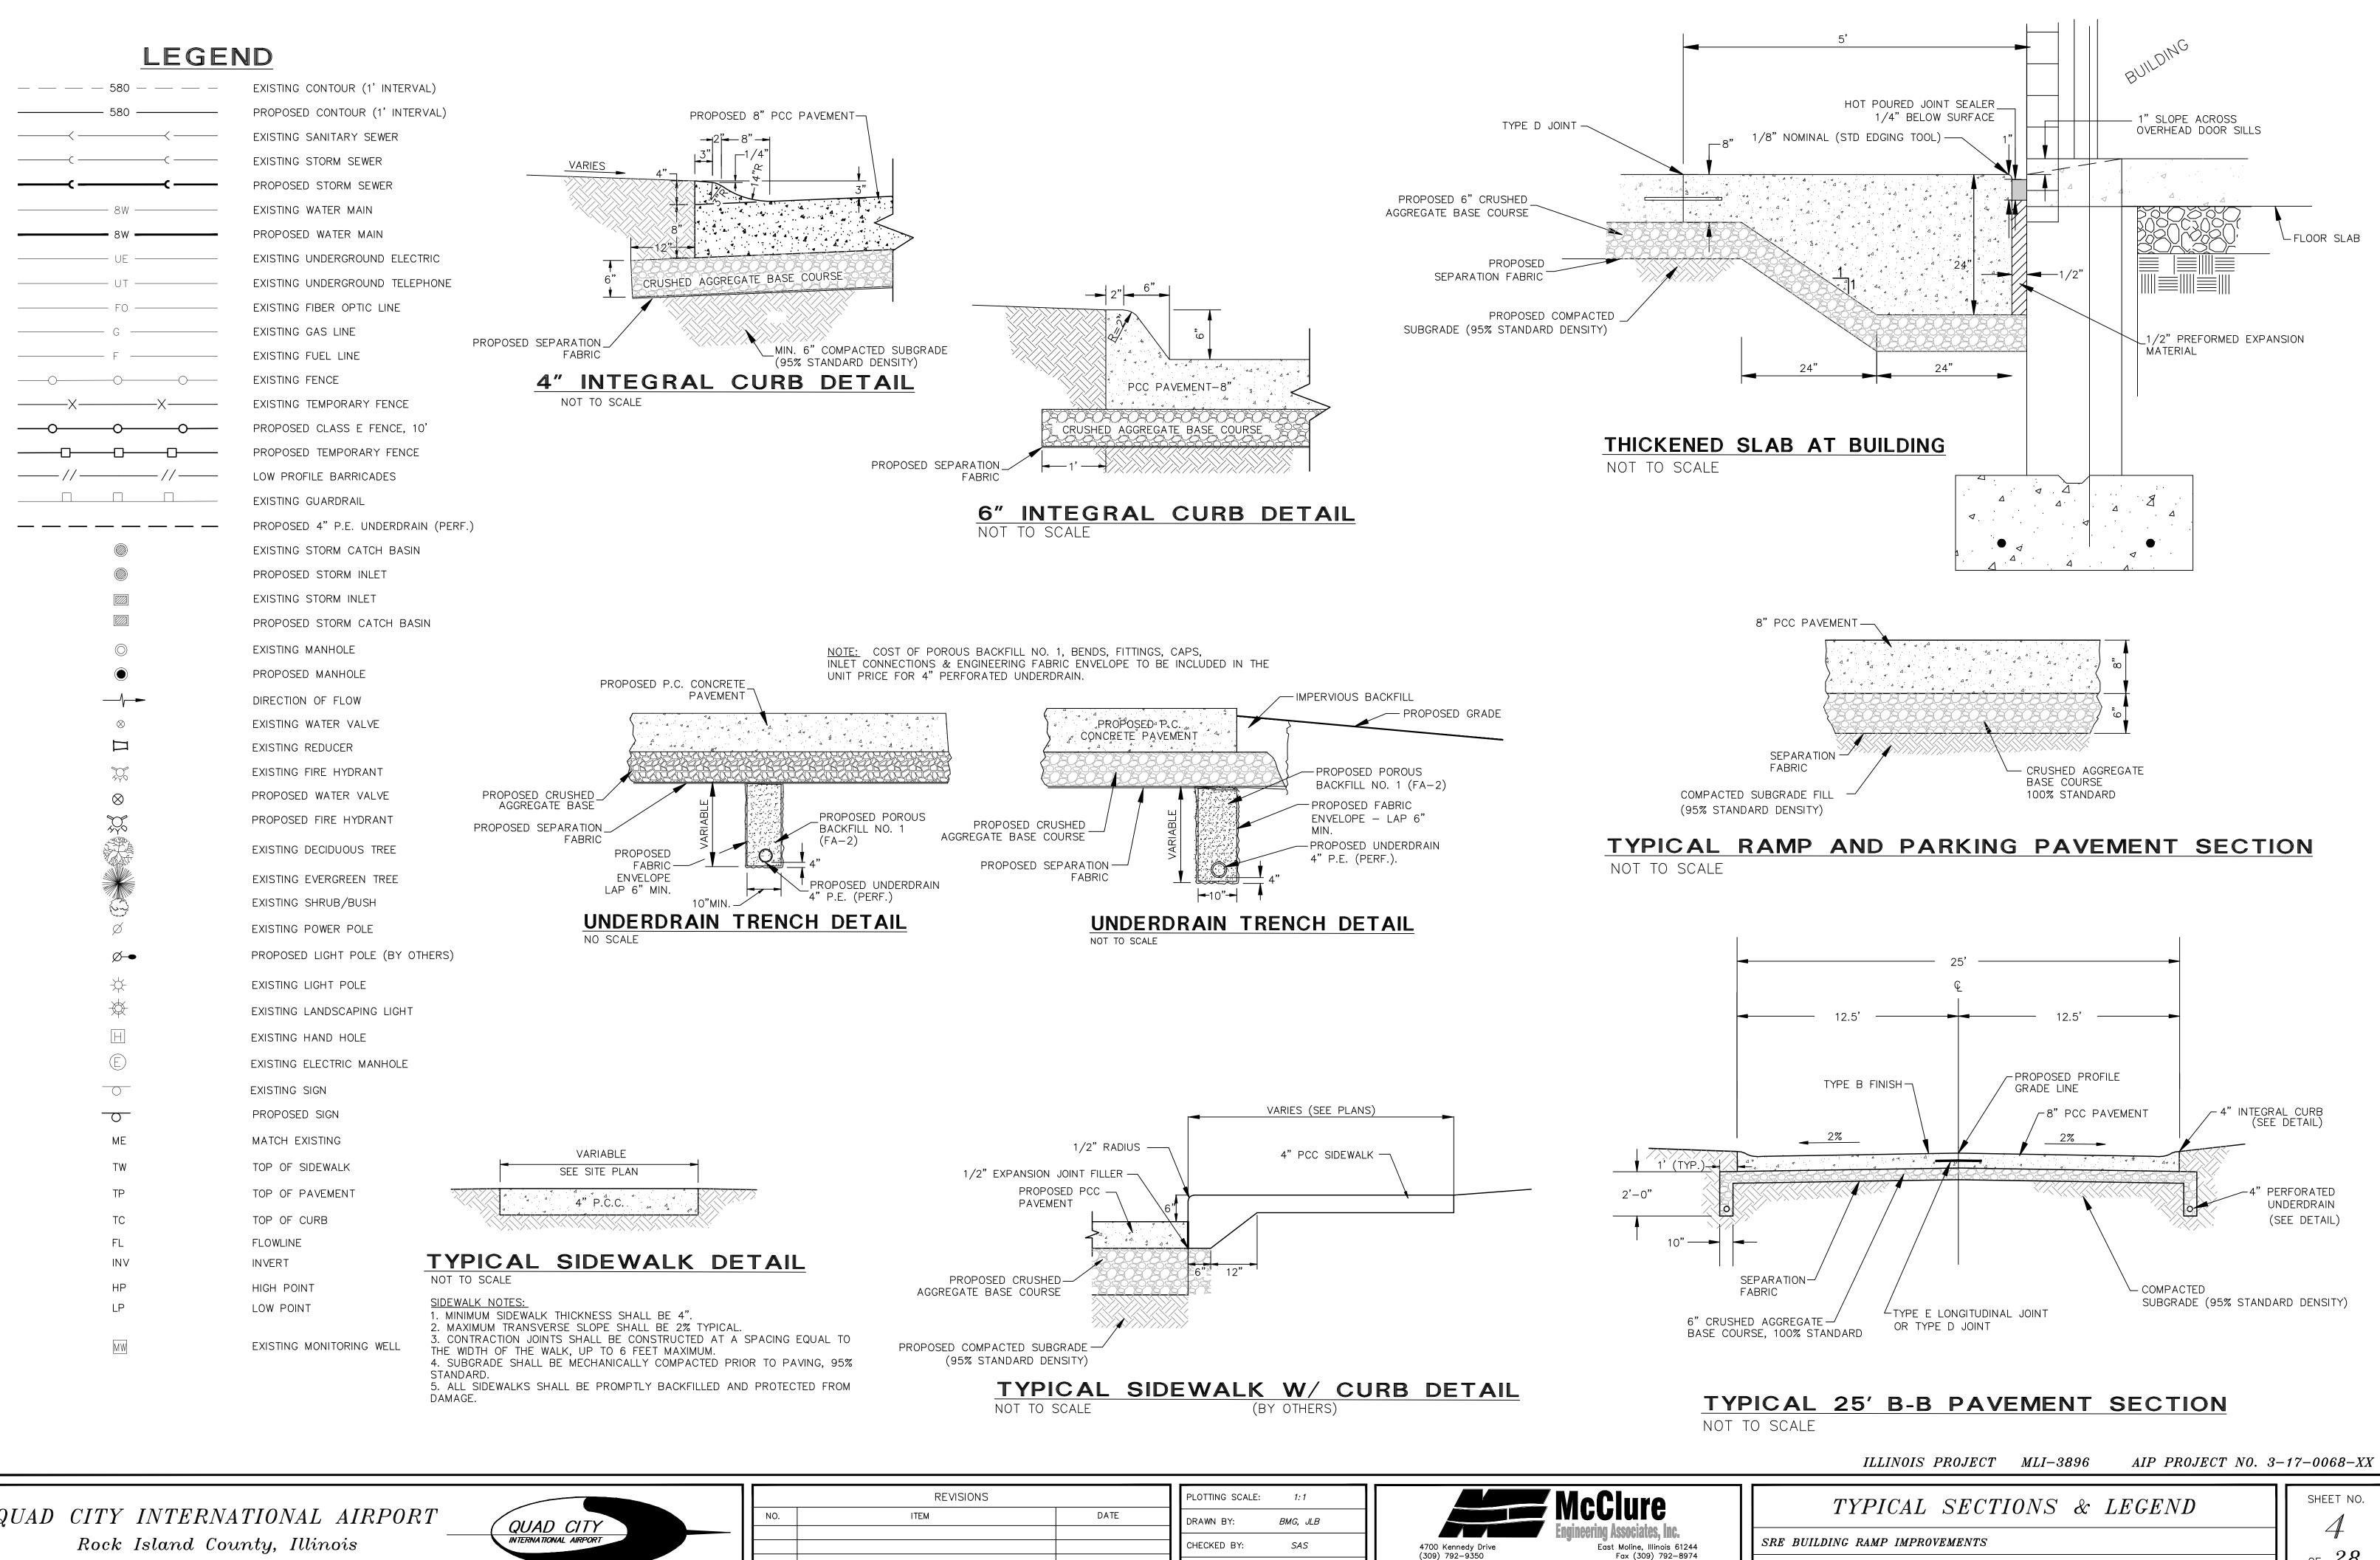

DATE:

MAY 10, 2013


Design Firm License: Illinois 184-000816 Copyright 2013 By McClure Engineering Associates,




JOB NUMBER: 01-29-08-128

FILE NAME: T: \M0108.128 \DWG \2012 PLANS \08128-MDL.DWG

of 28

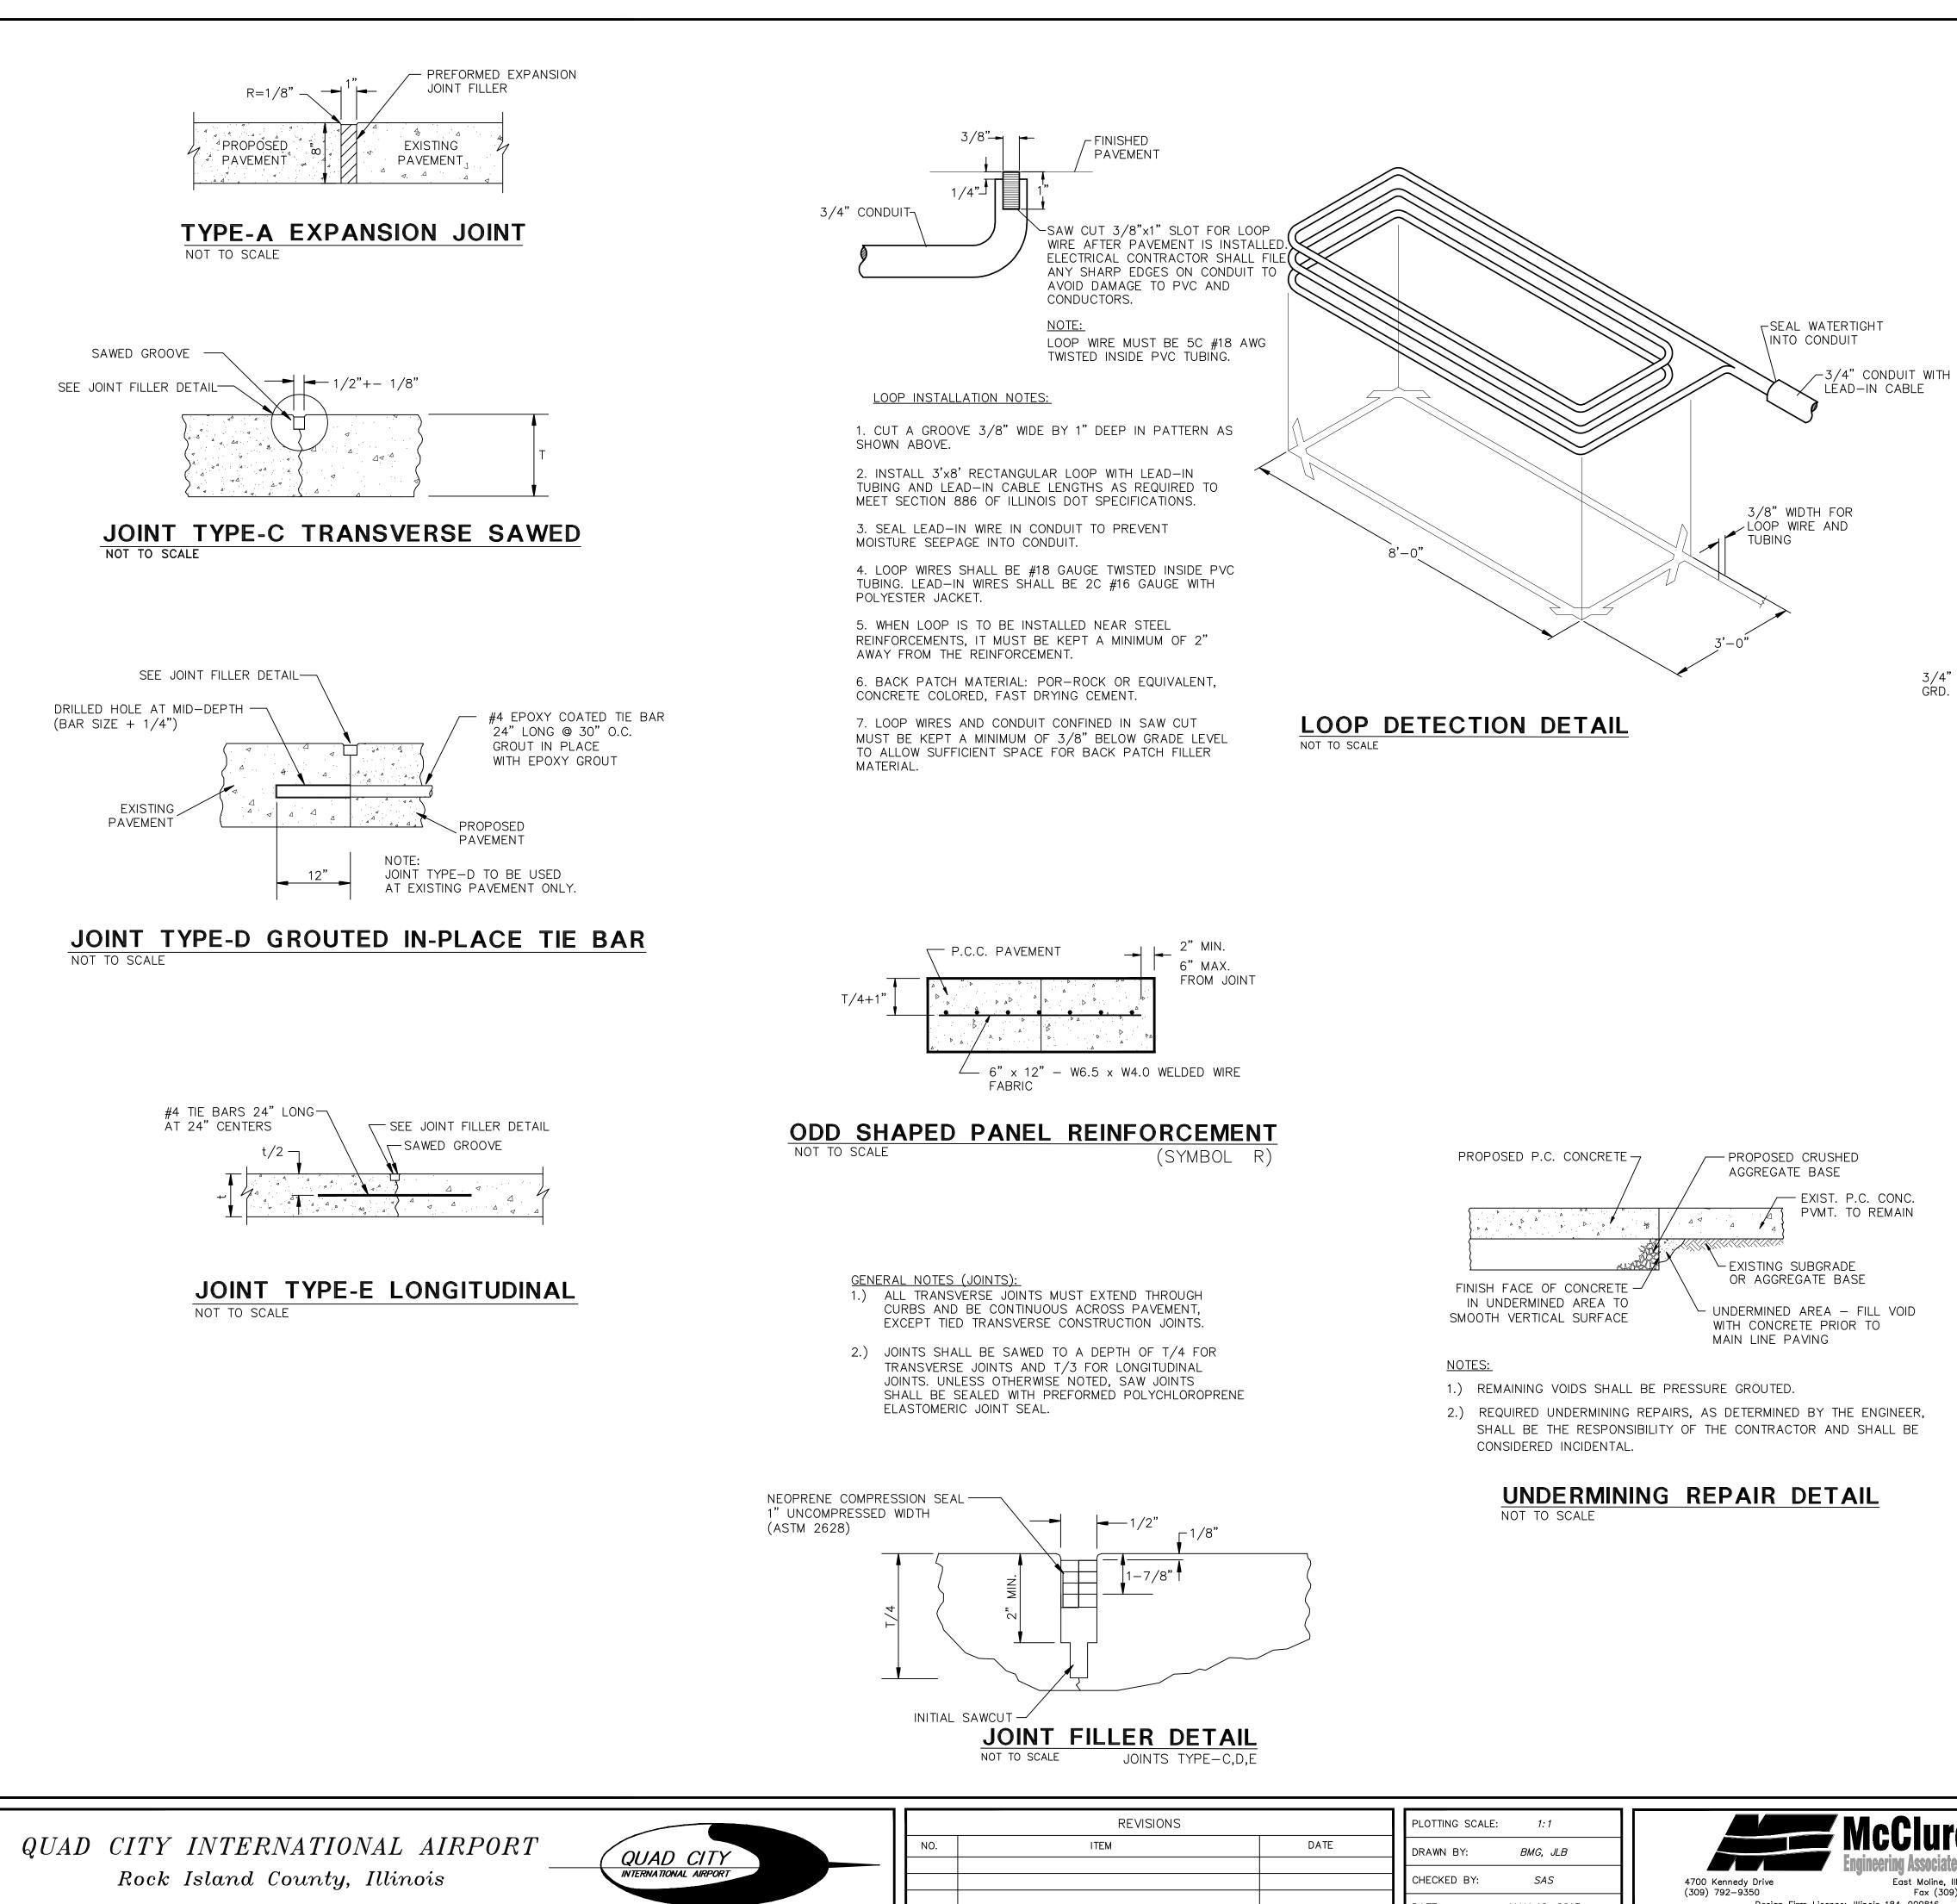


	REVISIONS		PLOTTING SCALE: 1:1	McClure
0.	ITEM	DATE	DRAWN BY: BMG, JLB	Engineering Associates, Inc.
			CHECKED BY: SAS DATE: MAY 10, 2013	4700 Kennedy Drive East Moline, Illinois 61244 (309) 792–9350 Fax (309) 792–8974 Design Firm License: Illinois 184–000816 Copyright 2013 By McClure Engineering Associates, Inc.

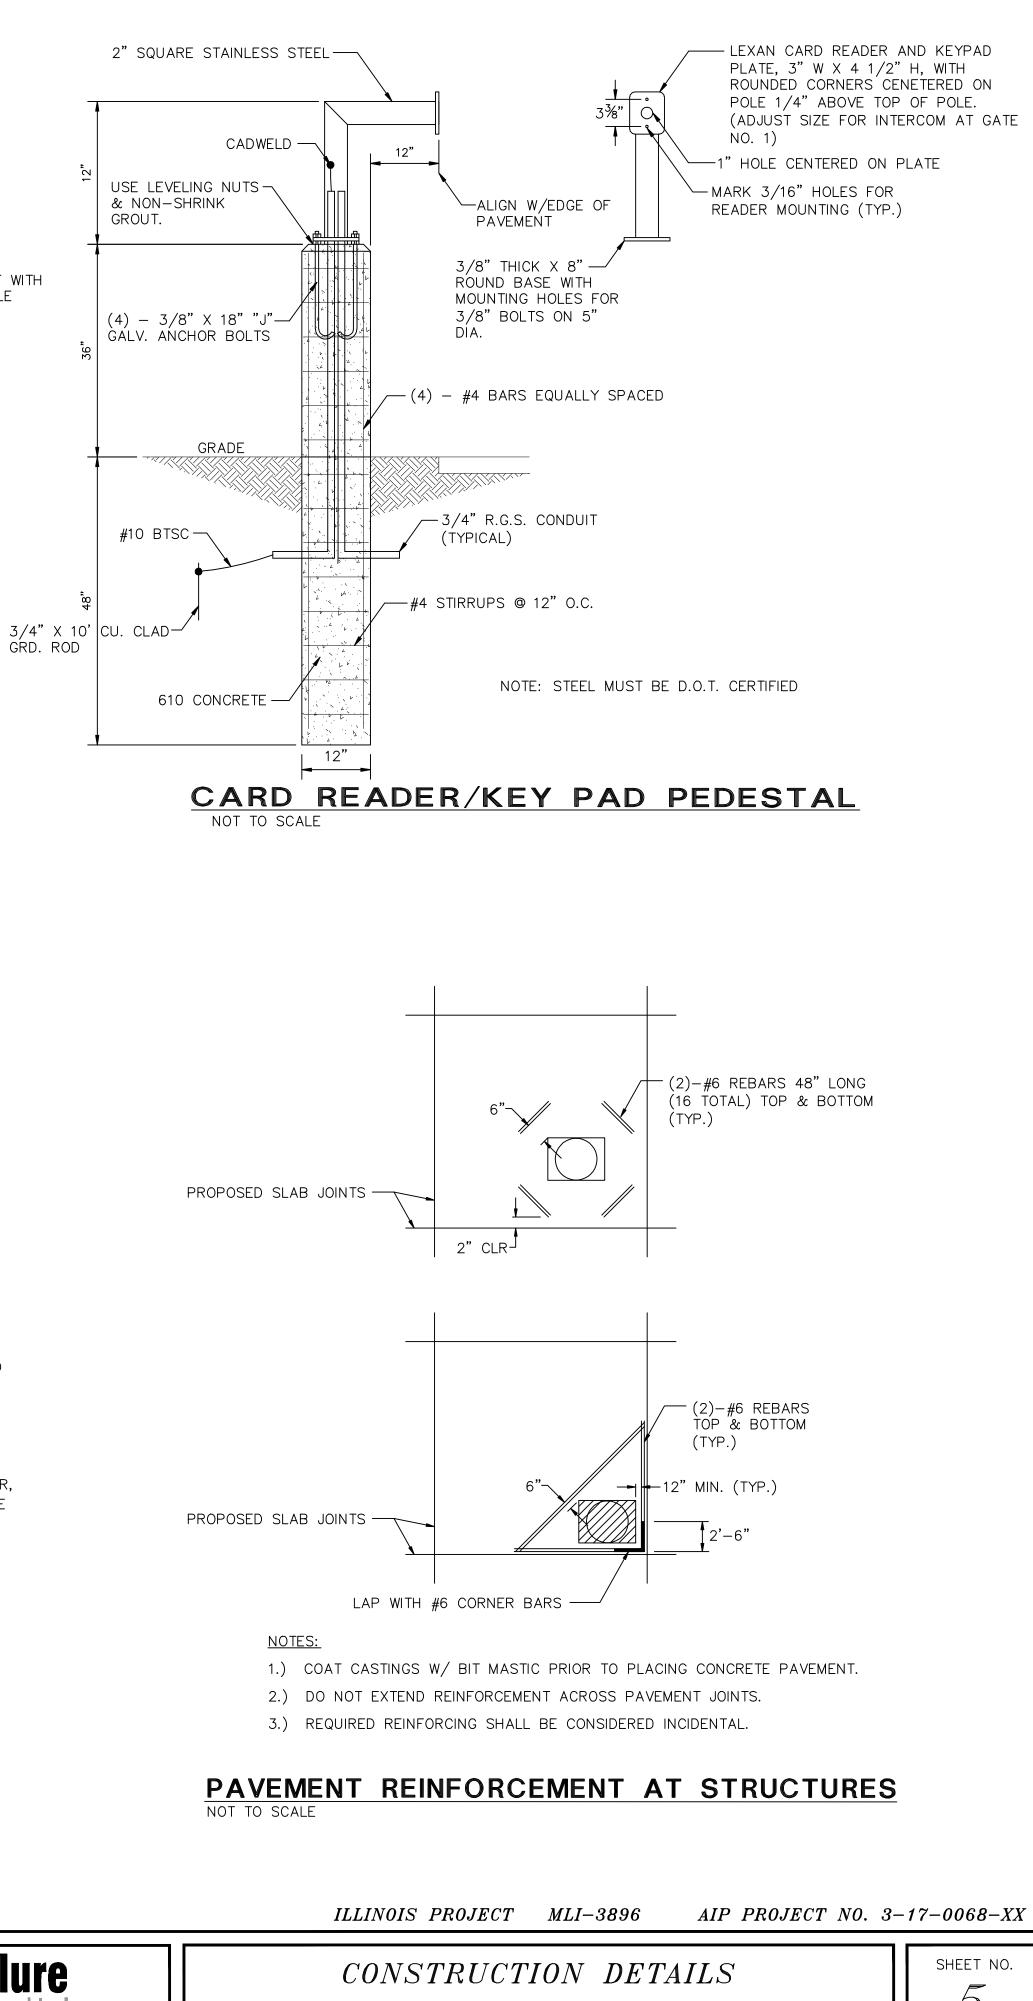


SRE BUILDING RAMP IMPROVEMENTS FILE NAME: T: \M0108.128\DWG\2012 PLANS\08128-MDL.DWG

JOB NUMBER: 01-29-08-128

28 OF

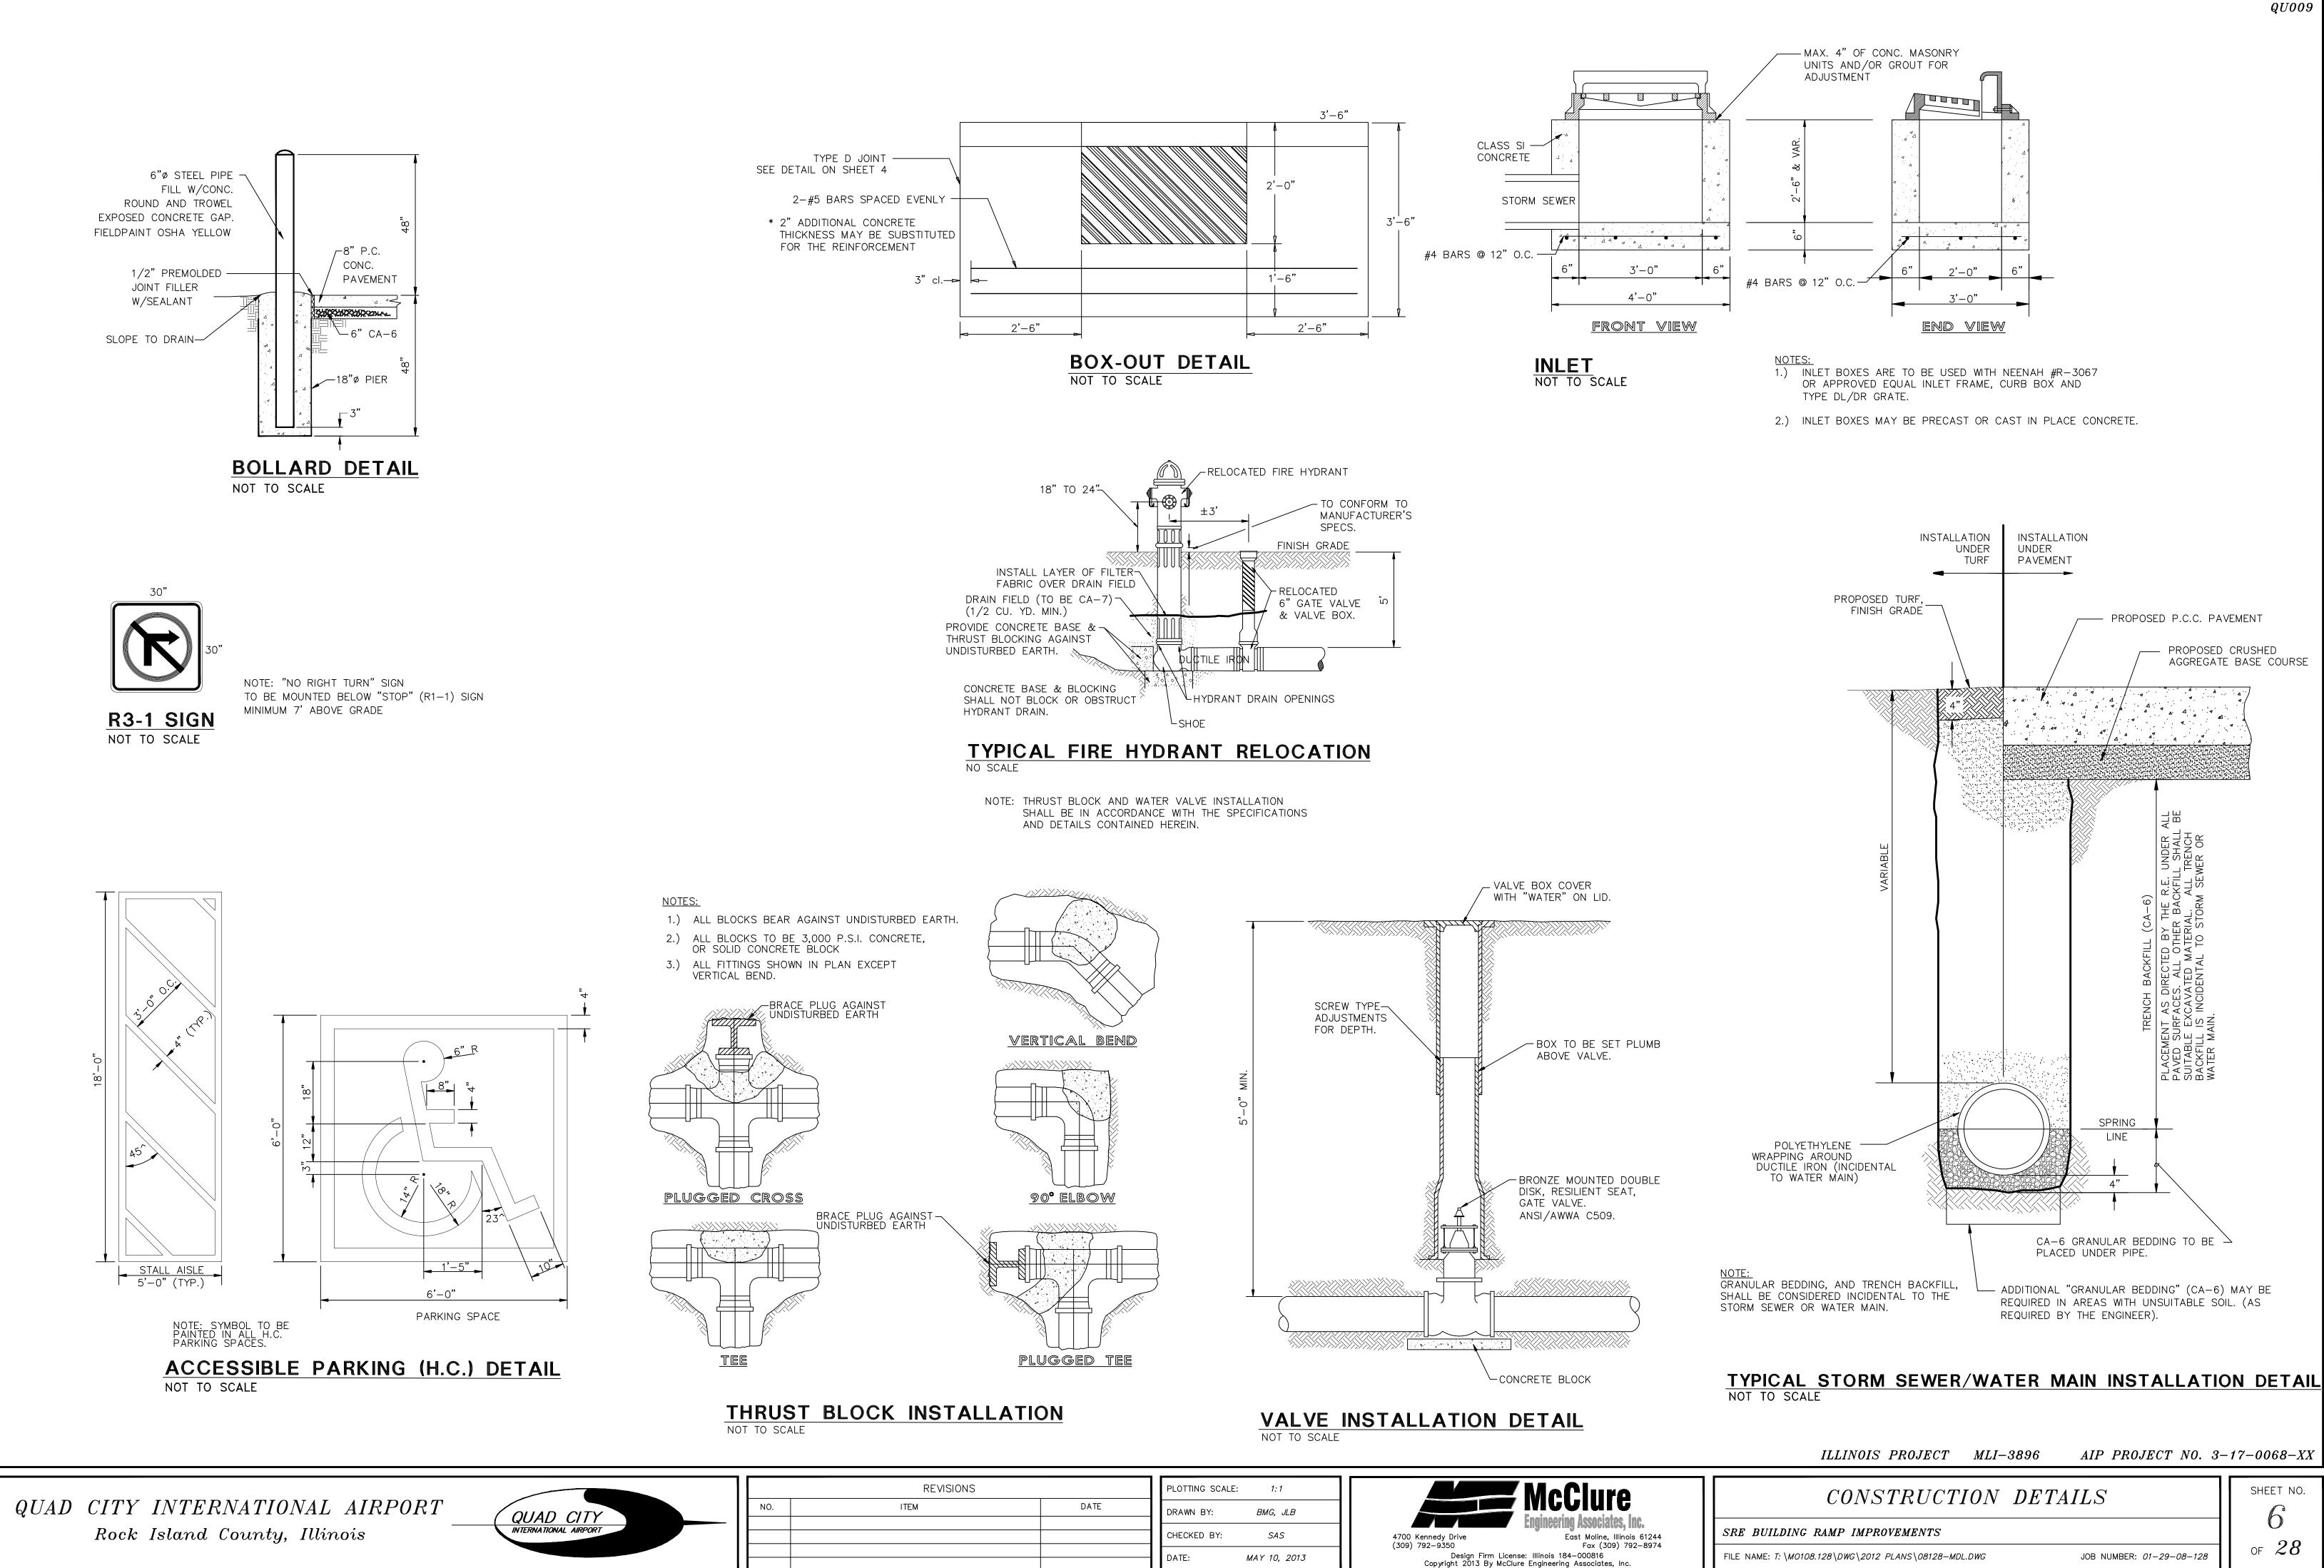

REVISIONS		PLOTTING SCALE: 1:1	
ITEM	DATE	DRAWN BY: BMG, JLB	MCCiure
		CHECKED BY: SAS	4700 Kennedy Drive East Moline, Illir
		DATE: MAY 10, 2013	(309) 792–9350 Design Firm License: Illinois 184–000816

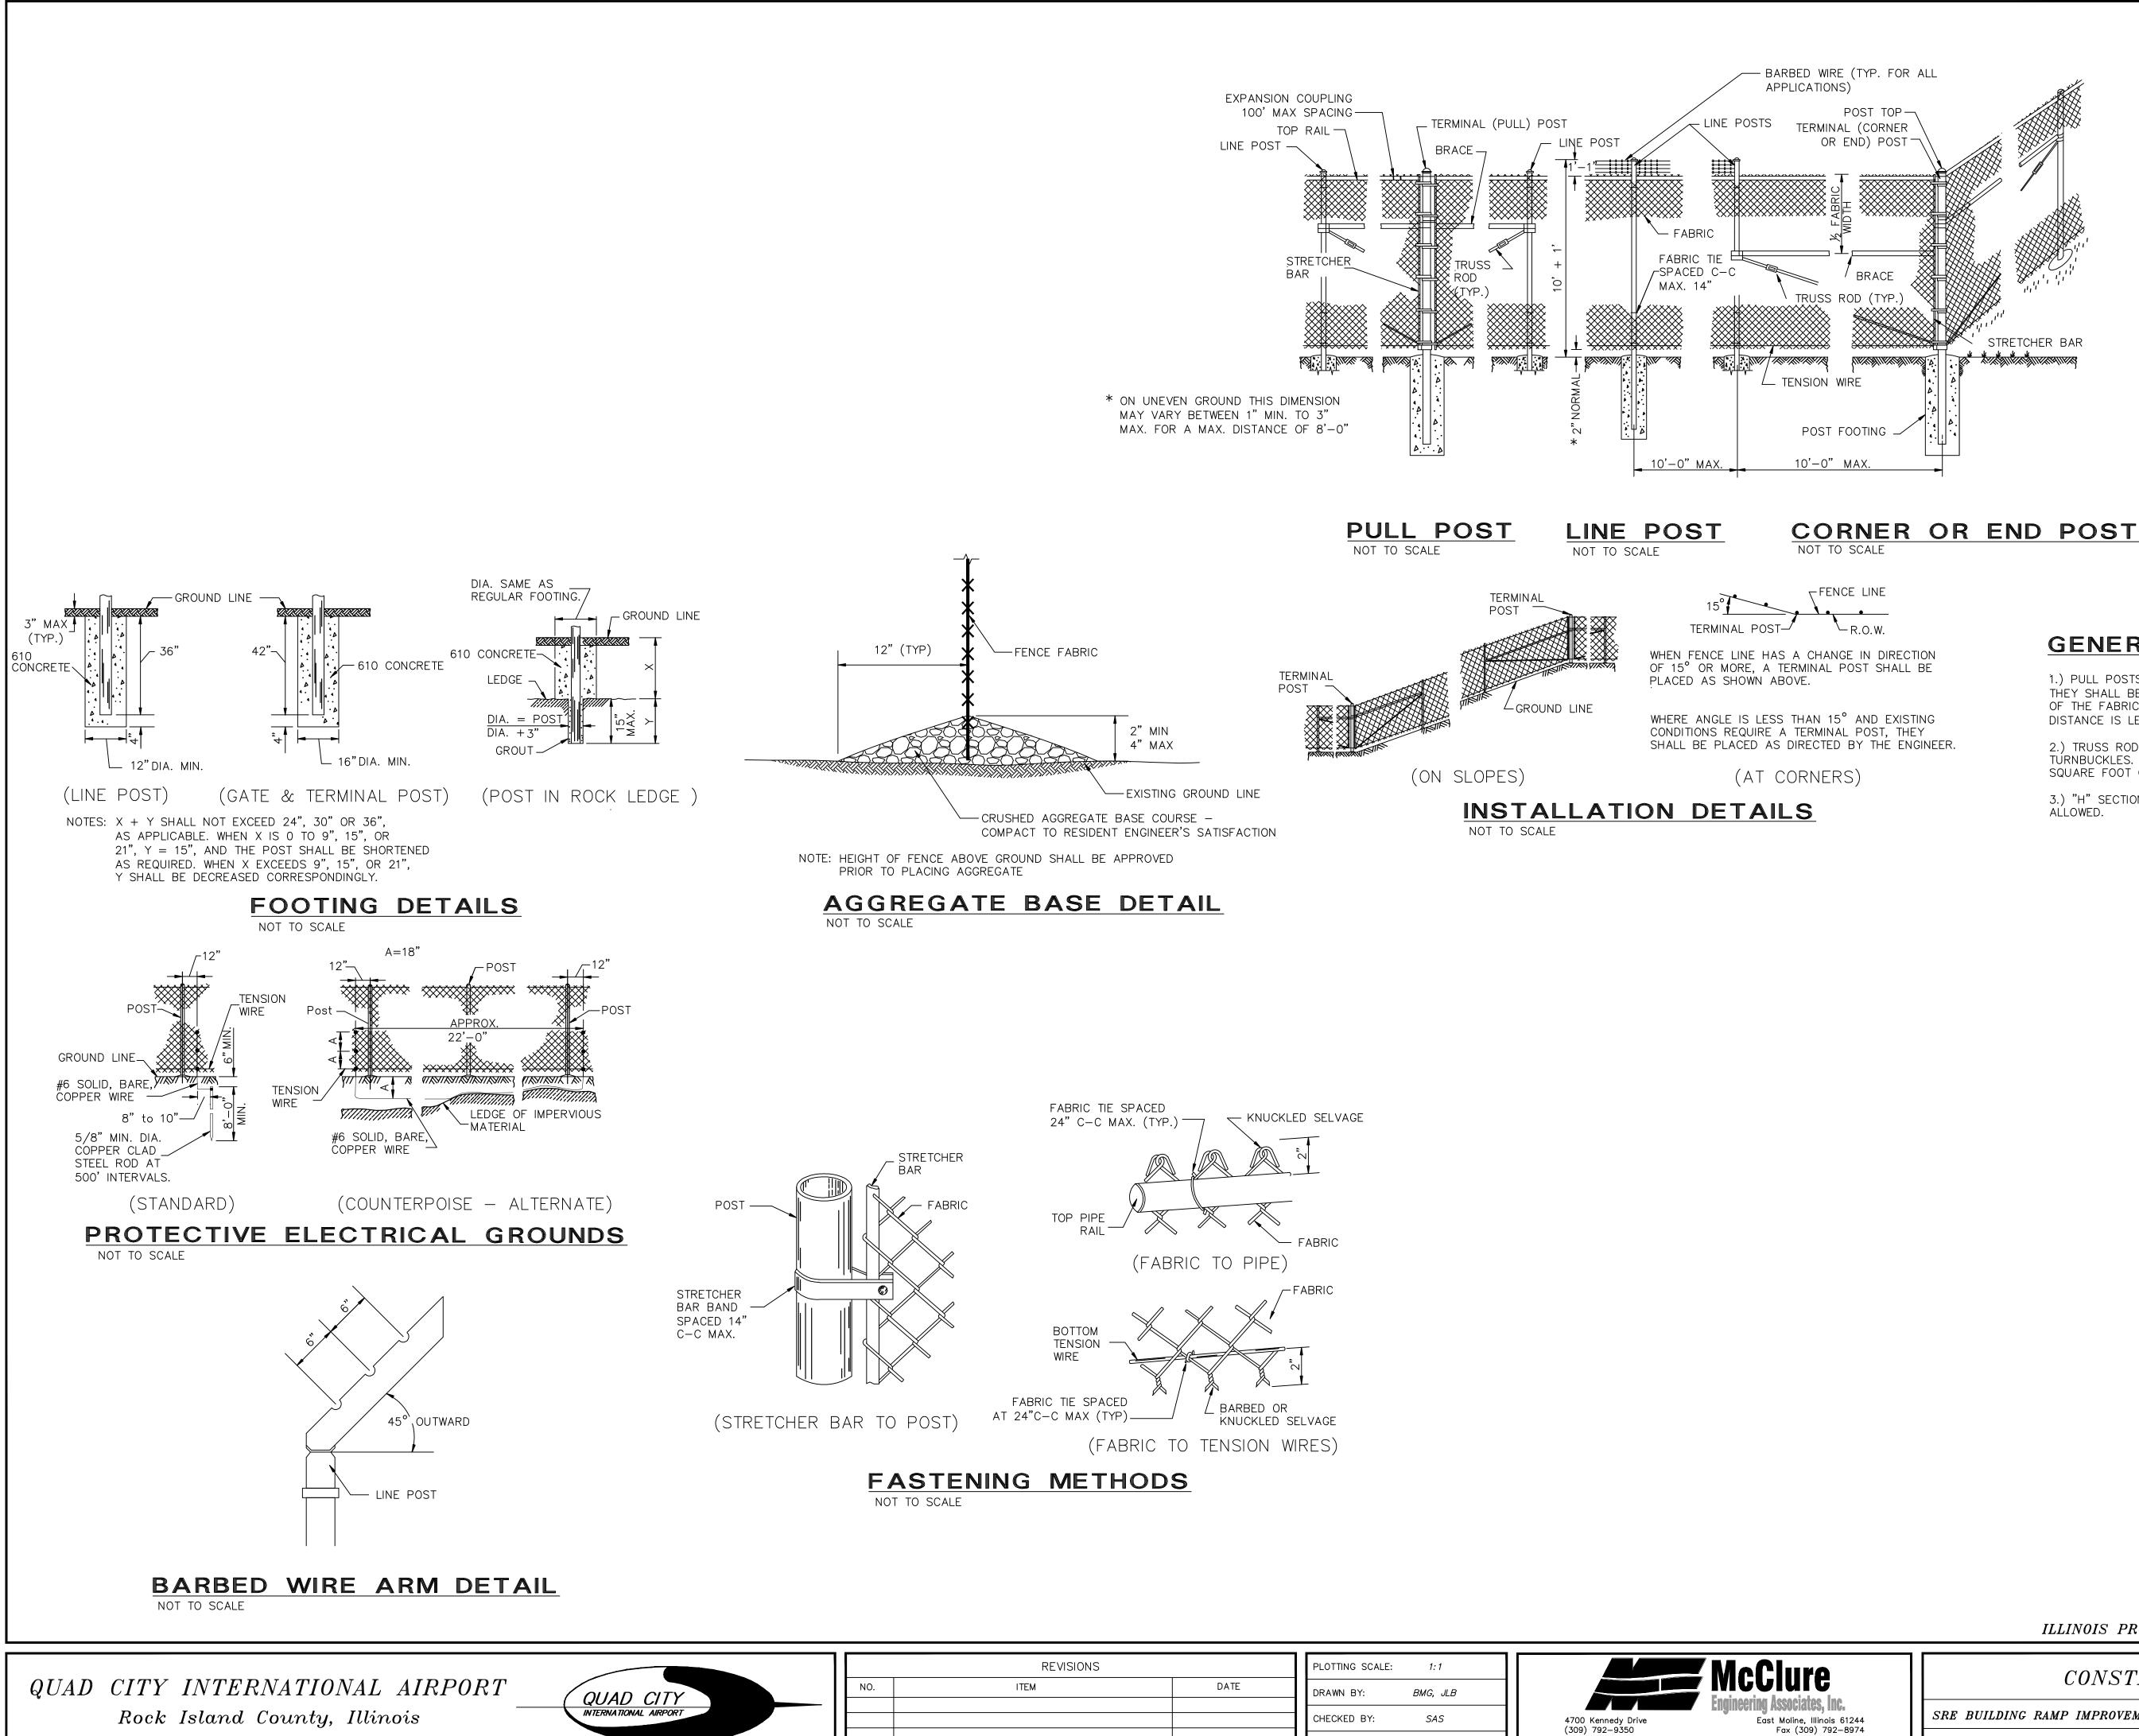

REVISIONS			PLOTTING SCALE: 1:1
NO.	ITEM	DATE	DRAWN BY: BMG, JLB
			CHECKED BY: SAS 4700 Kennedy Drive East Moline, III (309) 792–9350 Fax (309)
			DATE: MAY 10, 2013 Design Firm License: Illinois 184–000816 Copyright 2013 By McClure Engineering Associates,

QU009

POST AND	POST AND BRACE TABLE				
DESCRIPTION	DIAINCHES	WT-LBS/FT			
LINE POST	3.0	4.65			
TERMINAL POST	4.0	6.56			
END POST	4.0	6.56			
CORNER POST	4.0	6.56			
PULL POST	4.0	6.56			
GATE FRAMES	2.0	2.28			
GATE POST	4.0	9.10			
TOP RAIL	1.625	1.84			
HORIZONTAL BRACE	1.625	1.84			

GENERAL NOTES

1.) PULL POSTS SHALL BE PLACED AT LOCATIONS DETERMINED BY THE ENGINEER. THEY SHALL BE PLACED AT 660' INTERVALS BETWEEN POSTS TO WHICH THE ENDS OF THE FABRIC ARE CLAMPED OR MIDWAY BETWEEN SUCH POSTS WHEN THE DISTANCE IS LESS THAN 1320' AND GREATER THAN 660'.

2.) TRUSS RODS SHALL BE 3/8" ROUND GALVANIZED STEEL ROD WITH GALVANIZED TÚRNBUCKLES. THE ZINC COATING SHALL NOT BE LESS THAN 1.2 OUNCES PER SQUARE FOOT OF SURFACE.

3.) "H" SECTION STRUCTURAL SHAPE AND SQUARE TUBULAR PIPE SHALL NOT BE

ILLINOIS PROJECT MLI-3896

AIP PROJECT NO. 3-17-0068-XX

SHEET NO.


 \sim

of 28


CONSTRUCTION DETAILS

SRE BUILDING RAMP IMPROVEMENTS FILE NAME: T: \M0108.128\DWG\2012 PLANS\08128-MDL.DWG


JOB NUMBER: 01-29-08-128

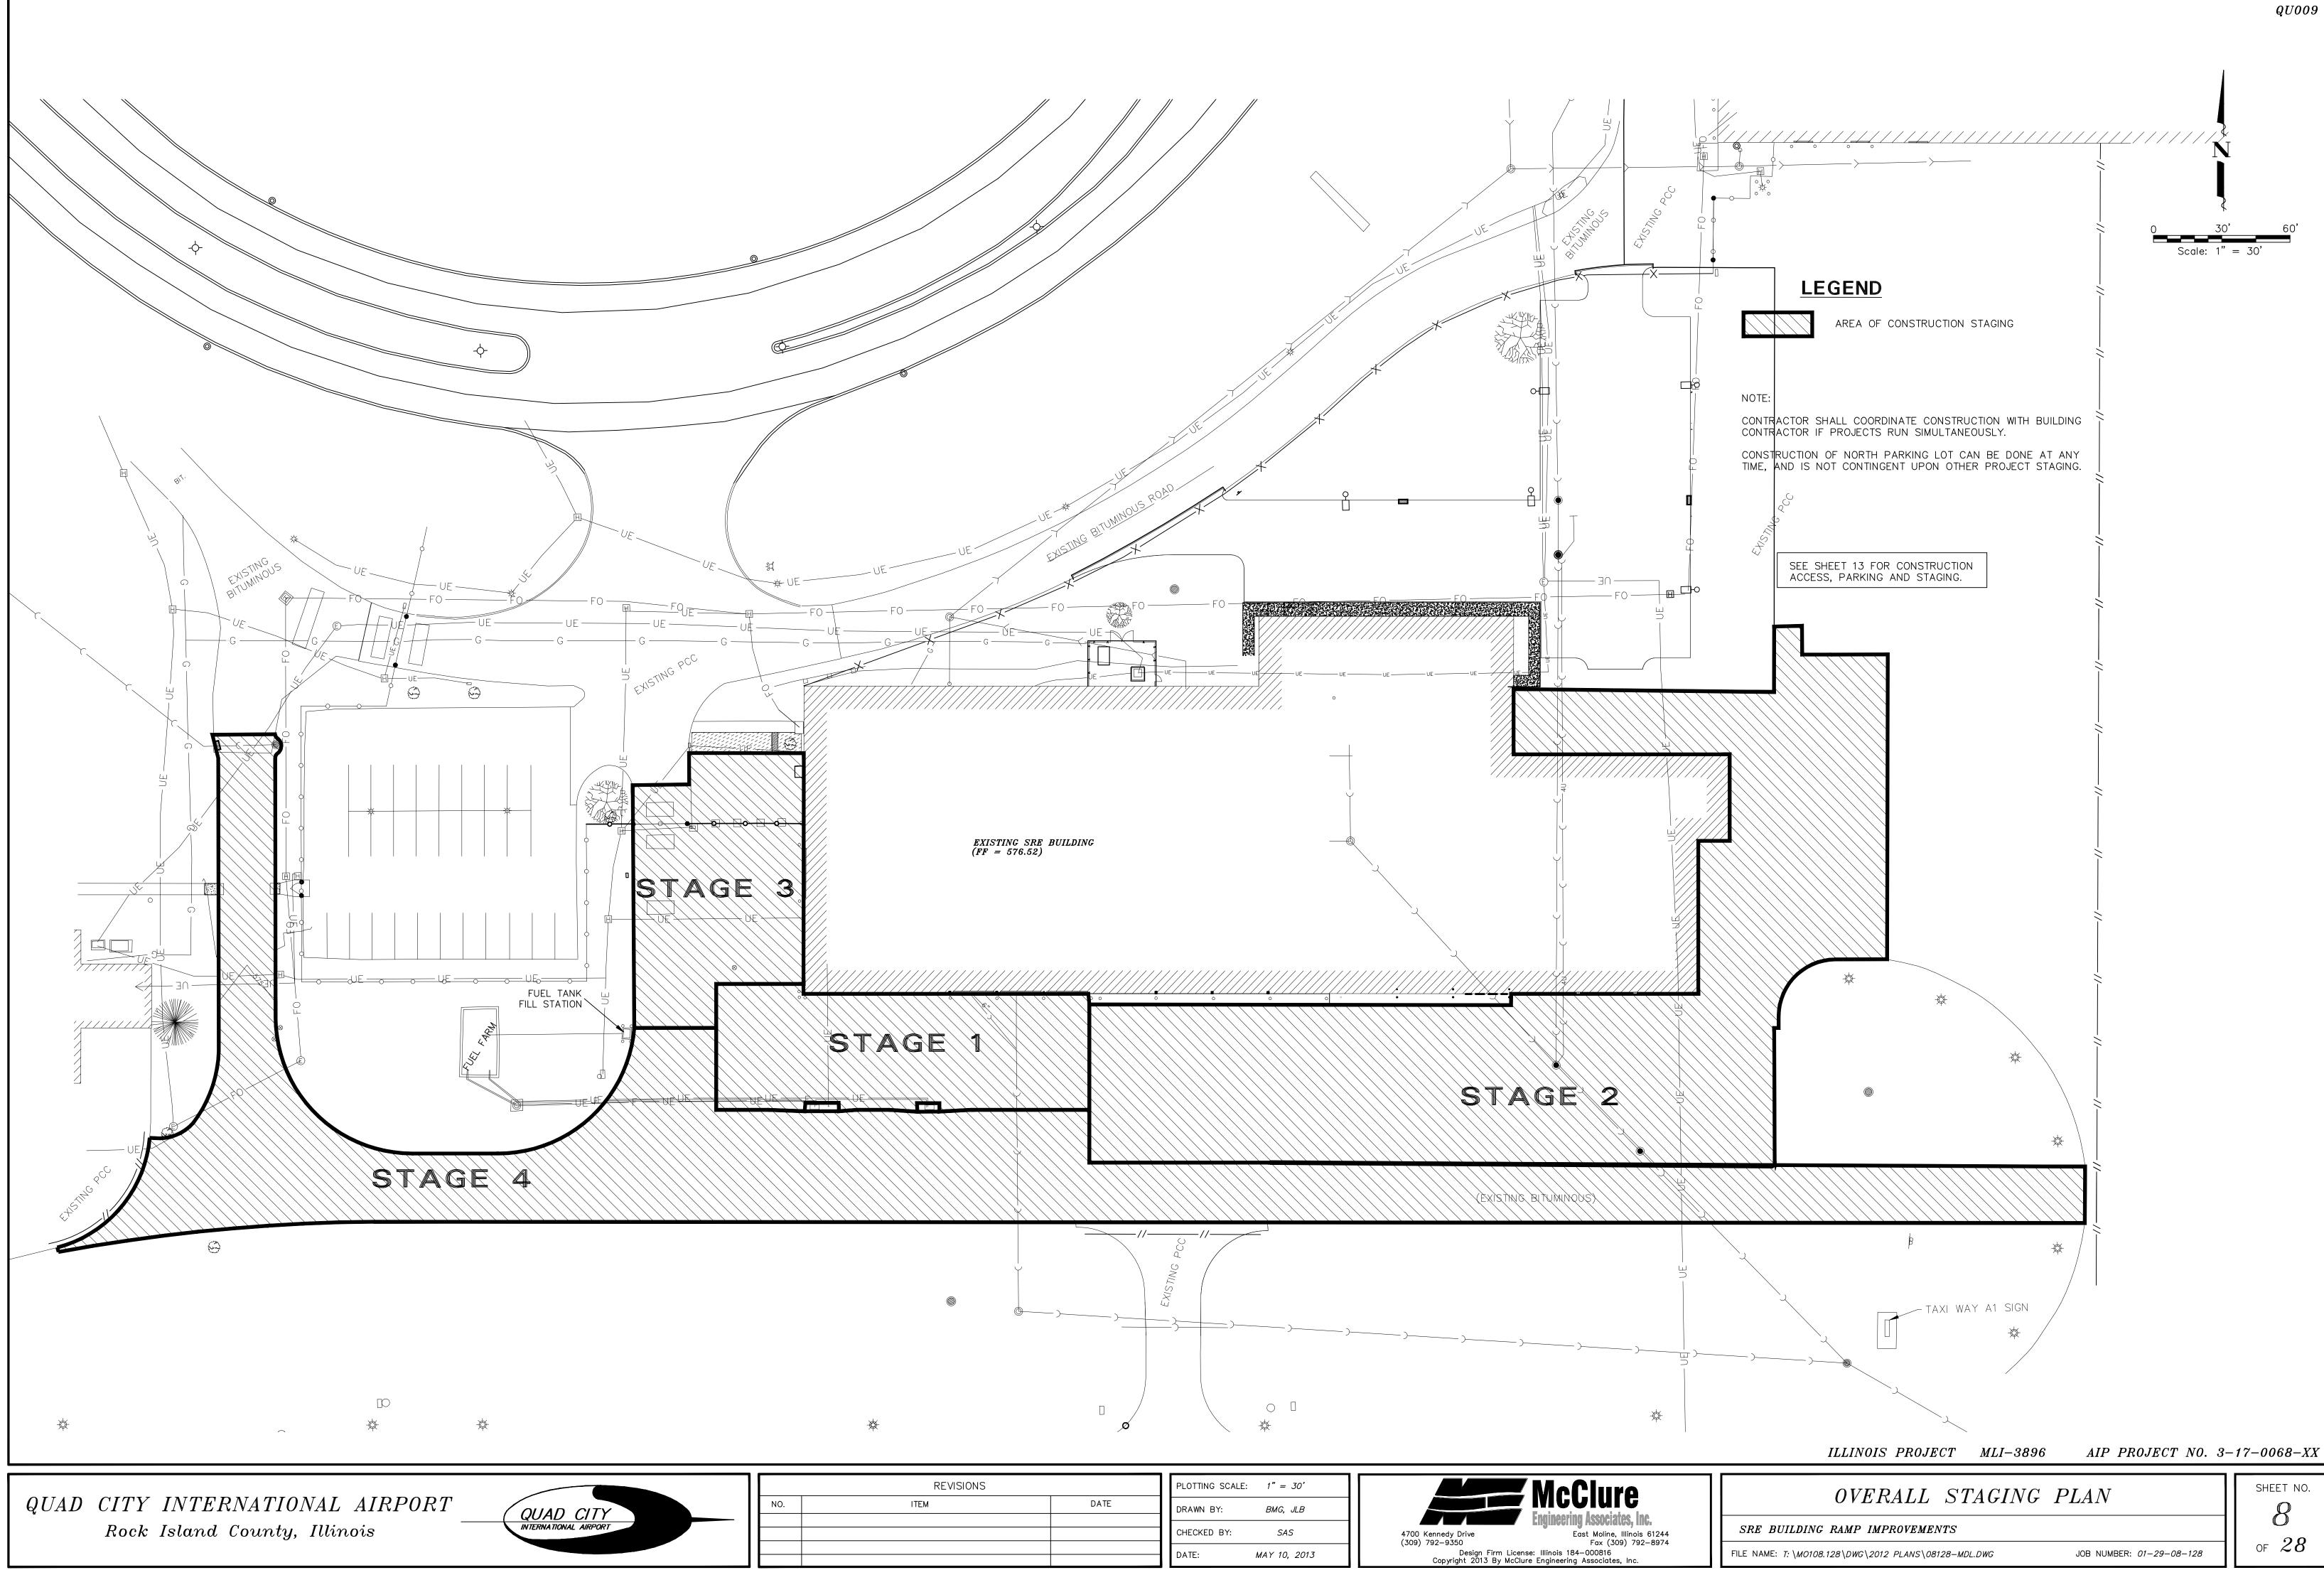


REVISIONS			PLOTTING SCALE:	1" = 30'		
0.	ITEM	DATE	DRAWN BY:	BMG, JLB		
			CHECKED BY:	SAS	4700 Kennedy Drive	Engineering Associate
			DATE:	MAY 10, 2013	(309) 792–9350 Design Firm Licens Copyright 2013 By McClur	Fax (309) se: Illinois 184–000816 re Engineering Associates,

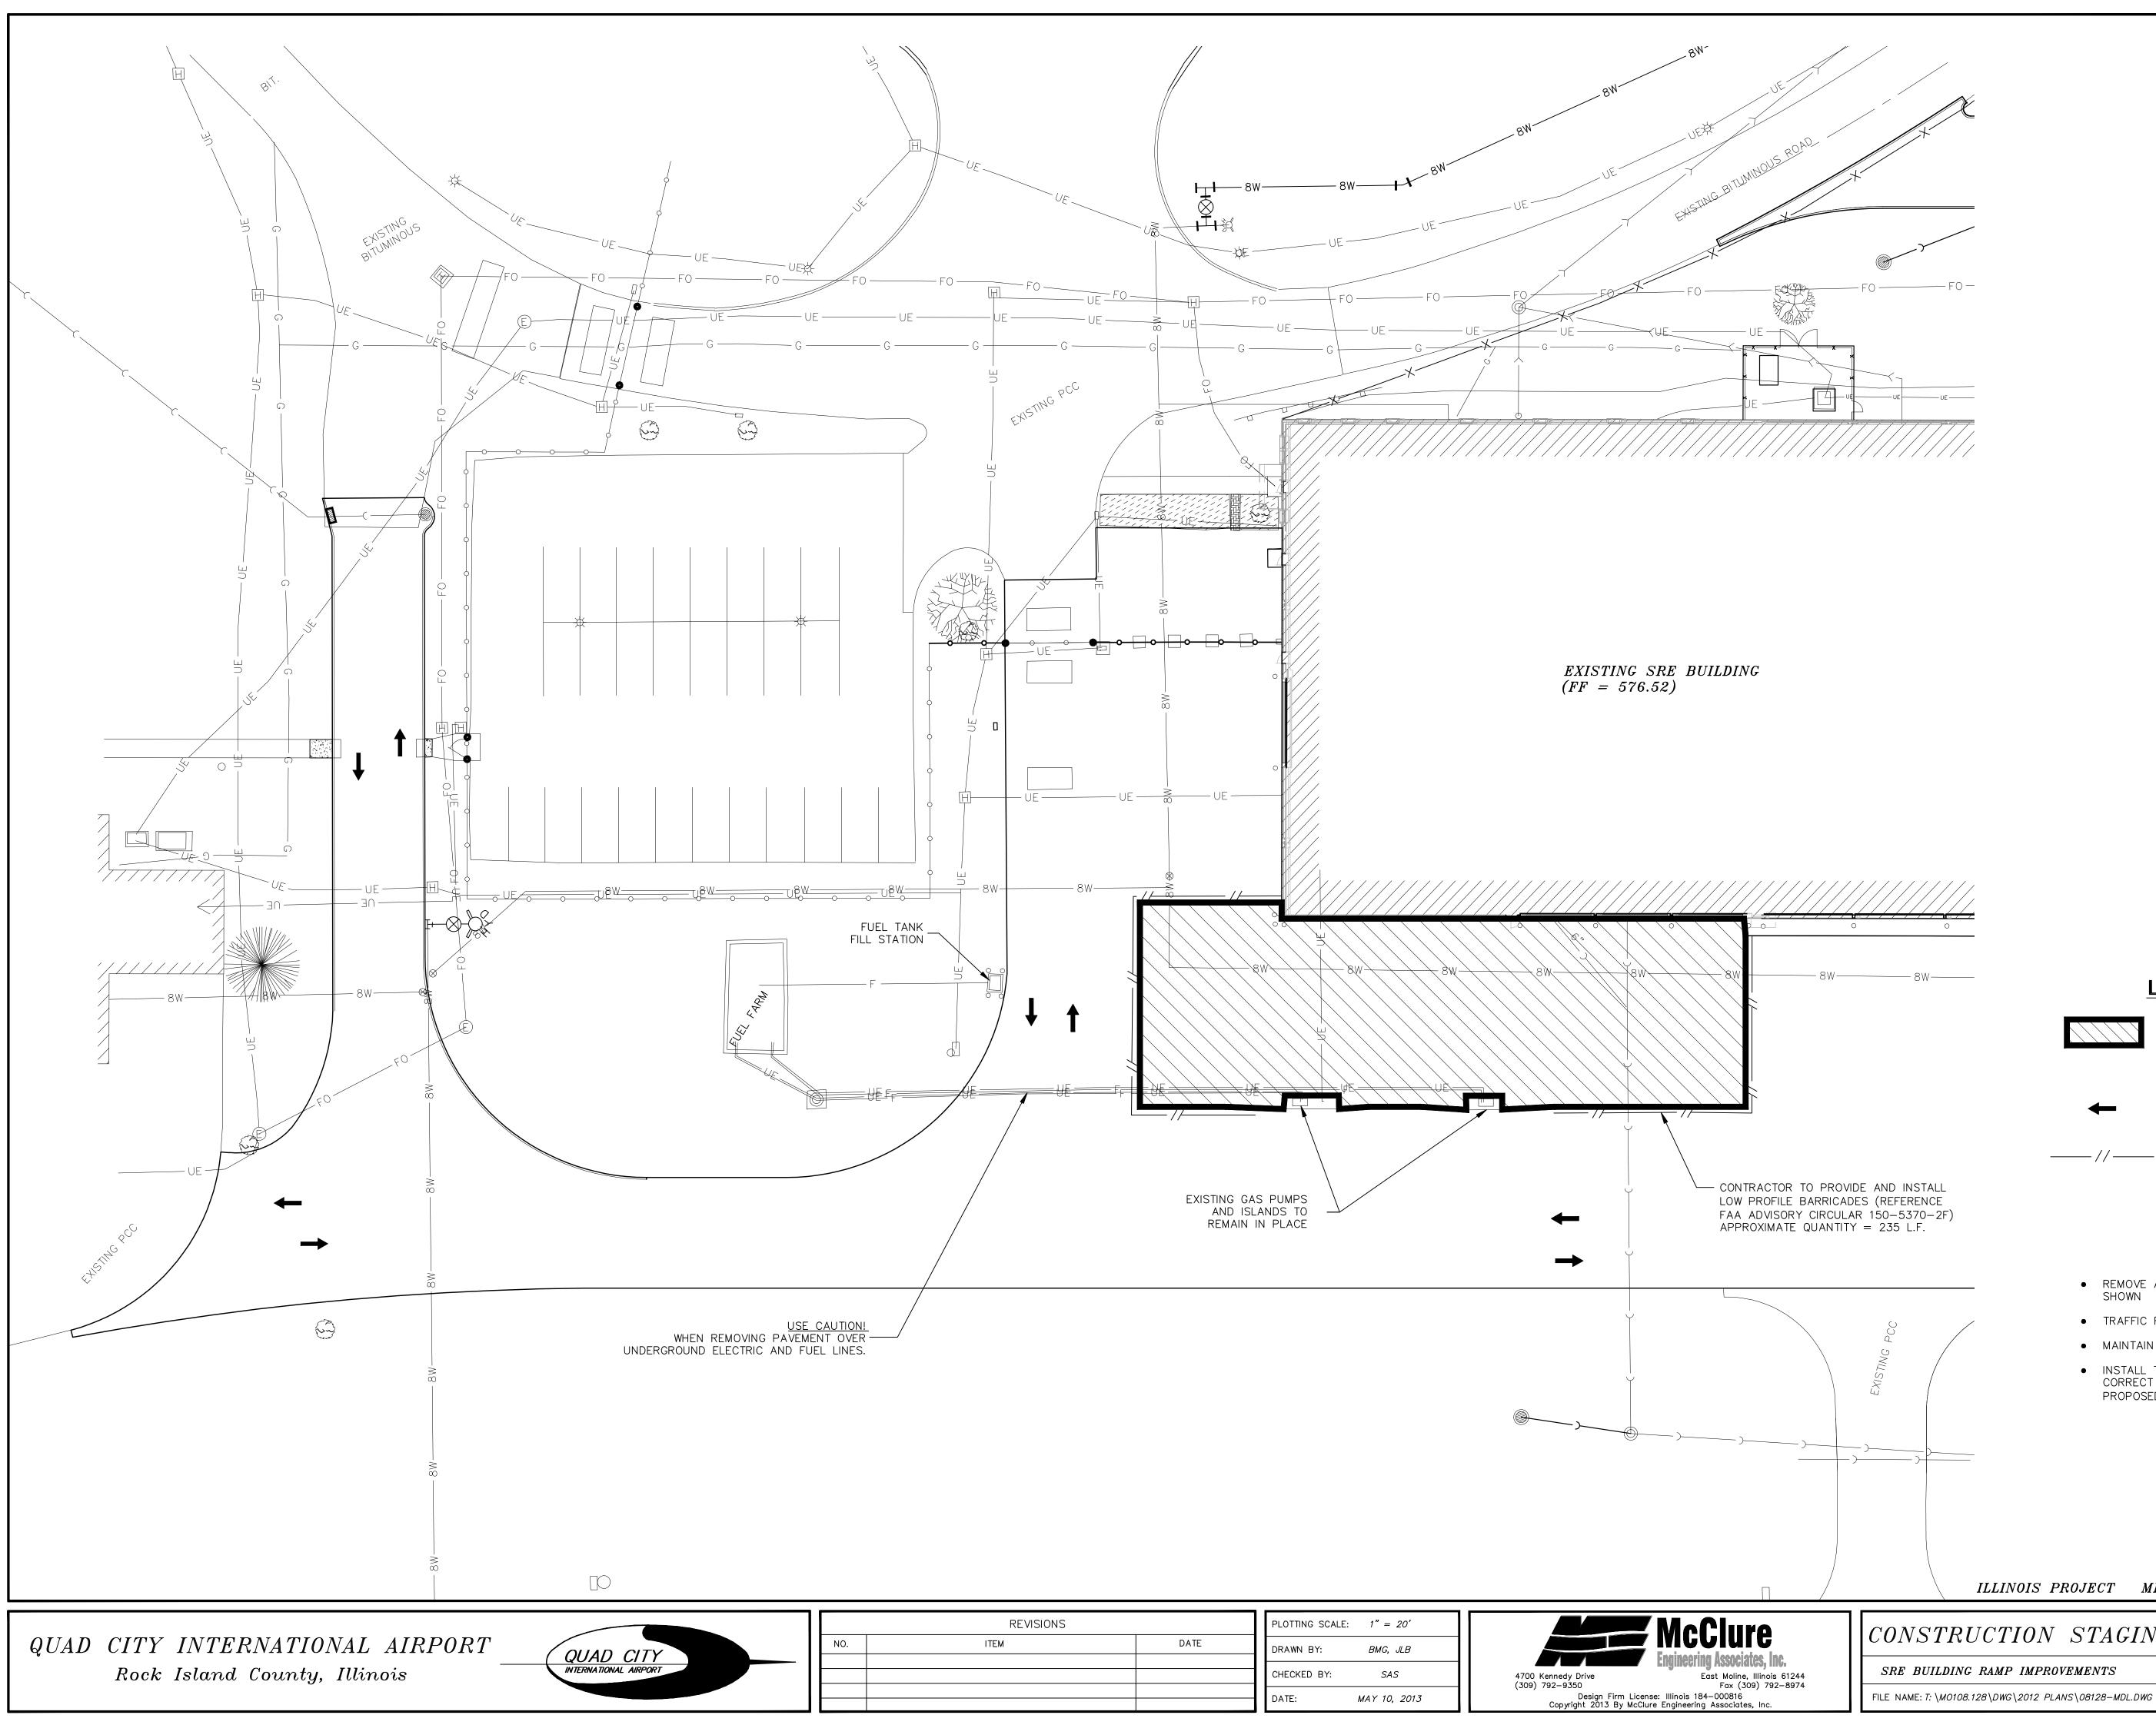


PLOTTING SCALE: $1'' = 20'$	REVISIONS	
DRAWN BY: BMG, JLB	ITEM DATE	
CHECKED BY: SAS		4700 Kennedy Drive East Moline,
DATE: MAY 10, 2013		(309) 792-9350 Fax (30 Design Firm License: Illinois 184-000816 Copyright 2013 By McClure Engineering Associates

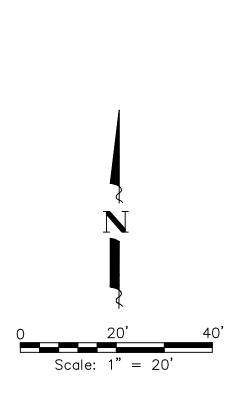


8w		LEGEND	
		AREA OF CONSTRUCTION STAGING	
		TRAFFIC DIRECTION	
RACTOR TO PROVIE PROFILE BARRICAD ADVISORY CIRCULA OXIMATE OLIANTITY	ES (REFERENCE R 150–5370–2F)	——————————————————————————————————————)
		STAGE 1	
		 REMOVE AND REPLACE PAVEMENT IN STAGE 1 AREA 	AS
			- Λ
	Q /	 MAINTAIN ACCESS TO SOUTH SIDE OF FUEL PUMPS. 	
	EXISTING	 INSTALL TEMPORARY BITUMINOUS RAMPS AS NECESS CORRECT ELEVATION DIFFERENCE BETWEEN EXISTING PROPOSED PAVEMENT. (INCIDENTAL TO 8" PCC PAVE 	AND
	_))		
Π		ILLINOIS PROJECT MLI-3896 AIP PROJECT NO. 3	2–17–0068–XX
re	CONSTRU	CTION STAGING PLAN - STAGE 1	SHEET NO.
tes, inc.	SRE BUILDING	RAMP IMPROVEMENTS	
99) 792–8974 s, Inc.	FILE NAME: <i>T:</i> \ <i>M0108.12</i>	28\DWG\2012 PLANS\08128-MDL.DWG JOB NUMBER: 01-29-08-128	OF 28
PROFILE BARRICAD ADVISORY CIRCULA OXIMATE QUANTITY	ES (REFERENCE R 150–5370–2F) (= 235 L.F.	I. LOW PROFILE BARRICADES (INCIDENTAL TO TRAFFIC MAINTENANCE) STAGE 1 • REMOVE AND REPLACE PAVEMENT IN STAGE 1 AREA SHOWN • TRAFFIC FLOW NORMAL EXCEPT WITHIN STAGE 1 AREA • MAINTAIN ACCESS TO SOUTH SIDE OF FUEL PUMPS. • INSTALL TEMPORARY BITUMINOUS RAMPS AS NECESS CORRECT ELEVATION DIFFERENCE BETWEEN EXISTING PROPOSED PAVEMENT. (INCIDENTAL TO 8" PCC PAVE ILLINOIS PROJECT MLI-3896 AIP PROJECT NO. 3 ICTION STACING PLAN - STAGE 1 RAMP IMPROVEMENTS	AS EA. SARY TO AND EMENT) SHEET NO.

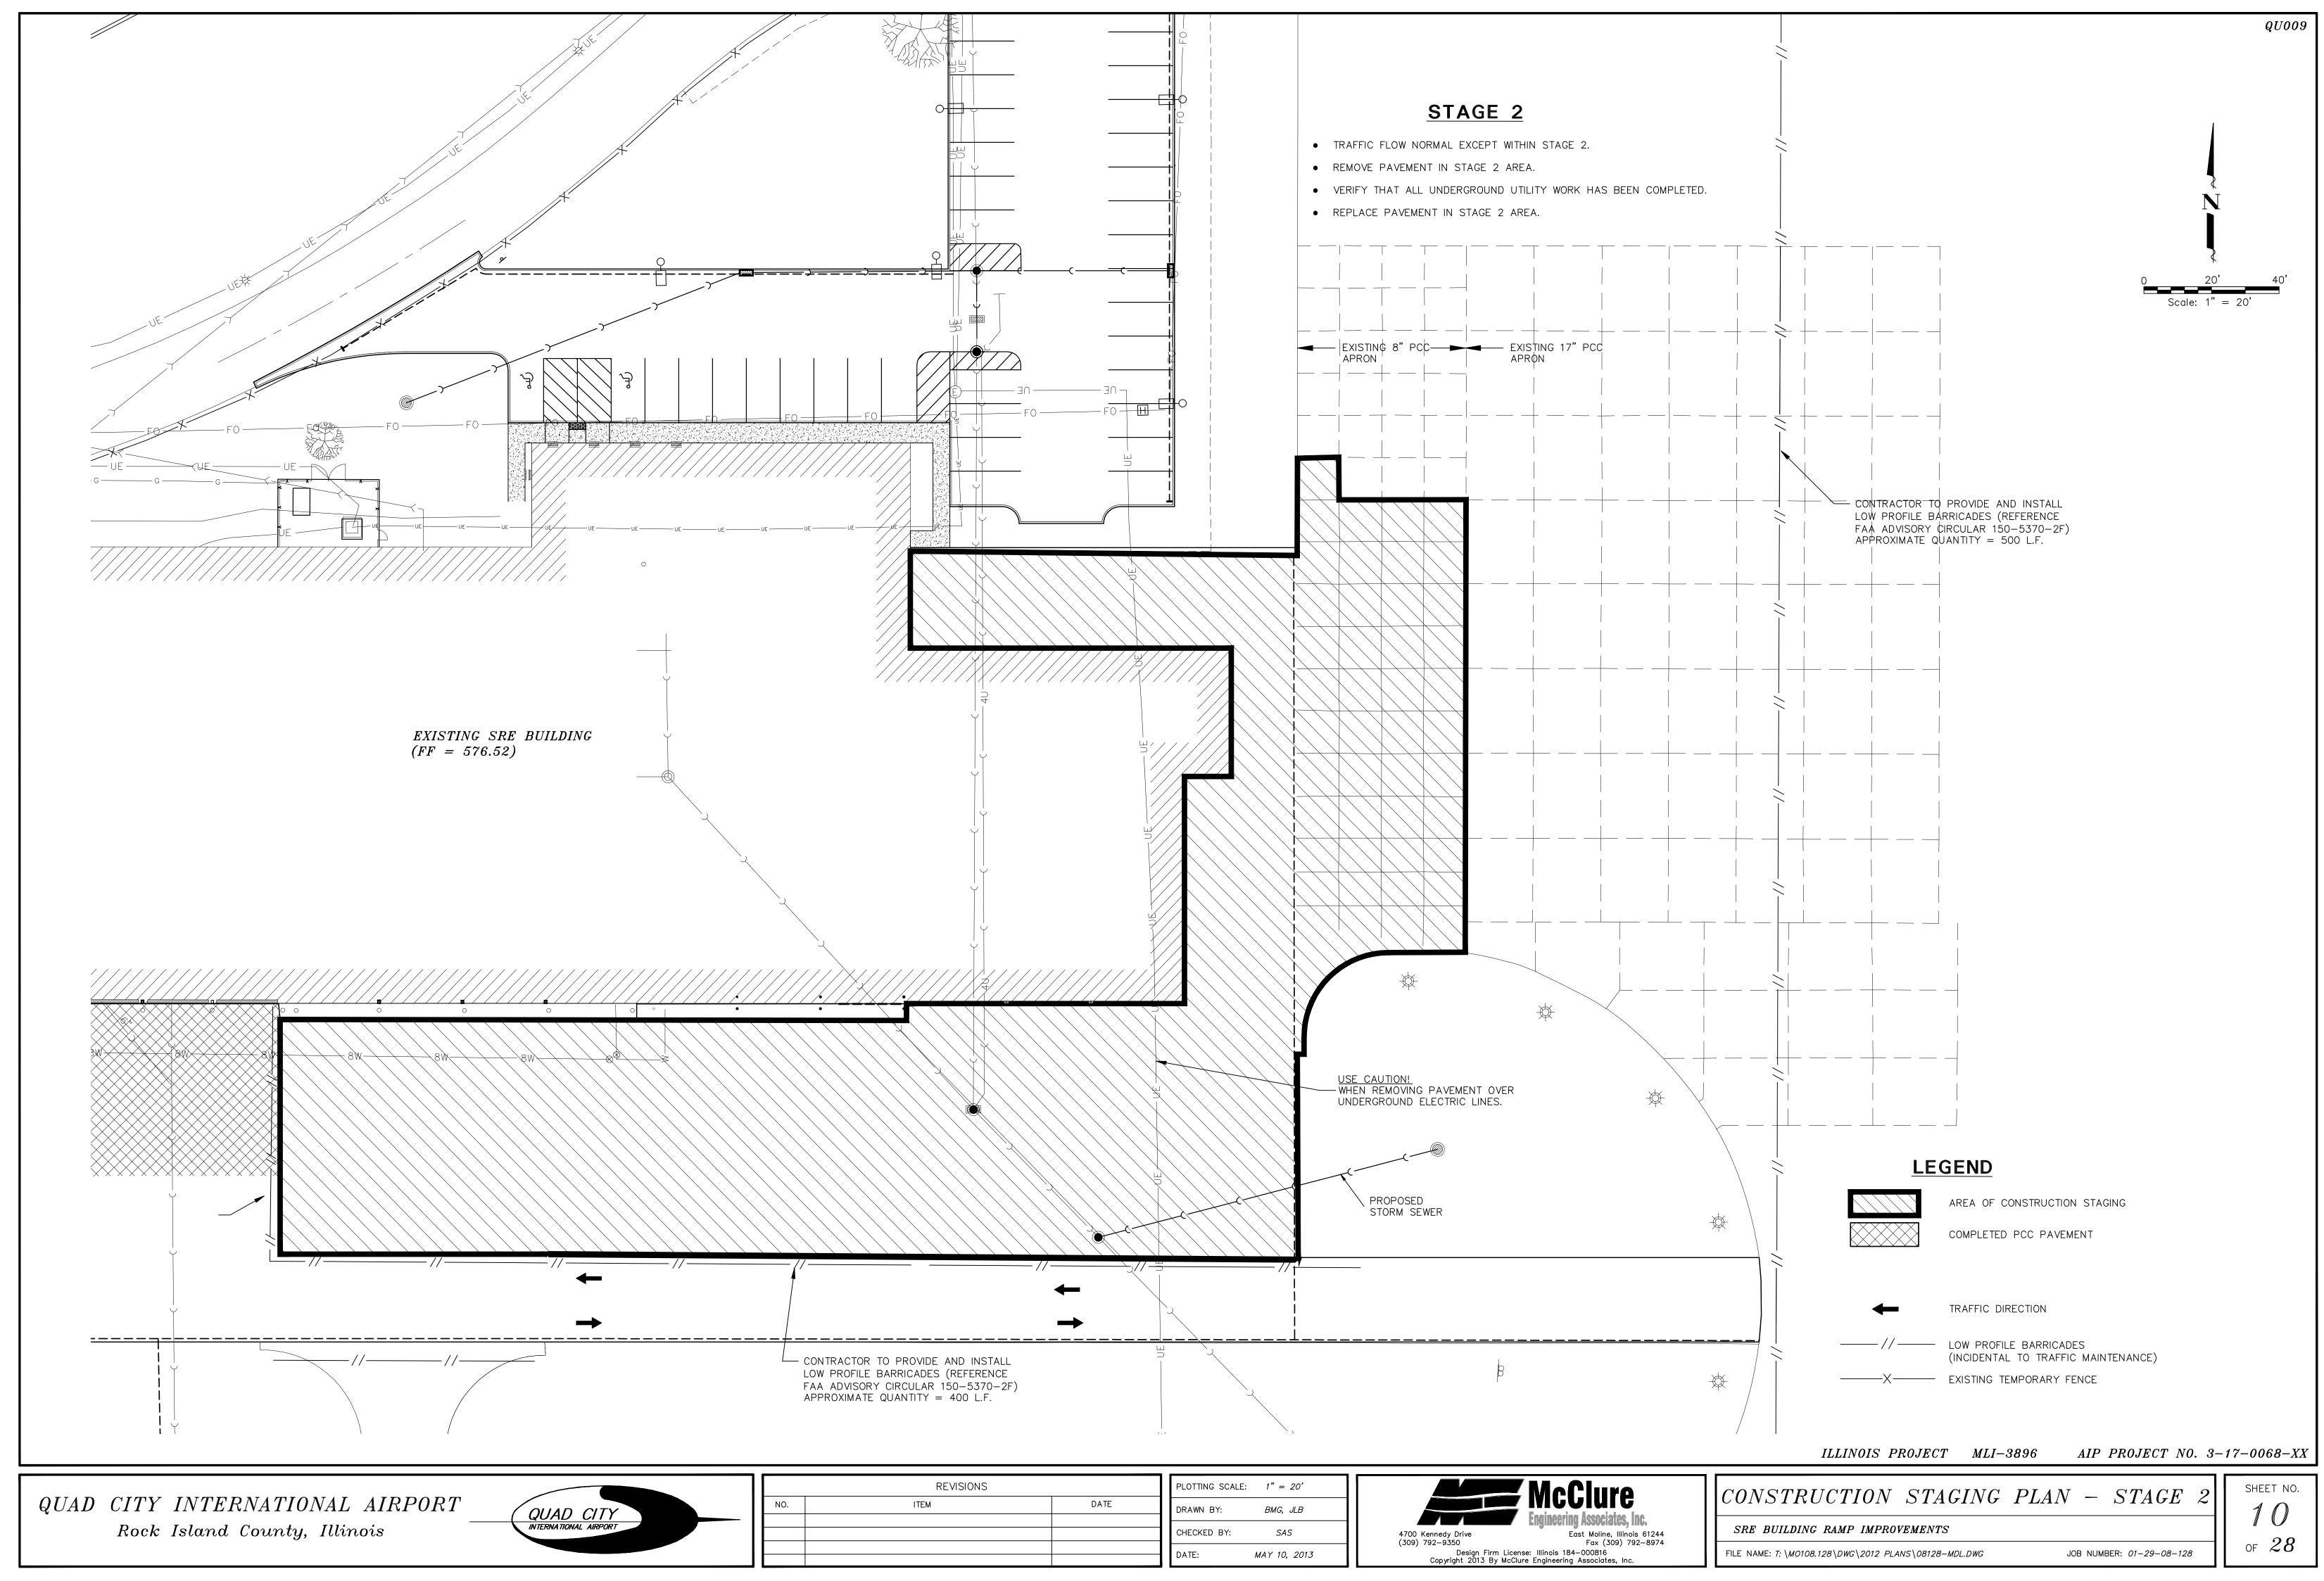


▰м₅∩ы		E: 1" = 20'	PLOTTING SCALE	REVISIONS						
E McClu		BMG, JLB	DRAWN BY:	DATE	ITEM	۱0.				
Engineering Assoc		SAS	CHECKED BY:							
East Molir Fax (h License: Illinois 184-000816	4700 Kennedy Drive (309) 792–9350									
McClure Engineering Associa		MAY 10, 2013	DATE:							

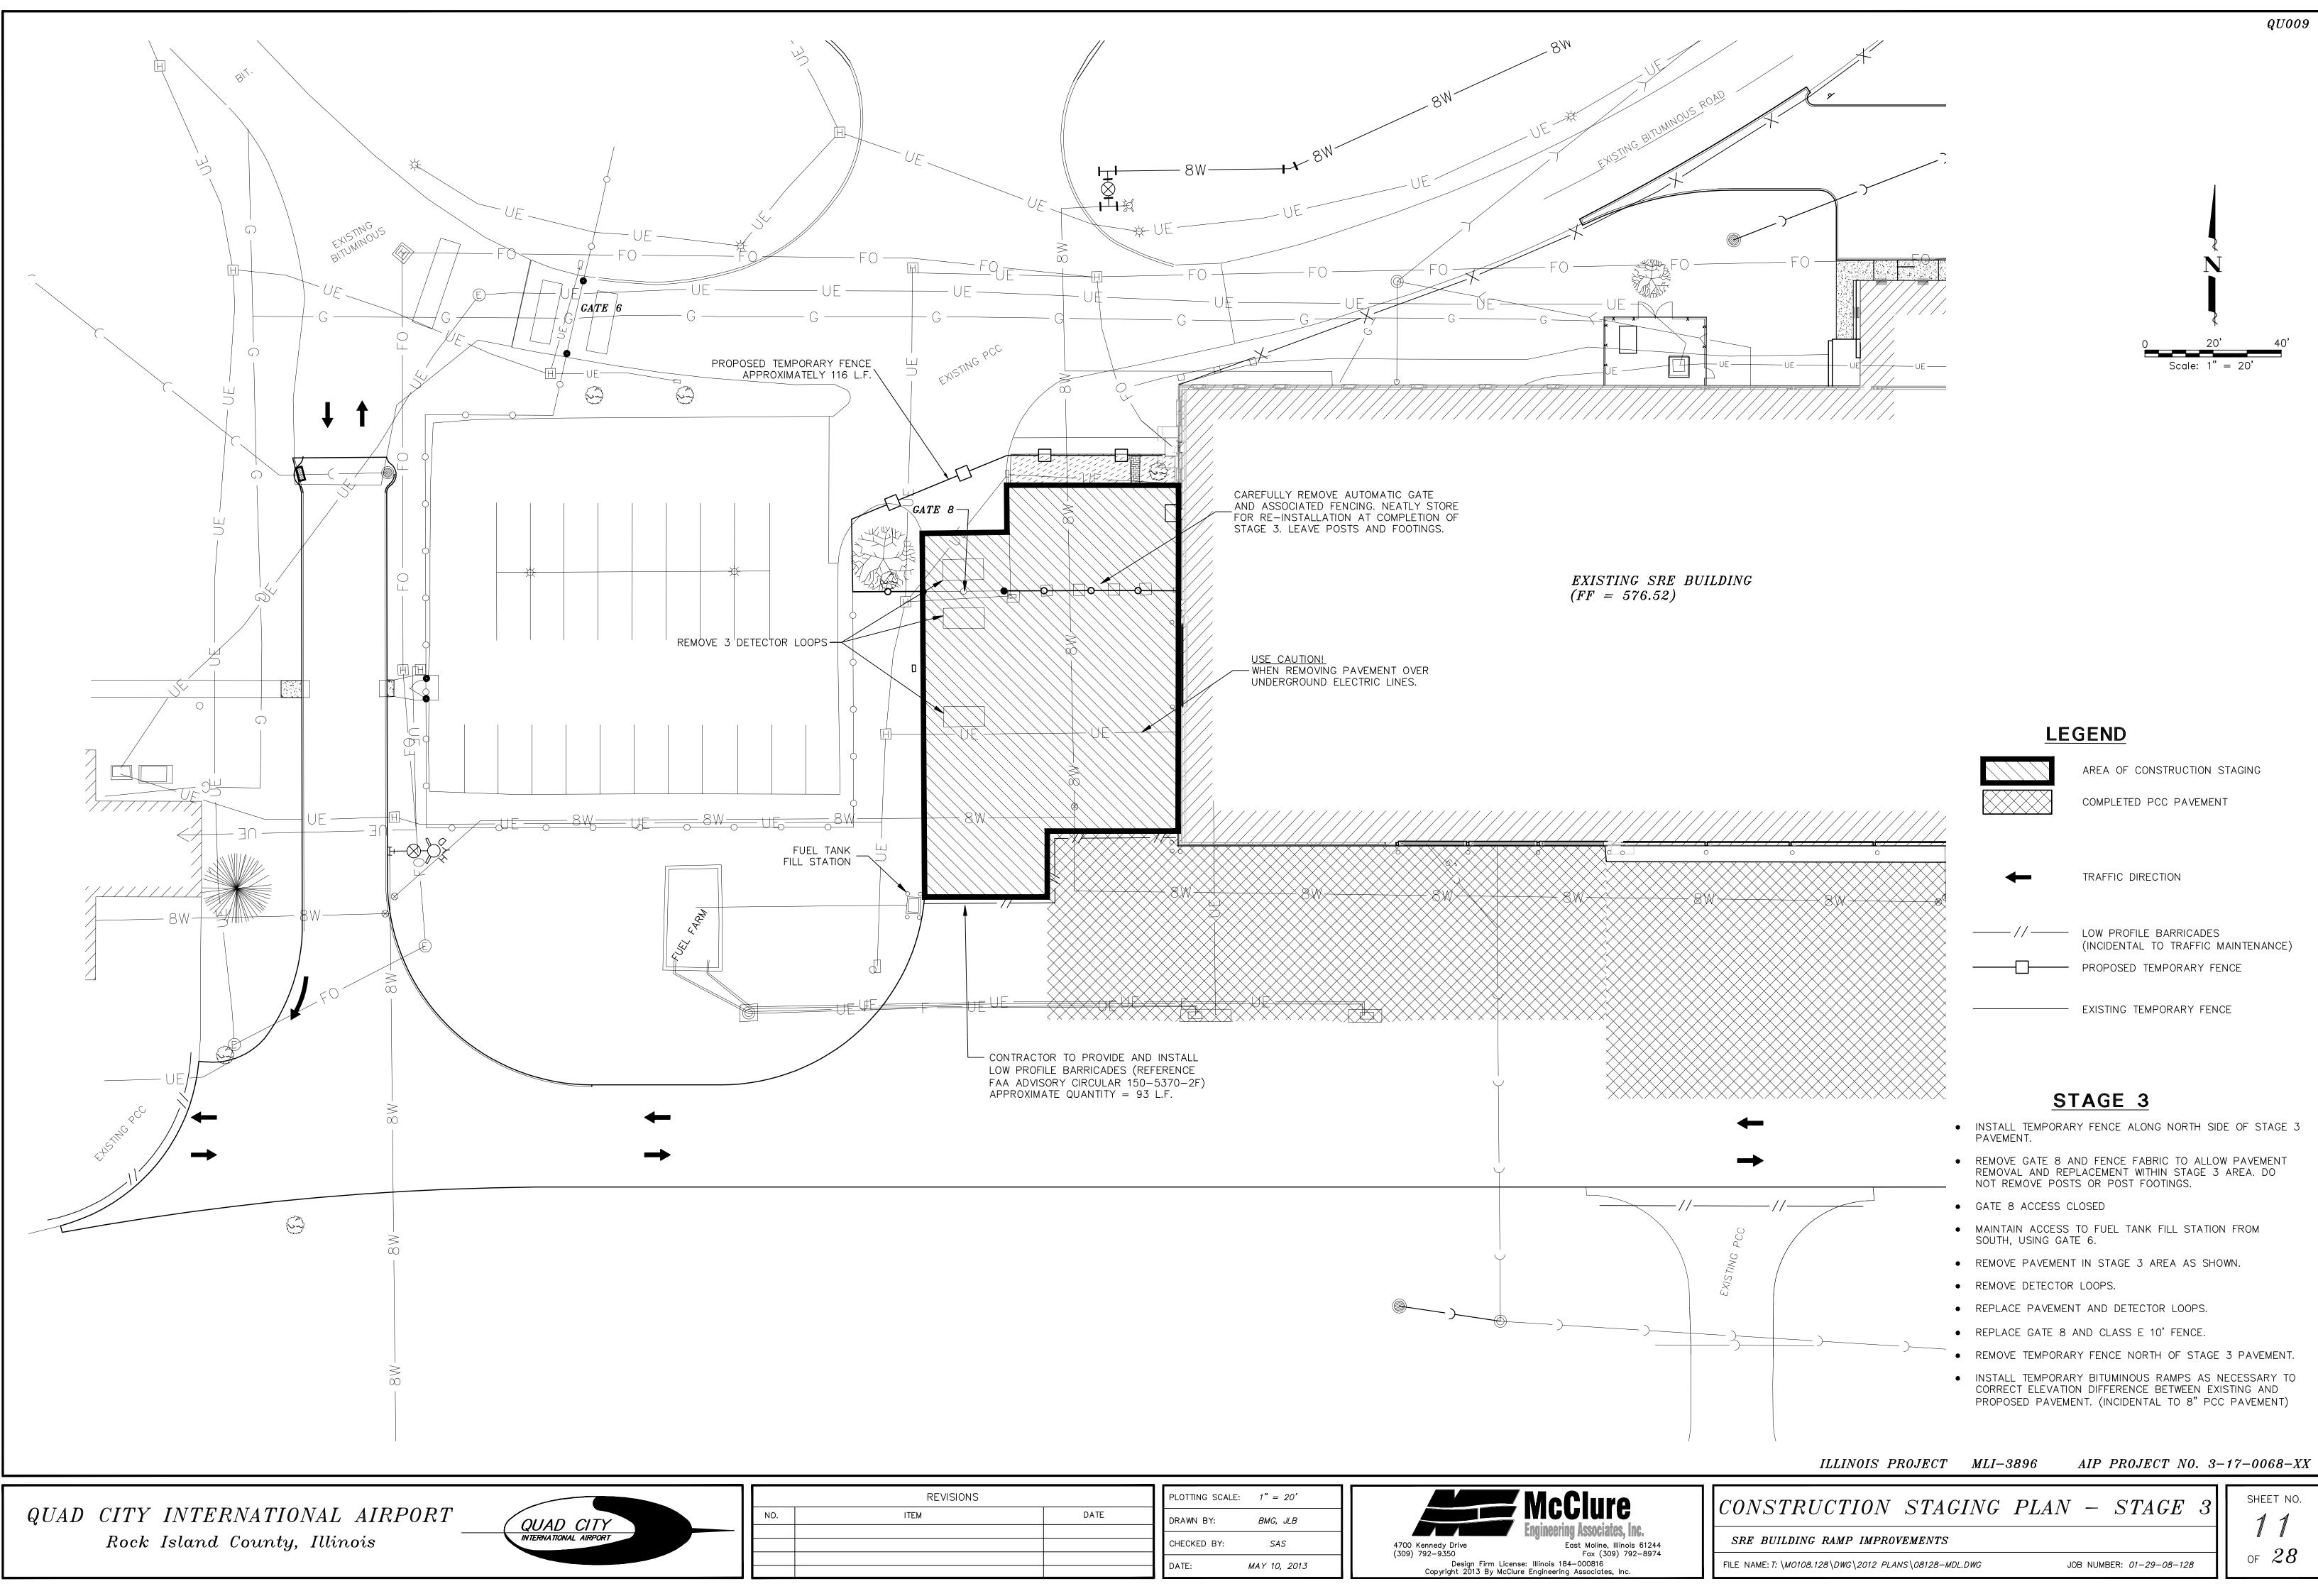



	REVISIONS		PLOTTING SCALE: $1'' = 20'$	
).	ITEM	DATE	DRAWN BY: BMG, JLB	
			CHECKED BY: SAS	4700 Kennedy Drive East Moline, Illin (700) 700 0250
			DATE: MAY 10, 2013	(309) 792-9350 Fax (309) Design Firm License: Illinois 184-000816 Copyright 2013 By McClure Engineering Associates, In

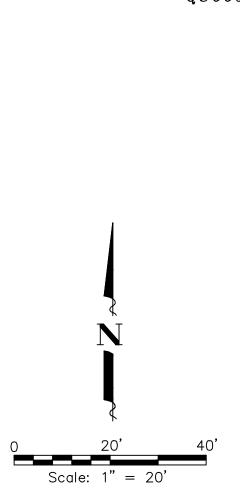

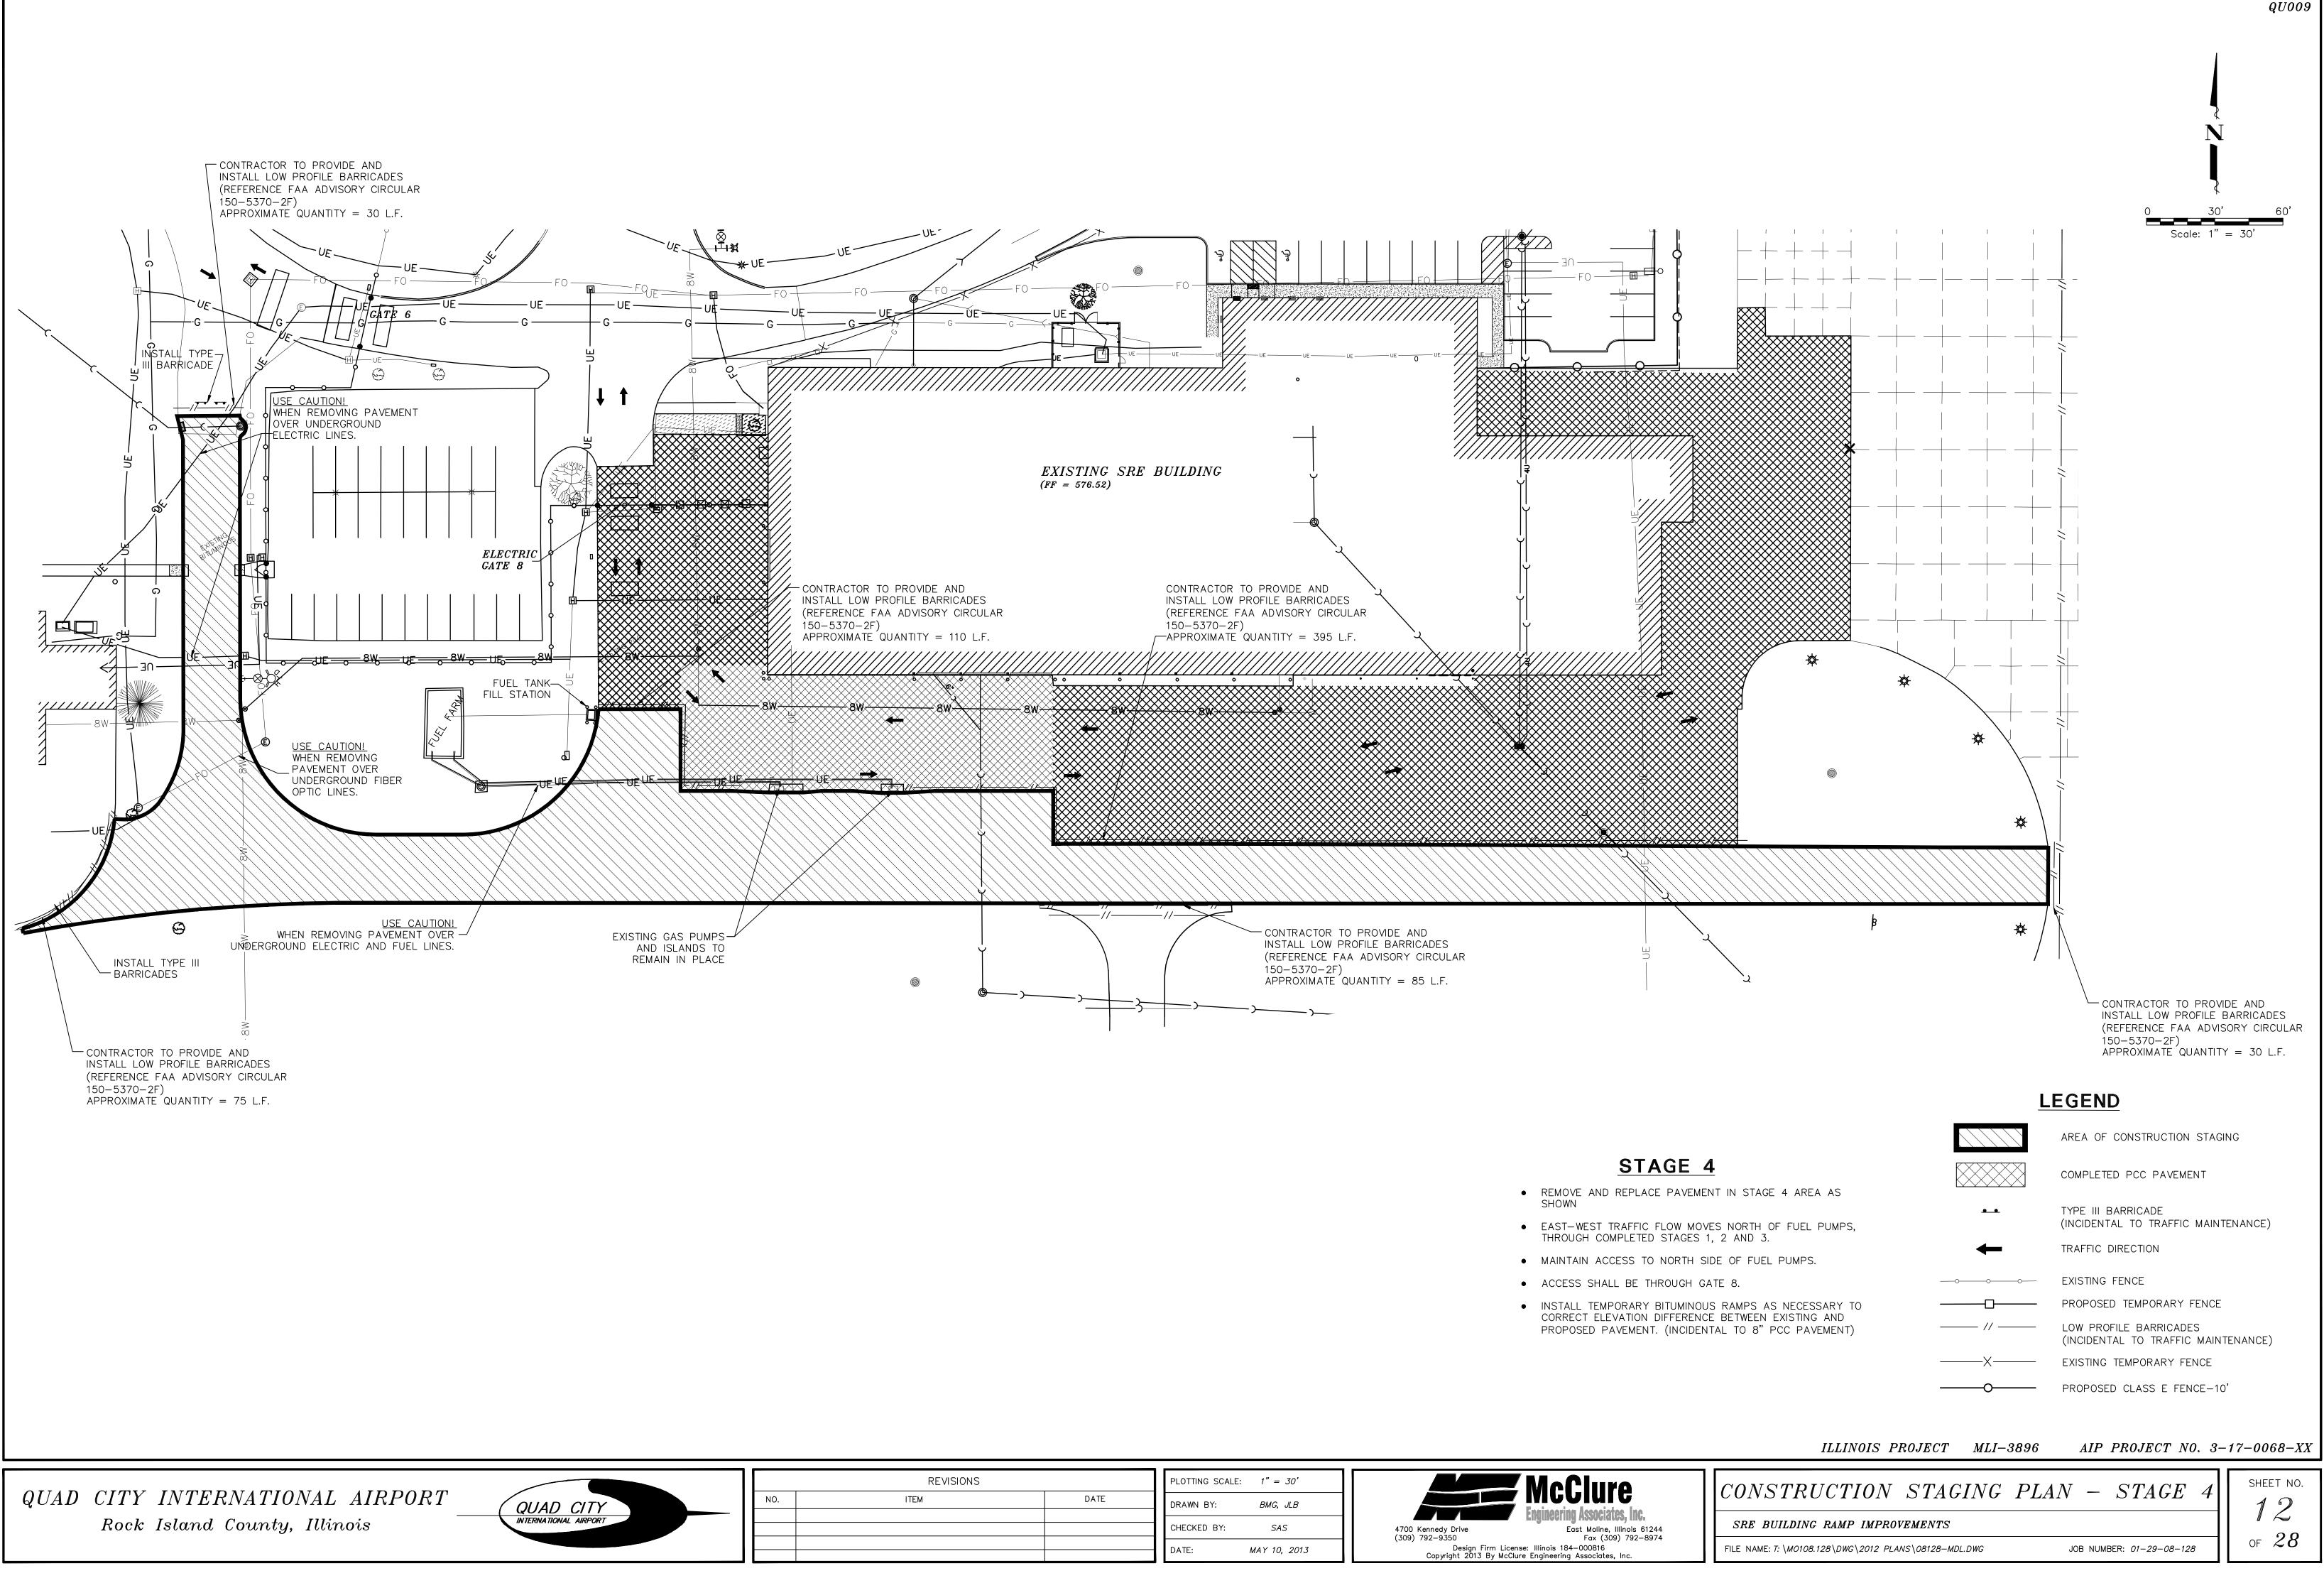


	REVISIONS		PLOTTING SCALE: $1'' = 30'$	McClure
NO.	ITEM	DATE	DRAWN BY: BMG, JLB	
			CHECKED BY: SAS 4700 Kennedy Drive	Engineering Associates, I
			(309) 792–9350 DATE: MAY 10, 2013 Copyright 2013 By McC	Fax (309) 79 ense: Illinois 184—000816 lure Engineering Associates, Inc.

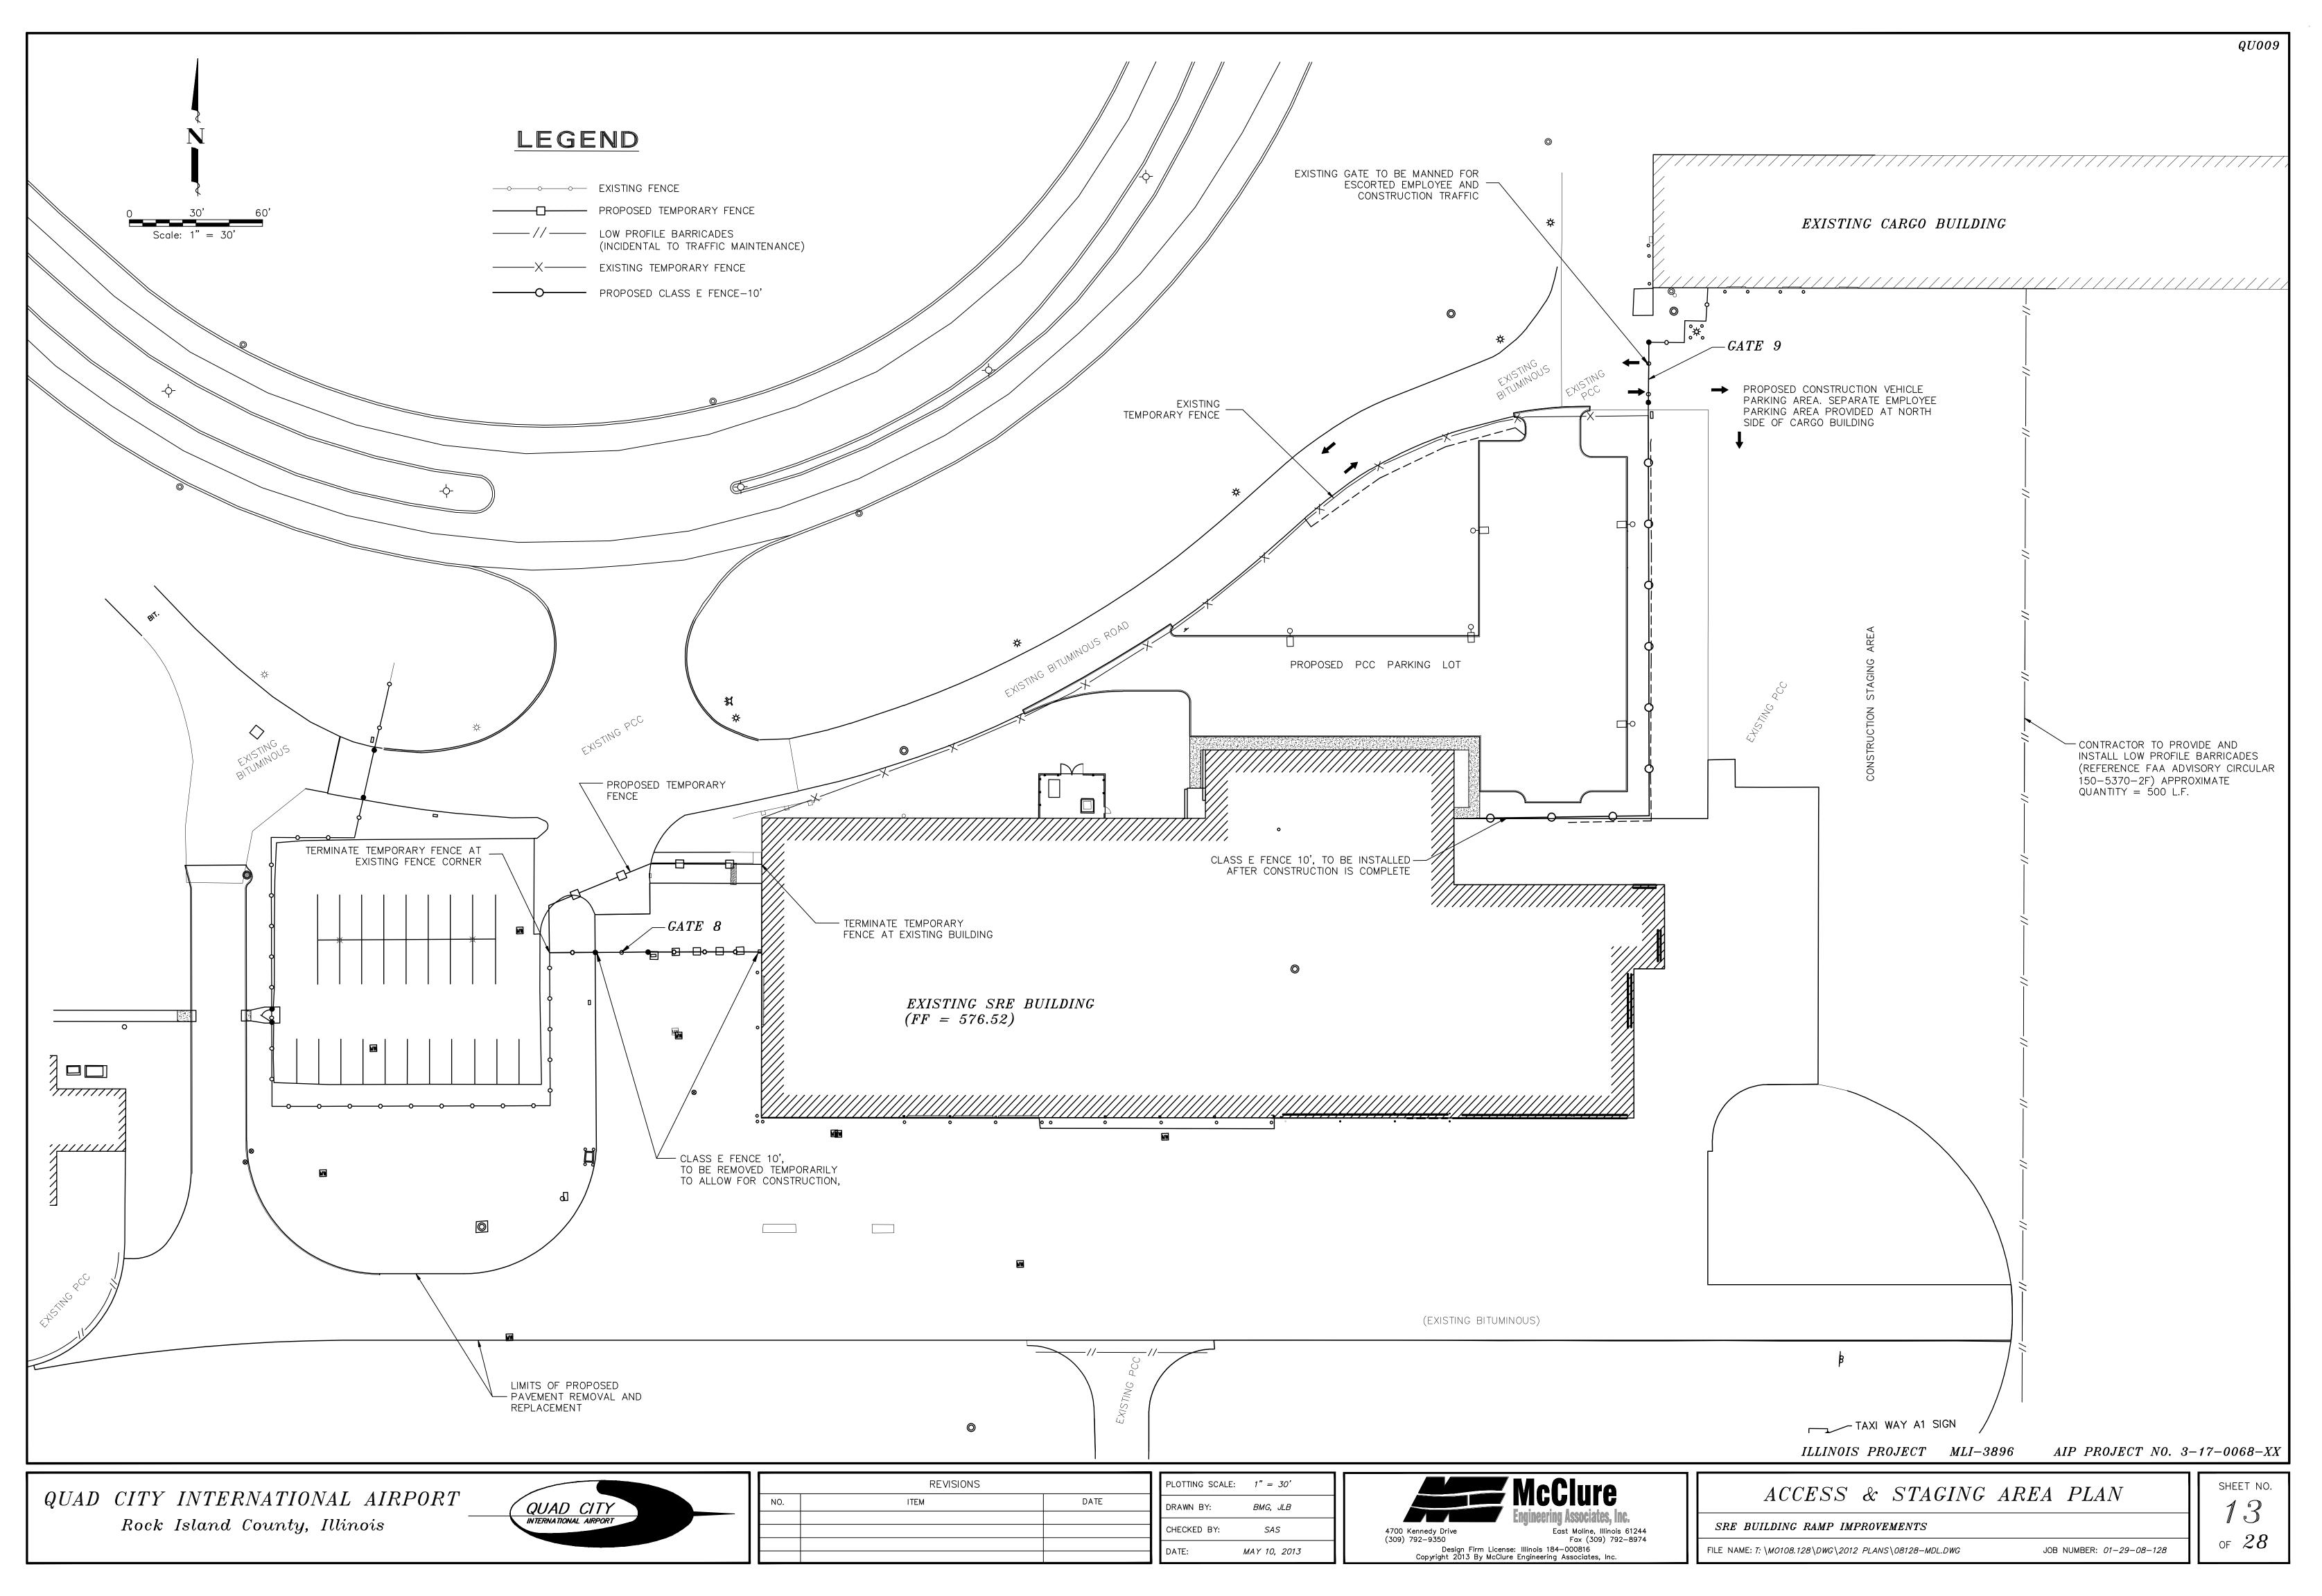

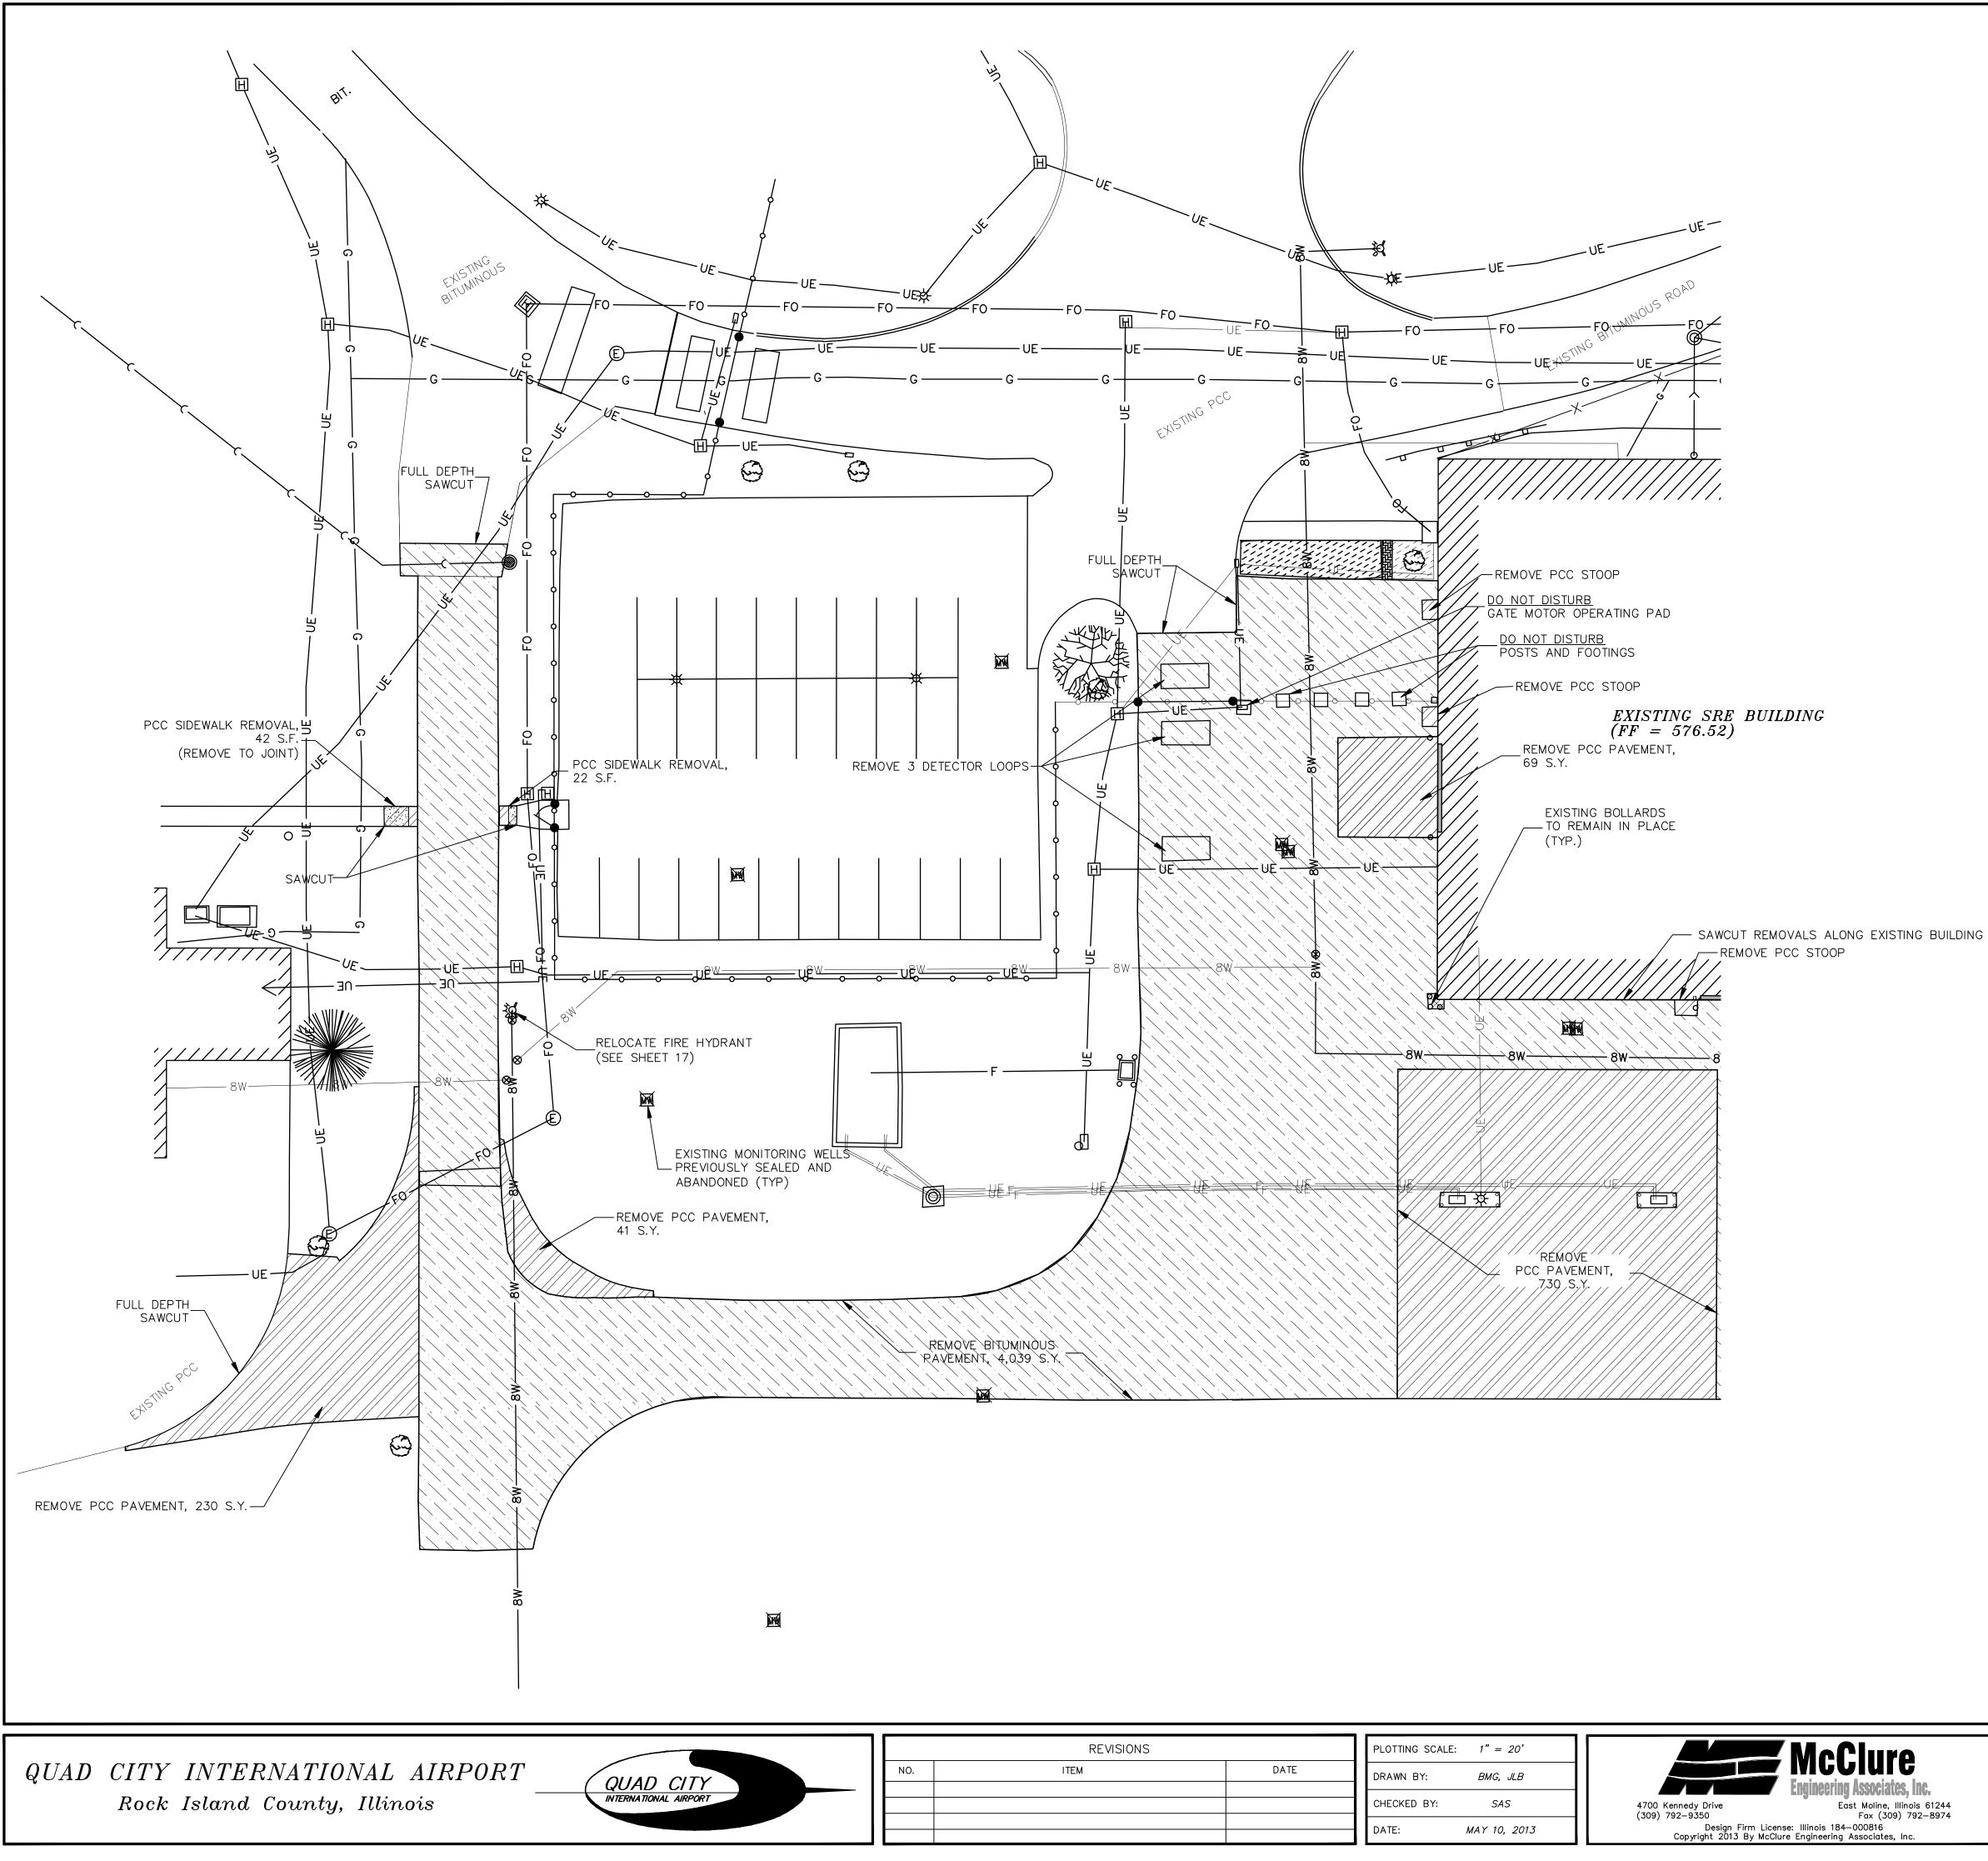

			ILLINOIS PROJECT MLI-3896 AIP PROJECT NO. 3-	-17-0068-XX
REVISIONS O. ITEM DATE Image: Colspan="2">Image: Colspan="2" Image: Colspan="2">Image: Colspan="2">Image: Colspan="2">Image: Colspan="2">Image: Colspan="2">Image: Colspan="2">Image: Colspan="2">Image: Colspan="2">Image: Colspan="2">Image: Colspan="2" Image: Colspan="2">Image: Colspan="2" Image: Colspan="2">Image: Colspan="2" Image: Colspan="2" Image: Colspan="2">Image: Colspan="2" Image: Colspa="">Colspa="Colspa=""Colspan=""Colspan=""Colspan=""Colspa=""Colspa	PLOTTING SCALE:1" = 20'DRAWN BY:BMG, JLBCHECKED BY:SASDATE:MAY 10, 2013	A700 Kennedy Drive (309) 792–9350 Design Firm License: Illinois 184–000816 Copyright 2013 By McClure Engineering Associates, Inc.	REMOVALS PLAN – WEST SRE BUILDING RAMP IMPROVEMENTS FILE NAME: T: \M0108.128\DWG\2012 PLANS\08128-MDL.DWG JOB NUMBER: 01-29-08-128	SHEET NO. 114 of 28

QU009

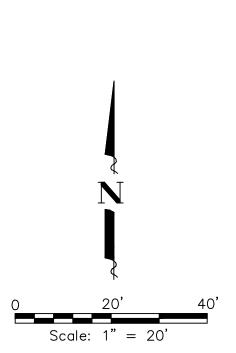



LEGEND

REMOVE PCC PAVEMENT


REMOVE BITUMINOUS PAVEMENT

<u>NOTE</u> SEE STAGING PLANS FOR ORDER OF PAVEMENT REMOVAL.

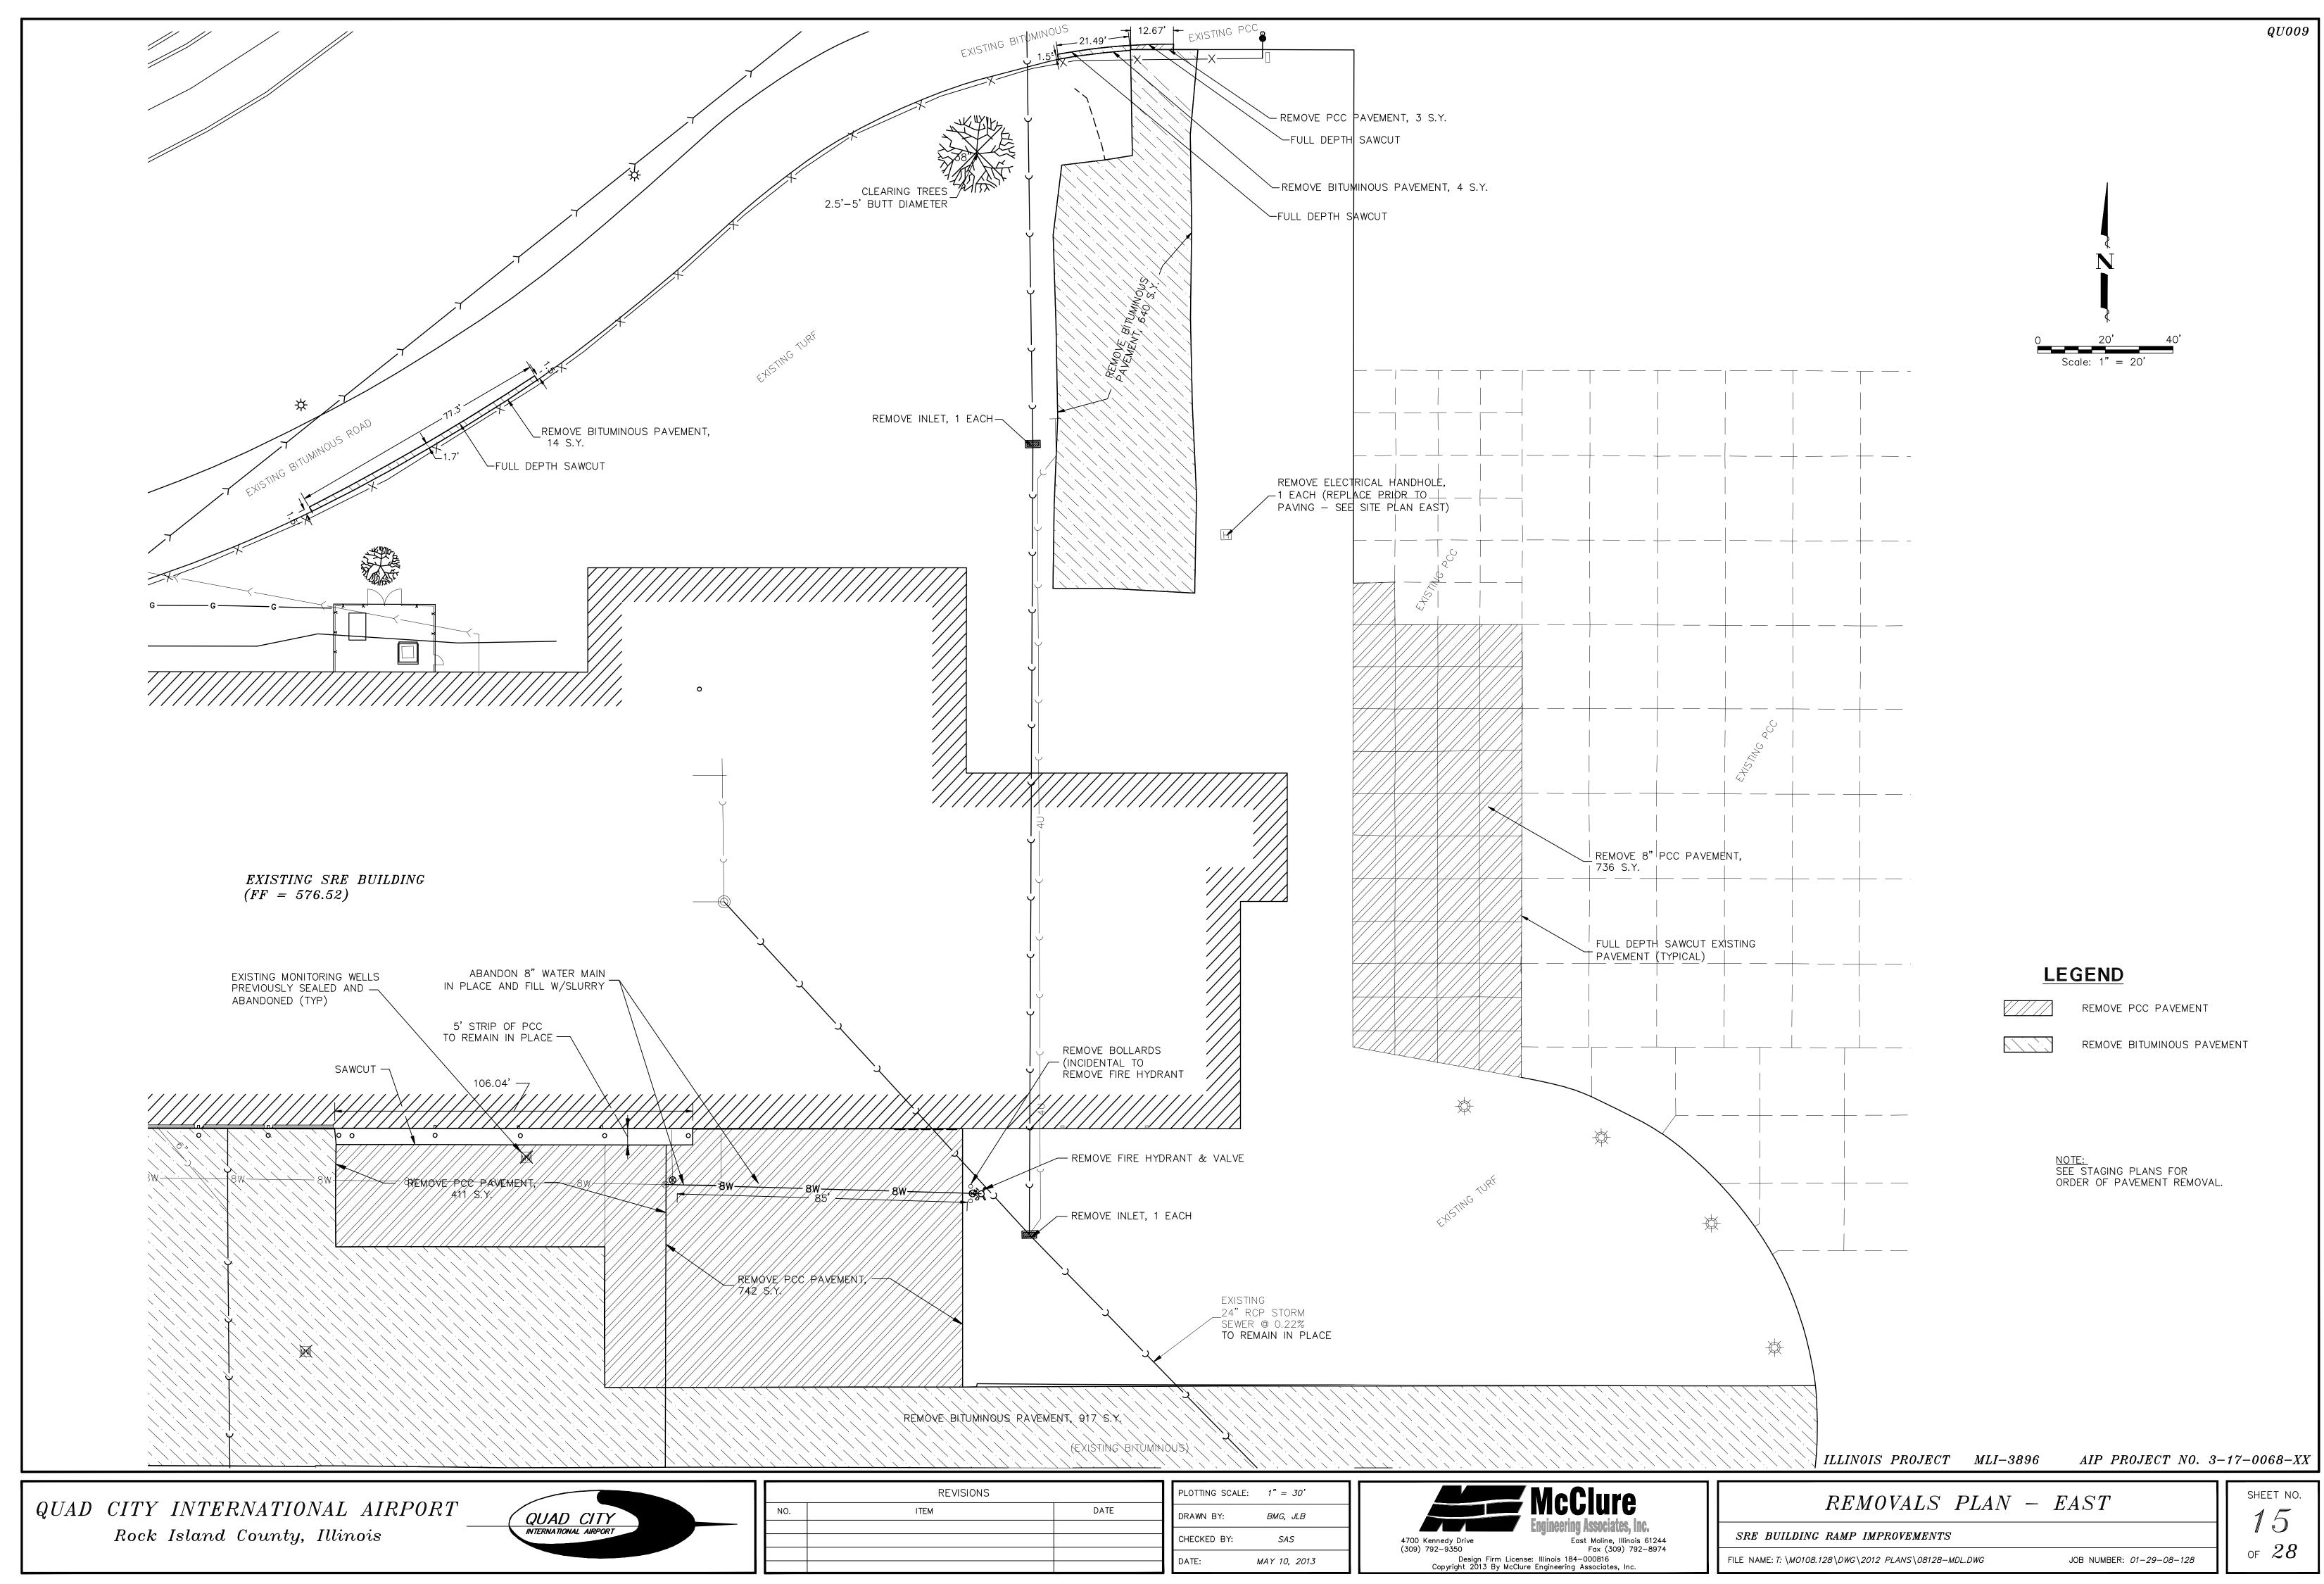


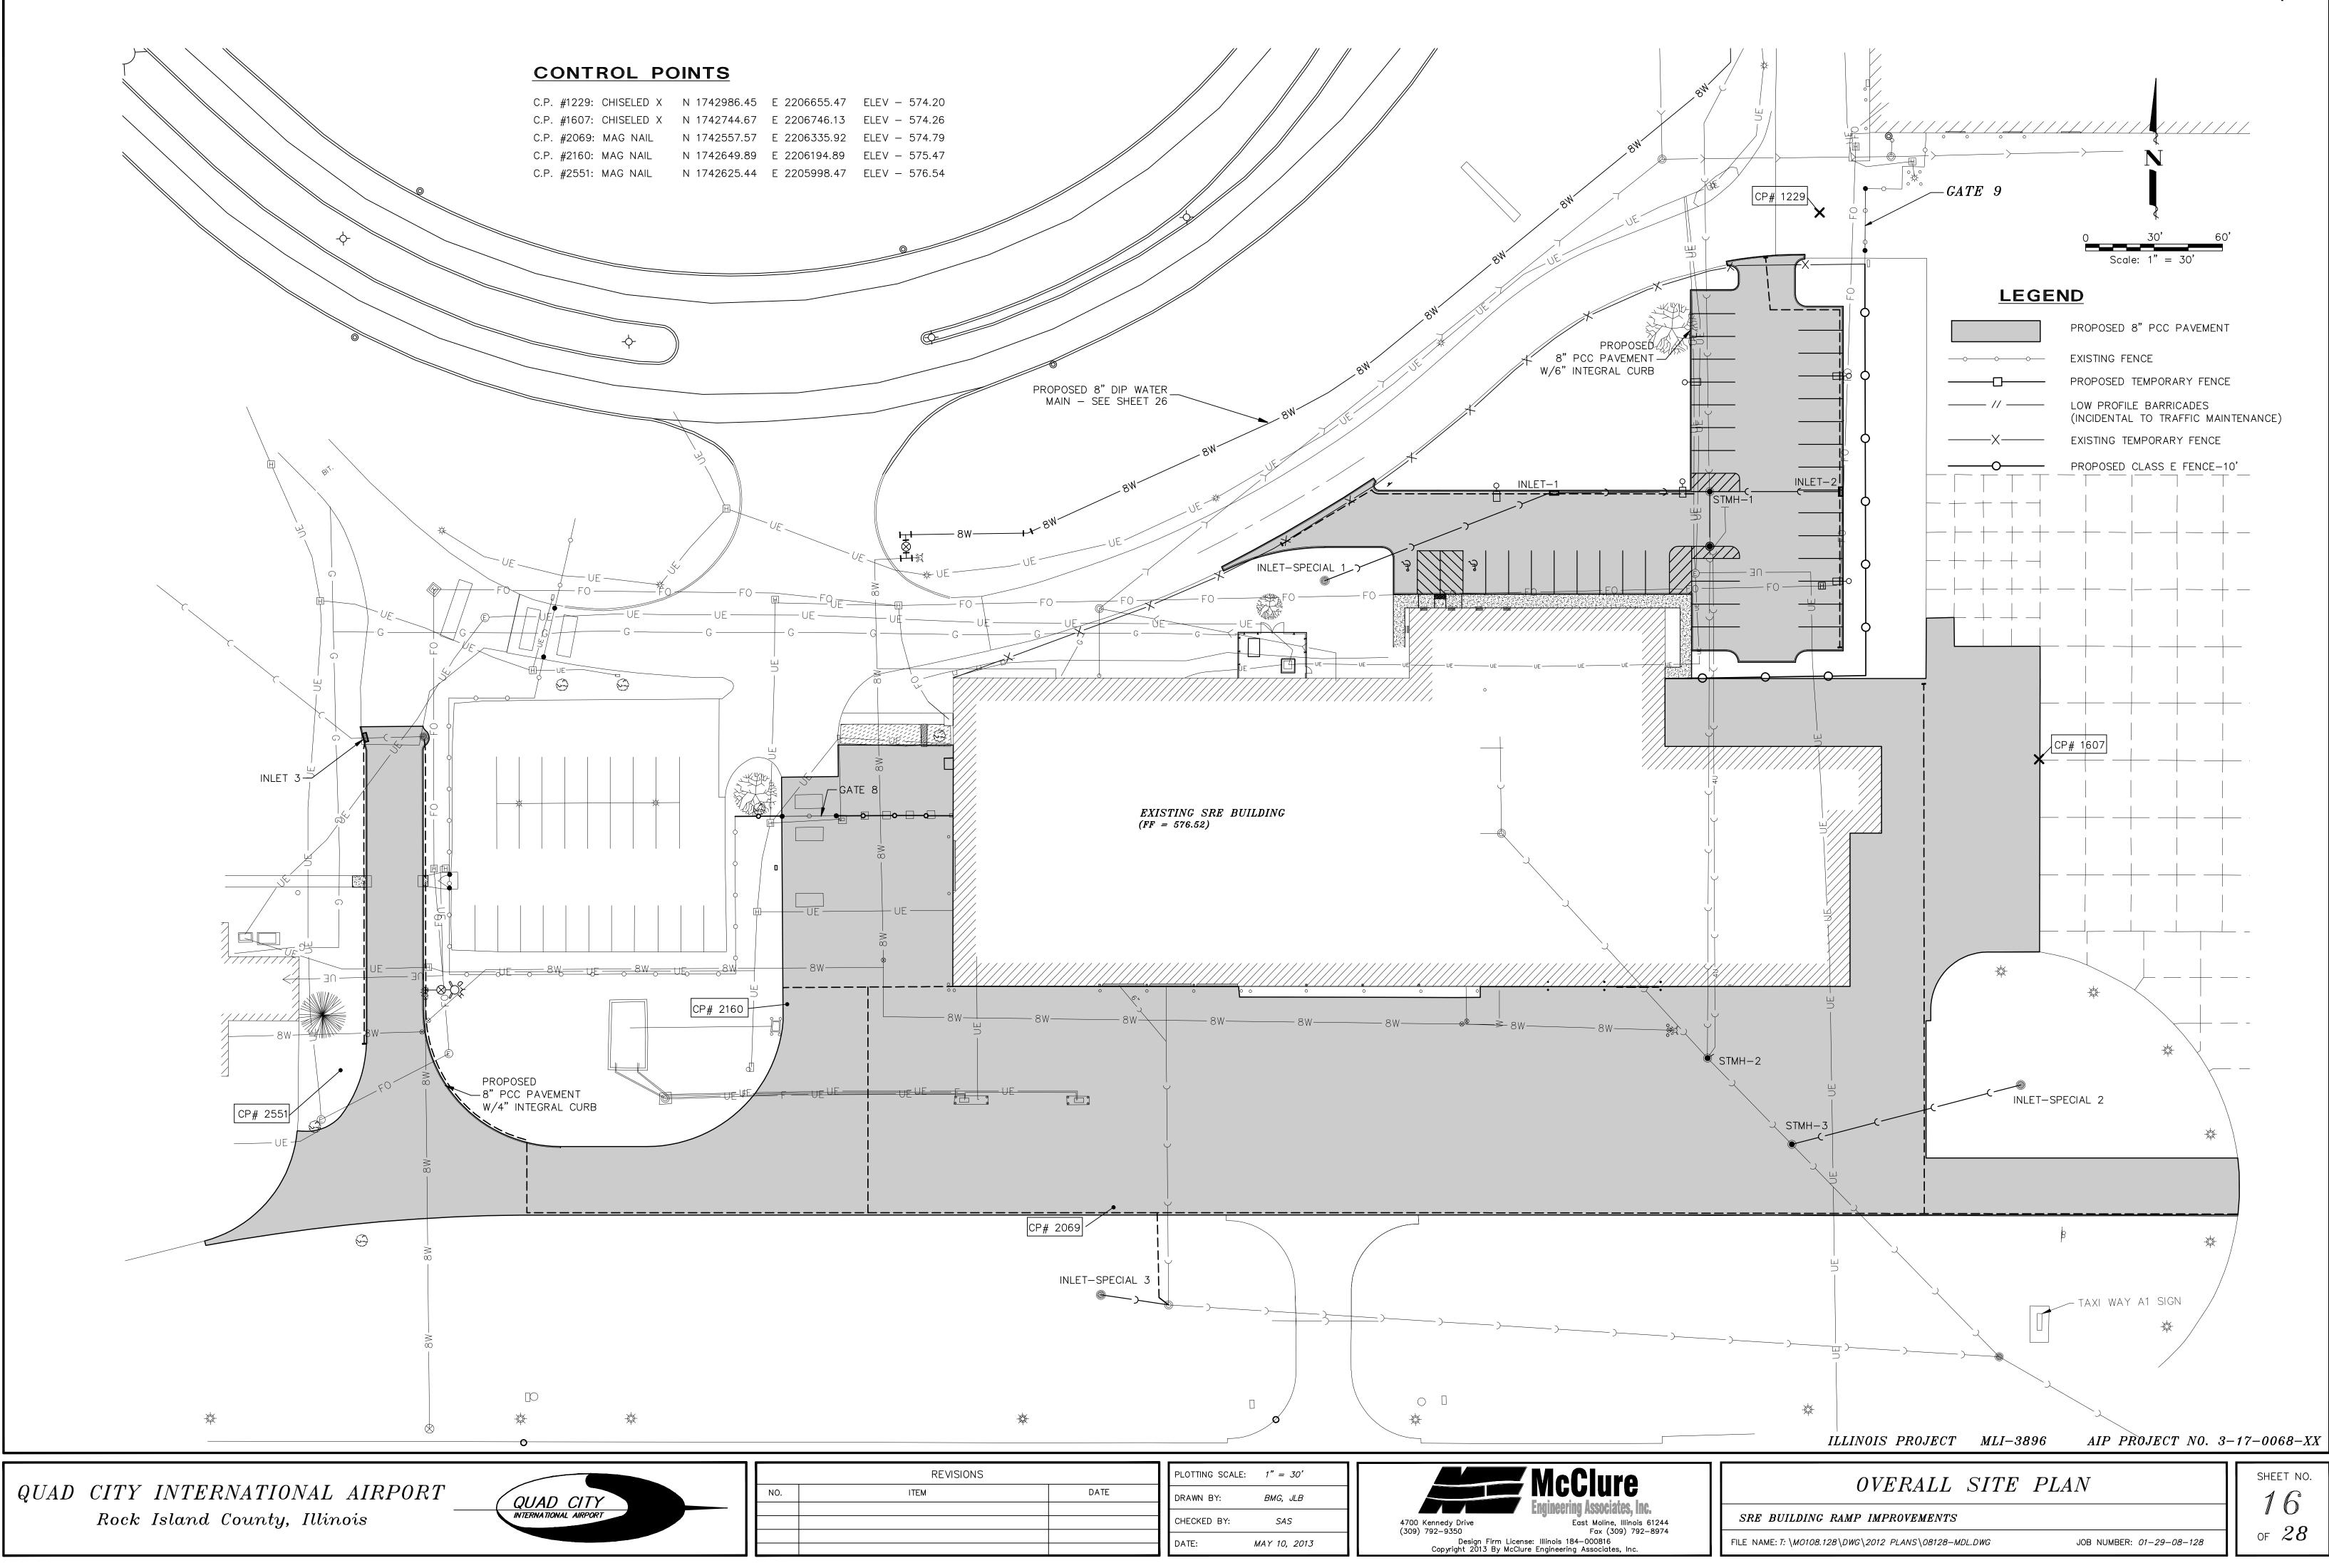





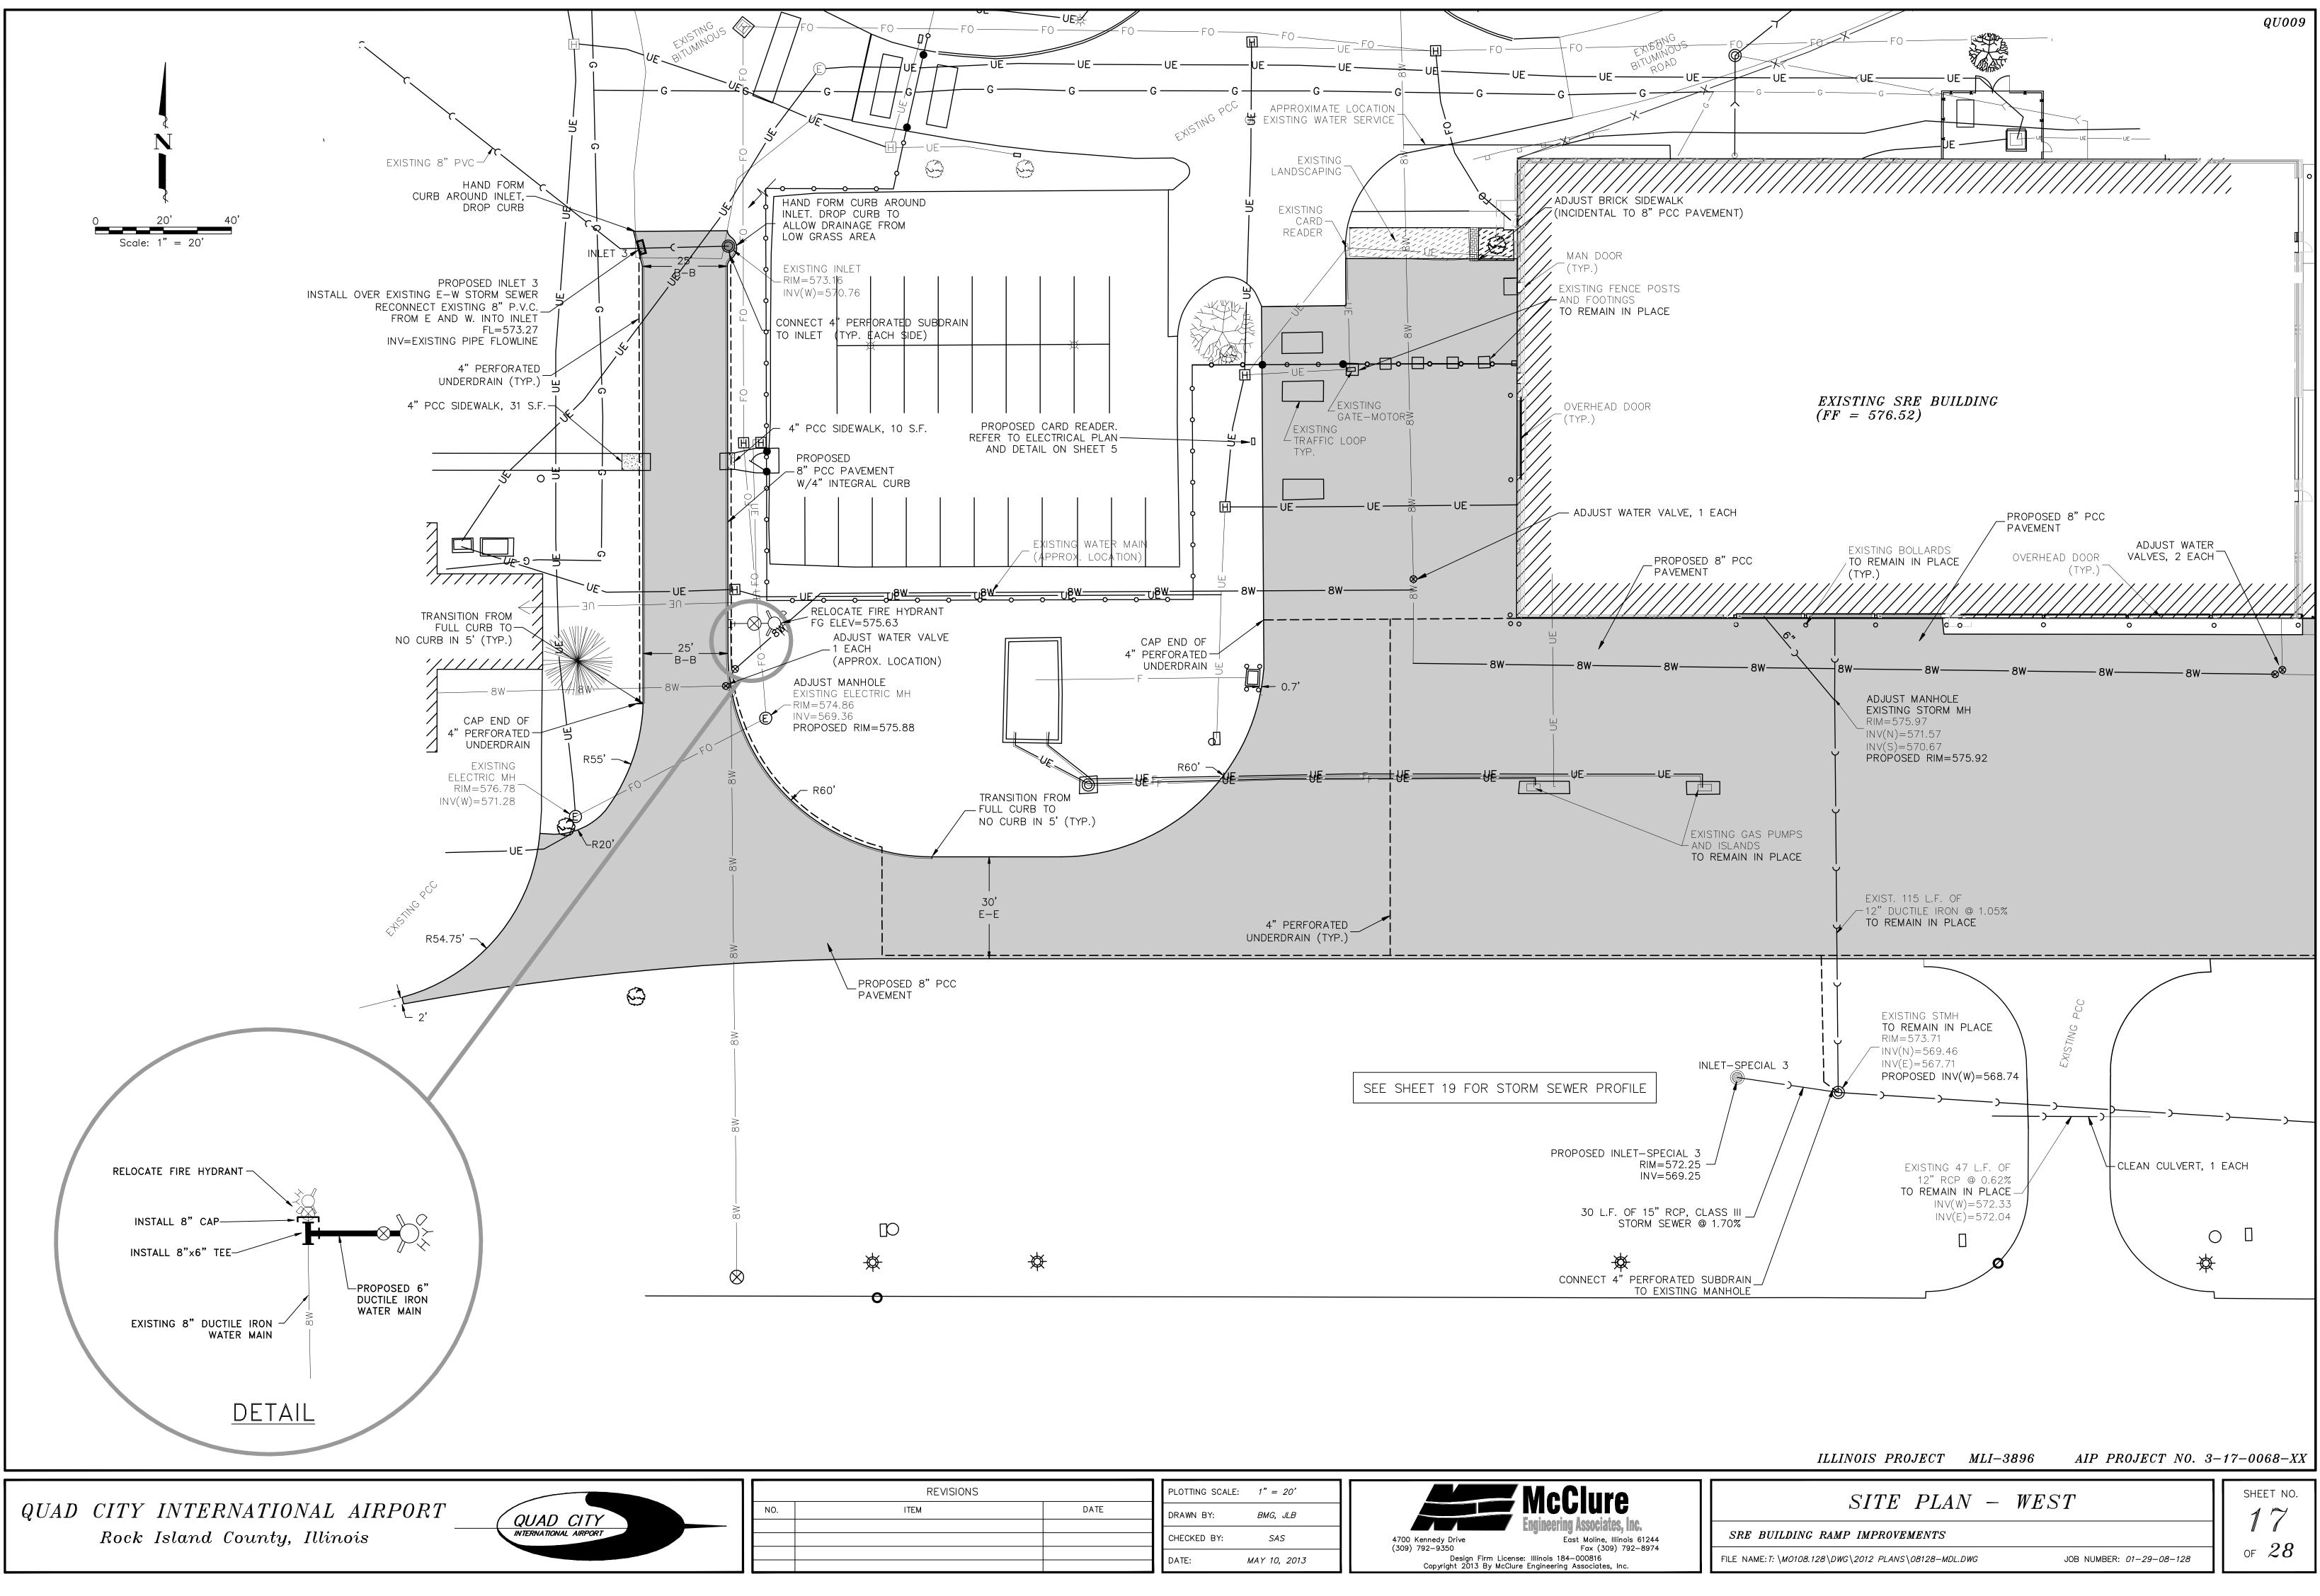


	REVISIONS		PLOTTING SCALE: $1'' = 20'$	McClure
NO.	ITEM	DATE	DRAWN BY: BMG, JLB	
			CHECKED BY: SAS 4700 Kenr (700) 700	
			(309) 792 DATE: MAY 10, 2013	—9350

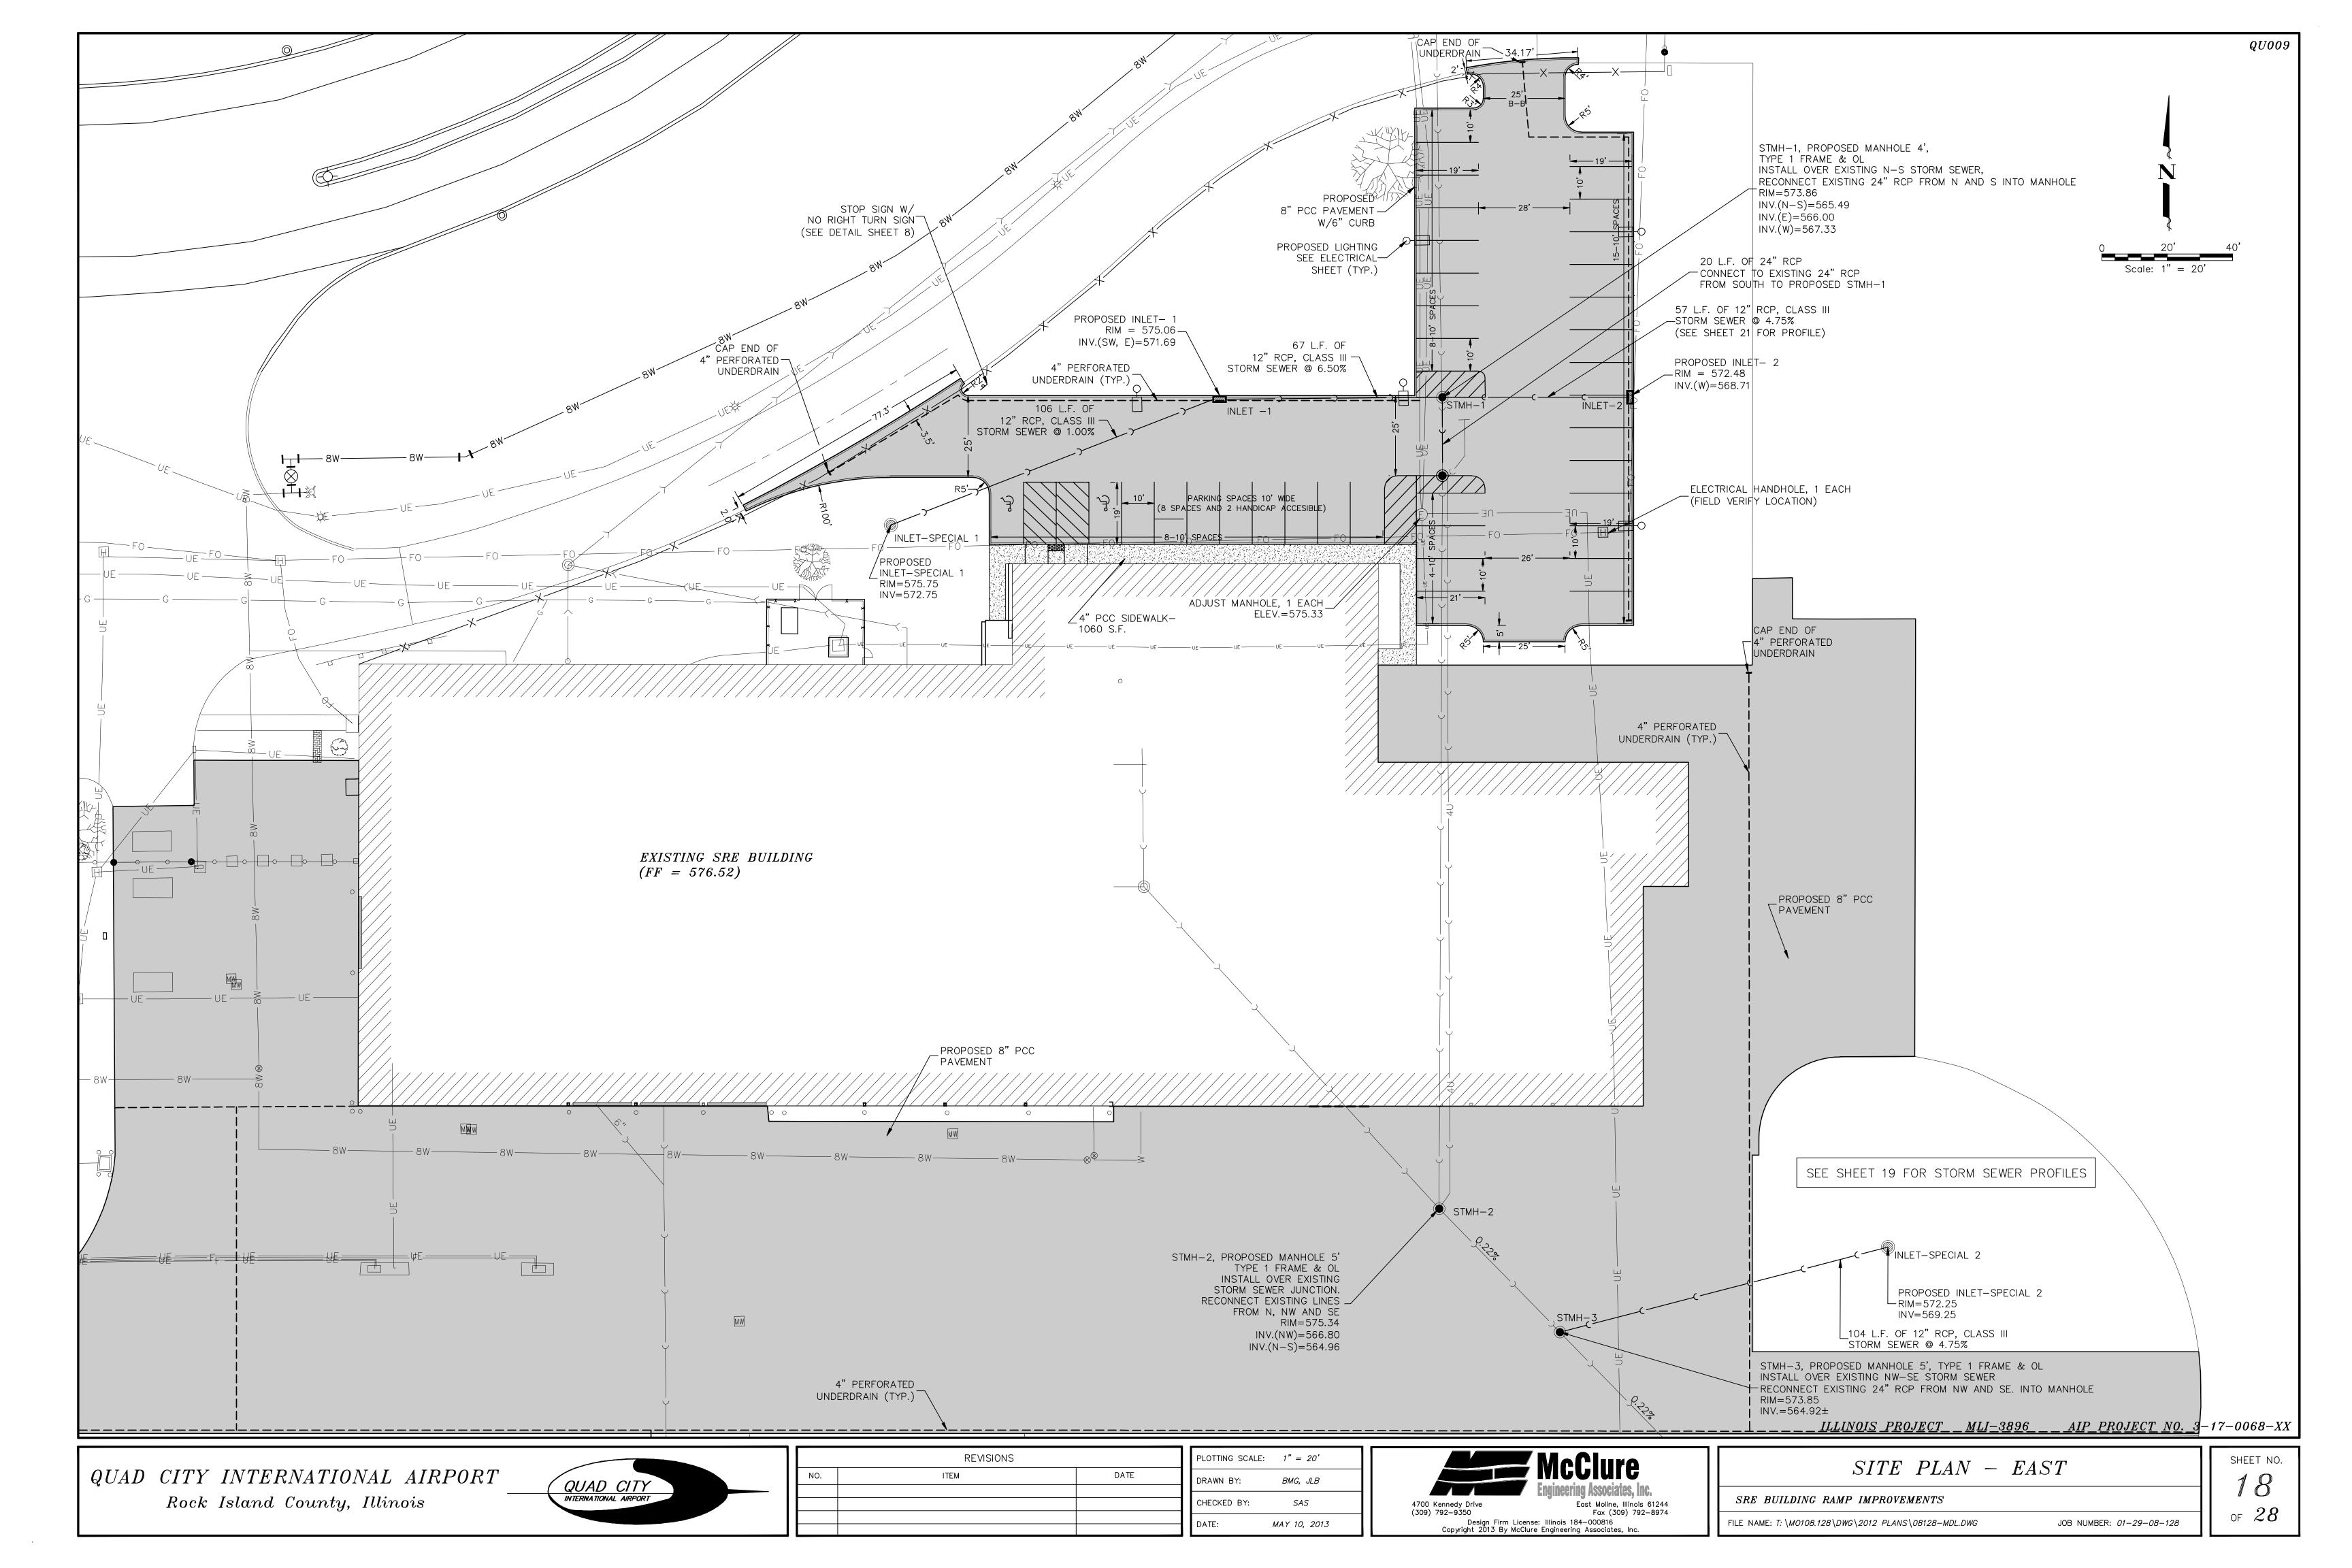


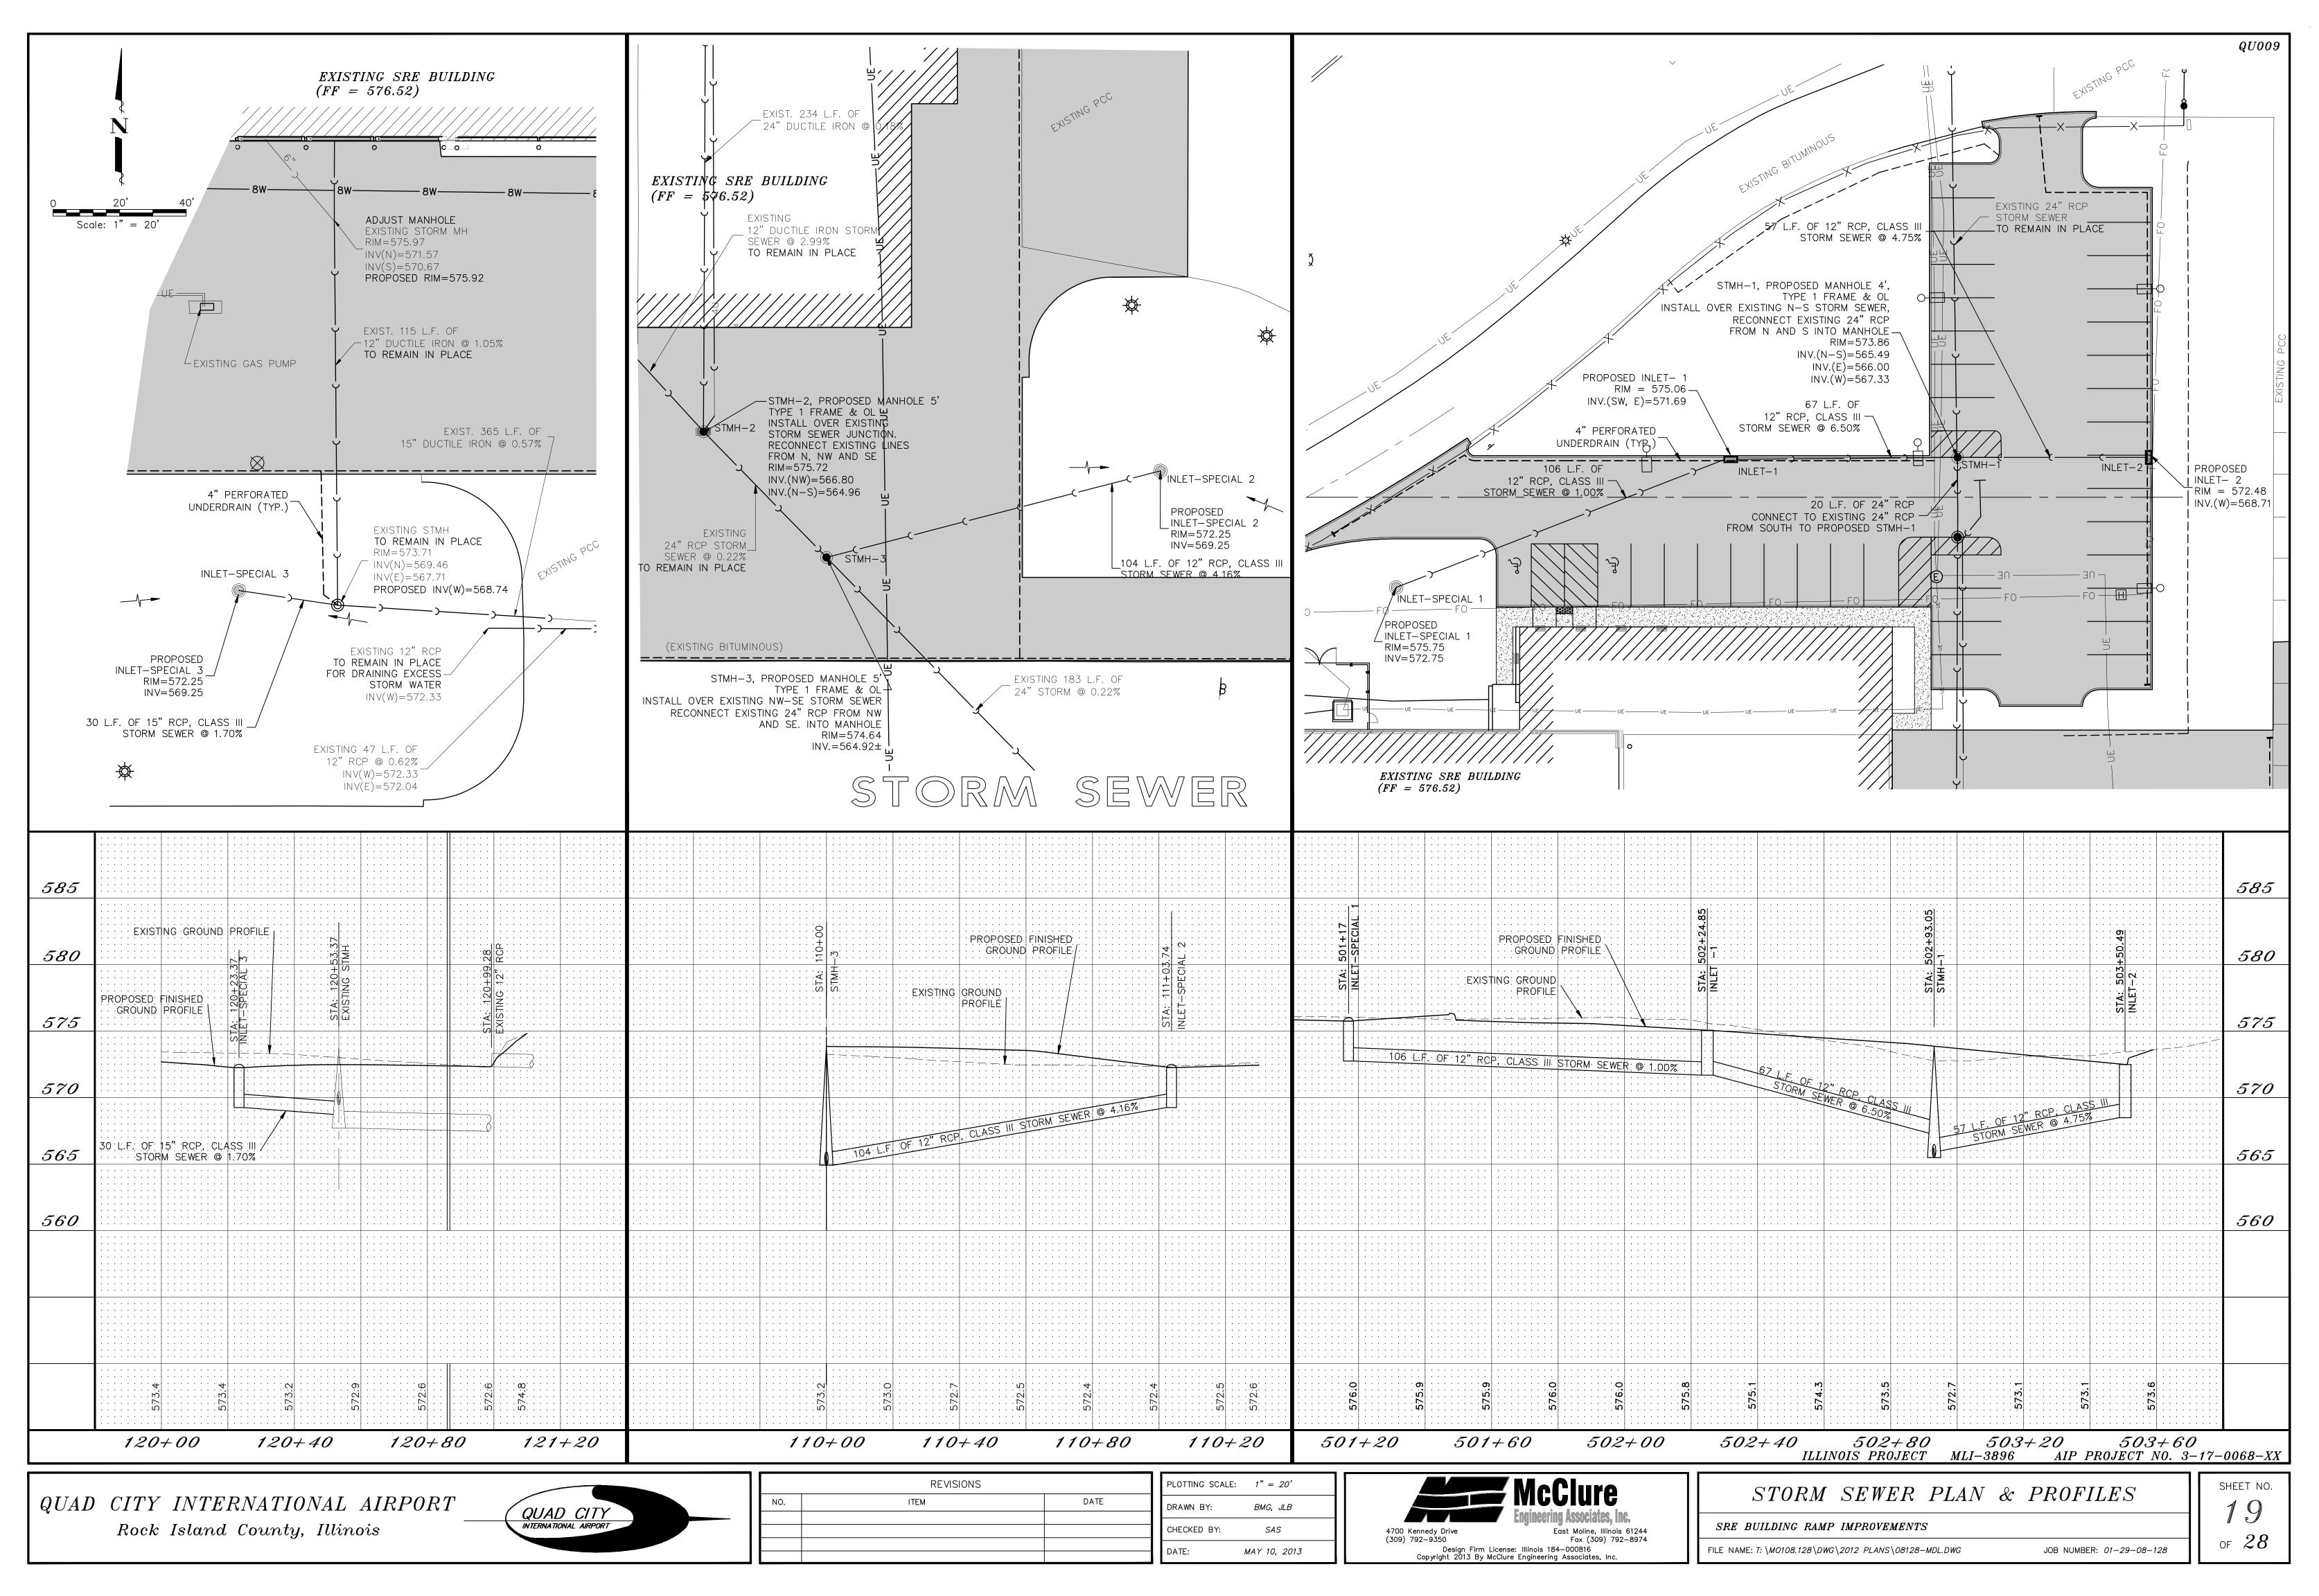

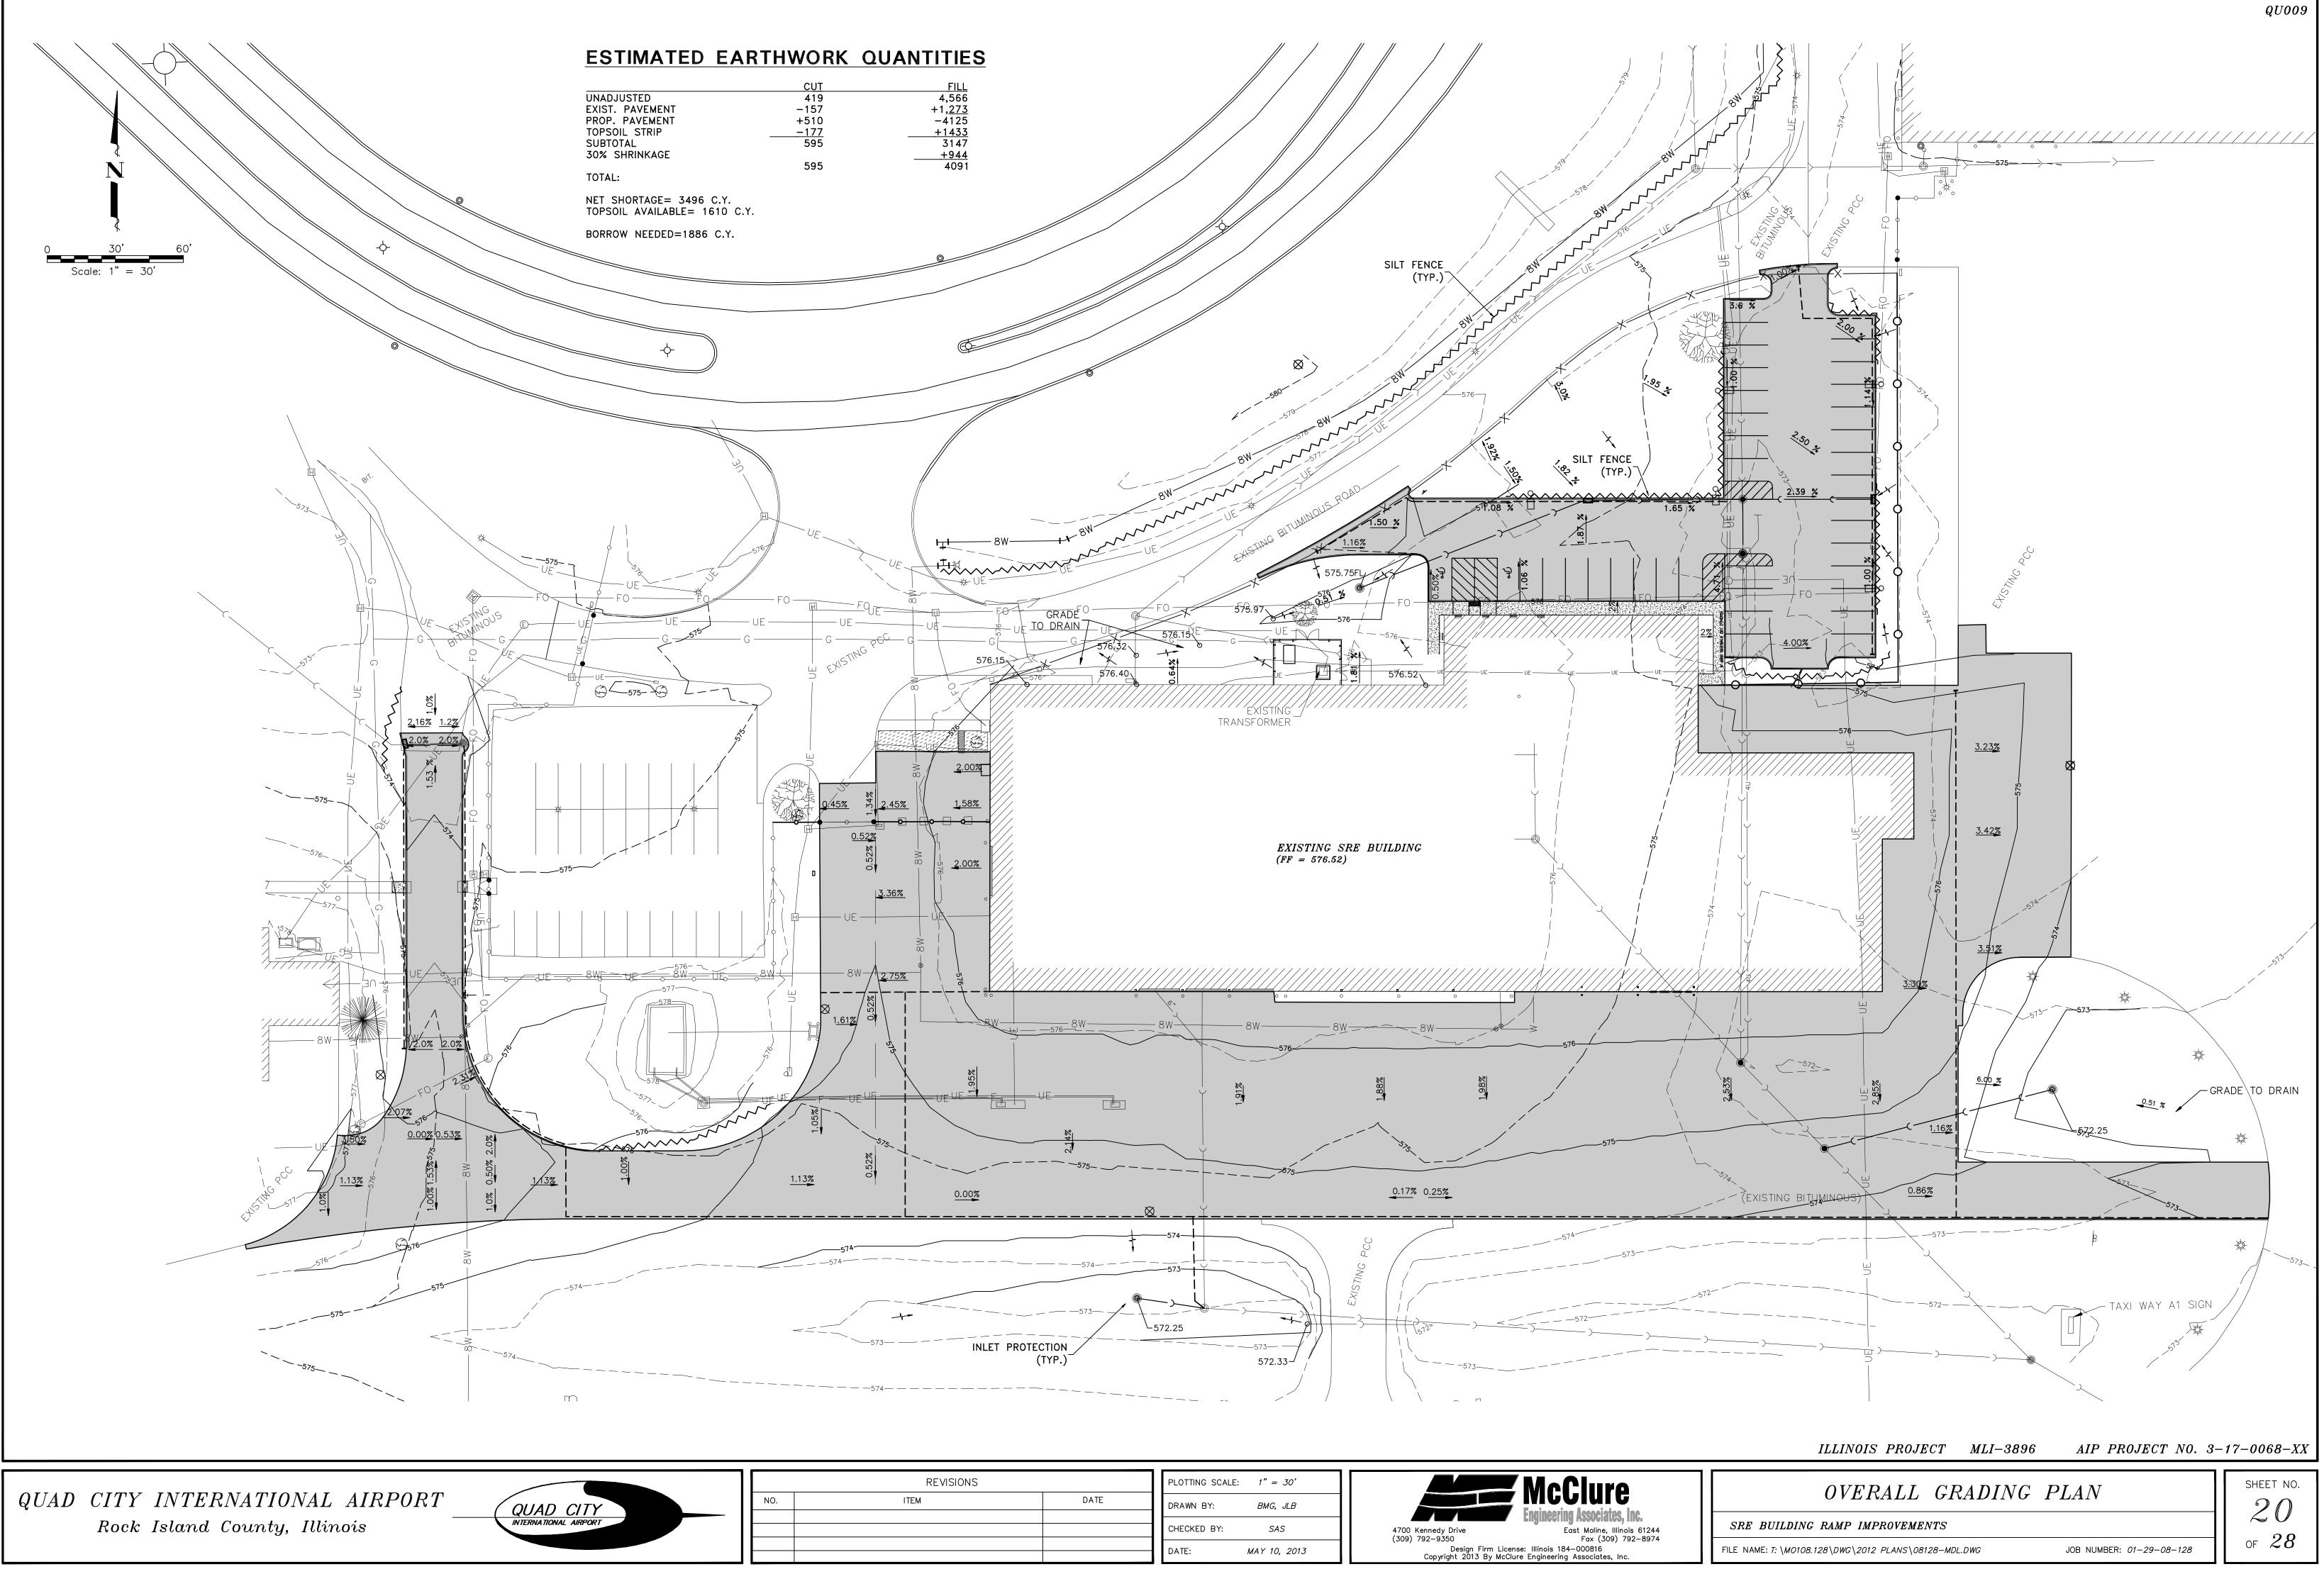

			_			
	REVISIONS		PLOTTING SCAL	E: 1" = 30'		MaClure
).	ITEM	DATE	DRAWN BY:	BMG, JLB		
			CHECKED BY:	SAS	4700 Kennedy Drive	Engineering Associates
			DATE:	MAY 10, 2013	– (309) 792–9350 Design Firm License Copyright 2013 By McClure	Fax (309) e: Illinois 184–000816 e Engineering Associates, Ir
						Engineering Associates, in

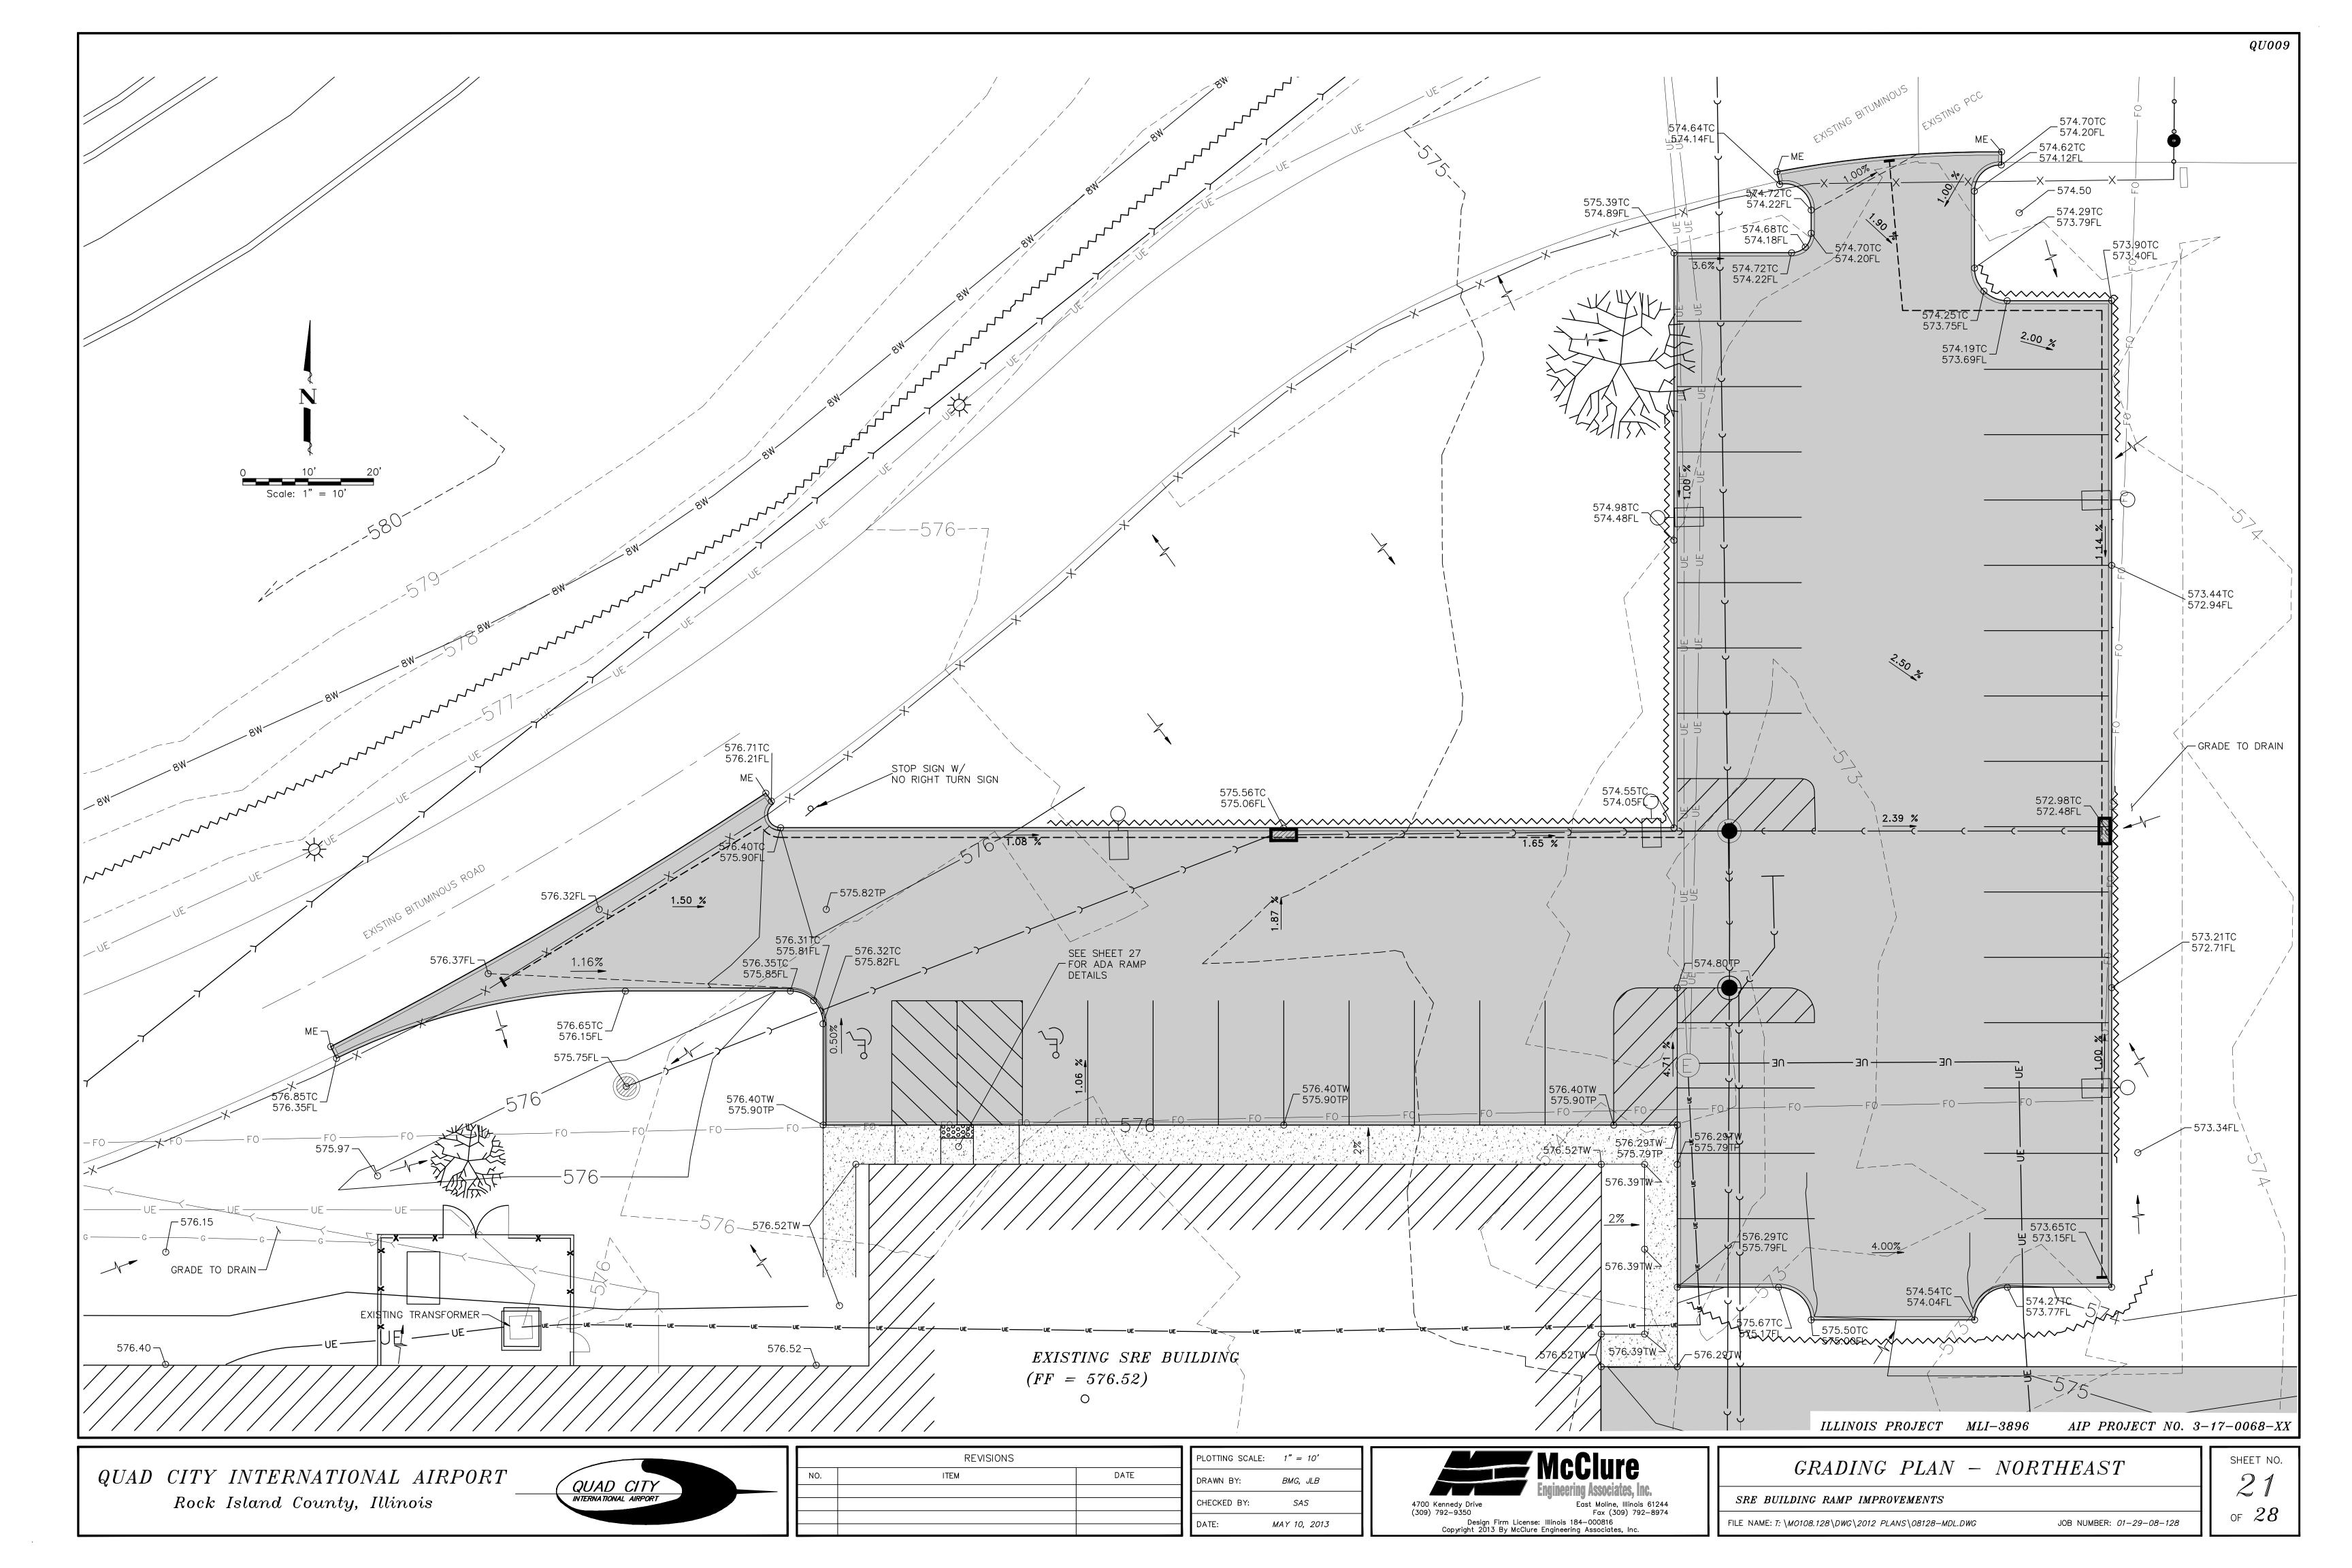

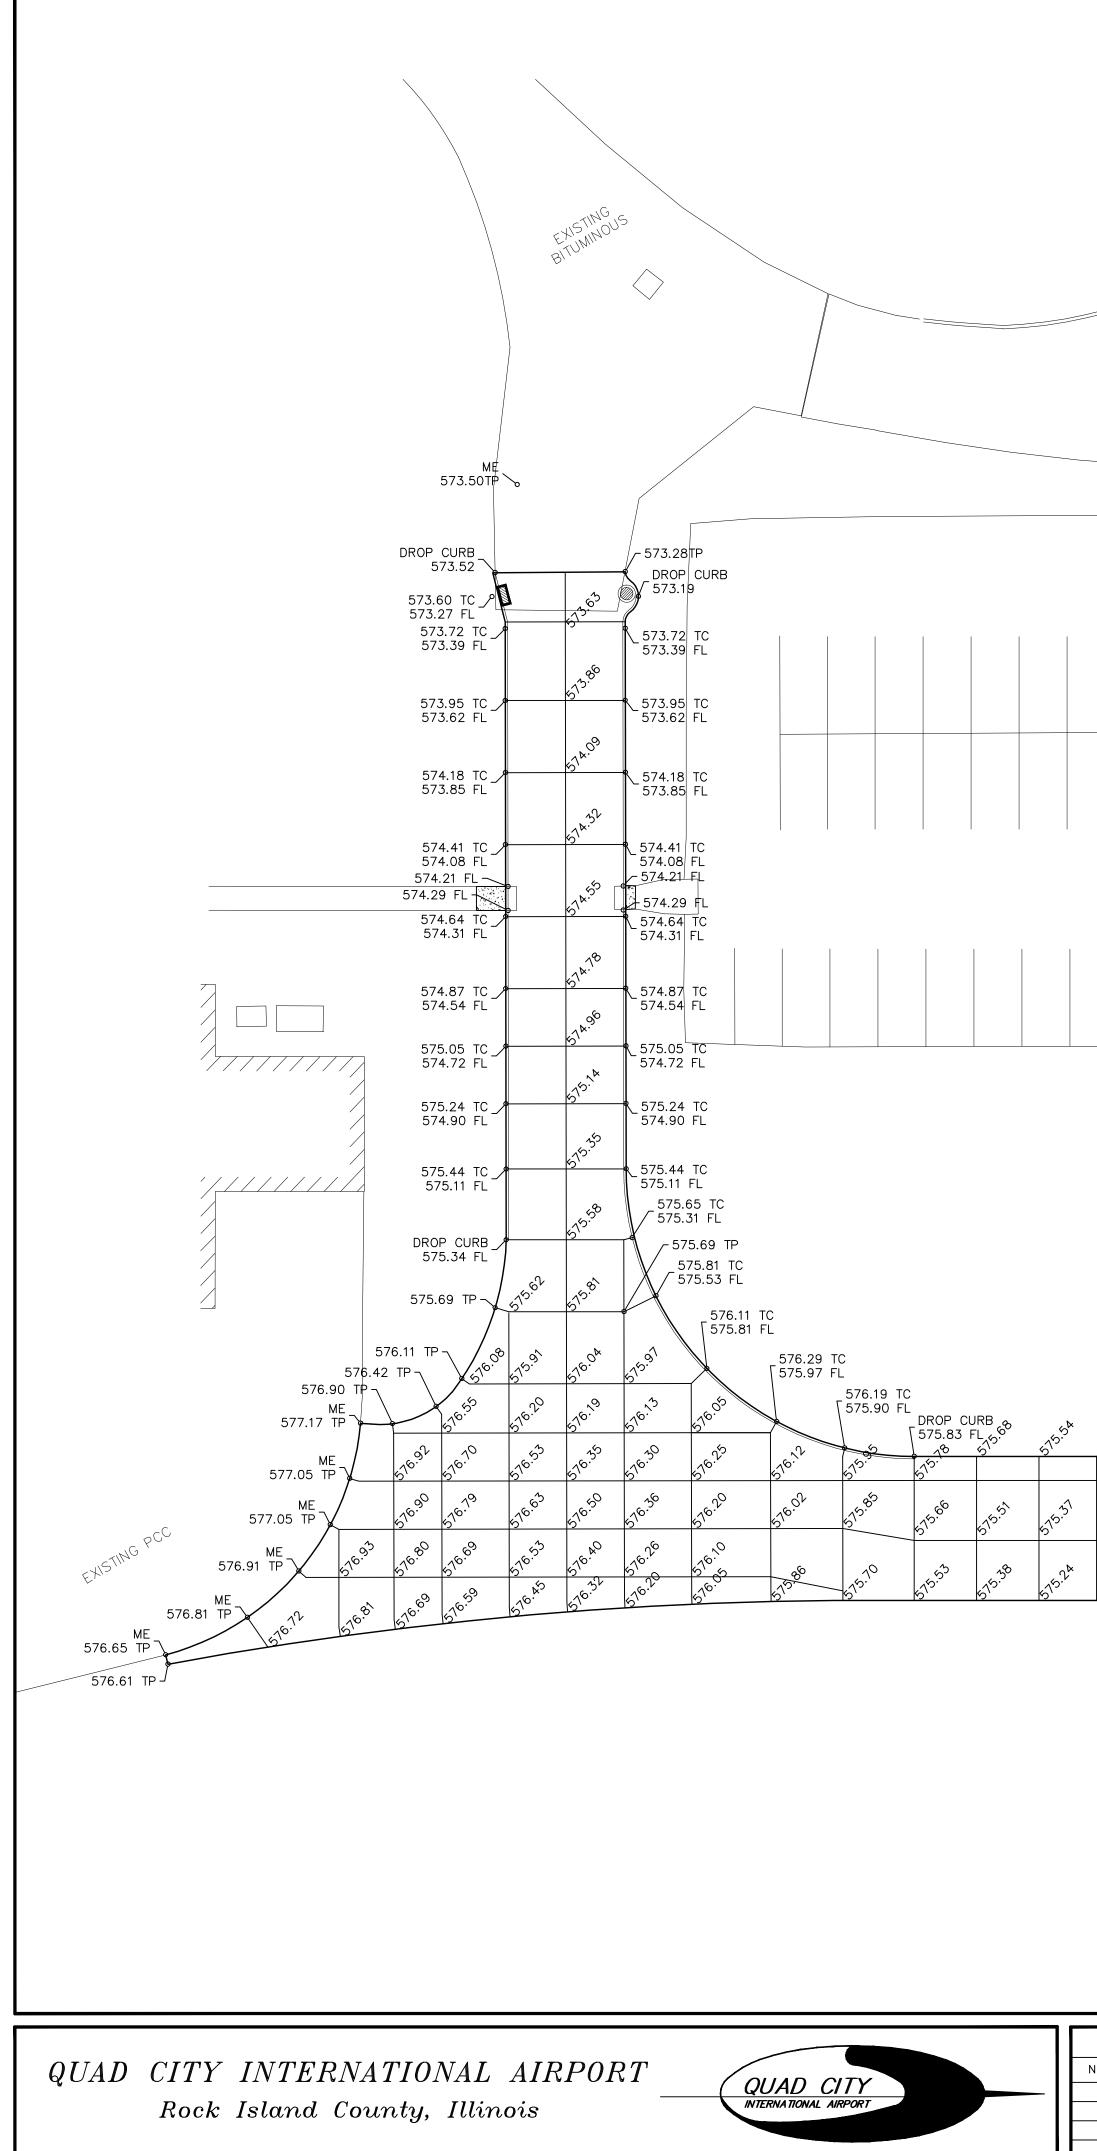


E	XISTING PCC	EXISTING B	ITUMINOUS ROAD
	575.57TP 575.63TP 75.55 TP 575.63TP	576.40 TP 576.40 TP 576.52 TP 576.22 TP 576.25 TP 576.25 TP 576.15 TP 576.15 TP 576.15 TP 576.15 TP 576.15 TP 576.15 TP 576.15 TP 576.15 TP 576.25 TP 576.15 TP 576.15 TP 576.15 TP 576.15 TP 576.25 TP 576.15 TP 576.15 TP 576.15 TP 576.25 TP 576.15 TP 576.15 TP 576.25 TP 576.15 TP 576.25 TP 576.25 TP 576.25 TP 576.15 TP 576.25 TP 576.25 TP 576.15 TP 576.55 TP 576.25 TP 576.55 TP 575.26 TP	EXISTII FF ELE

EXISTING SRE BUILDING FF ELEV.=576.52

		·	
REVISIONS		PLOTTING SCALE: $1'' = 20'$	
ITEM	DATE	DRAWN BY: BMG, JLB	
			Engineering Associates
		CHECKED BY: SAS	4700 Kennedy Drive East Moline, Illi (309) 792–9350 Fax (309)
		DATE: MAY 10, 2013	Design Firm License: Illinois 184–000816 Copyright 2013 By McClure Engineering Associates, I



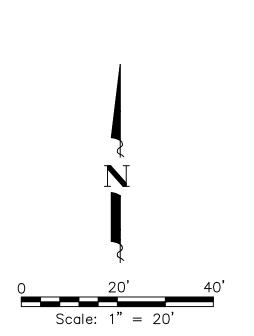


 ILLINOIS PROJECT
 MLI-3896
 AIP PROJECT NO. 3-17-0068-XX

 PAVEMENT JOINT ELEVATION PLAN - WEST
 SHEET NO.

 SRE BUILDING RAMP IMPROVEMENTS
 22

 FILE NAME: T: \M0108.128 \DWG\2012 PLANS\08128-MDL.DWG
 JOB NUMBER: 01-29-08-128

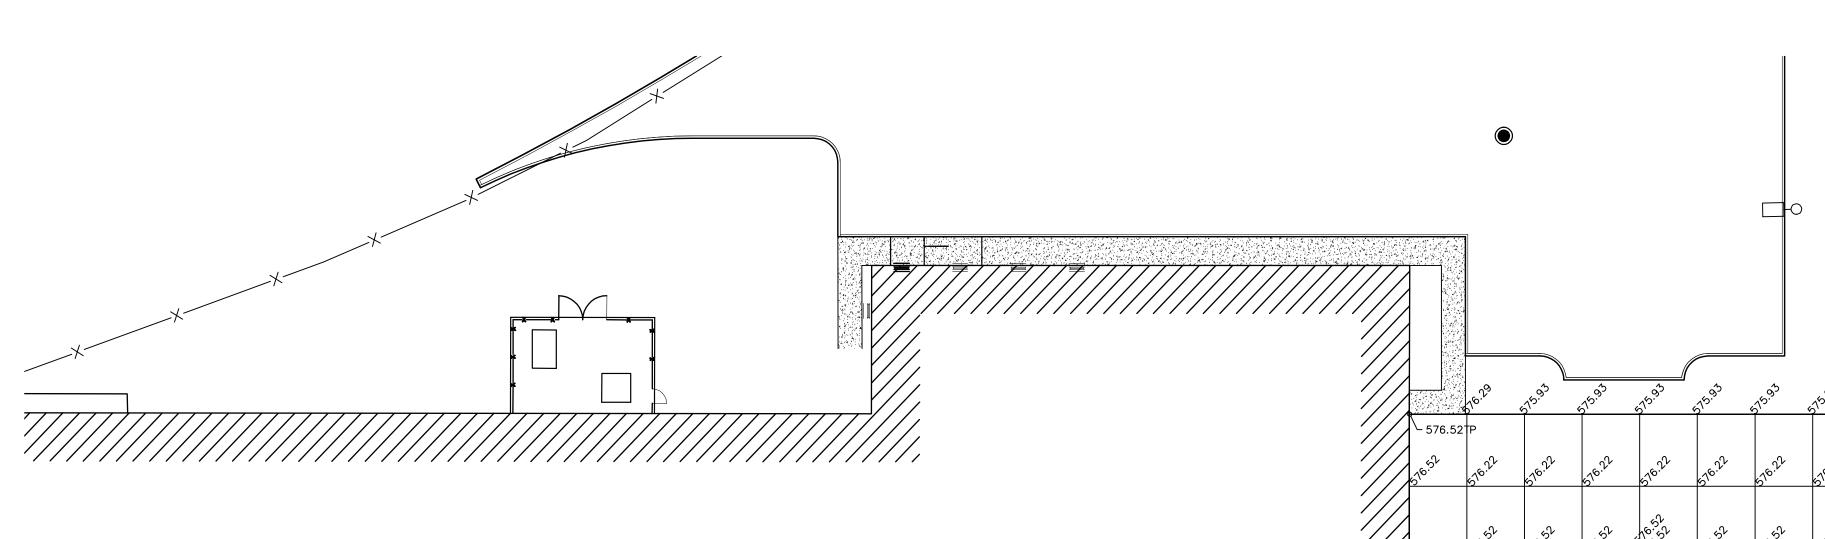

	_ 576.	.40TP 576	6.40TP / ⁵⁷⁶	.40TP	576.	40TP	.40TP _ 576.4	40TP /	/	ME 576.52TF ME					ME 576.38TP	~													610. ⁵²
				576.521				576.46		576.38TF																			510.52
	576.30		576.30	-576.43	576.30	576.31	576.31	576.31	V								▶												
	510.0°	-W8 -60	510.00	670.10	510.09	510.0	W 570.2	510 ^{.1} 8W	50°.	516. 51	16. 16.	510.03	510. S10.	5 ^{10.}	5 ^{10.}	10. 00.		576.20	510.20	576.0	510.0	510.0	510 ^{.5}	576.14	510 ^{.73}	510.2	5 ^{76.}	570.0	510.09
$\widetilde{\mathcal{S}}$	51 ^{59.}	51 ^{5.82}	515.82	51 ^{5.92}	51 ^{5,84}	61 ^{5,61}	5 ⁶⁰		5000 NO	51 ^{50.91}	in in in in iteration in the interview of the interview o	51 ^{69.}	5 ¹⁰ .00		51 ^{50.}	61 ^{(6).}	515. 515.	50 ⁵⁰	51 ^{69.}	50 ⁵⁰ .	51 ^{50.00}	515.81	5 ⁽⁵⁾	6 ⁵³	515.8°	515.00	51 ^{55.}	6 ^{15.11}	515.15
EET	51 ^{55.51}	51 ^{55.51}	51 ^{55,57}	5 ⁵⁰	ST ^{SS.}	51 ^{50.65}	51 ^{50.01}	51 ^{55.}	515.1A	57 ^{57.15}	515.1×	51 ^{53.13}	515.1×	575.15	515.13	515.10	51 ⁵⁰	5000 CON	51 ^{50.}	50. 50. 50. 50. 50. 50. 50. 50. 50. 50.	5 ^{15.61}	st ^{ron}	51 ^{65.50}	50 ^{65.1}	50. 50 ⁵⁰	STS. AS	51 ^{55.}	51 ^{57.45}	515. A
SHI	515.3	575.3	20 20 20 20 20 20 20 20 20 20 20 20 20 2	1070 50 50	515.3ª	515.42	57 ^{15.4^k}	51 ^{(5).}	50 50 F	51 ^{5,53}	51 ^{55.6}	515.00	55.5	51 ^{55,52}	515.0	51 ^{55.47}	515.44	51 ^{50.}	ST ^{SS.}	51 ^{(5).}	575.3ª	51 ⁵⁰	51 ^{59.21}	51 ^{69.13}	515. 51	515. 6	515. V	515.10	515.01
EE	51 ^{59.059}	515.05	515.05	575.0	51 ^{50.09}	51 ^{5,20}	515.22	515.26	500 - F	51 ^{55.}	30 31 ^{55.}	515.27	51 ^{57.28}	515.0	515.21	575.23	51 ^{52.0}	51 ⁵⁰ .	51 ^{50.}	5 ¹⁵¹	515.06	51 ⁵⁰	51 ^{4.91}	51 ^{4.05}	60 50 ×.	51 ^{k.}	50°.	51 ^{A.1}	51 ^{x.}
Ś	STA.	57 ^{4.79}	51 ^{4.00}	65 55 ×.	51 ^{4.09}	51 ^{4.91}	5000 50 ^{(k.}	\$^ ⁵⁰	50°.	51 ^{50.09}	51 ^{55.}	515.0A	51 ^{50.06}	515.07	515.0 ^A	51 ^{A.} .	51 ^{4.95}	57 ^{4.0}	51 ^{×.0}	67 ^{4.05}	51×.78	51 ^{4.75}	51 ^{4.67}	51×62	50 50 ^{×.0}	51 A.	514.A1	STA.	50 50 50
	51 ^{A.50}	57 ^{4.50}	51 ^{k.}	51 A.	51 ^{4.00}	57 ^{A.72}	57 ^{4,76}	51 ^{4.19}	302 57 x.	51 ^{4.06}	51 ^{4.84}	51 ^{k.}	57 ^{4.82}	51 ^{4.84}	51×.	57 ^{4.74}	574.70	5 A.	51 ^{4.62}	61 ^{4.55}	ST A.	57 ^{1,4,5}	51 ⁴	51 ^A	(^{k.}) ^k	51 A.	50 A.	51 ^{4.0}	50.53 51 ^{4.}
	57 ^{12.}	51 ^{A.A.}	57 ^{4.43}	57 ^{4.}	574.27	51 ^{4.50}	51 ×.52	51 ^{×.}								50 A.	51 ^{A.AA}	50° 50 ^{1.}	51 ^{A.}	574.21	51 ^{4.20}	514. ³³	51 ^{4.05}	61 ^{1).}	50 ⁵⁰	51.38k	51 ^{5.}	61 ^{3.13}	6 ^{13.61}
							574	ME _/【 .57TP		∫_ME 574.63	TP	∑ ME 574.561	P	∑ ME 574_61 11	ME 574.57TP														


SEE SHEET 2


 \mathbf{C}

QUAD CITY INTERNATIONAL AIRPORT Rock Island County, Illinois

QUAD CITY INTERNATIONAL AIRPORT EXISTING SRE BUILDING (FF = 576.52)

REVISIONS PLOTTING SC	ALE: $1'' = 20'$	McClure
. ITEM DATE DRAWN BY:	BMG, JLB	
CHECKED BY:		Engineering Associates, East Moline, Illino
DATE:	(309) 792–9350 <i>MAY 10, 2013</i> Copyright 2013 By McClu	Fax (309) 79 nse: Illinois 184—000816 ure Engineering Associates, Inc

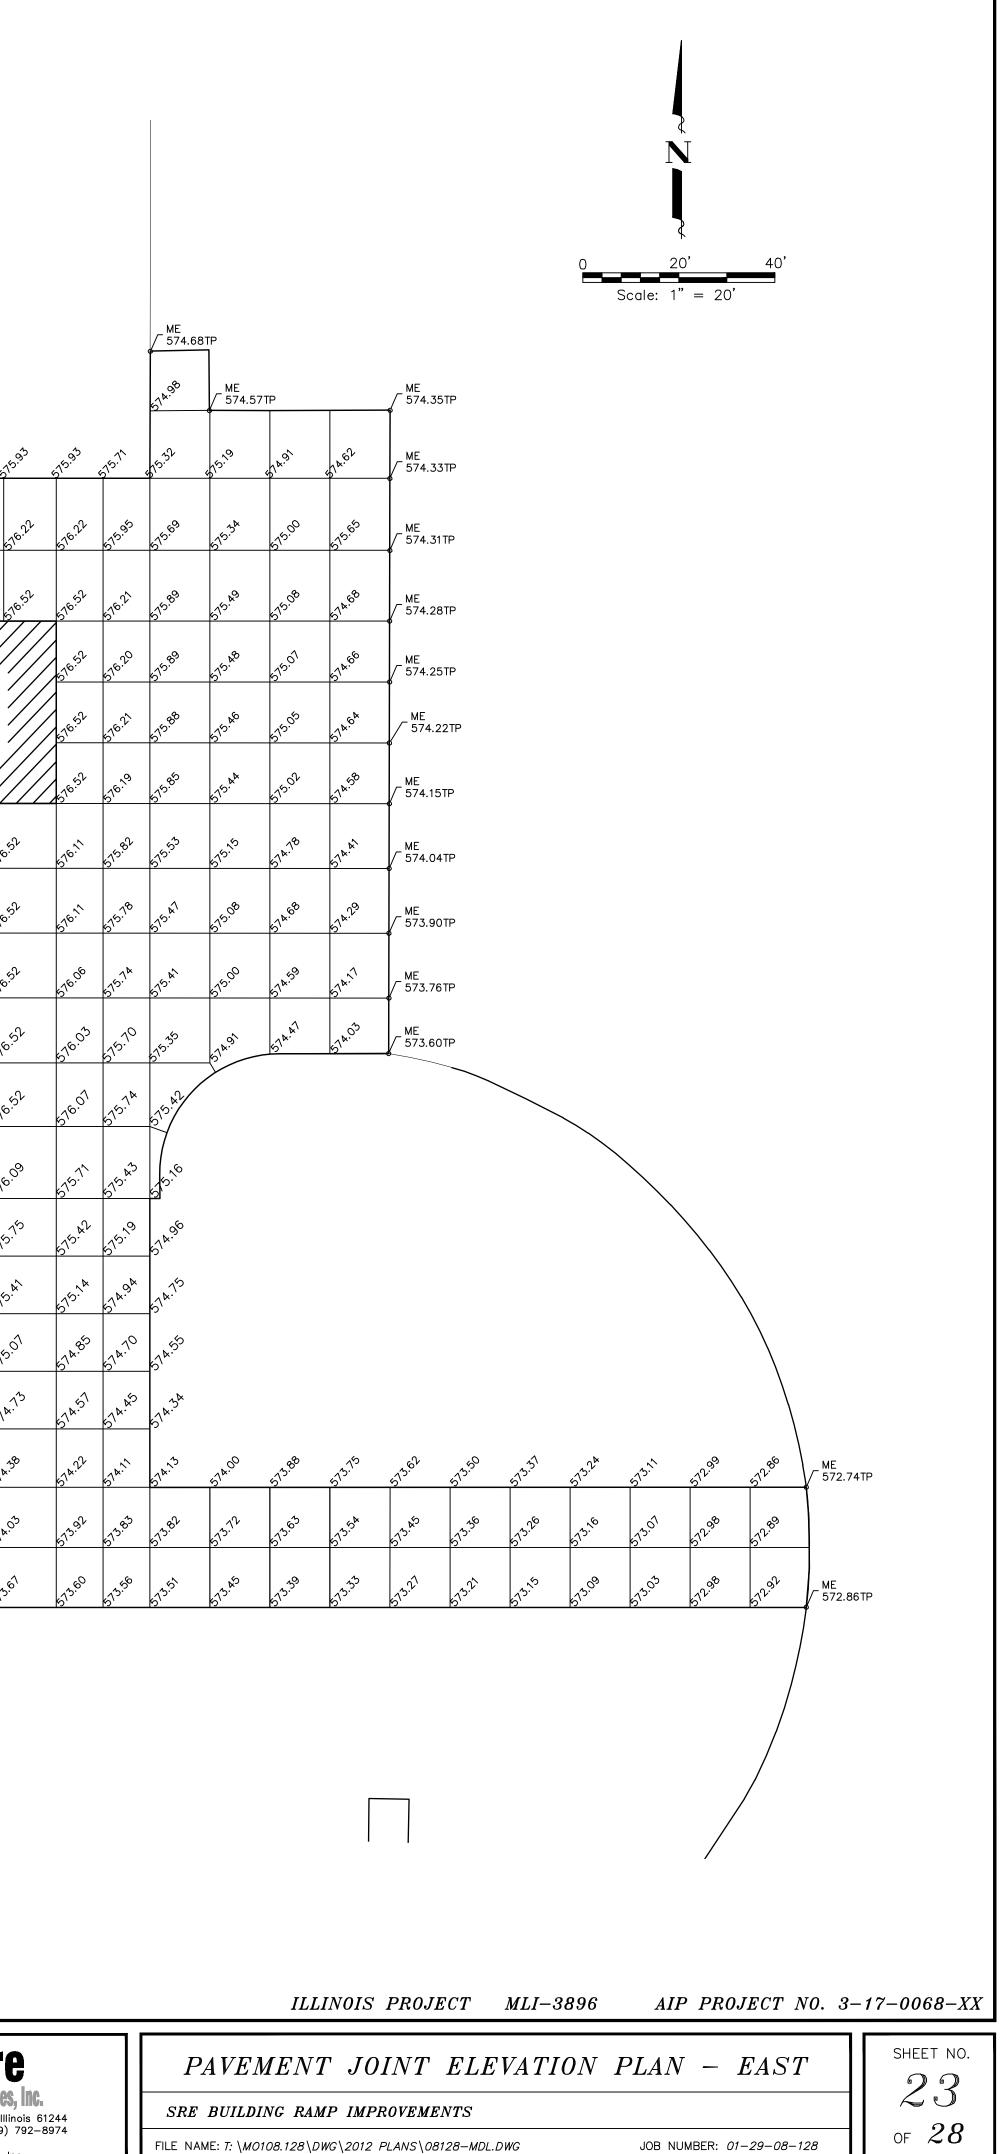

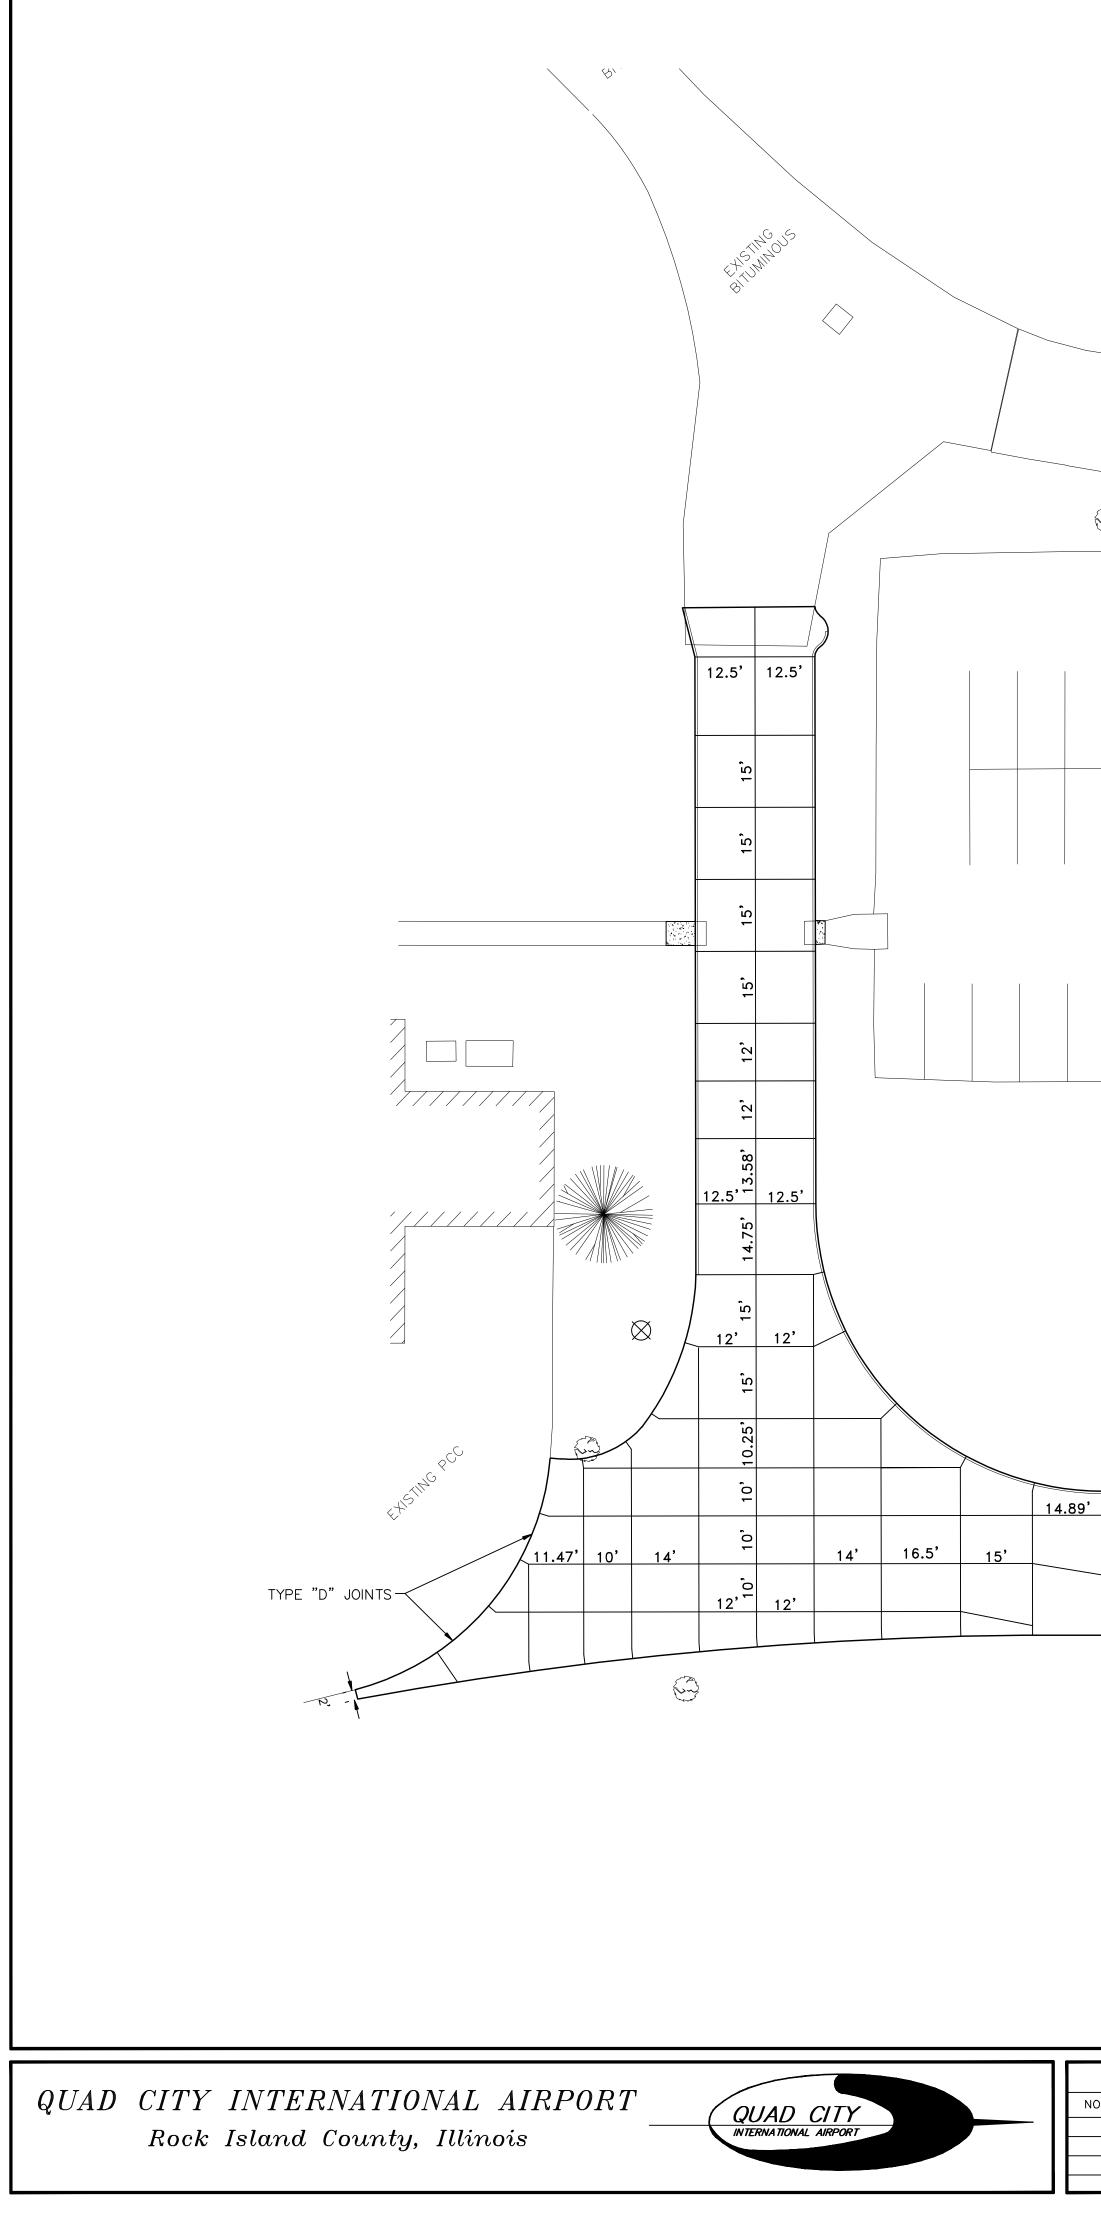


		EXISTING PCC		-17
		TYPE "D" JOINT	13.	
		12.86'	12' 12' 12' 12' 12' 12' 12' 12'	<u>11' 10.36'</u> • • • • •
			12.62' 12.62'	
			8.74' 13' 14.69'	
		× 12.03'	12' 10.35' 9' 8.7	
		12.65' ~	12 [°] 12'12'	11' 10.36'
ىي بر		5, 12.19, 12,		
13' 13' 12'	14.08' 15'	15' 15' 15' 15' 15' 15' 15' 12.65'	12' 12' 12'	11' 10.36'




EXISTING SRE BUILDING (FF = 576.52)

	REVISIONS		PLOTTING SCALE:	1" = 20'		
0.	ITEM	DATE	DRAWN BY:	BMG, JLB	IVICU Engineering As	Ur (
			CHECKED BY:	SAS	4700 Kennedy Drive East	Moline, Illi Tax (309)
			DATE:	MAY 10, 2013	Design Firm License: Illinois 184–00 Copyright 2013 By McClure Engineering Ass	0816



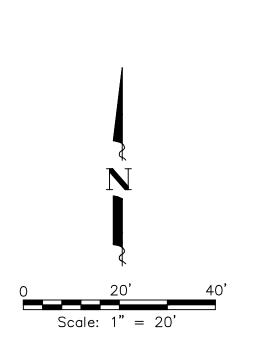

 Interview
 Interview

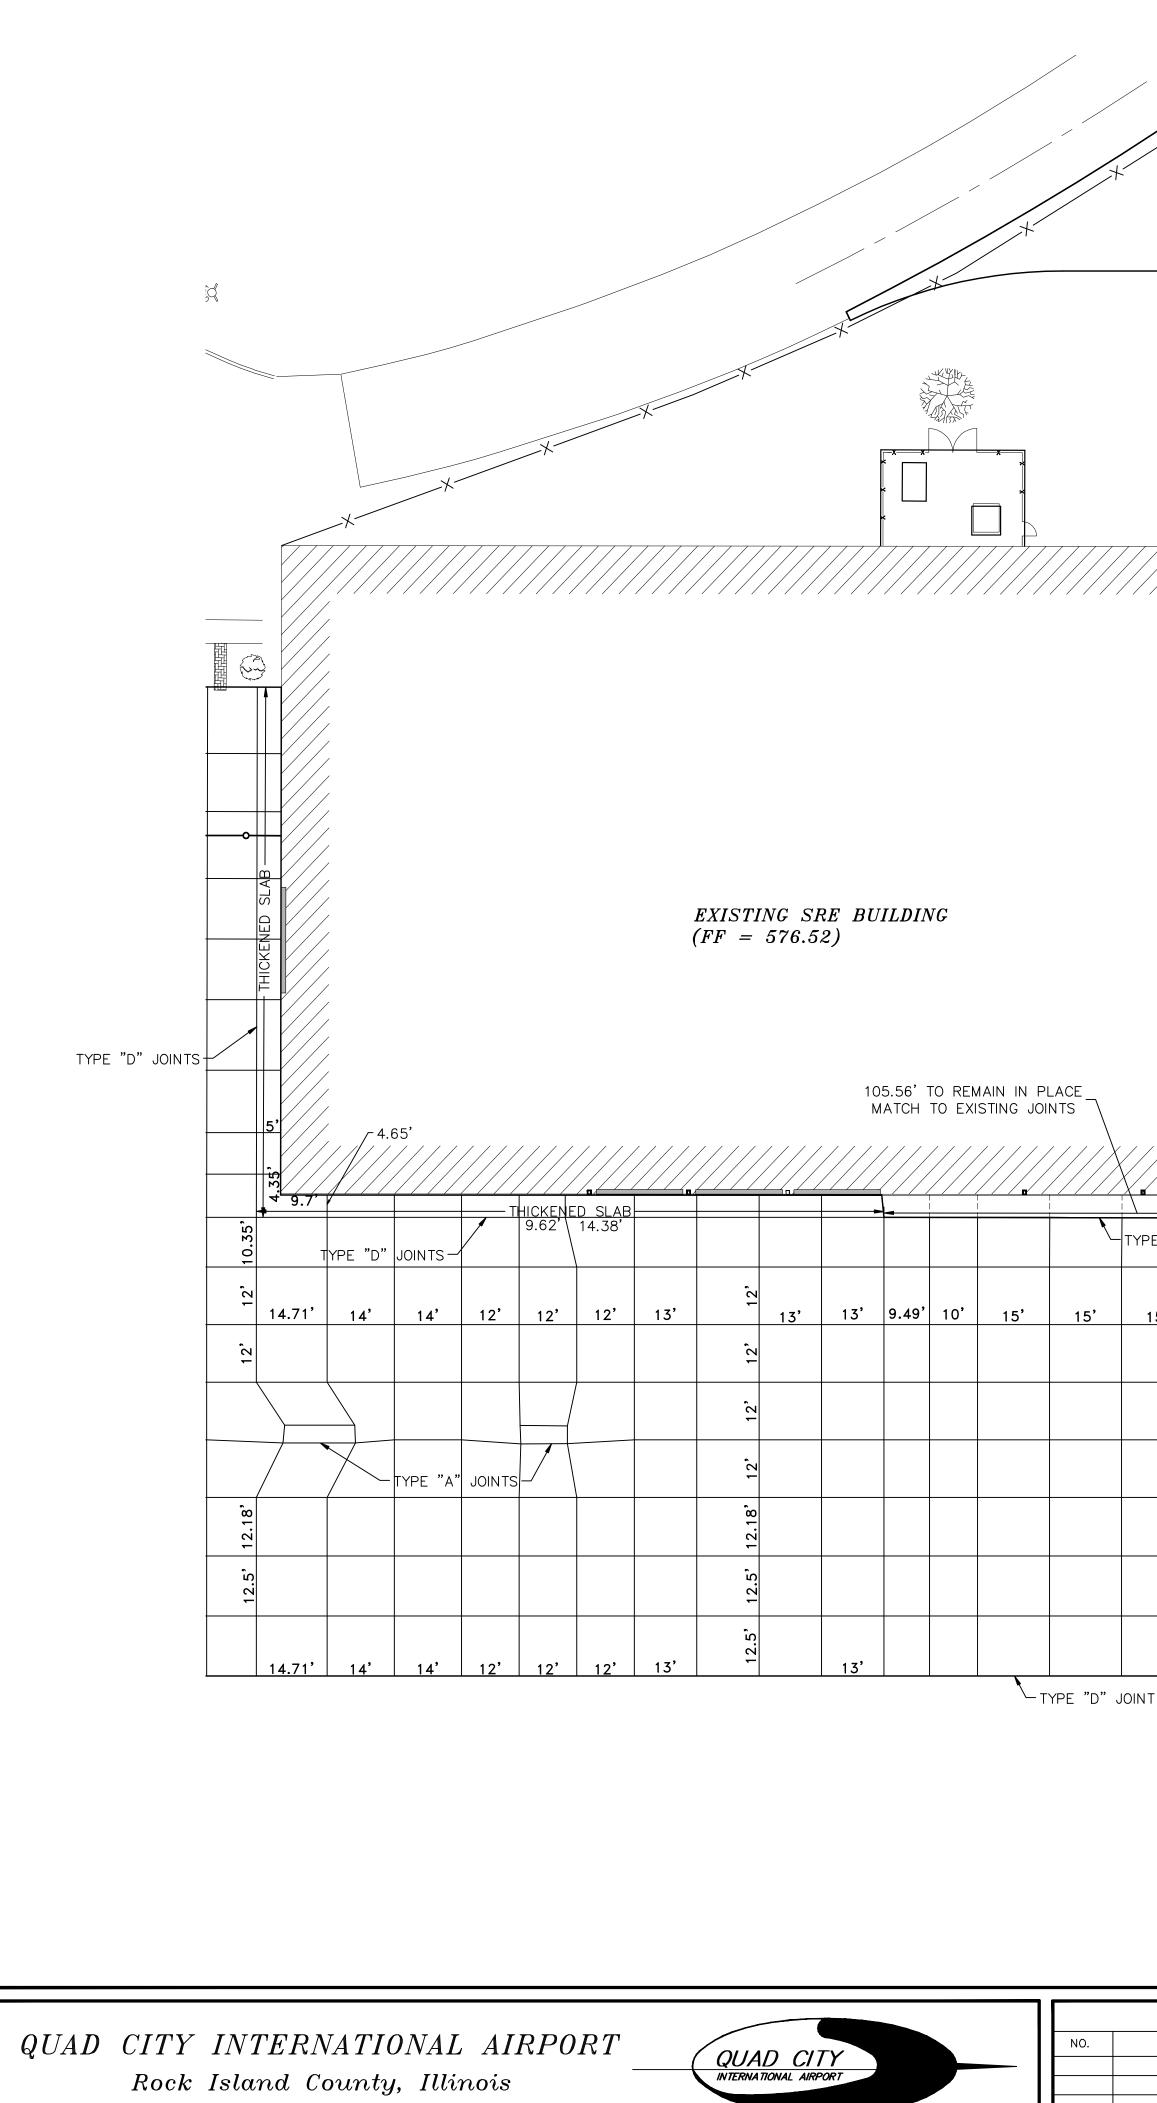


	~//	A	, .																
×		8							PRO	POSED P	CC PARK	KING LOT							
													<u> </u>						
											14.75' 15'					12'	14.75, ¹	<u>9.75'</u>	Ç
																	13.82'		
																		9.75'	(
<u>-</u>																			
																	13.82'		
15'	TYPE "D"	JOINTS	15'	11.06'	11.05'	10'	15'		TYPE "D"	JOINTS	12' 14.97'		15'	12'	12'	12.1'			
										15'	12,	15'	15'	12'	12'	12.1'			
"D" J0	OINT		15'	11.06'	11.05'	10'	15'	15'	15'	15'	15'	15'	15'	12'	12'	12.1'	13.82'	9.75'	Ç


REVISIONS

ITEM





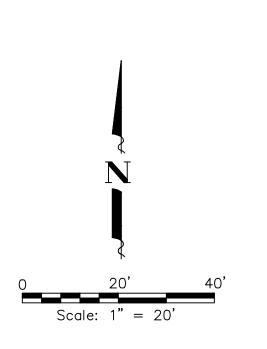

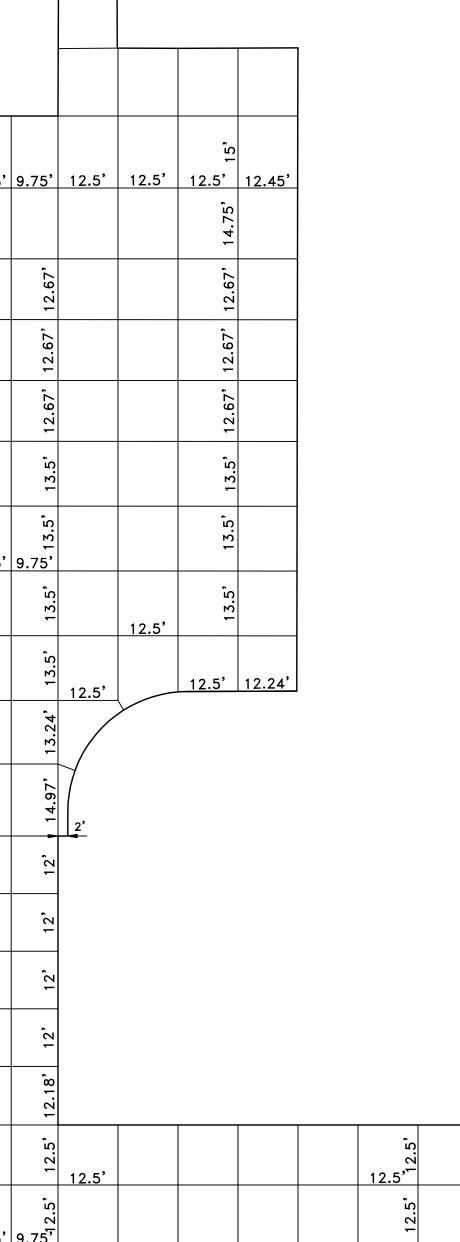

NOTES:

1.) ALL EDGES OF NEW SLABS, FREE STANDING OR CLOSURE, SHALL BE EDGED WITH AN APPROVED TOOL HAVING A RADIUS OF 1/8" TO 1/4" TO FACILITATE SAWING OF THE SEALANT RESERVOIR. RADIUS > 1/4" WILL NOT BE ACCEPTABLE.

2.) THE INITIAL SAWCUT FOR ALL LONGITUDINAL AND TRANSVERSE CÓNTRACTION JOINTS SHALL BE SAWED AS SOON AS POSSIBLE AFTER PLACEMENT OF THE PAVEMENT.

3.) ALL DOWEL BARS SHALL BE SECURELY HELD IN PLACE BY MEANS OF A DOWEL BAR ASSEMBLY WHICH WILL INSURE THAT THEY WILL REMAIN PARALLEL TO THE PAVEMENT LANES. THE DOWEL BAR ASSEMBLIES SHALL BE APPROVED BY THE RESIDENT ENGINEER PRIOR TO INSTALLATION.


4.) ALL TIE BARS AND MESH SHALL BE SECURELY HELD IN PLACE BÝ SUPPORT PINS OR OTHER APPROVED METHODS TO PREVENT SHIFTING DURING AND AFTER CONCRETE PLACEMENT.

5.) METAL FORMS USED FOR KEYED JOINTS MAY BE LEFT IN PLACE


6.) TIE BARS SHALL BE DEFORMED BARS IN CONFORMANCE WITH AÁSHTO M137.

7.) UNDERMINING OF EXISTING ADJACENT PAVEMENT SHALL BE RÉMEDIED BY FILLING VOID WITH CONCRETE PRIOR TO MAIN LINE PAVING, AND FINISH TO PRODUCE A SMOOTH VERTICAL SURFACE. REMAINING VOIDS SHALL BE PRESSURE GROUTED. UNDERMINING REPAIRS SHALL BE CONSIDERED INCIDENTAL.

	ILLINOIS PROJECT MLI-3896 AIP PROJECT NO. 3-	-17-0068-XX
6	PAVEMENT JOINT PLAN - EAST	SHEET NO.
PS, Inc.	SRE BUILDING RAMP IMPROVEMENTS	
)) 792–8974 Inc.	FILE NAME: T: \M0108.128\DWG\2012 PLANS\08128-MDL.DWG JOB NUMBER: 01-29-08-128	of 28

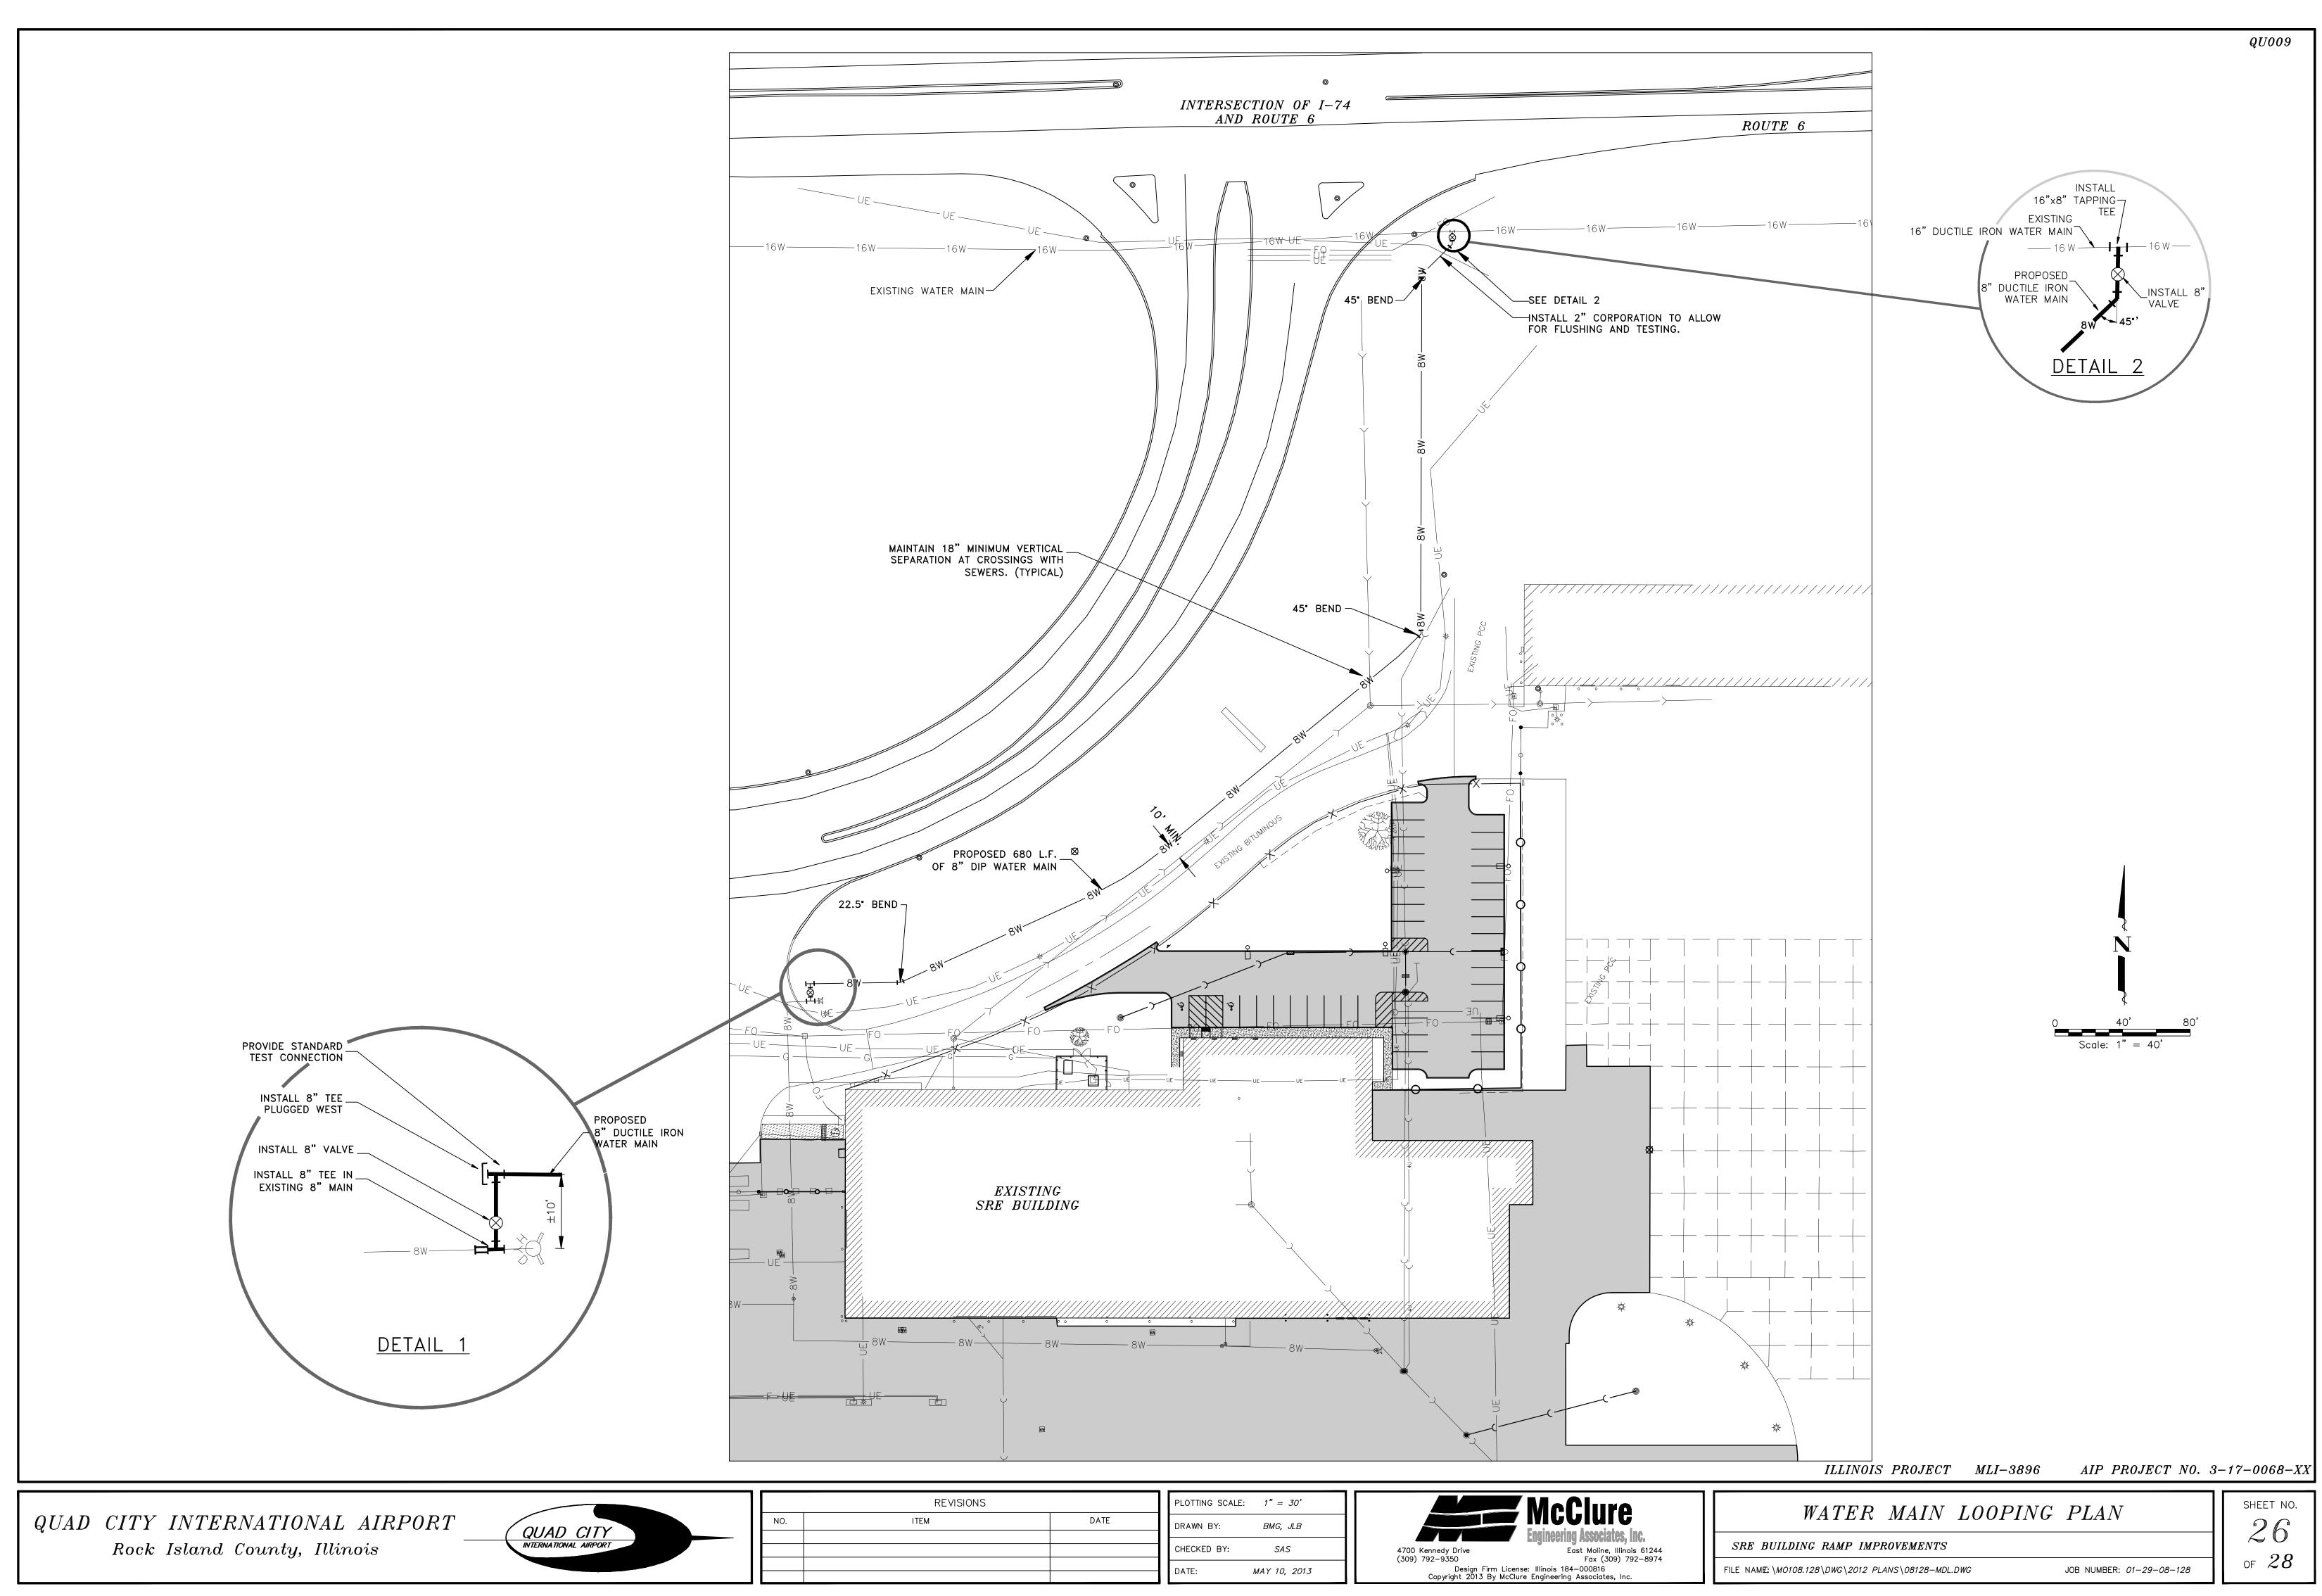

	PLOTTING SCALE: $1'' = 30'$	REVISIONS					
	DRAWN BY: BMG, JLB	DATE	ITEM).			
4700 Kennedy Drive East Moline	CHECKED BY: SAS						
(309) 792-9350 Fax (3 Design Firm License: Illinois 184-000816 Copyright 2013 By McClure Engineering Associat	DATE: MAY 10, 2013						

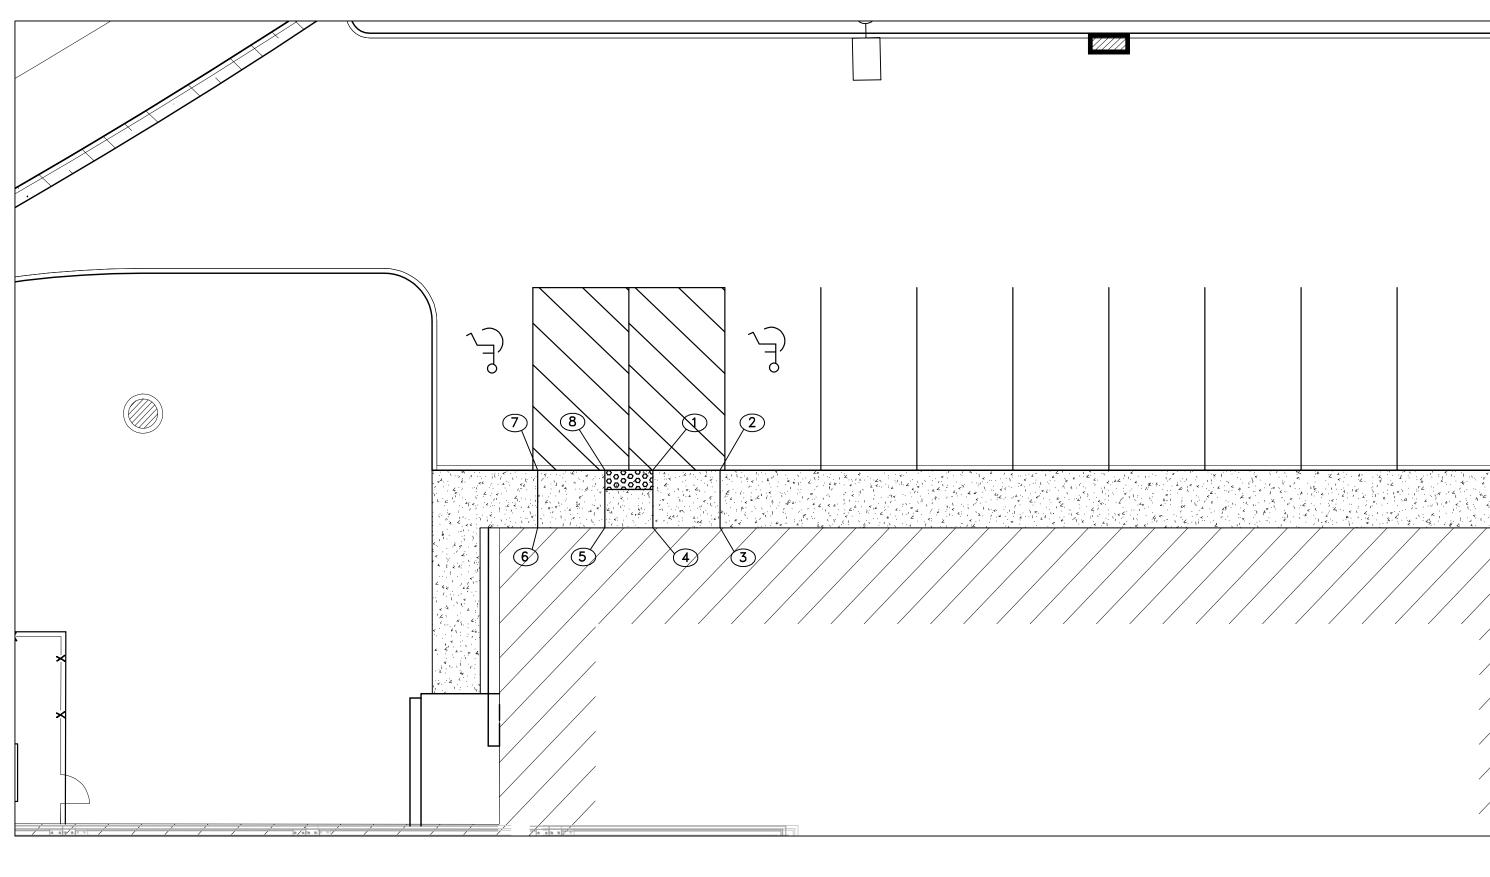


				SIDEWALK COMPLIANCE						
<u>tractor</u> 14-2013										
Offset	Elevation	Point t	o Point	Sidewalk Designation	Distance*	∆ Elevation	Slope	Legally Acceptable Range	Difference between Designed Slope and Maximum Legally	
					FT	FT	%	Pos. or Neg.	Acceptable Range	0
	575.93	1	2	Ramp Running Slope	7.00	0.50	7.1%	0.5% to 8.3%	1.2%	0.5% to 8
	576.43	2	3	Sidewalk Cross Slope	6.00	0.09	1.5%	0.5% to 2.0%	0.5%	0.5% to 2
	576.52	3	4	Ramp Running Slope	7.00	-0.50	-7.1%	0.5% to 8.3%	1.2%	0.5% to 8
	576.02	4	5	Landing/Turning Space	5.00	0.00	0.0%	0.1% to 2.0%	2.0%	0.1% to 2
	576.02	5	6	Ramp Running Slope	7.00	0.50	7.1%	0.5% to 8.3%	1.2%	0.5% to 8
	576.52	6	7	Sidewalk Cross Slope	6.00	-0.09	-1.5%	0.5% to 2.0%	0.5%	0.5% to 2
	576.43	7	8	Ramp Running Slope	7.00	-0.50	-7.1%	0.5% to 8.3%	1.2%	0.5% to 8.
	575.93	8	1	Landing/Turning Space	5.00	0.00	0.0%	0.1% to 2.0%	2.0%	0.1% to 2
		4	1	Landing/Turning Space	6.00	-0.09	-1.5%	0.1% to 2.0%	0.5%	0.1% to 2.
		5	8	Landing/Turning Space	6.00	-0.09	-1.5%	0.1% to 2.0%	0.5%	0.1% to 2.

QUAD CITY INTERNATIONAL AIRPORT Rock Island County, Illinois




	REVISIONS		PLOTTING SCALE: $1'' = 10'$	McClure
0.	ITEM	DATE	DRAWN BY: BMG, JLB	
			CHECKED BY: SAS	4700 Kennedy Drive East Moline, Illion
			DATE: MAY 10, 2013	(309) 792-9350 Fax (309) 79 Design Firm License: Illinois 184-000816 Copyright 2013 By McClure Engineering Associates, Inc.

QU009

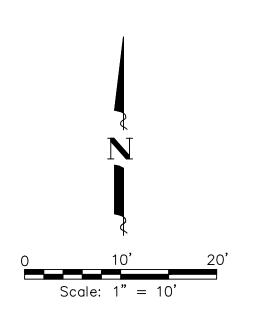



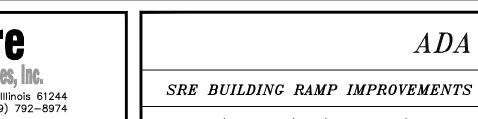

ILLINOIS PROJECT MLI-3896


AIP PROJECT NO. 3-17-0068-XX





FILE NAME:\M0108.128\DWG\2012 PLANS\08128-MDL.DWG

JOB NUMBER: 01-29-08-128

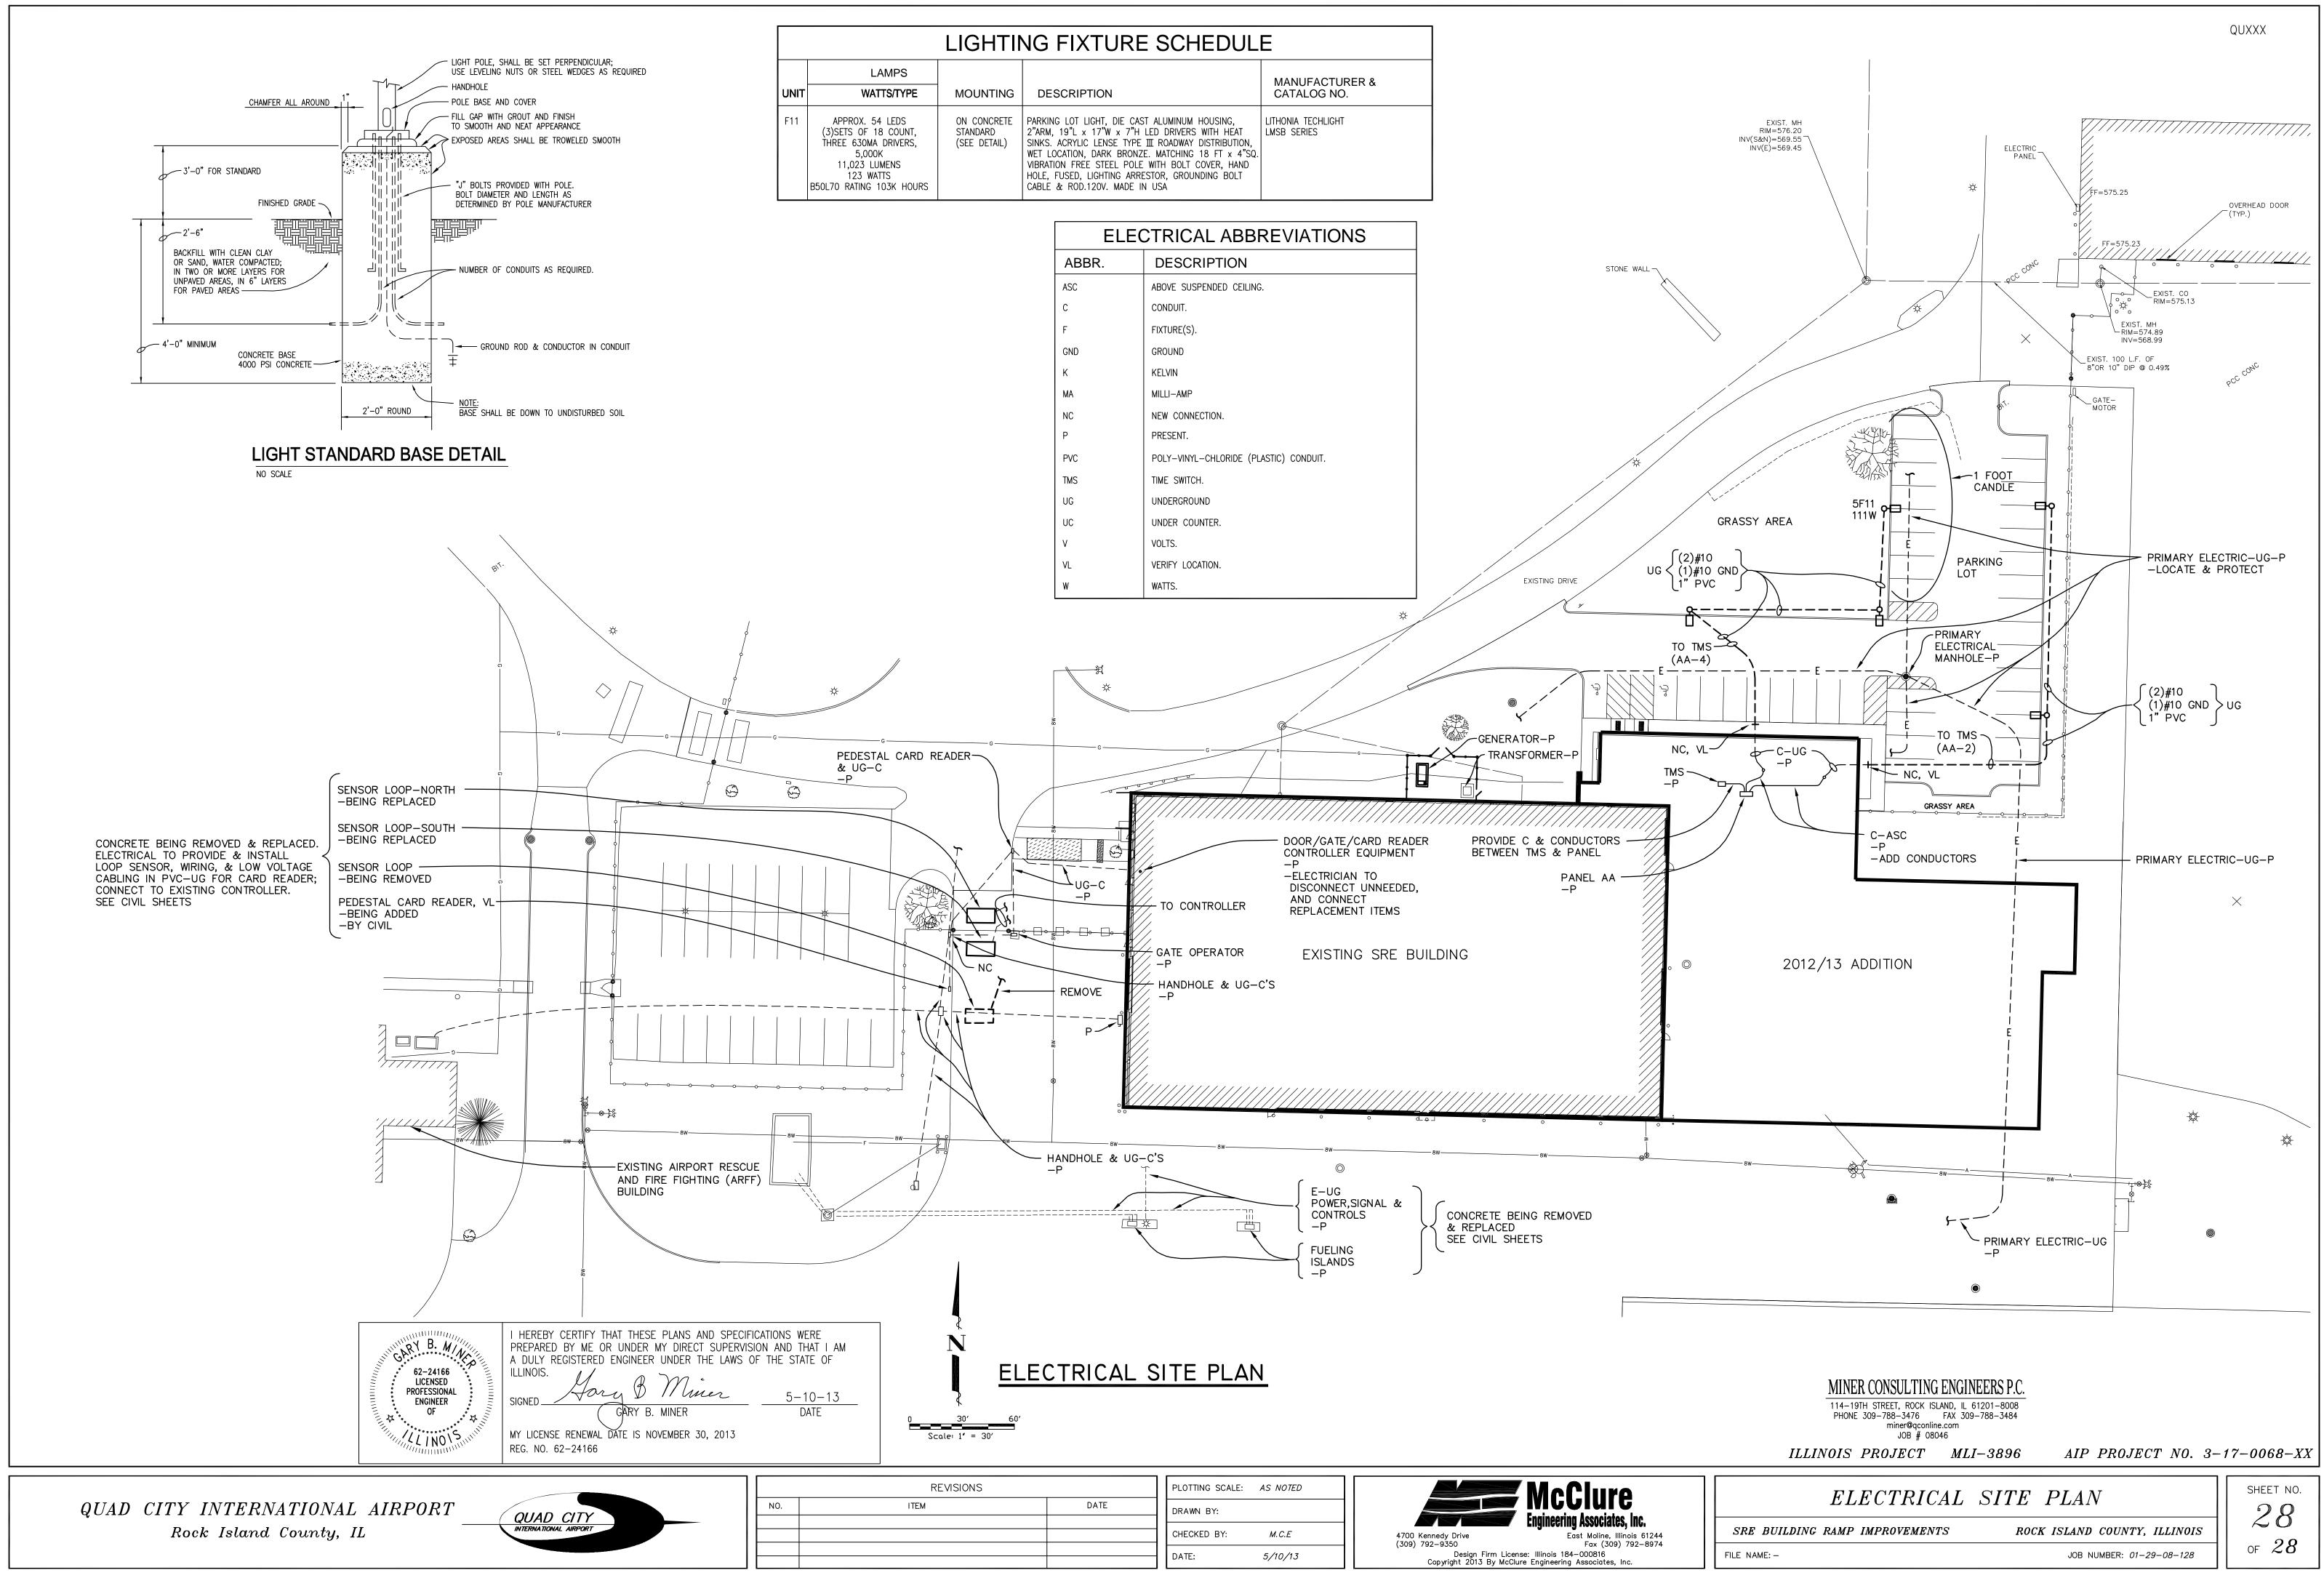

	REVISIONS		PLOTTING SCALE:	AS NOTED	
NO.	ITEM	DATE	DRAWN BY:		
					Engineering
			CHECKED BY:	M.C.E	4700 Kennedy Drive Ea (309) 792-9350
			DATE:	5/10/13	Design Firm License: Illinois 184-
					Copyright 2013 By McClure Engineering