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- WESTPORT PUMP STATION ELECTRICAL PLAN AND DETAILS
- WESTPORT PUMP STATION ELECTRICAL ONE-LINE DIAGRAM EFFINGHAM PUMP STATION ELECTRICAL PLAN AND DETAILS
- EFFINGHAM PUMP STATION ELECTRICAL ONE-LINE DIAGRAM
- DECATUR PUMP STATION ELECTRICAL PLAN AND DETAILS
- 8A EFFINGHAM PUMP STATION ELECTRICAL ELEVATION AND SCHEDULES 8B-8C EFFINGHAM PUMP STATION ELECTRICAL CONTROL DIAGRAM

DECATUR PUMP STATION ELECTRICAL ONE-LINE DIAGRAM

HIGHWAY STANDARDS

000001-07 STANDARD SYMBOLS, ABBREVIATIONS AND PATTERNS


STATE OF ILLINOIS

DEPARTMENT OF TRANSPORTATION


PROPOSED HIGHWAY PLANS

VARIOUS ROUTES SECTION D7 PUMP STATION 2019 NEW AUTOMATIC TRANSFER SWITCHES AND MISC. IMPROVEMENTS LAWRENCE, EFFINGHAM, AND MACON COUNTIES

C-30-010-19

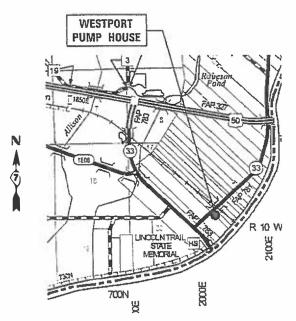

LAWRENCE_COUNTY

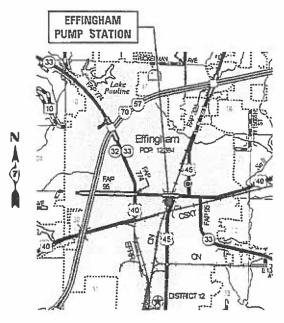


EFFINGHAM_COUNTY

GROSS LENGTH = NA NET LENGTH = NA

JOINT UTILITY LOCATION INFORMATION FOR EXCAVATION 1-800-892-0123

PROJECT MANAGER: KIMBERLY BLAIR

217-342-8265

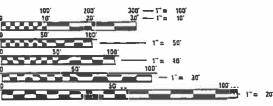

FULL SIZE PLANS HAVE BEEN PREPARED USING STANDARD ENGINEERING SCALES REDUCED SIZED PLANS WILL NOT CONFORM TO STANDARD SCALES. IN MAKING MEASUREMENTS ON REDUCED PLANS, THE ABOVE SCALES MAY BE USED.

CONTRACT NO. 46529

/\ REV. 6-3-2019



MACON_COUNTY



SECTI ON

· LAWRENCE/EFFINGHAM/MACON

★ 9 + 4 = 13 TOTAL SHEETS

LOCATION OF SECTION INDICATED THUS: -

KLINGNEA & ASSOCIATES, P.C.

Engineers · Architects · Surveyors

Quincy, Illinois 616 North Z4th Skest 217 233-3570 STATE OF ILUNOIS DESIGN FIRM NO. 184-2728

STATE OF ILLINOIS DEPARTMENT OF TRANSPORTATION

PRINTED BY THE AUTHORITY

OF THE STATE OF ILLINOIS

- 2. THE CONTRACTOR SHALL SECURE ANY LOCAL, STATE, COUNTY PERMITS NEEDED FOR THIS PROJECT.
- THE CONTRACTOR SHALL PERFORM ALL CONSTRUCTION FOR THE PROJECT IN A MANNER AND SEQUENCE THAT ARE BASED ON ACCEPTED INDUSTRY STANDARDS THAT RECOGNIZE THE INTERACTION OF THE COMPONENTS THAT COMPRISE THE STRUCTURE, WITHOUT CAUSING DISTRESS, UNANTICIPATED MOVEMENTS OR IRREGULAR LOAD PATHS AS A RESULT OF THE CONSTRUCTION MEANS AND METHODS EMPLOYED.
- CONSTRUCTION LOADS SHALL NOT EXCEED DESIGN LIVE LOAD. THE CONTRACTOR IS RESPONSIBLE FOR ALL DESIGN REQUIRED TO SUPPORT CONSTRUCTION EQUIPMENT USED IN CONSTRUCTING THIS PROJECT. SHORING AND RESHORING IS THE RESPONSIBILITY OF THE CONTRACTOR.
- 5. UTILITIES LOCATIONS / INFORMATION ON PLANS

ILLINOIS STATE LAW REQUIRES A 48-HOUR NOTICE TO BE GIVEN TO UTILITIES BEFORE DIGGING. FIELD MARKING OF FACILITIES MAY BE OBTAINED BY CONTACTING J.U.L.I.E. OR FOR NON-MEMBERS, THE UTILITY COMPANY DIRECTLY. AGENCIES KNOWN TO HAVE FACILITIES WITHIN THE PROJECT AREA ARE AS FOLLOWS:

* AMEREN ILLINOIS

MEMBERS OF J.U.L.I.E. CALL TOLL FREE (800) 892-0123 OR 811 AND ARE INDICATED BY *. NON-J.U.L.I.E. MEMBERS MUST BE NOTIFIED INDIVIDUALLY

- 6. IT IS THE CONTRACTOR'S RESPONSIBILITY TO ENFORCE ALL APPLICABLE SAFETY CODES AND REGULATIONS DURING ALL PHASES OF CONSTRUCTION.
- 7. ALL CONTRACTORS ARE REQUIRED TO EXAMINE THE DRAWINGS AND SPECIAL PROVISIONS CAREFULLY, VISIT THE SITE AND FULLY INFORM THEMSELVES AS TO ALL EXISTING CONDITIONS AND LIMITATIONS, PRIOR TO AGREEING TO PERFORM THE WORK. FAILURE TO VISIT THE SITE AND FAMILIARIZE THEMSELVES WITH THE EXISTING CONDITIONS AND LIMITATIONS WILL IN NO WAY RELIEVE THE CONTRACTOR FROM FURNISHING ANY MATERIALS OR PERFORMING ANY WORK IN ACCORDANCE WITH THE DRAWINGS AND SPECIFICATIONS WITHOUT ADDITIONAL COST TO THE OWNER.
- 8. DURING CONSTRUCTION THE CONTRACTOR SHALL BE RESPONSIBLE FOR MAINTENANCE OF THE EXISTING PUMP STATION BUILDING.
- 9. DRAWINGS ARE NOT TO SCALE.
- 10. THE DEPARTMENT RESERVES THE RIGHT TO NOTIFY THE CONTRACTOR TO CHANGE THE CONSTRUCTION SCHEDULE IF NEEDED TO ENSURE PROPER DEWATERING NEEDS FOR THE DEPARTMENT.

PAINTING

- 1. COLOR OF THE FINISH COAT SHALL BE GRAY, MUNSELL 5B 7/1.
- CLEANING AND PAINTING OF THE STRUCTURAL STEEL ROOF BEAMS SHALL BE AS SPECIFIED IN THE SPECIAL PROVISION FOR "CLEANING AND PAINTING EXISTING STEEL STRUCTURES". STRUCTURAL STEEL TO BE CLEANED BY SSPC-SP10 NEAR WHITE METAL BLAST CLEANING. ALL BEAMS IN THEIR ENTIRETY.
- THE DESIGNATED AREAS TO BE CLEANED PER NEAR WHITE METAL BLAST CLEANING SSPC-SP10 SHALL BE PAINTED ACCORDINGLY TO THE REQUIREMENTS OF PAINT SYSTEM 1 OZ/E/U.

THE EXISTING STRUCTURAL STEEL COATING MAY CONTAIN LEAD. THE CONTRACTOR SHALL TEST THE EXISTING PAINT AND TAKE APPROPRIATE PRECAUTIONS TO DEAL WITH THE PRESENCE OF LEAD ON THIS PROJECT.

/\ REV. 6-3-2019

LAWRENCE/EFFINGHAM/MACON

KLINGNER & ASSOCIATES, P.C.

DESIGNED REVISED USER NAME = ams ORAWN ADL REVISED CHECKED AMS REVISED PLOT DATE = 5/24/2019 DATE 5/16/2019 REVISED

STATE OF ILLINOIS **DEPARTMENT OF TRANSPORTATION**

GENERAL NOTES SCALE: NONE SHEET 1 OF 1 SHEETS STA.

SECTION COUNTY VAR. D7 PUMP STATIONS 2019 9 2 CONTRACT NO. 46529

TO STA.

ILLINOIS DEPARTMENT OF TRANSPORTATION

SUMMARY OF QUANTITIES

			100% STATE	CONSTR	UCTION TYPE	CODE
			TOTAL	LAWRENCE	EFFINGHAM	MACON
CODE NO.	ITEM	UNIT	TOTAL QUANTITY	0044	0044	0044
			Q0/111111	RURAL	URBAN	URBAN
50606701	CLEANING AND PAINTING STRUCTURAL STEEL, LOCATION 1	L SUM	1	1		
50606702	CLEANING AND PAINTING STRUCTURAL STEEL, LOCATION 2	L SUM	1			1
67100100	MOBILIZATION	L SUM	1	0.33	0.34	0.33
					{	
X0783300	PUMP STATION ELECTRICAL WORK	L SUM	1	0.08	0.81	0.11
Z0007101	CONTAINMENT AND DISPOSAL OF LEAD PAINT CLEANING RESIDUES NO. 1	L SUM	1	1		
Z0007102	CONTAINMENT AND DISPOSAL OF LEAD PAINT CLEANING RESIDUES NO. 2	L SUM	1			1
				*		
						,
,						
-			-	-	-	
					1	

* SPECIALTY ITEM

<u>∧</u> REV. 6-3-2019

LINES U SE

A S S O C I A T E S, P. C.

Engineers · Architects · Surveyors

610 N24TH ST. QUINCY, ILLINOIS 62301 217, 223, 5970
STATE OF LINKING ISSIAN FIRM NO. 148-2738

PLOT

SER NAMEbagj	DESIGNED - JNN	REVISED -
	DRAWN - AMS	REVISED -
LOT SCALE = 1:0 '-:' / in.	CHECKED - JNN	REVISED -
LOT DATE = 3/25/2019	DATE -	REVISED -

STATE OF ILLINOIS
DEPARTMENT OF TRANSPORTATION

		;	SUM	MA	RY OF	QUANTITIES	
SC ALE: NONE	SHEET	1	OF	1	SHEETS	STA.	TO STA.

REV. - MS

ELECTRICAL SYMBOLS LOW-VOLTAGE CIRCUIT BREAKER. RATING AND NUMBER OF POLES AS SHOWN FUSE: SIZE AND NUMBER OF FUSES AS NOTED ----RATING, FUSE SIZE, AND QUANTITY AS INDICATED -NON-FUSED SWITCH: CURRENT RATING, AND NUMBER OF POLES INDICATED DISCONNECT OR DRAWOUT CONNECTION MOTOR STARTER AND SEPARATELY MOUNTED COMBINATION MOTOR STARTER MOTOR CONTROLLER AND SEPARATELY MOUNTED MOTOR CONTROLLER WITH SHORT CIRCUIT PROTECTION AND DISCONNECT DISCONNECT MOTOR STARTER AND CONTROLLER SUBSCRIPTS: A- MOTOR STARTER NEMA SIZE B-STARTER TYPE FVNN- FULL VOLTAGE NON-REVERSING FVR- FULL VOLTAGE REVERSING 25- TWO SPEED RVAT- REDUCED VOLTAGE AUTO TRANSFORMER CD- CONTROL DIAGRAM D- CONTROLLER TYPE VFD- VARIABLE FREQUENCY DRIVE SS- SOLID STATE NON-FUSED DISCONNECT OR SAFETY SWITCH. SIZE AND NUMBER OF POLES AS NOTED FUSED DISCONNECT OR SAFETY SWITCH, X INDICATES SIZE, Y INDICATES FUSE SIZE, AND NUMBER OF POLES AS NOTED СВ SEPARATELY MOUNTED CIRCUIT BREAKER 60 HP MOTOR WITH DESIGN HORSEPOWER GENERATOR TRANSFORMER △ 3-PHASE, 3 WIRE DELTA CONNECTION Y 3-PHASE, 4 WIRE WYE CONNECTION $\exists \vdash$ VOLTAGE TRANSFORMER (VT OR PT) CURRENT TRANSFORMER TVSS TRANSIENT VOLTAGE SURGE SUPPRESSOR S SELECTOR SWITCH РΒ PUSH BUTTON IC INSTRUMENTATION/CONTROL DEVICE CONTROL PANEL 0 JUNCTION BOX ⅎ THERMOSTAT PANELBOARD (250V-600V) PANELBOARD (LESS THAN 250V)

FLECTRICAL SYMBOLS CONTROL SYMBOLS

ELE	ECTRICAL SYMBOLS		CONTROL SYMBOLS
\$	LIGHT SWITCH	-	ELECTRICAL CONNECTION
\$ x	LIGHT SWITCH, X WAY		NO ELECTRICAL CONNECTION
•	FLOOR BOX WITH DUPLEX RECEPTACLE	어Ю	NORMALLY OPEN CONTACT
©	FLOOR BOX FOR DATA/COMMUNICATION	01/40	NORMALLY CLOSED CONTACT
•	WALL BOX FOR DATA/COMMUNICATION	~0	NORMALLY OPEN TIME DELAY RELAY CONTACT. CLOSES UPON TIME DELAY AFTER ACTIVATING COIL
€	DUPLEX RECEPTACLE OUTLET	070	NORMALLY CLOSED TIME DELAY RELAY CONTACT. OPENS UPON TIME DELAY AFTER ACTIVATING COIL
⊕ GFCI	DUPLEX RECEPTACLE OUTLET WITH GROUND FAULT INTERRUPTER	0,0	NORMALLY OPEN TIME DELAY RELAY CONTACT. OPENS UPON TIME DELAY AFTER DE-ACTIVATING COIL
⊕ WP	WEATHERPROOF RECEPTACLE OUTLET WITH CFCI PROTECTION	010	NORMALLY CLOSED TIME DELAY RELAY CONTACT. CLOSES UPON TIME DELAY AFTER DE-ACTIVATING COIL
⊕ =	QUAD RECEPTACLE OUTLET		NORMALLY OPEN TEMPERATURE SWITCH: CLOSES ON RISING TEMPERATURE
X:##	CIRCUITING NOTATION: X DENOTES PANEL AND ## DENOTES CIRCUIT NUMBER	0-50	NORMALLY CLOSED TEMPERATURE SWITCH: OPENS ON RISING TEMPERATURE
\/	DENOTES CIRCUITING FOR STANDARD ELECTRICAL DEVICES	0,0	NORMALLY OPEN FLOW SWITCH: CLOSES ON INCREASING FLOW
Е	— UNDERGROUND ELECTRIC	olo	NORMALLY CLOSED FLOW SWITCH: OPENS ON INCREASING FLOW
A	OVERHEAD ELECTRIC	~0	NORMALLY OPEN LEVEL SWITCH: CLOSES ON INCREASING LEVEL
		0	NORMALLY CLOSED LEVEL SWITCH: OPENS ON INCREASING LEVEL
		~0	NORMALLY OPEN PRESSURE SWITCH: CLOSES ON INCREASING PRESSURE
		070	NORMALLY CLOSED PRESSURE SWITCH: OPENS ON INCREASING PRESSURE
		0,0	NORMALLY OPEN LIMIT SWITCH: CLOSES UPON REACHING LIMIT
		0-0	NORMALLY CLOSED LIMIT SWITCH: OPENS ON REACHING LIMIT
		PLC	MICROPROCESSOR INPUT
		PLC DED	MICROPROCESSOR OUTPUT
		DD	FIELD WIRING EXTERNAL TO CONTROL PANEL
		H O A X000	3-POSITION SELECTOR SWITCH, MAINTAINED CONTACTS
		0 0	NORMALLY OPEN PUSHBUTTON, MOMENTARY CONTACT
		مله	NORMALLY CLOSED PUSHBUTTON, MOMENTARY CONTACT
		• <u>×</u> •	INDICATING LIGHT, X INDICATES COLOR
		0 X	PUSH TO TEST INDICATING LIGHT, X INDICATES COLOR LENS COLOR: R- RED Y-YELLOW G- GREEN W-WHITE B-BILUE A- AMBER
		0-1-0	B-BLUE A- AMBER SOLENOID VALVE
		∞	THERMAL OVERLOAD ELEMENT
		o}to	THERMAL OVERLOAD ELEMENT RELAY CONTACT
		ETM	ELAPSED TIME METER
		MSC	MOTOR STARTS COUNTER

⚠ SHEET ADDED 6-3-2019


• LAWRENCE/EFFINGHAM/MACON

KLINGNER & ASSOCIATES, P.C. ngineers • Architects • Surveyor 616 n.24Th st. quincy, ill inois 62301 217.223,3670 state of ill inois design firm no. 184-2738

USER NAME = \$USER\$	DESIGNED - JJN	REVISED -
	DRAWN - BGJ	REVISED -
PLOT SCALE = \$SCALE\$	CHECKED - JJN	REVISED -
PLOT DATE = \$DATE\$	DATE - 05/16/2019	REVISED -

STATE OF ILLINOIS **DEPARTMENT OF TRANSPORTATION**

COUNTY TOTAL SHEET NO. 9 3A COUNTY SECTION **ELECTRICAL LEGEND** VAR. D7 PUMP STATIONS 2019 CONTRACT NO. 46529 SCALE: NONE SHEET 1 OF 1 SHEETS STA. TO STA. ILLINOIS FED. AID PROJECT

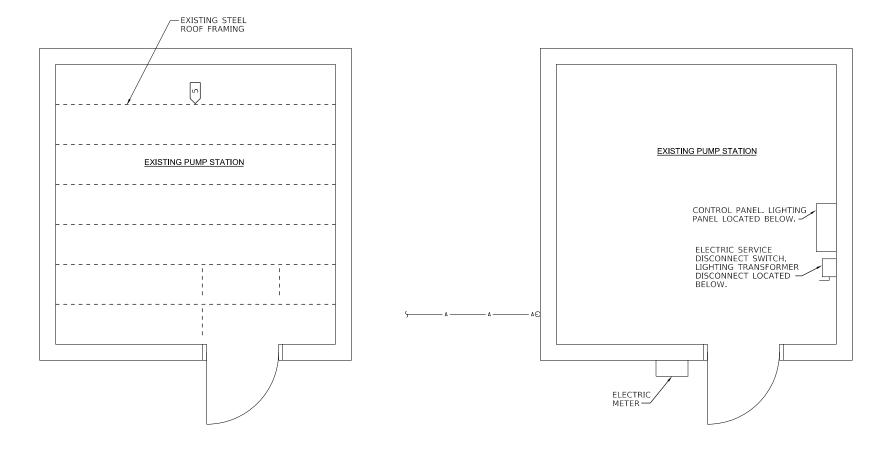

EXISTING PUMP STATION

CONTROL PANEL. LIGHTING PANEL LOCATED BELOW.

ELECTRIC SERVICE DISCONNECT SWITCH. LIGHTING TRANSFORMER DISCONNECT LOCATED BELOW.

PROPOSED ELECTRICAL PLAN
SCALE: 1/2"=1'-0"

EXISTING STRUCTURAL STEEL ROOF FRAMING PLAN

CALE: 1/2 = 1 - 0


* CONTRACTOR SHALL FIELD VERIFY STEEL FRAMING

EXISTING ELECTRICAL PLAN

SCALE: 1/2"=1'-0"

KEY NOTES (APPLICABLE TO THIS SHEET ONLY)

- 1) INSTALL NEW CONUIT/CONDUCTORS FROM SERVICE DISCONNECT TO NEW TRANSFER SWITCH.
- 2 NEW AUTOMATIC TRANSFER SWITCH.
- 3 NEW GENERATOR QUICK CONNECTION ENCLOSURE.
- 4) INSTALL NEW CONUIT/CONDUCTORS FROM TRANSFER SWITCH TO CONTROL PANEL AND LIGHTING TRANSFORMER DISCONNECT.
- 5 CLEAN AND PAINT EXISTING STRUCTURAL STEEL ROOF BEAMS.
 COST INCLUDED IN CLEANING AND PAINTING STRUCTURAL STEEL,
 LOCATION 1. THE CONTRACTOR SHALL FIELD VERIFY QUANTITY.

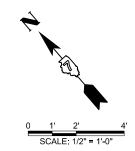

⚠ REVISED SHEET 6-3-2019

• LAWRENCE/EFFINGHAM/MACON

** A\$\$ O C I A T E \$, P. C.

Engineers · Architects · Surveyors
616 N.24TH 5T. QUINCY, ILLINOIS 62001 217 223.35070
STATE OF ILLINOIS DESON, FIRM NO. 1462798
PLC

STATE OF ILLINOIS
DEPARTMENT OF TRANSPORTATION


WESTPORT PUMP STATION ELECTRICAL PLAN AND DETAILS


F.A.I. SECTION COUNTY TOTAL SHEET NO.

VAR. D7 PUMP STATIONS 2019 • 9 4

CONTRACT NO. 46529

SCALE: AS NOTED SHEET 1 OF 2 SHEETS STA. TO STA. | ILLINOIS FED. AID F

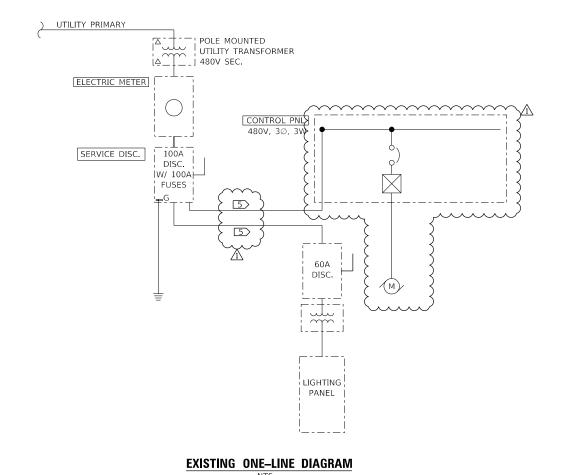

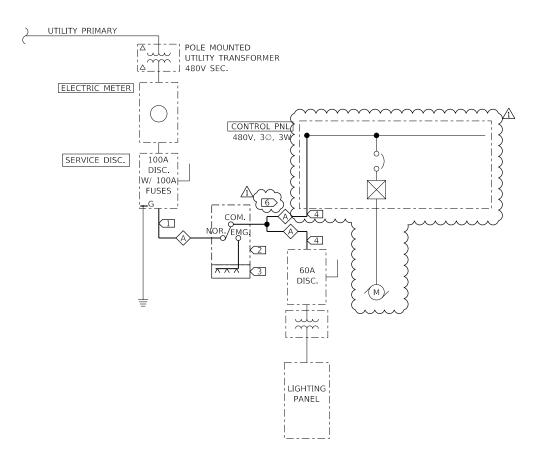

PROPOSED ONE-LINE DIAGRAM

FEEDER SCHEDULE									
TAG	NUMBER OF SETS	PHASE CON	NDUCTORS SIZE	NEUTRAL	EGC/ GEC	CONDUIT			
\Diamond	1	3	#1 AWG	-	#8 AWG	1.5"			

	KEY NOTES (APPLICABLE TO THIS SHEET ONLY)
	1 INSTALL NEW CONUIT/CONDUCTORS FROM SERVICE DISCONNECT TO NEW TRANSFER SWITCH.
	2 NEW AUTOMATIC TRANSFER SWITCH.
	3 NEW GENERATOR QUICK CONNECTION ENCLOSURE.
\triangle	4 INSTALL NEW CONUIT/CONDUCTORS FROM TRANSFER SWITCH TO CONTROL PANEL AND LIGHTING TRANSFORMER DISCONNECT. 5 REMOVE EXISTING FEEDERS / CONDUIT.
}	6 USE PARALLEL TAP CONNECTOR FOR CONNECTION. LOCATE TAP CONNECTION IN NEW JUNCTION BOX SIZED PER THE NATIONAL ELECTRIC CODE IF SUITABLE SPACE DOES NOT EXIST IN CURRENT ENCLOSURES.
(

<u>∧</u> REV. 6-3-2019

• LAWRENCE/EFFINGHAM/MACON

KLINGNER USER NAME = \$USER\$ & ASSOCIATES, P.C.


DESIGNED - JJN REVISED DRAWN - BGJ REVISED CHECKED - JJN REVISED PLOT DATE = \$DATE\$ DATE - 05/16/2019 REVISED


STATE OF ILLINOIS **DEPARTMENT OF TRANSPORTATION**

WESTPORT PUMP STATION **ELECTRICAL ONE-LINE DIAGRAM** SCALE: NONE SHEET 2 OF 2 SHEETS STA.

TO STA.


TOTAL SHEET NO. 9 5 SECTION COUNTY VAR. D7 PUMP STATIONS 2019 CONTRACT NO. 46529

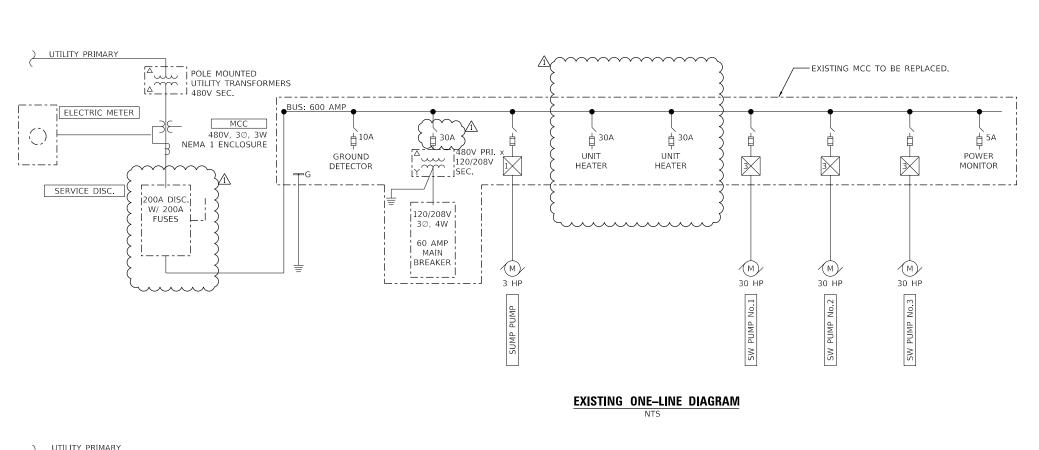

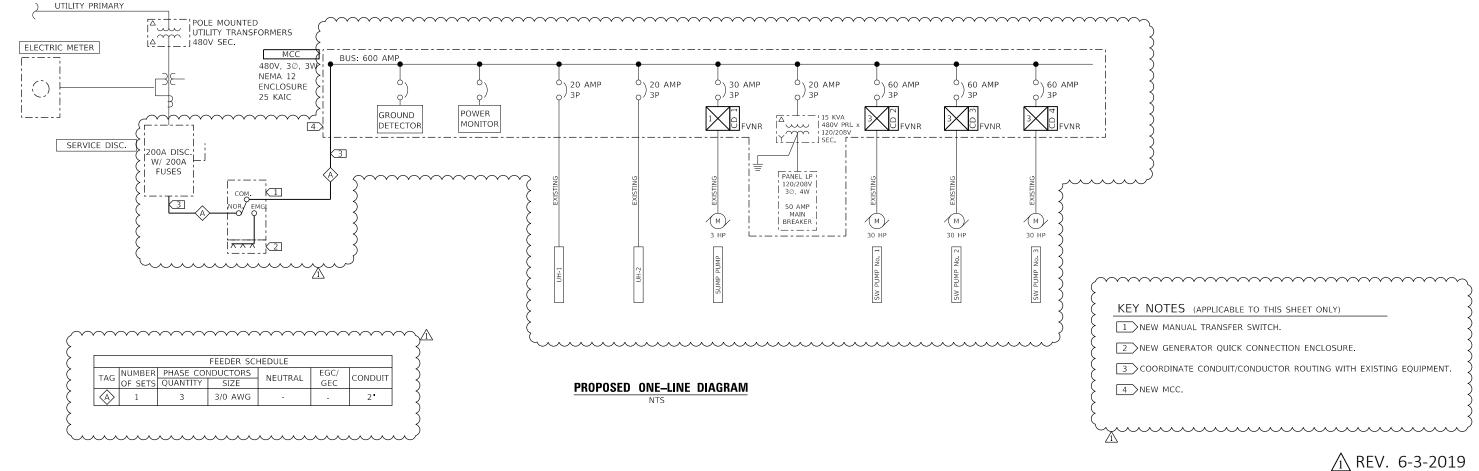

LAWRENCE/EFFINGHAM/MACON

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,	& ASSOCIATES, P.C.	
1	Engineers • Architects • Surveyors	Ρl
,	616 N.24TH ST. QUINCY, ILLINOIS 62301 217 223 3670 STATE OF ILLINOIS DESIGN FIRM NO. 184-2738	Ρl
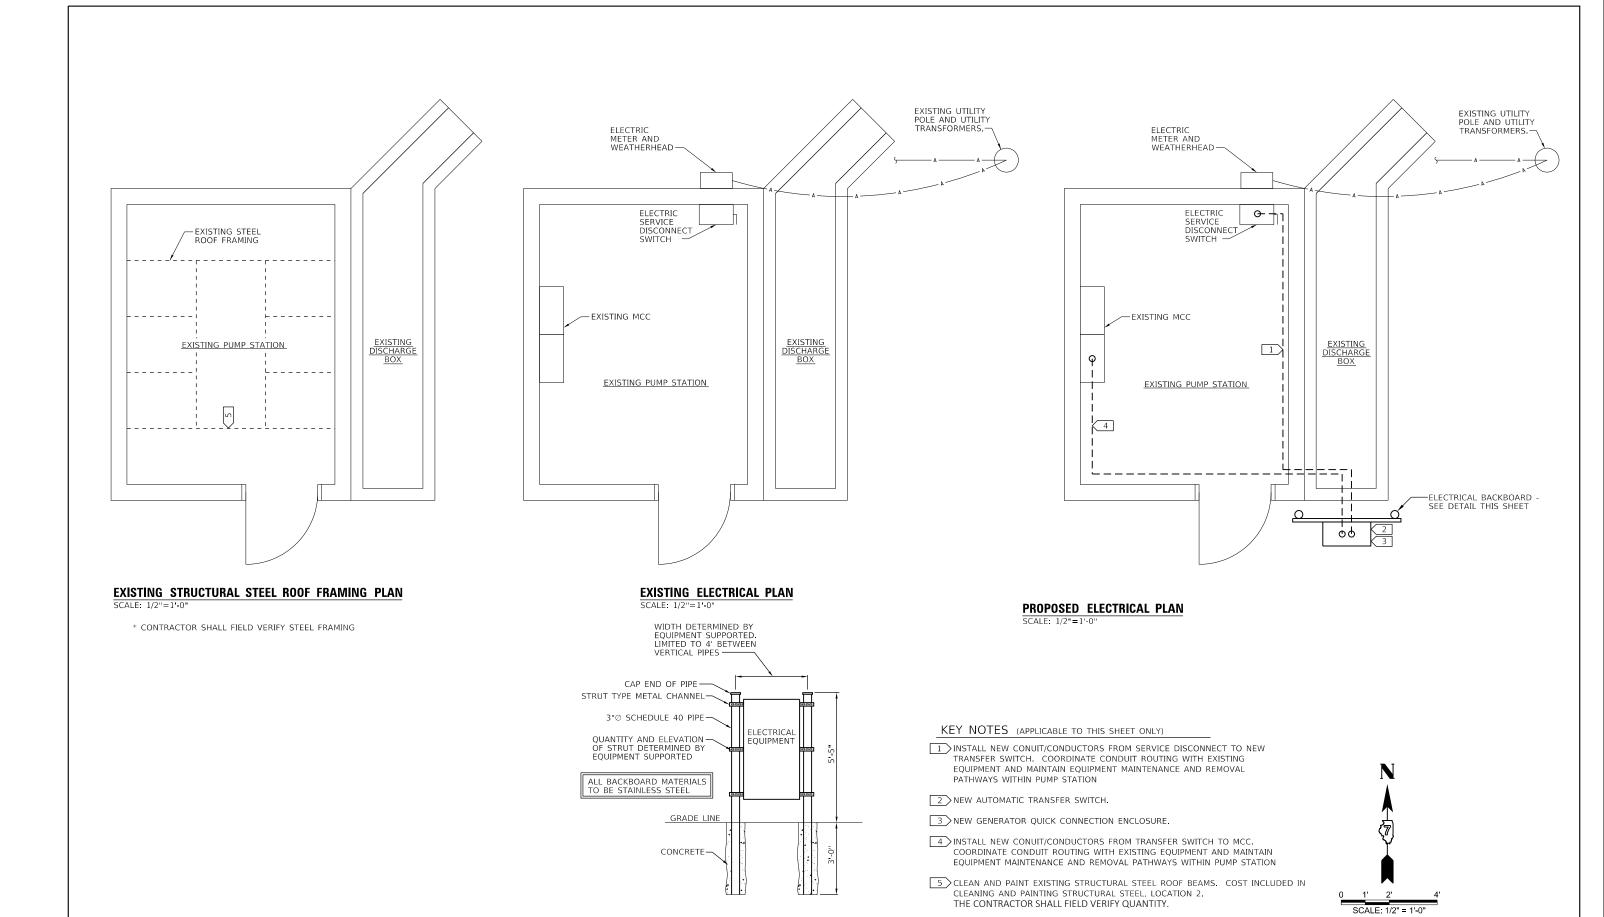
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PLOT DATE = \$DATE\$	DATE - 05/16/2019	REVISED -


STATE OF ILLINOIS DEPARTMENT OF TRANSPORTATION

ELECTRICAL BACKBOARD DETAIL

SCALE: AS NOTED SHEET

LAWRENCE/EFFINGHAM/MACON

	DI	ECAT	UR	PUMP	STATION		F.A.I. RTE.	SECTION	COUNTY	TOTAL SHEETS	SHEET NO.
ELECTRICAL PLAN AND DETAILS					UD DETAILS		VAR.	D7 PUMP STATIONS 2019	•	9	8
L	LUI	IIIUA		LAN A	AD DEIAILS				CONTRAC	T NO. 4	16529
FT	1	ΩF	2	SHEETS	STA	TO STA		TI I INOTE EED	AID DROJECT		

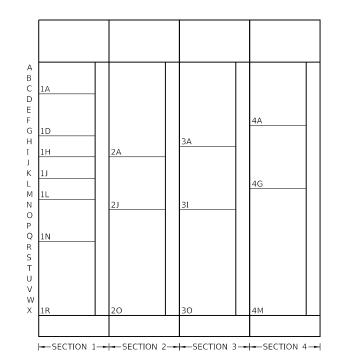

PROPOSED MCC ELEVATION NTS

					MC	Ç S	CH	IEC	UL													
ID							UX LKS				OR INDICATING						INDICATING			THE	R	
SECTION	CELL	STARTER, CLASS, OR DESCRIPTION	SIZE (INCHES)	CB TRIP/FUSE CLIPS (A)	HP RATING	NO	NC	START-STOP	FWD-REV-STOP	FAST-SLOW-STOP	HAND-OFF-AUTO	ON-OFF	FWD-OFF-REV	FAST-OFF-SLOW	GREEN	RED	AMBER	PUSH TO TEST	ELAPSED TIME METER	MOTOR STARTS COUNTER	CURRENT SWITCH	NAMEPLATE IDENTIFICATIONS
1	Α	MAIN LUGS	9			\vdash	\vdash		\vdash	Н				\dashv	\dashv	\dashv					\dashv	MAIN LUGS
1	D	GROUND DETECTION LIGHTS	12																			GROUND DETECTION
1	Н	POWER MONITOR RELAY	12																			POWER MONITOR RELAY
1	J	CIRCUIT BREAKER	6	20											ヿ	\neg						UH-1
1	F	CIRCUIT BREAKER	6	20																		UH-2
1	N	COMB, FVNR STARTER	12	30	3			Х			Χ				Х		Х	Χ	Х	Χ	Х	SUMP PUMP
1	R	SPACE	21												\neg							SPACE
2	Α	PANELBOARD	27												T							PANEL LP
2	J	SPACE	15												T							SPACE
2	0	15 KVA DISTRIBUTION TRANSFORMER	30	20																		120/208V, 3 PHASE XFMR
3	Α	RELAY SECTION	24											T	\neg							CONTROLS
3		COMB, FVNR STARTER	18	100	30						Х			ヿ	Х		Х	Х	Х	Х	Х	SW PUMP No. 1
3	0	SPACE	30											T	T							SPACE
4	Α	COMB, FVNR STARTER	18	100	30						Х			ヿ	Х		Х	Х	Х	Χ	Х	SW PUMP No. 2
4	G	COMB, FVNR STARTER	18	100	30						Х			T	Х		Х	Х	Х	Х	Х	SW PUMP No. 3
4	М	SPACE	36																			SPACE


Е	ELECTRICAL PANEL: LP											
Loc	ation:	-	100A		208 V	3 Ph 4 Wire 50A MAIN BREAKER						
MC	C			Fault Ra	Fault Rating: 10,000					•		
		Brkr.		Load					Brkr.			
No.	Description	Amps	Α	В	C	C	В	Α	Amps	Description	No.	
1	EF-1	20							25	DEH-1	2	
3	ELECTRODE RELAY	20							²⁵	DEH-I	4	
5	PUMP STATION INTERIOR LIGHTS	20							20	RECEPTACLES	6	
7	PUMP STATION EXTERIOR LIGHTS	20							20	SPARE	8	
9	STORMWATER PUMPS COMMON CONTROL	20							20	ENGINE BATTERY CHARGER	10	
11	CONDENSATION HEATERS	20							20	EF-2	12	
13	SPARE	20							20	SPARE	14	
15	SPARE	20							20	SPARE	16	
17	SPARE	20							20	SPARE	18	
_	'	•	0	0	0	0	0	0				
Totals			Phase A		Phase B Ph		ase C Total Wa		attage(\	'A Capacity	Capacity	
			0		0		0	1 0		#VALUE!		


⚠ SHEET ADDED 6-3-2019

• LAWRENCE/EFFINGHAM/MACON

	KLINGNER						
₩.	& ASSOCIATES, P.C.						
\$FILEL	Engineers • Architects • Surveyors	PL					
₩.	616 N.24TH ST. QUINCY, ILLINOIS 62301 217 223 3670 STATE OF ILLINOIS DESIGN FIRM NO. 184-2738	PL					

USER NAME = \$USER\$	DESIGNED - JJN	REVISED -
	DRAWN - BGJ	REVISED -
PLOT SCALE = \$SCALE\$	CHECKED - JJN	REVISED -
PLOT DATE = \$DATE\$	DATE - 05/16/2019	REVISED -

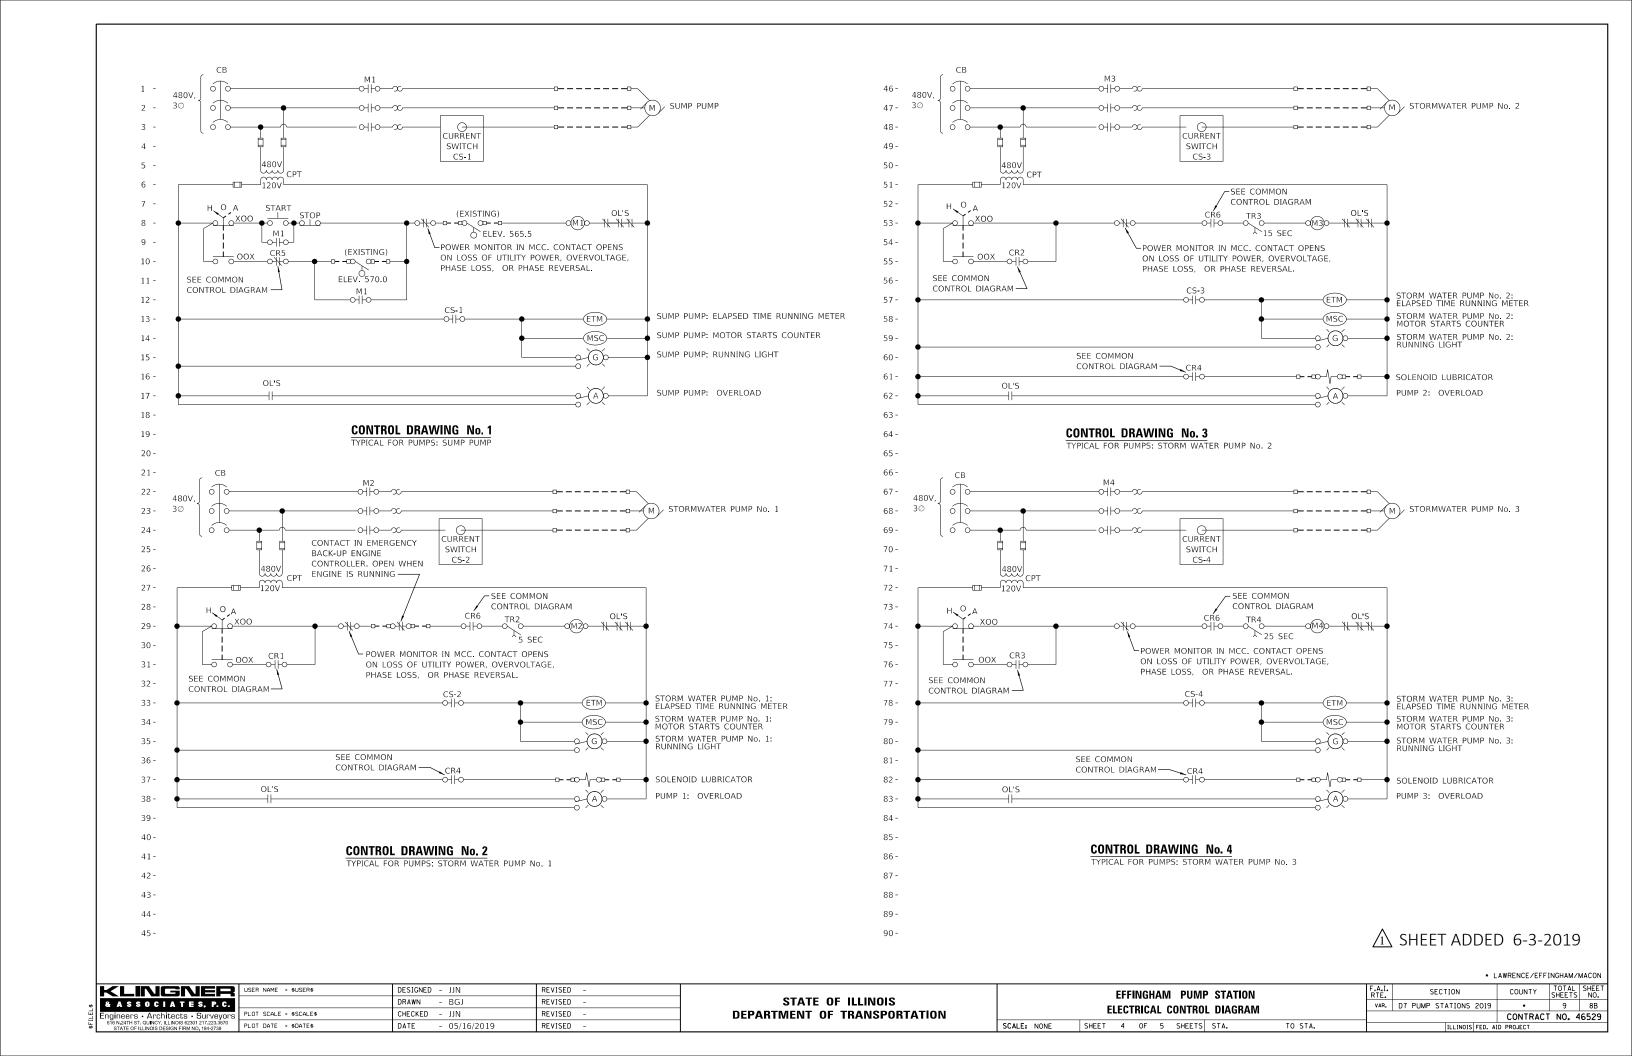

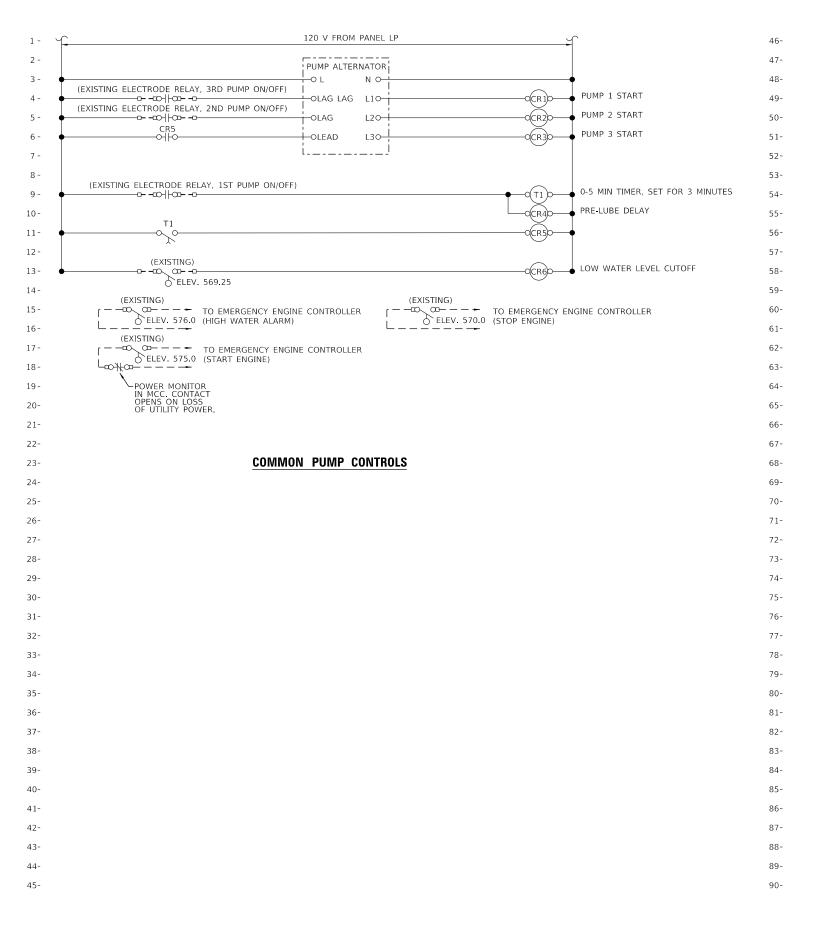

THE CONTROL LOOP DESCRIPTIONS ARE NOT INTENDED TO BE AN INCLUSIVE LISTING OF ALL ELEMENTS AND APPURTENANCES REQUIRED TO EXECUTE LOOP FUNCTIONS, BUT ARE RATHER INTENDED TO SUPPLEMENT AND COMPLEMENT THE DRAWINGS AND OTHER SPECIFICATION SECTIONS.

STORMWATER PUMPS

1.Major Equipment:
a.Pumps:
1)Existing Storm Water Pumps Nos. 1, 2, and 3
2)Sump Pump
b.Water level measurement system

1)Existing system is to be re-used

2.Control Logic:
a.Storm Water Pumps Nos. 1, 2, and 3
1)When HAND is selected at the MCC, the pump shall run if the water level is above the low water level cut off elevation.
2)When OFF is selected at the MCC, the pump shall be off.
3)When AUTO is selected at the MCC, the pumps shall be controlled as follows:

Rising Wetwell Water Level: -Start Lead Pump when water level reaches lead pump water level -Start Lag Pump when water level reaches lag pump water level -Start Lag-Lag Pump when water level reaches lag-lag pump water level

Falling Wetwell Water Level:
-Stop Lag-Lag Pump when water level drops below lag-lag off water level
-Stop Lag Pump when water level drops below lag off water level
-Stop Lead Pump when water level drops below lead off water level

4)Lead, Lag and Lag-Lag Pumps shall be automatically alternated to equalize runtime following each pumping cycle.

5)All pumps shall be pre-lubricated when the water level reaches the Lead pump start water level for 3 minutes (adjustable) prior to pump activation.

6)Pump start delay timers shall prevent more than one pump starting concurrently after a power outage.

7)Pump Running Pilot Light, Pump Starts Counter, and Pump Operating Hours shall be activated by CT switch on motor power circuit.

8)Pump No. 1 electric motor shall be prevented from operating when the back-up engine is operating.

b.Sump Pump

1)When HAND is selected at the MCC, the pump shall operate according to the START/STOP pushbuttons on the MCC when the water level is above the sump pump off level. 2)When OFF is selected at the MCC, the pump shall be off. 3)When AUTO is selected at the MCC, the pump shall be controlled as follows:

Rising Wetwell Water Level:
-Start Sump Pump when water level reaches sump pump start water level
-Sump Pump shall be shut off when LEAD Storm Water Pump is operating

Falling Wetwell Water Level:
--Start Sump Pump when water level falls below LEAD Storm Water Pump operating level.

-Stop Sump Pump when water level drops below sump pump off water level


4)Pump Running Pilot Light, Pump Starts Counter, and Pump Operating Hours shall be activated by CT switch on motor power circuit.

STORMWATER PUMPS CONTROL LOOP


⚠ SHEET ADDED 6-3-2019

• LAWRENCE/EFFINGHAM/MACON

KLINGNER DESIGNED - JJN REVISED USER NAME = \$USER\$ SECTION COUNTY EFFINGHAM PUMP STATION STATE OF ILLINOIS DRAWN - BGI REVISED & ASSOCIATES, P.C. VAR. D7 PUMP STATIONS 2019 9 80 **ELECTRICAL CONTROL DIAGRAM** CHECKED - JJN REVISED **DEPARTMENT OF TRANSPORTATION** CONTRACT NO. 46529 SHEET 5 OF 5 SHEETS STA. SCALE: NONE TO STA. PLOT DATE = \$DATE\$ DATE REVISED - 05/16/2019

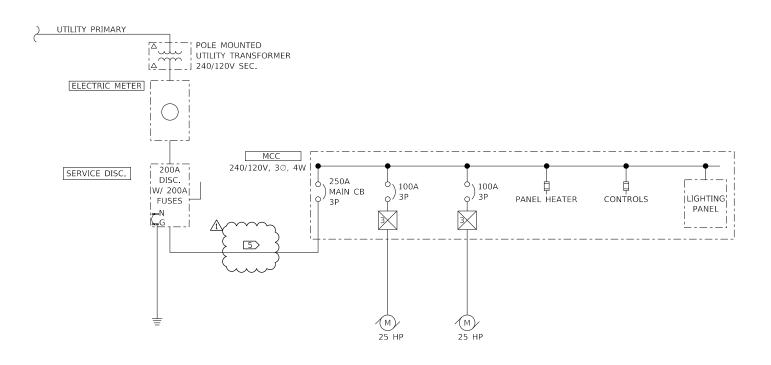

EXISTING ONE-LINE DIAGRAM

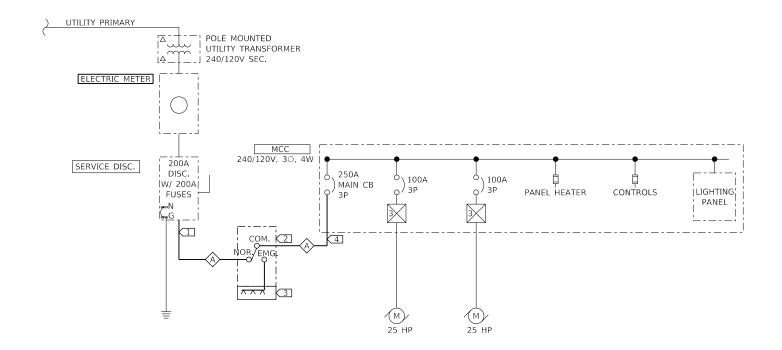

PROPOSED ONE-LINE DIAGRAM

NTS

FEEDER SCHEDULE									
TAG	TAG NUMBER PHASE CONDUCTO			NEUTRAL	EGC/ GEC	CONDUIT			
	OF SEIS	QUANTITY	SIZE						
	1	3	3/0 AWG	3/0 AWG	#6 AWG	2"			

<u>∧</u> REV. 6-3-2019

KEY NOTES (APPLICABLE TO THIS SHEET ONLY)

3 NEW GENERATOR QUICK CONNECTION ENCLOSURE.

TO NEW TRANSFER SWITCH.

2 NEW AUTOMATIC TRANSFER SWITCH.

5 REMOVE EXISTING FEEDERS / CONDUIT.

1 INSTALL NEW CONUIT/CONDUCTORS FROM SERVICE DISCONNECT

4) INSTALL NEW CONUIT/CONDUCTORS FROM TRANSFER SWITCH TO MCC.

• LAWRENCE/EFFINGHAM/MACON

F	CLINGNER USER NAME = \$USER\$	DESIGNED - JJN	REVISED -		DECATUR PUMP STATION		F	A.I. SECTION	COUNTY TOTAL SHEET
φ 8	ASSOCIATES, P.C.	DRAWN - BGJ	REVISED -	STATE OF ILLINOIS DEPARTMENT OF TRANSPORTATION S	ELECTRICAL ONE-LINE DIAGRAM			VAR. D7 PUMP STATIONS 2019	• 9 9
g En	gineers · Architects · Surveyors PLOT SCALE = \$SCALE\$	CHECKED - JJN	REVISED -					CONTRACT NO. 46529	
6	16 N.24TH ST. QUINCY, ILLINOIS 62301 217.223.3670 STATE OF ILLINOIS DESIGN FIRM NO. 184-2738 PLOT DATE = \$DATE\$	DATE - 05/16/2019	REVISED -		SCALE: NONE	SHEET 2 OF 2 SHEETS STA. TO	O STA.	ILLINOIS FED. A	D PROJECT