


LETTING ITEM NO. 03A **JUNE 14, 2019** 

# **CONSTRUCTION PLANS** FOR **ROCHELLE MUNICIPAL AIRPORT MAJOR THOMAS F. KORITZ FIELD**

ROCHELLE, OGLE COUNTY, ILLINOIS REHABILITATE RUNWAY 7/25 AND RUNWAY LIGHTING

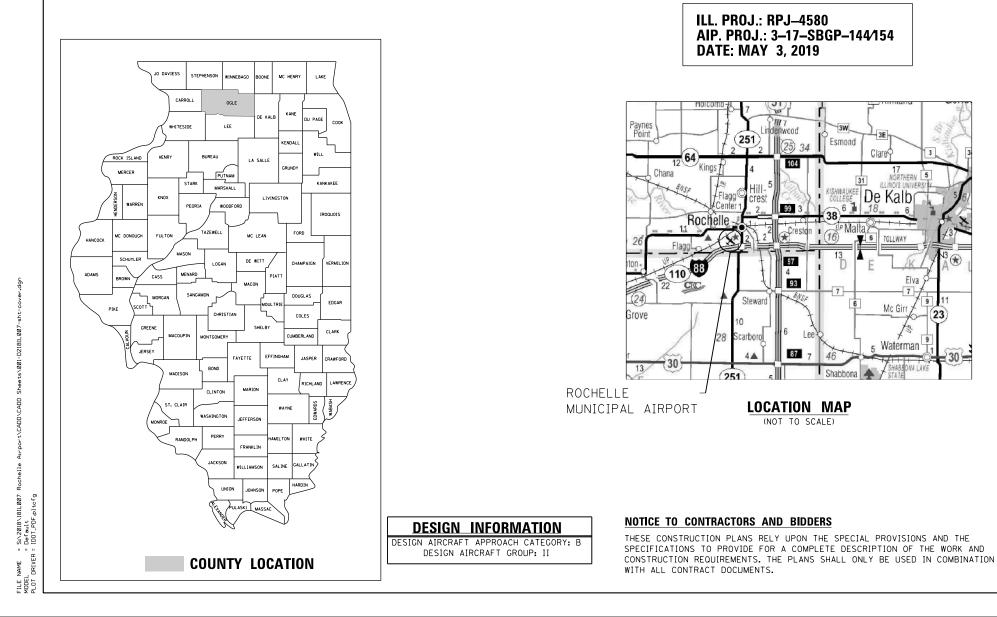

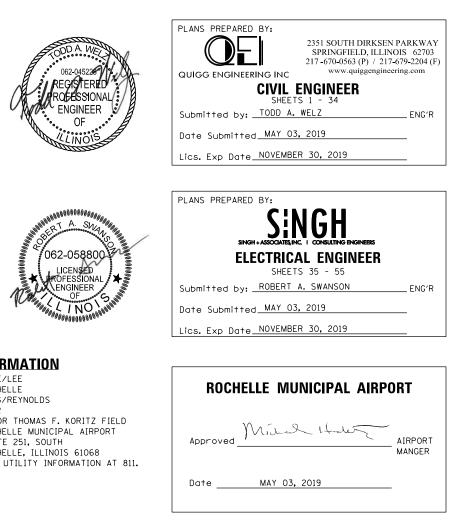

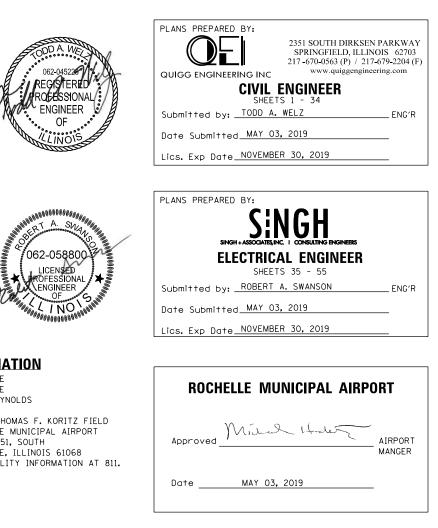

### J.U.L.I.E. INFORMATION

Mc Gir

Waterma

Shahhor

COUNTY	OGLE/LEE
CITY	ROCHELLE
TOWNSHIP	FLAG/REYNOLDS
SECTION NO.	35/2
ADDRESS	MAJOR THOMAS F.
	ROCHELLE MUNICIF
	ROUTE 251, SOUTH
	ROCHELLE, ILLINO
CALL J.U.L.I.E.	FOR UTILITY INFO

## **RC009 TOTAL SHEETS-55**

BASE BID				
ITEM NO.	DESCRIPTION	UNIT	QUANTITY	AS-BUI QUANTI
AR108158	1/C #8 5 KV UG CABLE IN UD	LF	5162	
AR108706	1/C *6 COUNTERPOISE	LF	3644	
AR108960	REMOVE CABLE	LF	3860	
AR110502	2-WAY CONCRETE ENCASED DUCT	LF	108	
AR110610	ELECTRICAL HANDHOLE	EA	2	
AR125410	MITL - STAKE MOUNTED	EA	46	
AR125415	MITL - BASE MOUNTED	EA	2	
AR125901	REMOVE STAKE MOUNTED LIGHT	EA	21	
AR125902	REMOVE BASE MOUNTED LIGHT	EA	4	
AR125964	RELOCATE TAXI GUIDANCE SIGN	EA	1	
AR150510	ENGINEER'S FIELD OFFICE	LSUM	1	
AR150520	MOBILIZATION	LSUM	1	
AR150540	HAUL ROUTE	LSUM	1	
AR152410	UNCLASSIFIED EXCAVATION	CY	2745	
AR152441	ON-SITE BORROW	CY	1528	
AR156510	SILT FENCE	LF	1990	
AR156511	DITCH CHECK	EA	2	
AR156513 SEPARATION FABRIC		SY	2539	
AR156520 INLET PROTECTION		EA	2	
AR156530	TEMPORARY SEEDING	ACRE	1	
AR201663	SAND MIX CRACK REPAIR	LF	21125	
AR209622	CRUSHED AGG. BASE COURSE - 22"	SY	2773	
AR401614	BIT. SURF. CSEMETHOD II, SUPERPAVE	TON	4166	
AR401630	BITUMINOUS SURFACE TEST SECTION	EA	1	
AR401640	BITUMINOUS PAVEMENT GROOVING	SY	25880	
AR401650	BITUMINOUS PAVEMENT MILLING	SY	35290	
AR401900	REMOVE BITUMINOUS PAVEMENT	SY	1245	
AR403613	BIT. BASE CSEMETHOD I. SUPERPAVE	TON	356	
AR602510	BITUMINOUS PRIME COAT	GAL	838	
AR603510	BITUMINOUS TACK COAT	GAL	5675	
AR620520	PAVEMENT MARKING - WATERBORNE	SF	24473	
AR620525	PAVEMENT MARKING - BLACK BORDER	SF	6060	
AR620900	PAVEMENT MARKING BEACK BONDEN	SF	310	
AR701713	RCEP SPAN 30 RISE 19	LF	352	
AR705506	6" PERFORATED UNDERDRAIN	LF	1000	
AR705546	6" NON-PERFORATED UNDERDRAIN	LF	170	
AR705546		EA	3	
	UNDERDRAIN COLLECTION STRUCTURE	EA	3	
AR705640	P R CONC. FES EQ. ROUND SIZE 24"	EA	4	
AR752724		ACRE	6	
AR901510	SEEDING	+		-

ITEM NO.	DESCRIPTION	UNIT	QUANTITY	AS-BUILT QUANTITY
AS108158	1/C #8 5 KV UG CABLE IN UD	LF	11110	
AS108706	1/C #6 COUNTERPOISE	LF	11848	
AS108960	REMOVE CABLE	LF	124	
AS125400	REPLACE ISOLATION TRANSFORMER	EA	105	

	INDEX OF SHEETS		
SHEET NO.	DESCRIPTION	SHEET NO.	
1	COVER SHEET	29	CROS
2	SUMMARY OF QUANTITIES AND INDEX OF SHEETS	30	CROS
3	PROPOSED SCOPE OF WORK PLAN & GENERAL NOTES	31	СИТ
4	CONSTRUCTION SAFETY PHASING PLAN PHASE 1	32	CROS
5	CONSTRUCTION SAFETY PHASING PLAN PHASE 2	33	CROS
6	CONSTRUCTION SAFETY PHASING DETAILS	34	CROS
7	TYPICAL SECTIONS AND DETAILS	35	AIRFI
8	RUNWAY SURFACE ELEVATIONS	36	AIRFI
9	MILLING AND OVERLAY PLAN STA. 107+65.00 TO STA. 112+75.00	37	AIRFI
10	MILLING AND OVERLAY PLAN STA. 112+75.00 TO STA. 127+50.00	38	AIRFI
11	MILLING AND OVERLAY PLAN STA. 127+50.00 TO STA. 142+25.00	39	AIRFI
12	MILLING AND OVERLAY PLAN STA. 142+25.00 TO STA. 150+00.00	40	AIRFI
13	EXISTING CIVIL SITE DEMOLITION PLAN	41	AIRFI
14	PLAN AND PROFILE TAXIWAY "A"	42	AIRFI
15	GRADING PLAN	43	AIRFI
16	GROOVING PLAN AND DETAIL	44	AIRFI
17	PAVEMENT MARKING PLAN STA. 107+09.16 TO STA. 112+75.00	45	AIRFI
18	PAVEMENT MARKING PLAN STA. 112+75.00 TO STA. 127+50.00	46	AIRFI
19	PAVEMENT MARKING PLAN STA. 127+50.00 TO STA. 142+25.00	47	AIRFI
20	PAVEMENT MARKING PLAN STA. 142+25.00 TO STA. 150+00.00	48	AIRFI
21	STORMWATER POLLUTION PREVENTION PLAN	49	AIRFI
22	STORMWATER POLLUTION PREVENTION PLAN DETAILS	50-52	AIRFI
23	DRAINAGE DETAILS	53	AIRFI
24	CROSS SECTIONS RELOCATED TAXIWAY "A"	54	AIRFI
25	CROSS SECTIONS RELOCATED TAXIWAY "A"	55	AIRFI
26	CROSS SECTIONS RUNWAY 7-25		
27	CROSS SECTIONS RUNWAY 7-25		
28	CROSS SECTIONS RUNWAY 7-25		

	USER NAME = tneffsmith	DESIGNED - GSN	REVISED -	ROCHELLE MUNICIPAL AIRPORT	SUMMARY OF QUANTITIES	SECTION COUNTY TOTAL SHEET
		DRAWN - TNS	REVISED -	MAJOR THOMAS F. KORITZ FIELD	•	0GLE 55 2
	PLOT SCALE = 2.0000 / in.	CHECKED - TAW	REVISED -		AND INDEX OF SHEETS	
QUIGG ENGINEERING INC	PLOT DATE = 5/7/2019	DATE - 5/03/19	REVISED -	ROCHELLE, OGLE COUNTY, ILLINOIS	SCALE: 1"=1' SHEET 1 OF 1 SHEETS STA. TO STA.	ILLINOIS FED. AID PROJECT

## RC009

## INDEX OF SHEETS

### DESCRIPTION

COSS SECTIONS RUNWAY 7-25

T AND FILL TABLES

OSS SECTIONS BORROW AREA

OSS SECTIONS BORROW AREA

OSS SECTIONS BORROW AREA

FIELD LIGHTING LEGEND, GENERAL NOTES, AND ABBREVIATIONS

FIELD LIGHTING REMOVAL PLAN BASE BID STA. 112+75.00 TO STA. 127+50.00

FIELD LIGHTING REMOVAL PLAN BASE BID STA. 127+50.00 TO STA. 142+25.00

FIELD LIGHTING PLAN BASE BID STA 98+00.00 TO STA 112+75.00

FIELD LIGHTING PLAN BASE BID STA. 112+75.00 TO STA. 127+50.00

FIELD LIGHTING PLAN BASE BID STA. 127+50.00 TO STA. 142+25.00

FIELD LIGHTING PLAN BASE BID STA. 142+25.00 TO STA. 150+00.00

RFIELD LIGHTING REMOVAL PLAN ADDITIVE ALTERNATE STA. 98+00.00 TO STA. 112+75.00 RFIELD LIGHTING REMOVAL PLAN ADDITIVE ALTERNATE STA. 112+75.00 TO STA. 127+50.00

FIELD LIGHTING REMOVAL PLAN ADDITIVE ALTERNATE STA. 127+50.00 TO STA. 142+25.00

REFIELD LIGHTING REMOVAL PLAN ADDITIVE ALTERNATE STA. 142+25.00 TO STA. 150+00.00

FIELD LIGHTING PLAN ADDITIVE ALTERNATE STA. 98+00.00 TO STA. 112+75.00

FIELD LIGHTING PLAN ADDITIVE ALTERNATE STA. 112+75.00 TO STA. 127+50.00

FIELD LIGHTING PLAN ADDITIVE ALTERNATE STA. 127+50.00 TO STA. 142+25.00


FIELD LIGHTING PLAN ADDITIVE ALTERNATE STA. 142+25.00 TO STA. 150+00.00

FIELD LIGHTING DETAILS

FIELD LIGHTING VAULT WIRING DETAILS

FIELD LIGHTING DETAILS

FIELD LIGHTING DETAILS ADDITIVE ALTERNATE

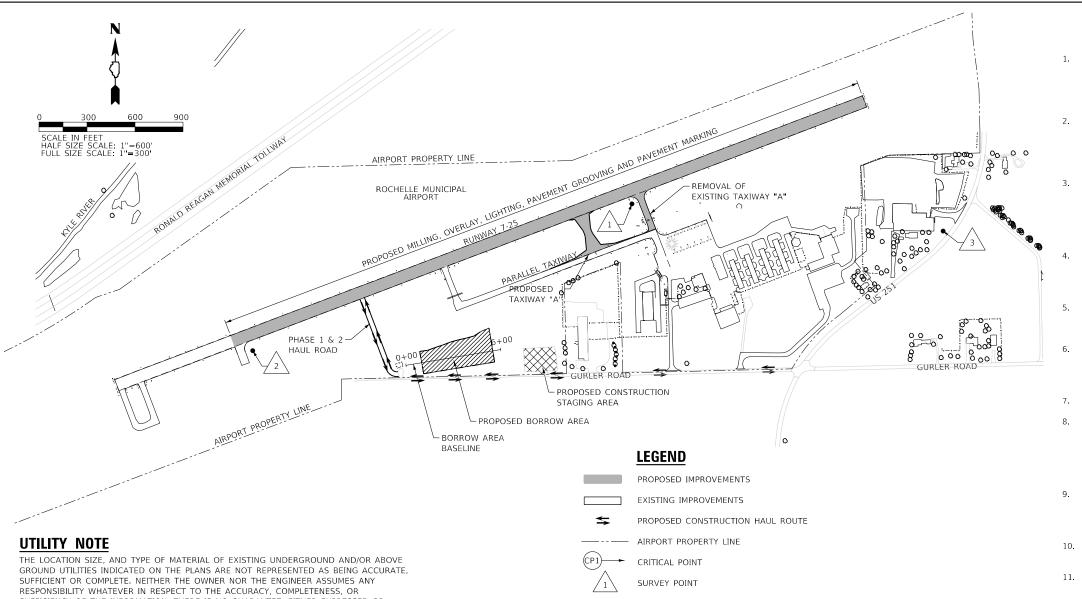

#### CONTROL POINT DATA

NO.	DESCRIPTION	NORTHING	EASTING	ELEV.
1	NGS STAINLESS STEEL ROD IN SLEEVE-"ROCHPORT"	1,905,524.80	2,593,429.93	774.18
2	NGS STAINLESS STEEL ROD IN SLEEVE-"ROCHPORT AZ MK"	1,904,607.07	2,591,059.02	769.60
З	NGS V223 DISK IN CONCRETE ON WEST SIDE OF RT. 251	1,905,355	2,595,375	782.95

#### SURVEY NOTES

- ALL COORDINATE VALUES SHOWN IN TABLE ARE BASED ON ILLINOIS STATE PLANE COORDINATES SYSTEM, WEST ZONE, NAD-83 (2007). ALL ELEVATIONS ARE REFERENCED TO NAVD 88.
- 2. THE CONTRACTOR SHALL BE RESPONSIBLE FOR ALL CONSTRUCTION LAYOUT AND ANY EXTENSION OF THE CONTROL NETWORK NEEDED TO PROPERLY COMPLETE THE WORK.
- 3. THE CONTRACTOR SHALL VERIFY ELEVATION AND DIMENSIONS SHOWN IN THE CONTRACT DOCUMENTS PRIOR TO THE COMMENCEMENT OF CONSTRUCTION. WHERE NEW WORK IS TO BE FITTED TO EXISTING, THE CONTRACTOR SHALL VERIFY DIMENSIONS AND CONDITIONS IN THE FIELD PRIOR TO THE START OF THE NEW WORK. ANY DISCREPANCIES FOUND SHALL BE REPORTED TO THE RESIDENT ENGINEER OR THE CONTRACTOR SHALL ASSUME RESPONSIBILITY FOR THE NEW WORK.

ALIGNMENT DATA							
ALIGNMENT	LIMITS	NORTHING	EASTING				
BUNNAN 7 85	BEGIN AT STA. 100+00	1904392.52	2590209.50				
RUNWAY 7-25	END AT STA. 150+00	1906166.49	2594884.22				
	BEGIN AT STA. 121+00	1904856.63	2592279.44				
PARALLEL TAXIWAY	END AT STA. 134+77.34	1905345.11	2593567.26				
	BEGIN AT STA. 0+00	1905208.57	2593207.28				
TAXIWAY "A"	END AT STA. 3+00.64	1905489.65	2593100.62				
	BEGIN AT STA. 0+00	1904515.59	2592017.14				
BORROW AREA	END AT STA. 6+00	1904614.13	2592608.99				

	USER NAME = tneffsmith	DESIGNED - GSN	REVISED -	ROCHELLE MUNICIPAL AIRPORT PROPOSED SCOPE OF WORK PLAN		SECTION COUNTY TOTAL SHEET
		DRAWN - TNS	REVISED -	MAJOR THOMAS F. KORITZ FIELD	& GENERAL NOTES	OGLE 55 3
	PLOT SCALE = 600.0000 ' / in.	CHECKED - TAW	REVISED -	ROCHELLE, OGLE COUNTY, ILLINOIS		CONTRACT NO. RC009
JUIGG ENGINEERING INC	PLOT DATE = 5///2019	DATE - 5/03/19	REVISED -		SCALE I =300 SHEET I OF I SHEETS STA. TO STA.	ILLINOIS FED. AID PROJECT

SUFFICIENCY OF THE INFORMATION. THERE IS NO GUARANTEE, EITHER EXPRESSED OR IMPLIED, THAT THE LOCATIONS, SIZE AND TYPE OF MATERIAL OF EXISTING UNDERGROUND UTILITIES INDICATED ARE REPRESENTATIVE OF THOSE TO BE ENCOUNTERED IN THE CONSTRUCTION. IT SHALL BE THE CONTRACTOR'S RESPONSIBILITY TO DETERMINE THE ACTUAL LOCATION OF ALL SUCH FACILITIES, INCLUDING SERVICE CONNECTIONS TO UNDERGROUND UTILITIES. PRIOR TO CONSTRUCTION, THE CONTRACTOR SHALL NOTIFY THE UTILITY COMPANIES OF HIS OPERATIONAL PLANS AND SHALL OBTAIN FROM THE RESPECTIVE UTILITY COMPANIES DETAILED INFORMATION AND ASSISTANCE RELATIVE TO THE LOCATION OF THEIR FACILITIES AND THE WORKING SCHEDULE OF THE COMPANIES FOR REMOVAL OR ADJUSTMENT WHERE REQUIRED. IN THE EVENT AN UNEXPECTED UTILITY INTERFERENCE IS ENCOUNTERED DURING CONSTRUCTION, THE CONTRACTOR SHALL IMMEDIATELY NOTIFY THE UTILITY COMPANY OF JURISDICTION. THE OWNER'S REPRESENTATIVE AND/ OR THE RESIDENT ENGINEER SHALL ALSO BE IMMEDIATELY NOTIFIED. ANY DAMAGE TO SUCH MAINS AND SERVICES SHALL BE RESTORED TO SERVICE AT ONCE AND PAID FOR BY THE CONTRACTOR AT NO ADDITIONAL COST TO THE CONTRACT. ALL UTILITY CABLES AND LINES SHALL BE LOCATED BY THE RESPECTIVE UTILITY. CONTACT J.U.L.I.E. ( JOINT UTILITY LOCATION INFORMATION FOR EXCAVATIONS) FOR UTILITY INFORMATION, PHONE: 1-800-892-0123. CONTACT THE FAA (FEDERAL AVIATION ADMINISTRATION) FOR ASSISTANCE IN LOCATING FAA CABLES AND UTILITIES. LOCATION OF FAA POWER, CONTROL, AND COMMUNICATION CABLES SHALL BE COORDINATED WITH AND/ OR LOCATED BY THE FAA. ALSO CONTACT AIRPORT DIRECTOR/MANAGER AND AIRPORT PERSONNEL FOR ASSISTANCE IN LOCATING UNDERGROUND AIRPORT CABLES AND/ OR UTILITIES. ALSO COORDINATE WORK WITH ALL ABOVEGROUND UTILITIES.

### **GENERAL NOTES**

THE SCOPE OF WORK SHEET IS INTENDED ONLY AS A GENERAL DESCRIPTION OF WORK ITEMS AND THEIR APPROXIMATE LOCATIONS AND LIMITS, FOR THE PURPOSE OF UNDERSTANDING THE SCOPE OF THE PROJECT. THIS SHEET SHALL NOT BE USED AS A CONSTRUCTION PLAN. REFER TO THE FOLLOWING PLAN SHEET FOR DETAILED CONSTRUCTION REQUIREMENTS, LOCATIONS, AND ITEMS OF WORK.

**RC009** 

WORK FOR THIS PROJECT SHALL CONSIST OF, BUT IS NOT LIMITED TO, UNCLASSIFIED AND ONSITE BORROW EXCAVATION, INSTALLATION OF DRAINAGE PIPE AND STRUCTURES, PLACEMENT OF CRUSHED AGGREGATE BASE COURSE, PLACEMENT OF BITUMINOUS PAVEMENT, MILLING, PAVEMENT GROOVING, PAVEMENT MARKING, INSTALLATION OF TAXIWAY LIGHTING, EROSION CONTROL, SEEDING AND ALL OTHER ASSOCIATED ITEMS.

THE PROJECT PAY ITEMS ARE INTENDED TO BE INCLUSIVE OF ALL WORK TO BE PERFORMED AS SHOWN IN THESE PLANS, ALL INCIDENTAL WORK REQUIRED TO COMPLETE THE PROJECT TO THE SATISFACTION OF THE RESIDENT ENGINEER IS TO BE INCLUDED IN THE COSTS OF PERFORMING THESE ITEMS. THE CONTRACTOR SHALL FURNISH ALL LABOR, MATERIAL, EQUIPMENT, AND TRANSPORTATION NECESSARY TO CONSTRUCT ALL ELEMENTS OF THE PROJECT AS DESCRIBED IN THE CONSTRUCTION PLANS AND SPECIFICATIONS.

THE RULES, REGULATIONS AND SPECIFICATIONS ENUMERATED HEREIN SHALL BE CONSIDERED AS MINIMUM REQUIREMENT. THEY SHALL NOT PROHIBIT THE CONTRACTOR FROM FURNISHING AND INSTALLING HIGHER GRADES OF MATERIAL THAN ARE SPECIFIED HEREIN, IF APPROVED BY THE ENGINEER.

ACCESS TO THE SITE SHALL BE RESTRICTED EXCLUSIVELY TO THE DESIGNATED CONSTRUCTION ENTRANCE, STAGING AREA, AND HAUL ROUTE. NO EQUIPMENT OR PERSONNEL SHALL BE PERMITTED OUTSIDE THE GENERAL PROJECT AREA.

IT SHALL BE THE RESPONSIBILITY OF THE CONTRACTOR TO PROTECT AND KEEP CLEAN OF DEBRIS ALL EXISTING AIRFIELD AND ROADWAY PAVEMENTS AT ALL TIMES. ANY DAMAGE TO EXISTING ELECTRICAL, DRAINAGE, AND PAVEMENT STRUCTURES SHALL BE IMMEDIATELY REPAIRED AT NO ADDITIONAL COST TO THE CONTRACT.

CONTRACTOR IS REQUIRED TO PROVIDE THEIR OWN RESTROOM FACILITIES.

THE OWNER SHALL HAVE THE RIGHT OF FIRST REFUSAL FOR ALL SALVAGEABLE MATERIAL REMOVED ON THE PROJECT. THE AIRPORT HAS EXPRESSED INTEREST IN RETAINING THE PIPE CULVERTS AND END SECTIONS UNDER EXISTING TAXIWAY "A" AND A PORTION OF THE RUNWAY MILLINGS. THE LOCATION OF DISPOSAL OF THE ITEMS SHALL BE COORDINATED WITH THE ENGINEER OR AIRPORT MANAGER. ALL OTHER WASTE MATERIAL SHALL BE HAULED FROM THE AIRPORT AND PROPERLY DISPOSED OF UNLESS SPECIFIED HEREIN.

THE CONTRACTOR SHALL BE RESPONSIBLE FOR OBTAINING PERMITS FOR HAULING ON PUBLIC ROADS, AS APPLICABLE. THE CONTRACTOR SHALL BE RESPONSIBLE FOR CORRECTING ANY DAMAGES TO ANY PAVEMENTS (PUBLIC OR PRIVATE) CAUSED BY THEIR CONSTRUCTION EQUIPMENT OR PERSONNEL.

10. THE CONTRACTOR SHALL PROVIDE ONE SET OF REDLINED RECORD DRAWINGS TO THE RESIDENT ENGINEER AT THE COMPLETION OF THE PROJECT.

11. CONTRACTOR SHALL NOTE THAT ALL AREAS WITHIN THE AIRPORT PROPERTY LINE AND OUTSIDE THE CONSTRUCTION LIMITS MAY BE USED FOR AGRICULTURE PURPOSES. THE CONSTRUCTION LIMITS SHALL BE RESTRICTED TO AREAS THAT ARE ABSOLUTELY NECESSARY TO DISTURB TO COMPLETE THE REQUIRED WORK ITEMS. LIMITS SHALL BE COORDINATED WITH THE RESIDENT ENGINEER PRIOR TO BEGINNING ANY WORK. ALL AREAS DISTURBED BY CONSTRUCTION ACTIVITY WHICH HAVE BEEN PREVIOUSLY FARMED OR ARE DESIGNATED TO BE FARMED AFTER THE PROJECT COMPLETION SHALL BE CHISEL PLOWED OR OTHERWISE SCARIFIED TO RETURN THE AREA TO A REASONABLE TILLABLE CONDITION (IF SO PERMITTED BY THE AIRPORT MANAGER) AT THE CONTRACTOR'S EXPENSE.

APPROXIMATE LOCATIONS OF UNDERGROUND UTILITIES ARE SHOWN THROUGHOUT THESE PLANS. THE CONTRACTOR SHALL DETERMINE EXACT LOCATIONS AND PROTECT THESE UTILITIES DURING CONSTRUCTION. ANY UTILITIES DAMAGED DURING CONSTRUCTION SHALL BE REPAIRED AT THE CONTRACTOR'S EXPENSE. CONTRACTOR SHALL COORDINATE WITH THE PROPER AUTHORITIES FOR THE PURPOSE OF LOCATING AND PROTECTING EXISTING UNDERGROUND UTILITIES.

13. THE CONTRACTOR MUST AT ALL TIMES MAINTAIN PROPER DRAINAGE AND EROSION CONTROL FOR ALL AREAS AFFECTED BY HIS WORK.


12.

15.

14. THIS PROJECT WILL DISTURB MORE THAN 1 ACRE, THEREFORE A NPDES PERMIT IS REQUIRED. THE CONTRACTOR IS RESPONSIBLE FOR IMPLEMENTING AND MAINTAINING THE EROSION CONTROL MEASURES AS SHOWN IN THE STORMWATER POLLUTION PREVENTION PLAN (SWPP) AND IN ACCORDANCE WITH THE STANDARDS AND <u>SPECIFICATIONS FOR SOIL</u> <u>EROSION AND SEDIMENT CONTROL</u>, ILLINOIS ENVIRONMENTAL PROTECTION AGENCY, CURRENT ISSUE.

<u>MATERIAL CERTIFICATIONS</u> - COMPLETED WORK ITEMS <u>CANNOT</u> BE PLACED ON A CONSTRUCTION REPORT FOR PAYMENT UNTIL <u>ALL</u> THE MATERIAL CERTIFICATIONS FOR THAT ITEM HAVE BEEN RECEIVED, REVIEWED AND ACCEPTED BY THE RESIDENT ENGINEER.

16. <u>CERTIFIED PAYROLLS</u> - THE RESIDENT ENGINEER <u>CANNOT</u> FORWARD A CONSTRUCTION REPORT FOR PAYMENT TO THE IDOT - DIVISION OF AERONAUTICS FOR PROCESSING UNTIL <u>ALL</u> CERTIFIED PAYROLLS FOR THAT PERIOD HAVE BEEN RECEIVED.

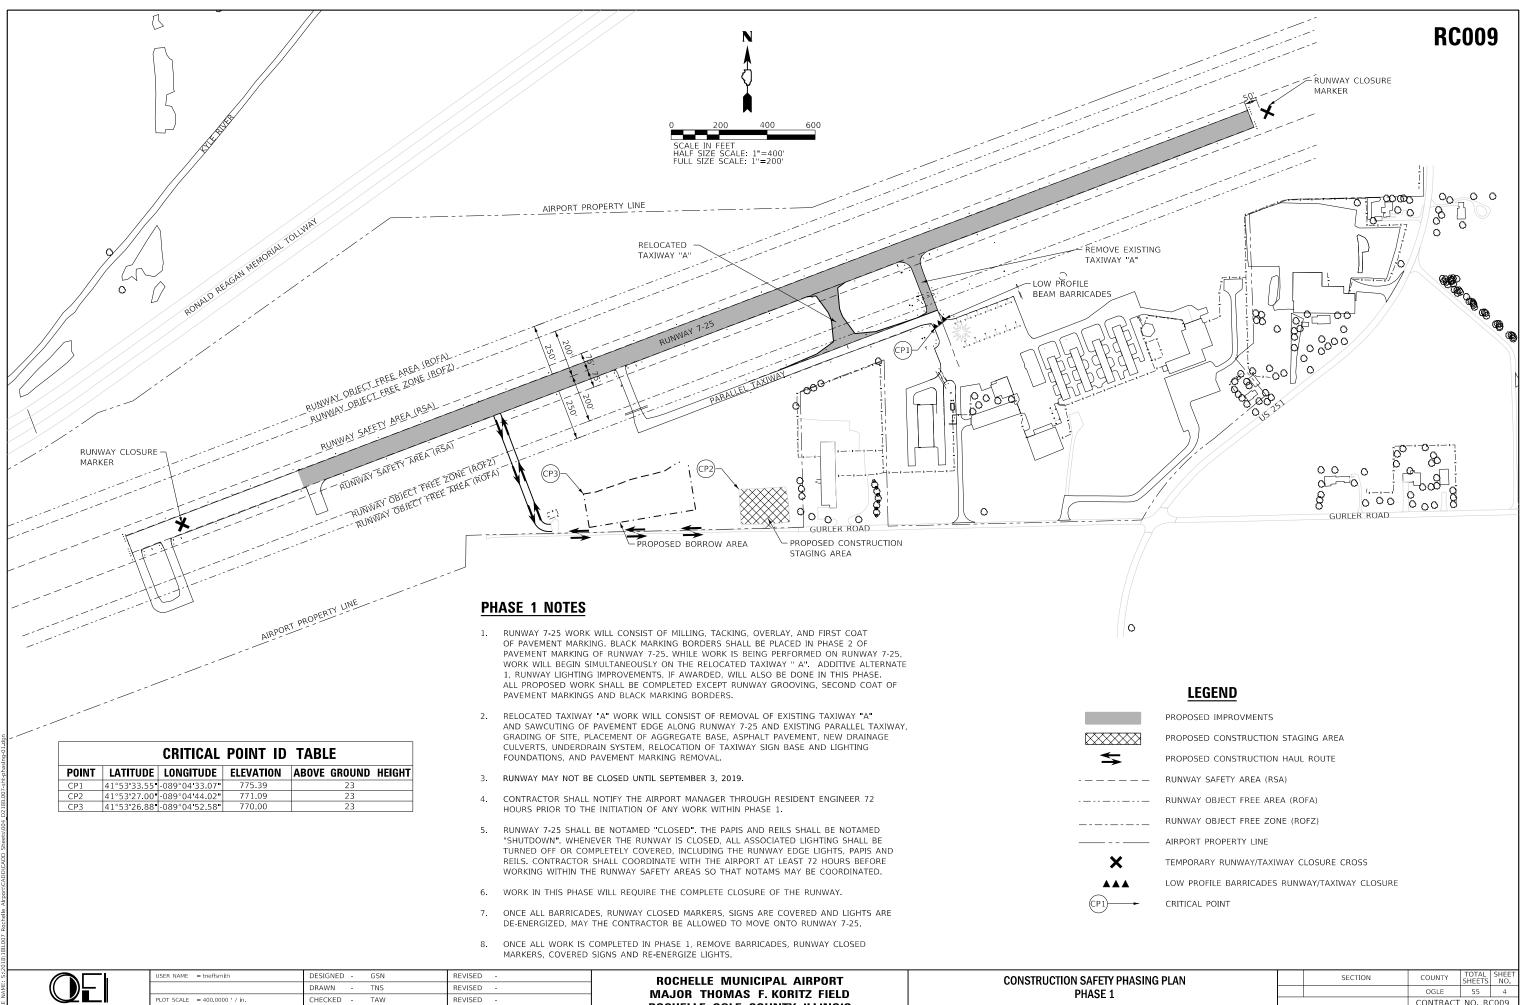

**MAJOR THOMAS F. KORITZ FIELD** TAW REVISED **ROCHELLE, OGLE COUNTY, ILLINOIS** REVISED 5/03/19

OT SCALE = 400.0000 ' / in.

DATE


PLOT DATE = 5/7/2019

QUIGG ENGINEERING INC

SCALE: 1"=200' SHEET 1 OF 2 SHEET

	PROPOSED IMPROVMENTS
$\sim$	PROPOSED CONSTRUCTION STAGING AREA
•	PROPOSED CONSTRUCTION HAUL ROUTE
	RUNWAY SAFETY AREA (RSA)
	RUNWAY OBJECT FREE AREA (ROFA)
	RUNWAY OBJECT FREE ZONE (ROFZ)
	AIRPORT PROPERTY LINE
X	TEMPORARY RUNWAY/TAXIWAY CLOSURE CROSS
	LOW PROFILE BARRICADES RUNWAY/TAXIWAY CLOSURE
	CRITICAL POINT

Y PHASING PLAN			SECT	ION		COUNTY	TOTAL SHEETS	SHEET NO.
						OGLE	55	4
						CONTRACT	NO. RO	2009
ГS	STA.	TO STA.	ILLINOIS FED. AID PROJECT					

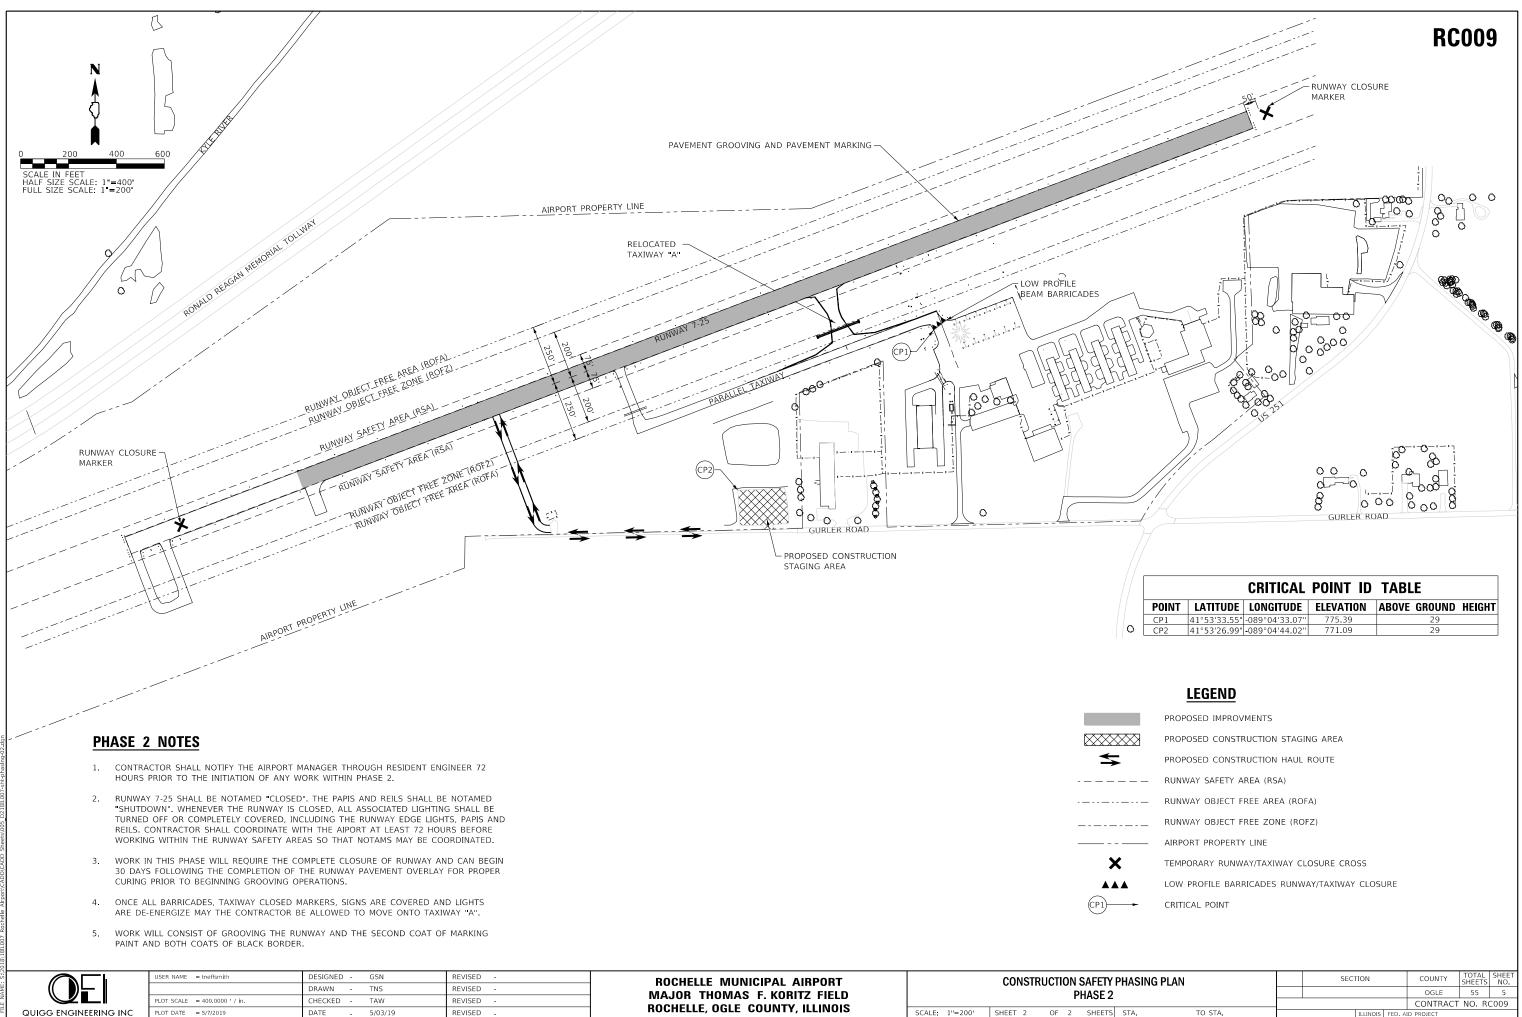

	PROPOSED IMPROVMENTS
$\times$	PROPOSED CONSTRUCTION STAGING AREA
\$	PROPOSED CONSTRUCTION HAUL ROUTE
	RUNWAY SAFETY AREA (RSA)
	RUNWAY OBJECT FREE AREA (ROFA)
	RUNWAY OBJECT FREE ZONE (ROFZ)
	AIRPORT PROPERTY LINE
×	TEMPORARY RUNWAY/TAXIWAY CLOSURE CROSS
	LOW PROFILE BARRICADES RUNWAY/TAXIWAY CLOSURE
1)	CRITICAL POINT
-	

Y PHASING PLAN 2			SECT	ION	COUNTY	TOTAL SHEETS	SHEET NO.
					OGLE	55	5
					CONTRACT	NO. RO	2009
ГS	STA.	TO STA.	ILLINOIS FED. AID PROJECT				

#### SAFETY AND PHASING PLAN

- GENERAL THE ROCHELLE MUNICIPAL AIRPORT IS COMPRISED OF A SINGLE PAVED RUNWAY AND PARTIAL PARALLEL TAXIWAY. THE PROPOSED CONSTRUCTION WILL NECESSITATE CLOSING BOTH THE RUNWAY AND TAXIWAY AT CERTAIN TIMES. THE CONTRACTOR SHALL COORDINATE ALL CLOSURES WITH THE AIRPORT MANAGER, TEMPORARY MARKINGS. BARRICADES AND CLOSER CROSSES SHALL BE PLACED AND MAINTAINED AS DETAILED ON THIS SHEET AND AS DIRECTED BY THE ENGINEER, ALL CONSTRUCTION/OPERATIONS ARE TO BE PERFORMED IN ACCORDANCE WITH FAA ADVISORY CIRCULAR (AC) 150/5370-2 (CURRENT EDITION) "OPERATION SAFETY"ON AIRPORTS DURING CONSTRUCTION"AND AC 150/5300-13 (CURRENT EDITION) "AIRPORT DESIGN". ALL COSTS ASSOCIATED WITH THE WORK AND MATERIALS INVOLVING CONSTRUCTION SAFETY AND PHASING AS SHOWN ON THIS SHEET, OR AS OTHERWISE DIRECTED BY THE ENGINEER OR AIRPORT MANAGER SHALL BE INCIDENTAL TO THE PROJECT.
- AIRCRAFT OPERATION LINE THE CONTRACTOR WILL LOCATE THIS LINE AT THE START OF CONSTRUCTION AND WILL PLACE AND MAINTAIN A FLAGGED LATHE EVERY 150 FEET ALONG IT THROUGH THE PROJECT AREA. NO CONSTRUCTION PERSONNEL OR EQUIPMENT MAY CROSS TIS LINE WITHOUT THE RUNWAY BEING CLOSED.
- RUNWAY CLOSURES RUNWAY 7-25 AND THE EXISTING TAXIWAY SHALL BE CLOSED ANY TIME THE CONTRACTOR INTENDS TO WORK WITHIN 200 FEET OF THE RUNWAY CENTERLINE OR 66 FEET OF THE EXISTING TAXIWAY CENTERLINE, AS DICTATED BY FAA CRITERIA AND DELINEATED ON THIS SHEET BY "AIRCRAFT OPERATION LINE". THE AIRPORT MANAGER HAS COMPLETE AUTHORITY ON DETERMINING WHEN THE RUNWAY MAY BE CLOSED.

#### CONSTRUCTION OPERATIONS

- WORK CAN BEGIN ON TUESDAY SEPTEMBER 3, 2019
- CONSTRUCTION WORK WILL BE LIMITED TO MONDAY THROUGH THURSDAY.
- ALL CONSTRUCTION EQUIPMENT AND MATERIALS SHALL BE MOVED FROM THE AIRFIELD WORKING AREA AND STORED IN THE CONSTRUCTION STAGING AREA FRIDAY THROUGH SUNDAY.

#### RUNWAY/TAXIWAY\_CLOSURE\_PROCEDURES:

- CONTACT AIRPORT MANAGER OR ASSIGNED REPRESENTATIVE A MINIMUM OF 72 HOURS BEFORE THE DESIRED CLOSING TIME.
- ISSUANCE OF NOTAM AND DEACTIVATION OF THE AIRFIELD LIGHTING AND NAVAIDS BY AIRPORT MANAGEMENT.
- PLACEMENT OF CROSSES, THEN LIGHTED BARRICADES ONLY AT THE TIME ALL OF THE ABOVE ARE COMPLETED MAY ANY CONSTRUCTION OPERATIONS WITHIN 200 FEET OR RUNWAY 7-25 OR WITHIN 66 FEET OF THE EXISTING CENTERLINE CAN BEGIN.

#### RUNWAY/TAXIWAY RE-OPENING PROCEDURES:

- REMOVE LIGHTED BARRICADES. THEN CROSSES. NOTIFY THE AIRPORT MANAGEMENT TOR
- REPRESENTATIVE TO CANCEL THE NOTAM. ACTIVATION OF THE AIRFIELD LIGHTING AND NAVAIDS AND CANCELLATION OF THE NOTAM BY THE AIRPORT MANAGEMENT.
- A CLOSED RUNWAY WILL NOT BE RE-OPENED UNTIL ALL EQUIPMENT AND WORK ARE FURTHER THAN 200 FEET FROM THE RUNWAY CENTERLINE OR 66 FEET FROM THE CENTERLINE OF THE EXISTING TAXIWAY.
- RADIO CONTROL THE CONTRACTOR WILL BE REQUIRED TO BE IN CONSTANT TWO-WAY RADIO CONTACT WITH THE ROCHELLE MUNICIPAL UNICOM 122,975 NHZ) WHILE THEY HAVE PERSONNEL OR EQUIPMENT ON THE AIRFIELD

#### **SAFETY AND PHASING NOTES**

- ALL PROVISIONS OF THE LATEST EDITION OF FAA ADVISORY CIRCULAR AC 150/5370-2 (CURRENT EDITION) "OPERATIONAL SAFETY ON AIRPORTS DURING CONSTRUCTION", APPLY TO THE CONTRACT EXCEPT AS MODIFIED BY THIS SAFETY PLAN, OR AS MODIFIED BY THE OWNER THROUGH THE RESIDENT ENGINEER AT THE PRECONSTRUCTION CONFERENCE, OR DURING THE COURSE OF THE CONTRACT
- THE CONTRACTOR SHALL MINIMIZE DISRUPTION OF STANDARD OPERATING PROCEDURES FOR 2. AERONAUTICAL ACTIVITY BY REMAINING WITH THE PRESCRIBED STAGING, CONSTRUCTION, AND PHASING AREAS PRESENTED ON THE PROJECT SAFETY AND PHASING PLANS, THE ENGINEER, ENGINEER'S REPRESENTATIVE AND/OR AIRPORT MANAGER RESERVE THE RIGHT TO SUSPEND OPERATIONS IN ORDER TO MAINTAIN SAFETY AT THE AIRPORT.
- ALL CONSTRUCTION EQUIPMENT OPERATING IN THE PRESCRIBED CONSTRUCTION AREA ARE REQUIRED TO DISPLAY A CHECKERBOARD FLAG PROPERLY LOCATED OR A ROTATING BEACON (STROBE) AS SPECIFIED IN AC 150/5210-5 (CURRENT EDITION) "PAINTING, MARKING, AND LIGHTING OF VEHICLES USED ON AN AIRPORT"
- CLOSED AIRFIELD PHASING AREAS, OPEN TRENCHES, 4 AND OTHER HAZARDOUS AREAS AT THE CONSTRUCTION SITE SHALL BE PROMINENTLY MARKED WITH LIGHTED BARRICADES WITH STEADY BURN OR FLASHING RED LIGHTS AS SPECIFIED IN 150/5370-2 (CURRENT EDITION) "OPERATIONAL SAFETY ON AIRPORT DURING CONSTRUCTION. LIGHTED BARRICADES MUST BE NO TALLER THAN 18", EXCLUSIVE OF SUPPLEMENTARY LIGHTS AND FLAGS, ON THE TAXIWAYS OR RAMPS AND COMPLY WITH ADVISORY CIRCULAR 150/5370-2 (CURRENT EDITION) CONTRACTOR SHALL CHECK BARRICADES NIGHTLY FOR PROPER OPERATION
- NO CONSTRUCTION EQUIPMENT GREATER THAN 23' TALL WILL BE PERMITTED ON THE AIRPORT WITHOUT APPROVAL OF THE AIRPORT MANAGER AND AIRSPACE APPROVAL BY THE FAA.
- SOIL DEBRIS AND LOOSE MATERIAL DROPPED OR 6 TRUCKED ONTO AIRPORT ROADS, TAXIWAYS AND SOD SURFACES, OR WHICH CAN BE BLOWN ONTO SUCH SURFACES, SHALL BE IMMEDIATELY SWEPT, PICKED UP AND REMOVED, OR PLACED INTO CLOSED CONTAINERS ANY DAMAGE TO AIRPORT PROPERTY SHALL BE REPAIRED IMMEDIATELY AT NO COST TO THE OWNER.
- CONTRACTOR SHALL BE RESPONSIBLE FOR LOCATING 7. AND MAINTAINING AIRPORT LIGHTING AND NAVIGATIONAL ELECTRICAL SYSTEMS DURING CONSTRUCTION. A CONTACT PERSON AND TELEPHONE NUMBER FOR 24 HOUR EMERGENCY IMMEDIATE REPAIR SHALL BE SUBMITTED TO THE AIRPORT MANAGER AND ENGINEER.
- HALL ROUTES CROSSING PAVEMENT DRAINAGE 8 STRUCTURES AND AIRFIELD CABLES SHALL BE PROTECTED FROM DAMAGE
- ALL AIRCRAFT AND AIRPORT OPERATIONS HAVE THE 9 RIGHT OF WAY. CONTRACTOR SHALL YIELD TO VEHICLES AND REMAIN CLEAR AT ALL TIMES.
- 10. THE CONTRACTOR SHALL UTILIZE WATER AND/OR CHEMICAL APPROVED BY THE RESIDENT ENGINEER AS NECESSARY TO CONTROL DUST.

### SUGGESTED SEQUENCE OF **CONSTRUCTION – PHASE 1**

- COORDINATE CLOSURES WITH RESIDENT ENGINEER 1. AND AIRPORT MANAGER
- 2. PLACE CLOSED RUNWAY MARKERS AND BARRICADES AS SHOWN OR DIRECTED BY THE ENGINEER.
- PLACE TEMPORARY EROSION CONTROL ITEMS OF WORK.
- REMOVE EXISTING TAXIWAY "A" 4
- 5. CONSTRUCT PROPOSED TAXIWAY "A"
- REHABILITATE RUNWAY 7/25 LIGHTING AND CIRCUIT (ADDITIVE ALTERNATIVE).
- MILL RUNWAY 7/25 EXISTING PAVEMENT.
- CLEAN AND SEAL BIT. CRACKS, AND SAND MIX CRACK 8. REPAIR
- APPLY TACK COAT TO RUNWAY 7/25 AND CONSTRUCT HMA PAVEMENT OVERLAY.
- PLACE RUNWAY 7/25 PAVEMENT MARKING 1ST 10. COAT
- 11. LANDSCAPE TO RUNWAY 7 / 25 GRADING LIMITS
- 12 CLEAN PAVEMENTS RESTORE DISTURBED WORK AREAS, AND REMOVE MISCELLANEOUS DEBRIS FROM WORK AREA
- 13. COORDINATE OPENING OF RUNWAY PAVEMENTS WITH RESIDENT ENGINEER AND AIRPORT MANAGER.
- REMOVE CLOSED RUNWAY MARKERS AND BARRICADES.

### SUGGESTED SEQUENCE OF **CONSTRUCTION – PHASE 2**


- COORDINATE CLOSURES WITH RESIDENT ENGINEER 1. AND AIRPORT MANAGER.
- PLACE CLOSED RUNWAY MARKERS AND BARRICADES 2. AS SHOWN OR DIRECTED BY THE ENGINEER.
- PROVIDE 30 CALENDAR DAY CURING PERIOD OR AS 3 APPROVED BY THE ENGINEER PRIOR TO RUNWAY 7 / 25 BITUMIOUS PAVEMENT GROOVING (SUSPEND CONTRACT TIME)
- CONSTRUCT RUNWAY 7 / 25 BITUMINOUS GROOVING.
- PLACE RUNWAY 7 / 25 PAVEMENT MARKING 2ND 5. COAT
- CLEAN PAVEMENTS, RESTORE DISTURBED WORK AREAS, AND REMOVE MISCELLANEOUS DEBRIS FROM WORK AREA
- COORDINATE OPENING OF RUNWAY PAVEMENTS WITH RESIDENT ENGINEER AND AIRPORT MANAGER.
- REMOVE CLOSED RUNWAY MARKERS AND 8 BARRICADES

#### PHASE 2 – NOTES

NO ADDITIONAL COST TO CONTRACT FOR REMOBILIZATION AND 2ND COAT PAVEMENT MARKING.

WORK AREA	ALLOWABLE WORK PERIOD	s
PHASE 1 RUNWAY 7/25 REHAB RUNWAY AND CIRCUIT (ADD. ALT.) RUNWAY MILLING	56 CALENDAR DAYS	RL
RUNWAY TACKING		
RUNWAY HMA OVERLAY		
RUNWAY PAVEMENT MARKING - FIRST COAT ONLY		
REMOVE EXISTING TAXIWAY "A"		
CONSTRUCT NEW TAXIWAY "A"		
LANDSCAPING		
SUSPEND CONTRACT TIME - AWAITING CURE FOR BIT. PVMT.	30 CALENDAR DAYS	
PHASE 2		R
RUNWAY GROOVING RUNWAY PAVEMENT MARKING - FINAL	11 CALENDAR DAYS	
	1.4	36"
	-	
OR	ANGE —	

WHITE

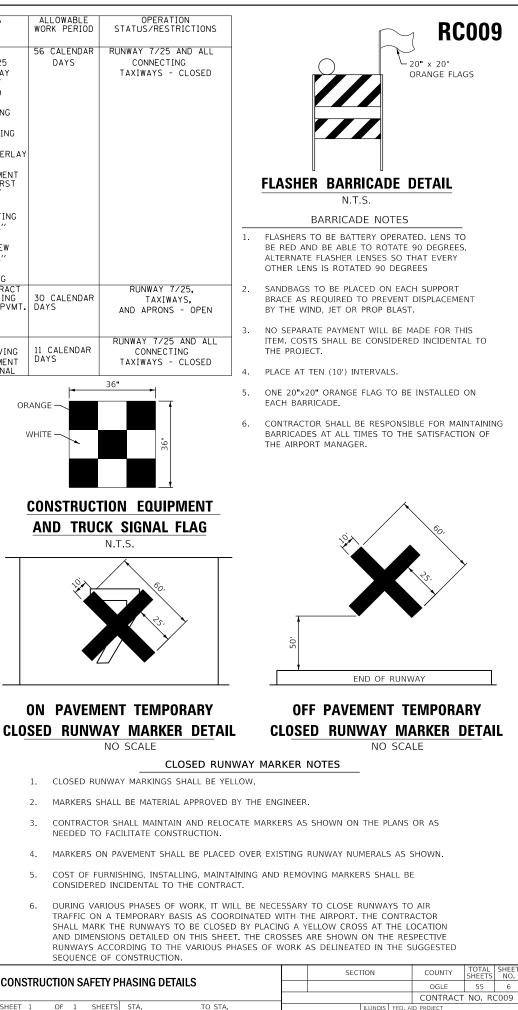


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- 2
- 3
- 5.
- 6.



	USER NAME = tneffsmith	DESIGNED - GSN DRAWN - TNS	REVISED - REVISED -	ROCHELLE MUNICIPAL AIRPORT Major Thomas F. Koritz Field		CONSTRUCTION S
	PLOT SCALE = 2.0000 ' / in	CHECKED - TAW	REVISED -			
NEERING INC	PLOT DATE = 5/7/2019	DATE - 5/03/19	REVISED -	ROCHELLE, OGLE COUNTY, ILLINOIS	SCALE: 1"=1'	SHEET 1 OF 1

1					CONTRACT NO.
	STA.	TO STA.	ILLINOIS	FED. AI	D PROJECT

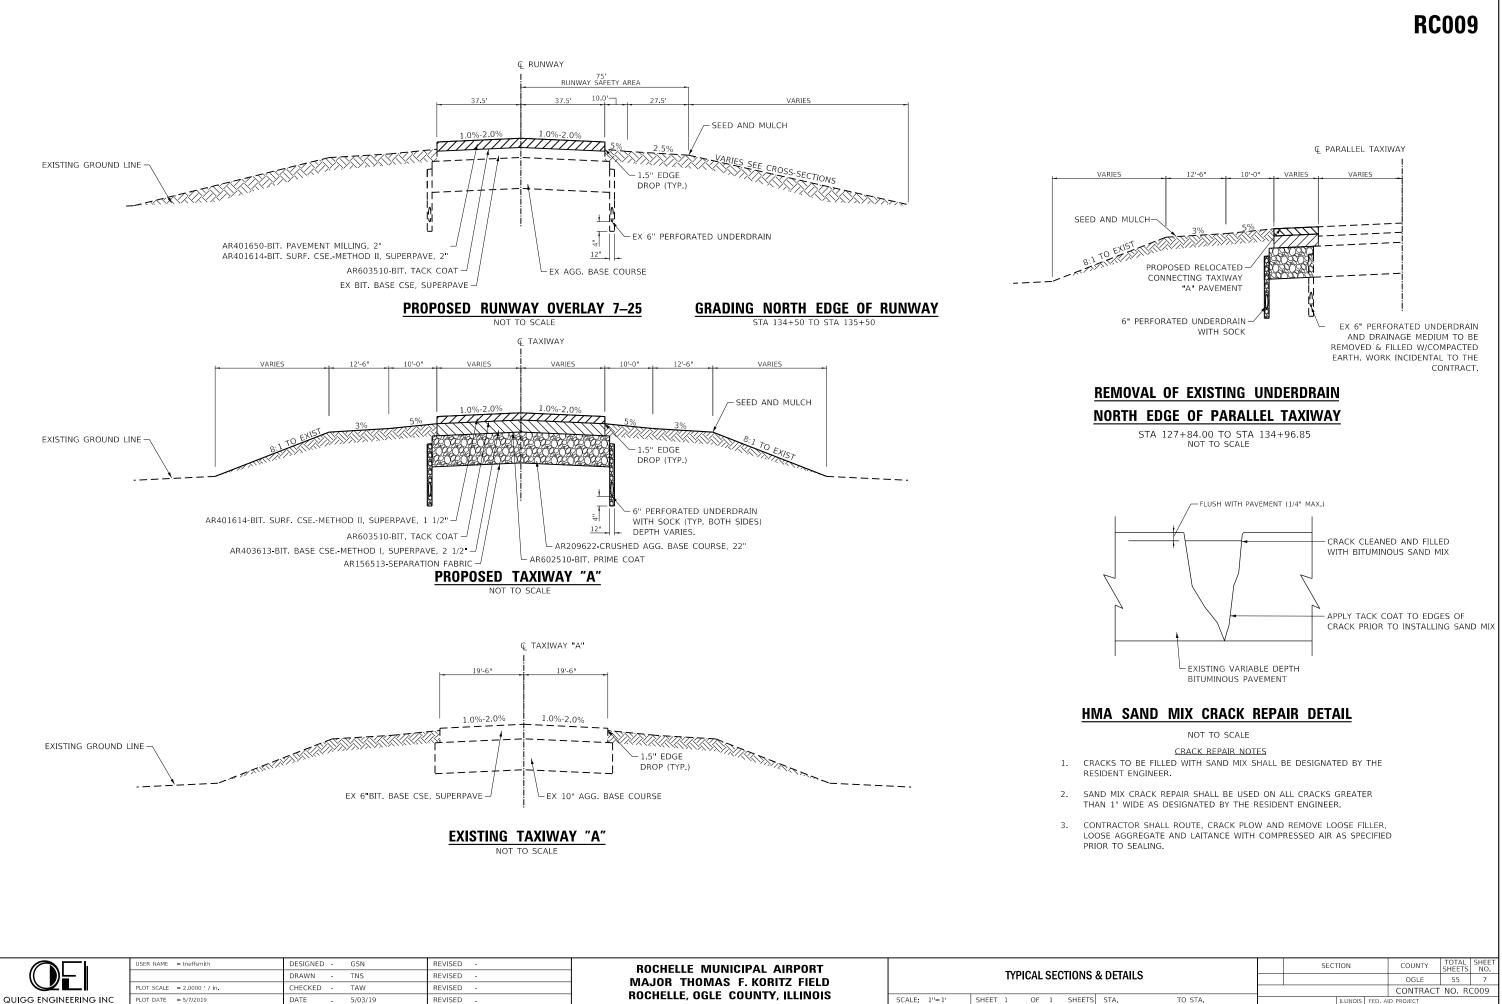


IS & DETAILS		JEC	ION		COONTI	SHEETS	NO.	
					OGLE	55	7	
					CONTRACT	NO. RO	2009	
TS	STA.	TO STA.		ILLINOIS	FED. AI	D PROJECT		

l	RUNWAY SURF	ACE ELEVATI	ONS
EXI	STING & PRO	DPOSED ELEV	ATIONS
STATION	LEFT EDGE	CENTERLINE	RIGHT EDGE
107+65	771.50	772.13	771.60
108+00	771.45	772.08	771.62
108+50	771.30	772.03	771.52
109+00	771.18	771.89	771.36
109+50	771.14	771.83	771.28
110+00	771.06	771.78	771.16
110+50	770.98	771.66	771.02
111+00	770.91	771.62	770.92
111+50	770.84	771.57	770.89
112+00	770.76	771.48	770.83
112+50	770.72	771.40	770.77
113+00	770.65	771.32	770.72
113+50	770.57	771.29	770.71
114+00	770.47	771.17	770.61
114+50	770.41	771.09	770.52
115+00	770.36	771.07	770.45
115+50	770.28	771.02	770.36
116+00	770.21	770.93	770.31
116+50	770.18	770.86	770.28
117+00	770.18	770.83	770.27
117+50	770.18	770.80	770.29
118+00	770.20	770.81	770.26
118+50	770.25	770.85	770.37
119+00	770.37	770.97	770.44
119+50	770.52	771.18	770.59
120+00	770.66	771.34	770.73
120+50	770.78	771.46	770.86
121+00	770.90	771.57	770.96
121+50	771.03	771.68	771.04
122+00	771.19	771.82	771.15
122+00	771.40	771.99	771.33
122+50	771.61	772.15	771.56
123+00	771.77	772.31	771.86
123+50	771.90	772.51	772.08
		772.73	772.30
124+50	772.10		
	772.33	773.01	772.49
125+50	772.51	773.20	772.70
126+00	772.70	773.37	772.88
126+50	772.88	773.57	772.95
127+00	773.05	773.76	773.16
127+50	773.23	773.94	773.32
128+00	773.45	774.14	773.54
128+50	773.70	774.36	773.70


	RUNWAY SURF	FACE ELEVAT	ONS			RC0
EXI	ISTING & PRO	OPOSED ELEV	ATIONS	4		
STATION	LEFT EDGE	CENTERLINE	RIGHT EDGE	-		
129+00	773.93	774.61	773.92			
129+50	774.19	774.82	774.11			
130+00	774.32	774.95	774.30	-		
130+50	774.49	775.14	774.55	-		
131+00	774.72	775.33	774.75	-		
131+50	774.93	775.50	774.95	-		
132+00	775.06	775.64	774.97	-		
132+50	775.22	775.81	775.23	-		
133+00	775.35	775.96	775.29	-		
133+50	775.41	776.02	775.32			
134+00	775.38	776.03	775.48	-		
134+50	775.38	776.07	775.69			
135+00	775.44	776.07	775.72	1		
135+50	775.46	776.04	775.58			
136+00	775.40	776.03	775.47			
136+50	775.36	776.04	775.39			
137+00	775.35	776.03	775.41			
137+50	775.34	776.01	775.47			
138+00	775.37	776.01	775.48			
138+50	775.41	776.02	775.50			
139+00	775.40	776.03	775.50			
139+50	775.44	776.07	775.58			
140+00	775.55	776.18	775.74	-		
140+50	775.64	776.30	775.80			
141+00	775.78	776.44	775.87			
141+50	775.99	776.61	776.00			
142+00	776.22	776.81	776.21			
142+50	776.42	777.07	776.47			
143+00	776.68	777.31	776.73			
143+50	777.00	777.63	777.05	1		
144+00	777.30	777.94	777.34	1		
144+50	777.64	778.25	777.65	1		
145+00	777.91	778.55	777.97			
145+50	778.25	778.87	778.30	]		
146+00	778.55	779.19	778.64	]		
146+50	778.84	779.46	778.90			
147+00	779.14	779.72	779.21			
147+50	779.49	779.98	779.53	]		
148+00	779.71	780.20	779.73	]		
148+50	779.83	780.36	779.90			
149+00	779.93	780.53	780.07			
149+50	780.08	780.80	780.27	1		
150+00	780.29	780.98	780.39	]		
				-	I	1 1 70
		RUNWAY SI	JRFACE ELEVATION	IS	 SECTION	COUNTY TO SHE OGLE 5




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		DRAWN - TNS	REVISED -	MAJOR THOMAS F. KORITZ FIELD		RUNWAY SURFACE ELEVATIONS			OGLE	55	8
	PLOT SCALE = 2.0000 / in.	CHECKED - TAW	REVISED -	ROCHELLE, OGLE COUNTY, ILLINOIS					CONTRACT	NO. RC	209
NEERING INC	PLOT DATE = 5/7/2019	DATE - 5/03/19	REVISED -		SCALE: 1"=1'	SHEET 1 OF 1 SHEETS STA.	TO STA.	ILLINOIS	FED. AID PROJECT		

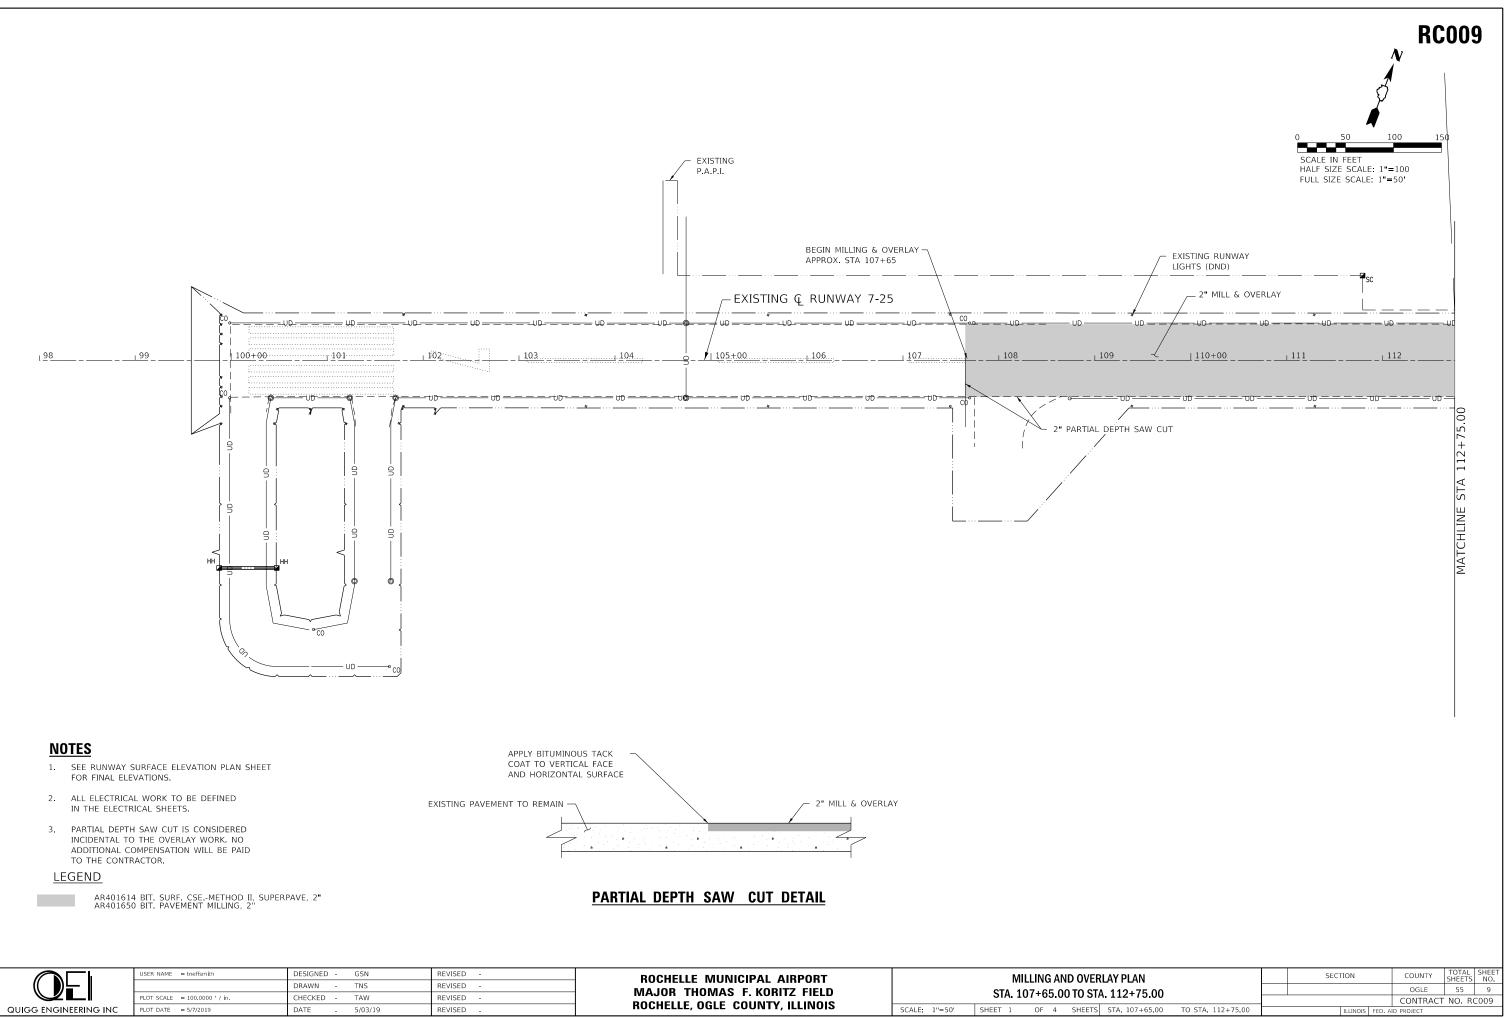


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		ST	A.	107+6	5.0	0
SCALE:	1"=50'	SHEET	1	OF	4	

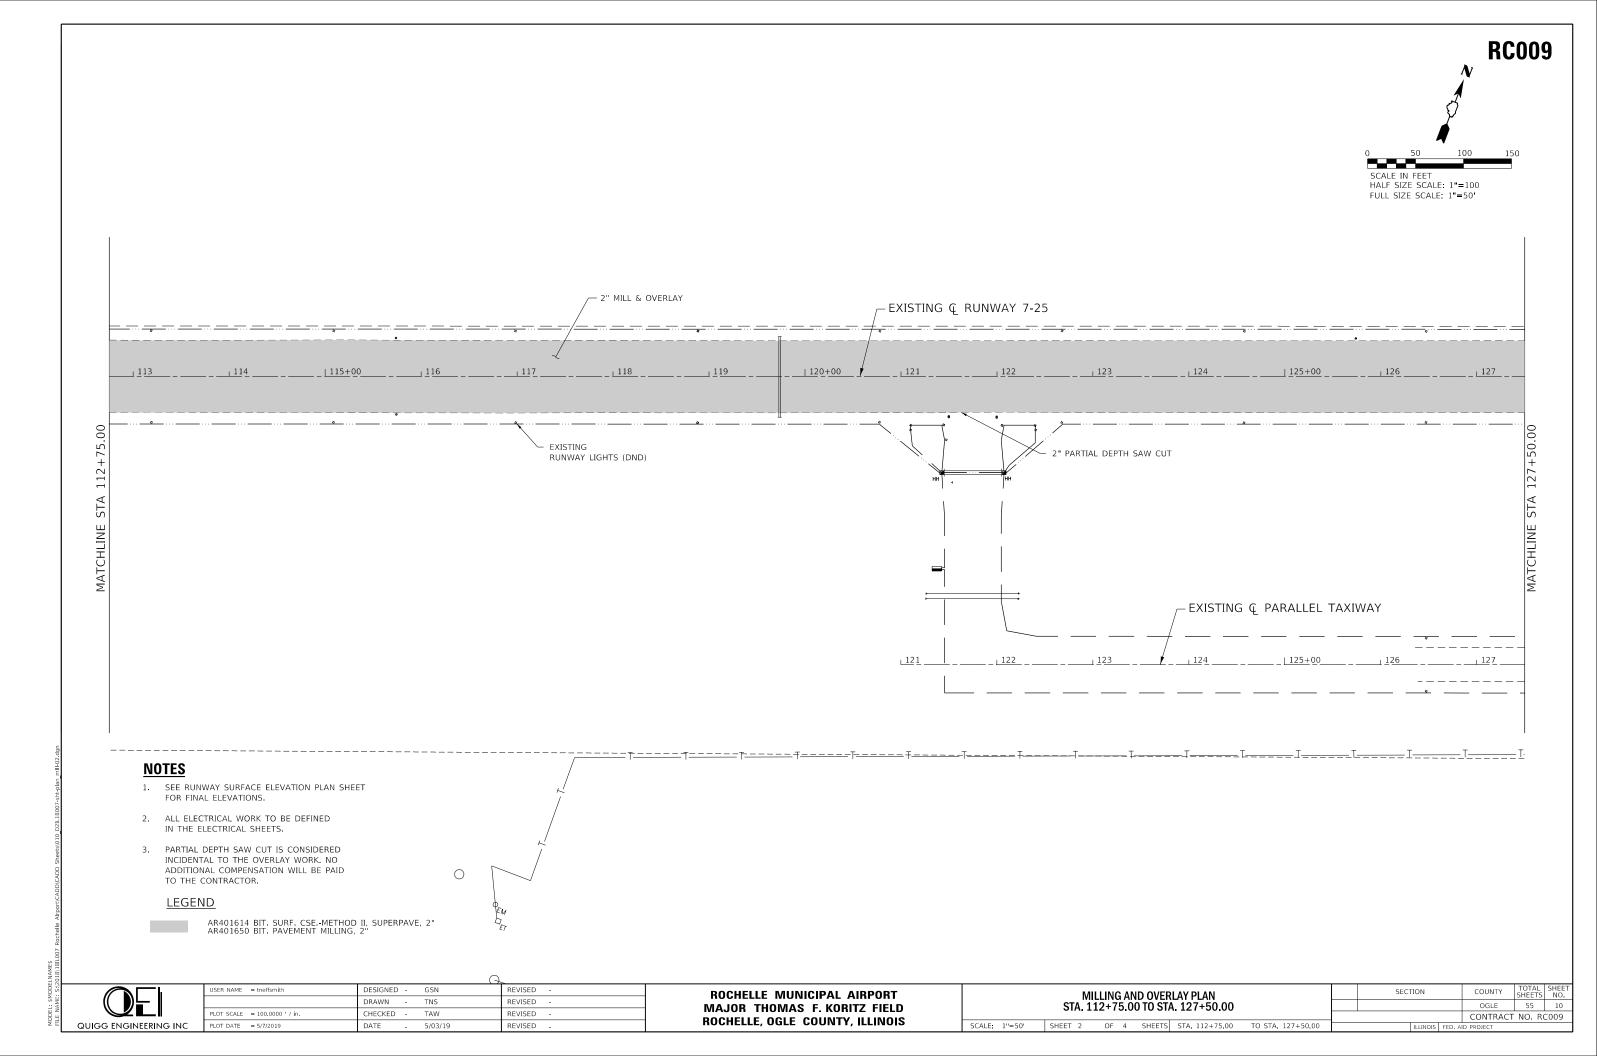


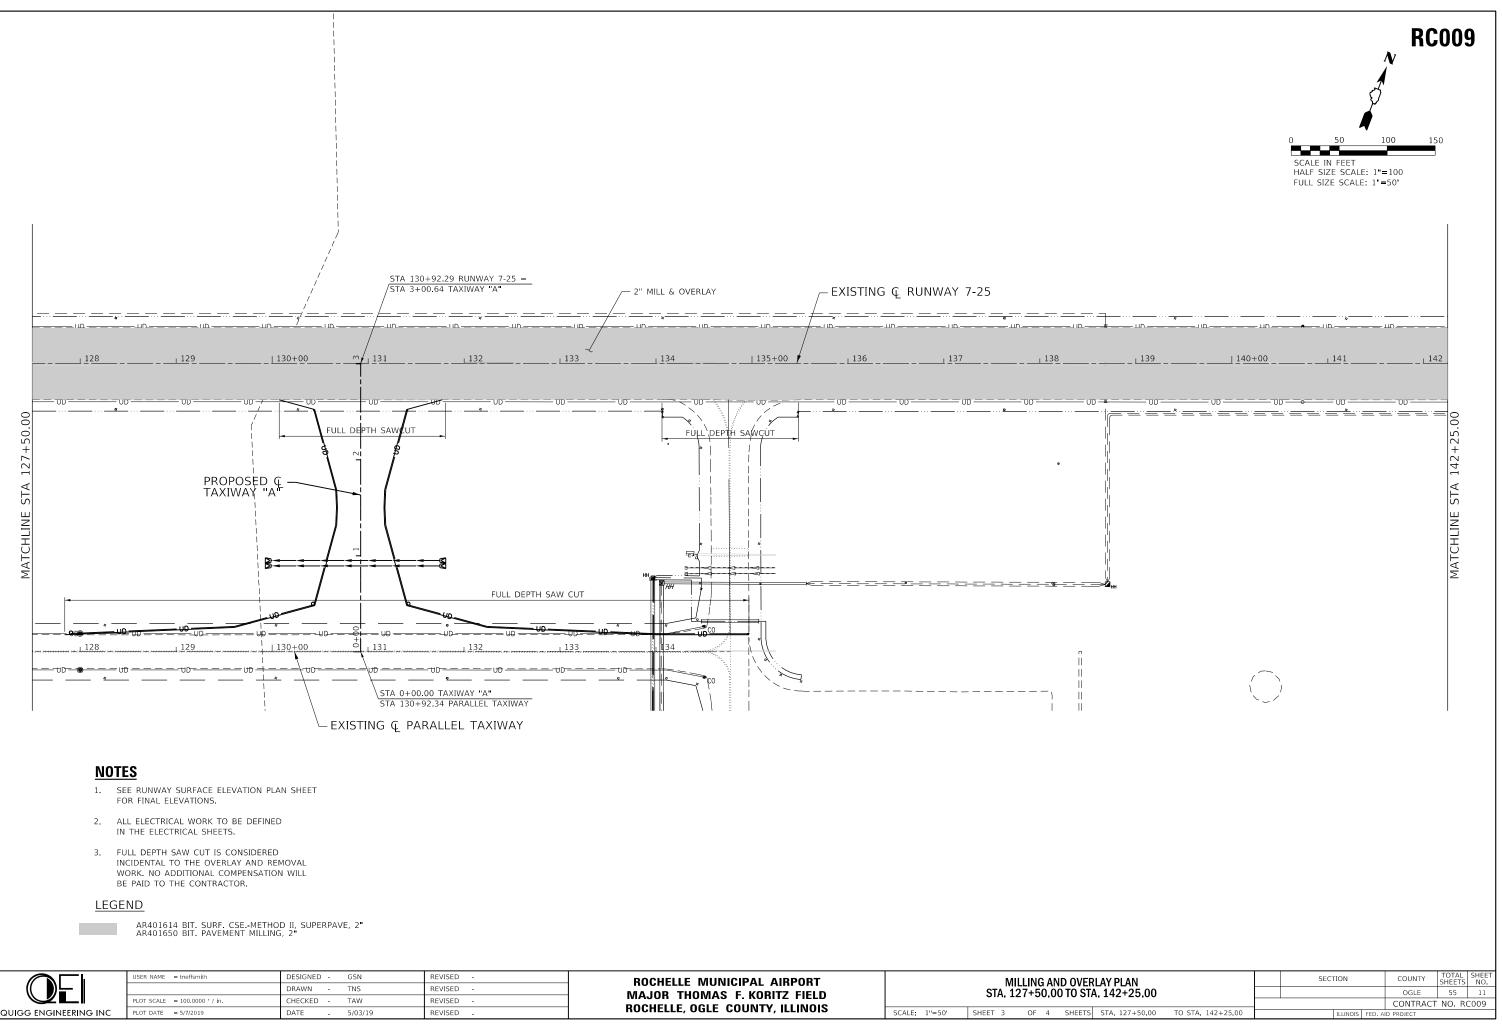



	USER NAME = tneffsmith	DESIGNED - GSN	REVISED -	ROCHELLE MUNICIPAL AIRPORT		MILLING AND OVER
		DRAWN - TNS	REVISED -	MAJOR THOMAS F. KORITZ FIELD		STA. 127+50.00 TO ST/
	PLOT SCALE = 100.0000 / in.	CHECKED - TAW	REVISED -			51A, 121 · 50,00 10 51/
QUIGG ENGINEERING INC	PLOT DATE = 5/7/2019	DATE - 5/03/19	REVISED -	ROCHELLE, OGLE COUNTY, ILLINOIS	SCALE: 1"=50'	SHEET 3 OF 4 SHEETS

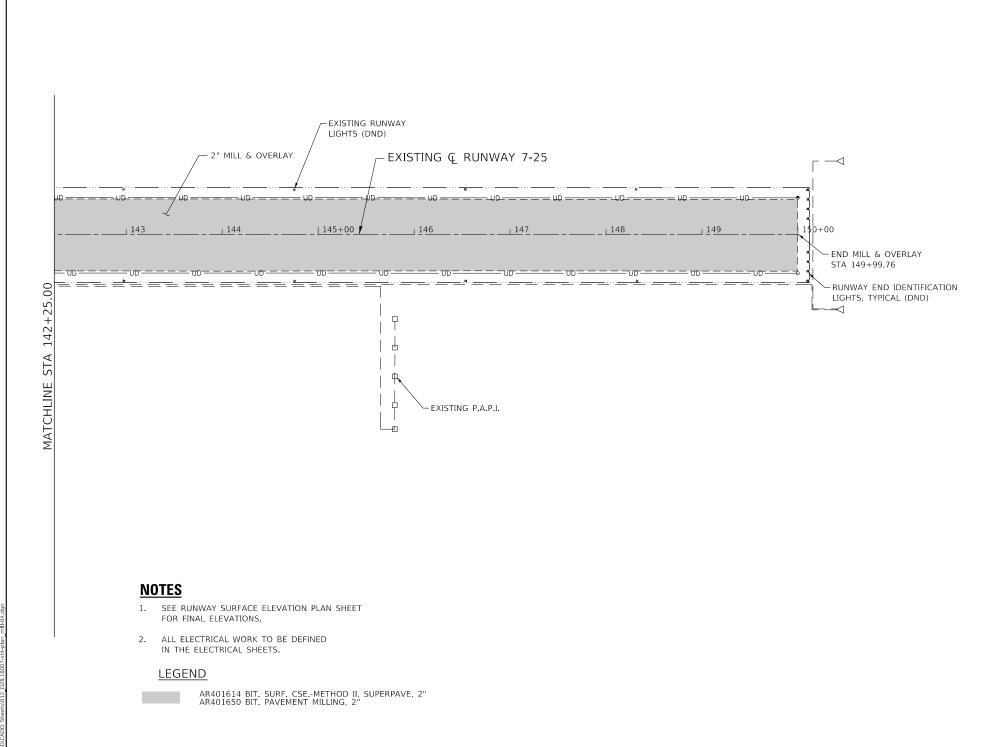

	USER NAME = tneffsmith	DESIGNED - GSN	REVISED -	ROCHELLE MUNICIPAL AIRPORT	MILLING AND OVERLAY PLAN	SECTION COUNTY TOTAL SHEET
		DRAWN - TNS	REVISED -	MAJOR THOMAS F. KORITZ FIELD		OGLE 55 12
	PLOT SCALE = 100.0000 / in.	CHECKED - TAW	REVISED -		STA. 142+25.00 TO STA. 150+00.00	CONTRACT NO. RC009
QUIGG ENGINEERING INC	PLOT DATE = 5/7/2019	DATE - 5/03/19	REVISED -	ROCHELLE, OGLE COUNTY, ILLINOIS	SCALE: 1"=50' SHEET 4 OF 4 SHEETS STA. 142+25.00 TO STA. 150+00.00	ILLINOIS FED. AID PROJECT

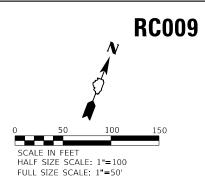

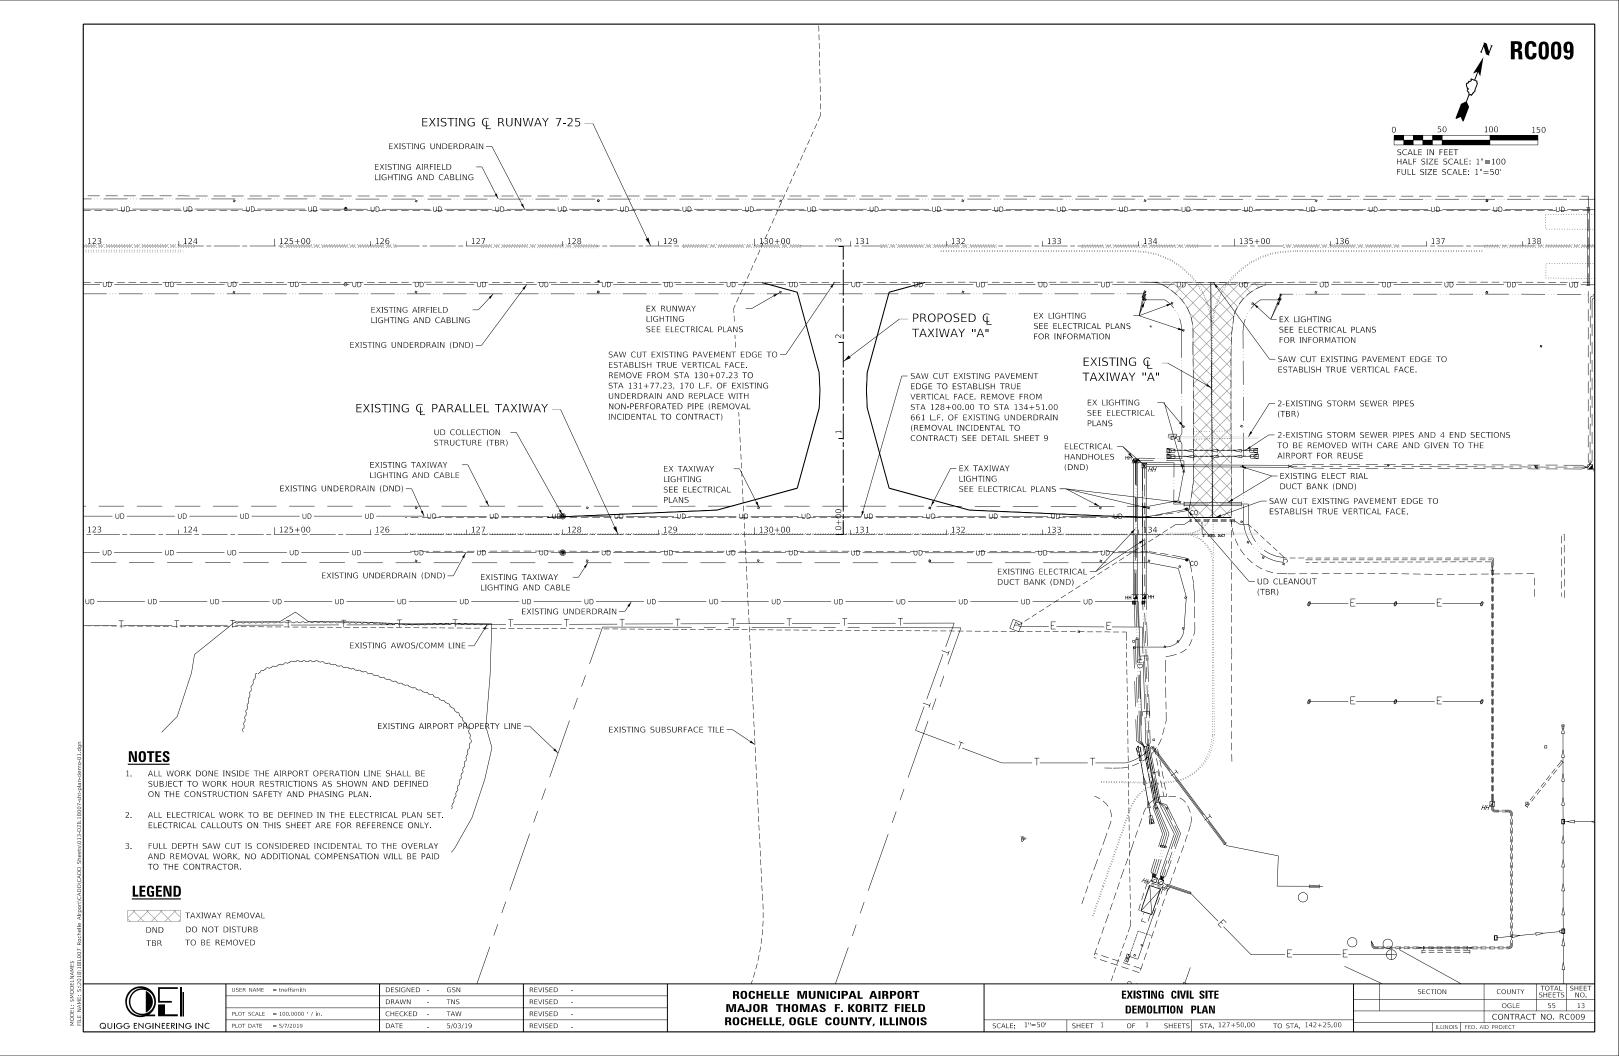


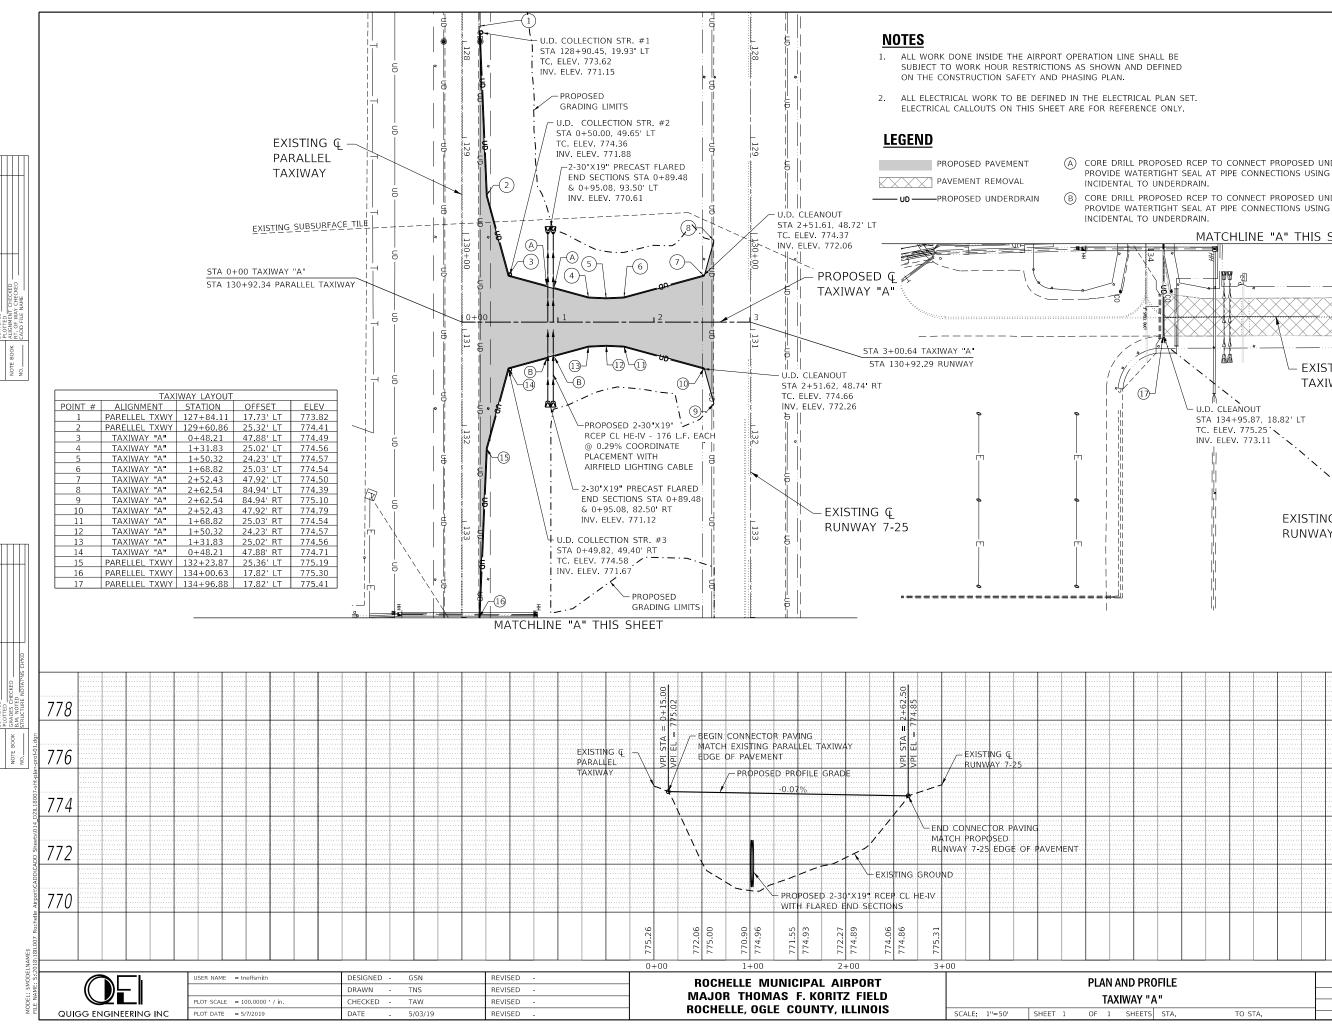



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	50 IN FEET	100	150
=.	SIZE SCALE SIZE SCALE		
DERDRAIN (U.C WATER SEALIN		,	
	INV FLEY	/ 77151)	

B Core drill proposed RCP to connect proposed underdrain (u.d. inv. elev. 771.5 provide watertight seal at pipe connections using water sealing grout. Cost 771.51). MATCHLINE "A" THIS SHEET fΨ EXISTING Q TAXIWAY "A" - U.D. CLEANOUT STA 134+95.87, 18.82 LT TC. ELEV. 775.25' INV. ELEV. 773.11 EXISTING C RUNWAY 7-25 778 776 774 772 770


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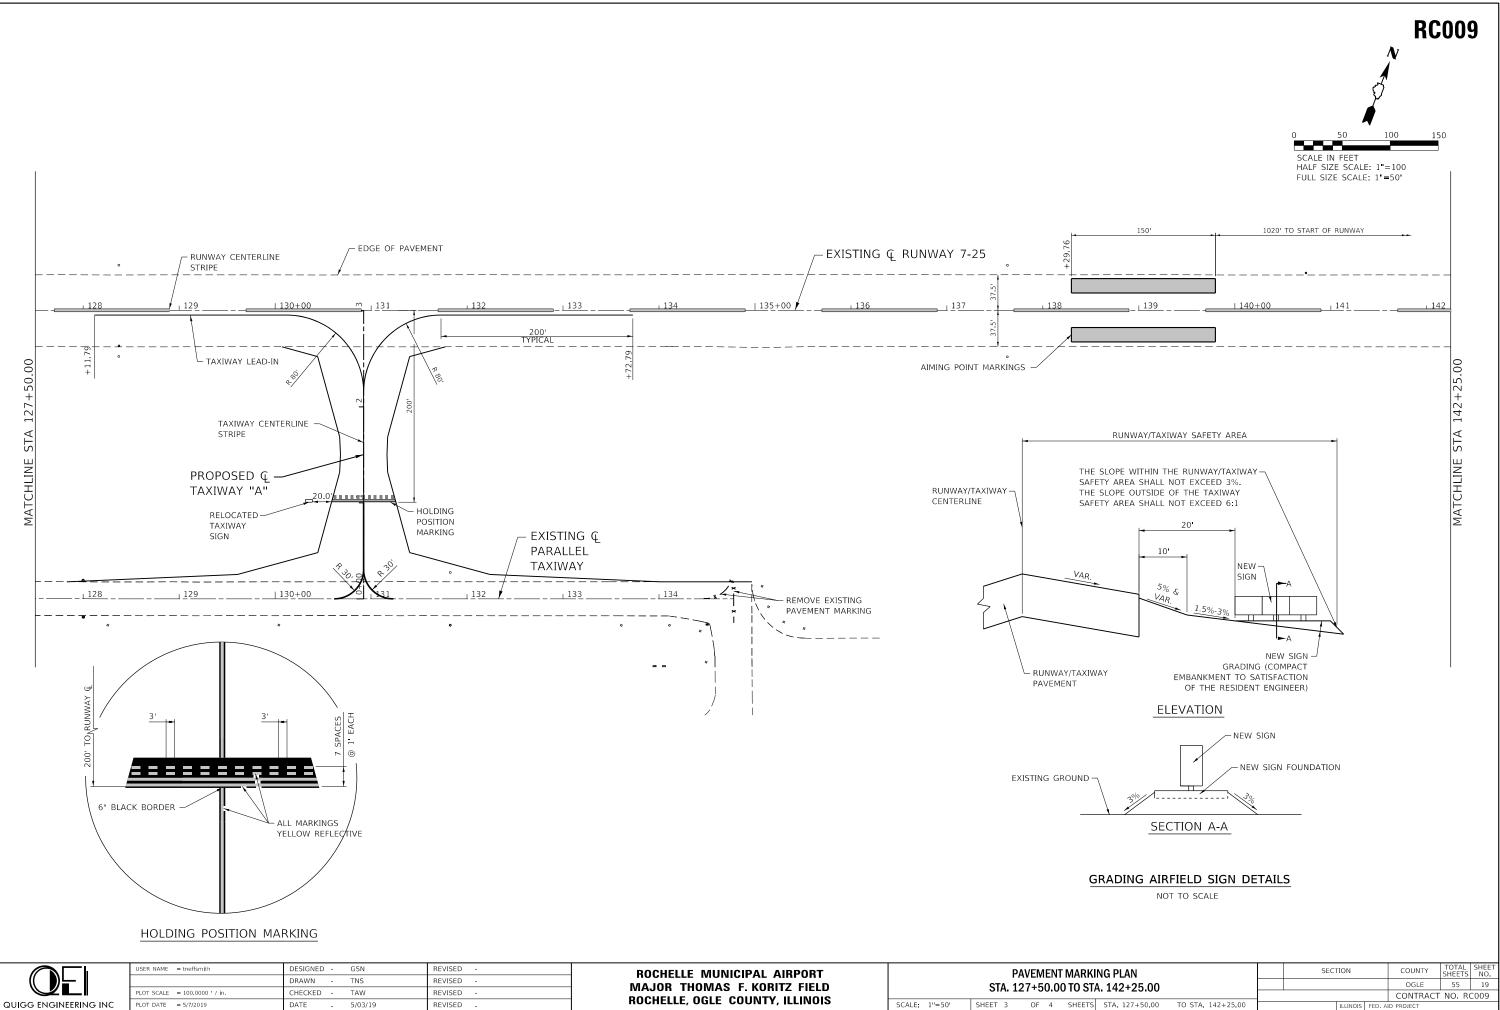


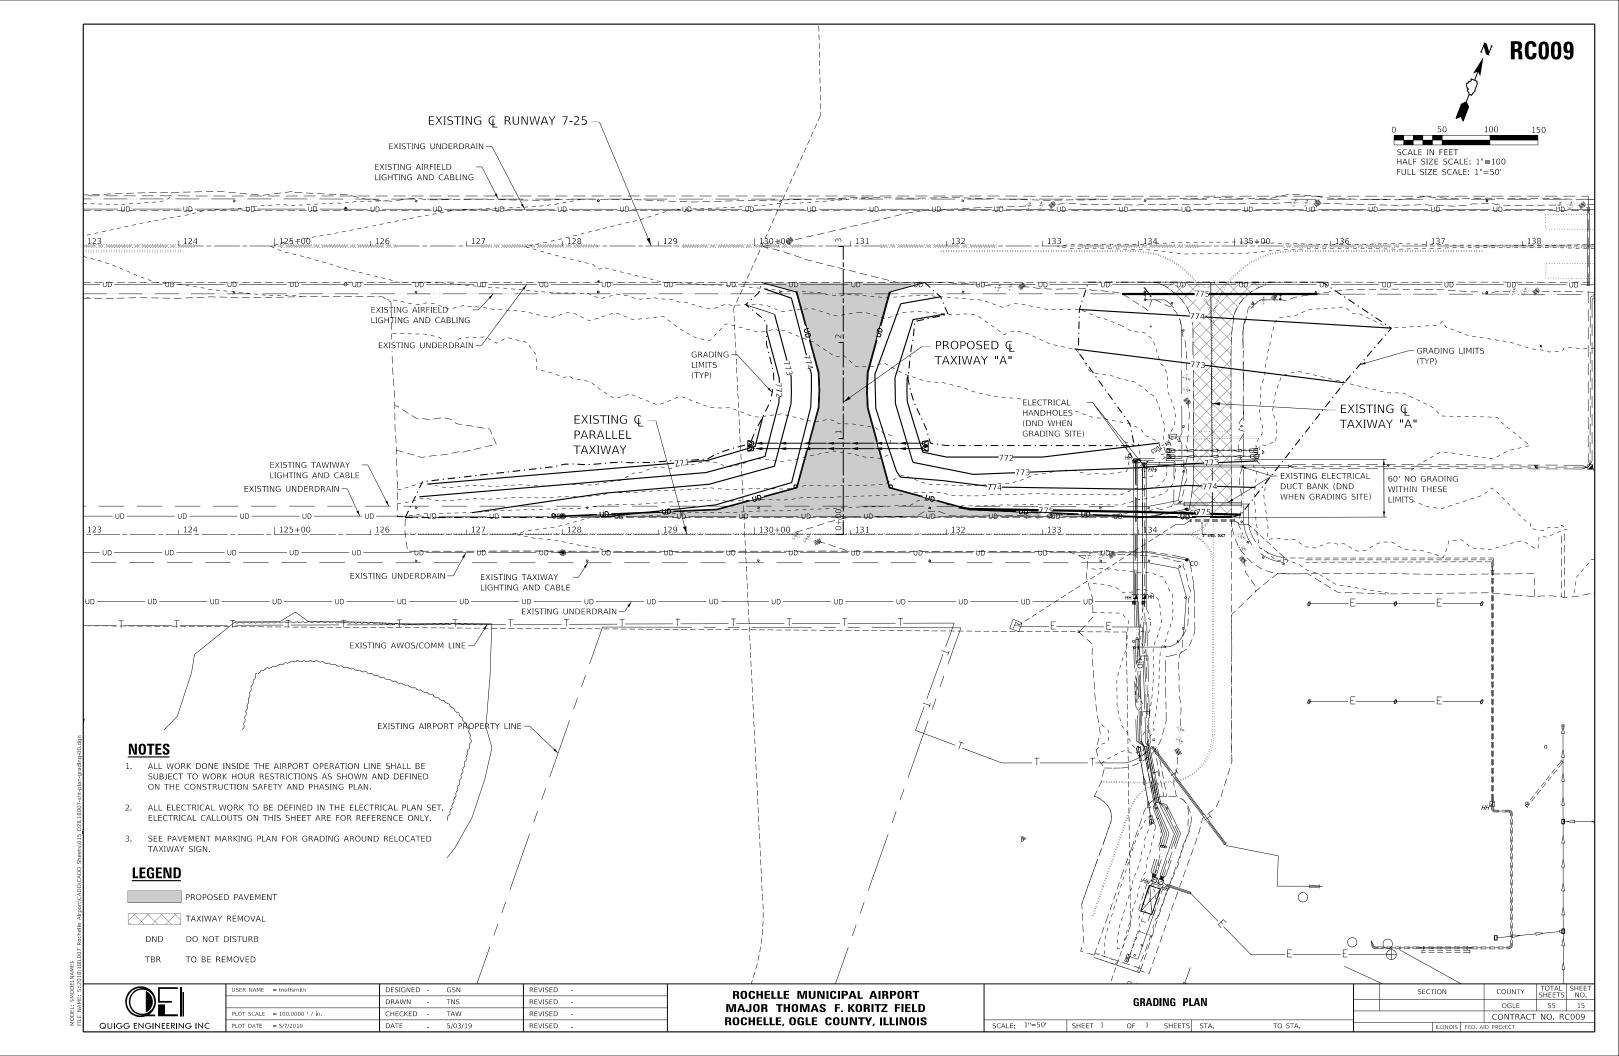

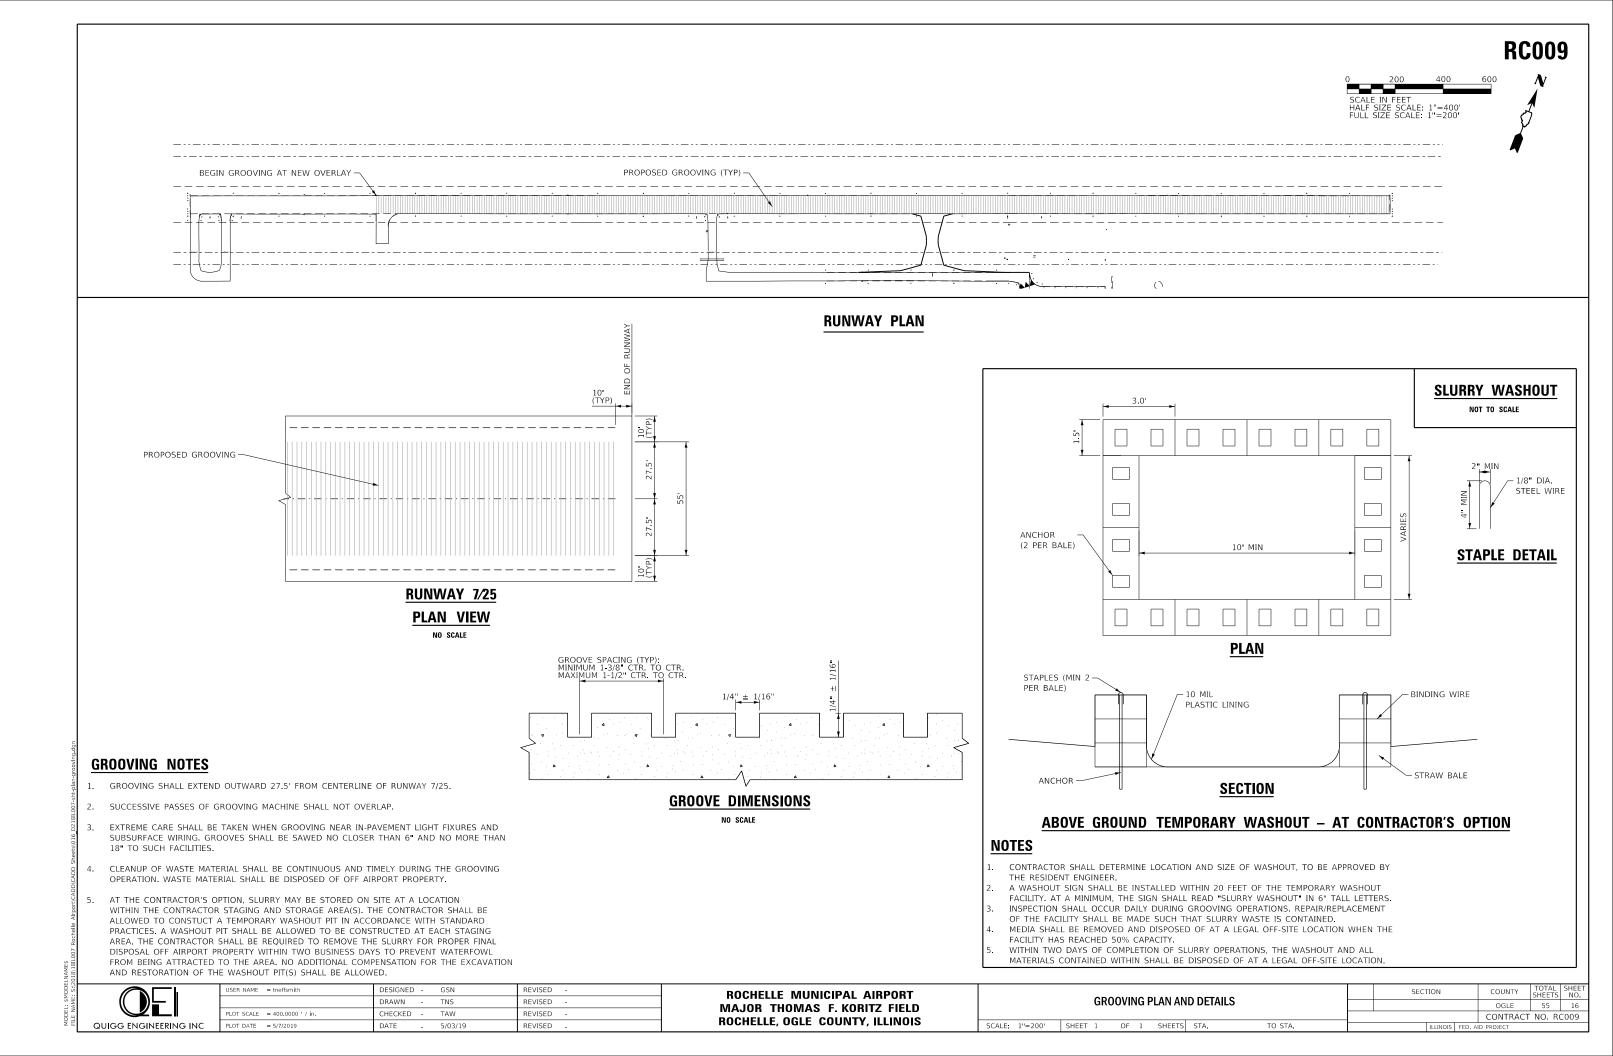


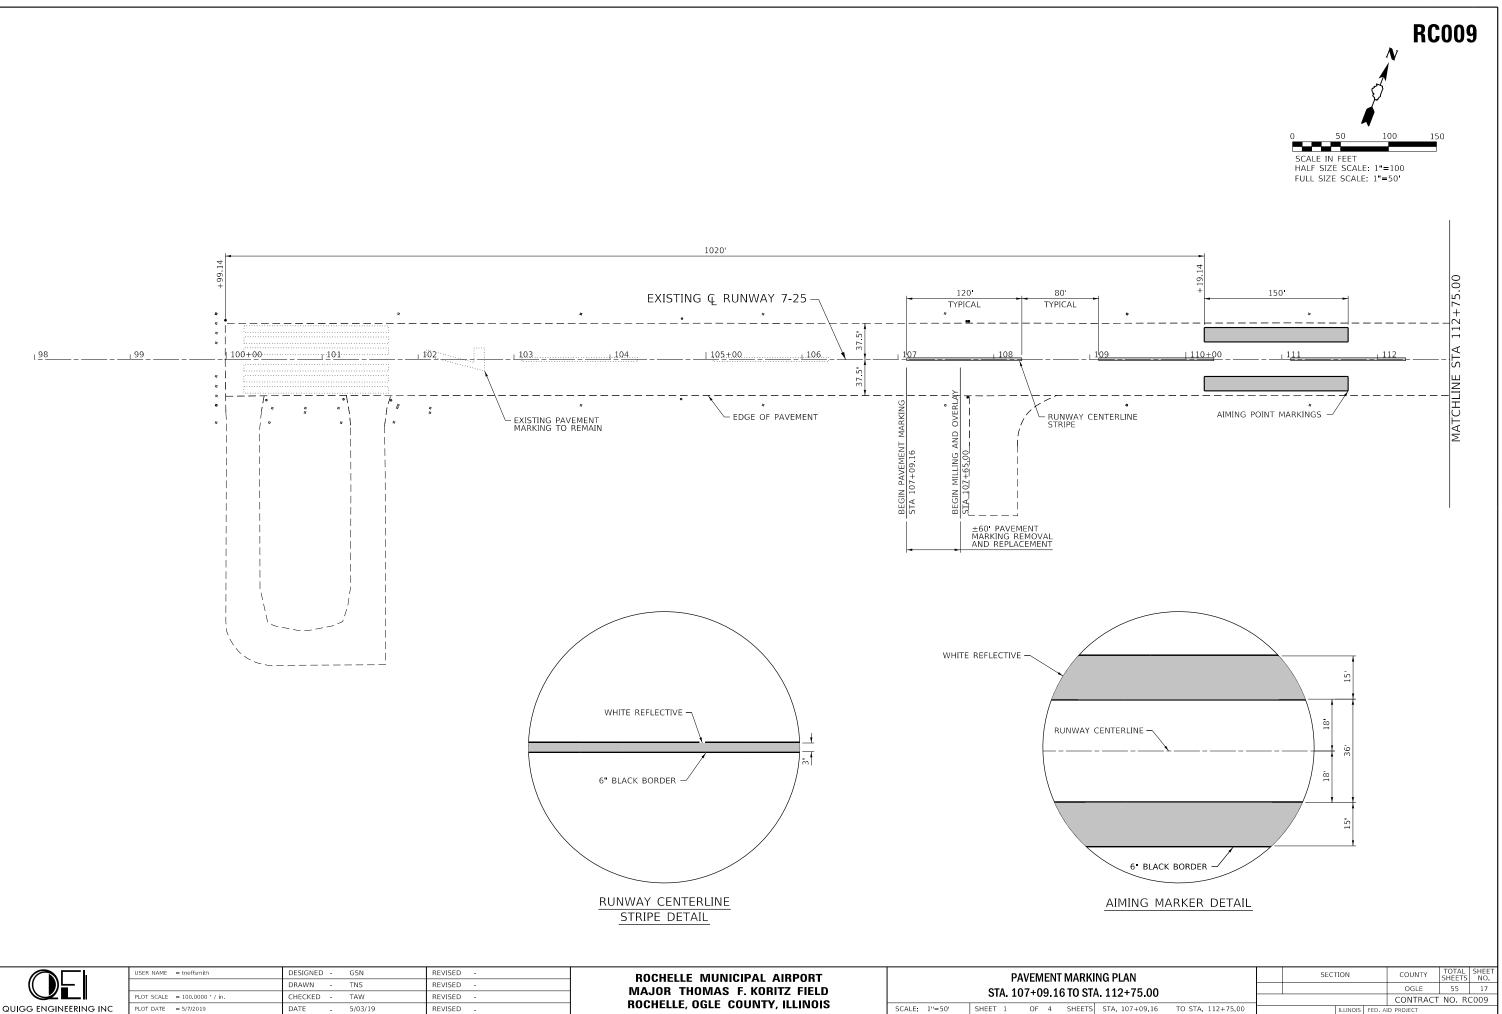	DRAWN - TNS	REVISED -	MAJOB THOMAS F. KOBITZ FIELD
PLOT SCALE = 100.0000 / in	CHECKED - TAW	REVISED -	
PLOT DATE = 5/7/2019	DATE - 5/03/19	REVISED -	ROCHELLE, OGLE COUNTY, ILLINOIS
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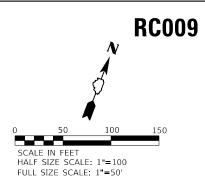


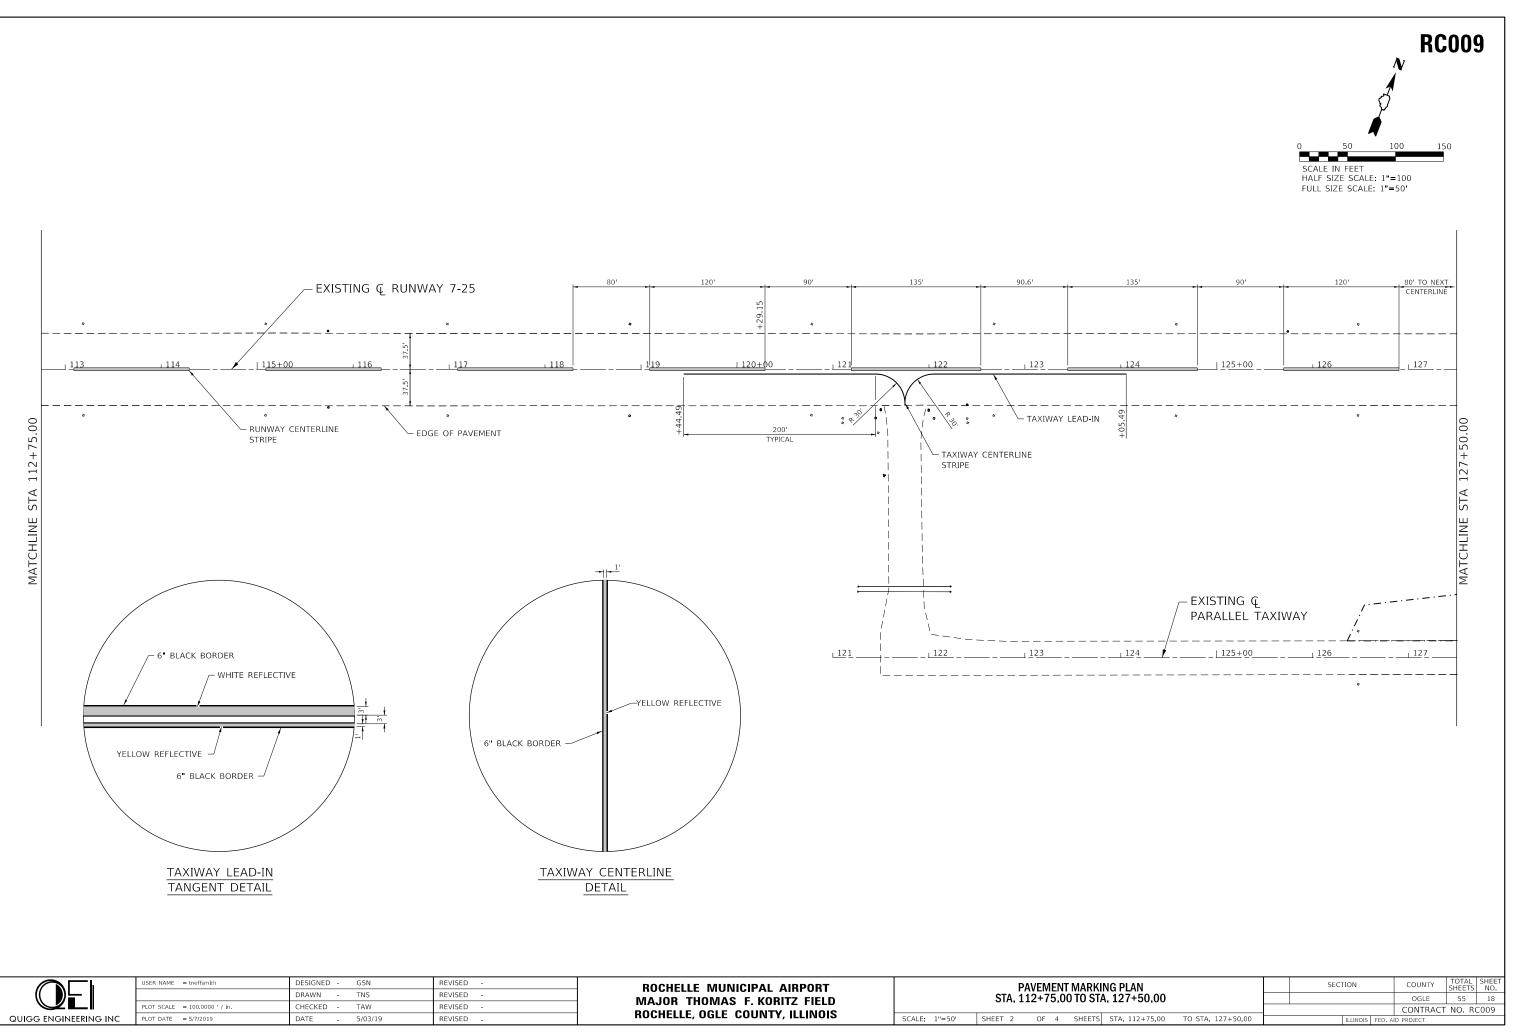



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0.011	1112-20100					CONTRACT	N
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	USER NAME = tneffsmith	DESIGNED - GSN	REVISED -	ROCHELLE MUNICIPAL AIRPORT	<b>ΔΑΛΕΜΕΝΤ ΜΑΡΚΙΝΟ ΟΙ ΑΝ</b>	SECTION COUNTY TOTAL SHEET
		DRAWN - TNS	REVISED -	MAJOR THOMAS F. KORITZ FIELD	STA. 142+25.00 TO STA. 150+00.00	OGLE 55 20
	PLOT SCALE = 100.0000 ' / in.	CHECKED - TAW	REVISED -	ROCHELLE, OGLE COUNTY, ILLINOIS		CONTRACT NO. RC009
QUIGG ENGINEERING INC	PLOT DATE = 5/7/2019	DATE - 5/03/19	REVISED -	NOONELLE, OGEE GOONTT, ILLINGIG	SCALE 1"=50' SHEET 4 OF 4 SHEETS STA 142+25.00 TO STA 150+00.00	ILLINOIS FED. AID PROJECT




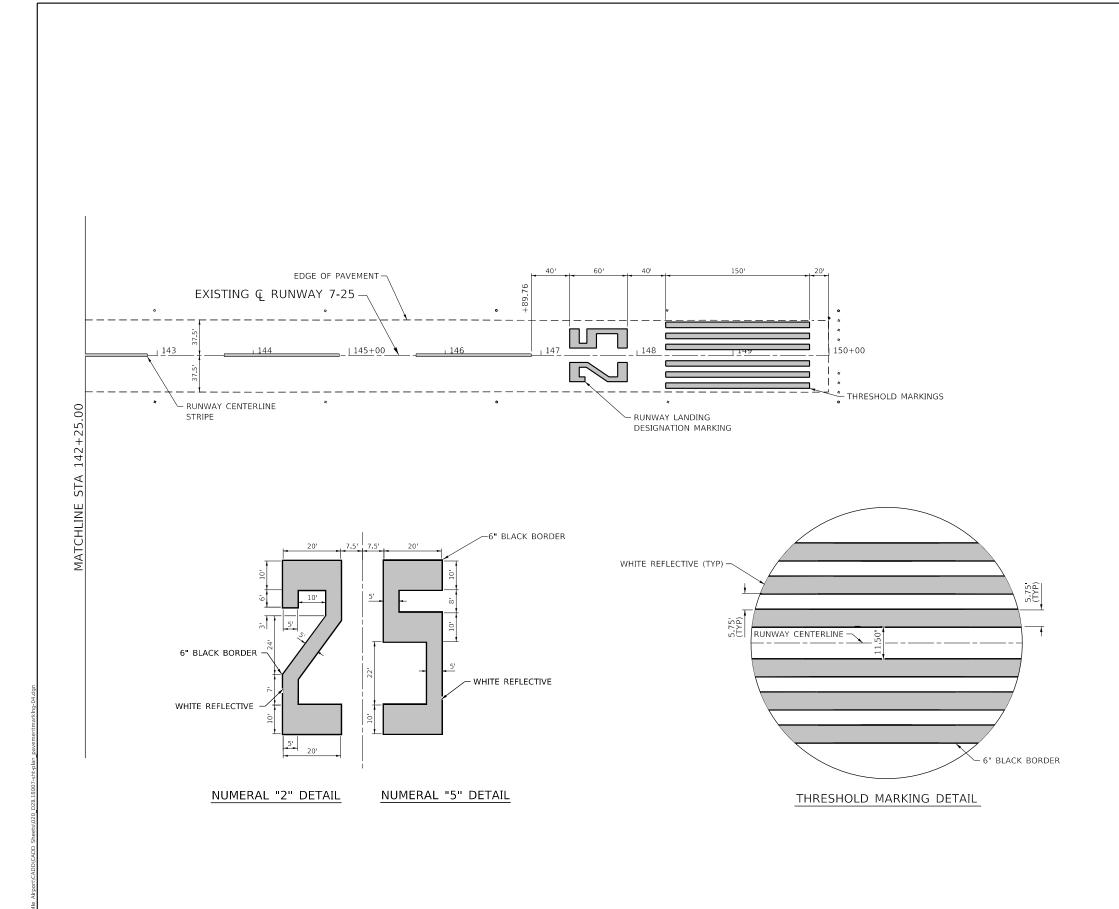

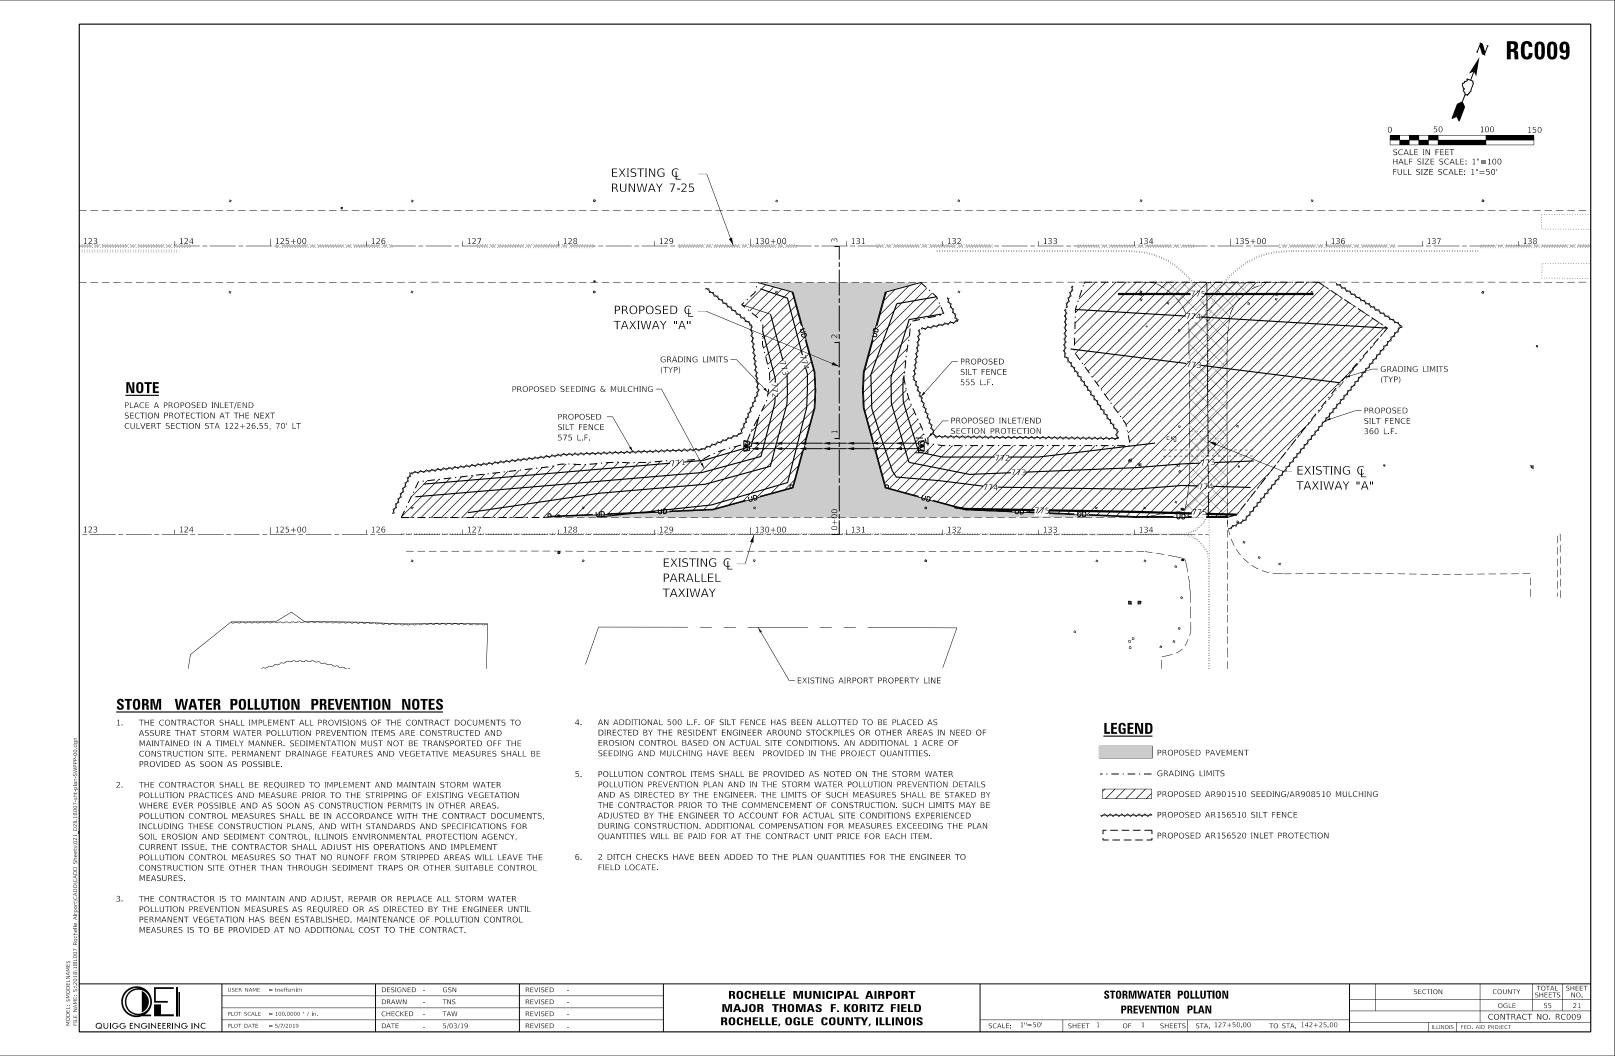

	USER NAME = tneffsmith	DESIGNED -	GSN	REVISED -	ROCHELLE MUNICIPAL AIRPORT		S	TORMWATER POLLUTION		SECTION	COUNTY	TOTAL	SHEET
	DRAWN - TNS REVISED -	MAJOR THOMAS F. KORITZ FIELD	PREVENTION PLAN DETAILS				OGLE	55	22				
	PLOT SCALE = 2.0000 / in.	CHECKED -	TAW	REVISED -			FF	VEVENTION PLAN DETAILS			CONTRAC	T NO. R	2009
QUIGG ENGINEERING INC	PLOT DATE = 5/7/2019	DATE -	5/03/19	REVISED -	ROCHELLE, OGLE COUNTY, ILLINOIS	SCALE: 1"=1"	SHEET 1	OF 1 SHEETS STA.	TO STA.	ILLINOIS FED	AID PROJECT		

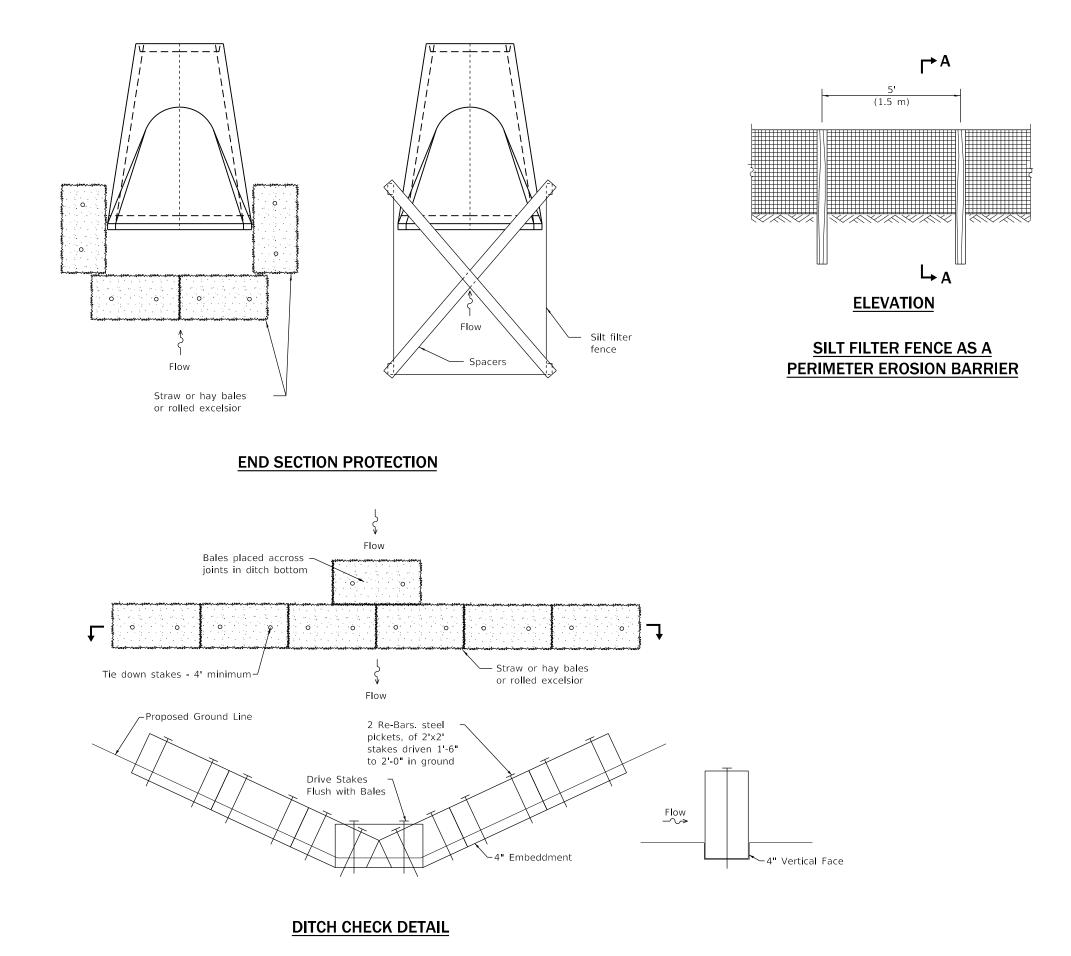
## **RC009**

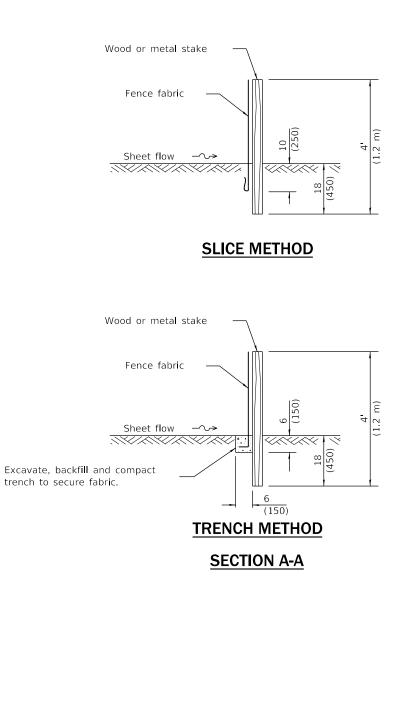

### **GENERAL NOTES**

The installation details and dimensions shown for perimeter erosion barriers shall also apply for inlet and pipe protection.

All dimensions are in inches (millimeters) unless otherwise shown.

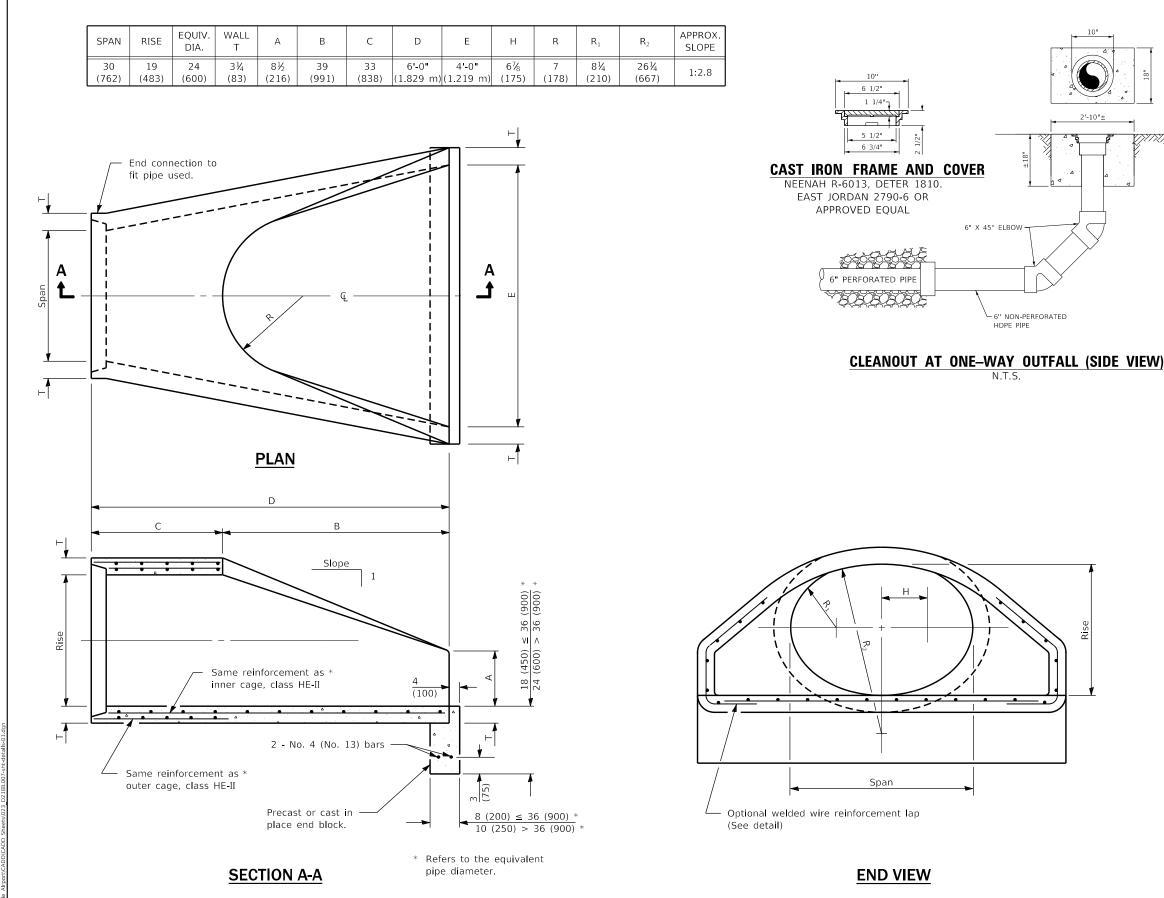

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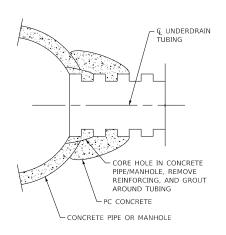
QE	USER NAME = tneffsmith PLOT SCALE = 2.0000 / in.	DESIGNED - GSN DRAWN - TNS CHECKED - TAW	REVISED - REVISED - REVISED -	ROCHELLE MUNICIPAL AIRPORT MAJOR THOMAS F. KORITZ FIELD	DRAINAGE DETAILS	SECTIC	N COUNTY TOTAL SHEETS OGLE 55 CONTRACT NO. R	SHEET NO. 23 RC009
QUIGG ENGINEERING INC	PLOT DATE = 5/7/2019	DATE - 5/03/19	REVISED -	ROCHELLE, OGLE COUNTY, ILLINOIS	SCALE: 1"=1' SHEET 1 OF 1 SHEETS STA. TO STA.	IL	LINOIS FED. AID PROJECT	

## **RC009**




#### CLEANOUT NOTES

- DIAMETER OF PIPE SPECIFIED. 1.
- TOP OF CLEANOUTS SHALL BE 2" ABOVE FINISH 2. GRADE LINE AT LOCATION SHOWN ON PLANS.
- 3. 1/2" CHAMFER TO BE USED ON ALL EXPOSED EDGES OF CLEANOUTS.
- 4. THE CONCRETE SHALL BE STRUCTURAL PORTLAND CEMENT CONCRETE (NON -REINFORCED).





STORM SEWER CONCRETE COLLAR AND GROUT CONNECTION

N.T.S.

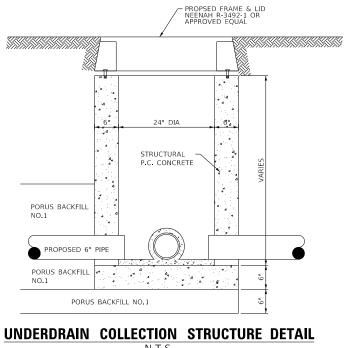


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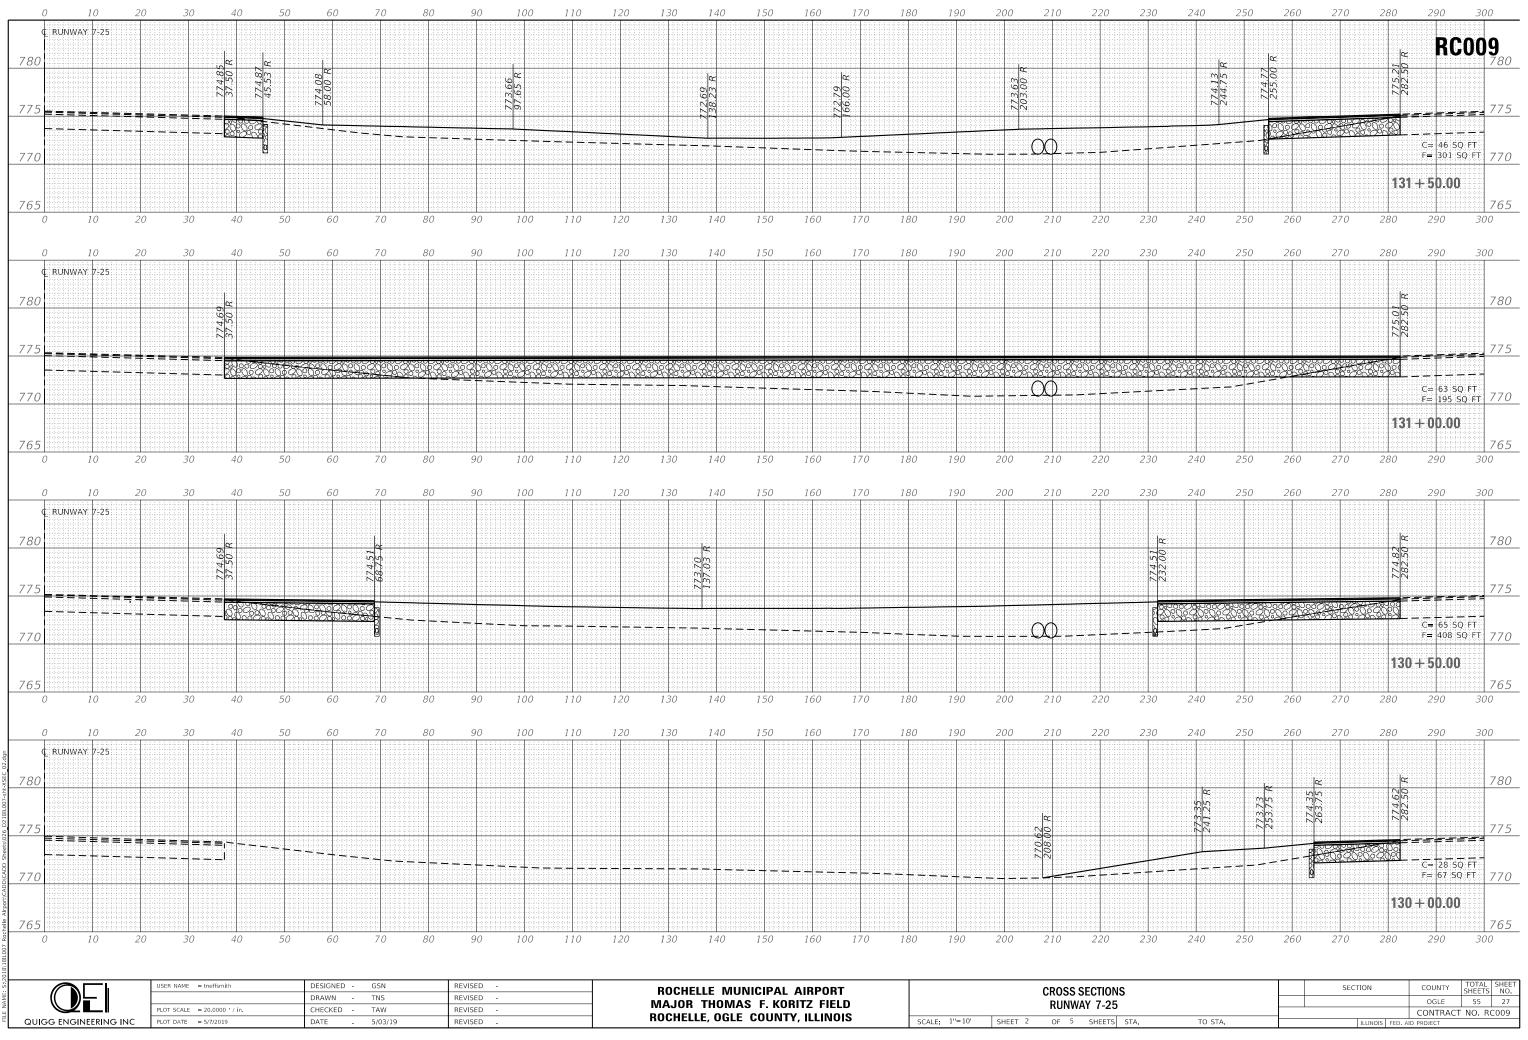


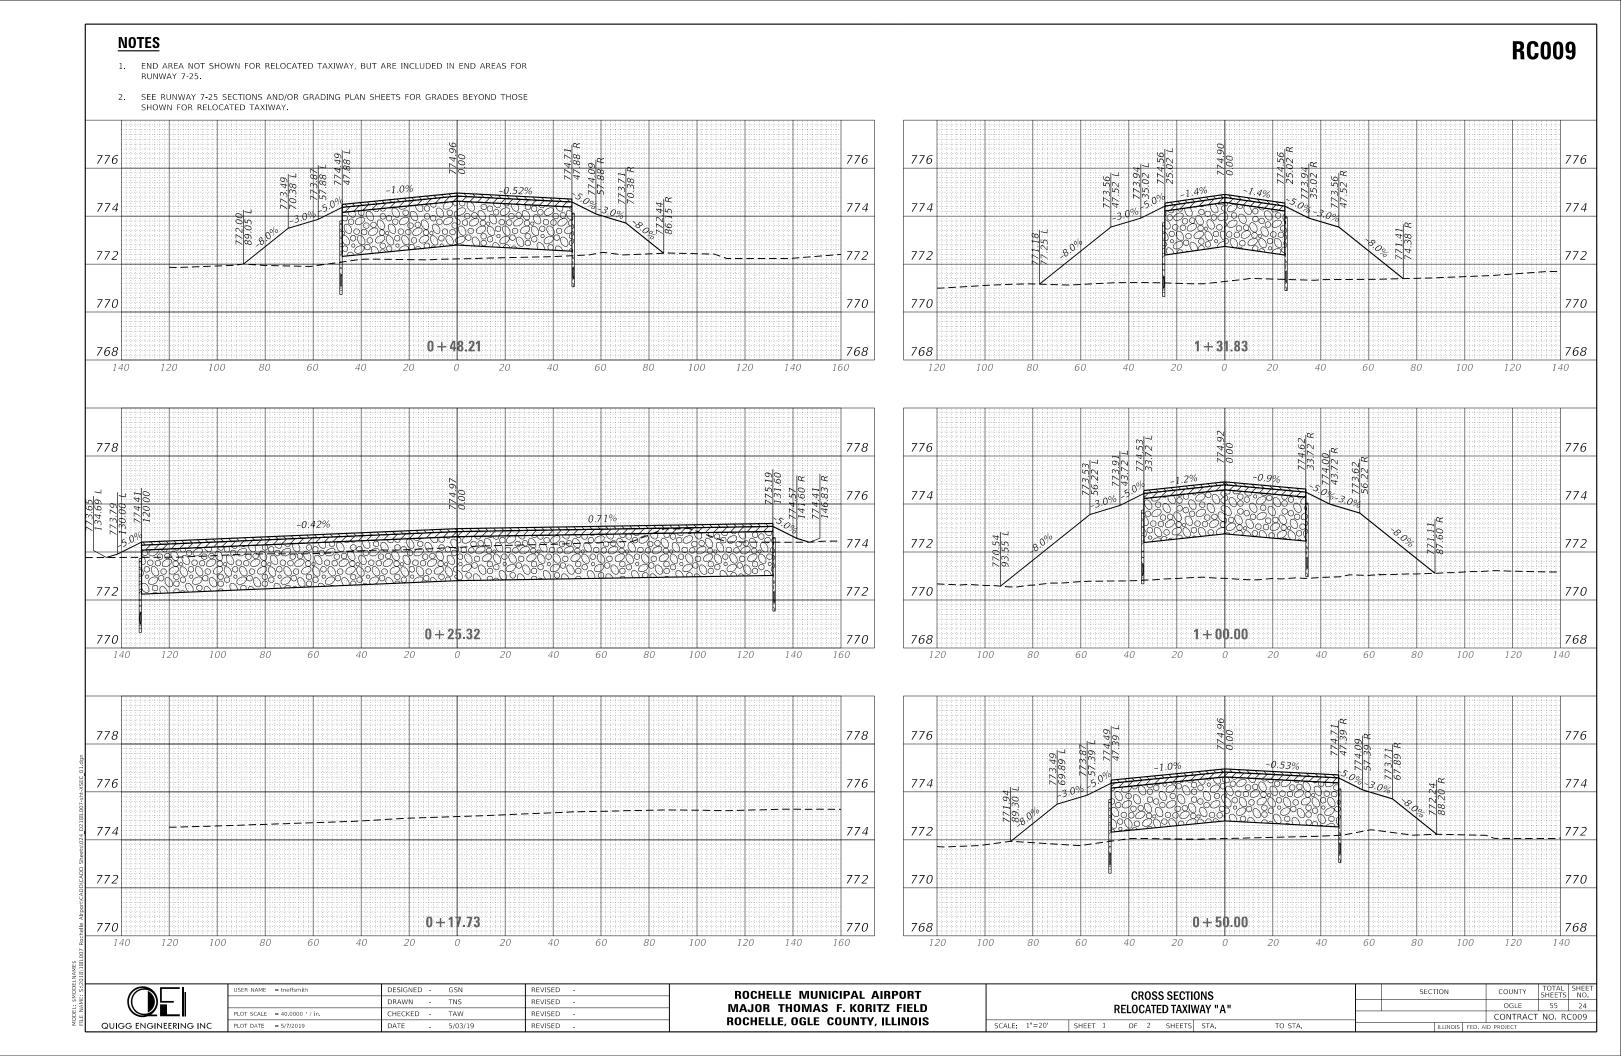

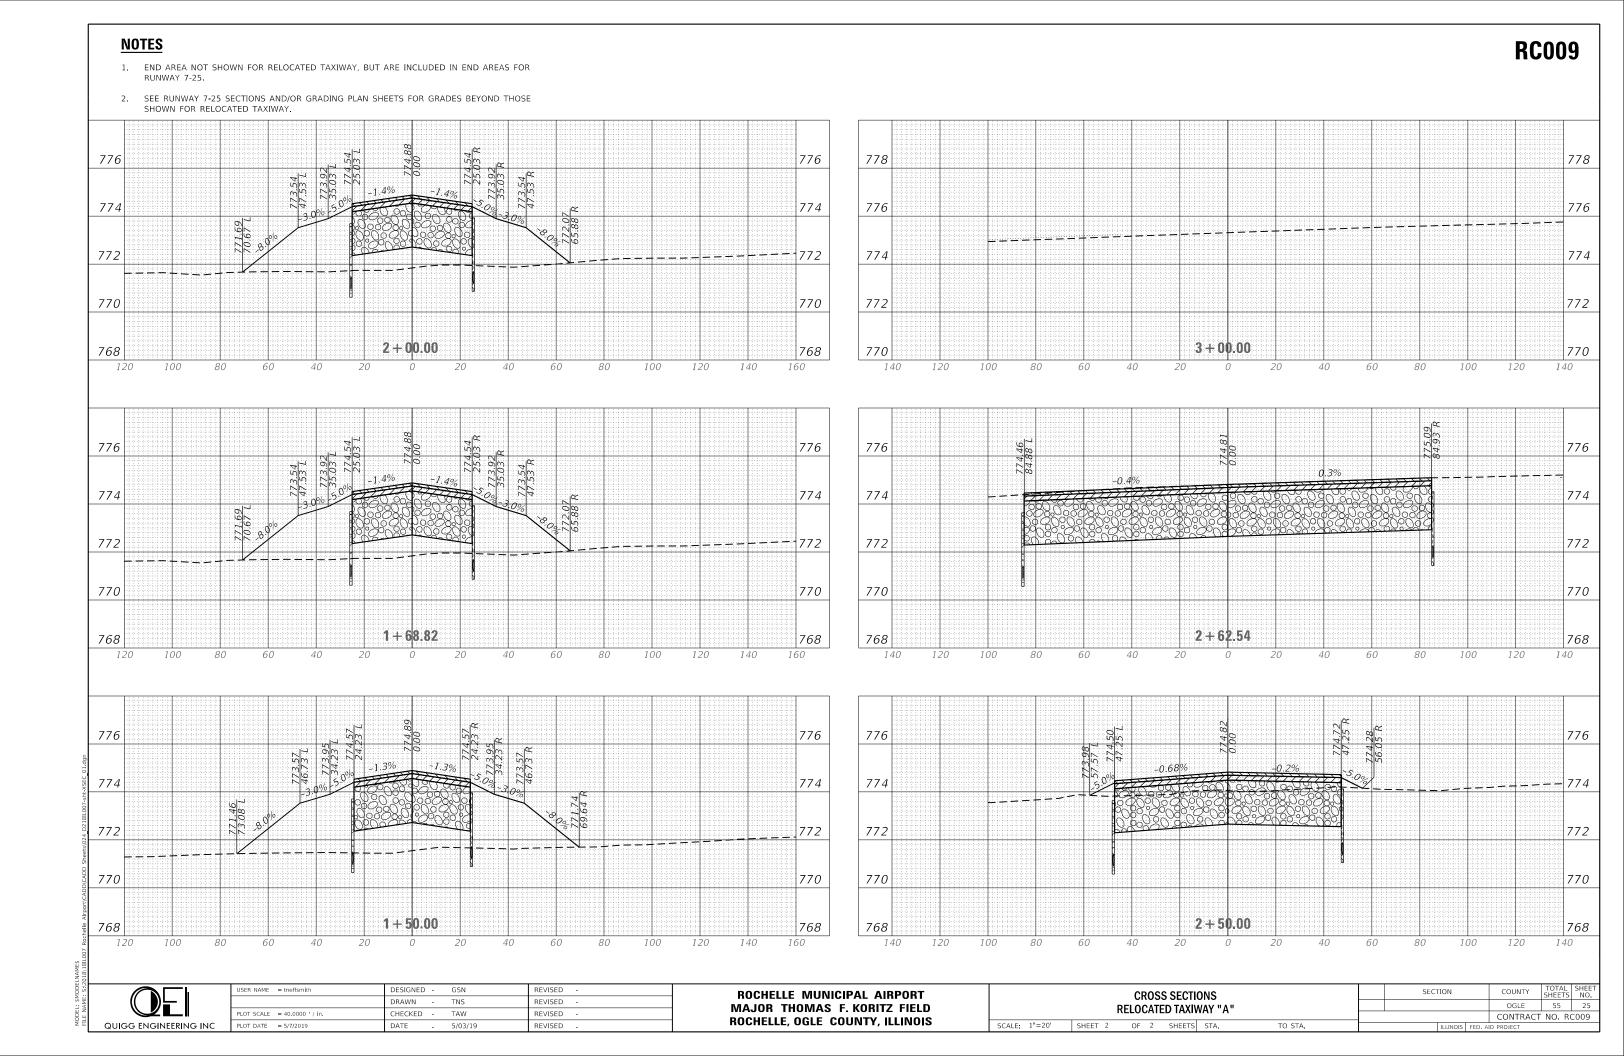
C RUNWAY 7-25 <u>演奏日本</u>演演員 美国会会会会 .30 - 0 RUNWAY 7-25 <sup>1914</sup>年末年年年年年年年年年年年年 Ω RUNWAY 7-25 77. [二二二] RUNWAY 7-25 DESIGNED -GSN REVISED JSER NAME = tneffsmith **ROCHELLE MUNICIPAL AIRPORT CROSS SECTIONS** DRAWN -TNS REVISED MAJOR THOMAS F. KORITZ FIELD RUNWAY 7-25 LOT SCALE = 20.0000 ' / in. CHECKED -TAW REVISED **ROCHELLE, OGLE COUNTY, ILLINOIS** QUIGG ENGINEERING INC SCALE: 1"=10' SHEET 1 OF 5 SHEETS STA. REVISED PLOT DATE = 5/7/2019 DATE 5/03/19

## RC009




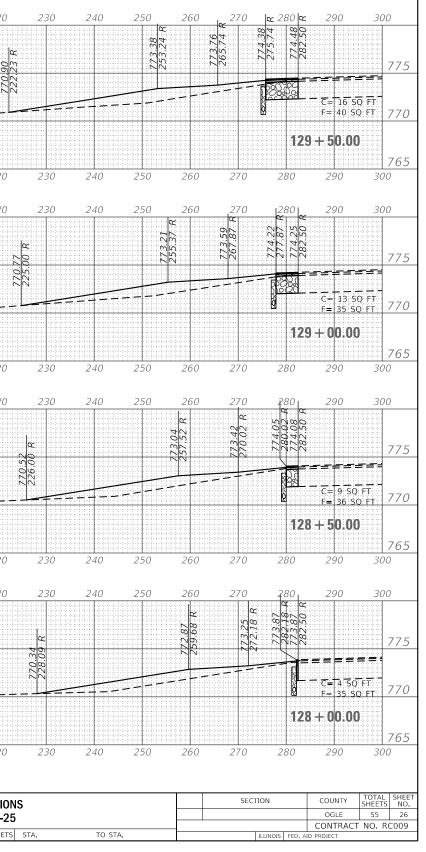


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5	-						OGLE	55	27
			_				CONTRACT	NO. R	2009
5	STA.	TO STA.			ILLINOIS	FED. A	ID PROJECT		

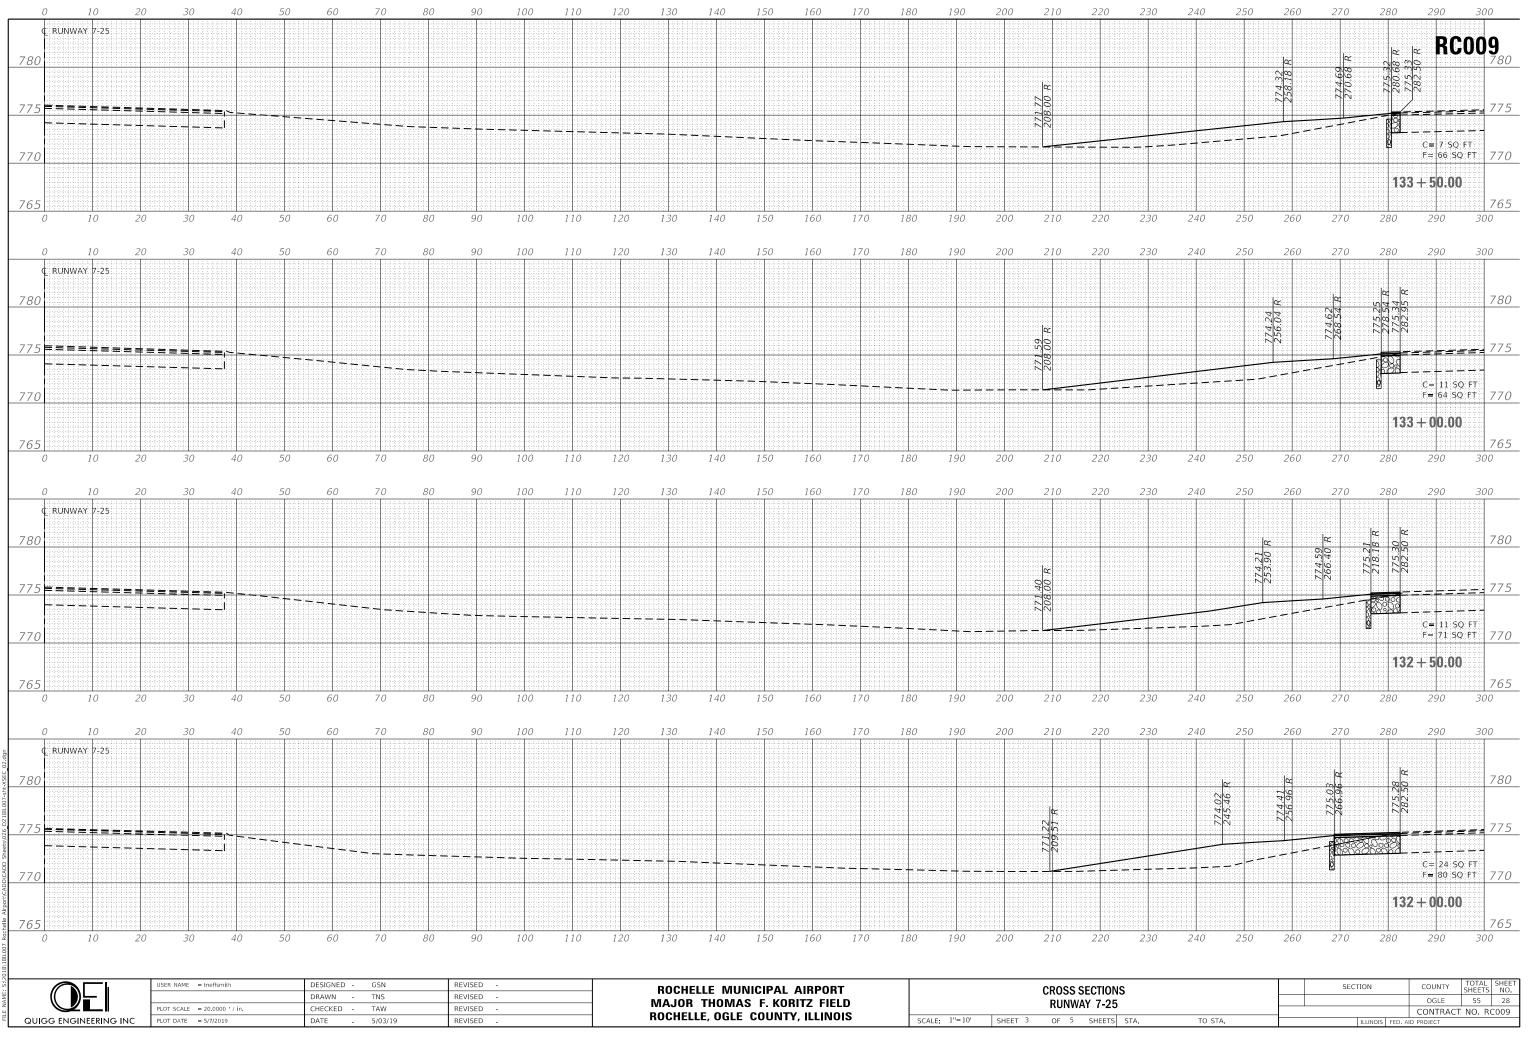

INS		COUNTY	SHEETS	NO.
25		OGLE	55	28
		CONTRACT	NO. RO	2009
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					CUM	CUM	CUM
STATION	CUT AREA (SF)	FILL AREA (SF)	CUT VOL (CY)	FILL VOL (CY)	CUT VOL (CY)	REUSEA BLE VOL -15% S.F. (CY)	FILL VOL (CY)
127+50	0.00	0.00	3.70	32.41	3.70	3.15	3.70
128+00	4.00	35.00	12.04	65.74	15.74	13.38	69.44
128+50	9.00	36.00	20.37	65.74	36.11	30.69	135.19
129+00	13.00	35.00	26.85	69.44	62.96	53.52	204.63
129+50	16.00	40.00	40.74	99.07	103.70	88.15	303.70
130+00	28.00	67.00	86.11	439.81	189.81	161.34	743.52
130+50	65.00	408.00	118.52	558.33	308.33	262.08	1301.85
131+00	63.00	195.00	100.93	459.26	409.26	347.87	1761.11
131+50	46.00	301.00	64.81	352.78	474.07	402.96	2113.89
132+00	24.00	80.00	32.41	139.81	506.48	430.51	2253.70
132+50	11.00	71.00	20.37	125.00	526.85	447.82	2378.70
133+00	11.00	64.00	16.67	120.37	543.52	461.99	2499.07
133+50	7.00	66.00	9.26	101.85	552.78	469.86	2600.93
134+00	3.00	44.00	340.74	40.74	893.52	759.49	2641.67
134+50	365.00	0.00	72.27	4.74	965.79	820.92	2646.41
134+57	214.00	38.00	139.04	25.19	1104.82	939.10	2671.59
134+75	189.00	35.00	155.93	29.63	1260.75	1071.64	2701.22
134+96	211.00	41.00	39.65	2.72	1300.39	1105.33	2703.94
135+00	387.00	0.00	364.81	0.00	1665.21	1415.43	2703.94
135+50	7.00	0.00	6.48	0.00	1671.69	1420.94	2703.94
136+00	0.00	0.00	0.00	0.00	1671.69	1420.94	2703.94

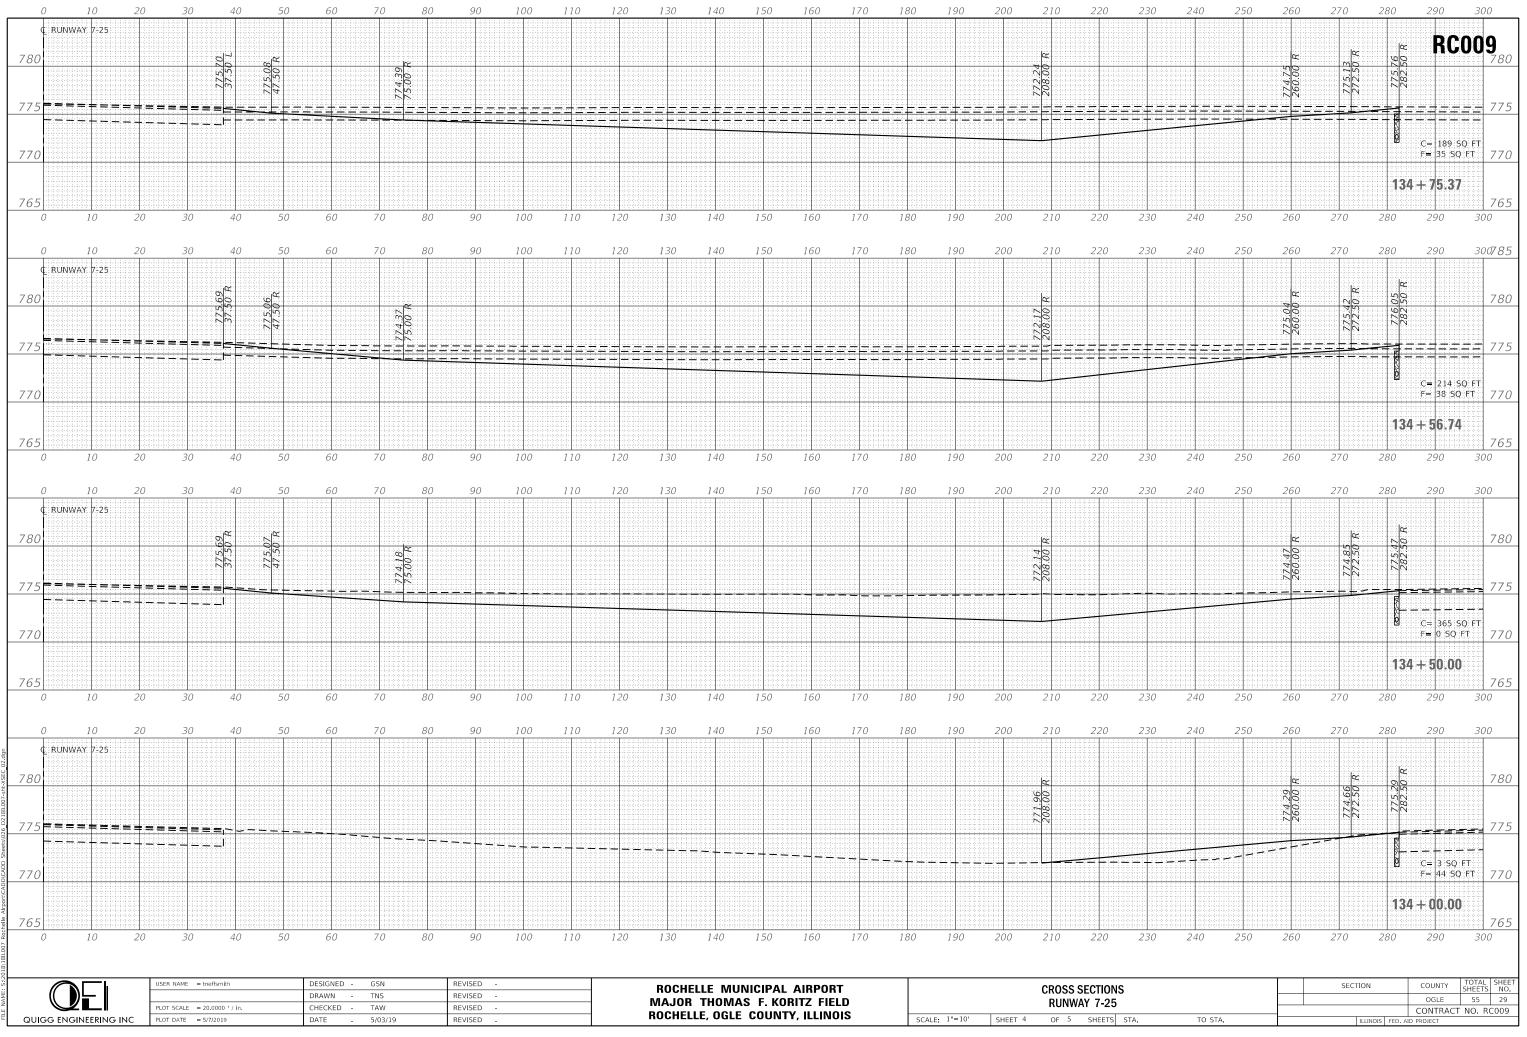BOF	ROW EA	RTHWORK	SUMMA	۲Y
STATION	CUT AREA (SF)	CUT VOL (CY)	CUM CUT VOL (CY)	CUM REUSEA BLE VOL -15% S.F. (CY)
+50	0.00	29.63	29.63	25.19
1+00	32.00	77.78	107.41	91.30
1+50	52.00	111.11	218.52	185.74
2+00	68.00	137.04	355.56	302.22
2+50	80.00	159.26	514.81	437.59
3+00	92.00	177.78	692.59	588.70
3+50	100.00	212.04	904.63	768.94
4+00	129.00	232.41	1137.04	966.48
4+50	122.00	205.56	1342.59	1141.20
5+00	100.00	185.19	1527.78	1298.61
5+50	44.00	40.74	1568.52	1333.24
6+00	0.00	0.00	1527.78	1298.61

TOTAL BORROW 1528

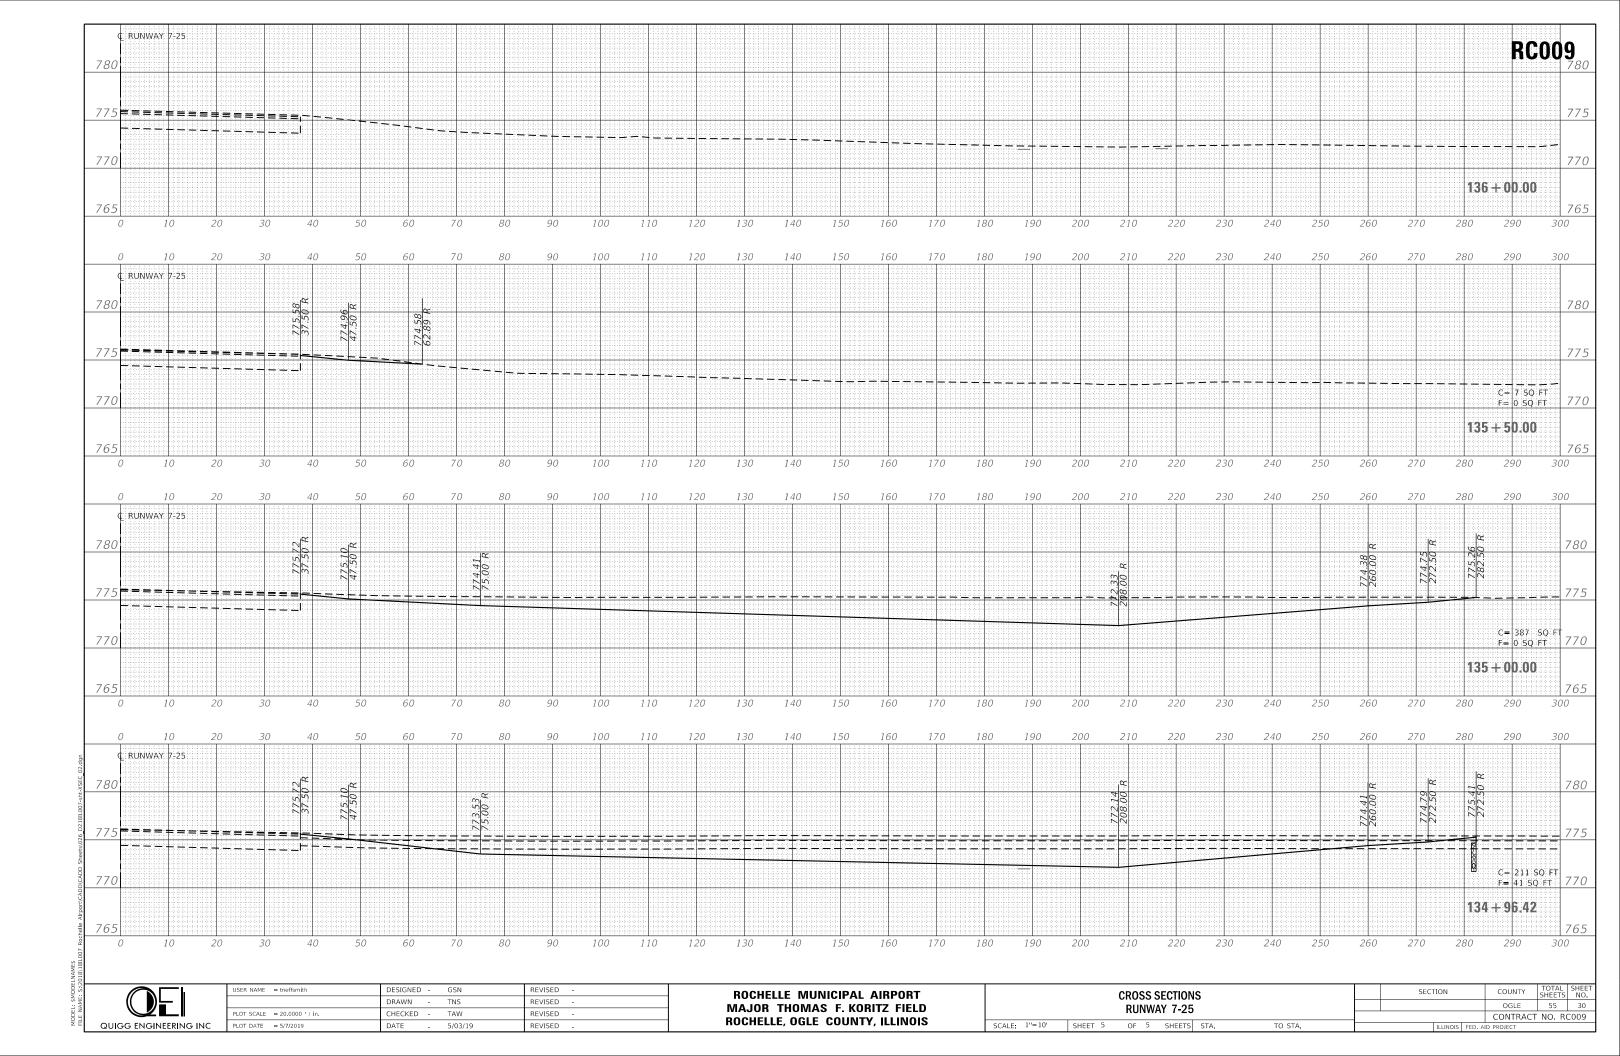NOTE:

THE FIRST 6" OF TOP SOIL WAS NOT CALCULATED AS BORROW. AFTER THE COMPLETION OF THE PROJECT THE TOP SOIL CAN BE PLACED BACK IN THE BORROW AREA. THIS WORK WILL BE INCIDENTIAL TO THE PROJECT.

UNCLASSIFIED EXCAVATION

GRAVEL VOLUME UNDER EXISTING TAXIWAY 1073

TOTAL 2745


1671.69


NOTE: THE AMOUNT OF BORROW WAS CALCULATED ASSUMING THE AGGREGATE IS NOT SUITABLE FOR CONSTRUCTION OF THE NEW TAXIWAY "A". THE MATERIAL MAY BE SUBSTITUTED FOR THE BORROW MATERIAL IF ACCEPTABLE BY THE ENGINEER.

	USER NAME = tneffsmith	DESIGNED -	GSN	REVISED -	ROCHELLE MUNICIPAL AIRPORT		SECTION	COUNTY TOTAL SHEET SHEETS NO.
		DRAWN -	TNS	REVISED -	MAJOR THOMAS F. KORITZ FIELD ROCHELLE, OGLE COUNTY, ILLINOIS	CUT AND FILL TABLES		OGLE 55 31
	PLOT SCALE = 2.0000 ' / in.	CHECKED -	TAW	REVISED -			÷	CONTRACT NO. RC009
QUIGG ENGINEERING INC	PLOT DATE = 5/7/2019	DATE -	5/03/19	REVISED -		SCALE: 1"=1" SHEET 1 OF 1 SHEETS STA. TO STA.	ILLINOIS FED.	AID PROJECT

## RC009



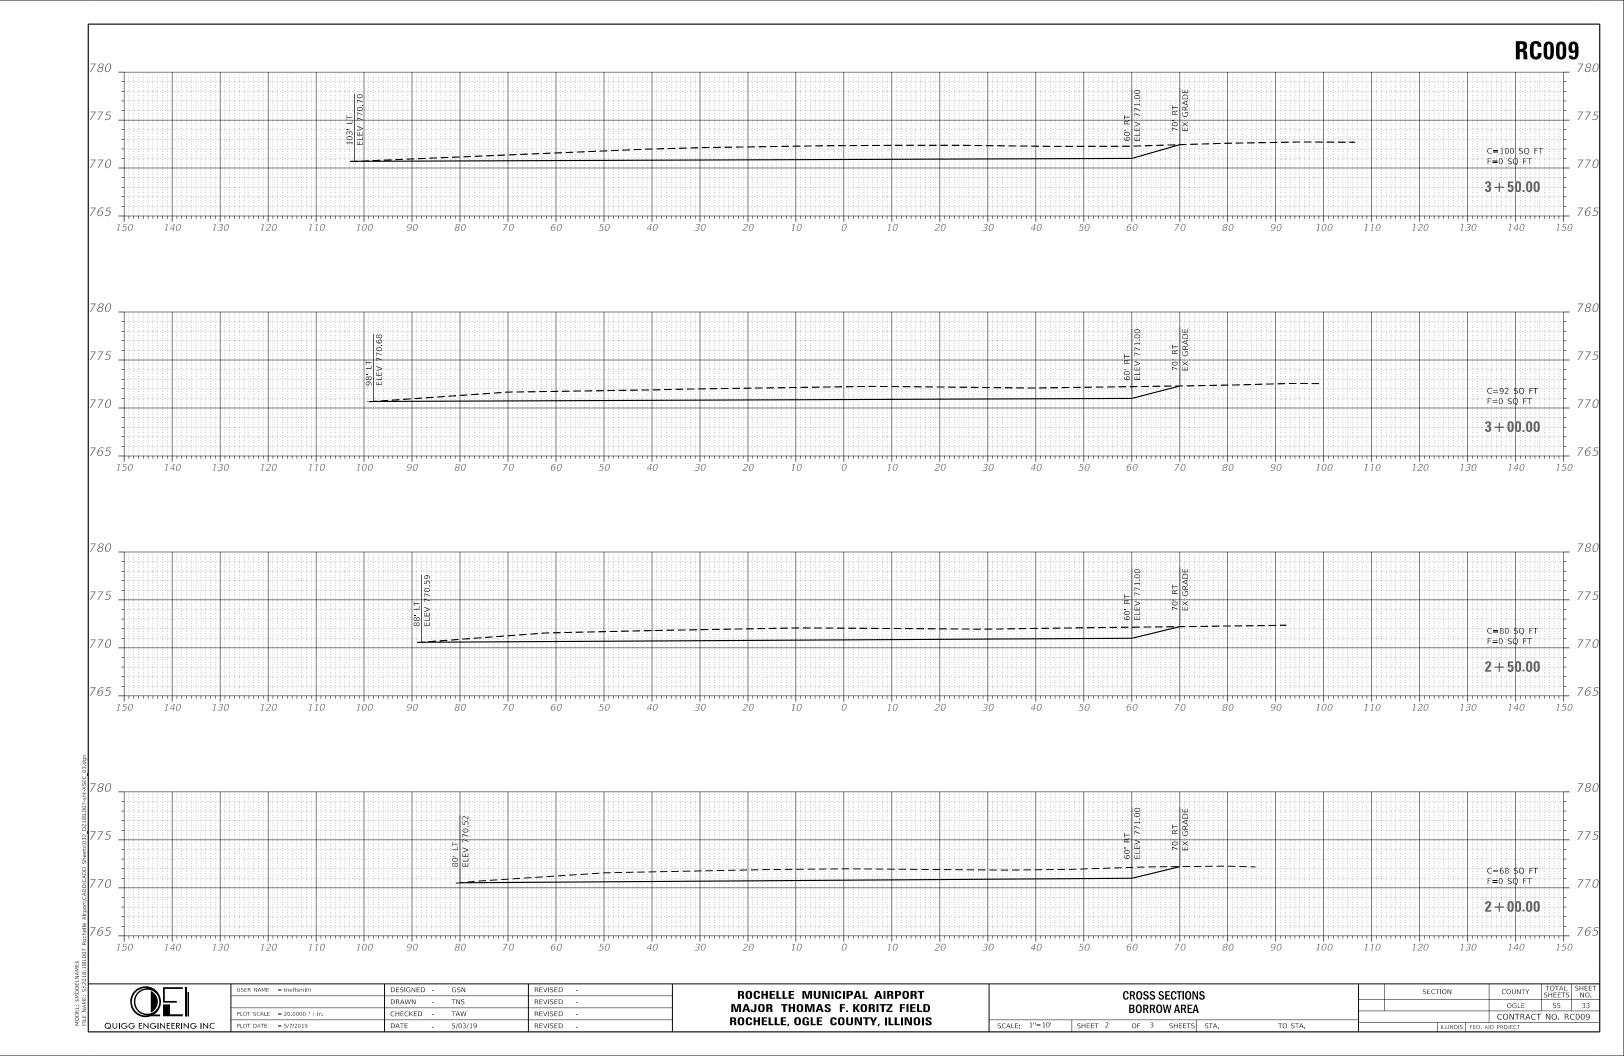

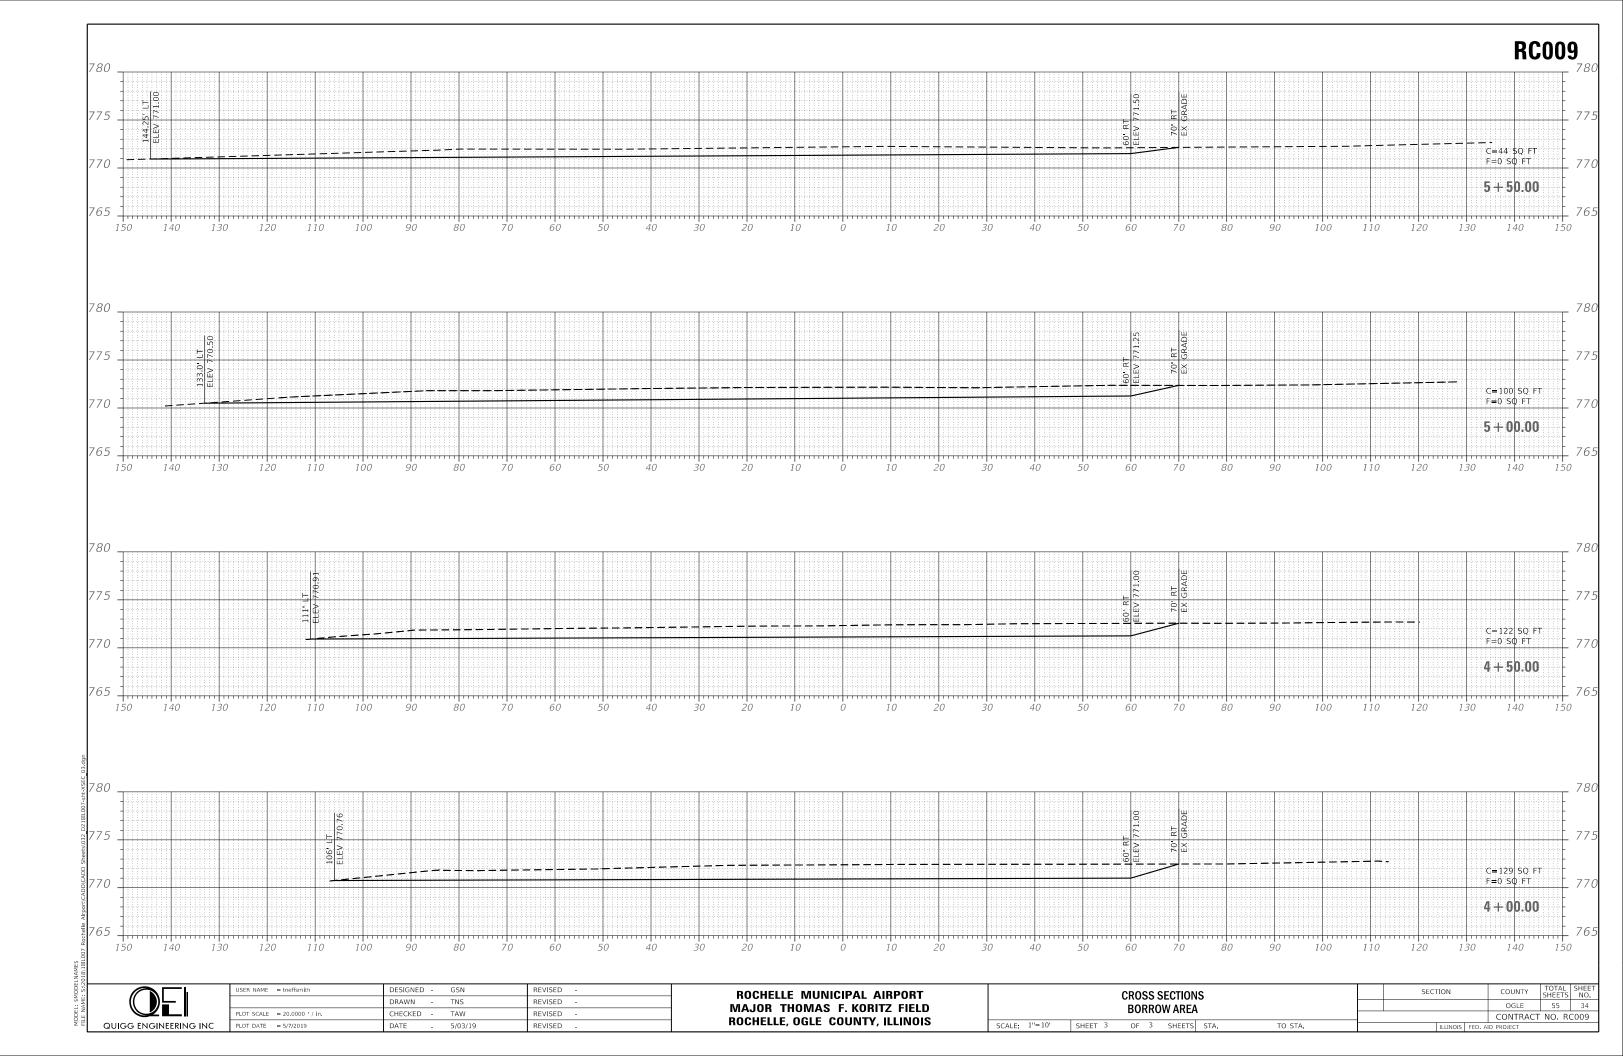

#### **AIRFIELD LIGHTING LEGEND**

- EXISTING STAKE MOUNTED TAXIWAY EDGE LIGHT 0 0 EXISTING BASE MOUNTED TAXIWAY EDGE LIGHT
- EXISTING STAKE MOUNTED RUNWAY EDGE LIGHT
- EXISTING BASE MOUNTED RUNWAY EDGE LIGHT
- EXISTING STAKE MOUNTED RUNWAY THRESHOLD LIGHT Φ
- $\square$ EXISTING BASE MOUNTED RUNWAY THRESHOLD LIGHT
- EXISTING ELECTRICAL HANDHOLE
- <sup>⊠</sup>SC EXISTING SPLICE CAN
- EXISTING REIL UNIT  $\triangleright$
- EXISTING ILLUMINATED SIGN
- EXISTING ELECTRIC CABLE
- EXISTING UNDERGROUND DUCTBANK
- EXISTING ELECTRIC CABLE TO BE ABANDONED
- EXISTING ELECTRIC CABLE TO BE REMOVED  $\times \times \times \times \times \times$ 
  - EXISTING STAKE MOUNTED TAXIWAY EDGE LIGHT TO BE REMOVED Ø
  - EXISTING BASE MOUNTED TAXIWAY EDGE LIGHT TO BE REMOVED
  - EXISTING STAKE MOUNTED RUNWAY EDGE LIGHT TO BE REMOVED X
  - ₩ EXISTING ILLUMINATED SIGN TO BE REMOVED
  - DENOTES REMOVAL AND REPLACEMENT OF EXISTING ISOLATION TRANSFORMER FOR ASSOCIATED LIGHT FIXTURE RR
  - PROPOSED L-861T(L) STAKE MOUNTED TAXIWAY EDGE LIGHT •
  - PROPOSED L-861T(L) BASE MOUNTED TAXIWAY EDGE LIGHT ۲
  - PROPOSED ELECTRICAL HANDHOLE
  - PROPOSED ELECTRIC CABLE (AS NOTED ON THE PLANS)
    - PROPOSED UNDERGROUND DUCTBANK
- ----- PROPOSED COUNTERPOISE WIRE FOR EXISTING ELECTRIC CABLE TO REMAIN

#### **AIRFIELD LIGHTING ABBREVIATIONS**

- AWG AMERICAN WIRE GAUGE CONSTANT CURRENT REGULATOR CCR СКТ CIRCUIT CU COPPER FAA FEDERAL AVIATION ADMINISTRATION GND GROUND GALVANIZED RIGID STEEL CONDUIT GRSC HIGH DENSITY POLYETHYLENE HDPF
- HIGH VOLTAGE ΗV
- ΚV KILOVOLT
- LIGHT EMITTING DIODE LED
- LOW VOLTAGE LV NEC NATIONAL ELECTRICAL CODE
- NPT NATIONAL PIPE THREAD
- OSHA OCCUPATIONAL SAFETY AND HEALTH ADMINISTRATION
- PAPI PRECISION APPROACH PATH INDICATOR
- PCU
- PVC SCH
- REIL
- UNDERWRITERS LABORATORIES UL
- VOLTS
- VOLTS ALTERNATING CURRENT VAC


#### POWER AND CONTROL UNIT POLYVINYL CHLORIDE SCHEDULE RUNWAY END IDENTIFIER LIGHT

011	USER NAME = rswanson	DESIGNED - RAS	REVISED -	ROCHELLE MUNICIPAL AIRPORT	AIRFIELD LIGHTING LEGEND,	SECTION	COUNTY TOTAL SHEET
СЦ		DRAWN - SG	REVISED -	MAJOR THOMAS F. KORITZ FIELD	GENERAL NOTES, AND ABBREVIATIONS		OGLE 55 35
ווט	PLOT SCALE = 2.00 / in	CHECKED - RAS	REVISED -	ROCHELLE, OGLE COUNTY, ILLINOIS	GENERAL NUTES, AND ADDREVIATIONS	· · · · · · · · · · · · · · · · · · ·	CONTRACT NO. 18IL007
CONSULTING ENGINEERS	PLOT DATE = 5/3/2019	DATE - 05/03/2019	REVISED -	NUCHELLE, VALE COUNTY, ILLINUIS	SCALE: NTS SHEET OF SHEETS STA. TO STA.	ILLINOIS FED. AID	) PROJECT


### **AIRFIELD LIGHTING GENERAL NOTES**

- 1. THE CONTRACTOR SHALL FIELD VERIFY EXISTING SITE CONDITIONS. THE CONTRACTOR SHALL FIELD VERIFY RESPECTIVE CIRCUITS AND POWER SOURCES PRIOR TO REMOVING OR DISCONNECTING THE RESPECTIVE AIRFIELD LIGHTING, NAVAID, OR OTHER DEVICE.
- 2. ALL WORK, POWER OUTAGES, AND/OR SHUTDOWN OF EXISTING SYSTEMS SHALL BE COORDINATED WITH THE AIRPORT MANAGER. ONCE SHUT DOWN, CIRCUITS SHALL BE LABELED AS SUCH TO PREVENT ACCIDENTAL ENERGIZATION OF THE RESPECTIVE CIRCUITS. THE CONTRACTOR SHALL COMPLY WITH ALL OSHA LOCKOUT/TAGOUT PROCEDURES.
- 3. IN AREAS WHERE THERE IS A CONGESTION OF CABLE OR PROPOSED CABLE CROSSES AN EXISTING CABLE. THE CONTRACTOR SHALL HAND DIG THE TRENCH REQUIRED FOR THE PROPOSED CABLE. AT OTHER LOCATIONS, THE PROPOSED CABLE MAY BE TRENCHED OR PLOWED INTO PLACE. HAND DIGGING, TRENCHING, AND/OR PLOWING WILL BE CONSIDERED INCIDENTAL TO THE PROPOSED CABLES, AND NO ADDITIONAL COMPENSATION WILL BE ALLOWED.
- 4. LIGHT FIXTURES, LIGHT BASES, AND ISOLATION TRANSFORMERS DESIGNATED FOR REMOVAL SHALL BE RETURNED TO THE AIRPORT MANAGER.
- 5. THE CONTRACTOR MAY ELECT TO REMOVE AND SALVAGE EXISTING ELECTRIC CABLE DENOTED FOR ABANDONMENT ON THE PLANS, BUT NO ADDITIONAL COMPENSATION WILL BE ALLOWED FOR CABLE REMOVAL.
- 6. ALL SHEETS DESIGNATED AS "ADDITIVE ALTERNATE" IN THE TITLE BLOCK SHALL BE DISREGARDED IF THE ADDITIVE ALTERNATE IS NOT ACCEPTED.
- 7. EXISTING LIGHT FIXTURES TO REMAIN IN PLACE WILL REQUIRE NEW NUMBERING TAGS DUE TO NEW WORK WHERE SHOWN ON THE PLANS. FIXTURE NUMBERING SHOWN ON REMOVAL PLAN SHEETS REFLECTS EXISTING CONDITIONS, AND FIXTURE NUMBERING ON PROPOSED PLAN SHEETS REPRESENTS FINAL CONDITIONS. REPLACEMENT OF LIGHT FIXTURE NUMBERING TAGS FOR EXISTING FIXTURES TO REMAIN IN PLACE IS INCIDENTAL TO THE CONTRACT.
- 8. THE CONTRACTOR SHALL IDENTIFY ALL EXISTING UNDERGROUND UTILITIES LOCATED WITHIN AREAS WHERE PROPOSED CABLES ARE BEING INSTALLED, AND SHALL TAKE PRECAUTIONS TO PROTECT THESE UTILITIES FROM DAMAGE. ANY UNDERGROUND UTILITY DAMAGED SHALL BE REPAIRED OR REPLACED AT THE CONTRACTOR'S EXPENSE.
- 9. ALL GROUND RODS ASSOCIATED WITH THE COUNTERPOISE SYSTEM ARE INCLUDED IN THE PRICE OF THE COUNTERPOISE WIRE. NO ADDITIONAL COMPENSATION WILL BE ALLOWED.


## **RC009**

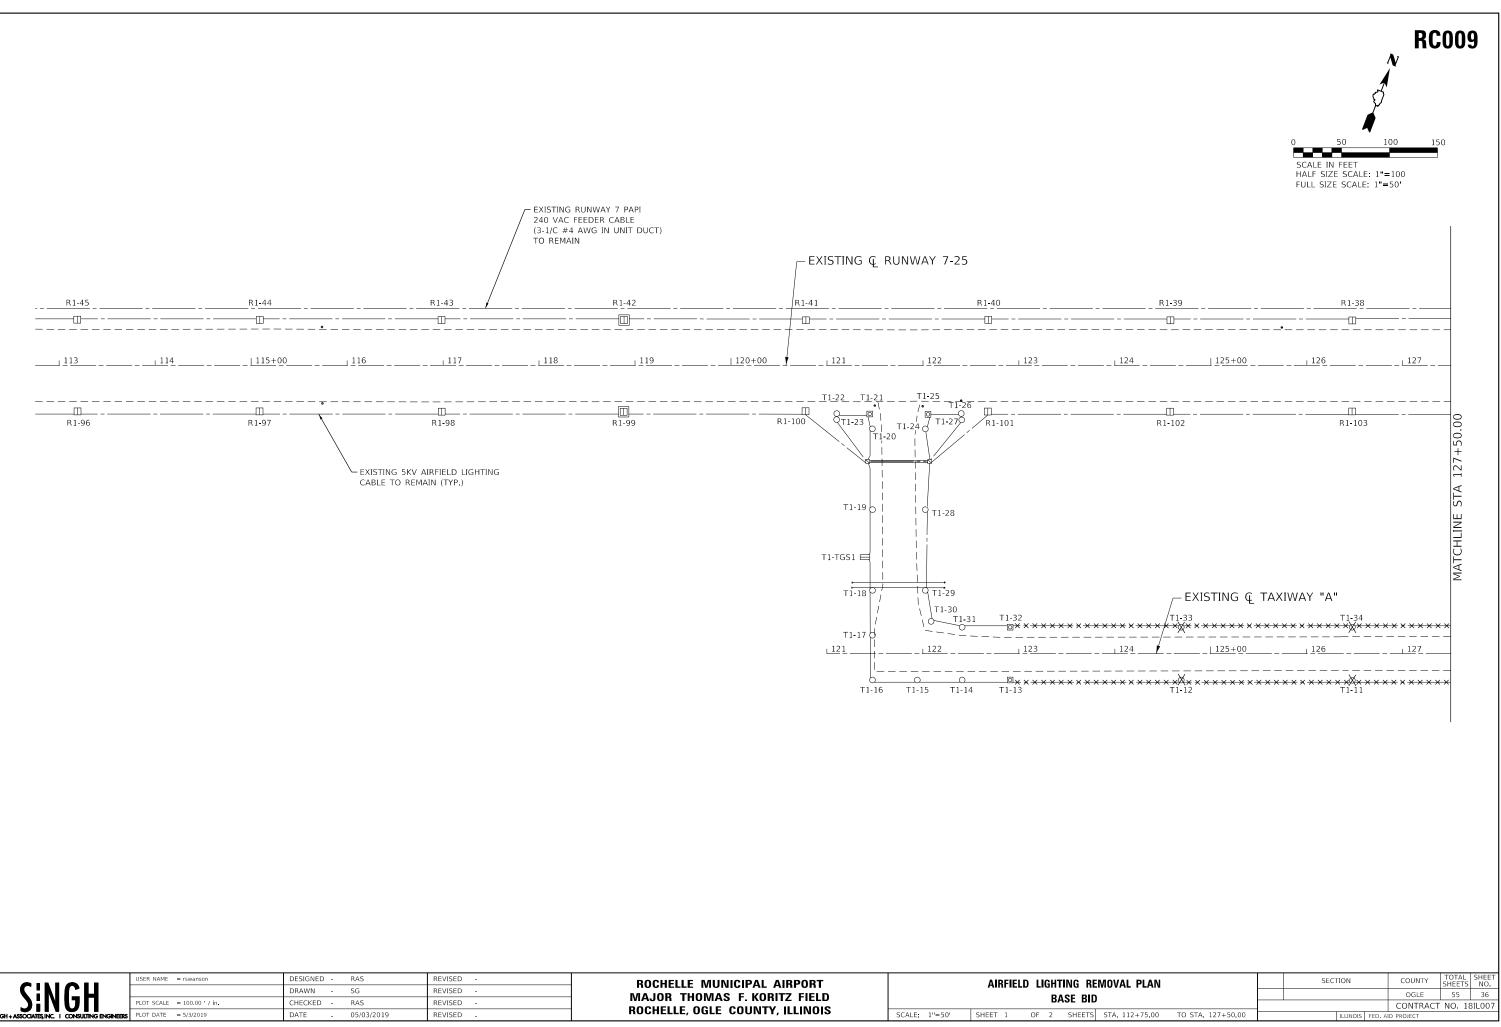


CINICII	USER NAME = rswanson	DESIGNED - RAS DRAWN - SG	REVISED - REVISED -	ROCHELLE MUNICIPAL AIRPORT		AIRFIEL	D LIGHTING REM
SINGH	PLOT SCALE = 100.00 ' / in.	CHECKED - RAS	REVISED -	MAJOR THOMAS F. KORITZ FIELD			BASE BID
+ ASSOCIATES, INC.   CONSULTING ENGINEERS	PLOT DATE = 5/3/2019	DATE - 05/03/2019	REVISED -	ROCHELLE, OGLE COUNTY, ILLINOIS	SCALE: 1"=50	SHEET 1	OF 2 SHEETS ST

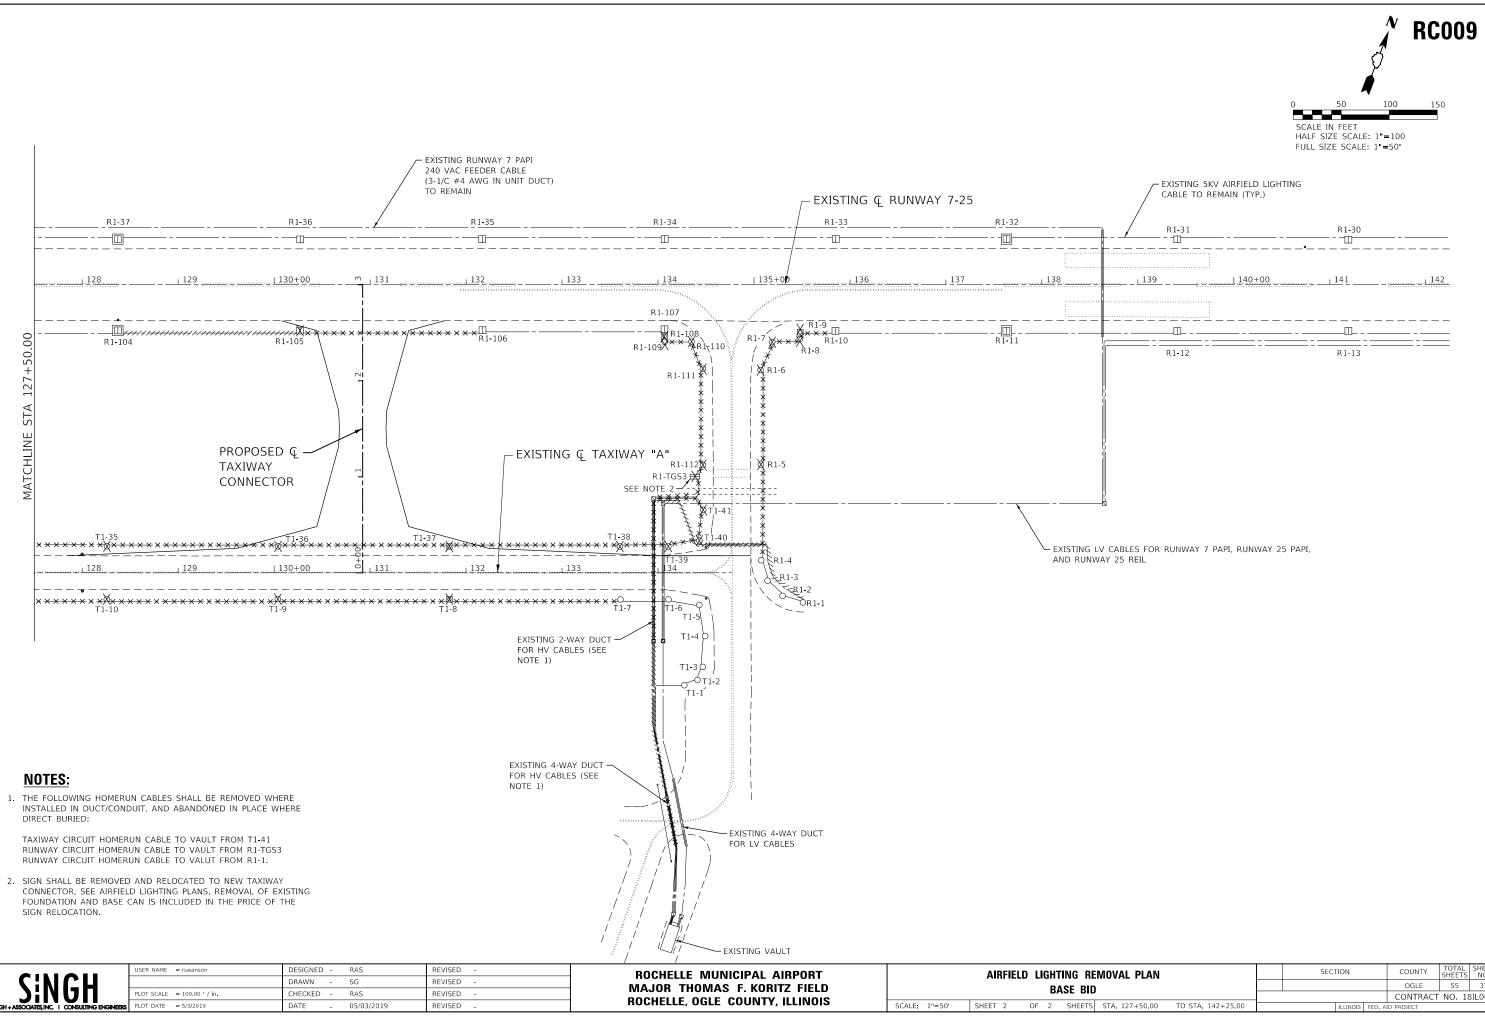


REMOVAL PLAN ID			SECT	ION		COUNTY	TOTAL SHEETS	SHEET NO.
						OGLE	55	37
						CONTRACT	NO. 18	BILOO7
٢S	STA. 127+50.00	TO STA. 142+25.00		ILLINOIS	FED. AI	D PROJECT		

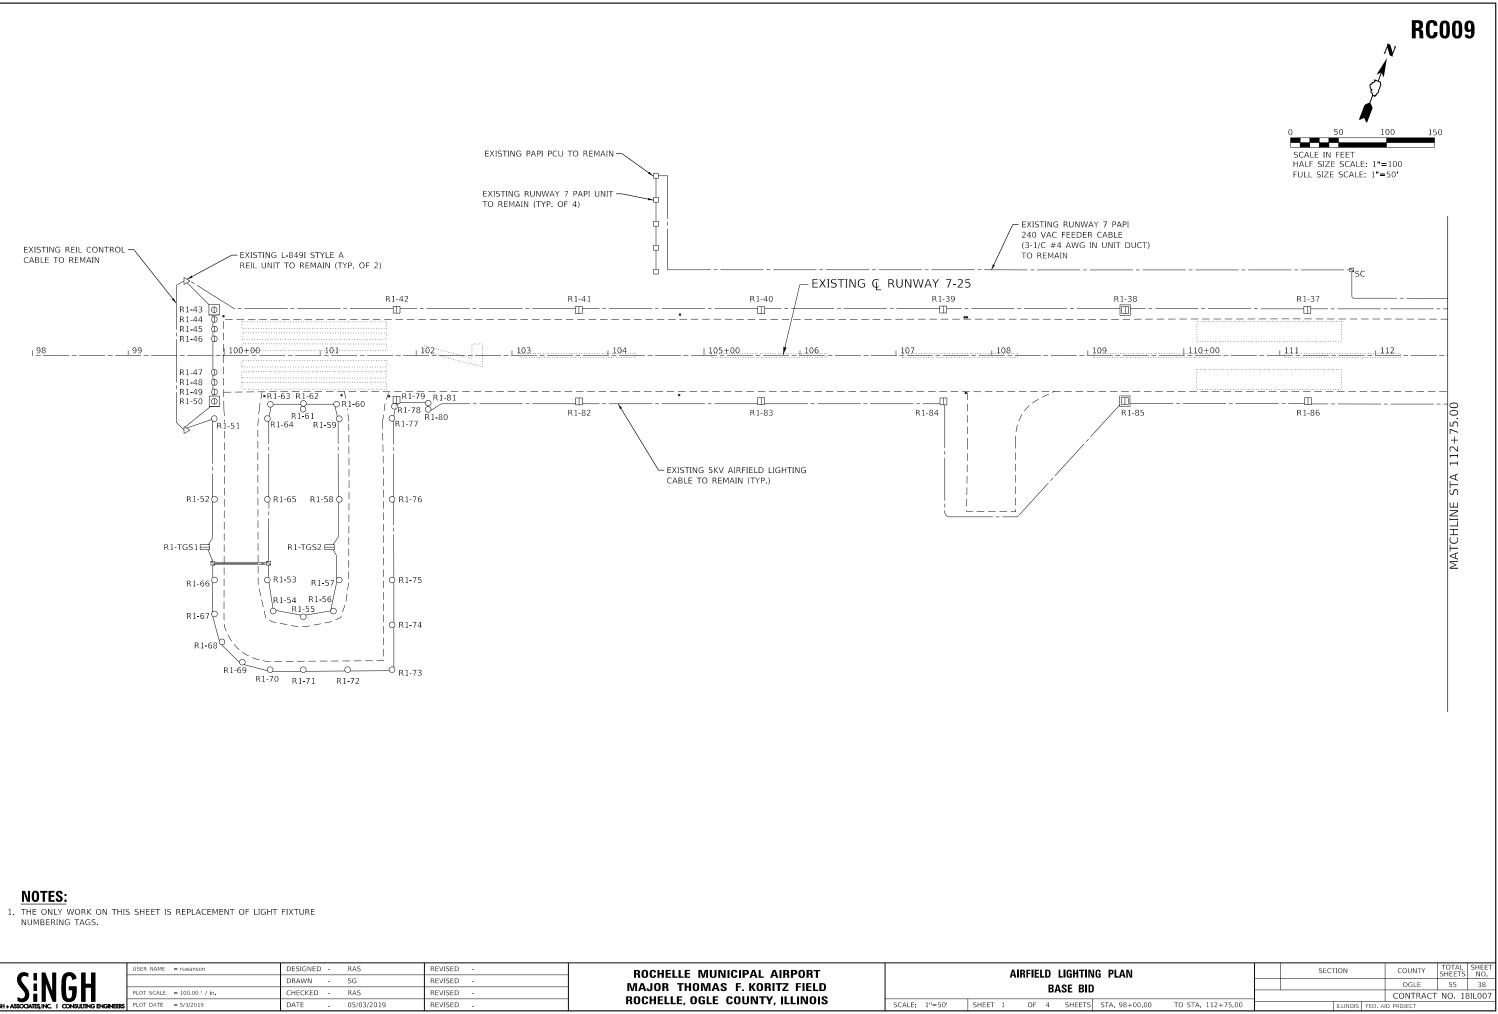


	USER NAME = rswanson	DESIGNED - RAS	REVISED -	ROCHELLE MUNICIPAL AIRPORT		AIF	RFIELD LIGHTING
		DRAWN - SG	REVISED -	MAJOR THOMAS F. KORITZ FIELD			
Э:КОП	PLOT SCALE = 100.00 / in.	CHECKED - RAS	REVISED -		L		BASE BID
SINGH + ASSOCIATES, INC.   CONSULTING ENGINEERS	PLOT DATE = 5/3/2019	DATE - 05/03/2019	REVISED -	ROCHELLE, OGLE COUNTY, ILLINOIS	SCALE: 1"=50'	SHEET 1	OF 4 SHEETS S

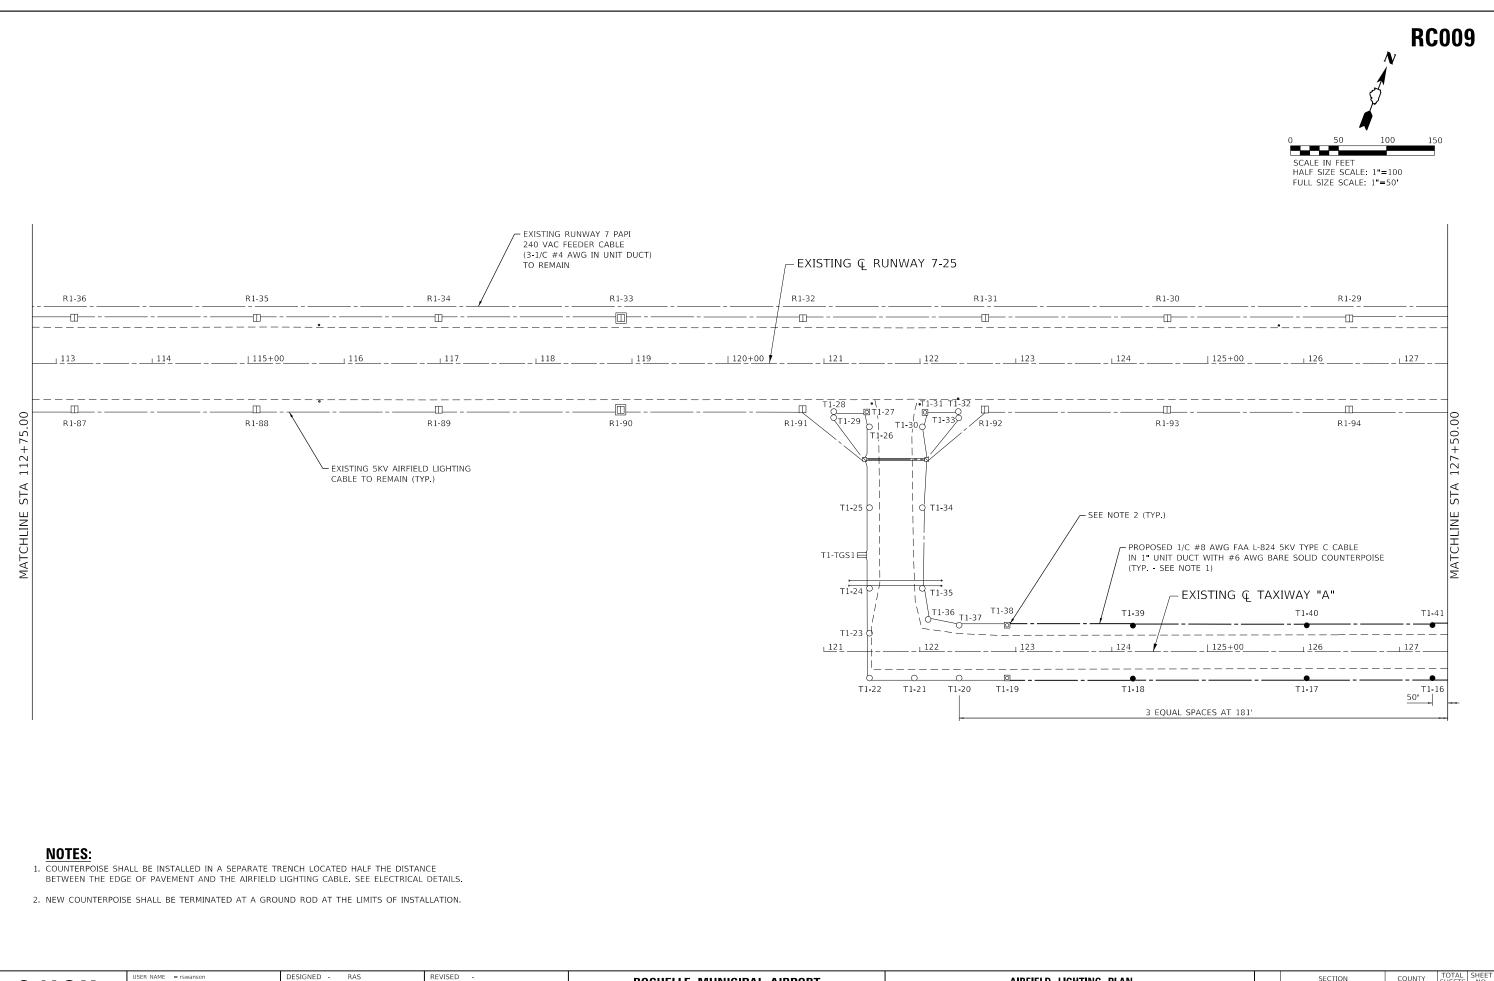


	USER NAME = rswanson	DESIGNED - RAS	REVISED -	ROCHELLE MUNICIPAL AIRPORT	AIRFIELD LIGHTING PLAN	SECTION	COUNTY TOTAL SHEET SHEETS NO.
SINGH		DRAWN - SG	REVISED -	MAJOR THOMAS F. KORITZ FIELD	BASE BID		OGLE 55 39
	PLOT SCALE = 100.00 ' / in.	CHECKED - RAS	REVISED -	ROCHELLE, OGLE COUNTY, ILLINOIS	SCALE: 1"=50' SHEET 2 OF 4 SHEETS STA 112+75.00 TO STA 127+50.00		CONTRACT NO. 18IL007
GH + ASSOCIATES, INC. I CONSULTING ENGINEERS	TEOT DATE = SISTEORS	BATE = 05/05/2015	REVISED -		SCALE 1 - 50 SILE 2 OI 4 SILE 3 SIA 112/7500 10 SIA 12/75000	ILLINUIS FED. AI	ID PROJECT

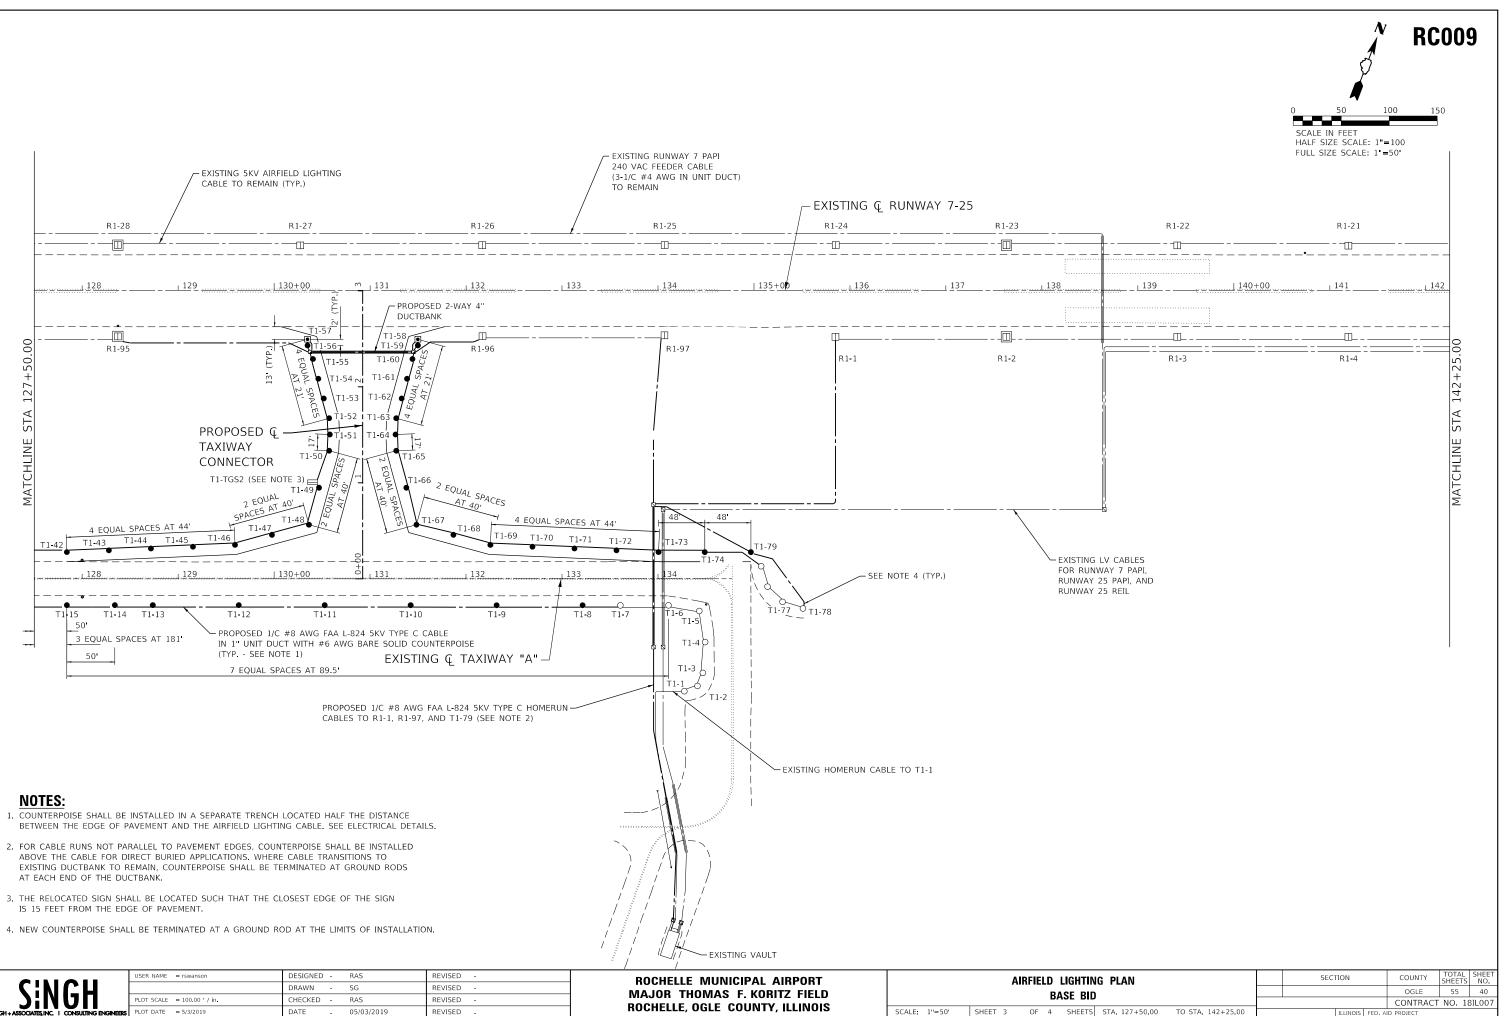


	USER NAME = ISWAIISUI	DESIGNED -	RAS	REVISED -	ROCHELLE MUNICIPAL AIRPORT	1	AIRFIELD LIGHTING F			
CINCU		DRAWN -	SG	REVISED -	MAJOR THOMAS F. KORITZ FIELD	1				
SINUN	PLOT SCALE = 100.00 ' / in.	CHECKED -	RAS	REVISED -		1		BA	SE BID	1
SOCIATES, INC.   CONSULTING ENGINEERS	PLOT DATE = 5/3/2019	DATE -	05/03/2019	REVISED -	ROCHELLE, OGLE COUNTY, ILLINOIS	SCALE: 1"=50'	SHEET 3	OF 4	SHEETS	STA

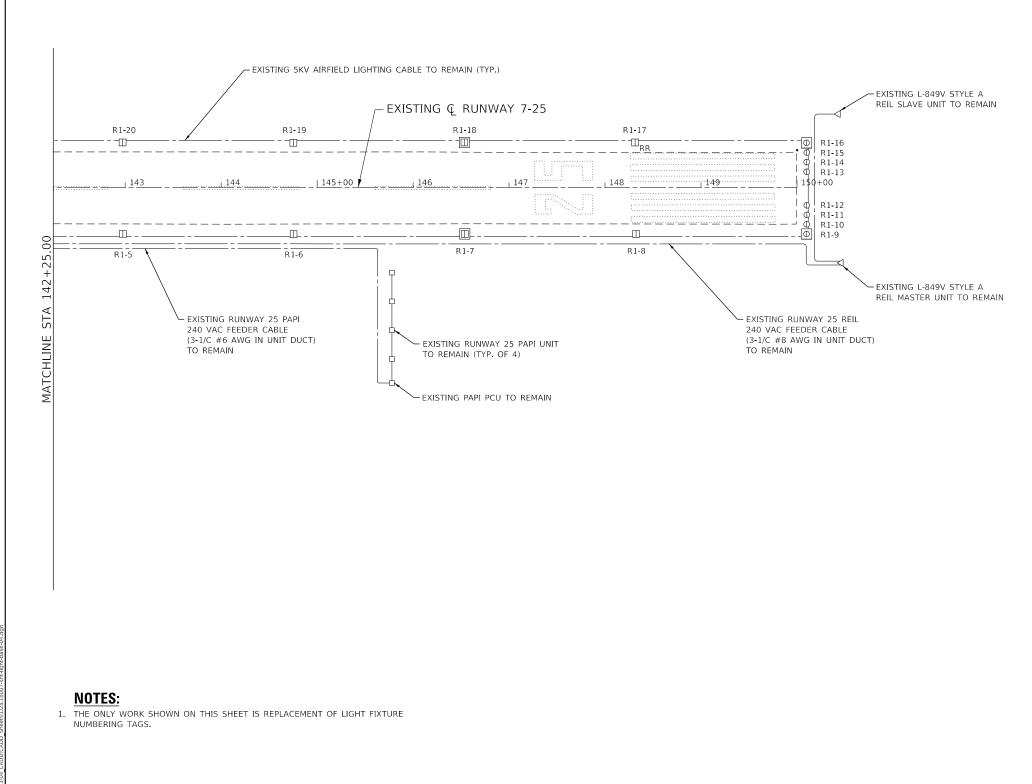


	USER NAME = rswanson	DESIGNED - RAS	REVISED -	ROCHELLE MUNICIPAL AIRPORT	AIRFIELD LIGHTING PLAN	SECTION	COUNTY TOTAL SHEET SHEETS NO.
SINCH		DRAWN - SG	REVISED -	MAJOR THOMAS F. KORITZ FIELD	BASE BID		OGLE 55 41
SINGH	PLOT SCALE = 100.00 / in.	CHECKED - RAS	REVISED -			·	CONTRACT NO. 18IL007
GH + ASSOCIATES, INC.   CONSULTING ENGINEERS	PLOT DATE = 5/3/2019	DATE - 05/03/2019	REVISED -		SCALE: 1"=50' SHEET 4 OF 4 SHEETS STA 142+25.00 TO STA 150+00.00	ILLINOIS FED. 4	ID PROJECT

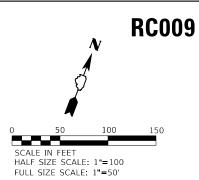

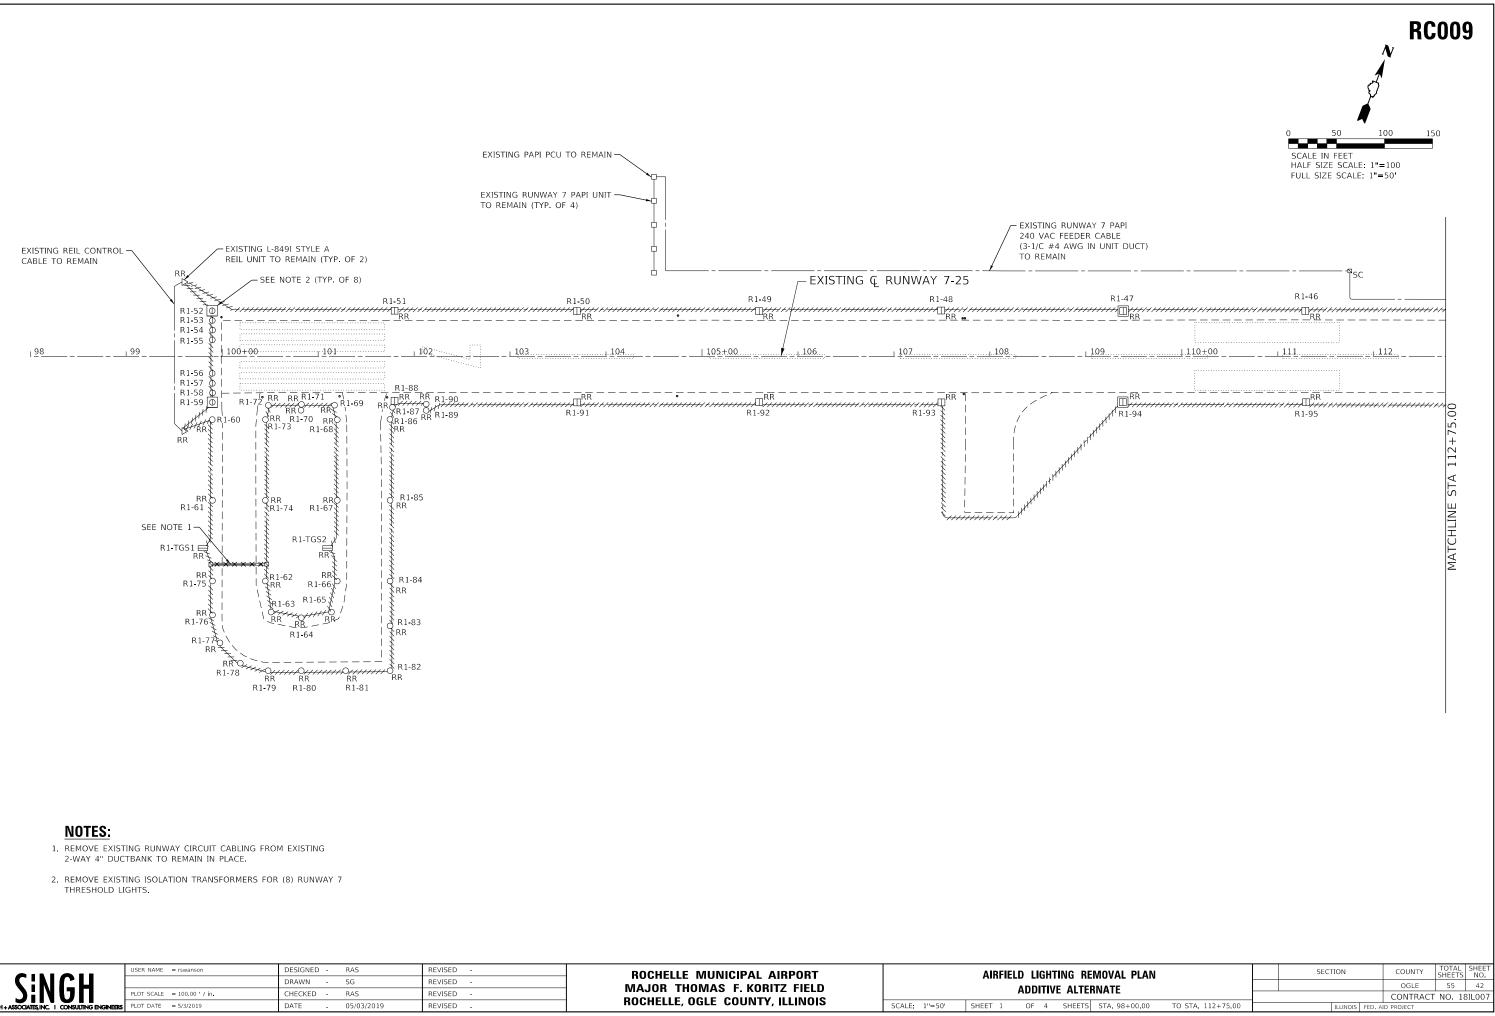


SINGH	USER NAME = rswanson PLOT SCALE = 100.00 ' / in.	DESIGNED - RAS DRAWN - SG CHECKED - RAS	REVISED - REVISED - REVISED -	ROCHELLE MUNICIPAL AIRPORT MAJOR THOMAS F. KORITZ FIELD		AIRFIELD LIGHTING REM ADDITIVE ALTERN
GH+ASSOCIATES, INC.   CONSULTING ENGINEERS	PLOT DATE = 5/3/2019	DATE - 05/03/2019	REVISED -	ROCHELLE, OGLE COUNTY, ILLINOIS	SCALE: 1"=50'	SHEET 1 OF 4 SHEETS S

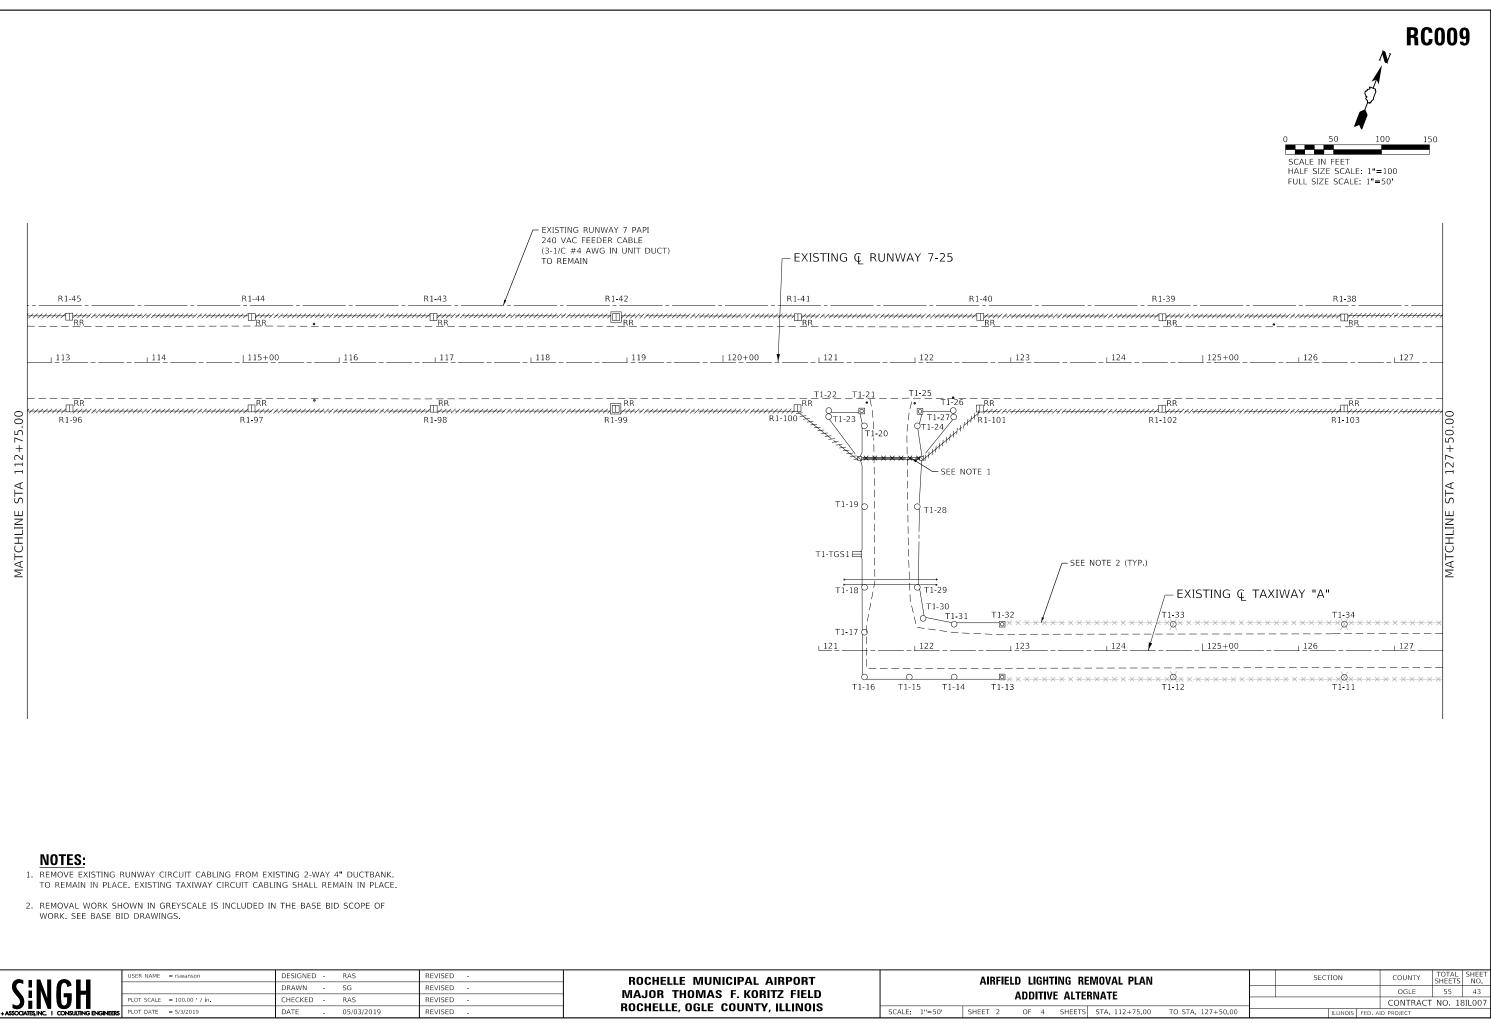


	USER NAME = rswanson	DESIGNED -	RAS	REVISED -
		DRAWN -	SG	REVISED -
INUN	PLOT SCALE = 100.00 ' / in.	CHECKED -	RAS	REVISED -
TES, INC.   CONSULTING ENGINEERS	PLOT DATE = 5/3/2019	DATE -	05/03/2019	REVISED -

ROCHELLE MUNICIPAL AIRPO	REVISED -	
MAJOR THOMAS F. KORITZ F	REVISED -	
	REVISED -	
ROCHELLE, OGLE COUNTY, ILLI	REVISED -	


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			A	D	ITI	/E AL	TE
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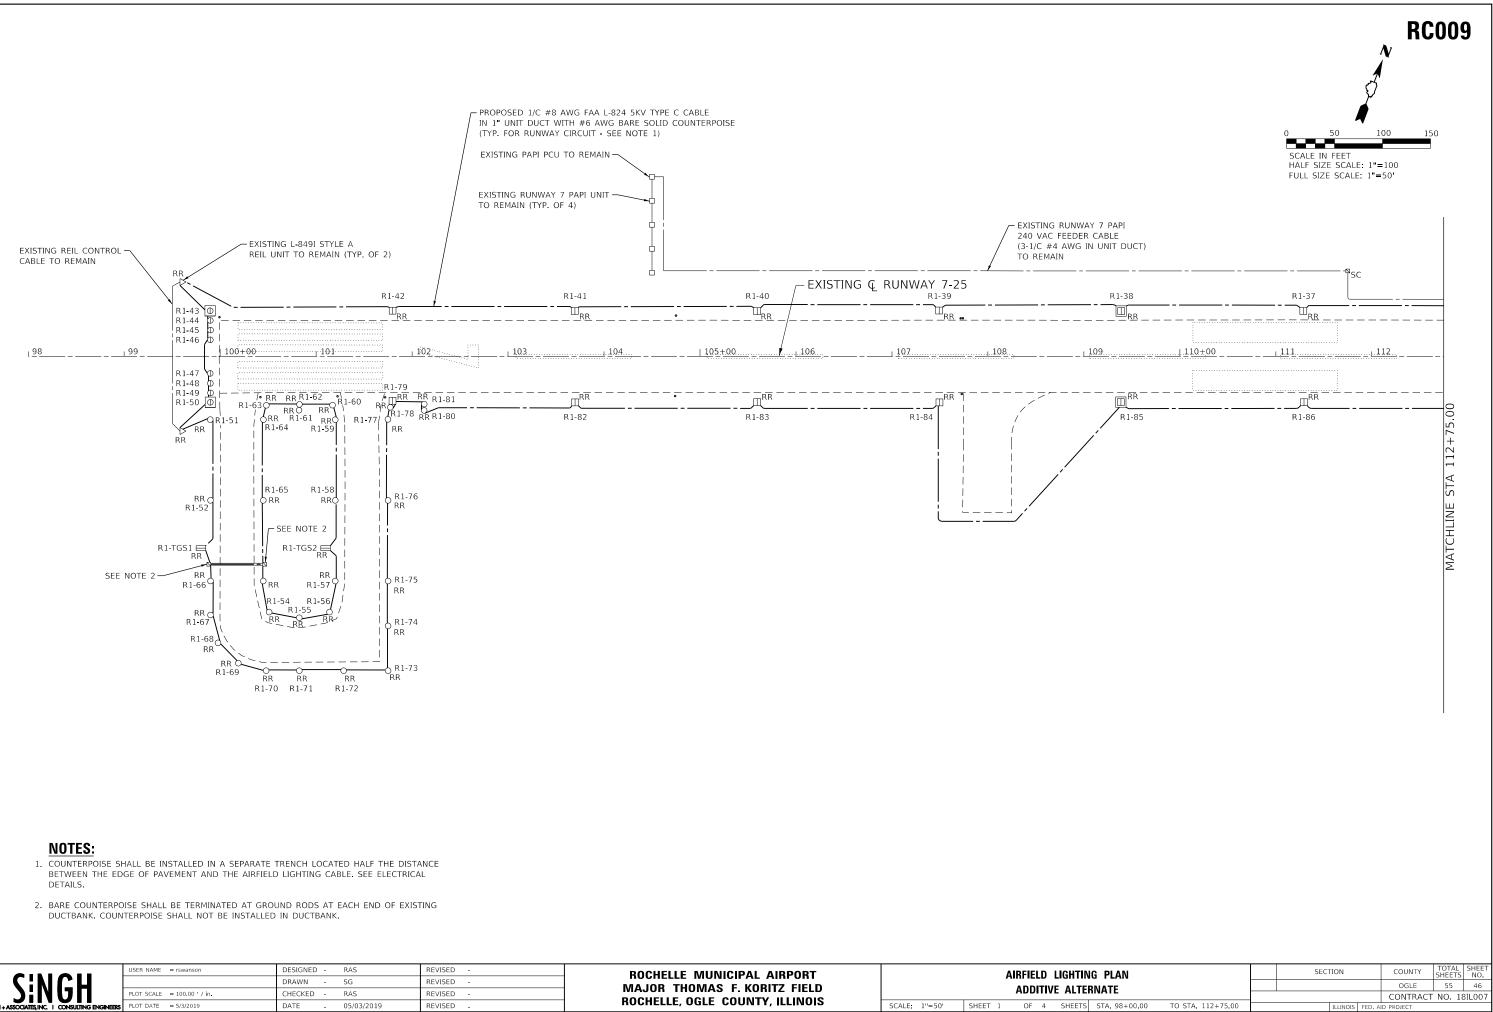


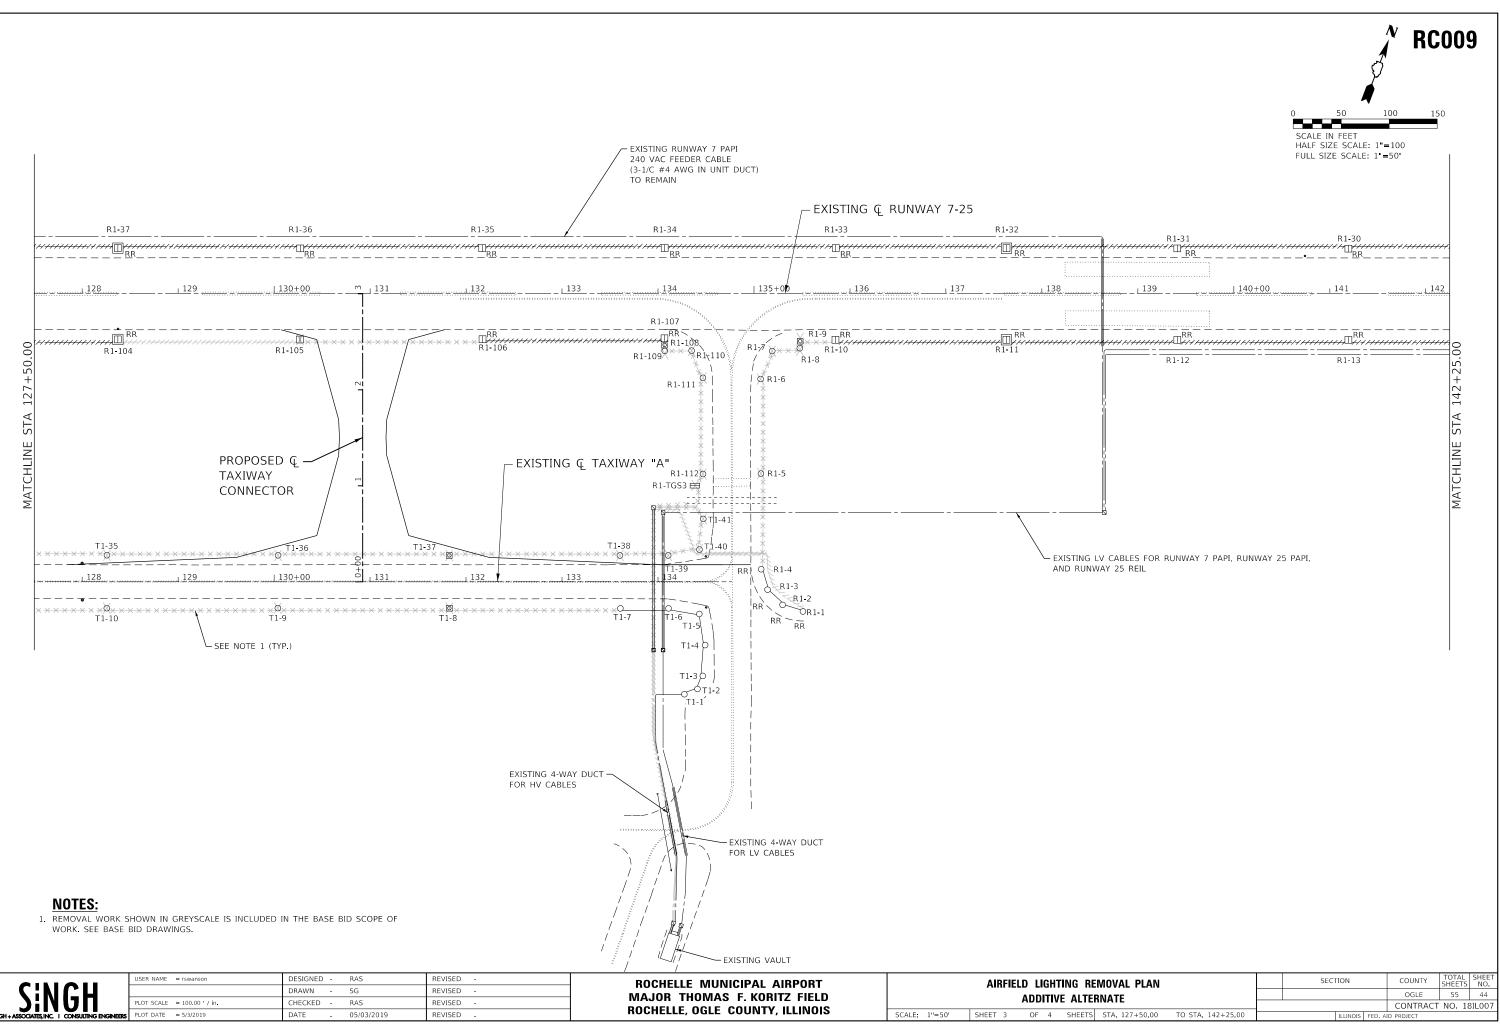SCALE: 1	'=50' SHEE	ET 3	OF	4

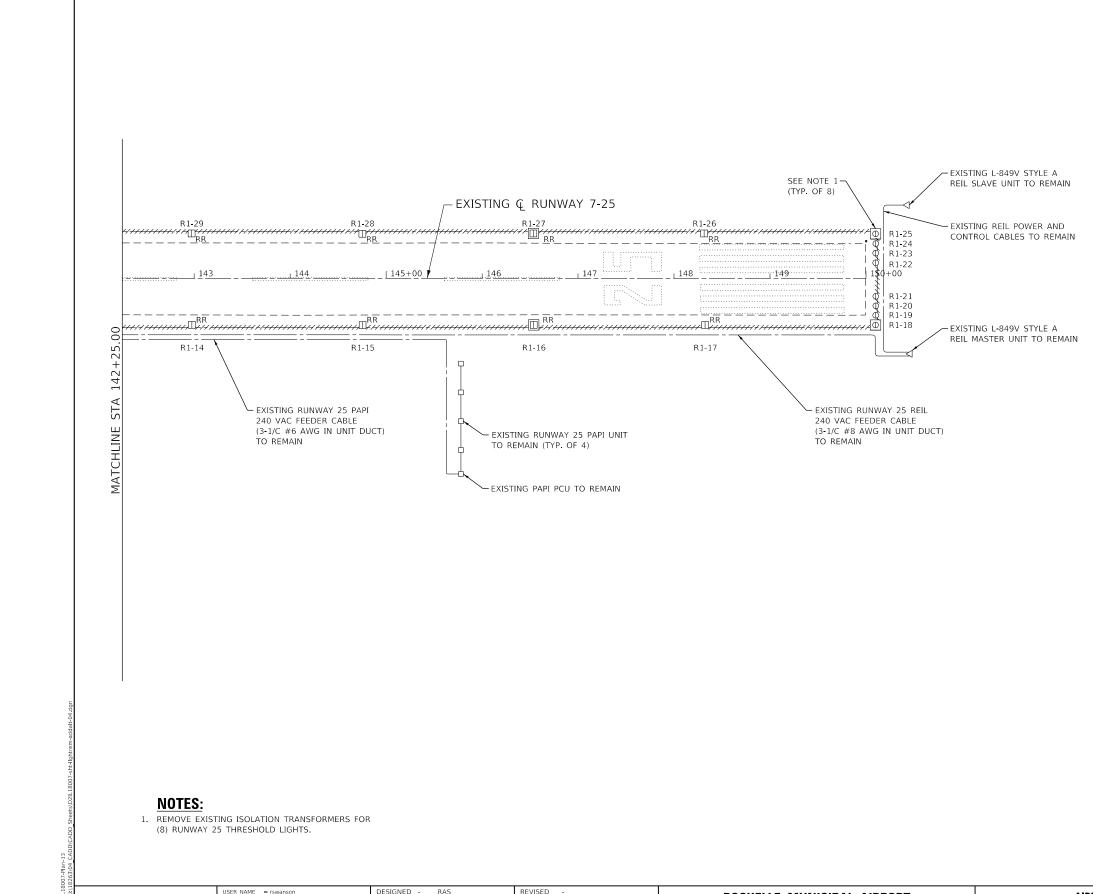


	USER NAME = rswanson	DESIGNED - RAS	REVISED -	ROCHELLE MUNICIPAL AIRPORT	AIRFIELD LIGHTING REMOVAL PLAN	SECTION	COUNTY TOTAL SHEET SHEETS NO.
SINGH		DRAWN - SG	REVISED -	MAJOR THOMAS F. KORITZ FIELD	ADDITIVE ALTERNATE		OGLE 55 45
SINDII	PLOT SCALE = 100.00 / in	CHECKED - RAS	REVISED -				CONTRACT NO. 18IL007
++ASSOCIATES, INC.   CONSULTING ENGINEE	RS PLOT DATE = 5/3/2019	DATE - 05/03/2019	REVISED -	ROCHELLE, OGLE COUNTY, ILLINOIS	SCALE: 1"=50' SHEET 4 OF 4 SHEETS STA. 142+25.00 TO STA. 150+00.00	ILLINOIS FED. AID	PROJECT




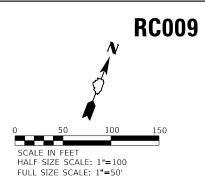


S:NGH	USER NAME = rswanson PLOT SCALE = 100.00 ' / in.	DESIGNED - RAS DRAWN - SG CHECKED - RAS	REVISED - REVISED - REVISED -	ROCHELLE MUNICIPAL AIRPORT Major Thomas F. Koritz Field		AIRFIELD LIGHTING ADDITIVE ALTERN
IGH + ASSOCIATES, INC.   CONSULTING ENGINEERS	PLOT DATE = 5/3/2019	DATE - 05/03/2019	REVISED -	ROCHELLE, OGLE COUNTY, ILLINOIS	SCALE: 1"=50'	SHEET 1 OF 4 SHEETS S

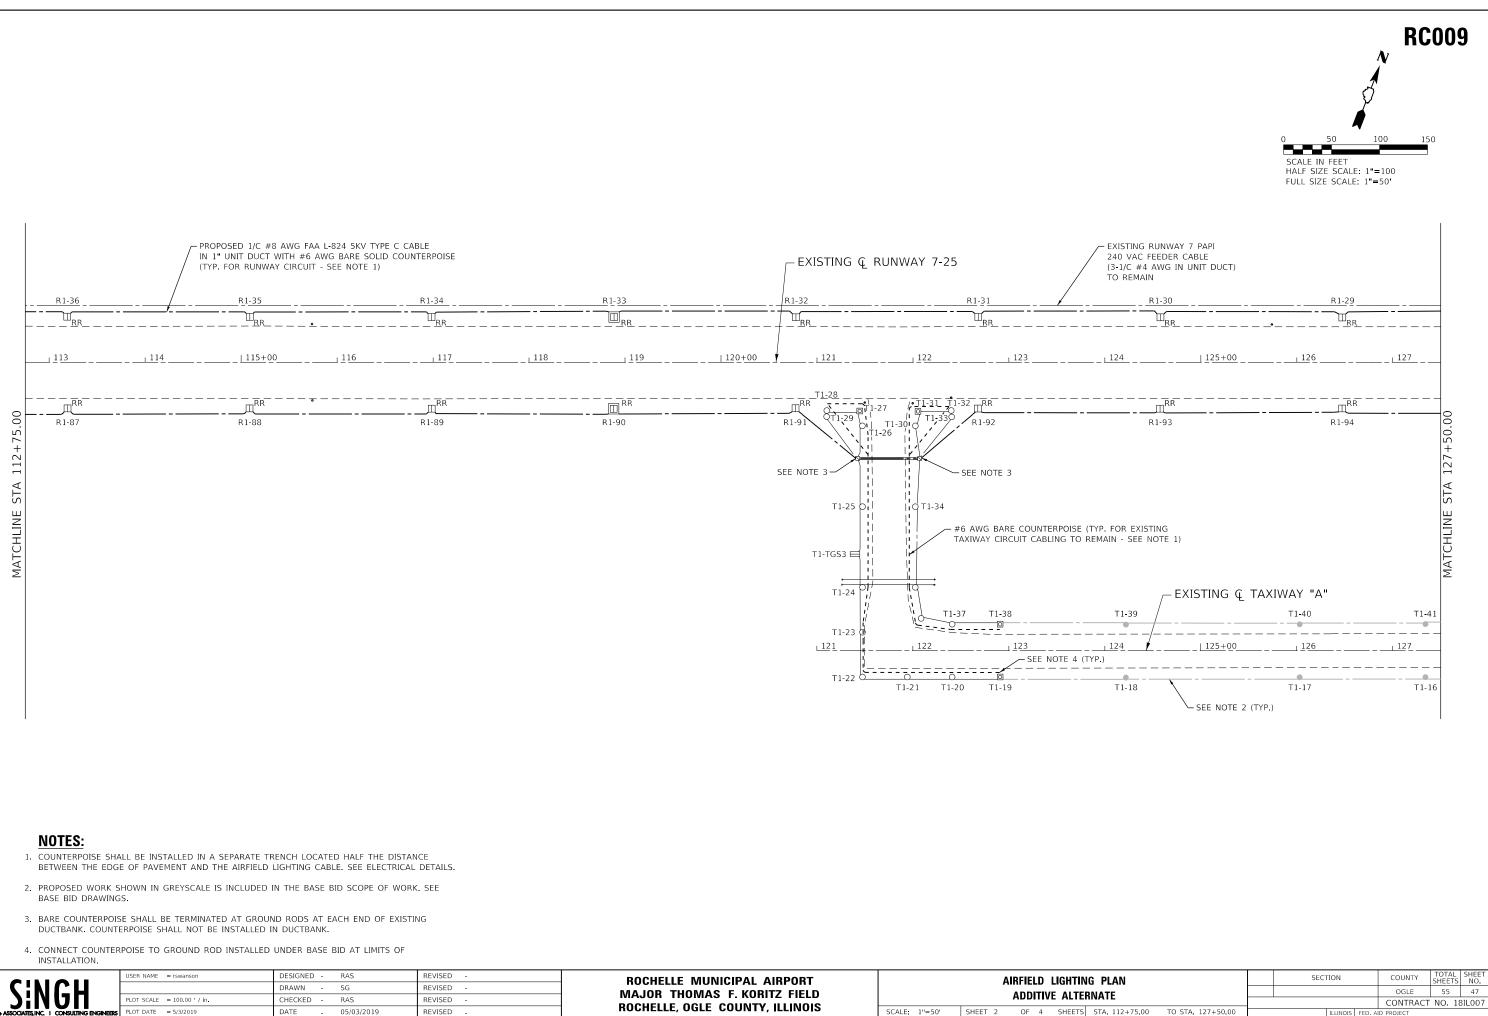


	USER NAME = rswanson	DESIGNED - RAS	REVISED -	ROCHELLE MUNICIPAL AIRPORT		ΔΙ	RFIELD LIGHTING
		DRAWN - SG	REVISED -	MAJOR THOMAS F. KORITZ FIELD		~	
<b>З:NUП</b>	PLOT SCALE = 100.00 / in.	CHECKED - RAS	REVISED -				ADDITIVE ALTERN
SINGH + ASSOCIATES, INC.   CONSULTING ENGINEERS	PLOT DATE = 5/3/2019	DATE - 05/03/2019	REVISED -	ROCHELLE, OGLE COUNTY, ILLINOIS	SCALE: 1"=50'	SHEET 2	OF 4 SHEETS

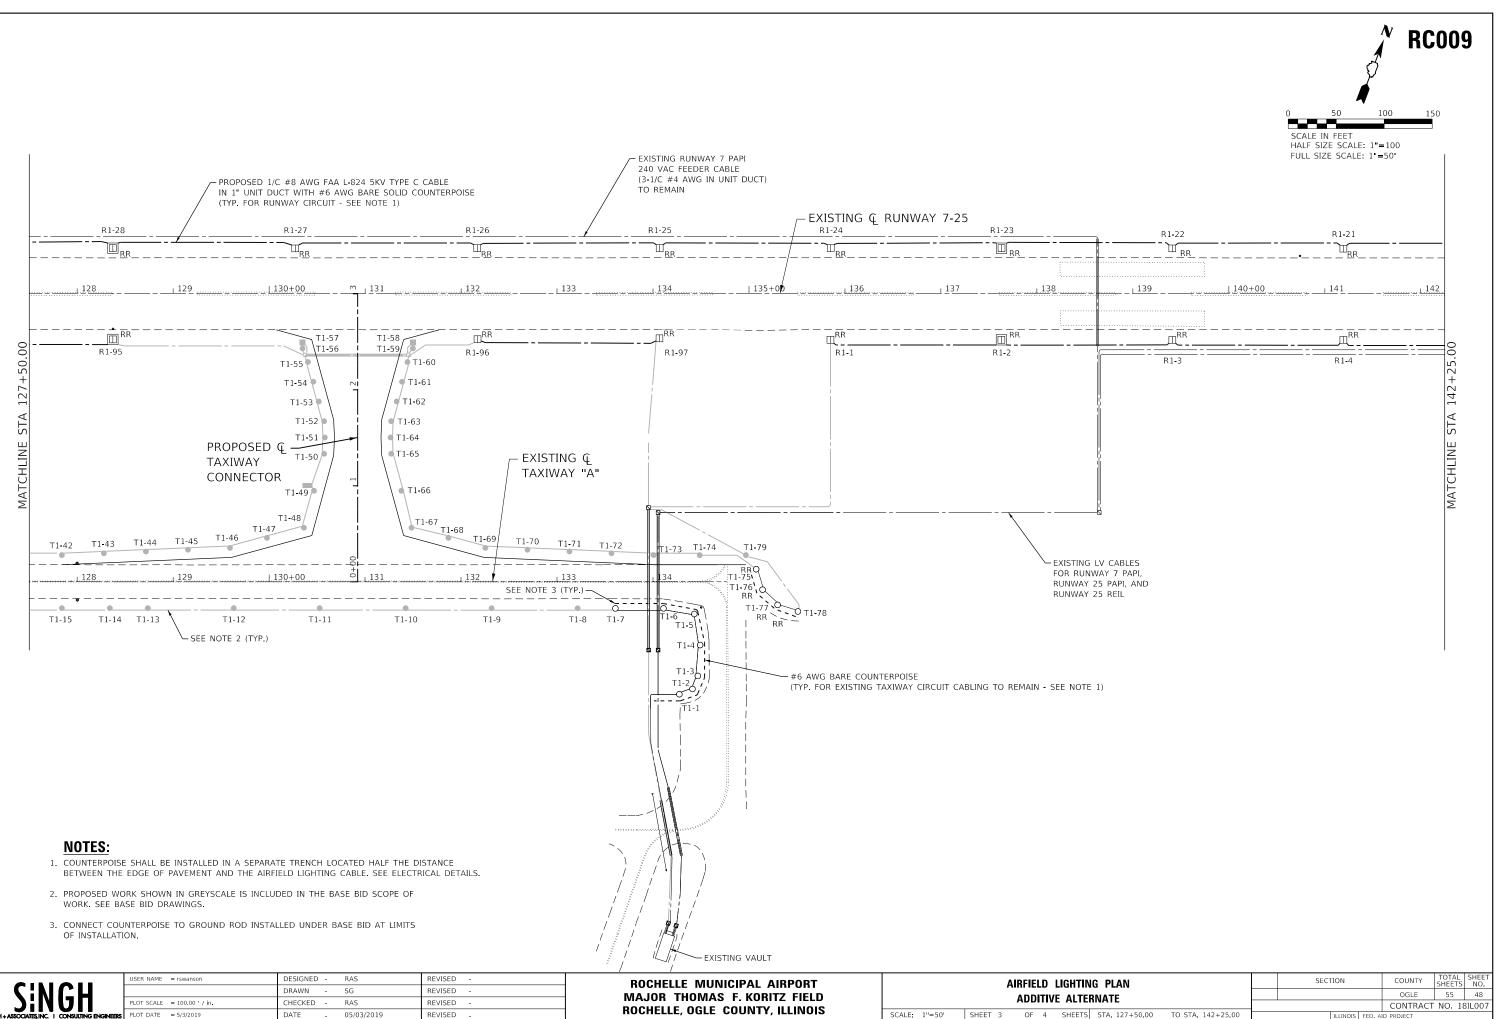


		USER NAME = rswanson	DESIGNED -	RAS	REVISED -	ROCHELLE MUNICIPAL AIRPORT		Δ	IRFIELD	LIGHTIN	IG PLAN
			DRAWN -	SG	REVISED -	MAJOR THOMAS F. KORITZ FIELD					
		PLOT SCALE = 100.00 / in	CHECKED -	RAS	REVISED -				ADDITIV	E ALTER	INATE
NG ENK	GINEERS	PLOT DATE = 5/3/2019	DATE -	05/03/2019	REVISED -	ROCHELLE, OGLE COUNTY, ILLINOIS	SCALE: 1"=50'	SHEET 3	OF 4	SHEETS	STA. 127+

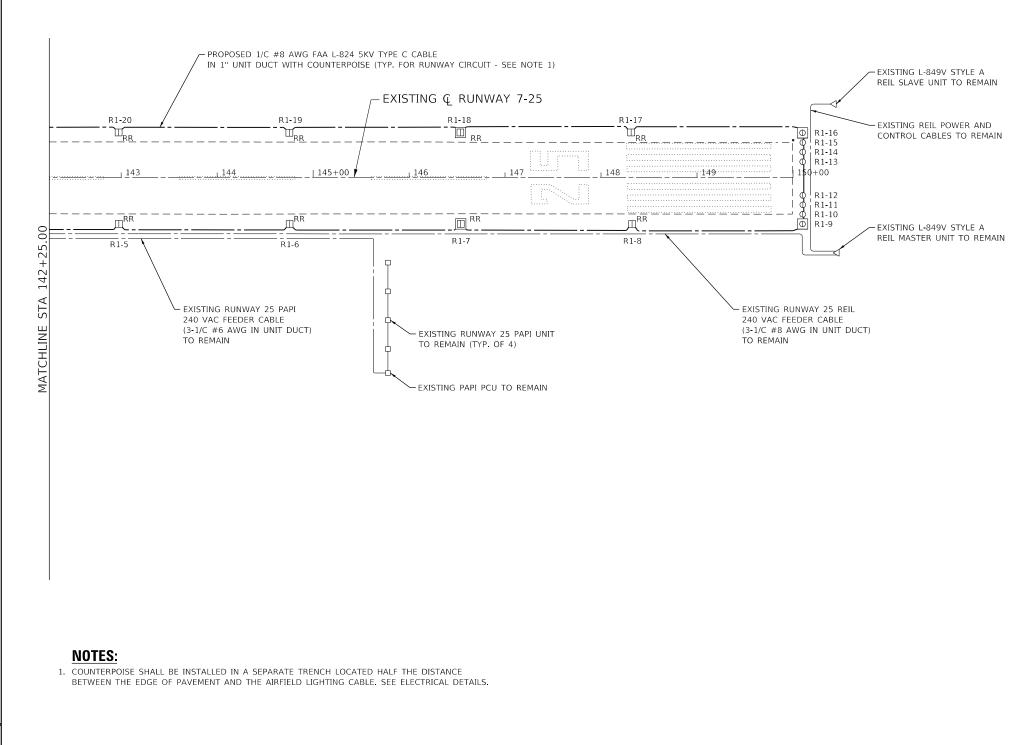

	USER NAME = rswanson	DESIGNED -	RAS	REVISED -	ROCHELLE MUNICIPAL AIRPORT	AIRFIELD LIGHTING PLAN	SECTION	COUNTY TOTAL SHEET SHEETS NO.
SINGH		DRAWN -	SG	REVISED -	MAJOR THOMAS F. KORITZ FIELD	ADDITIVE ALTERNATE		OGLE 55 49
JINDII	PLOT SCALE = 100.00 / in	CHECKED -	RAS	REVISED -	ROCHELLE, OGLE COUNTY, ILLINOIS			CONTRACT NO. 18IL007
SINGH + ASSOCIATES, INC.   CONSULTING ENGINEERS	PLOT DATE = 5/3/2019	DATE -	05/03/2019	REVISED -	RUCHELLE, UGLE CUUNTY, ILLINUIS	SCALE: 1"=50' SHEET 4 OF 4 SHEETS STA. 142+25.00 TO STA. 150+00.00	ILLINOIS FED. A	AID PROJECT

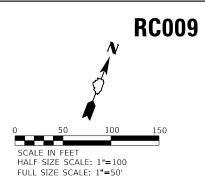


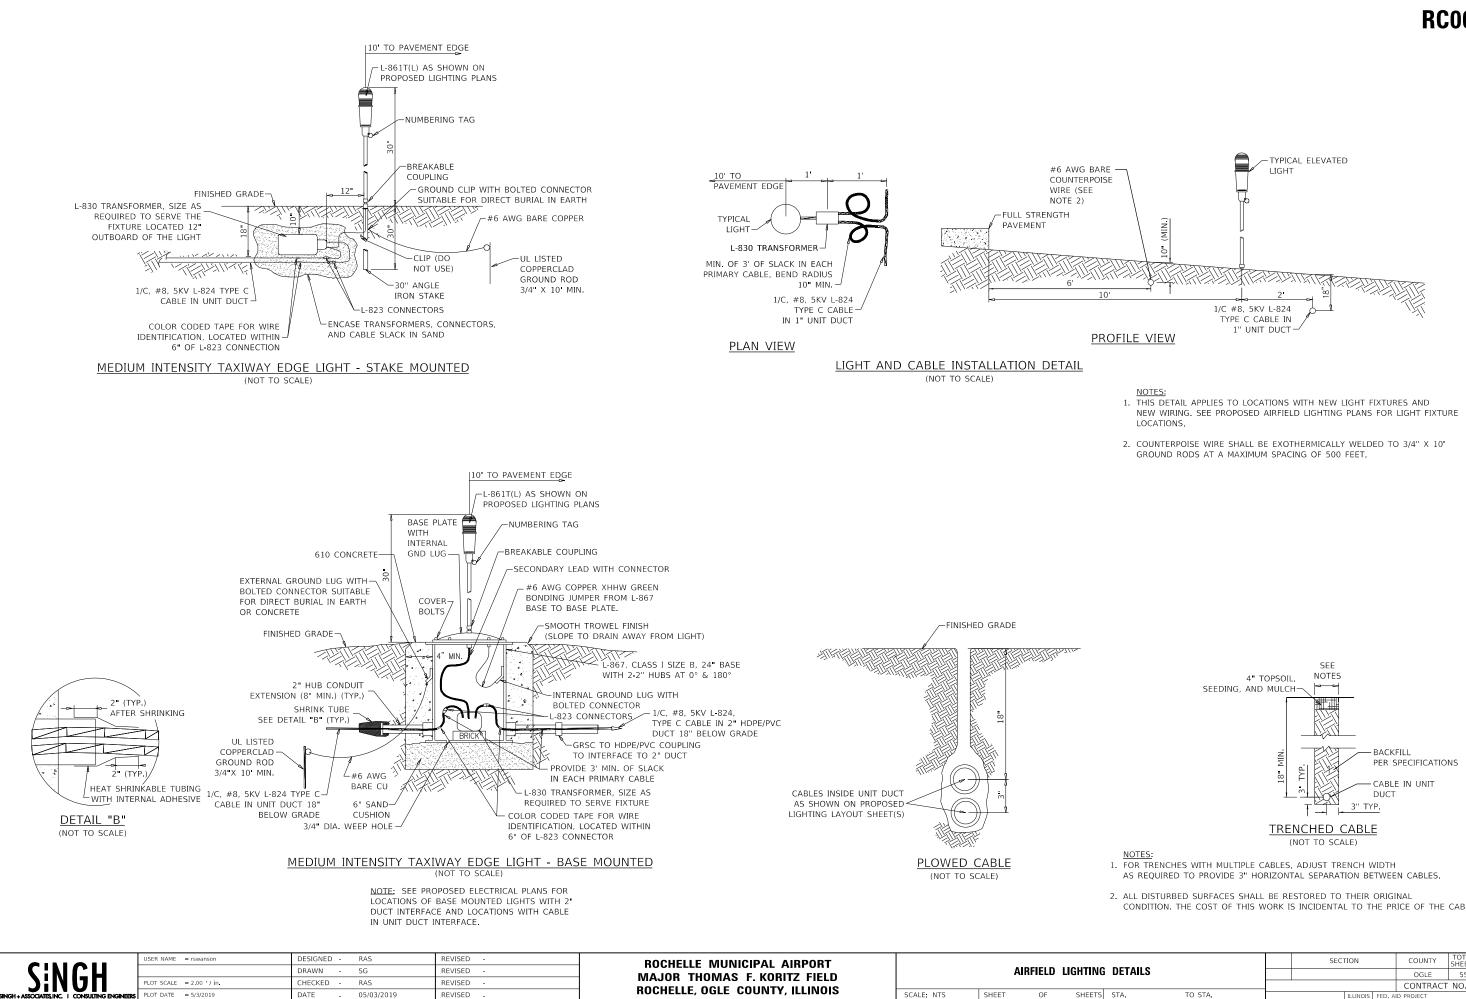


### **RC009**

- CONDITION. THE COST OF THIS WORK IS INCIDENTAL TO THE PRICE OF THE CABLE.

		SECT	ΠΟΝ		COUNTY	TOTAL SHEETS	SHEET NO.	
NG	NG DETAILS					OGLE	55	50
						CONTRACT	NO. 18	BILOO7
TS	STA.	TO STA.		ILLINOIS	FED. AI	ID PROJECT		

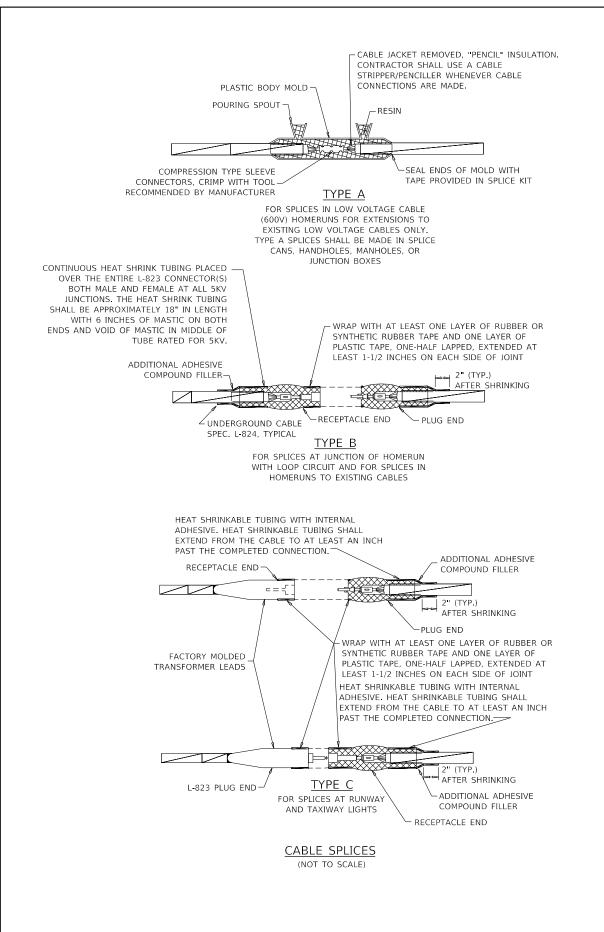

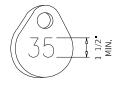


	USER NAME = rswanson	DESIGNED - RAS	REVISED -	ROCHELLE MUNICIPAL AIRPORT		SECTION COUNTY TOTAL SHEET
SINGH		DRAWN - SG	REVISED -	MAJOR THOMAS F. KORITZ FIELD	AIRFIELD LIGHTING DETAILS	OGLE 55 51
JINDII	PLOT SCALE = 2.00 / in	CHECKED - RAS	REVISED -	ROCHELLE, OGLE COUNTY, ILLINOIS		CONTRACT NO. 18IL007
SINGH + ASSOCIATES, INC.   CONSULTING ENGINEERS	PLOT DATE = 5/3/2019	DATE - 05/03/2019	REVISED -	RUCHELLE, UGLE COUNTY, ILLINUIS	SCALE: NTS SHEET OF SHEETS STA. TO STA.	ILLINOIS FED. AID PROJECT

## **RC009**


NOTE: AFFIX NON-CORROSIVE TAG TO FIXTURE FACING RUNWAY/TAXIWAY WITH SET SCREW, WIRE TIE, OR METAL BAND. NUMERALS SHALL BE ENGRAVED FOR PERMANENT READIBILITY

LIGHT FIXTURE NUMBERING TAG DETAIL

(NOT TO SCALE)

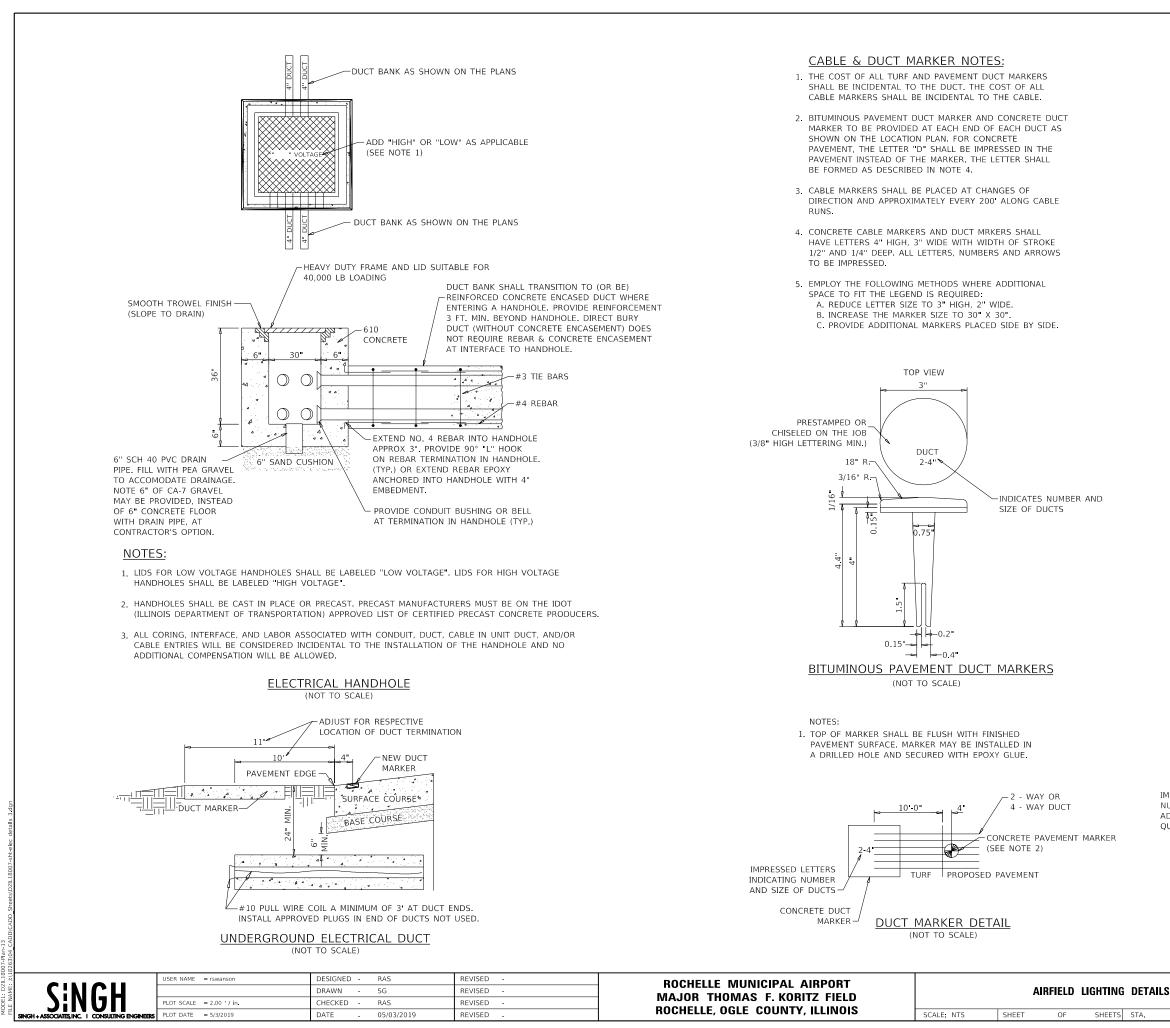



## RC009

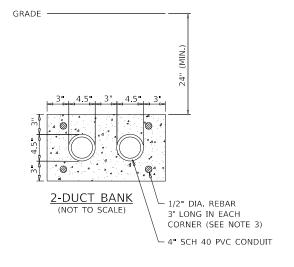

### DUCT BANK NOTES:

- 1. DIMENSIONS SHOWN FOR CONCRETE COVERAGE AND SEPARATION BETWEEN DUCTS ARE MINIMUM.
- 2. PROVIDE POLYSTYRENE DUCT SPACERS TO MAINTAIN PROPER SEPARATION OF CONDUITS. SPACER PLACEMENT INTERVAL SHALL BE AS RECOMMENDED BY THE MANUFACTURER.
- 3. REBAR IS REQUIRED TO ACCOMODATE FUTURE DUCT EXTENSIONS AND INTERFACE AT DUCT BANK TERMINATIONS. CONCRETE ENCASED DUCT BANKS TERMINATING IN HANDHOLES REQUIRE REBAR AT TERMINATIONS.
- 4. HIGH VOLTAGE AND LOW VOLTAGE CIRCUITS SHALL NOT BE INSTALLED IN THE SAME RACEWAY, CONDUIT, DUCT, HANDHOLE, OR MANHOLE.
- 5. HOMERUN CABLES FOR A RESPECTIVE CIRCUIT SHALL BE INSTALLED IN THE SAME RACEWAY OR DUCT.
- 6. DUCT INTERFACE TO HANDHOLES OR MANHOLES WILL BE CONSIDERED INCIDENTAL TO THE RESPECTIVE DUCT PAY ITEM.

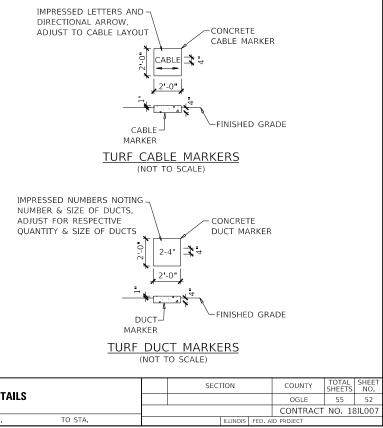

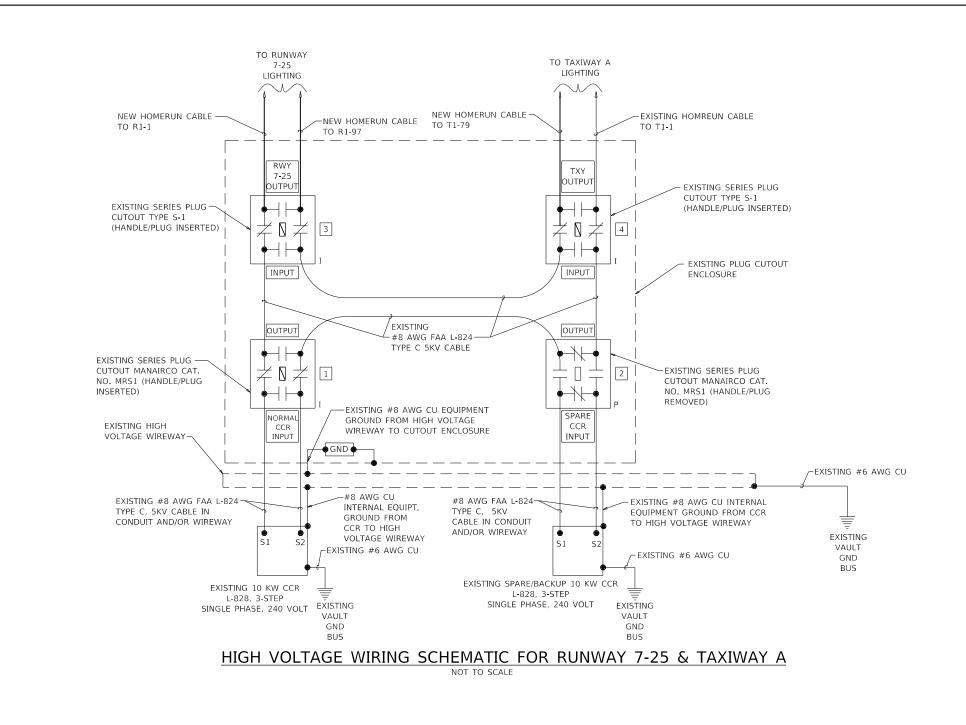


NOTES: 1. ALL CABLING AND EQUIPMENT IS EXISTING UNLESS NOTED OTHERWISE.

<u>LEGEND</u>


- DENOTES PLUG CUTOUT WITH PLUG INSERTED
- "I" DENOTES PLUG CUTOUT WITH PLUG INSERTED "P" DENOTES PLUG CUTOUT WITH PLUG PULLED

SINGH	USER NAME = rswanson	DESIGNED - RAS	REVISED -	NISED - ROCHELLE MUNICIPAL AIRPORT						SECTION	COUNTY	TOTAL SHEET
		DRAWN - SG	REVISED -	MAJOR THOMAS F. KORITZ FIELD	AIRFIELD LIGHTING VAULT WIRING DETAILS					OGLE	55 53	
JINUI	PLOT SCALE = 2.00 / in	CHECKED - RAS	REVISED -	ROCHELLE, OGLE COUNTY, ILLINOIS							CONTRAC	T NO 18IL007
SINGH + ASSOCIATES, INC.   CONSULTING ENGINEERS	PLOT DATE = 5/3/2019	DATE - 05/03/2019	REVISED -		SCALE: NTS	SHEET	OF	SHEETS STA.	TO STA.	ILLINOIS FED.	AID PROJECT	

# **RC009**

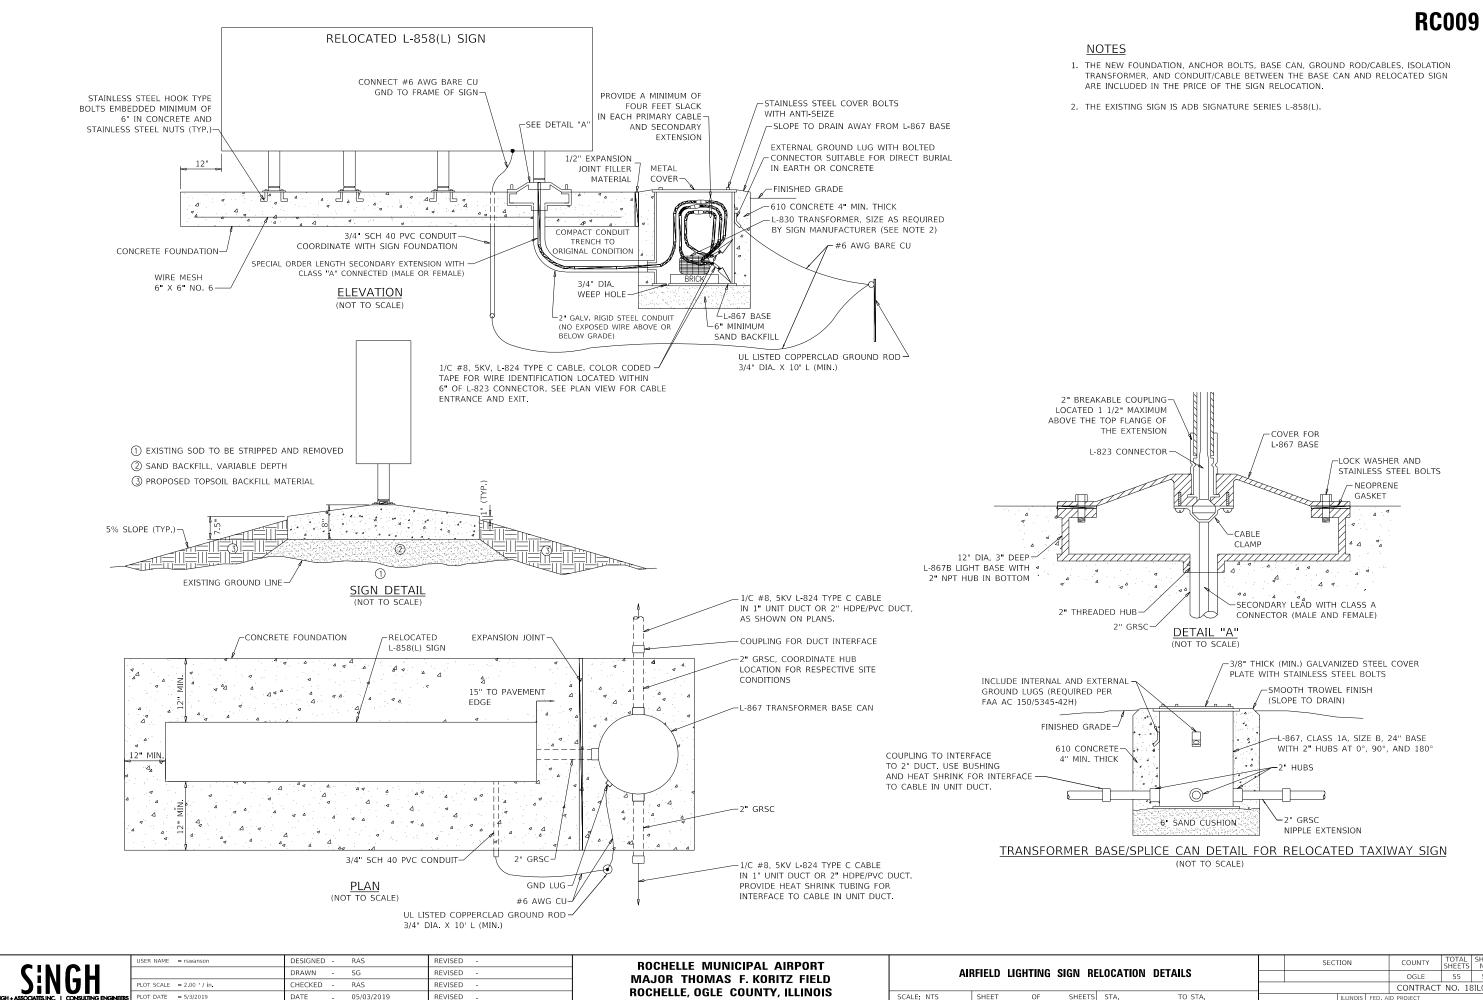

					UGLE	55	54
					CONTRACT	NO. 1	8IL007
ΤS	STA. TO STA.		ILLINOIS	FED. A	ID PROJECT		

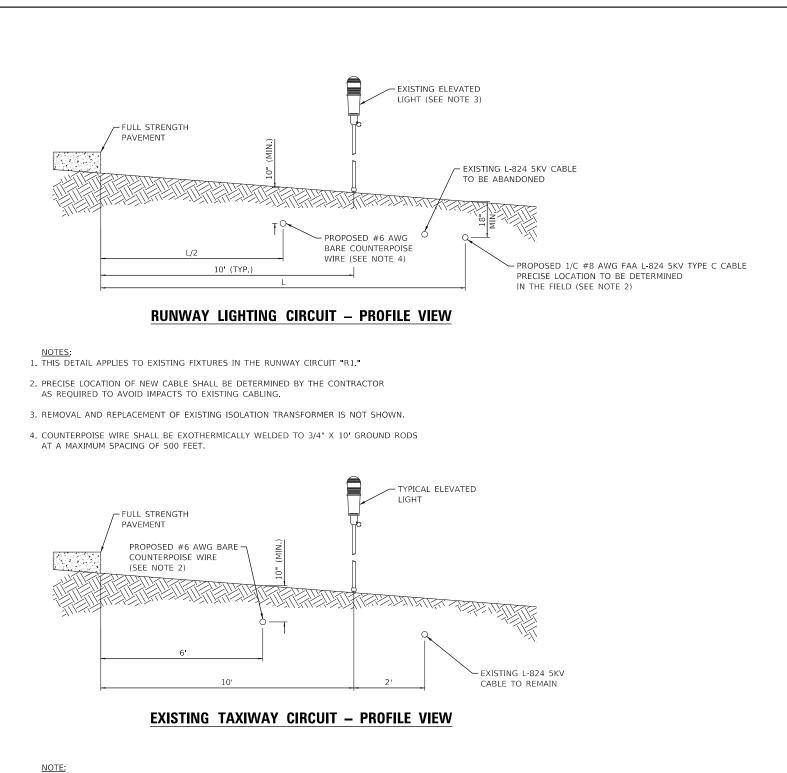

1. THIS DETAIL APPLIES TO EXISTING FIXTURES IN THE TAXIWAY CIRCUIT "T1."

2. COUNTERPOISE WIRE SHALL BE EXOTHERMICALLY WELDED TO 3/4" X 10' GROUND RODS AT A MAXIMUM SPACING OF 500 FEET.



# RC009

NG	NG DETAILS			SEC	ΓΙΟΝ		COUNTY	TOTAL SHEETS	
TER	TERNATE						OGLE	55	55
							CONTRACT	NO. 18	BILOO7
TS	TS STA. TO STA.				ILLINOIS	FED. AI	D PROJECT		