

SCALES:
1" = 20' HOR
1" = 2' VER

60605000
COMBINATION CONCRETE CURB AND GUTTER, TYP. B-6.24

LT STA. 5+49 TO STA. 7+85	241.5 FOOT
RT STA. 5+91 TO STA. 6+68	86.7 FOOT
RT STA. 6+84 TO STA. 7+56	78.0 FOOT
RT STA. 8+08 TO STA. 9+35	131.6 FOOT
LT STA. 8+23 TO STA. 9+35	112.6 FOOT
RT STA. 9+53 TO STA. 10+06	53.0 FOOT
LT STA. 9+59 TO STA. 10+58	100.6 FOOT
RT STA. 10+24 TO STA. 10+50	26.8 FOOT
RT STA. 10+67 TO STA. 11+00	20.3 FOOT
LT STA. 10+68 TO STA. 11+00	24.1 FOOT
SHEET TOTAL = 875.2 FOOT	

60255700
MANHOLES TO BE ADJUSTED WITH NEW TYPE 1 FRAME, CLOSED LID

1.4 LT STA. 5+73.5	1 EACH
8.4 LT STA. 8+31.7	1 EACH
SHEET TOTAL = 2 EACH	

44000200
DRIVEWAY PAVEMENT REMOVAL

RT STA. 7+84.25	26.9 SQ. YD.
LT STA. 8+02.24	11.3 SQ. YD.
LT STA. 9+43.97	5.6 SQ. YD.
RT STA. 9+48.85	12.3 SQ. YD.
LT STA. 10+14.39	5.3 SQ. YD.
LT STA. 10+58.83	5.4 SQ. YD.
RT STA. 10+68.85	13.5 SQ. YD.
SHEET TOTAL = 80.4 SQ. YD.	

60261100
INLETS TO BE ADJUSTED WITH NEW TYPE 9 FRAME AND GRATE

20.9 LT STA. 5+66.7	1 EACH
TOTAL = 1 EACH	

44000600
SIDEWALK REMOVAL

LT STA. 5+56.0 TO STA. 5+92.0	188.34 SQ. FT.
RT STA. 6+98.6 TO STA. 7+11.0	27.67 SQ. FT.
LT STA. 7+12.5 TO STA. 7+72.3	163.42 SQ. FT.
LT STA. 7+76.8 TO STA. 7+85.1	17.98 SQ. FT.
SHEET TOTAL = 397.4 SQ. FT.	

42300300
PORTLAND CEMENT CONCRETE DRIVEWAY PAVEMENT, 7 INCH


RT STA. 7+84.25	41.1 SQ. YD.
LT STA. 8+02.24	20.6 SQ. YD.
LT STA. 9+43.97	8.6 SQ. YD.
RT STA. 9+48.85	16.7 SQ. YD.
LT STA. 10+14.39	8.6 SQ. YD.
LT STA. 10+58.83	8.9 SQ. YD.
RT STA. 10+68.85	18.7 SQ. YD.
SHEET TOTAL = 123.3 SQ. YD.	

60260500
INLETS TO BE ADJUSTED WITH NEW TYPE 3 FRAME AND GRATE

16.7 RT STA. 5+93	1 EACH
43.6 RT STA. 6+87.7	1 EACH
SHEET TOTAL = 2 EACH	

42400100
PORTLAND CEMENT CONCRETE SIDEWALK 4 INCH


LT STA. 5+56.0 TO STA. 5+92.0	226.75 SQ. FT.
RT STA. 6+98.6 TO STA. 7+11.0	33.83 SQ. FT.
SHEET TOTAL = 260.6 SQ. FT.	

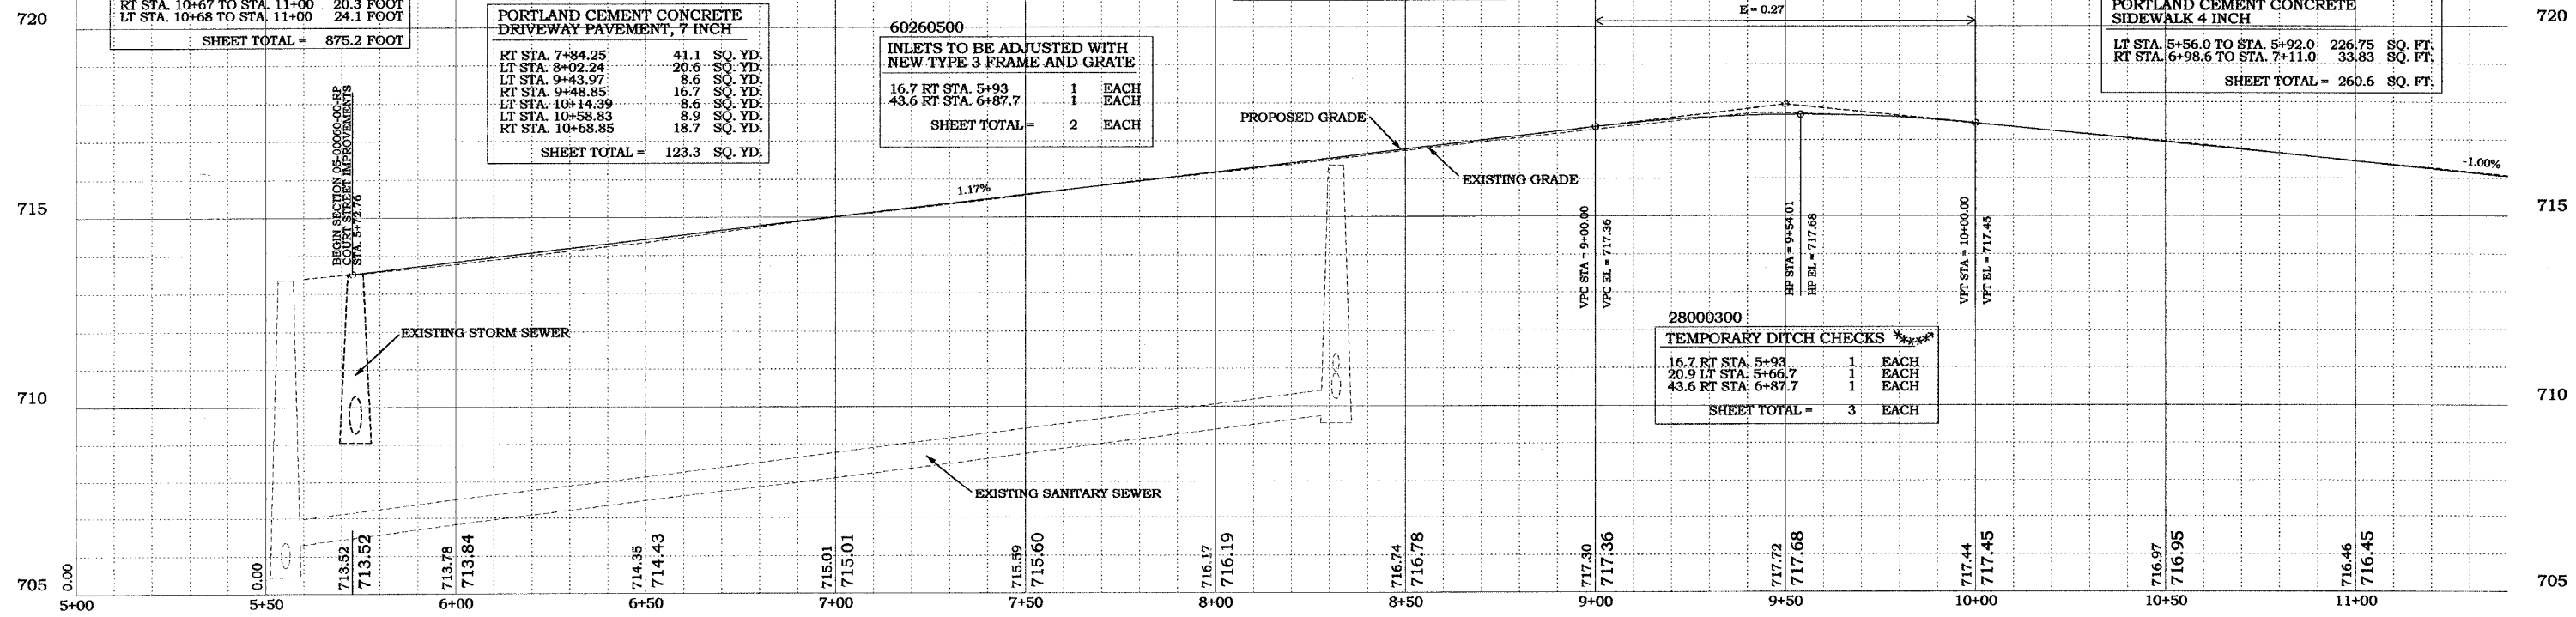

28000300
TEMPORARY DITCH CHECKS

16.7 RT STA. 5+93	1 EACH
20.9 LT STA. 5+66.7	1 EACH
43.6 RT STA. 6+87.7	1 EACH
SHEET TOTAL = 3 EACH	

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PROFESSIONAL DESIGN FIRM #184-001406

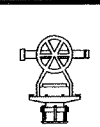

SCALES
PLAN: HOR. 1"=20'
VERT. 1"=2'

DRAWN	TJT
DATE	3/5/07
CHECKED	
DATE	
APPROVED	
DATE	
REVISED	
DATE	

FRANCIS ASSOC.
FILE NO.
P-356

PLAN AND PROFILE - COURT STREET
PLANS FOR PROPOSED IMPROVEMENTS TO EAST COURT STREET F.A.U. ROUTE 7562
CITY OF PARIS, ILLINOIS, EDGAR COUNTY

SHEET NO.
4
OF 26 SHEETS