


TREE REMOVAL		
STA.	OFFSET	SIZE
45+26 RT	39'	12"

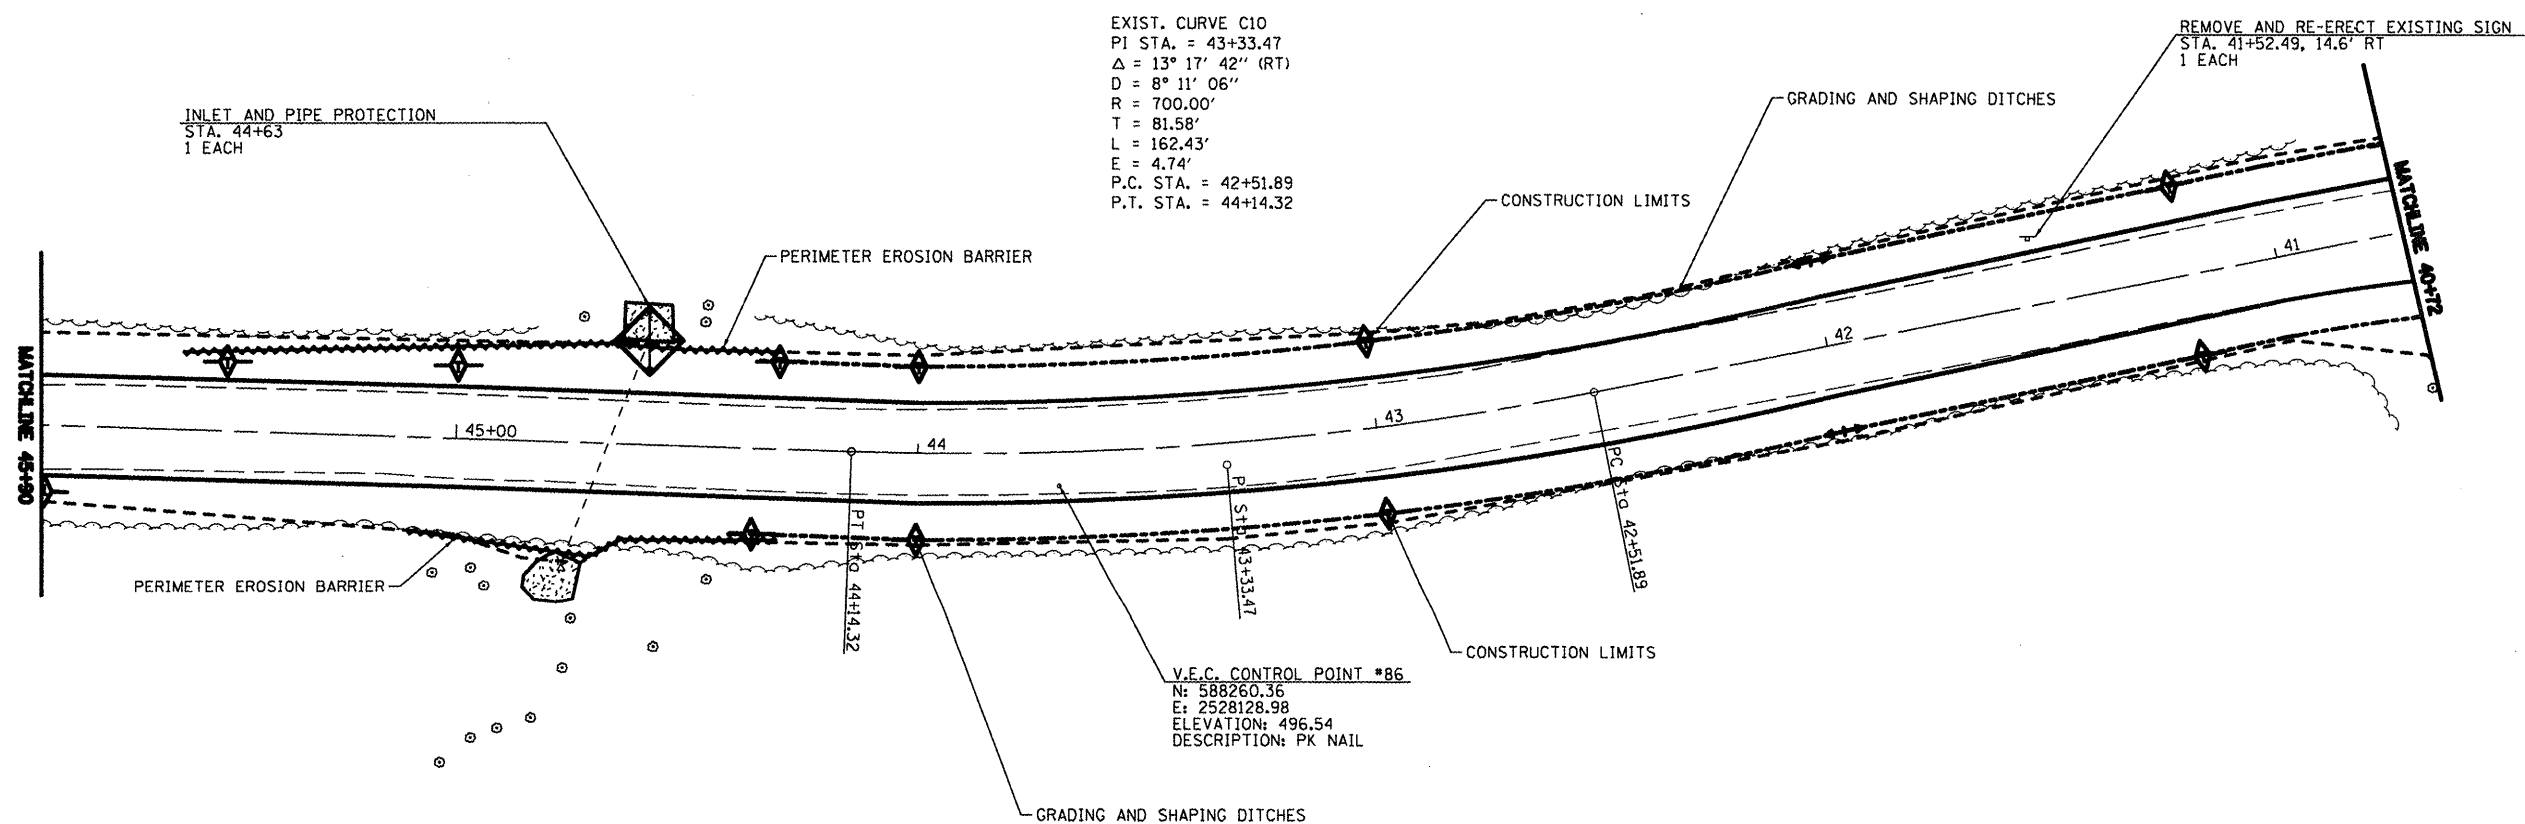

GRADING AND SHAPING DITCHES		
STA.	L.F.	
LT 40+72 - LT 44+40	368	
RT 40+72 - RT 44+35	363	

PERIMETER EROSION BARRIER		
STA.	L.F.	
RT 44+30 - RT 45+00	80	
LT 44+30 - LT 45+60	130	

- TEMPORARY DITCH CHECK
- INLET AND PIPE PROTECTION
- PROPOSED RIPRAP
- PERIMETER EROSION CONTROL

FILE NAME =	USER NAME = *USER*	DESIGNED - R.J.D.	REVISED -
*FILE#		DRAWN - J.T.T.	REVISED -
	PLOT SCALE = *SCALE*	CHECKED - R.J.D.	REVISED -
	PLOT DATE = *DATE*	DATE - 4/4/12	REVISED -

STATE OF ILLINOIS
DEPARTMENT OF TRANSPORTATION

WASHINGTON COUNTY CONSERVATOIN AREA
MAIN ALIGNMENT

SCALE: 1" = 20' SHEET NO. 23 OF 112 SHEETS STA. 40+72 TO STA. 45+90

F.A. RTE.	SECTION	COUNTY	TOTAL SHEETS	SHEET NO.
		WASHINGTON	112	23
CONTRACT NO. 48223			ILLINOIS PRD. AND PROJECT	

JOB NO. 200-081-R VASCONCELLOS ENGINEERING CORP. DESIGN FIRM REGISTRATION NUMBER 184-002107