


TREE REMOVAL		
STA.	OFFSET	SIZE
1000+62 RT	51'	16"
1000+79 RT	51'	16"
1000+89 RT	46'	16"

TEMPORARY DITCH CHECKS	
STA.	L.F.
LT 79+90	6

GRADING AND SHAPING DITCHES	
STA.	L.F.
LT 78+90 - LT 80+00	110

PERIMETER EROSION BARRIER	
STA.	L.F.
LT 77+00 - LT 78+60	160
RT 77+00 - RT 80+00	300
LT 79+90 - LT 80+50	60

EXIST. CURVE C21
 PI STA. = 78+59.55
 $\Delta = 60^\circ 06' 29''$ (RT)
 $D = 12^\circ 19' 18''$
 $R = 465.00'$
 $T = 269.05'$
 $L = 487.82'$
 $E = 72.23'$
 P.C. STA. = 75+90.50
 P.T. STA. = 80+78.32

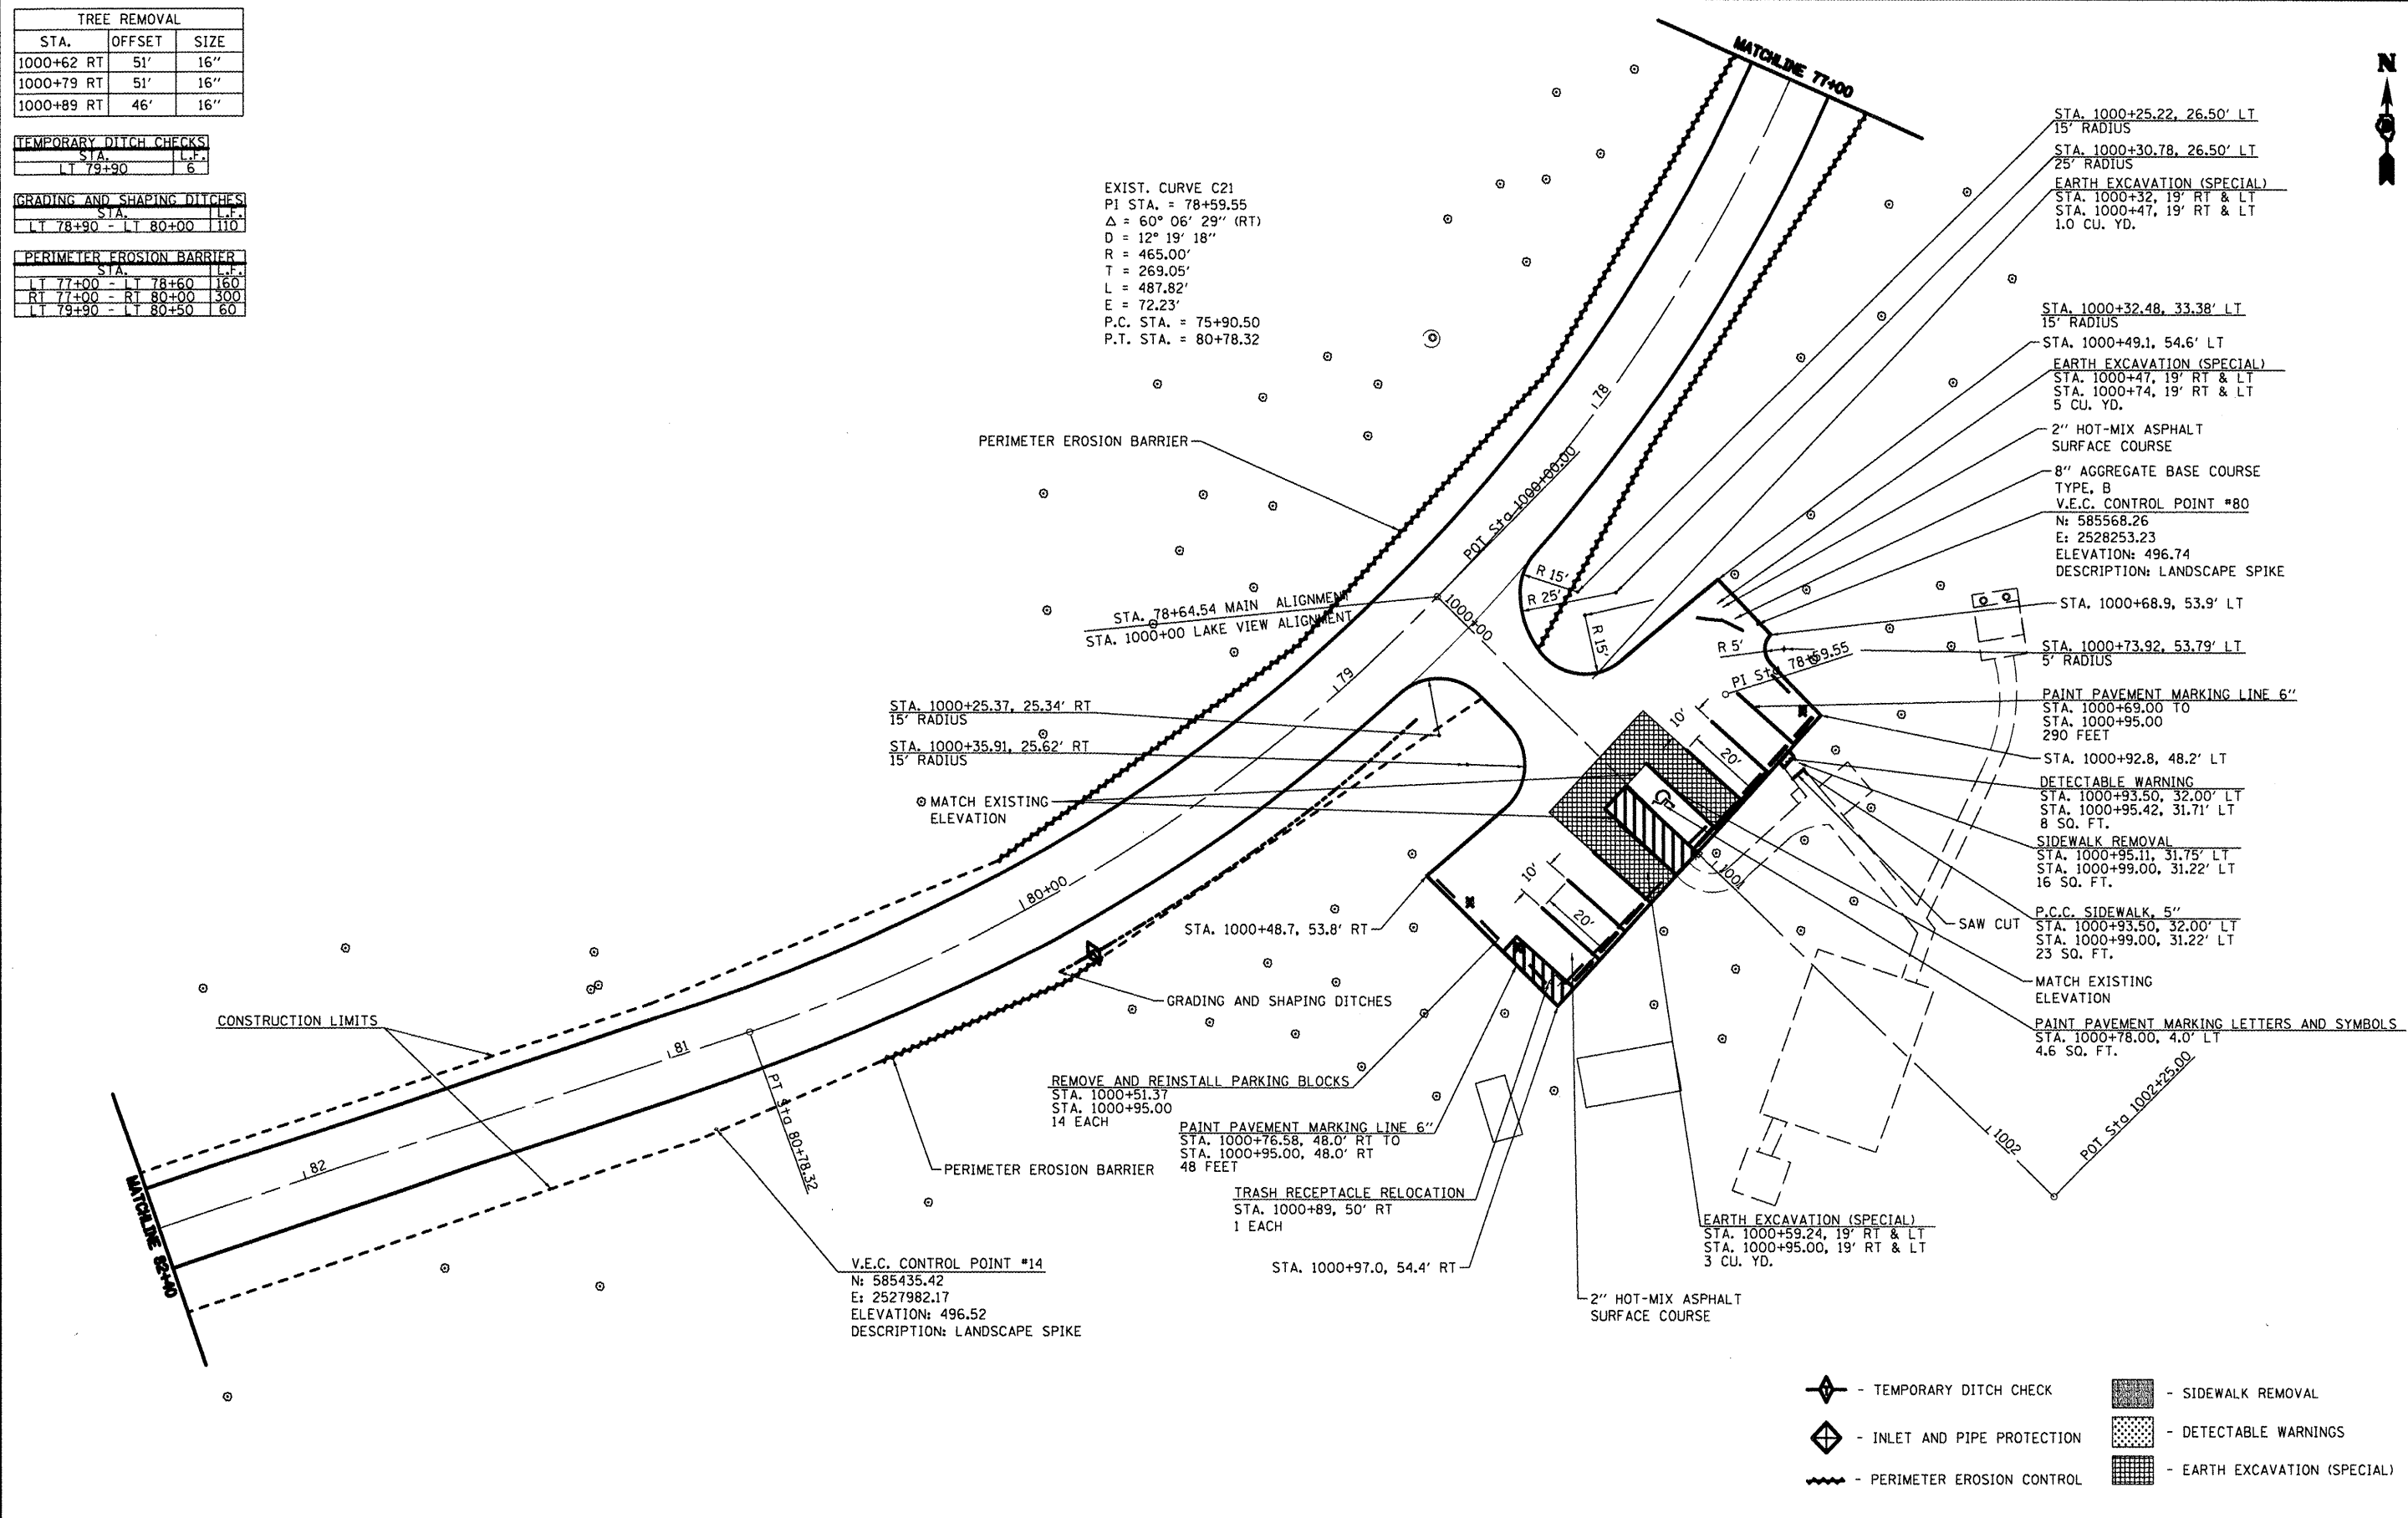

- TEMPORARY DITCH CHECK
- INLET AND PIPE PROTECTION
- PERIMETER EROSION CONTROL
- SIDEWALK REMOVAL
- DETECTABLE WARNINGS
- EARTH EXCAVATION (SPECIAL)

FILE NAME =	USER NAME = #USER*	DESIGNED - R.J.D.	REVISED -
FILE		DRAWN - J.T.T.	REVISED -
	PLOT SCALE = #SCALE*	CHECKED - R.J.D.	REVISED -
	PLOT DATE = #DATE*	DATE - 4/4/12	REVISED -

STATE OF ILLINOIS
DEPARTMENT OF TRANSPORTATION

WASHINGTON COUNTY CONSERVATION AREA
MAIN ALIGNMENT / LAKE VIEW ALIGNMENT

SCALE: 1" = 20' SHEET NO. 30 OF 112 SHEETS STA. 77+00 TO STA. 82+40

SECTION	COUNTY	TOTAL SHEETS	SHEET NO.
	WASHINGTON	112	30
CONTRACT NO. 46223			

ILLINOIS PBL. AND PROJECT

JOB NO. 260-061-4 VASCANSELLES ENGINEERING CORP. DESIGN FIRM REGISTRATION NUMBER 04-000207