


TREE REMOVAL		
STA.	OFFSET	SIZE
141+97 RT	15'	12"
141+99 RT	42'	12"
142+15 RT	44'	24"

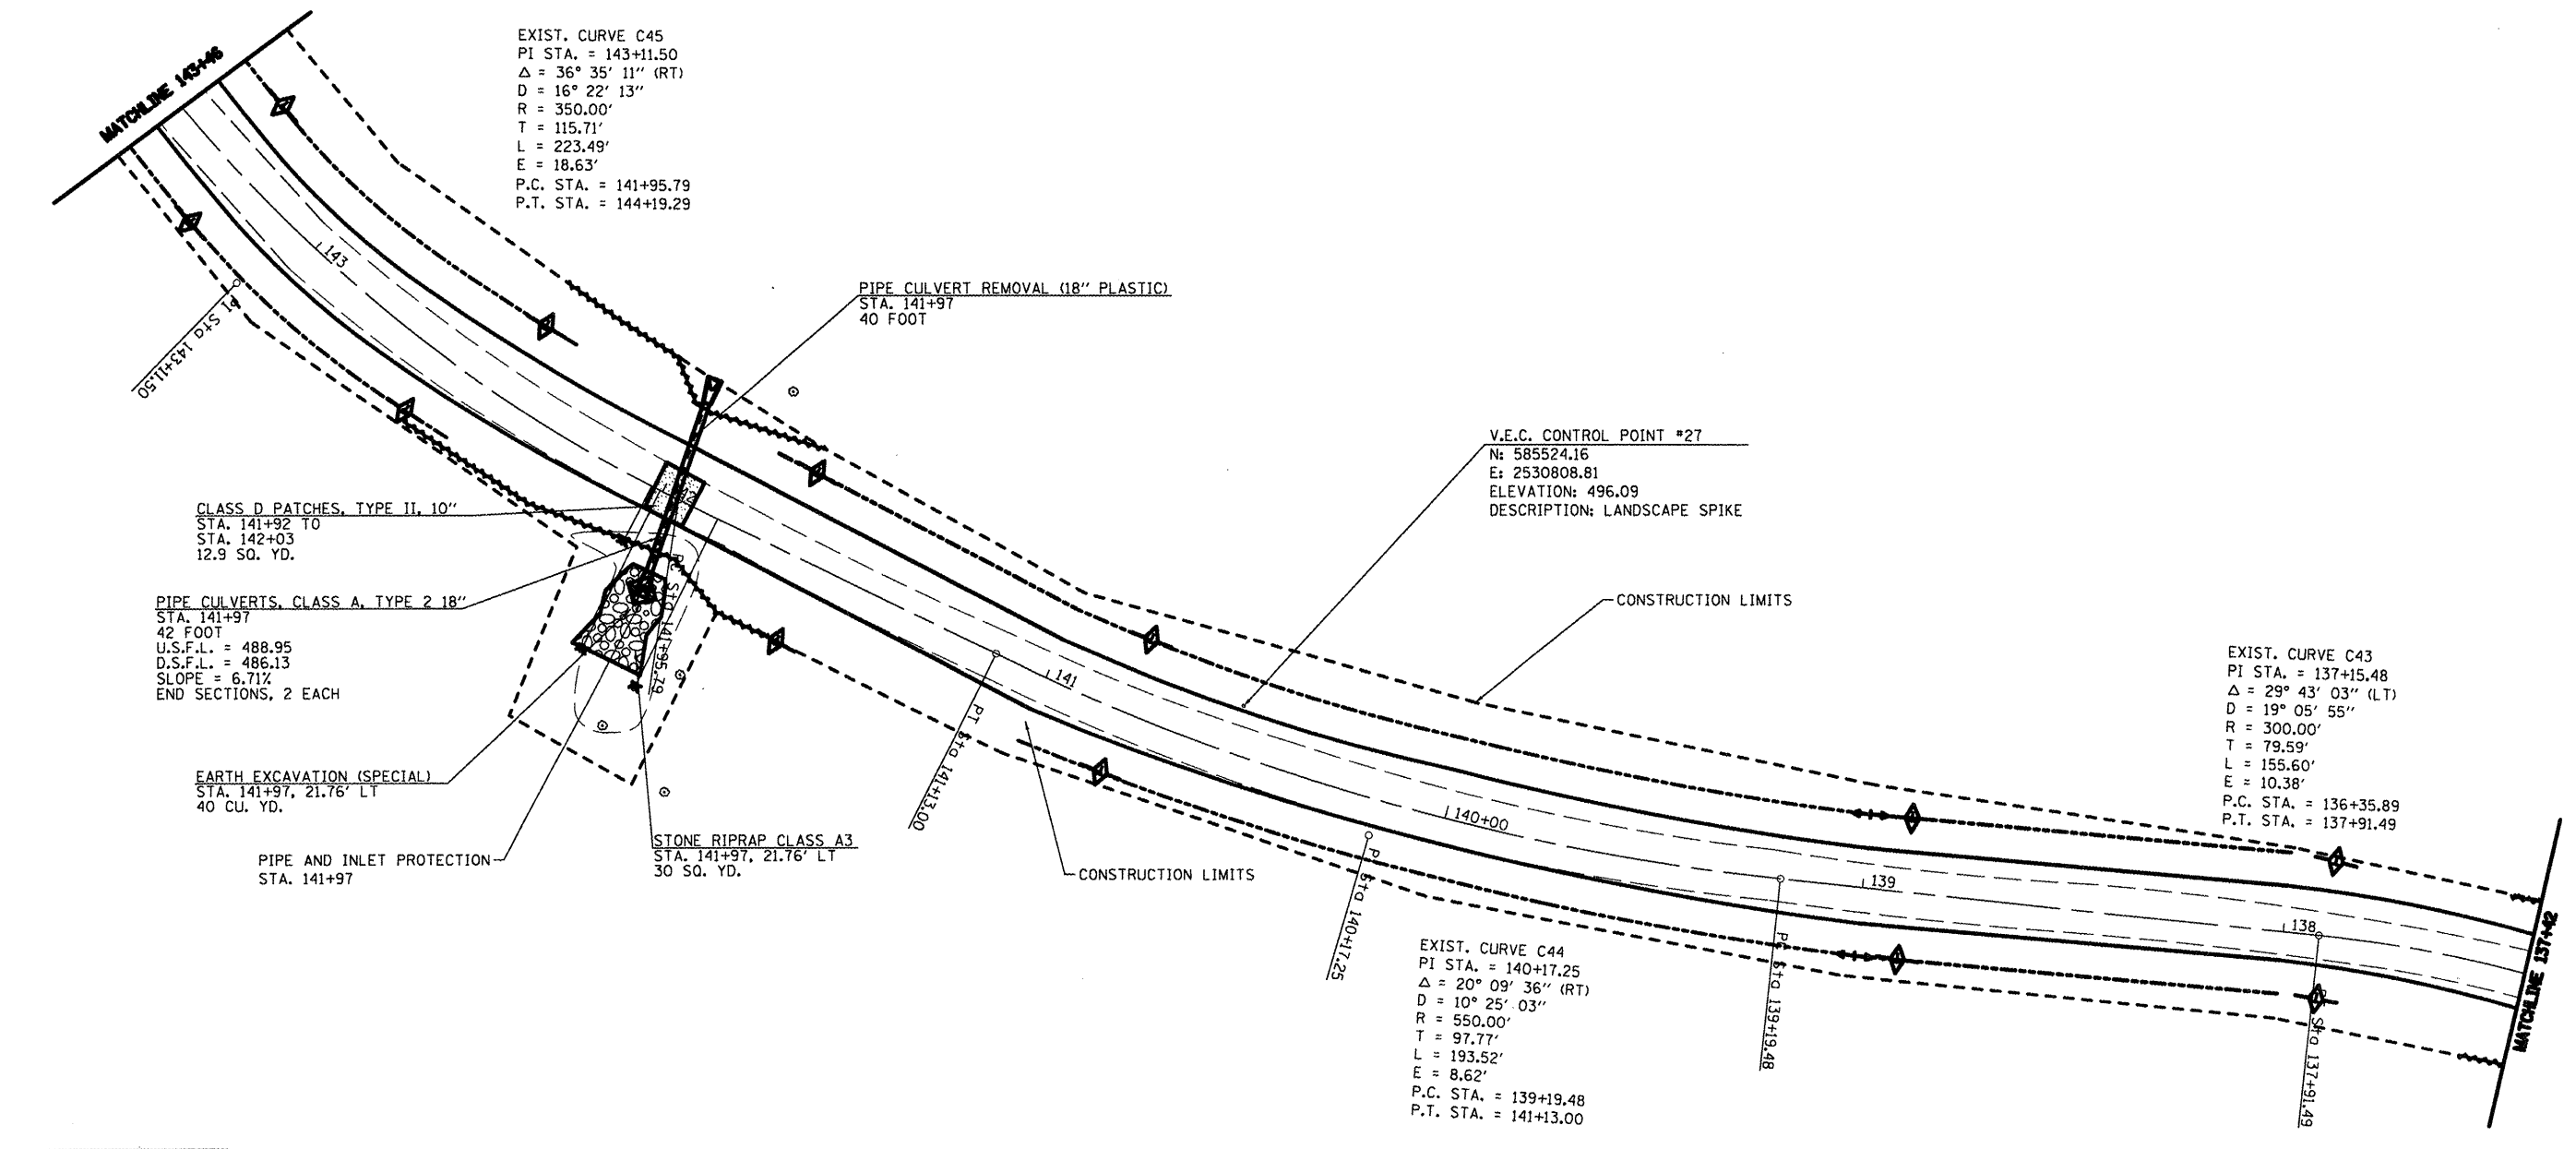

TEMPORARY DITCH CHECKS	
STA.	L.F.
LT 137+90	6
RT 137+90	6
LT 138+90	6
RT 138+90	6
LT 140+80	6
RT 140+80	6
LT 141+60	6
RT 141+60	6
LT 142+45	6
RT 142+45	6
LT 143+30	6
RT 143+30	6
LT 143+25	6

GRADING AND SHAPING DITCHES	
STA.	L.F.
LT 138+00 - LT 141+00	300
RT 138+00 - RT 141+80	380
LT 142+35 - RT 143+46	111
LT 142+50 - LT 143+46	96

PERIMETER EROSION BARRIER	
STA.	L.F.
LT 141+60 - LT 142+60	100
RT 141+70 - RT 142+45	75

- TEMPORARY DITCH CHECK
- INLET AND PIPE PROTECTION
- PERIMETER EROSION CONTROL
- PROPOSED RIPRAP
- PAVEMENT PATCHING

FILE NAME =	USER NAME = #USER#	DESIGNED - R.H.D.	REVISED -
#FILE#		DRAWN - J.T.T.	REVISED -
	PLOT SCALE = #SCALE#	CHECKED - R.H.D.	REVISED -
	PLOT DATE = #DATE#	DATE - 4/4/12	REVISED -

STATE OF ILLINOIS
DEPARTMENT OF TRANSPORTATION

WASHINGTON COUNTY CONSERVATION AREA
MAIN ALIGNMENT

SCALE: 1" = 20' SHEET NO. 40 OF 112 SHEETS STA. 137+42 TO STA. 143+46

ROUTE	SECTION	COUNTY	TOTAL SHEETS	SHEET NO.
		WASHINGTON	112	40
CONTRACT NO. 46223			ILLINOIS PBL. AND PROJECT	

JOB NO. 200-061-W VASCONCELLES ENGINEERING CORP. DESIGN FIRM REGISTRATION NUMBER 184-002507