





LEGEND




TEMPORARY PAVEMENT

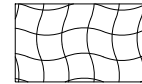

EROSION CONTROL BLANKET AND
TEMPORARY EROSION CONTROL SEEDING

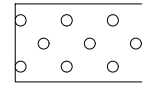

MULCH, METHOD 2 AND
TEMPORARY EROSION CONTROL SEEDING

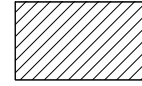

SEDIMENT BASIN
FOR DETAIL SEE SHEET 358



INLET FILTER AND 20 FEET PERIMETER EROSION
BARRIER PLACED AROUND OPEN GRATE STRUCTURE

15 FEET PERIMETER EROSION BARRIER PLACED
AROUND UPSTREAM FLARED END SECTION, BOTH
IN ACCORDANCE WITH STANDARD 280001-05



INLET FILTERS




TEMPORARY DITCH CHECKS




PERMANENT EARTH DITCH CHECKS
(PAID AS EARTH EXCAVATION)



RETAIN FROM PREVIOUS STAGE

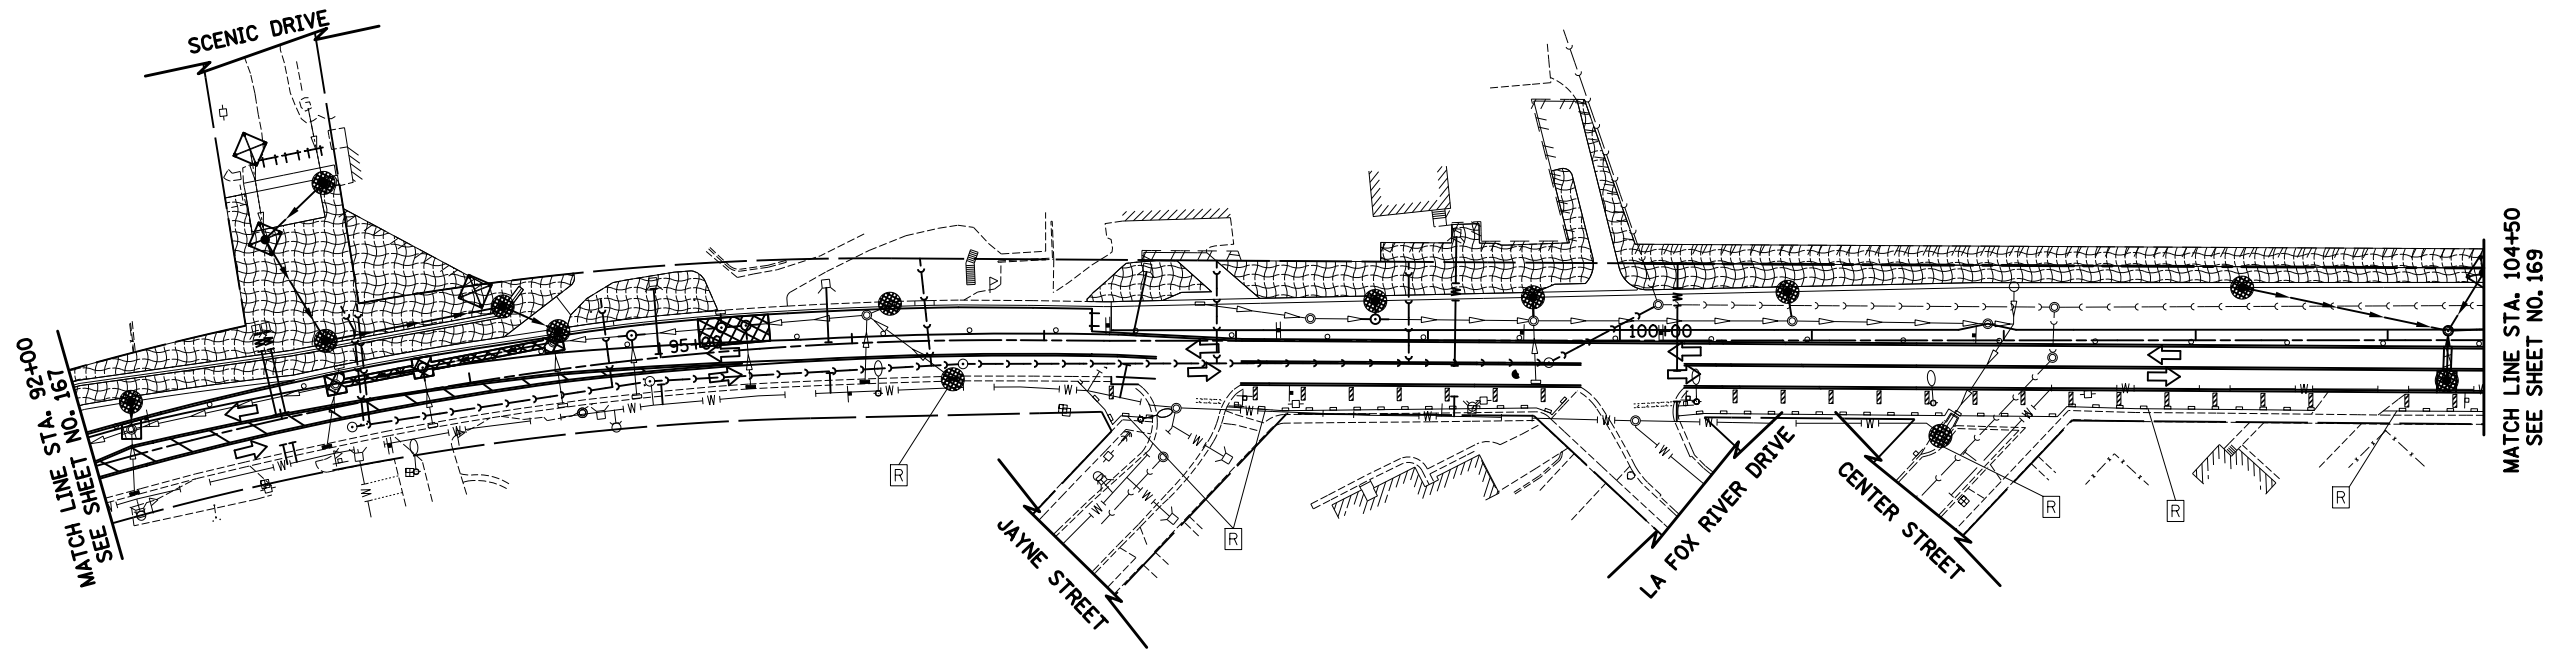

MATCH LINE STA. 104+50
SEE SHEET NO. 169

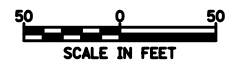

ILLINOIS ROUTE 31

FILE NAME = ...\\D160F72-sht-eros-20.dgn	USER NAME = ctb	DESIGNED - DTE	REVISED -
		DRAWN - DTE	REVISED -
	PLOT SCALE = 100.0000' / in.	CHECKED - GAB	REVISED -
	PLOT DATE = 5/2/2012	DATE - 5/3/2012	REVISED -

STATE OF ILLINOIS
DEPARTMENT OF TRANSPORTATION

EROSION AND SEDIMENT CONTROL - STAGE 3B & 3C

SCALE: 1" = 50' SHEET NO. 20 OF 28 SHEETS STA. 92+00 TO STA. 104+50

O.R. RTE.	SECTION	COUNTY	TOTAL SHEETS	SHEET NO.
0003	18A-2	MCHENRY	825	168
CONTRACT NO. 60F72				
FED. ROAD DIST. NO. 1 ILLINOIS FED. AID PROJECT				