

TEMPORARY PAVEMENT

EROSION CONTROL BLANKET AND TEMPORARY EROSION CONTROL SEEDING

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MULCH, METHOD 2 AND TEMPORARY EROSION CONTROL SEEDING

SEDIMENT BASIN FOR DETAIL SEE SHEET 358 INLET FILTER AND 20 FEET PERIMETER EROSION
BARRIER PLACED AROUND OPEN GRATE STRUCTURE

15 FEET PERIMETER EROSION BARRIER PLACED AROUND UPSTREAM FLARED END SECTION, BOTH IN ACCORDANCE WITH STANDARD 280001-05

INLET FILTERS

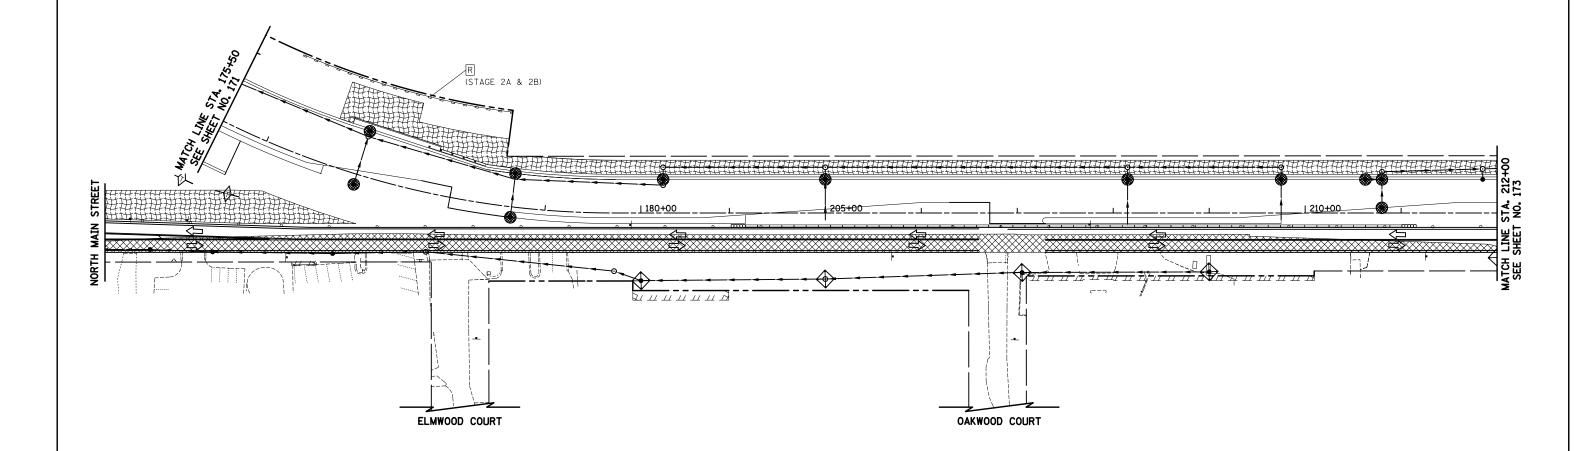
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TEMPORARY DITCH CHECKS

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PERMANENT EARTH DITCH CHECKS (PAID AS EARTH EXCAVATION)

RETAIN FROM PREVIOUS STAGE



NORTH MAIN STREET

				1401	II MAIN STILL		
FILE NAME =	USER NAME = ctb	DESIGNED - DTE	REVISED -			O.R. SECTION	COUNTY TOTAL SHEET
\D160F72-sht-eros-24.dgn		DRAWN - DTE	REVISED -	STATE OF ILLINOIS	EROSION AND SEDIMENT CONTROL – STAGE 4A	0003 18A-2	MCHENRY 825 172
	PLOT SCALE = 100.0000 '/ in.	CHECKED - GAB	REVISED -	DEPARTMENT OF TRANSPORTATION			CONTRACT NO. 60F72
	PLOT DATE = 5/2/2012	DATE - 5/3/2012	REVISED -		SCALE: 1" = 50' SHEET NO. 24 OF 28 SHEETS STA. 175+50 TO STA. 212+0	O EED BOAD DIST NO 1 ITH INDIS EED	ATD PROJECT