


NOTES:

1. THE LOCATION OF THE ELECTRICAL SERVICE INSTALLATION SHALL BE DETERMINED UPON RELOCATION OF THE EXISTING ELECTRICAL UTILITIES. PROPOSED LOCATIONS OF RELOCATED ELECTRICAL UTILITIES ARE NOT KNOWN AT THIS TIME.
2. QUANTITIES ESTIMATED FOR PROPOSED UTILITY SERVICE CONNECTION ARE:
200 FT. UNDERGROUND CONDUIT, 2 1/2" DIA.
210 FT. ELECTRIC CABLE IN CONDUIT, 600V (XLP-TYPE USE) 3-1/C NO. 3/0
3. THE EXISTING LIGHTING CONTROLLER SHALL REMAIN OPERATIONAL DURING CONSTRUCTION.
4. THE EXISTING LIGHTING CONTROLLER IS CURRENTLY UNDER McHENRY COUNTY DEPARTMENT OF TRANSPORTATION OWNERSHIP. THIS CONTROLLER WILL BE TRANSFERRED TO THE VILLAGE OF ALGONQUIN AFTER CONSTRUCTION.

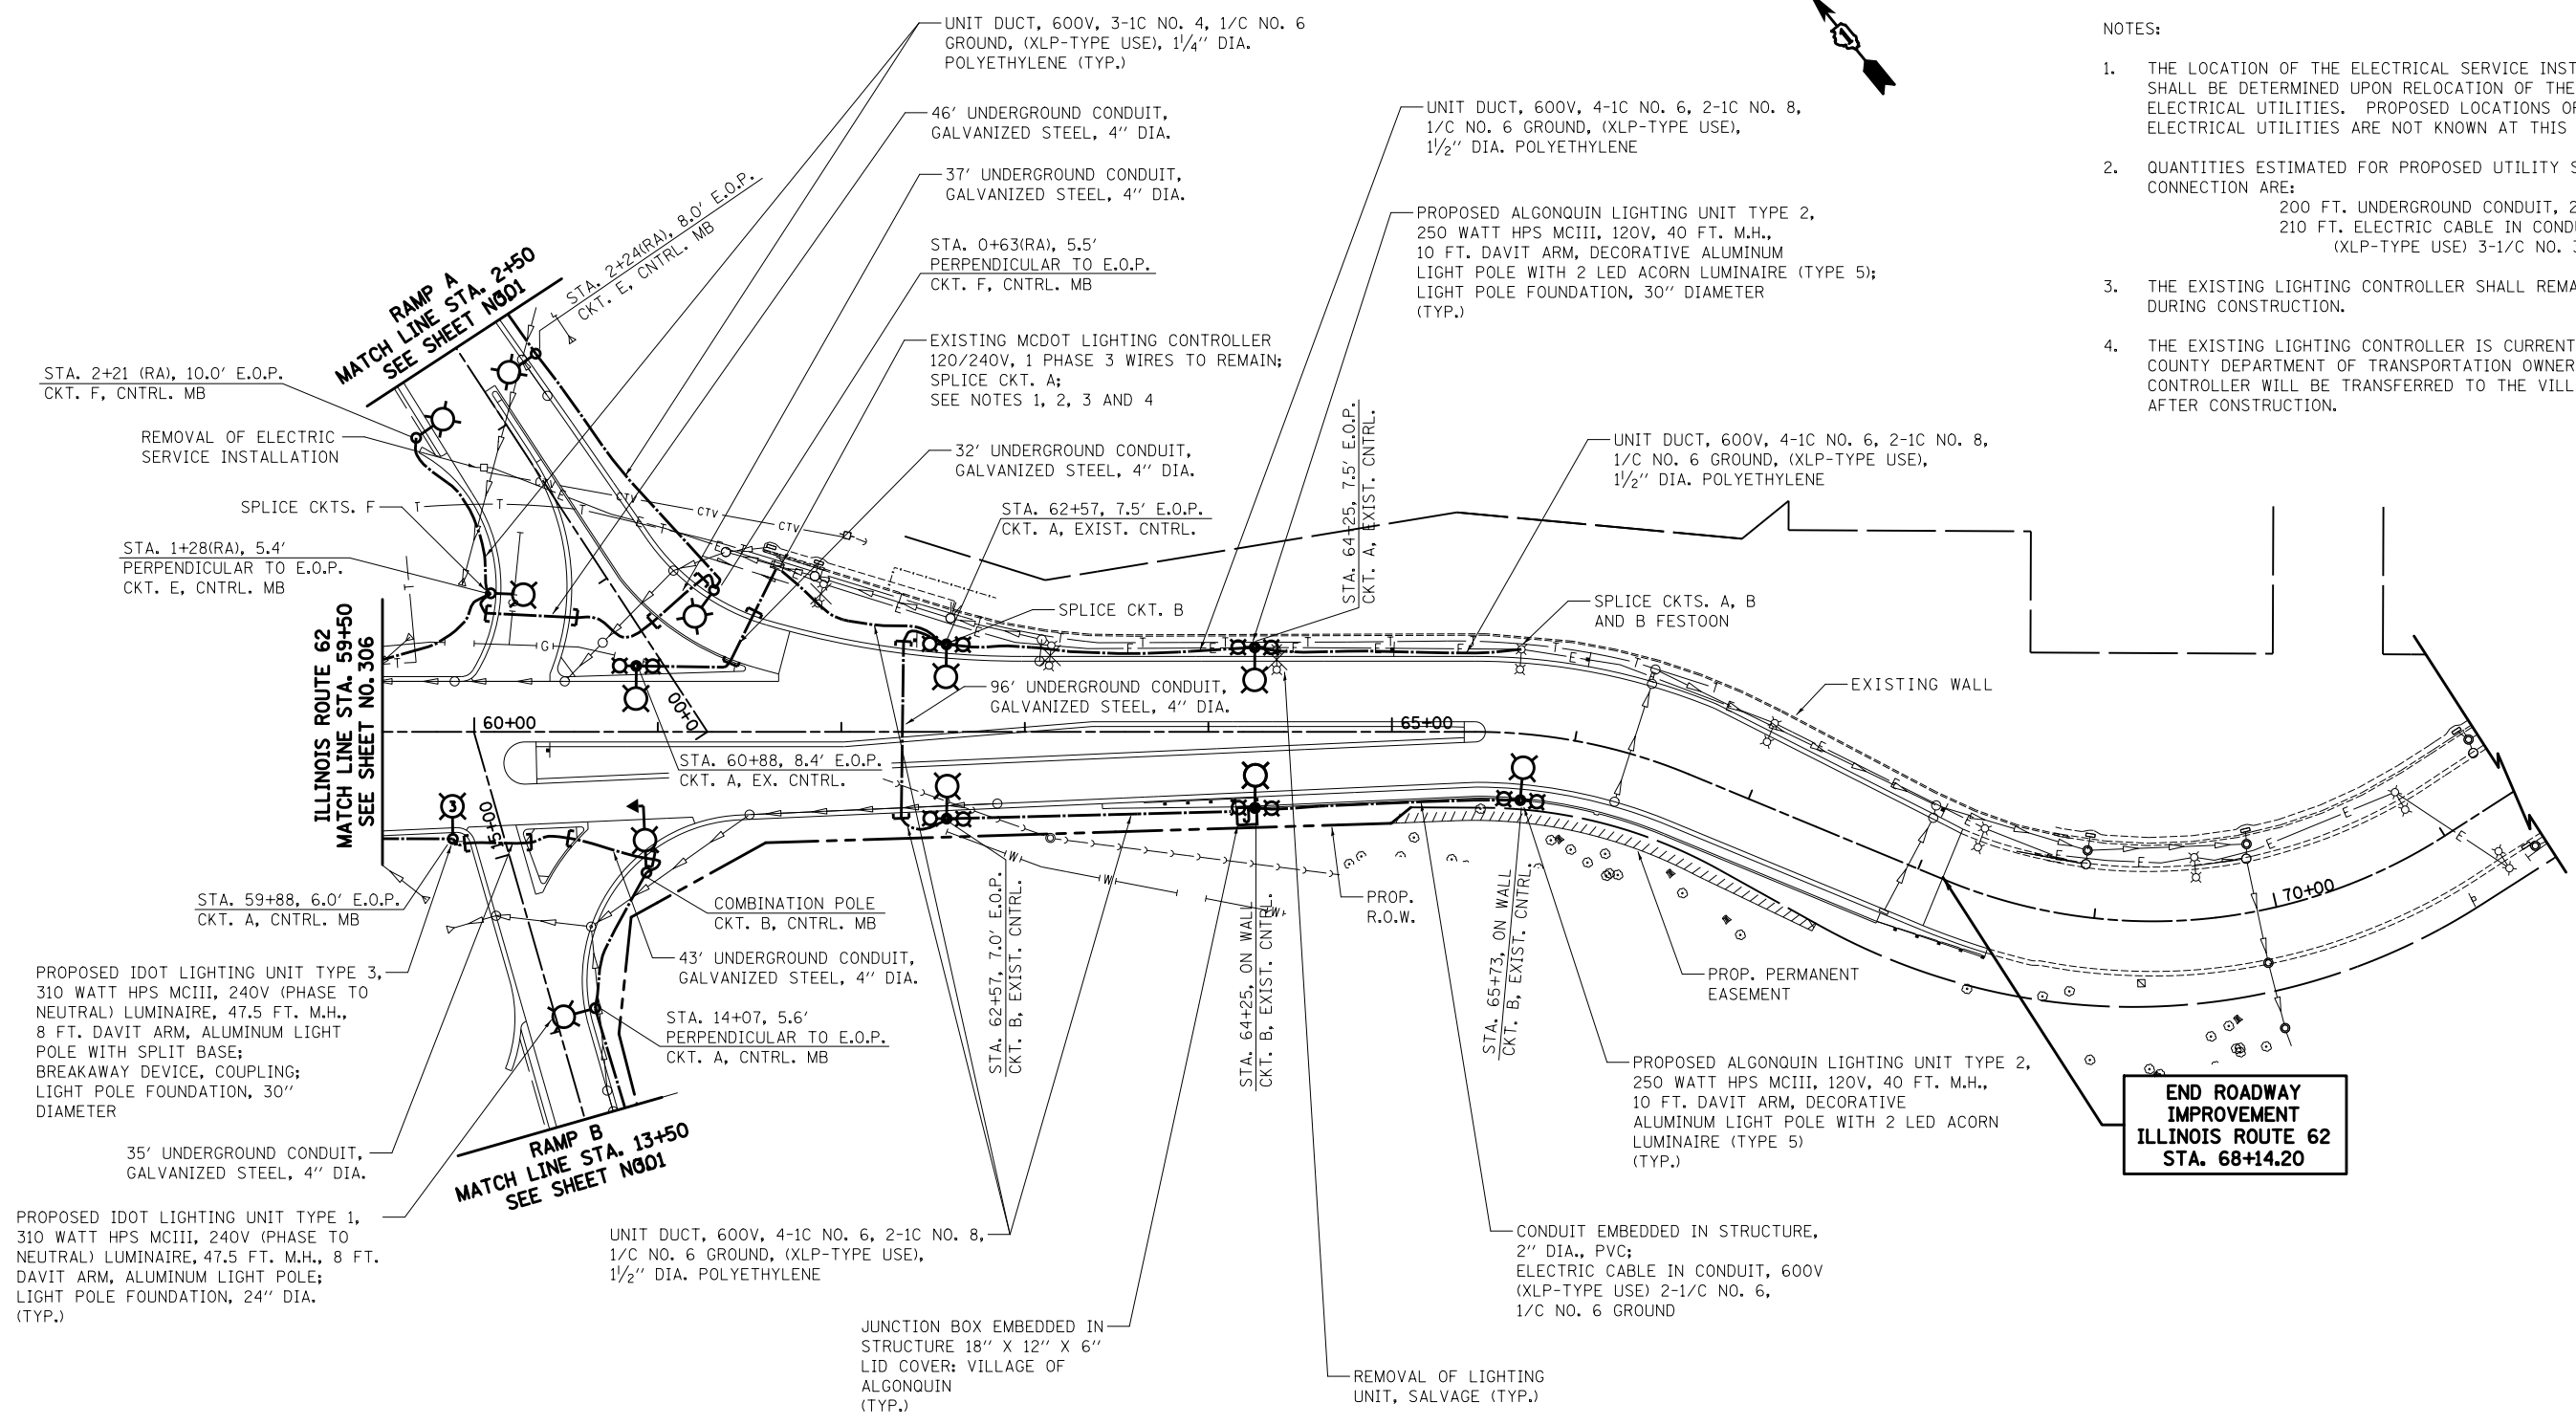

END ROADWAY IMPROVEMENT ILLINOIS ROUTE 62 STA. 68+14.20

**ILLINOIS ROUTE 62
RAMP A
RAMP B**



FILE NAME = ...\\D160F72-sht-light-09.dgn
CIVILTECH

USER NAME = akw
PLOT SCALE = 100.0000' / in.
PLOT DATE = 5/2/2012

DESIGNED - SJC
DRAWN - SJC
CHECKED - DNM
DATE - 5/3/2012

REVISED -
REVISED -
REVISED -
REVISED -

**STATE OF ILLINOIS
DEPARTMENT OF TRANSPORTATION**

LIGHTING PLAN

SCALE: 1" = 50' SHEET NO. 10 OF 31 SHEETS STA. 59+50 TO STA. 68+14.20

O.R. RTE.	SECTION	COUNTY	TOTAL SHEETS	SHEET NO.
0003	18A-2	MCHEMRY	825	307
CONTRACT NO. 60F72				
FED. ROAD DIST. NO. 1 ILLINOIS FED. AID PROJECT				