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Stream Restoration Grading Plan and Profile


Drawn By: t.e.g./EMK AES Project No.: 05-0198 (02-527)
Checked: WWS File Name: 020627/esd20100723_Grading.dwg
Approved: GDP Date: 05-16-2003

Crystal Creek Realignment

Algonquin, Illinois
Village of Algonquin
125 Wilbrandt Street
Algonquin, Illinois 60102

Revisions:			
No.	By	Date	Description
2		12-11-03	Regulatory Comments
3		02-04-04	Village Comments
4		11-30-09	CBBE Comments
5		02-26-10	Final AES review for ACOE submittal
6		05-28-10	ACOE & MCSWCD Comments
7		07-23-10	CTI Review - Towne Park Plans

Sheet Number
2 of 10


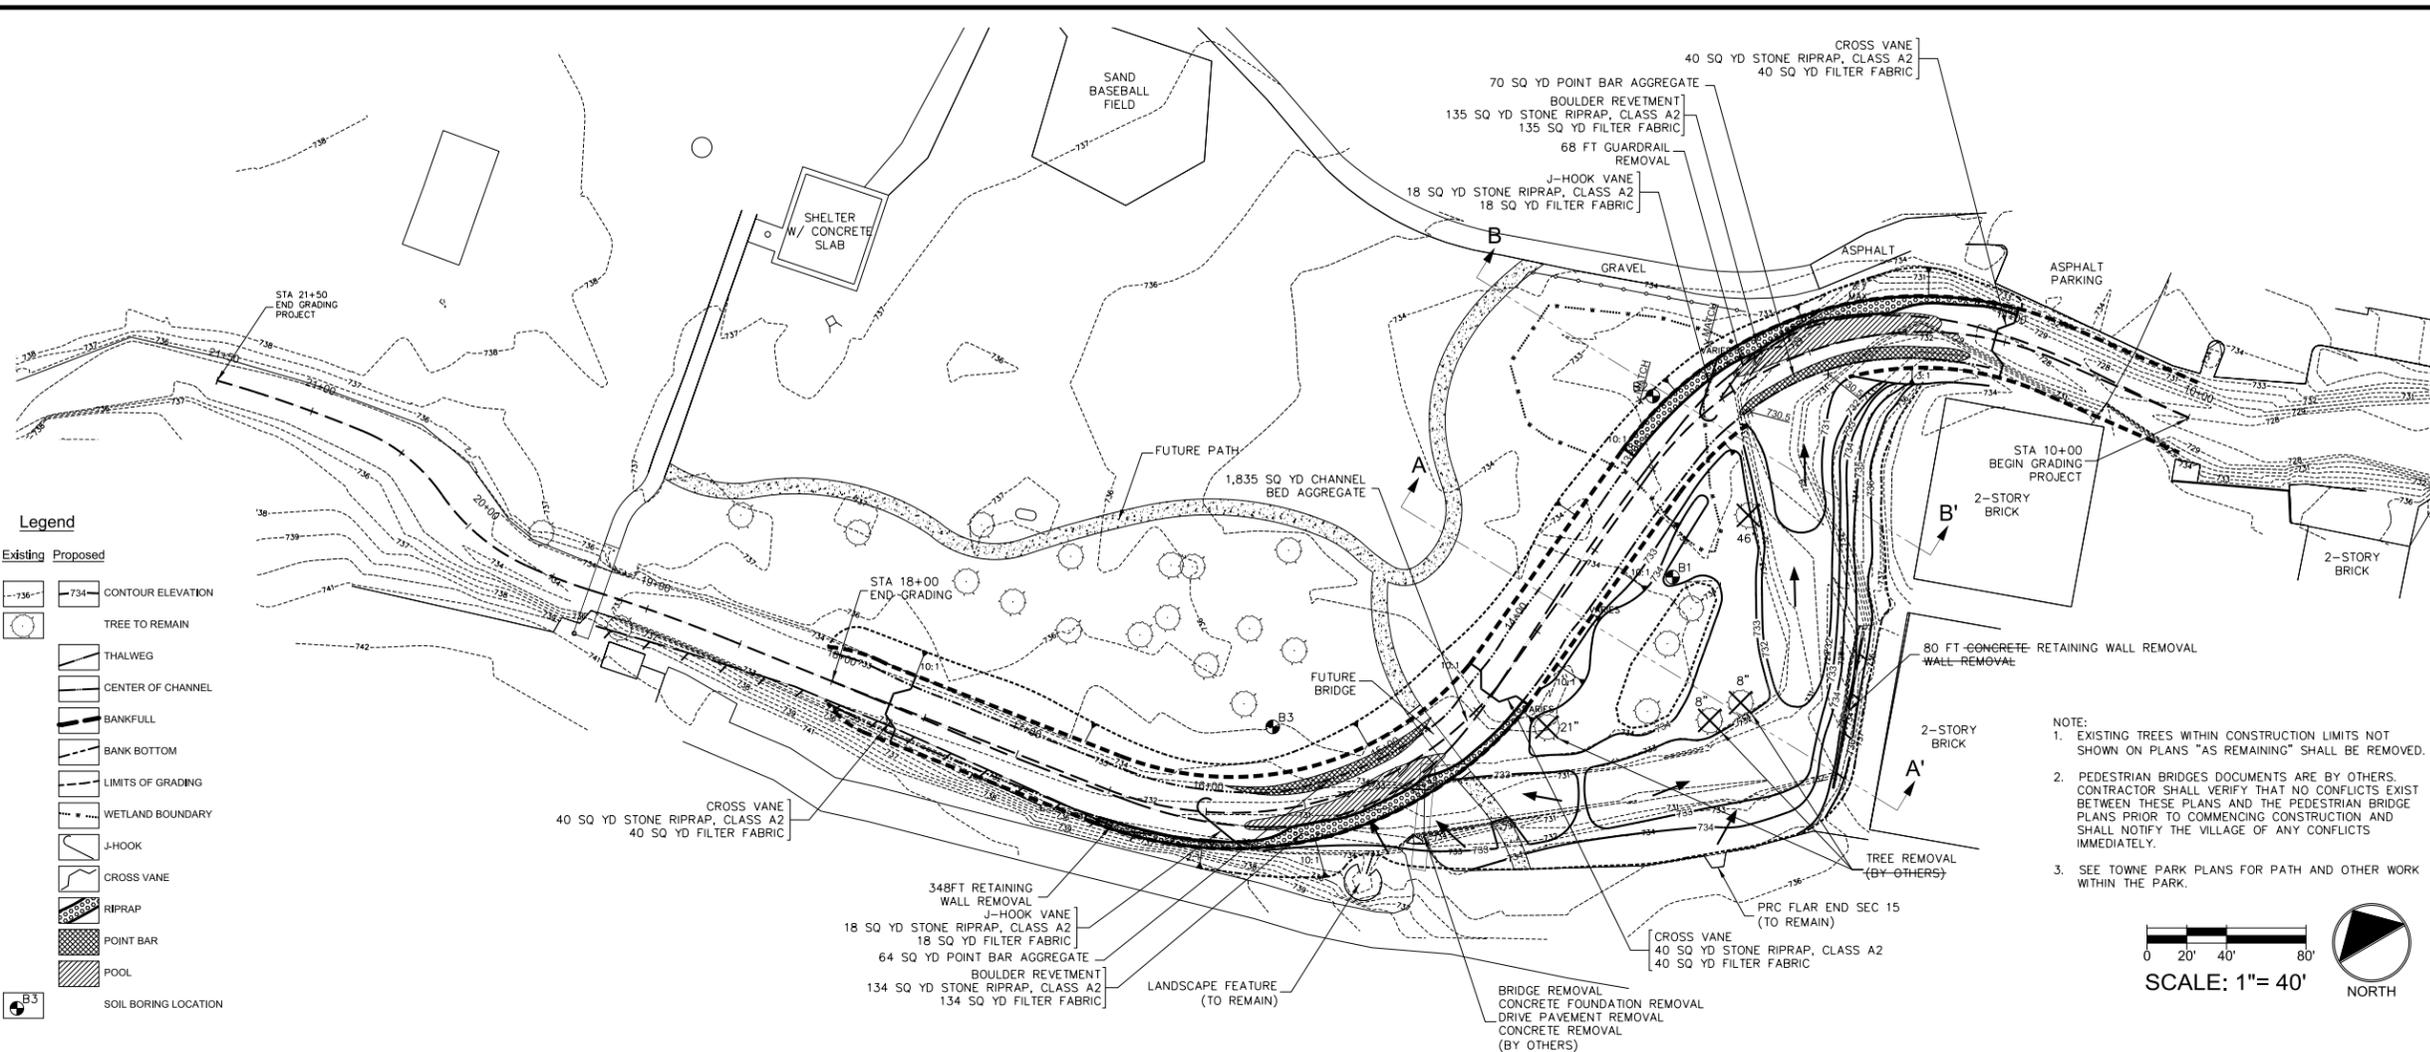


Legend

Existing Proposed

- CONTOUR ELEVATION
- TREE TO REMAIN
- THALWEG
- CENTER OF CHANNEL
- BANKFULL
- BANK BOTTOM
- LIMITS OF GRADING
- WETLAND BOUNDARY
- J-HOOK
- CROSS VANE
- RIPRAP
- POINT BAR
- POOL
- SOIL BORING LOCATION

- NOTE:
- EXISTING TREES WITHIN CONSTRUCTION LIMITS NOT SHOWN ON PLANS "AS REMAINING" SHALL BE REMOVED.
 - PEDESTRIAN BRIDGES DOCUMENTS ARE BY OTHERS. CONTRACTOR SHALL VERIFY THAT NO CONFLICTS EXIST BETWEEN THESE PLANS AND THE PEDESTRIAN BRIDGE PLANS PRIOR TO COMMENCING CONSTRUCTION AND SHALL NOTIFY THE VILLAGE OF ANY CONFLICTS IMMEDIATELY.
 - SEE TOWNE PARK PLANS FOR PATH AND OTHER WORK WITHIN THE PARK.

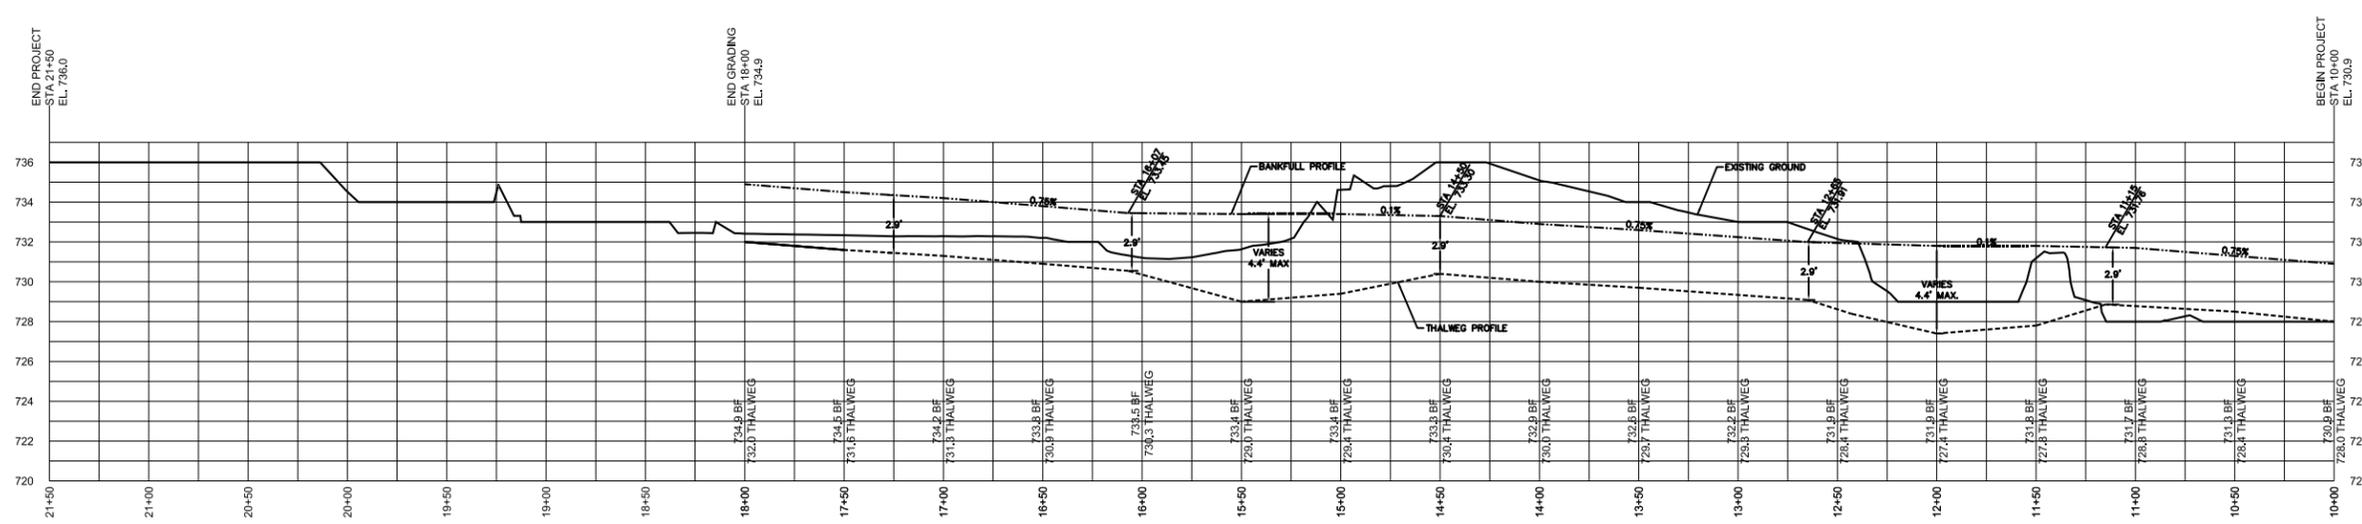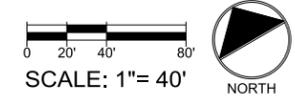

FILE NAME = ...\\D160F72-sht-Towne Park-04.dgn

USER NAME = akw
DESIGNED - AES
DRAWN - AES
PLOT SCALE = 2.0000' / in.
PLOT DATE = 5/2/2012

DESIGNED - AES
DRAWN - AES
CHECKED - AES
DATE - 5/3/2012

STATE OF ILLINOIS
DEPARTMENT OF TRANSPORTATION

CRYSTAL CREEK RELOCATION PLANS

SCALE: AS NOTED SHEET NO. 2 OF 10 SHEETS STA. TO STA.

O.R. RTE.	SECTION	COUNTY	TOTAL SHEETS	SHEET NO.
0003	18A-2	MCHENRY	825	401

CONTRACT NO. 60F72
FED. ROAD DIST. NO. 1 ILLINOIS FED. AID PROJECT



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Stream Restoration Planting Plan


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Crystal Creek Realignment Algonquin, Illinois Village of Algonquin 125 Wilbrandt Street Algonquin, Illinois 60102

Revisions:

No.	By	Date	Description
1		06-30-03	Village Comments
2		12-11-03	Regulatory Comments
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4		11-30-09	CBBE Comments
5		02-26-10	Final AES review for ACOE submittal
6		05-28-10	ACOE & MCSWCD Comments
7		05-16-11	ACOE permit submittal


Sheet Number
3 of 10

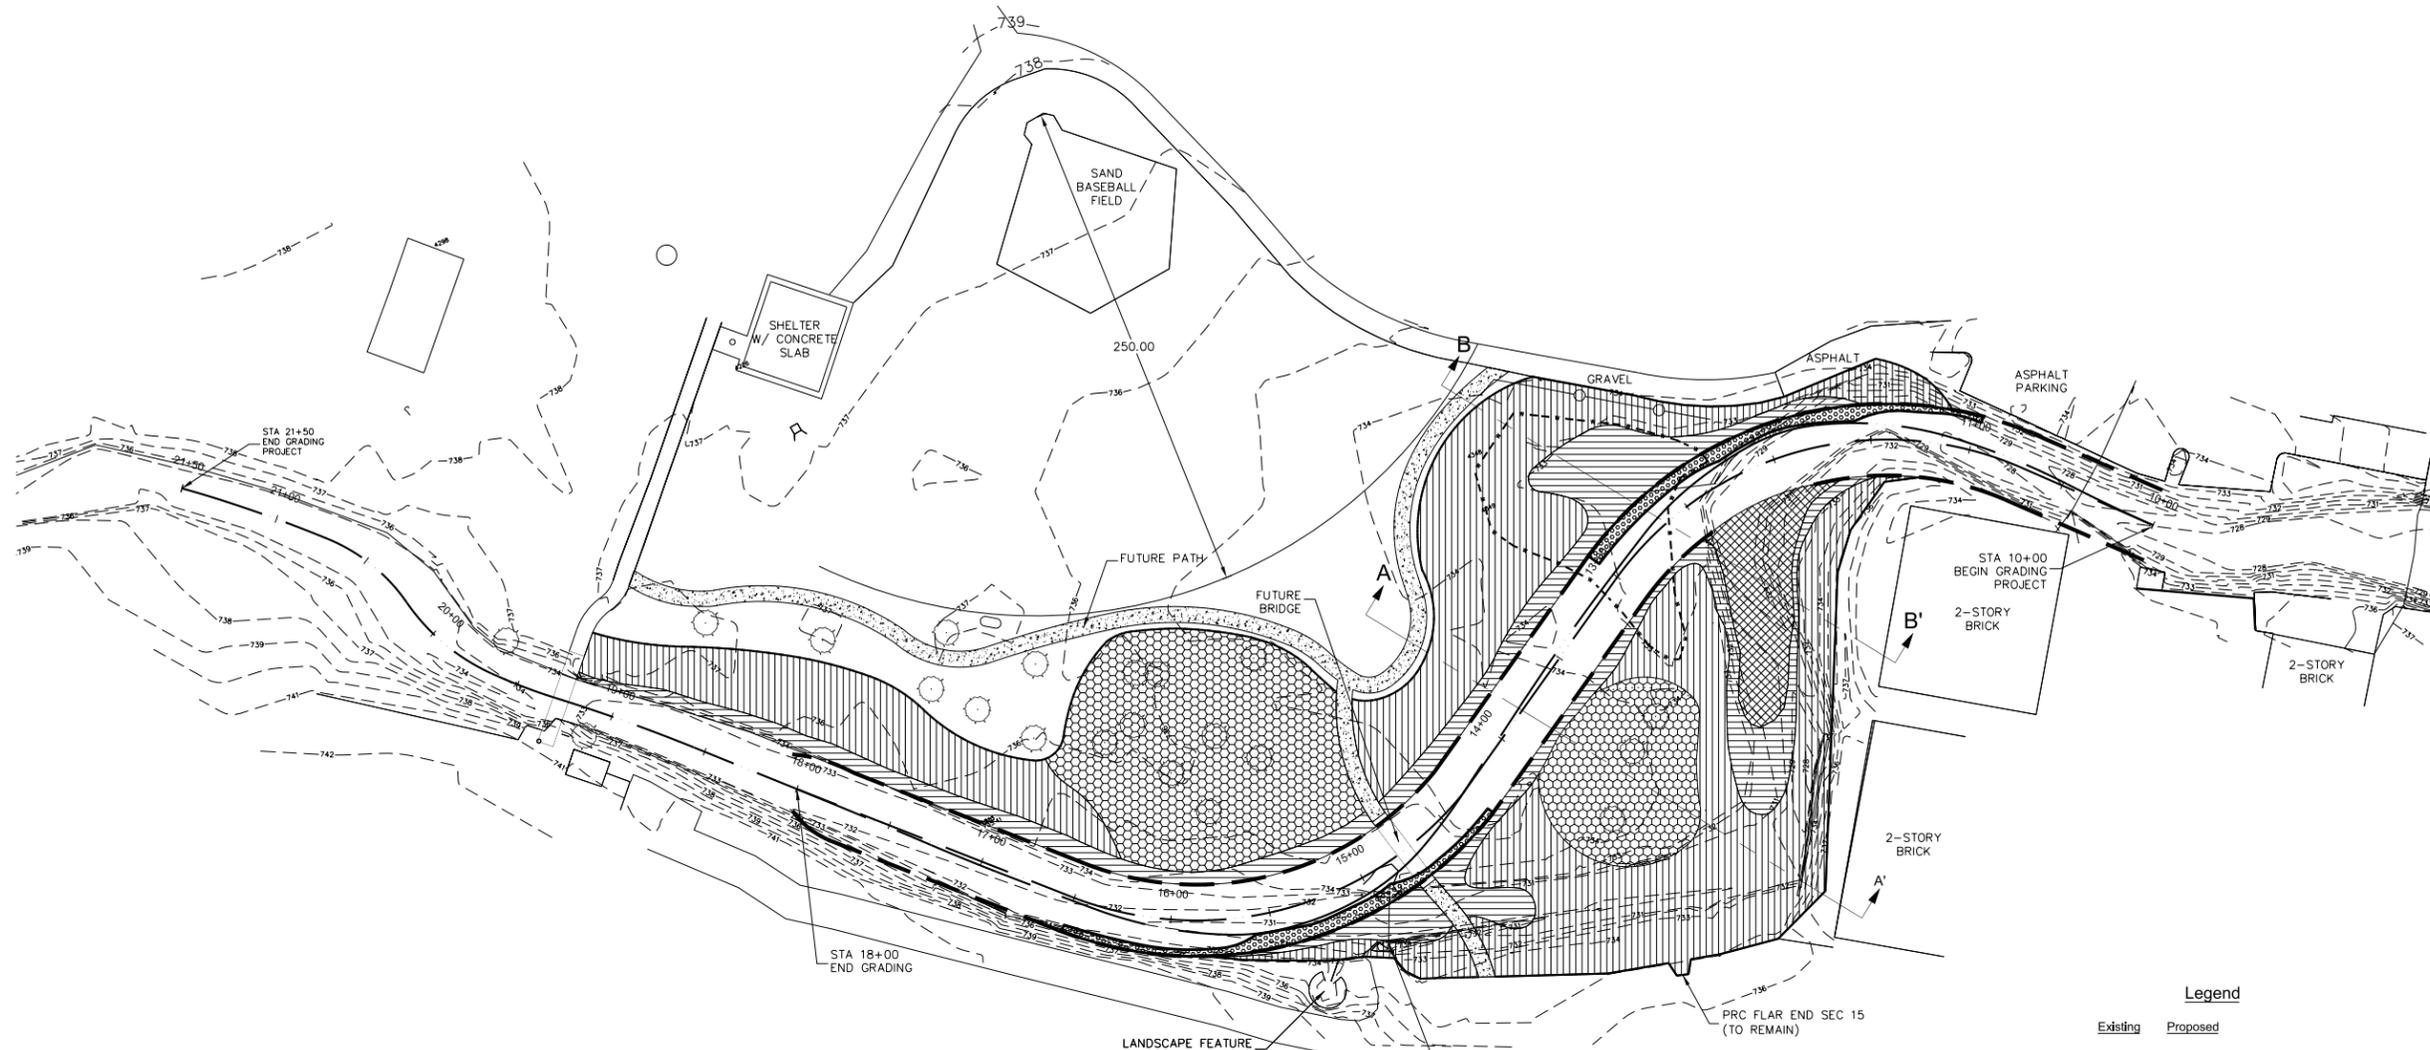

Legend

- | | | | |
|--|--|--|--|
| | Existing | | Proposed |
| | CONTOUR ELEVATION | | TREE TO REMAIN |
| | BANKFULL | | LIMIT OF CONSTRUCTION |
| | WETLAND BOUNDARY | | SEEDING EMERGENT MIX AND EMERGENT TYPE PLUGS |
| | SEEDING WET PRAIRIE MIX AND WET PRAIRIE TYPE PLUGS | | SEEDING MESIC PRAIRIE MIX AND MESIC PRAIRIE TYPE PLUGS |
| | SEEDING SAVANNA MIX AND SAVANNA TYPE PLUGS | | FENCE |
| | RIPRAP | | |

NOTE:
1. FINAL LOCATION AND DESIGN OF ASPHALT HIKING PATH TO BE BY VILLAGE OF ALGONQUIN. PRELIMINARY LOCATION OF PATH IS SHOWN FOR INFORMATIONAL PURPOSES ONLY AND PATH IS NOT INCLUDED IN THIS CONTRACT.
2. IRIS VIRGINICA SHREVEI (BLUE FLAG), IN THE WET PRAIRIE PLUG LIST, SHOULD BE CONCENTRATED ALONG THE STREAM EDGE.

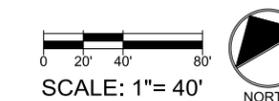

PERENNIAL PLANTS, EMERGENT TYPE, 2" DIAMETER BY 4" DEEP PLUG

SCIENTIFIC NAME	COMMON NAME	plants
<i>Acorus calamus</i>	Sweet flag	520
<i>Iris virginica albens</i>	Blue flag	520
<i>Sagittaria arifolia</i>	Chaimaker's rush	520
<i>Sagittaria latifolia</i>	Common arrowhead	520
<i>Sparganium americanum</i>	Common bur reed	520

PERENNIAL PLANTS, MESIC PRAIRIE TYPE, 2" DIAMETER BY 4" DEEP PLUG

SCIENTIFIC NAME	COMMON NAME	plants
<i>Corynephorus lanicola</i>	Sand tickseed	200
<i>Achillea tuberosa</i>	Butterfly milkweed	200
<i>Liatris aspera</i>	Rough blazing star	200
<i>Pentstemon digitalis</i>	Foxglove beard tongue	200

PERENNIAL PLANTS, SAVANNA TYPE, 2" DIAMETER BY 4" DEEP PLUG

SCIENTIFIC NAME	COMMON NAME	plants
<i>Carex praeclara</i>	Pennsylvania sedge	250
<i>Geranium maculatum</i>	Wild geranium	100
<i>Hibiscus strumosus</i>	Woodland sunflower	200
<i>Phlox divaricata</i>	Blue phlox	250

PERENNIAL PLANTS, WET PRAIRIE TYPE, 2" DIAMETER BY 4" DEEP PLUG

SCIENTIFIC NAME	COMMON NAME	plants
<i>Calamagrostis canadensis</i>	Blue joint grass	1000
<i>Carex lycuria</i>	Bottlebrush sedge	2000
<i>Carex lasiocarpa</i>	Bebb's sedge	2000
<i>Carex vulpinoidea</i>	Fox sedge	2000
<i>Iris virginica albens</i>	Blue flag	2000
<i>Spartina patens</i>	Prairie cord grass	1000

SEEDING, MESIC MIX

Wet Prairie Species List

SCIENTIFIC NAME	COMMON NAME	oz./ac.
<i>Andropogon gerardii</i>	Big bluestem	32.0
<i>Andropogon scoparius</i>	Little bluestem	24.0
<i>Elymus canadensis</i>	Canada wild rye	48.0
<i>Panicum virgatum</i>	Switch grass	16.0
<i>Sorghastrum nutans</i>	Indian grass	40.0
Total grasses, sedges, etc. (lbs./ac.) 10.0		

Forbs

SCIENTIFIC NAME	COMMON NAME	oz./ac.
<i>Allium arvensis</i>	Nodding wild onion	4.0
<i>Aster laevis</i>	Smooth blue aster	2.4
<i>Aster erinoides</i>	Heath aster	1.6
<i>Aster novae-angliae</i>	New England aster	2.4
<i>Echinacea purpurea</i>	Purple coneflower	1.6
<i>Domium canadense</i>	Shovely tick leaf	4.8
<i>Hedeotis helianthoides</i>	False sunflower	4.8
<i>Lepachys capitata</i>	Round-headed bush clover	2.4
<i>Liatris scariosa</i>	Prairie blazing star	6.4
<i>Lupinus perennis</i>	Lupine	1.6
<i>Wild begoniat</i>		3.2
<i>Foxglove beard tongue</i>		2.4
<i>Purple prairie clover</i>		3.2
<i>Common mountain mint</i>		1.6
<i>Yellow coneflower</i>		4.8
<i>Black-eyed Susan</i>		2.4
<i>Stiff goldenrod</i>		1.6
<i>Wild goldenrod</i>		2.4
<i>Common spiderwort</i>		2.4
<i>Heavy veronica</i>		1.6
<i>Golden Alexander</i>		2.4
Total forbs (lbs./ac.) 4.0		

Cover Crop

SCIENTIFIC NAME	COMMON NAME	oz./ac.
<i>Avena sativa</i> (spring)	Oats	320.0
<i>Secale cereale</i> (fall)	Winter rye	320.0
Total (lbs./ac.) 20.0		

SEEDING, WET PRAIRIE MIX

Wet Prairie Species List

SCIENTIFIC NAME	COMMON NAME	oz./ac.
<i>Andropogon gerardii</i>	Big bluestem	8.0
<i>Andropogon scoparius</i>	Little bluestem	8.0
<i>Carex crinitella</i>	Crested oval sedge	16.0
<i>Carex vulpinoidea</i>	Bottlebrush sedge	24.0
<i>Elymus canadensis</i>	Canada wild rye	1.6
<i>Elymus virginicus</i>	Virginia wild rye	16.0
<i>Elymus virginicus</i>	Virginia wild rye	40.0
<i>Glyceria striata</i>	Manna grass	8.0
<i>Juncus dielii</i>	Dodley's rush	1.6
<i>Juncus effusus</i>	Common spike rush	1.6
<i>Lernia stygioides</i>	Rice cut grass	1.6
<i>Panicum virgatum</i>	Switch grass	16.0
<i>Sagittaria arifolia</i>	Chaimaker's rush	1.6
<i>Sagittaria latifolia</i>	Common arrowhead	2.4
Total grasses, sedges, etc. (lbs./ac.) 9.1		

Forbs

SCIENTIFIC NAME	COMMON NAME	oz./ac.
<i>Achillea millefolium</i>	Swamp milkweed	2.4
<i>Aster novae-angliae</i>	New England aster	4.8
<i>Aster paniculatus</i>	Marsh aster	3.2
<i>Cirsium montanum</i>	White thistle	1.6
<i>Hibiscus asotensis</i>	Succoweed	3.2
<i>Lobelia siphilitica</i>	Great blue lobelia	2.4
<i>Lycopodium obscurum</i>	Common water horsetail	1.6
<i>Mimulus ringens</i>	Monkey flower	3.2
<i>Polygonum pennsylvanicum</i>	Smartweed	2.4
<i>Pycnanthemum virginianum</i>	Common mountain mint	3.2
<i>Tricorythos albidus</i>	Gemander	1.6
<i>Veronica hastata</i>	Blue veronica	2.4
Total forbs (lbs./ac.) 2.0		

Cover Crop

SCIENTIFIC NAME	COMMON NAME	oz./ac.
<i>Echinochloa crusgalli</i>	Barnyard grass	160.0
<i>Lolium multiflorum</i> (spring)	Annual rye	160.0
<i>Secale cereale</i> (fall)	Winter rye	160.0
Total (lbs./ac.) 20.0		

SEEDING, SAVANNA MIX

Savanna Species List

SCIENTIFIC NAME	COMMON NAME	oz./ac.
<i>Andropogon gerardii</i>	Big bluestem	16.0
<i>Bromus pteropus</i>	Woodland Bromo	24.0
<i>Carex spraguei</i>	Long-beaked sedge	8.0
<i>Elymus canadensis</i>	Canada wild rye	32.0
<i>Elymus villosus</i>	Silky Wild Rye	24.0
<i>Elymus virginicus</i>	Virginia Wild Rye	24.0
<i>Hymenopappus</i>	Bottlebrush Grass	24.0
<i>Panicum virgatum</i>	Switch grass	4.0
<i>Sorghastrum nutans</i>	Indian grass	8.0
Total grasses, sedges, etc. (lbs./ac.) 10.3		

Forbs

SCIENTIFIC NAME	COMMON NAME	oz./ac.
<i>Allium arvensis</i>	Nodding wild onion	1.6
<i>Anemone virginiana</i>	Tall thimbleweed	1.2
<i>Aquilegia canadensis</i>	Columbine	1.6
<i>Aster ageratoides</i>	Sky-Blot Aster	1.6
<i>Aster latifolius</i>	Side-flowering aster	4.8
<i>Aster spicatus</i>	Diamond's aster	4.0
<i>Campanula americana</i>	Tall bellflower	4.8
<i>Eupatorium purpureum</i>	Savanna Joe Pyeweed	3.2
<i>Eupatorium rugosum</i>	White snakeroot	2.4
<i>Geranium maculatum</i>	Wild geranium	2.4
<i>Hibiscus strumosus</i>	Woodland sunflower	2.4
<i>Manisuris flabellata</i>	Wild begoniat	6.8
<i>Pentstemon digitalis</i>	Bearded fox glove	4.8
<i>Phlox pilosa</i>	Phlox	0.8
<i>Polimonium virginicum</i>	Jacob's ladder	0.8
<i>Lycopodium obscurum</i>	Common water horsetail	8.0
<i>Rudbeckia triloba</i>	Brown-eyed Susan	2.4
<i>Scyrinchium campetris</i>	Eye Grass	0.4
<i>Solidago nemoralis</i>	Faint Solomon's seal	4.8
<i>Solidago flexilis</i>	Brad-leaved goldenrod	1.2
<i>Solidago nemoralis</i>	Elm-leaved goldenrod	3.2
<i>Tradescantia virginiana</i>	Spiderwort	1.6
<i>Zizia aurea</i>	Golden Alexander	1.6
Total forbs (lbs./ac.) 4.1		

Cover Crop

SCIENTIFIC NAME	COMMON NAME	oz./ac.
<i>Avena sativa</i> (spring)	Oats	320.0
<i>Secale cereale</i> (fall)	Winter rye	320.0
Total (lbs./ac.) 20.0		

BRIDGE REMOVAL
CONCRETE FOUNDATION REMOVAL
DRIVE PAVEMENT REMOVAL
CONCRETE REMOVAL
(BY OTHERS)

FILE NAME = ...\\D160F72-sht-Towne Park-05.dgn

USER NAME = okw
PLOT SCALE = 2.0000' / in.
PLOT DATE = 5/2/2012

DESIGNED - AES
DRAWN - AES
CHECKED - AES
DATE - 5/3/2012

REVISED -
REVISED -
REVISED -
REVISED -

STATE OF ILLINOIS
DEPARTMENT OF TRANSPORTATION

CRYSTAL CREEK REALIGNMENT PLANS
SCALE: AS NOTED
SHEET NO. 3 OF 10 SHEETS
STA. TO STA.

O.R. RTE. SECTION COUNTY TOTAL SHEETS SHEET NO.
0003 18A-2 MCHENRY 825 402
CONTRACT NO. 60F72
FED. ROAD DIST. NO. 1 ILLINOIS FED. AID PROJECT



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Construction Sequence and Erosion Control Plan

Drawn By: t.e.g./EMK AES Project No.: 05-0198 (02-527)
Checked: WWS File Name: 020627(esa)20100528_Erosion.dwg
Approved: GDP Date: 05-16-2003

Crystal Creek Realignment Algonquin, Illinois Village of Algonquin 125 Wilbrandt Street Algonquin, Illinois 60102

Revisions:			
No.	By	Date	Description
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7			

Sheet Number
4 of 10

- IF DEWATERING SERVICES ARE USED, ADJOINING PROPERTIES AND DISCHARGE LOCATIONS SHALL BE PROTECTED FROM EROSION. DISCHARGES SHALL BE ROUTED THROUGH AN EFFECTIVE SEDIMENT CONTROL MEASURE (E.G. SEDIMENT TRAP, SEDIMENT BASIN, FILTER BAG, OR OTHER APPROPRIATE MEASURE.)
- ALL DISTURBED AREAS AND WORK AREAS MUST BE ISOLATED FROM CREEK FLOWS AT ALL TIMES. THE DIMENSION / ISOLATION OF THE CREEK FLOWS MUST BE CONSTRUCTED FROM NON-ERODIBLE MATERIALS. THE U.S. ARMY CORP OF ENGINEERS MUST BE IN AGREEMENT WITH OVERALL METHOD OF DIVERSION / ISOLATION PRIOR TO THE COMMENCEMENT OF CONSTRUCTION.
- DURING WORK ON THE BANKS, SHALERIVER/STREAM/WETLAND WORK MUST BE TIMED TO TAKE PLACE DURING LOW OR NON-FLOW CONDITIONS.
- CONCENTRATED FLOW MUST BE ISOLATED FROM THE WORK AREA USING A NON-ERODIBLE COFFERDAM. EXACT MEANS AND METHODS SHOULD BE DISCUSSED DURING A SCHEDULED PRE-CONSTRUCTION MEETING.
- IF BYPASS IS NECESSARY, THE INLET OF THE HOSE SHALL BE PLACED IN A SUMP PIT AND THE OUTLET FILTER BAG TO BE PLACED ON A FLAT, NON-ERODIBLE, ENERGY DISSIPATING SURFACE PRIOR TO REJOINING THE STREAM FLOW OR WETLAND.
- IF DEWATERING THE CONSTRUCTION AREAS IS NECESSARY, THE CONTRACTOR SHALL FILTER ALL WATER BY USING PUMP PIT, FILTER BAGS, AN INLINE FILTER OR APPROVED ALTERNATE MEASURE. WATER MUST HAVE SEDIMENT REMOVED BEFORE BEING ALLOWED TO DISCHARGE TO THE CREEK/STREAM/WETLAND/RIVER.
- CRITICAL SIDE SLOPES MUST BE RESEEDED AND STABILIZED WITH APPROPRIATE EROSION CONTROL BLANKET PRIOR TO BEING EXPOSED TO STREAM FLOW.

CONSTRUCTION SEQUENCE

PRIOR TO COMMENCING CLEARING OR GRADING OPERATIONS

- INSTALL CONSTRUCTION FENCE AROUND TREE PRESERVATION AREAS AND CONSTRUCTION BOUNDARIES.
- INSTALL SILT FENCE ALONG THE TOE OF CHANNEL BANK SLOPES, PROPOSED TEMPORARY STOCKPILE AREAS, AND BRIDGE ABUTMENTS DESIGNATED FOR REMOVAL.
- INSTALL DEWATERING.

STAGE 1

- STREAM ROUTING:
 - CONVEYANCE MAINTAINED IN EXISTING CRYSTAL CREEK CHANNEL. THE UPSTREAM AND DOWNSTREAM CONVEYANCE AREAS WILL BE RESTRICTED TO THE LEFT-HAND (LOOKING UPSTREAM) CHANNEL HALF USING A COFFERDAM.
- CONSTRUCTION:
 - REMOVE EXISTING PEDESTRIAN BRIDGE AND ITS NORTH BRIDGE ABUTMENT. CONSTRUCT ABUTMENTS FOR RELOCATED EAST BRIDGE.
 - CONSTRUCT AND STABILIZE THE ENTIRE CHANNEL LOCATED OUTSIDE OF THE EXISTING CHANNEL LIMITS. EXCAVATE COBBLE AND GRAVEL FROM EXISTING POINT BARS TO PROVIDE THE CHANNEL BED MATERIALS.
 - CONSTRUCT AND STABILIZE THE RIGHT-HAND (LOOKING UPSTREAM) SECTION OF THE CHANNEL AT THE UPSTREAM END OF THE PROJECT.
 - STOCKPILE EXCAVATED MATERIAL BETWEEN THE EXISTING CHANNEL AND THE NEWLY CONSTRUCTED CHANNEL.

EROSION CONTROL:

- STRIP AND STOCKPILE TOPSOIL.
- MAINTAIN SILT FENCE AROUND ALL STOCKPILE AREAS, EXISTING WETLAND AREAS.
- MAINTAIN DEWATERING TO PREVENT STREAM WATER FROM ENTERING THE CONSTRUCTION AREA.
- MAINTAIN A PUMPING PIT AND FILTER BAG TO RECEIVE ALL WATER PUMPED FROM CONSTRUCTION AREA (NO CONSTRUCTION AREA DRAINAGE SHALL BE DISCHARGED DIRECTLY TO CRYSTAL CREEK).

STAGE 2

- STREAM ROUTING:
 - CONVEYANCE MAINTAINED IN RELOCATED CRYSTAL CREEK CHANNEL AND THE RIGHT-HAND (LOOKING UPSTREAM) SECTION OF THE EXISTING CHANNEL AT THE DOWNSTREAM AREA OF THE PROJECT. THE UPSTREAM AREA WILL BE RESTRICTED TO THE RIGHT-HAND (LOOKING UPSTREAM) RELOCATED CHANNEL HALF USING A COFFERDAM.
- CONSTRUCTION:
 - REMOVE SOUTH ABUTMENT OF EXISTING BRIDGE.
 - CONSTRUCT AND STABILIZE THE LEFT-HAND (LOOKING UPSTREAM) SECTION OF THE CHANNEL AT THE UPSTREAM END OF THE PROJECT.
 - CONSTRUCT AND STABILIZE THE LEFT HALF (LOOKING UPSTREAM) OF THE DOWNSTREAM CHANNEL.
 - FILL THE EXISTING CHANNEL WITH THE TEMPORARY STOCKPILE MATERIAL.
- EROSION CONTROL:
 - MAINTAIN SILT FENCE AROUND ALL STOCKPILE AREAS, EXISTING WETLAND AREAS.
 - MAINTAIN DEWATERING TO PREVENT STREAM WATER FROM ENTERING THE CONSTRUCTION AREA.
 - MAINTAIN A PUMPING PIT AND FILTER BAG TO RECEIVE ALL WATER PUMPED FROM CONSTRUCTION AREA (NO CONSTRUCTION AREA DRAINAGE SHALL BE DISCHARGED DIRECTLY TO CRYSTAL CREEK).

EROSION CONTROL AND CONSTRUCTION SEQUENCE PLAN

THE PLAN IS DESIGNED TO: 1) PREVENT THE TRANSPORT OF SOIL AND SUBSOIL FROM GRADED AND DISTURBED AREAS INTO THE EXISTING CHANNEL DURING CONSTRUCTION OF THE NEW CHANNEL AND 2) MAINTAIN FLOW CONVEYANCE OF CRYSTAL CREEK DURING CONSTRUCTION. THE INTENT OF THE PLAN IS TO ALLOW CONSTRUCTION OF THE RELOCATED CHANNEL AND PLACEMENT OF THE EXCAVATED MATERIALS TO REFILL THE EXISTING CHANNEL TO BE DONE UNDER AS DRY A CONDITION AS PRACTICAL. THE CONTRACTOR SHALL MAINTAIN AT LEAST ONE-HALF THE EXISTING CHANNEL WIDTH FOR CONVEYANCE PURPOSES DURING ALL STAGES OF CONSTRUCTION. ADDITIONAL PUMP AROUND AND BYPASS TECHNIQUES MAY BE NECESSARY TO ASSIST WITH CONVEYANCE.

CONSTRUCTION IS ANTICIPATED TO BE COMPLETE WITHIN 30 DAYS OF THE PROJECT START DATE. TEMPORARY DIVERSIONS TO CREATE DRIER CONDITIONS FOR GRADING OF POOL STRUCTURES SHALL BE CONSTRUCTED USING A COMBINATION OF COFFERDAMS AND SANDBAGS. THESE SHALL BE IN PLACE PRIOR TO COMMENCING EACH CONSTRUCTION STAGE. THE CONTRACTOR SHALL BE RESPONSIBLE FOR STABILIZING THE EXISTING AND/OR NEW CHANNEL AT DAYS END IF ADDITIONAL WORK FOR THAT PHASE IS NEEDED THE NEXT DAY.

EXCAVATED SOIL SHALL BE TEMPORARILY STOCKPILED ON-SITE IN LOCATIONS DESIGNATED FOR DRY SOIL (TOP SOIL), WET SOIL (SAND AND SILT), AND COBBLE/GRAVEL, CHANNEL BED AND BANKS. SILT FENCE SHALL BE INSTALLED AND MAINTAINED AROUND THE STOCKPILES THROUGHOUT THE PROJECT DURATION. ALL EXCAVATION MATERIAL SHALL BE PLACED ON SITE.

EXPOSED SOIL SHALL BE STABILIZED WITH COVER CROP OR PERMANENT SEED MIXES. IF CONSTRUCTION OCCURS MID TO LATE SUMMER, COVER CROP, STRAW MULCH AND/OR EROSION CONTROL BLANKET SHALL BE USED TO STABILIZE EXPOSED SLOPES. SEEDING OF PERMANENT MATRIP SHALL OCCUR AS A DORMANT SEEDING (AFTER NOVEMBER 1) AFTER BLANKET NETTING IS REMOVED AND THE COVER CROP IS MOWED. SILT FENCE SHALL NOT BE REMOVED UNTIL VEGETATIVE COVERAGE ON SEEDS EXCEEDS 90%.

THIS PLAN INCLUDES A SUGGESTED CONSTRUCTION STAGING SEQUENCE. THE CONTRACTOR MAY PRESENT AN ALTERNATIVE METHOD IN WRITTEN AND PLAN FORM WHICH MAY BE USED CONDITIONED UPON WRITTEN ACCEPTANCE BY THE OWNER, ENGINEER, U.S. ARMY CORPS OF ENGINEERS, AND THE MCHENRY COUNTY SOIL AND WATER CONSERVATION DISTRICT.

GENERAL EROSION CONTROL NOTES

- ALL WORK WITH A STREAM IS SUBJECT TO THE RULES AND REGULATIONS OF THE U.S. ARMY CORPS OF ENGINEERS FOR IN-STREAM MODIFICATIONS (404 PERMITS), THE ILLINOIS DNR, AND THE VILLAGE OF ALGONQUIN.
- EROSION CONTROL FOR THIS PROJECT IS A HIGH MAINTENANCE ITEM. DAILY INSPECTION AND MAINTENANCE SHALL BE PERFORMED AS NEEDED TO ENSURE THAT THE TEMPORARY DIVERSION, STREAMS AND STREAMBANKS ARE MAINTAINED AND NOT DAMAGED. MAINTENANCE SHALL INCLUDE REMOVAL AND DISPOSAL OF ANY TRAPPED SEDIMENT OR DEBRIS. DEBRIS WILL BE REMOVED FROM THE SITE. SEDIMENT MAY BE DISPOSED OF IN THE TEMPORARY STOCKPILE AREA.
- SILT FENCE SHALL BE UTILIZED AS THE PRIMARY MEANS FOR PROTECTING THE CONVEYANCE CHANNEL THROUGH ALL PHASES OF THE PROJECT. THE CONTRACTOR SHALL EXPECT THAT ROUTINE REMOVAL OF ACCUMULATED SEDIMENT WILL BE REQUIRED FOR NEARLY ALL PHASES WHERE DREDGING OR EXCAVATING OCCURS. THE CONTRACTOR SHALL USE MACHINERY SUITABLE FOR SEDIMENT REMOVAL IN SHALLOW WATER CONDITIONS.
- ALL TEMPORARY STREAM DIVERSIONS SHALL BE REMOVED WITHIN 1 CALENDAR DAYS AFTER THE DIVERSION IS NO LONGER NEEDED.
- STABILIZED MATS OF AGGREGATE UNDERLIES WITH FILTER FABRIC OR AN APPROPRIATE MEASURE SHALL BE LOCATED AT DOWNSTREAM ENDS TO PREVENT ESCAPE OF FILL MATERIAL (E.G. SAND, THE GRAVEL, ETC.) SHOULD LEVELS BEHIND MATS BE LOWER THAN THE EXISTING CHANNEL CONVEYANCE CHANNEL.
- THE HEIGHT OF ALL TEMPORARY COFFERDAMS AND SANDBAG LEVEES SHALL BE THE BANKFULL DEPTH.
- ALL DEWATERING OF THE CONSTRUCTION AREA SHALL BE PUMPED TO A DEWATERING BASIN (PUMP PIT) THEN TO A FILTER BAG PRIOR TO RE-ENTERING THE STREAM.
- THE PROCESS OF EXCAVATION AND STABILIZATION SHALL BE A CONTINUOUS (UNINTERRUPTED) OPERATION. ALL MATERIALS SHALL BE ON-SITE ONE DAY PRIOR TO ITS IMPLEMENTATION.
- ADDITIONAL EROSION CONTROL MEASURES BEYOND THOSE DESCRIBED IN THIS PLAN OR APPROVED BY THE U.S. ARMY CORPS OF ENGINEERS, THE ILLINOIS DNR, AND THE VILLAGE OF ALGONQUIN SHALL BE REQUIRED AS NECESSARY.
- CONTRACTOR MAY LOCATE CONSTRUCTION FENCE WITH APPROVAL OF VILLAGE FORESTER TO MINIMIZE ROOT PRUNING OF EXISTING TREES.
- REMOVE CONSTRUCTION FENCE WHEN SEEDING IS COMPLETE.
- RESTORE TEMPORARY ACCESS TO PRE-CONSTRUCTION CONDITIONS.
- SOIL DISTURBANCE SHALL BE CONDUCTED IN SUCH A MANNER AS TO MINIMIZE EROSION. SOIL STABILIZATION MEASURES SHALL CONSIDER THE TIME OF YEAR, SITE CONDITIONS AND THE USE OF TEMPORARY OR PERMANENT MEASURES.
- SOIL EROSION AND SEDIMENT CONTROL FEATURES SHALL BE CONSTRUCTED PRIOR TO THE COMMENCEMENT OF HYDROLOGIC DISTURBANCE OF UPLAND AREAS.
- AREAS OR EMBANKMENTS HAVING SLOPES GREATER THAN, OR EQUAL TO, 3H:1V AND APPROVED BY THE ENFORCEMENT OFFICER, SHALL BE STABILIZED WITH MAT OR BLANKET IN COMBINATION WITH SEED.
- ALL STORM SEWERS THAT ARE, OR WILL BE, FUNCTIONING DURING CONSTRUCTION SHALL BE PROTECTED BY AN APPROPRIATE SEDIMENT CONTROL MEASURE.
- ALL TEMPORARY EROSION AND SEDIMENT CONTROL MEASURES SHALL BE REMOVED WITHIN 30 DAYS AFTER FINAL SITE STABILIZATION IS ACHIEVED, OR AFTER THE TEMPORARY MEASURES ARE NO LONGER NEEDED.
- ALL TEMPORARY AND PERMANENT EROSION CONTROL MEASURES MUST BE MAINTAINED AND REPAIRED AS NEEDED.

STABILIZED MATS OF AGGREGATE UNDERLIES WITH FILTER FABRIC OR AN APPROPRIATE MEASURE SHALL BE LOCATED AT DOWNSTREAM ENDS TO PREVENT ESCAPE OF FILL MATERIAL (E.G. SAND, THE GRAVEL, ETC.) SHOULD LEVELS BEHIND MATS BE LOWER THAN THE EXISTING CHANNEL CONVEYANCE CHANNEL.

PUMPING AREAS SHALL BE REMOVED ON OR BEFORE THE END OF THE PROJECT AND THE PUMPING AREAS SHALL BE RESTORED TO PRE-CONSTRUCTION CONDITIONS.

STABILIZED MATS OF AGGREGATE UNDERLIES WITH FILTER FABRIC OR AN APPROPRIATE MEASURE SHALL BE LOCATED AT DOWNSTREAM ENDS TO PREVENT ESCAPE OF FILL MATERIAL (E.G. SAND, THE GRAVEL, ETC.) SHOULD LEVELS BEHIND MATS BE LOWER THAN THE EXISTING CHANNEL CONVEYANCE CHANNEL.

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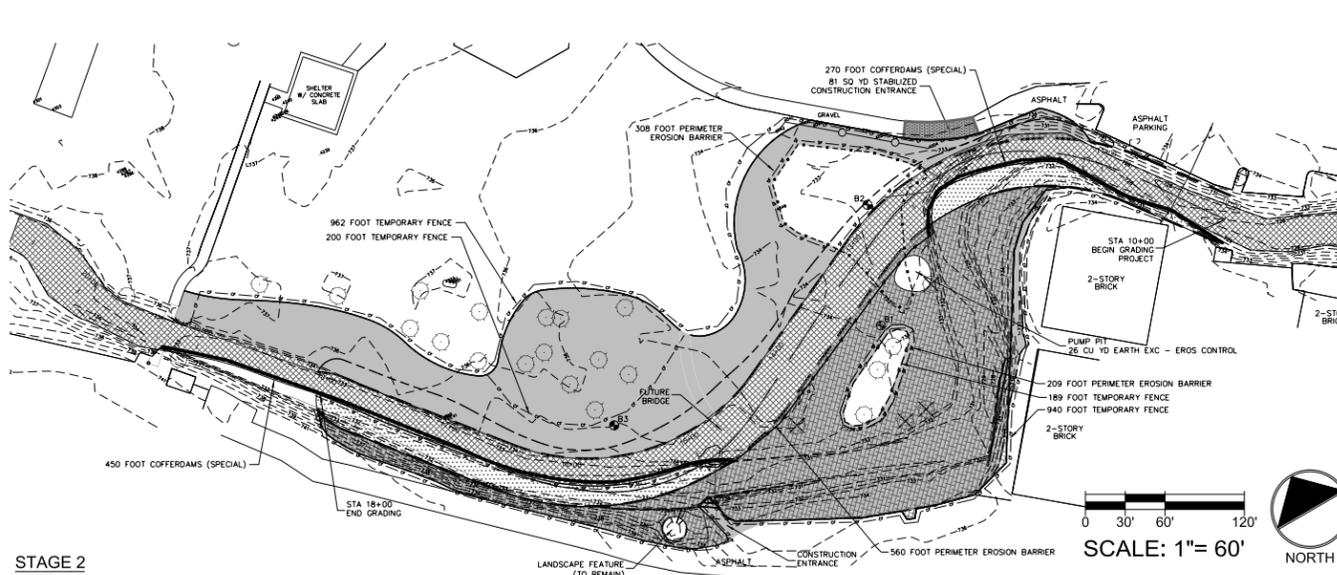
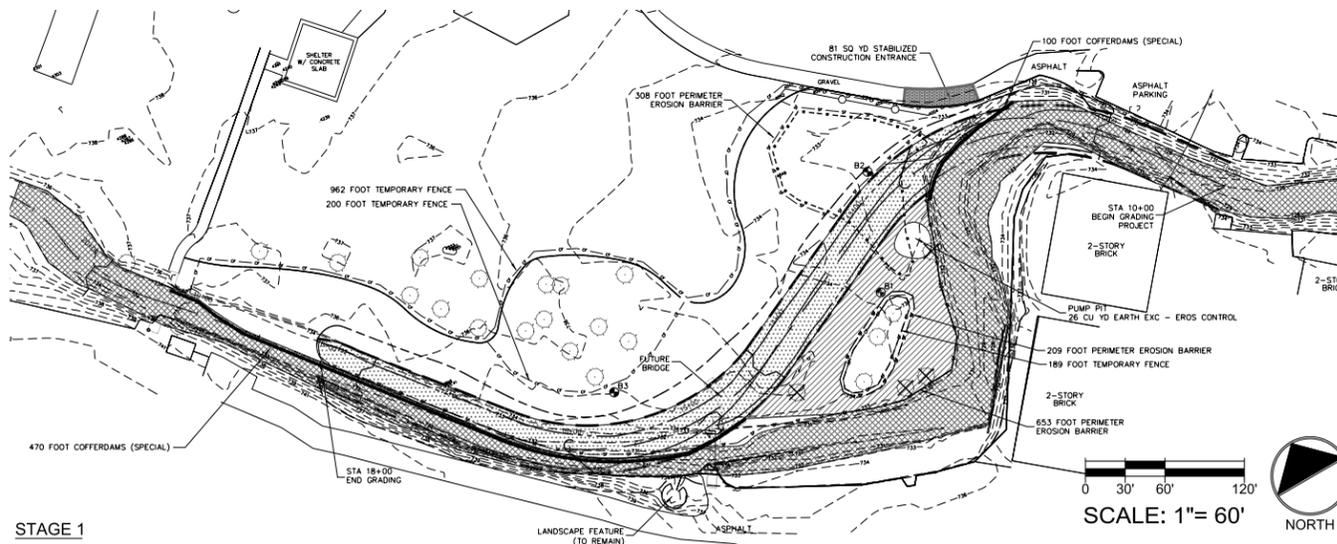
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SCALE: 1" = 60'

SCALE: 1" = 60'

Legend		
Temporary Erosion Control	Existing	Proposed
		CONTOUR ELEVATION
		TREE TO REMAIN
		BANKFULL
		TREE TO BE REMOVED
		WETLAND BOUNDARY
		FENCE
		PERIMETER EROSION BARRIER
		TEMPORARY FENCE
		COFFERDAMS (SPECIAL)
		EROSION CONTROL BLANKET
		LIMIT OF GRADING
		LIMIT OF CONSTRUCTION
		CHANNEL CONSTRUCTION AREA
		STOCKPILE AREA
		STREAM CONVEYANCE AREA
		GRADING AREA

FILE NAME = ...\\D160F72-sht-Towne Park-06.dgn	USER NAME = akw	DESIGNED - AES	REVISED -
		DRAWN - AES	REVISED -
		CHECKED - AES	REVISED -
		DATE - 5/3/2012	REVISED -

STATE OF ILLINOIS
DEPARTMENT OF TRANSPORTATION

CRYSTAL CREEK RELOCATION PLANS

SCALE: AS NOTED SHEET NO. 4 OF 10 SHEETS STA. TO STA.

O.R. RTE.	SECTION	COUNTY	TOTAL SHEETS	SHEET NO.
0003	18A-2	MCHENRY	825	403
FED. ROAD DIST. NO. 1 ILLINOIS FED. AID PROJECT				CONTRACT NO. 60F72



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Construction Details & Cross Sections









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Checked: WWS File Name: 020627(2)20100528_Details-1.dwg
Approved: GDP Date: 05-16-2003

Crystal Creek Realignment



Algonquin, Illinois
Village of Algonquin
125 Wilbrandt Street
Algonquin, Illinois 60102

No.	By	Date	Description
2		12-11-03	Regulatory Comments
3		02-04-04	Village Comments
4		11-30-09	CBBE Comments
5		02-26-10	Final AES review for ACOE submittal
6		03-09-10	Revised Boulder
7		05-28-10	ACOE & MCSWCD Comments

Sheet Number
5 of 10

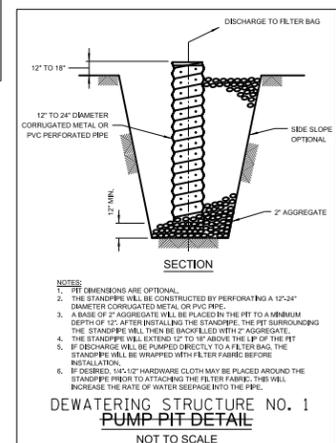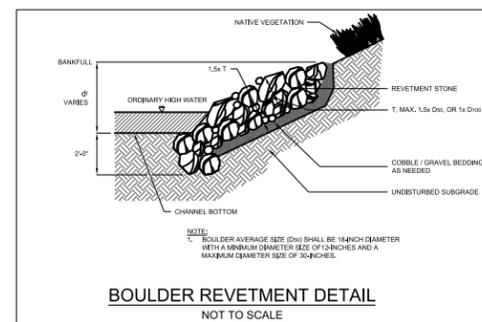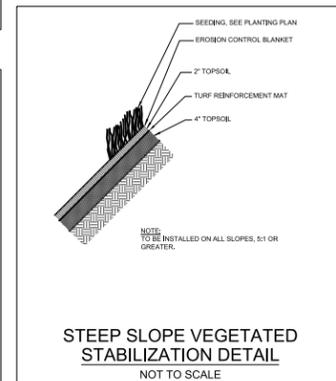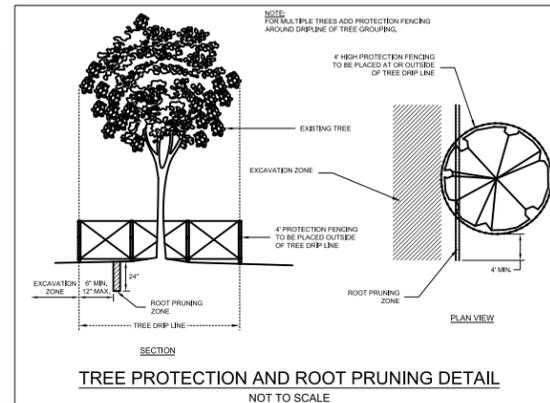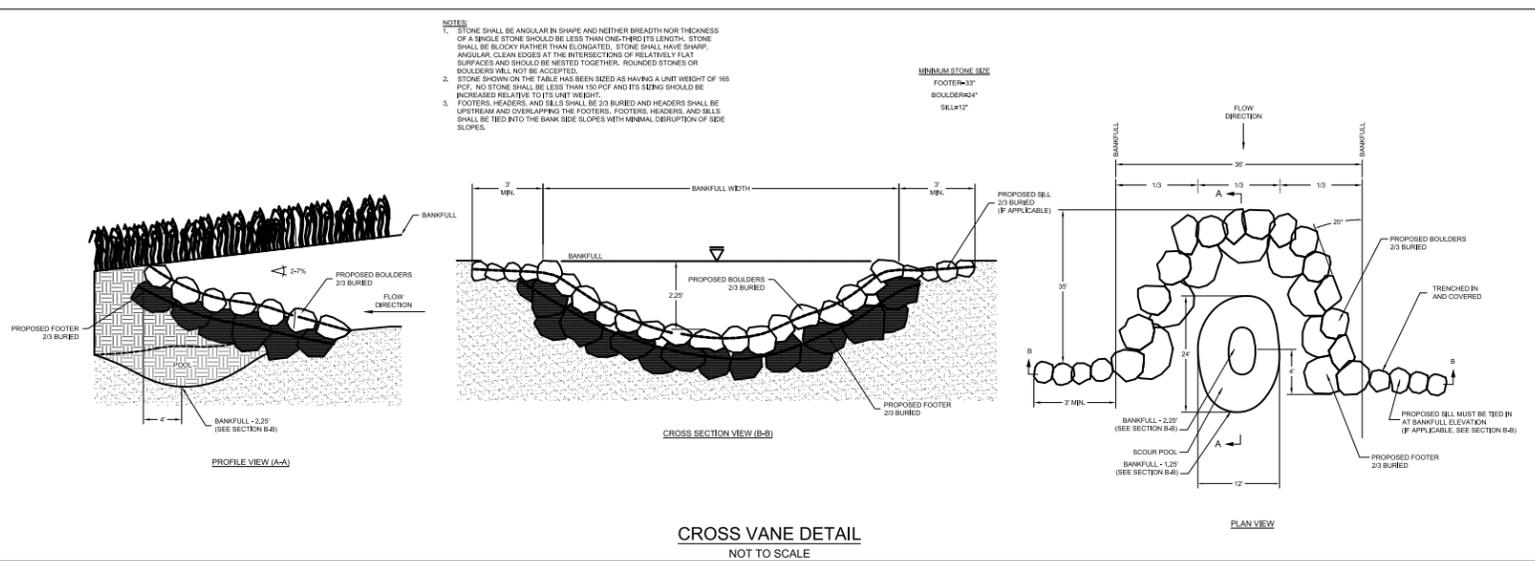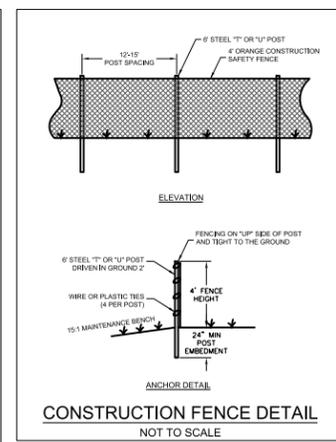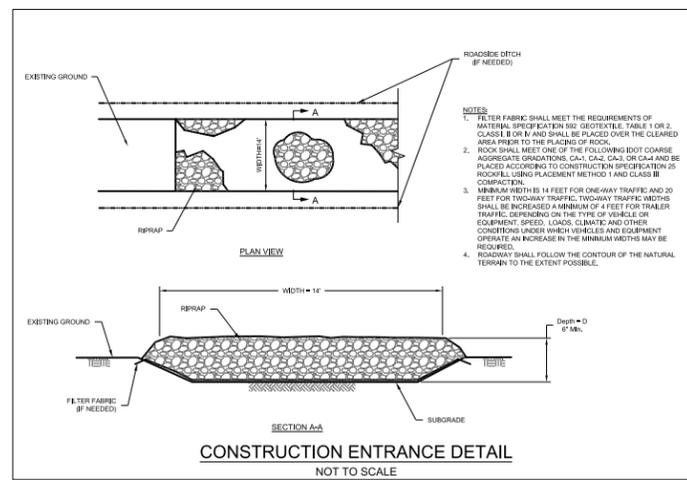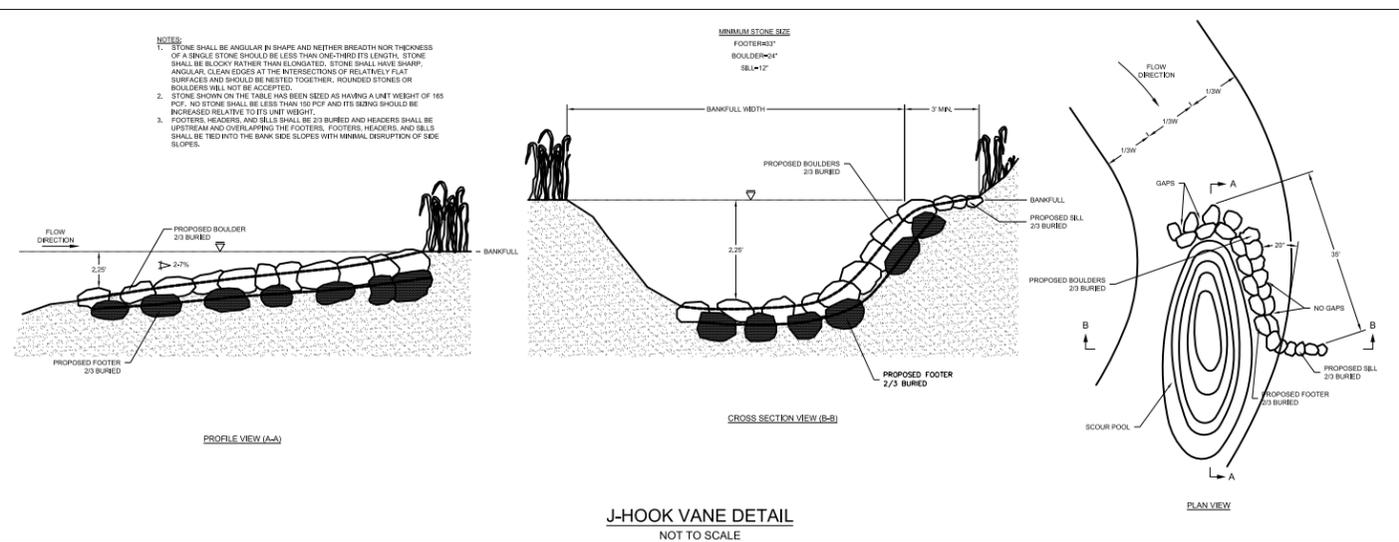

NOTES:
SEE STANDARD SPECIFICATIONS, SPECIAL PROVISIONS, AND STANDARD DETAILS FOR ADDITIONAL INFORMATION.

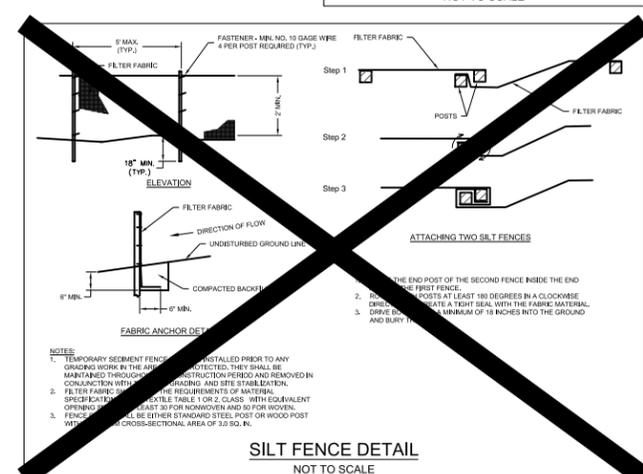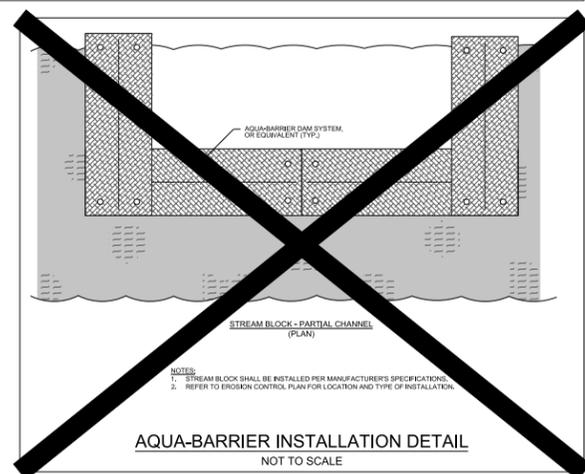

FILE NAME	USER NAME	DESIGNED	REVISED
...\\D160F72-sht-Towne Park-07.dgn	akw	AES	-
		AES	-
		AES	-
		-	-

STATE OF ILLINOIS
DEPARTMENT OF TRANSPORTATION

CRYSTAL CREEK RELOCATION PLANS

SCALE: AS NOTED SHEET NO. 5 OF 10 SHEETS STA. TO STA.

O.R. RTE.	SECTION	COUNTY	TOTAL SHEETS	SHEET NO.
0003	18A-2	MCHENRY	825	404
CONTRACT NO. 60F72				
FED. ROAD DIST. NO. 1 ILLINOIS FED. AID PROJECT				



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Construction Details & Cross Sections





Drawn By: t.e.g./EMK AES Project No.: 05-0198 (02-527)
Checked: WWS File Name: 020627/esd20100528_Details-2.dwg
Approved: GDP Date: 05-16-2003

Crystal Creek Realignment

Algonquin, Illinois
Village of Algonquin
125 Wilbrandt Street
Algonquin, Illinois 60102

Revisions:			
No.	By	Date	Description
2		12-11-03	Regulatory Comments
3		02-04-04	Village Comments
		11-30-09	CBBE Comments
5		02-26-10	Final AES review for ACOE submittal
6		03-09-10	Revised Typical Channel Sections
7		05-28-10	ACOE & MCSWCD Comments

Sheet Number
6 of 10

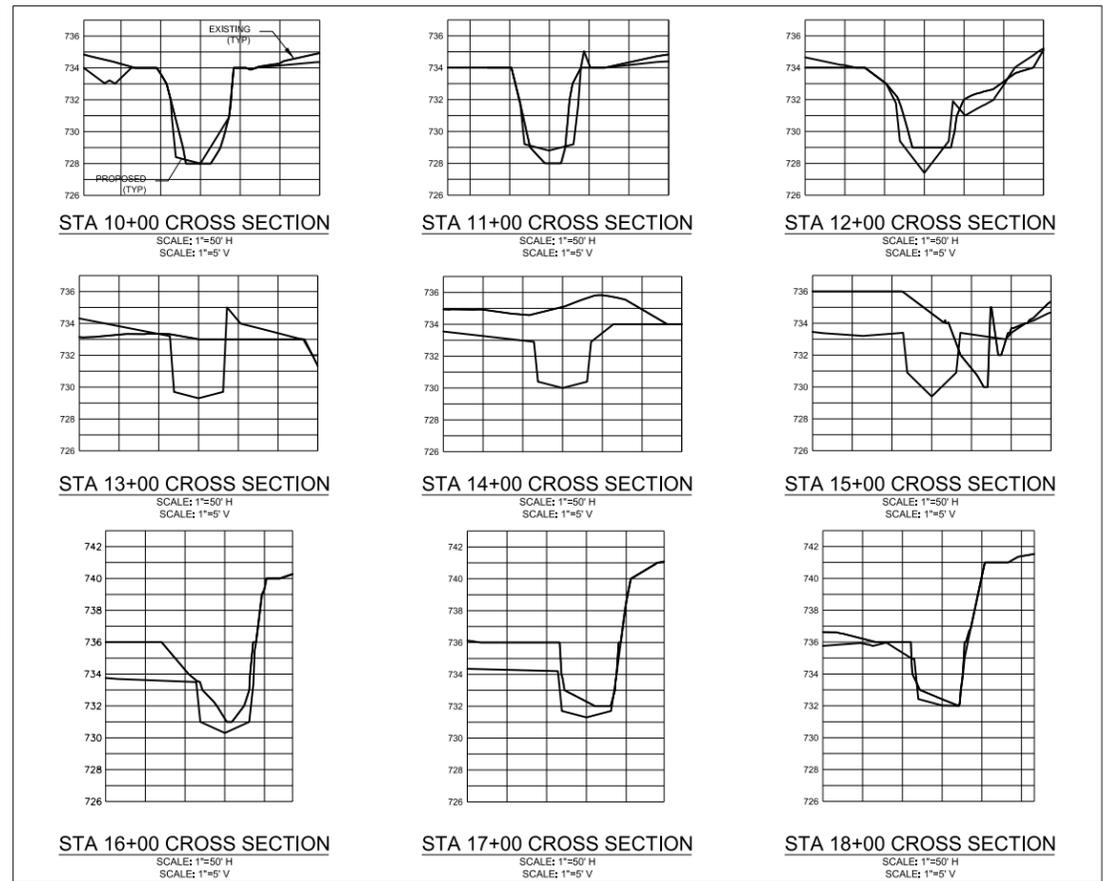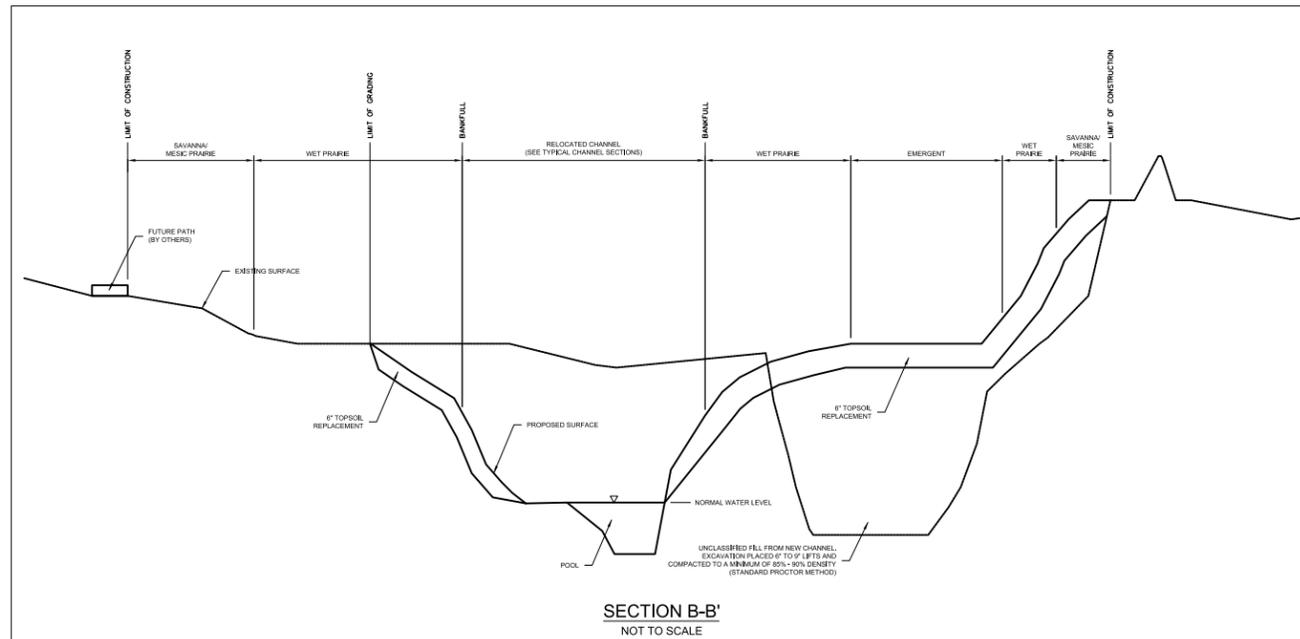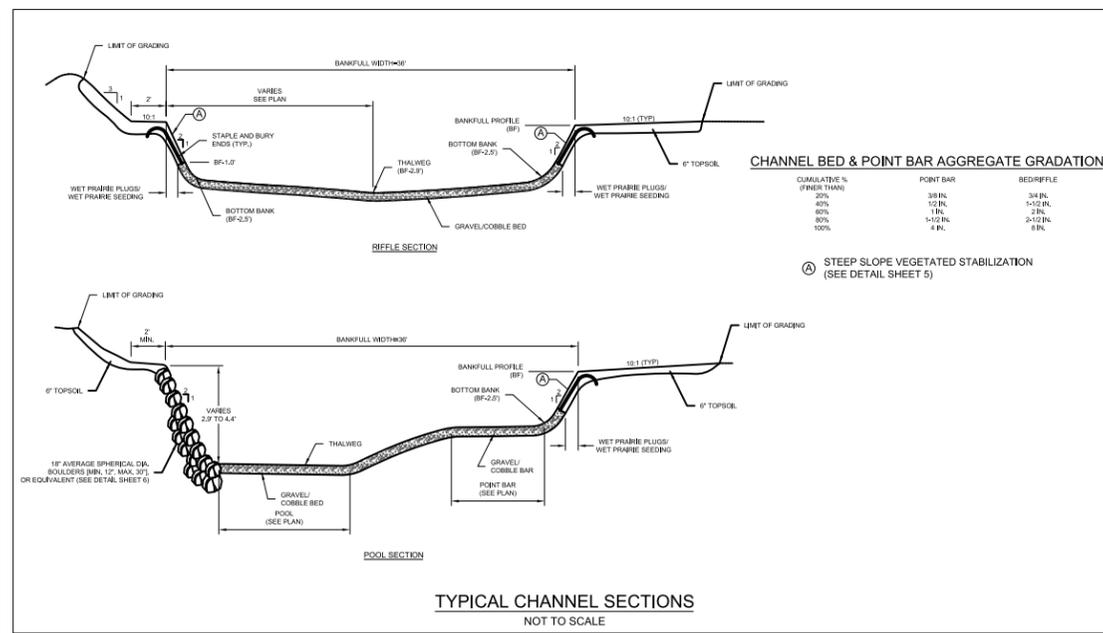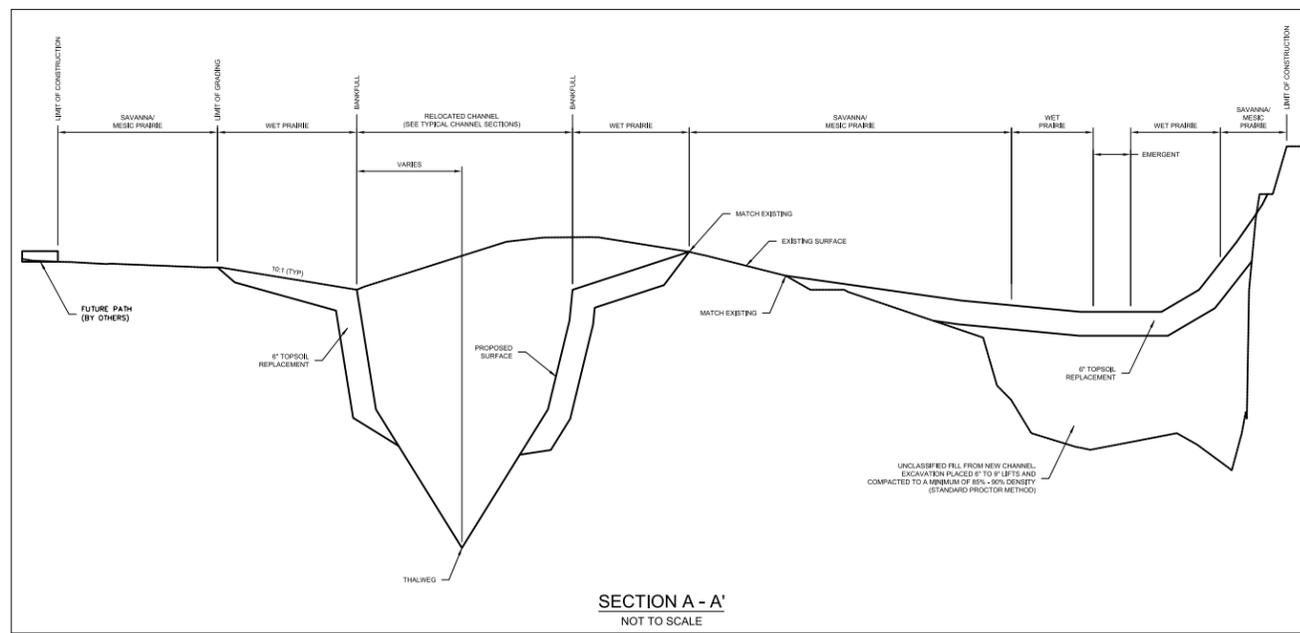

FILE NAME = ...\\D160F72-sht-Towne Park-08.dgn	USER NAME = akw	DESIGNED - AES	REVISED -
PLOT SCALE = 2.0000' / in.	CHECKED - AES	DRAWN - AES	REVISED -
PLOT DATE = 5/2/2012	DATE - 5/3/2012		REVISED -

STATE OF ILLINOIS
DEPARTMENT OF TRANSPORTATION

CRYSTAL CREEK RELOCATION PLANS

SCALE: AS NOTED SHEET NO. 6 OF 10 SHEETS STA. TO STA.

O.R. RTE.	SECTION	COUNTY	TOTAL SHEETS	SHEET NO.
0003	18A-2	MCHENRY	825	405
FED. ROAD DIST. NO. 1 ILLINOIS FED. AID PROJECT			CONTRACT NO. 60F72	



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Construction Notes & Specifications
Crystal Creek Realignment
 Algonquin, Illinois
 Village of Algonquin
 125 Wilbrandt Street
 Algonquin, Illinois 60102

Drawn By:	AES Project No.:	09-0198 (02-927)
Checked:	File Name:	020627es20100529_Notees2.dwg
Approved:	Date:	11-30-2009

PART 3. EXECUTION

3.1 METHOD

A. THE CONTRACTOR SHALL REMOVE AND DISPOSE OF OFF-SITE ALL WOODY SPECIES WITHIN THE CONSTRUCTION LIMITS AS DESIGNATED ON THE PLANS. WHERE GRADING IS PROPOSED AND IN ALL OTHER AREAS AS SPECIFIED ON THE PLANS AND IN ACCORDANCE WITH SECTION 201 OF THE BDOT SPECIFICATIONS.

B. TREES SHALL BE REMOVED BY CUTTING WITH HAND TOOLS INCLUDING, BUT NOT NECESSARILY LIMITED TO: GAS POWERED CHAIN SAWS, GAS POWERED CLEARING SAWS, BOW SAWS, AND LOPPERS.

C. THE PROJECT ECOLOGIST MUST BE CONTACTED TO DESIGNATE AREAS OF TREE REMOVAL PRIOR TO COMMENCEMENT OF ANY CLEARING; FAILURE TO DO SO RESULTING REMOVAL OF PROTECTED TREES MAY REQUIRE RECOMPENST THAT SHALL BE PROVIDED AT THE CONTRACTOR'S EXPENSE.

D. ALL STUMPS WITHIN THE GRADING LIMITS DESIGNATED ON THE PLAN FOR REMOVAL SHALL BE GRUBBED UNLESS IT IS DETERMINED BY THE CONTRACTOR AND APPROVED BY THE OWNER THAT SOME STUMPS CAN REMAIN. STUMPS TO REMAIN SHALL BE CUT TO WITHIN 3 INCHES OF SURROUNDING GRADE AND TREATED IMMEDIATELY WITH AN APPROVED HERBICIDE.

E. ALL CUT MATERIAL SHALL BE HAUL-TRUCKED TO A STAGING AREA FOR TEMPORARY STOCKPILE, THEN DISPOSED OF OFF-SITE. NO PILES SHALL REMAIN ON-SITE AT THE END OF EACH WORK DAY.

F. REMOVAL OF UNDESIRABLE WOODY SPECIES SHALL PREFERENTIALLY OCCUR WHEN THE GROUND IS FROZEN.

G. THE CONTRACTOR SHALL ROOT PRUNE TREES DESIGNATED TO REMAIN. ROOT PRUNING SHALL CONFORM TO THE OWNER'S SPECIFICATIONS.

H. ROOT PRUNING SHALL BE MADE TO A DISTANCE OF 4 FEET BEYOND THE TREE'S DRAIN LINE. ALL ROOT PRUNING CUTS SHALL BE MADE TO A DEPTH OF 16 TO 24 INCHES AND BE PLACED 6 TO 12 INCHES CLOSER TO THE TREE THAN THE CONSTRUCTION LIMIT. THIS ALLOWS FOR ROOT REGENERATION WITHIN THE 6 TO 12 INCH AREA DURING THE CONSTRUCTION PERIOD. TRENCHES FORMED BY THIS PROCEDURE SHALL BE BACKFILLED THE SAME DAY UTILIZING THE SOIL REMOVED DURING THE OPERATION AND THE BACKFILL MATERIAL LIGHTLY TAMPED DOWN. ROOT PRUNING CUTS MADE AT THE CONSTRUCTION LIMIT IS NOT PERMITTED BECAUSE THE CUT SURFACES OF THE ROOT REMAIN EXPOSED TO THE AIR, WHOSE GAUGES DISEMPOW FROM THIS POINT.)

I. CONSTRUCTION ACTIVITY AND STORAGE OF MATERIALS OR EXCAVATION SPILLS ARE NOT PERMITTED WITHIN THE 6 TO 12 INCH AREA OF ANY ROOT PRUNING CUT. FAILURE TO COMPLY WILL REQUIRE THE CONTRACTOR TO INSTALL PROTECTIVE FENCING ALONG THE ROOT PRUNING CUTS THROUGHOUT THE PROJECT.

J. A SUPPLY OF CHEMICAL ABSORBENT SHALL BE MAINTAINED AT THE PROJECT SITE. ANY CHEMICAL SPILLS SHALL BE PROPERLY CLEANED UP AND REPORTED TO THE OWNER WITHIN 24 HOURS.

K. THE CONTRACTOR SHALL MAINTAIN COPIES AT THE PROJECT SITE OF ALL CURRENT PESTICIDE APPLICATOR'S LICENSES, HERBICIDE LABELS, AND MSDS'S (MATERIAL SAFETY DATA SHEETS) FOR ALL CHEMICALS UTILIZED DURING CONSTRUCTION OF THE WORK.

3.2 CLEAN-UP, REMOVAL AND REPAIR

A. CLEAN UP: THE WORK AREA SHALL BE KEPT FREE OF DEBRIS BY THE CONTRACTOR. AT NO TIME SHALL TRASH OR OTHER MATERIAL BE ALLOWED TO ACCUMULATE AT THE PROJECT SITE. ALL TOOLS SHALL BE KEPT IN APPROPRIATE CARRYING GASES, TOOL BOXES, ETC. PARKING AREAS, ROADS, SIDEWALKS, PATHS, TRAILS, AND PAVED AREAS SHALL BE KEPT FREE OF MUD AND DIRT.

B. REMOVAL: AFTER WORK HAS BEEN COMPLETED REMOVE TOOLS AND ALL OTHER DEBRIS GENERATED BY THE CONTRACTOR.

C. REPAIR: THE CONTRACTOR SHALL REPAIR ANY DAMAGES THAT OCCURRED DURING COMPLETION OF THE WORK DESCRIBED IN THIS SECTION. SAID DAMAGES MAY INCLUDE, BUT ARE NOT LIMITED TO: TIRE RUTS IN THE GROUND, DAMAGE TO PLANTED AREAS, DAMAGE TO TRAILS, ETC. ALL AREAS DAMAGED BY THE CONTRACTOR DURING THE EXECUTION OF THIS WORK SHALL BE REPAIRED BY CONTRACTOR AND RESTORED TO THE CONDITIONS SHOWN ON THE PLANS AT NO ADDITIONAL COST TO THE OWNER. ALL AREAS OUTSIDE OF THE CONSTRUCTION LIMITS DISTURBED BY CONSTRUCTION SHALL BE RESTORED TO PRE-CONSTRUCTION GRADES AND STABILIZED WITH TURF, EXCEPT WHERE DESIGNATED OTHERWISE ON THE PLANNING PLAN.

3.3 INSPECTION

A. AFTER COMPLETION OF SELECTIVE TREE REMOVAL, THE CONTRACTOR SHALL SCHEDULE WITH THE OWNER A PROVISIONAL ACCEPTANCE INSPECTION OF THE WORK.

3.4 ACCEPTANCE AND GUARANTEE

A. FINAL ACCEPTANCE: THE WORK SHALL BE CONSIDERED 100% COMPLETE AFTER FINAL TREE REMOVAL IS COMPLETED, AND THE CONTRACTOR HAS COMPLETED ALL CLEAN-UP, REMOVAL, AND REPAIR AS DESCRIBED IN 3.2 OF THIS SECTION.

GRADING

PART 1. GENERAL

CLEARING AND REMOVAL OF ALL UNDESIRABLE TREES AND OTHER VEGETATIVE GROWTH WITHIN THE CONSTRUCTION AREA SHALL BE AS DESIGNATED BY THE PLANS AND THE PROJECT ECOLOGIST. IF ADEQUATE AND APPROPRIATE SPACE IS NOT AVAILABLE ON SITE FOR REMOVED TREES AND OTHER VEGETATIVE GROWTH, THEY SHALL BE DISPOSED OFF-SITE. NO BURNING SHALL BE PERMITTED ON SITE. THE CONTRACTOR SHALL COMPLY WITH LOCAL TREE ORDINANCES.

TREES AND SHRUBS DESIGNATED TO BE SAVED SHALL BE PROTECTED BY PLACING HIGHLY VISIBLE CONSTRUCTION FENCING ALONG THEIR DRIP LINES. TREES DESIGNATED FOR RELOCATION AND/OR TEMPORARILY STORED FOR TRANSPLANTING SHALL BE PROTECTED IN THE SAME MANNER. WHERE REQUIRED BY OWNER, TRUNKS OF DESIGNATED TREES SHALL BE PROTECTED WITH STRAPPED 2" X 6" PLANKING FROM THE BASE TO A HEIGHT OF EIGHT FEET.

TOPSOIL SHALL BE STOCKPILED AS DIRECTED BY THE OWNER. TOPSOIL STOCKPILED FOR FUTURE USE SHALL BE RELATIVELY FREE OF LARGE ROOTS, STONKS, WEEDS, BRUSH, STONES LARGER THAN ONE ONE-INCH DIAMETER, OR OTHER LITTER AND WASTE PRODUCTS INCLUDING EXTRANEOUS MATERIALS NOT CONDUCE TO PLANT GROWTH.

MATERIALS SHALL BE STOCKPILED IN SEQUENCE TO MINIMIZE REHANDLING. FAILURE TO PROPERLY SEQUENCE THE STOCKPILE OPERATIONS SHALL NOT CONSTITUTE A CLAIM FOR ADDITIONAL COMPENSATION. NO MATERIAL SHALL BE STOCKPILED IN RESIDENTIAL AREAS, DRINKING WATER FLOOD ROUTING AREAS, WETLANDS, PROPOSED UTILITY LOCATIONS, UTILITY EASEMENTS OR RIGHTS-OF-WAY. ABSOLUTELY NO MATERIALS WILL BE STOCKPILED OR DISPOSED UNDER THE CANOPIES OF TREES DESIGNATED FOR PROTECTION.

UNSATURABLE MATERIALS SHALL BE REMOVED FROM ROADWAY, DRIVEWAY/PARKING, AND OTHER DESIGNATED AREAS AND DISPOSED OF OFF-SITE UPON COMPLETION OF MASS GRADING.

DEMOLITION AND REMOVAL OF EXISTING MATERIALS INCLUDING OFF-SITE DISPOSAL OF SAME SHALL BE AT A LEGAL DISPOSAL SITE SELECTED BY THE CONTRACTOR. ON-SITE DISPOSAL WILL ONLY BE ALLOWED IF EXPRESSLY APPROVED BY THE OWNER IN WRITING.

CLAY CUT AND FILL SHALL INCLUDE COMPACTION WITHIN ROADWAYS, TRAILS, DRIVEWAY/PARKING AREAS, BUILDING PADS, AND OTHER DESIGNATED AREAS. PLACEMENT AND COMPACTION OF CLAY SHALL BE PROVIDED AS SPECIFIED IN THE BDOT SPECIFICATIONS TO THE DESIGN SUBGRADE ELEVATIONS. THE CONTRACTOR WILL NOTE THAT THE ELEVATIONS SHOWN ON THE PLANS ARE FINISHED GRADE ELEVATIONS AND THAT FINEMENT, TOPSOIL REPLACEMENT, AND SOIL STABILIZATION TECHNIQUE THICKNESS MUST BE SUBTRACTED TO DETERMINE SUBGRADE ELEVATIONS. FINAL SHAPING AND TRIMMING TO THE LINES, GRADES, AND GROSS SECTIONS SHOWN ON THE PLANS SHALL BE TO DESIGN FINISHED GRADE ELEVATIONS.

THE QUANTITIES GIVEN IN THE ENGINEER'S SUMMARY FOR EARTHWORK ARE INTENDED AS A GUIDE FOR THE CONTRACTOR IN DETERMINING SCOPE OF THE COMPLETED PROJECT. IT IS THE CONTRACTOR'S RESPONSIBILITY TO DETERMINE ALL MATERIAL QUANTITIES HIMSELF AND APPRAISE ALL SITE CONDITIONS. THE CONTRACT PRICE SUBMITTED BY THE CONTRACTOR SHALL BE CONSIDERED AS LUMP SUM FOR THE COMPLETE PROJECT. NO CLAIMS FOR EXTRA WORK WILL BE RECOGNIZED UNLESS ORDERED IN WRITING BY THE OWNER.

PRIOR TO ONSET OF MASS GRADING OPERATIONS AND, IF INCLUDED IN THIS CONTRACT, THE EARTH WORK CONTRACTOR SHALL FAMILIARIZE HIMSELF WITH THE SOIL EROSION CONTROL SPECIFICATIONS, THE INITIAL ESTABLISHMENT OF EROSION CONTROL PROCEDURES AND THE PLACEMENT OF FILTERS, FENCING, ETC. TO PROTECT ADJACENT PROPERTY SHALL OCCUR BEFORE MASS GRADING BEGINS AND IN ACCORDANCE WITH THE SOIL EROSION CONTROL CONSTRUCTION SCHEDULE.

THE GRADING OPERATIONS ARE TO BE CLOSELY SUPERVISED AND INSPECTED BY THE SOILS ENGINEER OR HIS REPRESENTATIVE PARTICULARLY DURING THE REMOVAL OF UNSATURABLE MATERIAL AND THE CONSTRUCTION OF EMBANKMENTS. ALL TESTING, INSPECTION, AND OTHER SOIL RELATED OPERATIONS SHALL BE ENTIRELY THE RESPONSIBILITY OF THE SOILS ENGINEER.

A QUALIFIED SOILS ENGINEER SHALL REGULARLY INSPECT THE EXCAVATION OF STORMWATER TREATMENT AREAS TO ENSURE THAT THEY ARE CAPABLE OF MAINTAINING DESIGNED WATER LEVELS. GRAVEL OR SAND SEAMS OR OTHER CONDITIONS WHICH MAY BE ENCOUNTERED SHALL BE REVIEWED BY THE SOILS ENGINEER FOR COMPATIBILITY WITH THE DESIGN INTENT.

THE PROPOSED GRADING ELEVATIONS SHOWN ON THE PLANS ARE FINISHED GRADE. A MINIMUM OF SIX INCHES OF TOPSOIL IS TO BE PLACED BEFORE FINISHED GRADE ELEVATIONS ARE ACHIEVED WITH PLANTING AREAS.

STRUCTURAL FILL MATERIAL SHALL BE PLACED IN LEVEL, UNIFORM LAYERS SO THAT THE COMPACTED THICKNESS IS APPROXIMATELY SIX (6) INCHES. IF COMPACTION EQUIPMENT DEMONSTRATES THE ABILITY TO COMPACT A GREATER THICKNESS, AS DETERMINED BY SOIL ENGINEER, THEN A MAXIMUM THICKNESS OF NINE (9) INCHES MAY BE SPECIFIED. EACH LAYER SHALL BE THOROUGHLY MIXED DURING SPREADING TO ENSURE UNIFORMITY.

EM BANKMENT MATERIAL WITHIN ROADWAY, DRIVEWAY/PARKING AREAS, AND OTHER STRUCTURAL CLAY FILL AREAS SHALL BE COMPACTED TO A MINIMUM OF NINETY-FIVE PERCENT (95%) OF MODIFIED PROCTOR DENSITY (ASTM D-1557), OR TO SUCH DENSITY AS MAY BE DETERMINED APPROPRIATE BY THE SOILS ENGINEER.

EM BANKMENT FILL WITH NON-STRUCTURAL MATERIALS APPROVED BY THE SOIL ENGINEER SHALL BE COMPACTED EIGHTY PERCENT (80%) TO EIGHTY-FIVE (85%) STANDARD PROCTOR DENSITY (ASTM D-690); OR TO SUCH DENSITY AS MAY BE DETERMINED APPROPRIATE BY THE SOIL ENGINEER. REPEATED USE OF TRACKED EQUIPMENT OVER AREA SHOULD BE ADEQUATE TO ACHIEVE THE REQUIRED DENSITY.

EM BANKMENT FILL FOR STREAM CONSTRUCTION SHALL BE COMPACTED EIGHTY PERCENT (80%) TO EIGHTY-FIVE (85%) STANDARD PROCTOR DENSITY (ASTM D-690) ON BANKS ABOVE THE BANK PROTECTION AND EIGHTY-FIVE (85%) TO NINETY PERCENT (90%) STANDARD PROCTOR DENSITY ON THE STREAM BED AND LOWER FOOT OF THE BANK. OR TO SUCH DENSITIES AS MAY BE DETERMINED APPROPRIATE BY THE SOIL ENGINEER.

THE SURFACE VEGETATION, TOPSOIL, AND ANY OBVIOUSLY SOFT UNDERLYING SOIL SHALL BE STRIPPED FROM ALL AREAS TO RECEIVE CLAY FILL. IF THE UNDERLYING SUBGRADE SOILS RUF DEEPER THAN ONE INCH UNDER CONSTRUCTION EQUIPMENT OR IF THE MOISTURE CONTENT EXCEEDS THAT NEEDED FOR PROPER COMPACTION, THE SOIL SHALL BE SCARIFIED, DRIED, AND RECOMPACTED TO THE REQUIRED SPECIFICATIONS.

PRIOR TO UTILITY CONSTRUCTION, PROPOSED GRADING AREAS SHALL BE ROUGH GRADED BY THE CONTRACTOR TO PLUS OR MINUS ONE FOOT OF DESIGN ELEVATIONS.

UPON COMPLETION OF THE SURFACE GRADING IMPROVEMENTS, THE CONTRACTOR SHALL RESPAAD A SIX INCH LAYER OF TOPSOIL ON ALL PLANTING AREAS.

RIP-RAP MATERIAL, AGGREGATE MATERIAL, AND ASSOCIATED GEOTEXTILE FILTERS SHALL CONFORM TO SECTIONS 210, 281, 1003, 1004, 1005, AND 1086 OF THE BDOT SPECIFICATIONS.

SOIL BORING REPORT, AVAILABLE AT THE OFFICES OF THE ENGINEER AND THE OWNER, ARE SOLELY FOR THE INFORMATION AND GUIDANCE OF THE ENGINEER, OWNER, AND CONTRACTOR. THE ENGINEER MAKES NO REPRESENTATION OR WARRANTY REGARDING THE INFORMATION CONTAINED IN THE SOIL BORING REPORT. THE CONTRACTOR SHALL MAKE HIS OWN INVESTIGATIONS AND SHALL PLAN HIS WORK ACCORDINGLY. ARRANGEMENTS TO ENTER THE PROJECT SITE DURING THE BIDDING PHASE MAY BE MADE UPON REQUEST OF THE OWNER. THERE WILL BE NO ADDITIONAL PAYMENT FOR EXPENSES INCURRED BY THE CONTRACTOR RESULTING FROM ADVANCE SOIL OR GROUND WATER CONDITIONS.

SOIL PREPARATION

1.1 DESCRIPTION

A. GRADING SHALL INCLUDE ALL CLEARING, GRUBBING, REMOVAL OF WALLS, FOUNDATIONS, AND OTHER STRUCTURAL ELEMENTS WITHIN THE LIMITS OF CONSTRUCTION; EXCAVATION STOCKPILES AND REPLACEMENT, TOPSOIL, EXCAVATION, STOCKPILE AND REPLACEMENT, ROCK AND COBBLE REMOVAL, STOCKPIILING AND REPLACEMENT CONSTRUCTION AS SHOWN ON THE PLANS, DETAILED IN THESE SPECIFICATIONS, AND IN ACCORDANCE WITH SECTIONS 202 THROUGH 214, 282, AND 1086 OF THE BDOT SPECIFICATIONS.

1.2 RELATED SECTIONS

A. TEMPORARY EROSION CONTROL, TEMPORARY BARRIER FENCING, SLOPE PROTECTION CONSTRUCTION, COVER CROP SEEDING, SEEDING.

1.3 QUALITY ASSURANCE

A. QUALIFICATIONS OF WORKMEN: PROVIDE AT LEAST ONE PERSON WHO SHALL BE PRESENT AT ALL TIMES DURING EXECUTION OF THIS PORTION OF THE WORK AND WHO SHALL BE THOROUGHLY FAMILIAR WITH THE TYPE AND OPERATION OF EQUIPMENT BEING USED. SAID PERSON SHALL DIRECT ALL WORK PERFORMED UNDER THIS SECTION.

B. STANDARDS: ALL MATERIALS, EQUIPMENT, AND PROCEDURES USED DURING THIS PORTION OF THE WORK SHALL MEET OR EXCEED APPLICABLE FEDERAL, STATE, COUNTY AND LOCAL LAWS AND REGULATIONS.

1.4 SUBMITTALS

A. MATERIALS: THE CONTRACTOR SHALL SUBMIT TO THE OWNER FOR APPROVAL A COMPLETE LIST OF ALL MATERIALS TO BE USED DURING THIS PORTION OF THE WORK PRIOR TO DELIVERY OF ANY MATERIALS TO THE SITE, INCLUDE COMPLETE DATA ON SOURCE, AMOUNT AND QUALITY. THIS SUBMITTAL SHALL IN NO WAY BE CONSTRUED AS PERMITTING SUBSTITUTION FOR SPECIFIC ITEMS DESCRIBED ON THE PLANS OR IN THESE SPECIFICATIONS UNLESS APPROVED IN WRITING BY THE OWNER.

B. EQUIPMENT: THE CONTRACTOR SHALL PROVIDE A LIST OF EQUIPMENT AND A DESCRIPTION AND LOCATION OF ITS INTENDED USE, AND A LIST OF SAID PERSONS PERFORMING THE WORK AND THEIR QUALIFICATIONS FOR OPERATING AND MAINTAINING THE LISTED EQUIPMENT.

C. AFTER THE WORK IS COMPLETED THE CONTRACTOR SHALL SUBMIT TO THE OWNER RECORD DRAWINGS, THE CONTRACTOR SHALL MARK IN RED INK ON THE ORIGINAL PLANS ANY FIELD CHANGES OR DEVIATIONS FROM THE ORIGINAL PLANS.

PART 2. PRODUCTS

2.1 MATERIALS

A. TOPSOIL SHALL BE SUITABLE ORGANIC SOIL OBTAINED FROM ON-SITE SOURCES OR AS APPROVED BY THE OWNER. ALL TOPSOIL SHALL BE APPROVED BY THE OWNER BEFORE USE.

B. UNCLASSIFIED EXCAVATION SHALL CONSIST OF SOIL WHICH IS NOT TOPSOIL, GRAVEL OR COBBLE.

C. GRAVEL AND COBBLE TO BE PLACED IN RECONSTRUCTED OR STABILIZED CREEK CHANNEL AREAS SHALL BE ROCK MATERIAL FOUND IN THE BED OF THE EXISTING CHANNEL AND AS SIZED PER THE PLAN.

2.2 RELATED SECTIONS

A. GRADING AND SEEDING.

2.3 QUALITY ASSURANCE

A. QUALIFICATIONS OF WORKMEN: PROVIDE AT LEAST ONE PERSON WHO SHALL BE PRESENT AT ALL TIMES DURING EXECUTION OF THIS PORTION OF THE WORK WHO SHALL BE THOROUGHLY FAMILIAR WITH THE TYPE AND OPERATION OF EQUIPMENT BEING USED. SAID PERSON SHALL DIRECT ALL WORK PERFORMED UNDER THIS SECTION.

B. STANDARDS: ALL MATERIALS, EQUIPMENT, AND PROCEDURES USED DURING THIS PORTION OF THE WORK SHALL MEET OR EXCEED APPLICABLE FEDERAL, STATE, COUNTY AND LOCAL LAWS AND REGULATIONS.

2.4 SUBMITTALS

A. EQUIPMENT: THE CONTRACTOR SHALL PROVIDE A LIST OF EQUIPMENT AND A DESCRIPTION AND LOCATION OF ITS INTENDED USE, AND A LIST OF SAID PERSONS PERFORMING THE WORK AND THEIR QUALIFICATIONS FOR OPERATING AND MAINTAINING THE LISTED EQUIPMENT.

PART 3. EXECUTION

3.1 METHOD

A. PRIOR TO SEEDING AND PLANTING, CONTRACTOR SHALL CHECK COMPACTION OF TOPSOIL (0-6" DEPTH) AND NORMAL SUBSOIL DEPTH (6-12" DEPTH). A 150 LB. PERSON SHOULD LEAVE NO GREATER THAN A 1/4" DEEP FOOTPRINT.

B. PRIOR TO SEEDING AND PLANTING, AREAS DISTURBED BY CONSTRUCTION VEHICLES AND TRAFFIC SHALL BE RESTORED TO GRADE, RAKED, AND CHECKED FOR COMPACTION AS IN 3.1.A.

C. PRIOR TO SEEDING AND PLANTING, AREAS NOT REGRADED AND CONTAINING TURF, OLD FILL, OR OTHER NON-NATIVE HERBACEOUS VEGETATION SHALL BE HERICIDED TWICE (2X) AND DISCED ONCE (1X) BETWEEN HERBICIDE TREATMENTS TO PREPARE THE AREAS FOR SEEDING. SEEDING AND PLANTING SHALL BE DONE NO SOONER THAN 2 WEEKS AFTER THE LAST HERBICIDE TREATMENT.

3.2 CLEAN-UP, REMOVAL AND REPAIR

A. CLEAN UP: THE WORK AREA SHALL BE KEPT FREE OF DEBRIS BY THE CONTRACTOR. AT NO TIME SHALL TRASH OR OTHER MATERIAL BE ALLOWED TO ACCUMULATE AT THE PROJECT SITE. ALL TOOLS SHALL BE KEPT IN APPROPRIATE CARRYING GASES, TOOL BOXES, ETC. PARKING AREAS, ROADS, SIDEWALKS, PATHS, TRAILS, AND PAVED AREAS SHALL BE KEPT FREE OF MUD AND DIRT.

B. REMOVAL: AFTER WORK HAS BEEN COMPLETED REMOVE TOOLS AND ALL OTHER DEBRIS GENERATED BY THE CONTRACTOR.

C. REPAIR: THE CONTRACTOR SHALL REPAIR ANY DAMAGES THAT OCCURRED DURING COMPLETION OF THE WORK DESCRIBED IN THIS SECTION. SAID DAMAGES MAY INCLUDE, BUT ARE NOT LIMITED TO: TIRE RUTS IN THE GROUND, DAMAGE TO PLANTED AREAS, DAMAGE TO TRAILS, ETC. ALL AREAS DAMAGED BY THE CONTRACTOR DURING THE EXECUTION OF THIS WORK SHALL BE REPAIRED BY CONTRACTOR AND RESTORED TO THE CONDITIONS SHOWN ON THE PLANS AT NO ADDITIONAL COST TO THE OWNER. ALL AREAS OUTSIDE OF THE CONSTRUCTION LIMITS DISTURBED BY CONSTRUCTION SHALL BE RESTORED TO PRE-CONSTRUCTION GRADES AND STABILIZED WITH APPROPRIATE SEED OR PLANTINGS.

3.3 INSPECTION

A. AFTER COMPLETION OF SEEDING, THE CONTRACTOR SHALL SCHEDULE WITH OWNER A PROVISIONAL ACCEPTANCE INSPECTION OF THE WORK.

3.4 ACCEPTANCE AND GUARANTEE

A. PROVISIONAL ACCEPTANCE: THE WORK SHALL BE CONSIDERED 90% COMPLETE AFTER ALL COVER CROP SEED HAS BEEN INSTALLED, AND THE CONTRACTOR HAS COMPLETED ALL CLEAN-UP, REMOVAL, AND REPAIR AS DESCRIBED IN 3.2 OF THIS SECTION.

B. FINAL ACCEPTANCE: THE WORK SHALL BE CONSIDERED 100% COMPLETE AFTER THE CONTRACTOR HAS COMPLETED ALL CLEAN-UP, REMOVAL, AND REPAIR AS DESCRIBED IN 3.5 OF THIS SECTION.

COVER CROP SEEDING

3.3 INSPECTION

A. AFTER COMPLETION OF SOIL PREPARATION, THE CONTRACTOR SHALL SCHEDULE WITH THE OWNER A FINAL ACCEPTANCE INSPECTION OF SOIL PREPARATION.

3.4 ACCEPTANCE

A. FINAL ACCEPTANCE: THIS PORTION OF THE WORK SHALL BE CONSIDERED 100% COMPLETE AFTER THE CONTRACTOR HAS COMPLETED SOIL PREPARATION, AND COMPLETED ALL REQUIRED CLEAN UP AS DESCRIBED IN 3.2 OF THIS SECTION.

PART 1. GENERAL

1.1 DESCRIPTION

A. THIS SECTION INCLUDES INSTALLATION OF COVER CROP SEED IN ANY AREA OF DISTURBED SOIL, INCLUDING TEMPORARY CONSTRUCTION ACCESS AND CONSTRUCTION TRAFFIC AREAS, IMMEDIATELY FOLLOWING THE DISTURBANCE AND PRIOR TO SEEDING.

1.2 RELATED SECTIONS

A. SOIL PREPARATION AND SEEDING.

1.3 QUALITY ASSURANCE

A. QUALIFICATIONS OF WORKMEN: PROVIDE AT LEAST ONE PERSON WHO SHALL BE PRESENT AT ALL TIMES DURING EXECUTION OF THIS PORTION OF THE WORK WHO SHALL BE THOROUGHLY FAMILIAR WITH THE TYPE AND OPERATION OF EQUIPMENT BEING USED. SAID PERSON SHALL DIRECT ALL WORK PERFORMED UNDER THIS SECTION.

B. STANDARDS: ALL MATERIALS AND METHODS USED DURING THIS PORTION OF THE WORK SHALL MEET OR EXCEED APPLICABLE FEDERAL, STATE, COUNTY AND LOCAL LAWS AND REGULATIONS. ALL SEED SHALL BE FREE FROM INSECTS AND DISEASE. SPECIES SHALL BE TRUE TO THEIR SCIENTIFIC NAME AS SPECIFIED.

1.4 SUBMITTALS

A. MATERIALS: THE CONTRACTOR SHALL SUBMIT TO THE OWNER FOR APPROVAL A COMPLETE LIST OF ALL MATERIALS TO BE USED DURING THIS PORTION OF THE WORK PRIOR TO DELIVERY OF ANY MATERIALS TO THE SITE, INCLUDE COMPLETE DATA ON SOURCE, AMOUNT AND QUALITY. THIS SUBMITTAL SHALL IN NO WAY BE CONSTRUED AS PERMITTING SUBSTITUTION FOR SPECIFIC ITEMS DESCRIBED ON THE PLANS OR IN THESE SPECIFICATIONS UNLESS APPROVED IN WRITING BY THE OWNER.

B. EQUIPMENT: THE CONTRACTOR SHALL PROVIDE A LIST OF EQUIPMENT AND A DESCRIPTION AND LOCATION OF ITS INTENDED USE, AND A LIST OF SAID PERSONS PERFORMING THE WORK AND THEIR QUALIFICATIONS FOR OPERATING AND MAINTAINING THE LISTED EQUIPMENT.

PART 2. PRODUCTS

2.1 MATERIALS

A. ALL GRASS SPECIES SHALL BE SUPPLIED AS PURE LIVE SEED.

B. STRAW OR HAY FOR EROSION CONTROL SHALL BE CLEAN, SEED-FREE HAY OR THRESHED STRAW OF WHEAT, RYE, OATS, OR BARLEY.

PART 3. EXECUTION

3.1 METHOD

A. IF PLANTED IN SPRING, SEEDS SHALL HAVE PROPER STRATIFICATION AND/OR SCARIFICATION TO BREAK SEED DORMANCY.

B. SEEDING SHALL BE PREFERENTIALLY INSTALLED WITH A HANGELAND TYPE GRAM DRILL OR NO-TILL PLANTER, SUCH AS BY TRIAX, OR EQUIVALENT AS APPROVED IN WRITING BY THE OWNER.

C. IF SOIL IS TOO WET OR GRADE IS TOO STEEP TO INSTALL, SEED AS DESCRIBED IN 3.1B, A MECHANICAL BROADCAST SEEDER, SUCH AS BY CYCLONE, SHALL BE USED. HAND BROADCASTING OF SEED MAY ALSO BE EMPLOYED, WITHIN 24 HOURS, OR AS SOON AS SITE CONDITIONS PERMIT. BROADCAST SEEDED AREAS SHALL BE ROLLED, BUT SOIL SHALL BE LIGHTLY TILLED BEFOREHAND.

D. CRIMP 2,500 POUNDS PER ACRE OF STRAW FOR EROSION CONTROL ONTO SLOPES GREATER THAN ONE FOOT HORIZONTAL TO FIVE FOOT VERTICAL (1:5) IMMEDIATELY FOLLOWING SEEDING.

E. IF AREA TO BE SEEDED WAS TREATED WITH HERBICIDE, SEEDING SHALL OCCUR NO LESS THAN 14 DAYS AFTER HERBICIDE APPLICATION.

F. COVER CROP SHALL NOT BE INSTALLED WITHIN AREAS DESIGNATED FOR TURF GRASS.

3.2 CLEAN-UP, REMOVAL AND REPAIR

A. CLEAN UP: THE WORK AREA SHALL BE KEPT FREE OF DEBRIS BY THE CONTRACTOR. AT NO TIME SHALL TRASH OR OTHER MATERIAL BE ALLOWED TO ACCUMULATE AT THE PROJECT SITE. ALL TOOLS SHALL BE KEPT IN APPROPRIATE CARRYING GASES, TOOL BOXES, ETC. PARKING AREAS, ROADS, SIDEWALKS, PATHS, TRAILS, AND PAVED AREAS SHALL BE KEPT FREE OF MUD AND DIRT.

B. REMOVAL: AFTER WORK HAS BEEN COMPLETED REMOVE TOOLS AND ALL OTHER DEBRIS GENERATED BY THE CONTRACTOR.

C. REPAIR: THE CONTRACTOR SHALL REPAIR ANY DAMAGES THAT OCCURRED DURING COMPLETION OF THE WORK DESCRIBED IN THIS SECTION. SAID DAMAGES MAY INCLUDE, BUT ARE NOT LIMITED TO: TIRE RUTS IN THE GROUND, DAMAGE TO TREES OR OTHER PLANTED AREAS, DAMAGE TO TRAILS, ETC. ALL AREAS DAMAGED BY THE CONTRACTOR DURING THE EXECUTION OF THIS WORK SHALL BE REPAIRED BY CONTRACTOR AND RESTORED TO THE CONDITIONS SHOWN ON THE PLANS AT NO ADDITIONAL COST TO THE OWNER. ALL AREAS OUTSIDE OF THE CONSTRUCTION LIMITS DISTURBED BY CONSTRUCTION SHALL BE RESTORED TO PRE-CONSTRUCTION GRADES AND STABILIZED WITH APPROPRIATE SEED OR PLANTINGS.

3.3 INSPECTION

A. AFTER COMPLETION OF SEEDING, THE CONTRACTOR SHALL SCHEDULE WITH OWNER A PROVISIONAL ACCEPTANCE INSPECTION OF THE WORK.

3.4 ACCEPTANCE AND GUARANTEE

A. PROVISIONAL ACCEPTANCE: THE WORK SHALL BE CONSIDERED 90% COMPLETE AFTER ALL COVER CROP SEED HAS BEEN INSTALLED, AND THE CONTRACTOR HAS COMPLETED ALL CLEAN-UP, REMOVAL, AND REPAIR AS DESCRIBED IN 3.2 OF THIS SECTION.

B. FINAL ACCEPTANCE: THE WORK SHALL BE CONSIDERED 100% COMPLETE AFTER THE CONTRACTOR HAS MET OR EXCEEDED THE PERFORMANCE STANDARDS GIVEN IN 3.4C OF THIS SECTION.

C. THE CONTRACTOR SHALL GUARANTEE SEEDED AREAS WILL MEET OR EXCEED THE FOLLOWING PERFORMANCE CRITERIA: 80% PLANT COVER WITHIN 3 MONTHS OF SEEDING.

SEEDING

PART 1. GENERAL

1.1 DESCRIPTION

A. THIS SECTION INCLUDES INSTALLATION OF SEED IN ALL DESIGNATED AREAS.

1.2 RELATED SECTIONS

A. SOIL PREPARATION AND COVER CROP SEEDING.

1.3 QUALITY ASSURANCE

A. QUALIFICATIONS OF WORKMEN: PROVIDE AT LEAST ONE PERSON WHO SHALL BE PRESENT AT ALL TIMES DURING EXECUTION OF THIS PORTION OF THE WORK WHO SHALL BE THOROUGHLY FAMILIAR WITH THE TYPE AND OPERATION OF EQUIPMENT BEING USED. SAID PERSON SHALL DIRECT ALL WORK PERFORMED UNDER THIS SECTION.

B. STANDARDS: ALL MATERIALS AND METHODS USED DURING THIS PORTION OF THE WORK SHALL MEET OR EXCEED APPLICABLE FEDERAL, STATE, COUNTY AND LOCAL LAWS AND REGULATIONS. ALL SEED SHALL BE FREE FROM INSECTS AND DISEASE. SPECIES SHALL BE TRUE TO THEIR SCIENTIFIC NAME AS SPECIFIED.

1.4 SUBMITTALS

A. MATERIALS: THE CONTRACTOR SHALL SUBMIT TO THE OWNER FOR APPROVAL A COMPLETE LIST OF ALL MATERIALS TO BE USED DURING THIS PORTION OF THE WORK PRIOR TO DELIVERY OF ANY MATERIALS TO THE SITE, INCLUDE COMPLETE DATA ON SOURCE, AMOUNT AND QUALITY. THIS SUBMITTAL SHALL IN NO WAY BE CONSTRUED AS PERMITTING SUBSTITUTION FOR SPECIFIC ITEMS DESCRIBED ON THE PLANS OR IN THESE SPECIFICATIONS UNLESS APPROVED IN WRITING BY THE OWNER.

B. EQUIPMENT: THE CONTRACTOR SHALL PROVIDE A LIST OF EQUIPMENT AND A DESCRIPTION AND LOCATION OF ITS INTENDED USE, AND A LIST OF SAID PERSONS PERFORMING THE WORK AND THEIR QUALIFICATIONS FOR OPERATING AND MAINTAINING THE LISTED EQUIPMENT.

C. AFTER THE WORK IS COMPLETED THE CONTRACTOR SHALL SUBMIT TO THE OWNER RECORD DRAWINGS, MARK IN RED INK ON THE ORIGINAL PLANS ANY FIELD CHANGES OR DEVIATIONS FROM THE ORIGINAL PLANS.

PART 2. PRODUCTS

2.1 MATERIALS

A. ALL SEED SPECIES SHALL BE SUPPLIED AS PURE LIVE SEED. SEE PLANTING PLAN (SHEET 3) FOR SEEDING LISTS AND QUANTITIES.

B. SEED OF ALL SPECIES NATIVE TO ILLINOIS SHALL BE FROM WITHIN A 25-MILE RADIUS OF THE PROJECT SITE UNLESS APPROVED BY THE OWNER.

C. GRASS SEED SHALL BE IN CONFORMANCE WITH USDA RULES AND REGULATIONS UNDER THE FEDERAL SEED ACT AND APPLICABLE ILLINOIS STATE SEED LAWS.

D. STRAW OR HAY FOR EROSION CONTROL SHALL BE CLEAN, SEED-FREE HAY OR THRESHED STRAW OF WHEAT, RYE, OATS, OR BARLEY.

PART 3. EXECUTION

3.1 METHOD

A. IF PLANTED IN SPRING, SEEDS SHALL HAVE PROPER STRATIFICATION AND/OR SCARIFICATION TO BREAK SEED DORMANCY.

B. SEEDING SHALL BE PREFERENTIALLY CONDUCTED IN EARLY SPRING AS SOON AS THE SOIL IS FREE OF FROST AND IN A WORKABLE CONDITION BUT NO LATER THAN JUNE 15TH OR AS A LATE FALL DORMANT SEEDING AFTER NOVEMBER 15TH.

C. ALL SEED SHALL BE PREFERENTIALLY INSTALLED WITH A HANGELAND TYPE GRAM DRILL OR NO-TILL PLANTER, SUCH AS BY TRIAX, OR EQUIVALENT, OR BROADCAST INTO LIGHTLY TILLED SOIL SURFACE, FOLLOWED BY IMPRESSING SEED INTO THE SOIL WITH A CULTIVATOR ROLLER. ALL METHODS SHALL BE APPROVED BY THE OWNER.

D. IF SOIL IS TOO WET OR GRADE IS TOO STEEP TO INSTALL, SEED AS DESCRIBED IN 3.1B. ABOVE, A MECHANICAL BROADCAST SEEDER, SUCH AS BY CYCLONE, SHALL BE USED. HAND BROADCASTING OF SEED MAY ALSO BE EMPLOYED, WITHIN 24 HOURS, OR AS SOON AS SITE CONDITIONS PERMIT. BROADCAST SEEDED AREAS SHALL BE ROLLED, BUT SOIL SHALL BE LIGHTLY TILLED BEFOREHAND.

E. NORTH AMERICAN GREEN SOYBEAN EROSION CONTROL MAT OR EQUAL SHALL BE USED FOR EROSION CONTROL ONTO SLOPES GREATER THAN ONE FOOT HORIZONTAL TO FIVE FOOT VERTICAL (1:5) IMMEDIATELY FOLLOWING SEEDING. 575 OR EQUAL CAN BE USED FOR EROSION CONTROL IN AREAS OF LESS THAN 1:5 SLOPES.

F. IF AREA TO BE SEEDED WAS TREATED WITH HERBICIDE, SEEDING SHALL OCCUR NO LESS THAN 14 DAYS AFTER HERBICIDE APPLICATION.

NOTES:
SEE STANDARD SPECIFICATIONS, SPECIAL PROVISIONS, AND STANDARD DETAILS FOR ADDITIONAL INFORMATION.

FILE NAME = ...:\D160F72-sht-Towne Park-10.dgn				USER NAME = akw	DESIGNED - AES	REVISED -	STATE OF ILLINOIS DEPARTMENT OF TRANSPORTATION			O.R. RTE.	SECTION	COUNTY	TOTAL SHEETS	SHEET NO.
				PLOT SCALE = 2.0000' / in.	DRAWN - AES	REVISED -	CRYSTAL CREEK RELOCATION PLANS			0003	18A-2	MCHENRY	825	407
				PLOT DATE = 5/2/2012	CHECKED - AES	REVISED -	SCALE: AS NOTED			SHEET NO. 8 OF 10 SHEETS			CONTRACT NO. 60F72	
					DATE = 5/3/2012	REVISED -	STA. TO STA.			FED. ROAD DIST. NO. 1 ILLINOIS FED. AID PROJECT				

**Sheet Number
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Applied Ecological Services, Inc.
120 West Main Street
West Dundee, Illinois 60118
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Construction Notes & Specifications

Drawn By: EWM
Checked: WWS
Approved: GDP

AES Project No.: 09-0198 (02-527)
File Name: 020627es201001629_Notes-4.dwg
Date: 11-30-2009

Crystal Creek Realignment Algonquin, Illinois Village of Algonquin 125 Wilbrandt Street Algonquin, Illinois 60102

No.	By	Date	Description
1		02-26-10	Final AES review for ACOE submittal
2		05-28-10	ACOE & MCSWCD Comments
3		05-16-11	ACOE permit submittal
4			
5			
6			
7			

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NOTES:
SEE STANDARD SPECIFICATIONS, SPECIAL PROVISIONS, AND STANDARD DETAILS FOR ADDITIONAL INFORMATION.

PART 2 - PRODUCTS

2.1 MATERIALS

A. HERBACEOUS SPECIES TO BE REMOVED IN AREAS WITH STANDING WATER OR SATURATED SOILS SHALL BE TREATED WITH A 5% SOLUTION OF GLYPHOSATE-N-(PHOSPHONOMETHYL) GLYCLINE IN A FORM APPROVED FOR AQUATIC APPLICATIONS SUCH AS ROBOG OR EQUIVALENT, WITH ADDED NON-IONIC SURFACTANT, AS APPROVED IN WRITING BY OWNER.

B. HERBACEOUS SPECIES TO BE REMOVED IN AREAS WITHOUT STANDING WATER OR SATURATED SOILS SHALL BE TREATED WITH A 3% SOLUTION OF GLYPHOSATE-N-(PHOSPHONOMETHYL) GLYCLINE, TRADE NAME ROUNDUP OR EQUIVALENT AS APPROVED IN WRITING BY OWNER. CONTRACTOR MAY ALSO USE A GRASS-SPECIFIC HERBICIDE WITH THE APPROVAL OF THE OWNER.

C. HERBICIDE TO BE USED FOR BARK-TO-WOOD VEGETATION SHALL BE A 25% SOLUTION OF TRICLOPIR-3,5,6-TRICHLORO-2-PYRIDINYLOXYACETIC ACID, BUTOXYETHYL ESTER, TRADE NAME GARLON 3 OR EQUIVALENT, WITH ADDED IONIC SURFACTANT, AS APPROVED IN WRITING BY THE OWNER.

D. HERBICIDE TO BE USED FOR FOLIAR APPLICATIONS TO WOODY VEGETATION SHALL BE A 5% SOLUTION OF TRICLOPIR-3,5,6-TRICHLORO-2-PYRIDINYLOXYACETIC ACID, BUTOXYETHYL ESTER, TRADE NAME GARLON 3 OR EQUIVALENT, WITH ADDED IONIC SURFACTANT, AS APPROVED IN WRITING BY OWNER.

E. HERBICIDE TO BE USED ON HONEYUCKLE SPECIES SHALL BE A 50% SOLUTION OF GLYPHOSATE AND WATER. NO GARLON PRODUCTS SHALL BE USED ON HONEYUCKLE.

F. OTHER PRODUCTS SUCH AS GRASS-SPECIFIC HERBICIDES MAY BE PROPOSED BY THE CONTRACTOR FOR APPROVAL BY THE OWNER.

G. THE CONTRACTOR SHALL SUBMIT TO THE OWNER FOR APPROVAL PROPOSED RATES OF HERBICIDE APPLICATION PRIOR TO COMMENCING THE WORK DESCRIBED IN THIS SECTION.

PART 3 - EXECUTION

3.1 METHOD - HERBICIDE APPLICATION

A. CONTRACTOR SHALL TREAT WEEDY HERBACEOUS AND UNDESIRABLE WOODY VEGETATION WITHIN EACH VEGETATION COMMUNITY AS NEEDED DURING THE FIRST FIVE GROWING SEASONS FOLLOWING INITIAL SEEDING OF EACH VEGETATION COMMUNITY USING THE APPROPRIATE HERBICIDE. HERBICIDE APPLICATION INSTRUCTIONS GIVEN ON THE LABEL SHALL BE FOLLOWED AT ALL TIMES. UNDESIRABLE SPECIES INCLUDE ALL VASCULAR SPECIES NOT NATIVE TO THIS LOCATION IN MCHENRY COUNTY, ILLINOIS.

B. HERBICIDE SHALL BE MIXED AND PLACED IN CONTAINERS AWAY FROM ANY NATURAL AREA, TREES, SHRUBS, HERBACEOUS OR WOODY GROWTH, OR BODY OF WATER. HERBICIDES SHALL NOT BE TRANSPORTED TO THE WORK AREA IN ANY CONTAINER OTHER THAN THAT USED FOR APPLICATION.

C. WORK OR SPOT APPLICATION WITH ROBOG, REED CANARY GRASS, TEASER, SWIFTER CLOVER, AND PURPLE LOOSESTRIFE PRESENT IN THE PROJECT VICINITY SHOULD BE TREATED DIRECTLY WITH A 2% SOLUTION OF ROBOG. BEST APPLICATION PERIOD IS JUST BEFORE OR DURING THE VERY EARLIEST STAGES OF FLOWERING, WHERE LARGE PATCHES OF TARGET WEEDS ARE PRESENT IT MAY BE NECESSARY TO USE A LARGER WORK UNIT WHICH CAN BE ATTACHED TO AN ALL-TERRAIN VEHICLE OR TRACTOR. SEVERAL BACK-TO-BACK TREATMENTS MAY BE USEFUL IN GREATLY REMEDIATING THESE PLANTS.

D. A SUPPLY OF CHEMICAL ABSORBENT SHALL BE MAINTAINED AT THE PROJECT SITE. ANY CHEMICAL SPILLS SHALL BE PROPERLY CLEANED UP AND REPORTED TO THE OWNER WITHIN 24 HOURS.

E. THE CONTRACTOR SHALL MAINTAIN COPIES AT THE PROJECT SITE OF ALL CURRENT PESTICIDE APPLICATION LICENSES, HERBICIDE LABELS, AND MSDS MATERIAL SAFETY DATA SHEETS FOR ALL CHEMICALS UTILIZED DURING COMPLETION OF THE WORK.

F. TARGET SPECIES SHALL BE TREATED AS OFTEN AS REQUIRED TO MEET THE SEED AND PLANT GUARANTEES IN THESE SPECIFICATIONS.

G. IT IS THE RESPONSIBILITY OF THE CONTRACTOR TO PROTECT NATIVE SPECIES AND AREAS OUTSIDE OF THE PROJECT AREA DURING EXECUTION OF THE WORK DESCRIBED IN THIS SECTION. THE CONTRACTOR SHALL RESTORE ALL AREAS AFFECTED OR DISTURBED BY THE WORK ACCORDING TO THE APPROVED PLANS AND SPECIFICATIONS AT NO ADDITIONAL COST TO THE OWNER.

3.2 METHOD - MOWING

A. THE CONTRACTOR SHALL MOW SEEDING AREAS TO A HEIGHT OF 4-10" AFTER VEGETATION IN SAID AREAS REACHES A HEIGHT OF APPROXIMATELY 24" AND BEFORE NON-NATIVE SPECIES GO TO SEED DURING THE FIRST GROWING SEASON AFTER PLANTING. MOWING DURING THE FIRST GROWING SEASON SHALL OCCUR THREE TIMES (APPROXIMATELY EARLY JUNE, MID JULY, AND LATE AUGUST). THE CONTRACTOR SHALL ALSO MOW SEEDING AREAS TO A HEIGHT OF 12" TWO TIMES DURING THE SECOND GROWING SEASON (APPROXIMATELY EARLY JUNE AND EARLY AUGUST) UNLESS THE PROJECT ECOLOGIST DETERMINES THAT MOWING IS NOT NEEDED.

B. MOWING SHOULD BE DONE WITH A ROTARY BUSH-HOE STYLE MOWER TO ENSURE CLIPPINGS ARE DISPERSED RATHER THAN DEPOSITED IN DENSE MATS, WHICH SMOOTHER VEGETATION, OR THE CLIPPINGS BRANCHES SHOULD BE REMOVED FROM THE MOWED AREA.

3.3 METHOD - PRESCRIBED BURNING

A. PRESCRIBED BURNING SHALL BE THE PRIMARY METHOD OF LONG-TERM ECOLOGICAL MANAGEMENT AND WEED CONTROL OF PLANTING AREAS AT THE PROJECT SITE. BURNING SHALL BE CONDUCTED IN THE SPRING OF THE THIRD GROWING SEASON FOLLOWING INITIAL SEEDING. THEREAFTER, THE OWNER SHOULD CONTRACT A PARTY TO CONTINUE BURNING ONCE EVERY 2-3 YEARS. BURNING SHALL BE CONDUCTED BY A CONTRACTOR EXPERIENCED IN BURN PLANNING AND PERMIT APPLICATION AS WELL AS PRESCRIBED BURN MANAGEMENT.

B. PRIOR TO THE COMMENCEMENT OF PRESCRIBED BURNING, THE CONTRACTOR SHALL COMPLETE A BURN PLAN THAT OUTLINES A PLAN OF ACTION, IDENTIFIES CONTINGENCIES, AND LISTS THE NAMES AND PHONE NUMBERS OF EMERGENCY AGENCIES (FIRE DEPARTMENT, POLICE DEPARTMENT, ETC.). PROPER NOTICE OF INTENT TO BURN SHALL BE GIVEN.

C. THE CONTRACTOR SHALL APPLY FOR AND RECEIVE ALL REQUIRED PERMITS PRIOR TO THE COMMENCEMENT OF PRESCRIBED BURNING.

3.4 CLEAN-UP, REMOVAL AND REPAIR

A. CLEAN-UP: THE WORK AREA SHALL BE KEPT FREE OF DEBRIS BY THE CONTRACTOR. AT NO TIME SHALL EMPTY HERBICIDE CONTAINERS, TRASH, OR OTHER MATERIAL BE ALLOWED TO ACCUMULATE AT THE PROJECT SITE. ALL CLEANING OF HERBICIDE CONTAINERS SHALL BE DONE AWAY FROM THE OWNER'S PROPERTY OR ANY SURROUNDING AREA. ALL TOOLS SHALL BE KEPT IN APPROPRIATE CARRYING CASES, TOOLBOXES, ETC. PARKING AREAS, ROADS, SIDEWALKS, PATHS AND PAVED AREAS SHALL BE KEPT FREE OF MUD AND DIRT.

B. REMOVAL: AFTER WORK HAS BEEN COMPLETED REMOVE TOOLS, EMPTY CONTAINERS, AND ALL OTHER DEBRIS GENERATED BY THE CONTRACTOR.

C. REPAIR: REPAIR ANY DAMAGES CAUSED BY THE CONTRACTOR DURING COMPLETION OF THE WORK DESCRIBED IN THIS SECTION. GAD DAMAGES MAY INCLUDE, BUT ARE NOT LIMITED TO, TIRE RUTS IN THE GROUND, DAMAGE TO PLANTED AREAS, DAMAGE TO TRAILS, SMOKE AND/OR FIRE DAMAGE TO TREES, ETC. THE CONTRACTOR SHALL BE LIABLE FOR REMEDIATING DAMAGES TO PLANT MATERIALS AND PROPERTY AT NO COST TO THE OWNER CAUSED BY CONTRACTOR NEGLIGENCE DURING COMPLETION OF THE WORK.

D. REPLANTING: AREAS OF PLANTING FAILURE WILL NEED TO BE REPLANTED. CONTRACTOR SHALL IDENTIFY THE AREAS OF FAILURE WITH THE OWNER AND DETERMINE THE REASON FOR FAILURE. REPLANTING IF NOT DUE TO VANDALISM OR REASONS NOT IDENTIFIED IN THE SITE WORK PLANTING SPECIFICATIONS SHALL BE DONE BY THE CONTRACTOR AS PART OF THE SITE WORK TASKS. OTHER PLANTING FAILURE AREAS WILL BE REPLANTED BY CONTRACTOR AS EXTRA WORK AUTHORIZED IN WRITING BY THE OWNER PRIOR TO COMMENCEMENT OF THE CONSTRUCTION.

3.5 INSPECTION

A. AT THE REQUEST OF THE OWNER, THE CONTRACTOR SHALL SCHEDULE AN INSPECTION WITH THE OWNER TO REVIEW THE WORK COMPLETED BY THE CONTRACTOR PURSUANT TO THIS SECTION.

3.6 ACCEPTANCE AND GUARANTEE

A. FINAL ACCEPTANCE: MANAGEMENT SHALL BE CONSIDERED 100% COMPLETE AFTER THE CONTRACTOR HAS COMPLIED WITH ALL PARTS OF THIS SECTION AND MEETS ALL PERFORMANCE STANDARDS FOR SEEDING AREAS (SECTION SEEDING 3.4), PLANTINGS (SECTION HERBACEOUS PERENNIAL 3.4).

AQUA-BARRIER PRODUCT SPECIFICATION

1.1 SPECIFICATION

A. WATER-INFLATED TEMPORARY DAM SHALL CONSIST OF THE FOLLOWING:

1. THE WATER-INFLATED DAM WILL CONSIST OF A SELF-CONTAINED, SINGLE-TUBE WITH AN INNER RESTRAINT BAFFLE (S/DIAPHRAGM(S)) STABILIZATION SYSTEM. THE WATER-INFLATED DAM MUST HAVE THE ABILITY TO STAND BALANCE WITHOUT ANY ADDITIONAL MECHANICAL OR GRAVITATIONAL STABILIZATION DEVICES, AS A POSITIVE WATER BARRIER AND WATER MANAGEMENT SYSTEM.
2. THE WATER-INFLATED DAM SHALL BE PRODUCED FROM HEAVY-GAUGE POLYVINYL CHLORIDE (PVC) REINFORCED WITH POLYESTER. THE PVC FABRIC USED TO CREATE THE INFLATABLE DAM WILL BE INFILTED REPAIRABLE UTILIZING A VINYL ADHESIVE AND PATCH MATERIAL.
3. THE WATER-INFLATED DAM MUST MAINTAIN MECHANICAL STABILITY IN ADDITION TO PROVIDING ANTI-ROLLING WHEN EXPOSED TO UNEVEN HYDROSTATIC PRESSURE FROM EITHER SIDE.
4. THE SELF-CONTAINED WATER-INFLATED DAM SHALL HAVE THREADED FILL PORTS AND DRAIN PORTS FOR RAPID INFLATION AND DRAINING. THE DAM WILL BE EQUIPPED WITH END-LIFTING LOOPS USED TO CONTROL THE DAM WITH EQUIPMENT DURING THE INSTALLATION AND REMOVAL PROCESSES.
5. METHOD FOR CONNECTING THE INDIVIDUAL UNITS TOGETHER WILL CONSIST OF OVERLAPPING THE END OF THE UNITS A SPECIFIC LENGTH WHICH WILL CREATE A WATER-TIGHT CONNECTION. NO OTHER DEVICES OR METHODS FOR CONNECTING THE BARRIERS ARE REQUIRED.

1.2 AQUA-BARRIER™ PRODUCT DESCRIPTION

AQUA-BARRIERS™ ARE WATER-INFLATED DAMS USED TO CONTROL INVASIVE WATER IN FLOODWATER SITUATIONS. A MEANS OF WATER MANAGEMENT TO PROVIDE ACCESS TO UNDERWATER AREAS FOR CONSTRUCTION AND MAINTENANCE OPERATIONS; HAZARDOUS LIQUID CONTAINMENT; SEDIMENT RETENTION IN ENVIRONMENTALLY SENSITIVE AREAS IN ADDITION TO A CONTINUALLY EXPANDING LIST OF WATER CONTROL RELATED APPLICATIONS.

AQUA-BARRIERS™ ARE A SINGLE-TUBE DEVICE WITH A PATENTED INNER RESTRAINT BAFFLE (S/DIAPHRAGM(S)) STABILIZATION SYSTEM REQUIRED FOR STABILITY.

1.3 DAM SIZE REQUIREMENTS

THE WATER-INFLATED TEMPORARY DAM HEIGHT SHALL BE DETERMINED AS FOLLOWS:

1. STATIC WATER HEIGHT CONDITIONS SHALL NOT EXCEED 75% OF THE PROPERLY FILLED HEIGHT OF THE BARRIER.
2. DYNAMIC WATER HEIGHT CONDITIONS SHALL NOT EXCEED STATED VALUE DURING HYDRODYNAMIC INSTALLATION PROCEDURES (SEE DYNAMIC INSTALLATION INSTRUCTIONS FOR COMPLETE LIST OF REQUIREMENTS).
3. INSTALLATION SITE CRITERIA ARE REQUIRED FOR ASSESSMENT OF ALL RELEVANT FACTORS.

EXCESS SLOPE, HIGH WATER VELOCITIES, DYNAMIC LOADS RESULTING FROM WAVE ACTIONS, MOUNTING SURFACE IRREGULARITIES, AND CHANGES IN INTERRELATED HYDROLOGICAL CONDITIONS CAN INCREASE THE REQUIRED WATER-INFLATED DAM HEIGHT VERSUS RETENTION HEIGHT REQUIREMENTS.

NORTH AMERICAN GREEN® MATERIAL AND PERFORMANCE SPECIFICATIONS SC150 EROSION CONTROL BLANKET

The extended-term double net erosion control blanket shall be a machine-produced mat of 70% agricultural straw and 30% coconut fiber with a functional longevity of up to 24 months. (NOTE: functional longevity may vary depending upon climatic conditions, soil, geographical location, and seedlings). The blanket shall be of consistent thickness with the straw and coconut evenly distributed over the entire area of the mat. The blanket shall be covered on the top side with a heavyweight photodegradable polypropylene netting having ultraviolet additives to delay breakdown. The blanket shall be 1.50 x 0.90 m (1.27 x 1.27 m) mesh. The blanket shall be sewn together on 1.50 inch (3.81 cm) centers with degradable thread.

The SC150 must meet requirements established by the Erosion Control Technology Council (ECTC) Specification and the US Department of Transportation Highway Administration's (FHWA) Standard Specifications for Construction of Roads and Bridges, Section 713.17 as a type 3.B Extended-Term Erosion Control Blanket.

The SC150 is also available with the DOT System™ which consists of installation stipe patterns clearly marked on the erosion control blanket with environmentally safe ink. The blanket shall be manufactured with a colored thread stitched along both outer edges (approximately 2.5 inches [5-12.5 cm] from the edge) as an overlap guide for adjacent mats.

Material Content		
Matrix	100% Straw Fiber	0.35 lbs/yd ² (0.35 kg/m ²)
Nettings	Top side only: Leno Woven 100% biodegradable polypropylene fiber	9.3 lbs/100 yd ² (9.3 kg/100 m ²)
Thread	Degradable	approx.

SC150 is available in the following standard rolls:

Width	6.67 ft (2.03 m)	16 ft (4.88 m)
Length	108 ft (32.92 m)	108 ft (32.92 m)
Weight ± 10%	44 lbs (19.9 kg)	105 lbs (47.6 kg)
Area	80.0 yd ² (69.9 m ²)	192 yd ² (195.5 m ²)

Index Value Properties:

Property	Test Method	Typical
Thickness	ASTM D5525	0.24 in (6.1 mm)
Resiliency	ECTC Guidelines	91%
Water Absorbency	ASTM D1117	39.7 g/g (339.7 g/m ²)
Mass/Unit Area	ASTM G475	9.3 lbs/100 yd ² (9.3 kg/100 m ²)
Smell	ECTC Guidelines	None
Smolder Resistance	ECTC Guidelines	Yes
Softness	ASTM D1388	8.92 oz/in
Light Penetration	ECTC Guidelines	9.1%
Tensile Strength - MD	ASTM D2256	187.2 lbs/ft (2.78 kN/m)
Elongation - MD	ASTM D2256	6.7%
Tensile Strength - TD	ASTM D2256	193.2 lbs/ft (2.86 kN/m)
Elongation - TD	ASTM D2256	8.5%

Performance Design Values:

Maximum Permissible Shear Stress		Slope Design Data: C Factors	
Unvegetated Shear Stress	2.00 lbs/ft ² (98 Pa)	Slope Length (ft)	≤ 3.1
Unvegetated Velocity	8.00 fts (2.44 m/s)	Slope Gradient (S)	3:1 - 2:1
			≥ 2:1
			0.001
			0.048
			0.145
			0.079
			0.110
			0.190

Bench Scale Testing (MCP):

Test Method	Results	Roughness Coefficient: Unveg.
ECTC Method 2 (2 in/hr for 30 min)	SLR** = 5.47	≤ 0.60 ft (0.15 m)
Rainfall (100mm (4 in/hr) for 30 min)	SLR** = 5.67	0.50 - 2.0 ft (0.15 - 0.61 m)
ECTC Method 3 (50 mm (2 in/hr) for 30 min)	SLR** = 5.86	≥ 2.0 ft (0.60 m)
ECTC Method 4 (Top Soil, Fescue, 21 day incubation)	454% improvement of biomass	0.018

** Soil Loss Ratio - Soil loss with Bare Soil/Soil loss with MCP (soil loss is based on regression analysis)

NORTH AMERICAN GREEN® MATERIAL AND PERFORMANCE SPECIFICATIONS S75BN EROSION CONTROL BLANKET

The short-term single net erosion control blanket shall be a machine-produced mat of 100% agricultural straw with a functional longevity of up to 12 months. (NOTE: functional longevity may vary depending upon climatic conditions, soil, geographical location, and elevation). The blanket shall be of consistent thickness with the straw evenly distributed over the entire area of the mat. The blanket shall be covered on the top side with a heavyweight woven natural organic fiber netting. The netting shall consist of machine directional strands formed from two interlaced yarns. The strands shall be interwoven through the twisted machine strands (commonly referred to as a Leno weave) to form an approximate 1.50 x 0.90 m (1.27 x 1.27 m) mesh. The blanket shall be sewn together on 1.50 inch (3.81 cm) centers with degradable thread.

The S75BN must meet requirements established by the Erosion Control Technology Council (ECTC) Specification and the US Department of Transportation Highway Administration's (FHWA) Standard Specifications for Construction of Roads and Bridges, Section 713.17 as a type C Short-Term Single Net Erosion Control Blanket.

The blanket shall be manufactured with a colored thread stitched along both outer edges (approximately 2.5 inches [5-12.5 cm] from the edge) as an overlap guide for adjacent mats.

Material Content		
Matrix	100% Straw Fiber	0.5 lbs/yd ² (0.5 kg/m ²)
Nettings	Top side only: Leno Woven 100% biodegradable polypropylene fiber	9.3 lbs/100 yd ² (9.3 kg/100 m ²)
Thread	Degradable	approx.

S75BN is available in the following standard rolls:

Width	6.67 ft (2.03 m)	16 ft (4.88 m)
Length	108 ft (32.92 m)	108 ft (32.92 m)
Weight ± 10%	46.4 lbs (21.05 kg)	105 lbs (47.6 kg)
Area	80.0 yd ² (69.9 m ²)	192 yd ² (195.5 m ²)

Index Value Properties:

Property	Test Method	Typical
Thickness	ASTM D5525	0.24 in (6.1 mm)
Resiliency	ECTC Guidelines	91%
Water Absorbency	ASTM D1117	39.7 g/g (339.7 g/m ²)
Mass/Unit Area	ASTM G475	9.3 lbs/100 yd ² (9.3 kg/100 m ²)
Smell	ECTC Guidelines	None
Smolder Resistance	ECTC Guidelines	Yes
Softness	ASTM D1388	8.92 oz/in
Light Penetration	ECTC Guidelines	9.1%
Tensile Strength - MD	ASTM D2256	187.2 lbs/ft (2.78 kN/m)
Elongation - MD	ASTM D2256	6.7%
Tensile Strength - TD	ASTM D2256	193.2 lbs/ft (2.86 kN/m)
Elongation - TD	ASTM D2256	8.5%

Performance Design Values:

Maximum Permissible Shear Stress		Slope Design Data: C Factors	
Unvegetated Shear Stress	1.60 lbs/ft ² (78 Pa)	Slope Length (ft)	≤ 3.1
Unvegetated Velocity	5.00 fts (1.52 m/s)	Slope Gradient (S)	3:1 - 2:1
			≥ 2:1
			0.009
			NA
			NA
			NA
			NA

Bench Scale Testing (MCP):

Test Method	Results	Roughness Coefficient: Unveg.
ECTC Method 2 (2 in/hr for 30 min)	SLR** = 6.63	≤ 0.60 ft (0.15 m)
Rainfall (100mm (4 in/hr) for 30 min)	SLR** = 7.25	0.50 - 2.0 ft (0.15 - 0.61 m)
ECTC Method 3 (50 mm (2 in/hr) for 30 min)	SLR** = 7.52	≥ 2.0 ft (0.60 m)
ECTC Method 4 (Top Soil, Fescue, 21 day incubation)	454% improvement of biomass	0.021

** Soil Loss Ratio - Soil loss with Bare Soil/Soil loss with MCP (soil loss is based on regression analysis)


PART OF THE EAST 1/2 OF SEC. 33 AND PART OF THE FRACTIONAL WEST 1/2 OF SEC. 34, TWP. 43 N., R. 8 E. OF THE 3RD. P.M., IN McHENRY COUNTY, ILLINOIS.

LEGEND

Proposed Pavement Huntington Drive Curve #5

P.I. = Sta. 207+87.44
 Δ = 63°44'35"
 R = 360.00'
 T = 223.83'
 L = 400.51'
 E.C. = 63.91'
 P.C. = Sta. 205+63.61
 P.T. = Sta. 209+64.12

Schedule of Ties		
Point Number	Tie to point	Tie Distance (feet)
1	T1	14.60
	T2	19.16
	T3	27.42
2	T1	21.60
	T2	13.78
	T3	20.91

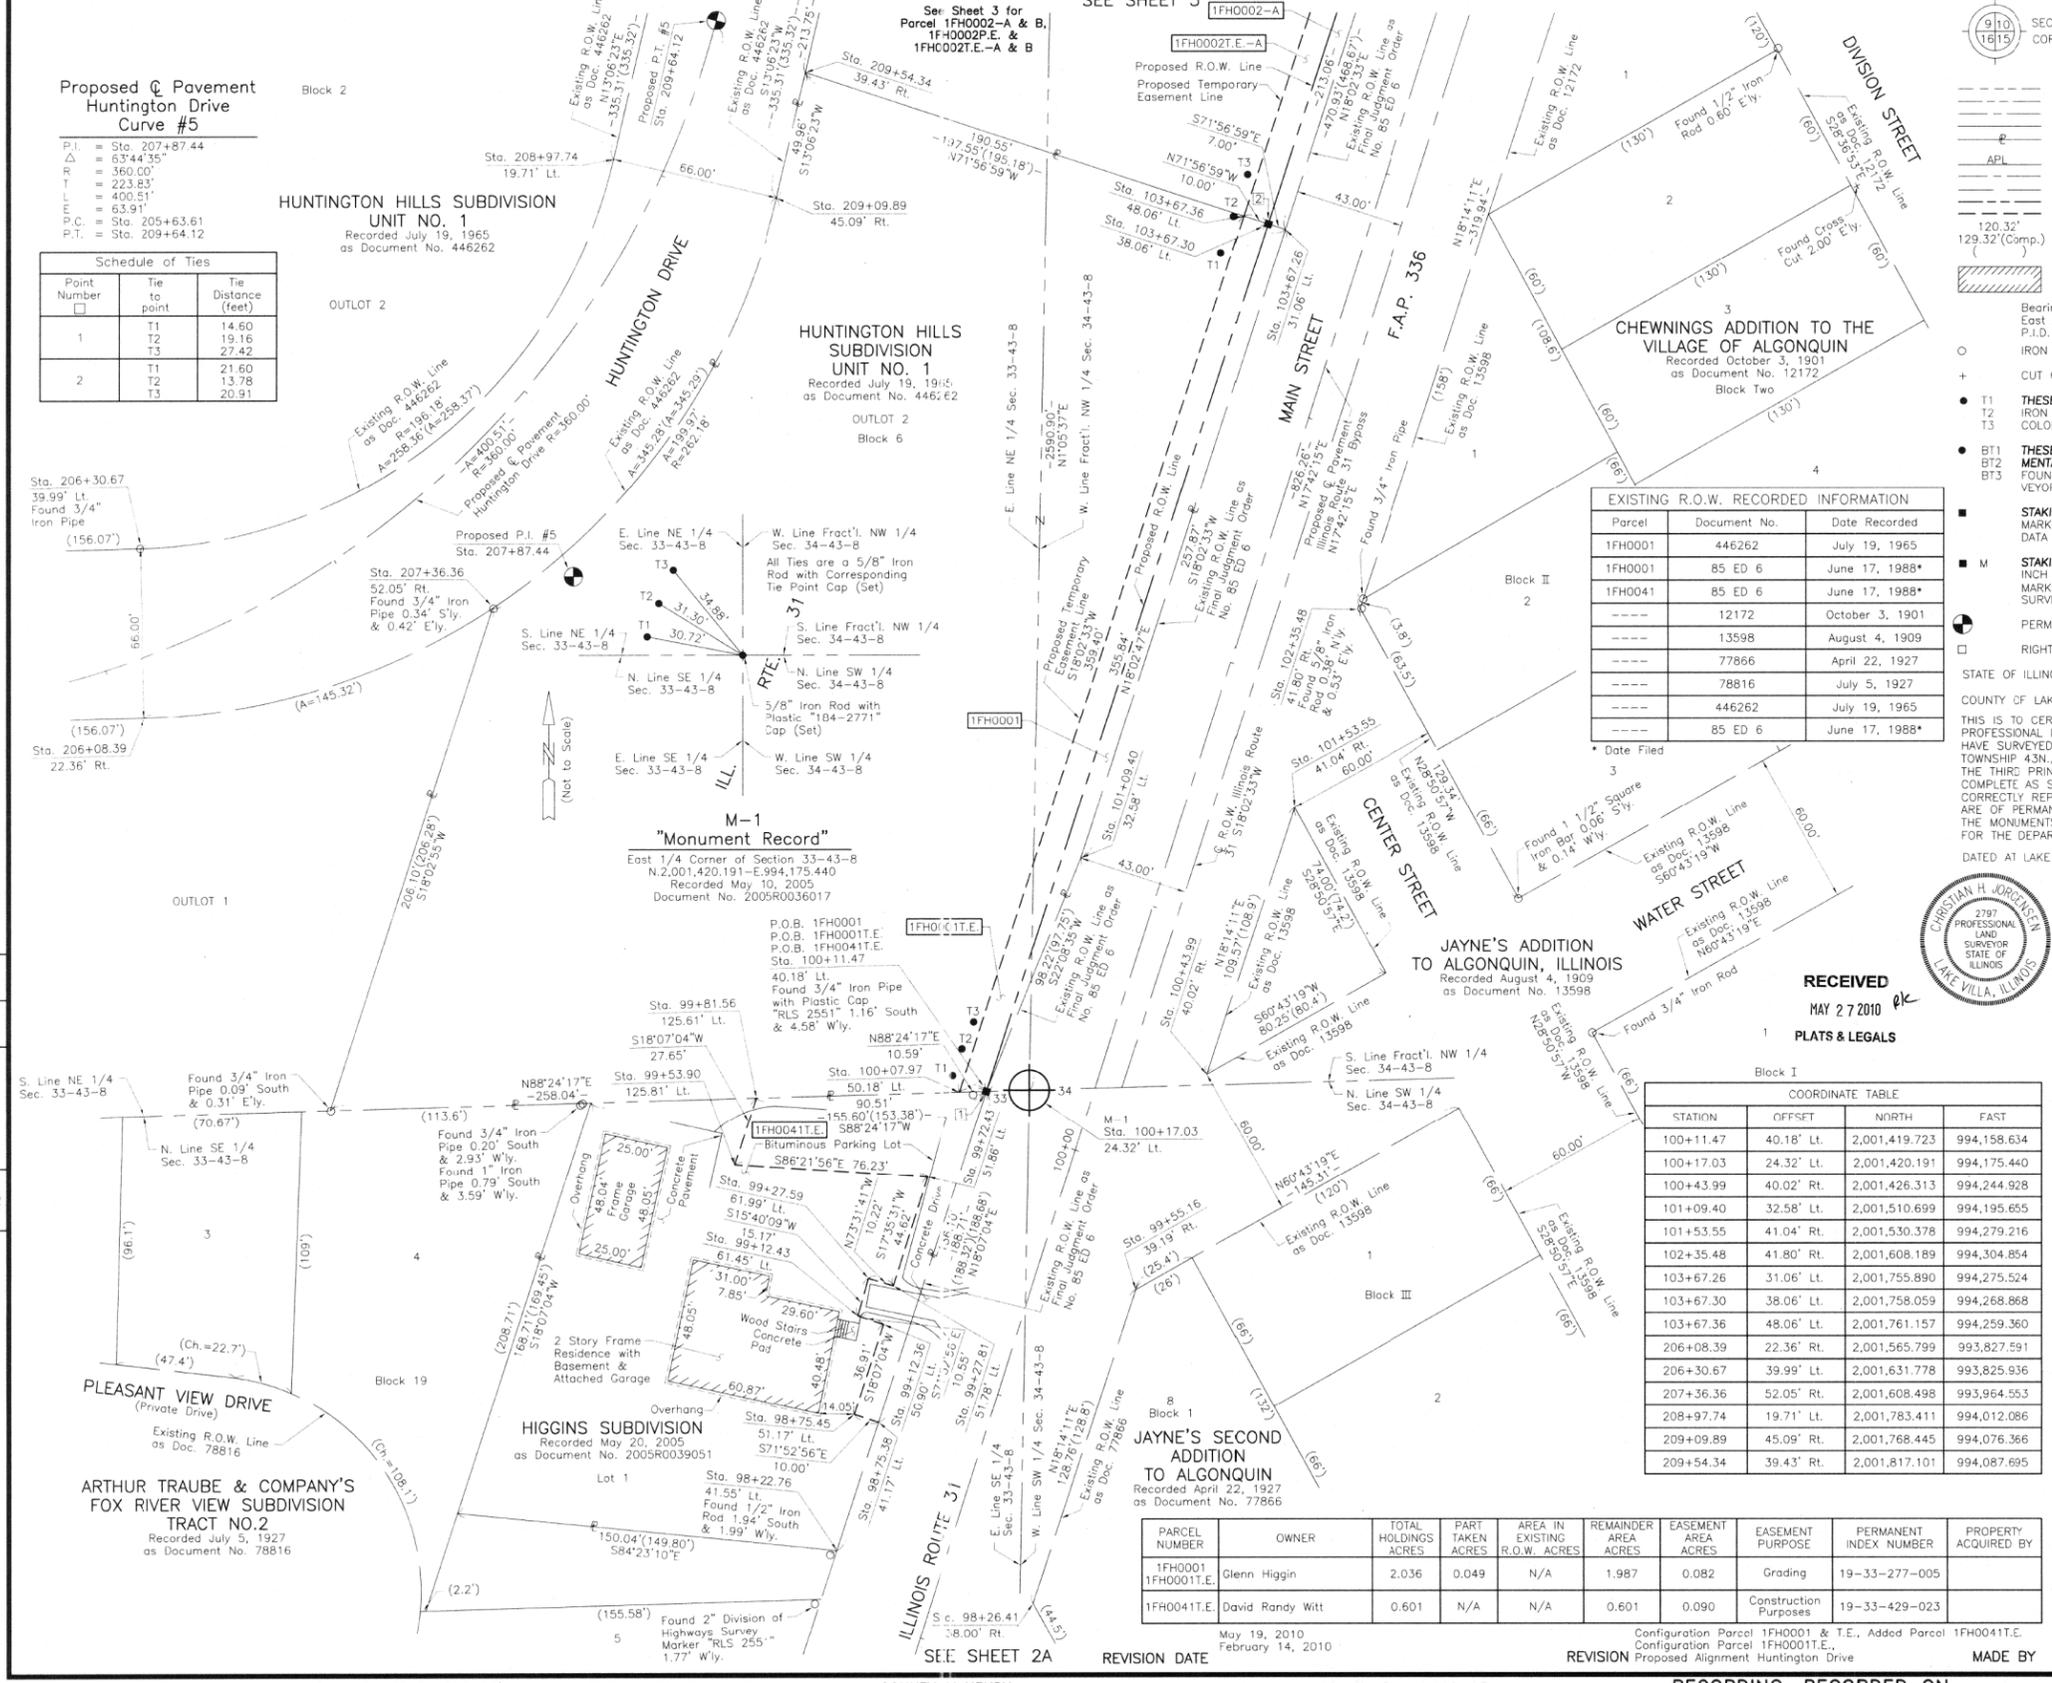

EXISTING R.O.W. RECORDED INFORMATION			
Parcel	Document No.	Date Recorded	
1FH0001	446262	July 19, 1965	
1FH0001	85 ED 6	June 17, 1988*	
1FH0041	85 ED 6	June 17, 1988*	
----	12172	October 3, 1901	
----	13598	August 4, 1909	
----	77866	April 22, 1927	
----	78816	July 5, 1927	
----	446262	July 19, 1965	
----	85 ED 6	June 17, 1988*	

COORDINATE TABLE			
STATION	OFFSET	NORTH	EAST
98+22.76	41.55' Lt.	2,001,240.369	994,099.950
98+26.41	38.00' Rt.	2,001,219.650	994,176.835
98+75.38	41.17' Lt.	2,001,290.374	994,116.312
98+75.45	51.17' Lt.	2,001,293.484	994,106.807
99+12.36	50.90' Lt.	2,001,328.563	994,118.265
99+12.43	61.45' Lt.	2,001,331.844	994,108.256
99+27.59	61.99' Lt.	2,001,346.450	994,112.354
99+27.81	51.78' Lt.	2,001,343.554	994,122.150
99+53.90	125.81' Lt.	2,001,390.920	994,059.559
99+55.16	39.19' Rt.	2,001,341.940	994,217.128
99+72.43	51.86' Lt.	2,001,386.088	994,135.636
99+81.56	125.61' Lt.	2,001,417.203	994,068.159
100+07.97	50.18' Lt.	2,001,419.428	994,148.045

COORDINATE TABLE			
STATION	OFFSET	NORTH	EAST
100+11.47	40.18' Lt.	2,001,419.723	994,158.634
100+17.03	24.32' Lt.	2,001,420.191	994,175.440
100+43.99	40.02' Rt.	2,001,426.313	994,244.928
101+09.40	32.58' Lt.	2,001,510.699	994,195.655
101+53.55	41.04' Rt.	2,001,530.378	994,279.216
102+35.48	41.80' Rt.	2,001,608.189	994,304.854
103+67.26	31.06' Lt.	2,001,755.890	994,275.524
103+67.30	38.06' Lt.	2,001,758.059	994,268.868
103+67.36	48.06' Lt.	2,001,761.157	994,259.360
206+08.39	22.36' Rt.	2,001,565.799	993,827.591
206+30.67	39.99' Lt.	2,001,631.778	993,825.936
207+36.36	52.05' Rt.	2,001,608.498	993,964.553
208+97.74	19.71' Lt.	2,001,783.411	994,012.086
209+09.89	45.09' Rt.	2,001,768.445	994,076.366
209+54.34	39.43' Rt.	2,001,817.101	994,087.695

PARCEL NUMBER	OWNER	TOTAL HOLDINGS ACRES	PART TAKEN ACRES	AREA IN EXISTING R.O.W. ACRES	REMAINDER AREA ACRES	EASEMENT AREA ACRES	EASEMENT PURPOSE	PERMANENT INDEX NUMBER	PROPERTY ACQUIRED BY
1FH0001	Glenn Higgin	2.036	0.049	N/A	1.987	0.082	Grading	19-33-277-005	
1FH0041E	David Randy Witt	0.601	N/A	N/A	0.601	0.090	Construction Purposes	19-33-429-023	

SECTION CORNER
 QUARTER SECTION CORNER

SECTION LINE
 QUARTER SECTION LINE
 EXISTING RIGHT OF WAY LINE
 PLATTED LOT LINE
 PROPERTY (DEED) LINE

APL
 APPARENT PROPERTY LINE
 CENTER LINE
 EXISTING RIGHT OF WAY LINE
 PROPOSED RIGHT OF WAY LINE
 PROPOSED EASEMENT
 MEASURED DIMENSION
 COMPUTED DIMENSION
 RECORD DATA

EXISTING BUILDING

Bearings are referenced to the Illinois Coordinate System NAD83 (1997) East Zone at Found Geodetic Survey Control Monument "MCH31 1A", P.I.D. A2855 and "Algonquin", P.I.D. A2945.

○ IRON PIPE OR ROD FOUND
 ● CUT CROSS FOUND OR SET
 ● T1 T2 T3 THESE STAKES REFERENCE FOUND OR SET MONUMENTATION. SET 5/8 INCH IRON ROD FLUSH WITH GROUND TO THE FOUND IRON STAKE. IDENTIFIED BY COLORED PLASTIC CAP BEARING SURVEYORS REGISTRATION NUMBER.
 ● BT1 BT2 BT3 THESE STAKES, IN CULTIVATED AREAS, REFERENCE FOUND OR SET MONUMENTATION. BURIED 5/8 INCH IRON ROD 20 INCHES BELOW GROUND TO THE FOUND IRON STAKE. IDENTIFIED BY COLORED PLASTIC CAP BEARING SURVEYORS REGISTRATION NUMBER.
 ■ STAKING OF PROPOSED RIGHT OF WAY. SET DIVISION OF HIGHWAYS SURVEY MARKER TO MONUMENT THE POSITION SHOWN. IDENTIFIED BY INSCRIPTION DATA AND SURVEYORS REGISTRATION NUMBER.
 ■ M STAKING OF PROPOSED RIGHT OF WAY IN CULTIVATED AREAS. BURIED 5/8 INCH METAL ROD 20 INCHES BELOW GROUND TO MARK FUTURE SURVEY MARKER POSITION IDENTIFIED BY COLORED PLASTIC CAP BEARING SURVEYORS REGISTRATION NUMBER.
 ● PERMANENT SURVEY MARKER, I.D.O.T STD 2135 (TO BE SET BY OTHERS)
 □ RIGHT OF WAY STAKING PROPOSED TO BE SET.

STATE OF ILLINOIS }
 COUNTY OF LAKE }
 THIS IS TO CERTIFY THAT WE, JORGENSEN & ASSOCIATES, INC., AN ILLINOIS PROFESSIONAL DESIGN FIRM LAND SURVEYING CORPORATION, NUMBER 184-2771, HAVE SURVEYED THE PLAT OF HIGHWAYS SHOWN HEREON BETWEEN SECTION 33, TOWNSHIP 43N., RANGE 8E. AND SECTION 34, TOWNSHIP 43N., RANGE 8E., OF THE THIRD PRINCIPAL MERIDIAN, McHENRY COUNTY, THAT THE SURVEY IS TRUE AND COMPLETE AS SHOWN TO THE BEST OF MY KNOWLEDGE AND BELIEF; THAT THE PLAT CORRECTLY REPRESENTS SAID SURVEY; THAT ALL MONUMENTS FOUND AND ESTABLISHED ARE OF PERMANENT QUALITY AND OCCUPY THE POSITIONS SHOWN THEREON AND THAT THE MONUMENTS ARE SUFFICIENT TO ENABLE THE SURVEY TO BE RETRACED. MADE FOR THE DEPARTMENT OF TRANSPORTATION, STATE OF ILLINOIS.

DATED AT LAKE VILLA, ILLINOIS THIS 20th DAY OF May 2010 A.D.

RECEIVED
 MAY 27 2010
 PLATS & LEGALS

DATE FILED

2797
 PROFESSIONAL LAND SURVEYOR
 STATE OF ILLINOIS
 CHRISTIAN H. JORGENSEN
 LAKE VILLA, ILLINOIS

PRESIDENT
 ILLINOIS PROFESSIONAL LAND SURVEYOR NO. 35-2797
 LICENSE EXPIRATION DATE: NOVEMBER 30, 2010
 THIS PROFESSIONAL SERVICE CONFORMS TO THE CURRENT ILLINOIS MINIMUM STANDARDS FOR A BOUNDARY SURVEY. COORDINATES ARE BASED ON THE PUBLISHED METRIC COORDINATE VALUES AT FOUND GEODETIC SURVEY CONTROL MONUMENT "MCH31 1A", P.I.D. A2855, OF N.613,205.182-E.303,895.917. NOTE: SURFACE COORDINATES ARE SHOWN.

ROW	DATE	BY	MADE	CHECKED	INDEXED	NOTED	BOOK	NO.

ROUTE F.A.P. 336 (ILLINOIS ROUTE 31 BYPASS) SECTION 96-00209-00-PV COUNTY McHENRY JOB NO. R-91-022-03 RECORDING: RECORDED ON AS DOCUMENT NO.

FILE NAME = ...\\D160F72-sht-PH-02.dgn

USER NAME = okw	DESIGNED -	REVISED -
	DRAWN - JORGENSEN & ASSOC.	REVISED -
	CHECKED - CJ	REVISED -
	DATE -	REVISED -


STATE OF ILLINOIS
 DEPARTMENT OF TRANSPORTATION

PLAT OF HIGHWAYS
 SCALE: GRAPHIC SHEET NO. 2 OF 49 SHEETS STA. TO STA.


O.R. RTE.	SECTION	COUNTY	TOTAL SHEETS	SHEET NO.
0003	18A-2	McHENRY	825	411
CONTRACT NO. 60F72				
FED. ROAD DIST. NO. 1 ILLINOIS FED. AID PROJECT				

PART OF THE SE 1/4 OF SEC. 33 AND PART OF THE SW 1/4 OF SEC. 34, TWP. 43 N., R. 8 E. OF THE 3RD. P.M., IN McHENRY COUNTY, ILLINOIS.

LEGEND

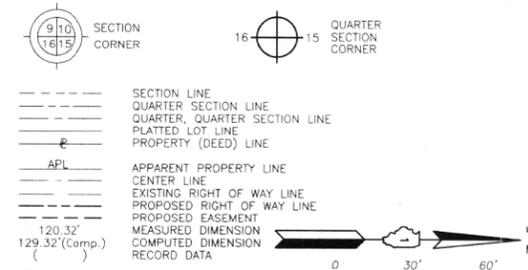

COORDINATE TABLE			
STATION	OFFSET	NORTH	EAST
98+02.77	41.69' Lt.	2,001,221.361	994,093.731
98+22.76	41.55' Lt.	2,001,240.369	994,099.950
98+26.41	38.00' Rt.	2,001,219.650	994,176.835
99+55.16	39.19' Rt.	2,001,341.940	994,217.128

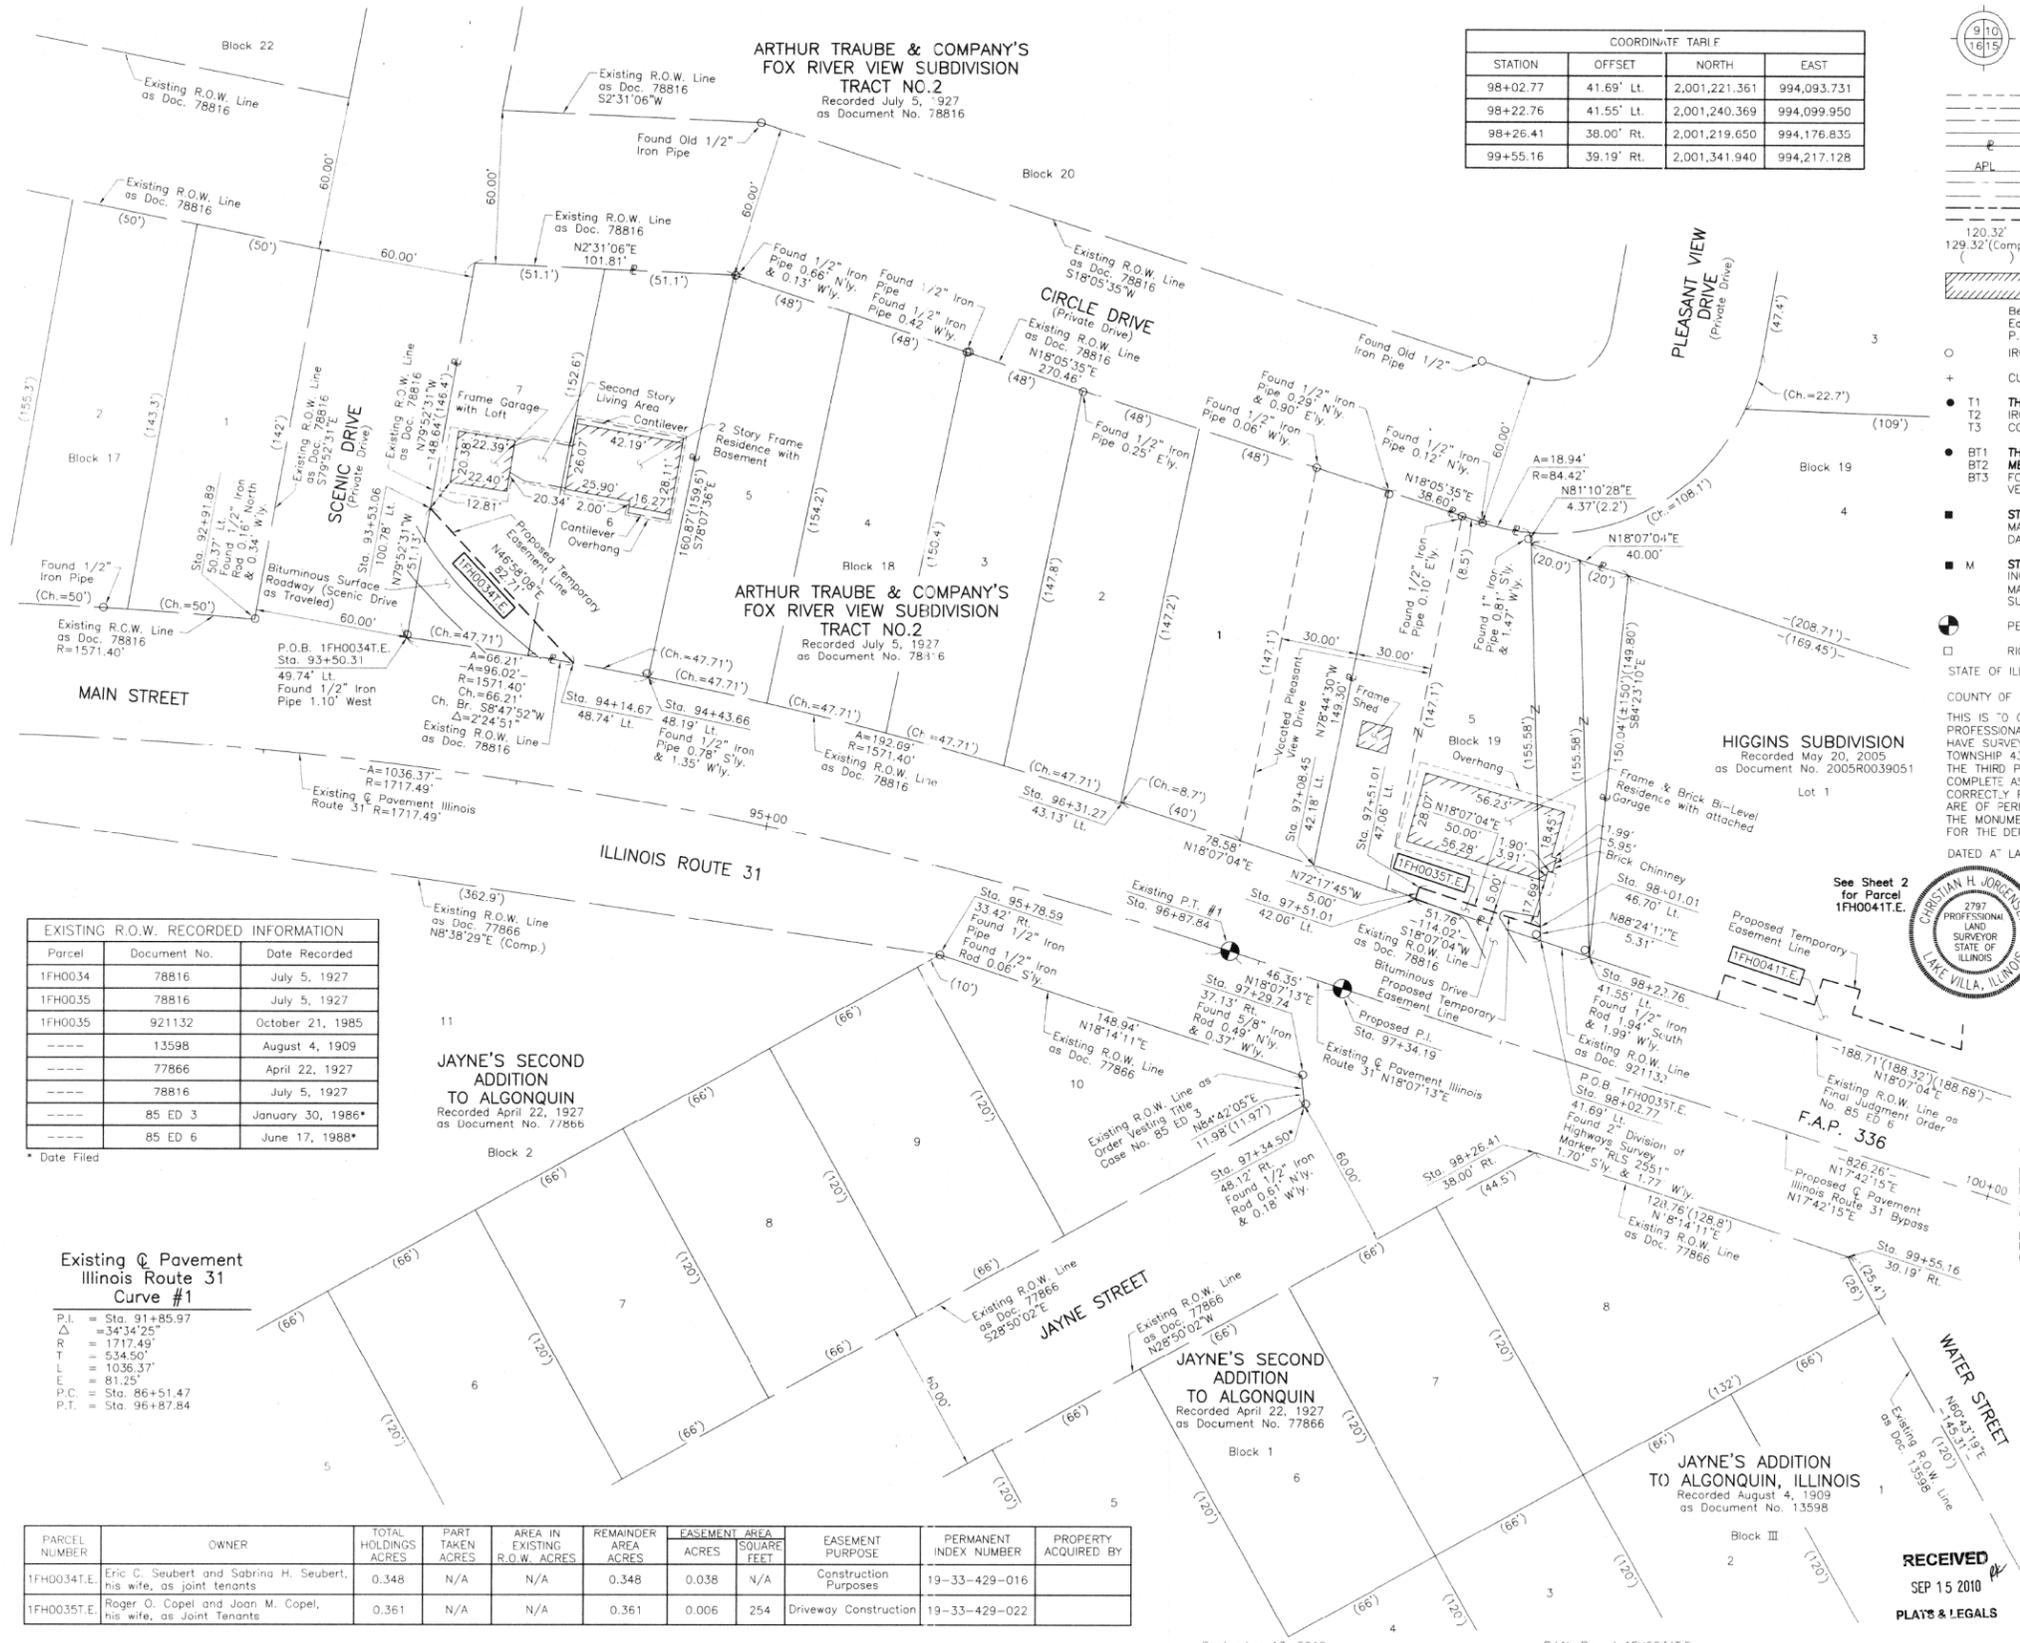

EXISTING R.O.W. RECORDED INFORMATION		
Parcel	Document No.	Date Recorded
1FH0034	78816	July 5, 1927
1FH0035	78816	July 5, 1927
1FH0035	921132	October 21, 1985
----	13598	August 4, 1909
----	77866	April 22, 1927
----	78816	July 5, 1927
----	85 ED 3	January 30, 1986*
----	85 ED 6	June 17, 1988*

Existing & Pavement Illinois Route 31 Curve #1
 P.I. = Sta. 91+85.97
 Δ = 34°34'25"
 R = 1717.49'
 T = 534.50'
 L = 1036.37'
 E = 81.25'
 P.C. = Sta. 86+51.47
 P.T. = Sta. 96+87.84

PARCEL NUMBER	OWNER	TOTAL HOLDINGS ACRES	PART TAKEN ACRES	AREA IN EXISTING R.O.W. ACRES	REMAINDER AREA ACRES	EASEMENT ACRES	AREA SQUARE FEET	EASEMENT PURPOSE	PERMANENT INDEX NUMBER	PROPERTY ACQUIRED BY
1FH0034T.E.	Eric C. Seubert and Sabrina H. Seubert, his wife, as joint tenants	0.348	N/A	N/A	0.348	0.038	N/A	Construction Purposes	19-33-429-016	
1FH0035T.E.	Roger O. Copel and Joan M. Copel, his wife, as Joint Tenants	0.361	N/A	N/A	0.361	0.006	254	Driveway Construction	19-33-429-022	

Bearings are referenced to the Illinois Coordinate System NAD83 (1997) East Zone at Found Geodetic Survey Control Monuments "MCH31 1A", P.I.D. AJ2855 and "Algonquin", P.I.D. AJ2845.

IRON PIPE OR ROD FOUND "MAG" NAIL SET
 ○ CUT CROSS FOUND OR SET ● 5/8" REBAR SET

● T1 THESE STAKES REFERENCE FOUND OR SET MONUMENTATION. SET 5/8 INCH IRON ROD FLUSH WITH GROUND TO THE FOUND IRON STAKE, IDENTIFIED BY COLORED PLASTIC CAP BEARING SURVEYORS REGISTRATION NUMBER.
 ● T2
 ● T3

● BT1 THESE STAKES, IN CULTIVATED AREAS, REFERENCE FOUND OR SET MONUMENTATION. BURIED 5/8 INCH IRON ROD 20 INCHES BELOW GROUND TO THE FOUND IRON STAKE IDENTIFIED BY COLORED PLASTIC CAP BEARING SURVEYORS REGISTRATION NUMBER.
 ● BT2
 ● BT3

■ STAKING OF PROPOSED RIGHT OF WAY. SET DIVISION OF HIGHWAYS SURVEY MARKER TO MONUMENT THE POSITION SHOWN, IDENTIFIED BY INSCRIPTION DATA AND SURVEYORS REGISTRATION NUMBER.

■ M STAKING OF PROPOSED RIGHT OF WAY IN CULTIVATED AREAS. BURIED 5/8 INCH METAL ROD 20 INCHES BELOW GROUND TO MARK FUTURE SURVEY MARKER POSITION IDENTIFIED BY COLORED PLASTIC CAP BEARING SURVEYORS REGISTRATION NUMBER.

● PERMANENT SURVEY MARKER, I.D.O.T. STD 2135 (TO BE SET BY OTHERS)

□ RIGHT OF WAY STAKING PROPOSED TO BE SET.

STATE OF ILLINOIS }
 COUNTY OF LAKE }
 THIS IS TO CERTIFY THAT WE, JORGENSEN & ASSOCIATES, INC., AN ILLINOIS PROFESSIONAL DESIGN FIRM LAND SURVEYING CORPORATION, NUMBER 184-2771, HAVE SURVEYED THE PLAT OF HIGHWAYS SHOWN HEREON BETWEEN SECTION 33, TOWNSHIP 43N., RANGE 8E. AND SECTION 34, TOWNSHIP 43N., RANGE 8E., OF THE THIRD PRINCIPAL MERIDIAN, McHENRY COUNTY, THAT THE SURVEY IS TRUE AND COMPLETE AS SHOWN TO THE BEST OF MY KNOWLEDGE AND BELIEF, THAT THE PLAT CORRECTLY REPRESENTS SAID SURVEY, THAT ALL MONUMENTS FOUND AND ESTABLISHED ARE OF PERMANENT QUALITY AND OCCUPY THE POSITIONS SHOWN THEREON AND THAT THE MONUMENTS ARE SUFFICIENT TO ENABLE THE SURVEY TO BE RETRACED, MADE FOR THE DEPARTMENT OF TRANSPORTATION, STATE OF ILLINOIS.
 DATED AT LAKE VILLA, ILLINOIS THIS 23RD DAY OF DECEMBER 2010 A.D.

CHRISTIAN H. JORGENSEN
 2797 PROFESSIONAL LAND SURVEYOR STATE OF ILLINOIS
 LAKE VILLA, ILLINOIS

COORDINATE TABLE

STATION	OFFSET	NORTH	EAST
92+91.89	50.37' Lt.	2,000,716.500	993,969.117
93+50.31	49.74' Lt.	2,000,776.235	993,975.917
93+53.06	100.78' Lt.	2,000,785.233	993,925.585
94+14.67	48.74' Lt.	2,000,841.662	993,986.043
94+43.66	48.19' Lt.	2,000,870.972	993,991.501
95+78.59	33.42' Rt.	2,000,866.109	994,099.886
96+31.27	43.13' Lt.	2,001,057.321	994,040.058
97+08.45	42.18' Lt.	2,001,132.006	994,064.494
97+29.74	37.13' Rt.	2,001,127.573	994,146.497
97+51.01	47.06' Lt.	2,001,173.692	994,072.873
98+01.01	46.70' Lt.	2,001,221.213	994,088.422

*Back Tangent Extend Forward JORGENSEN & ASSOCIATES, INC. 120 PARK AVENUE LAKE VILLA, ILLINOIS 60046 (847) 356-3371 SHEET 1 IS A COVER SHEET AND IS NOT RECORDED.

ROUTE F.A.P. 336 (ILLINOIS ROUTE 31 BYPASS) SECTION 96-00209-00-PV COUNTY McHENRY JOB NO. R-91-022-03 RECORDING: RECORDED ON AS DOCUMENT NO.


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USER NAME	DESIGNED	REVISED
akw	-	-
JORGENSEN & ASSOC.	-	-
CJ	-	-
	-	-

STATE OF ILLINOIS DEPARTMENT OF TRANSPORTATION

PLAT OF HIGHWAYS
 SCALE: GRAPHIC SHEET NO. 3 OF 49 SHEETS STA. TO STA.

O.R. RTE.	SECTION	COUNTY	TOTAL SHEETS	SHEET NO.
0003	18A-2	McHENRY	825	412
CONTRACT NO. 60F72				
FED. ROAD DIST. NO. 1 ILLINOIS FED. AID PROJECT				

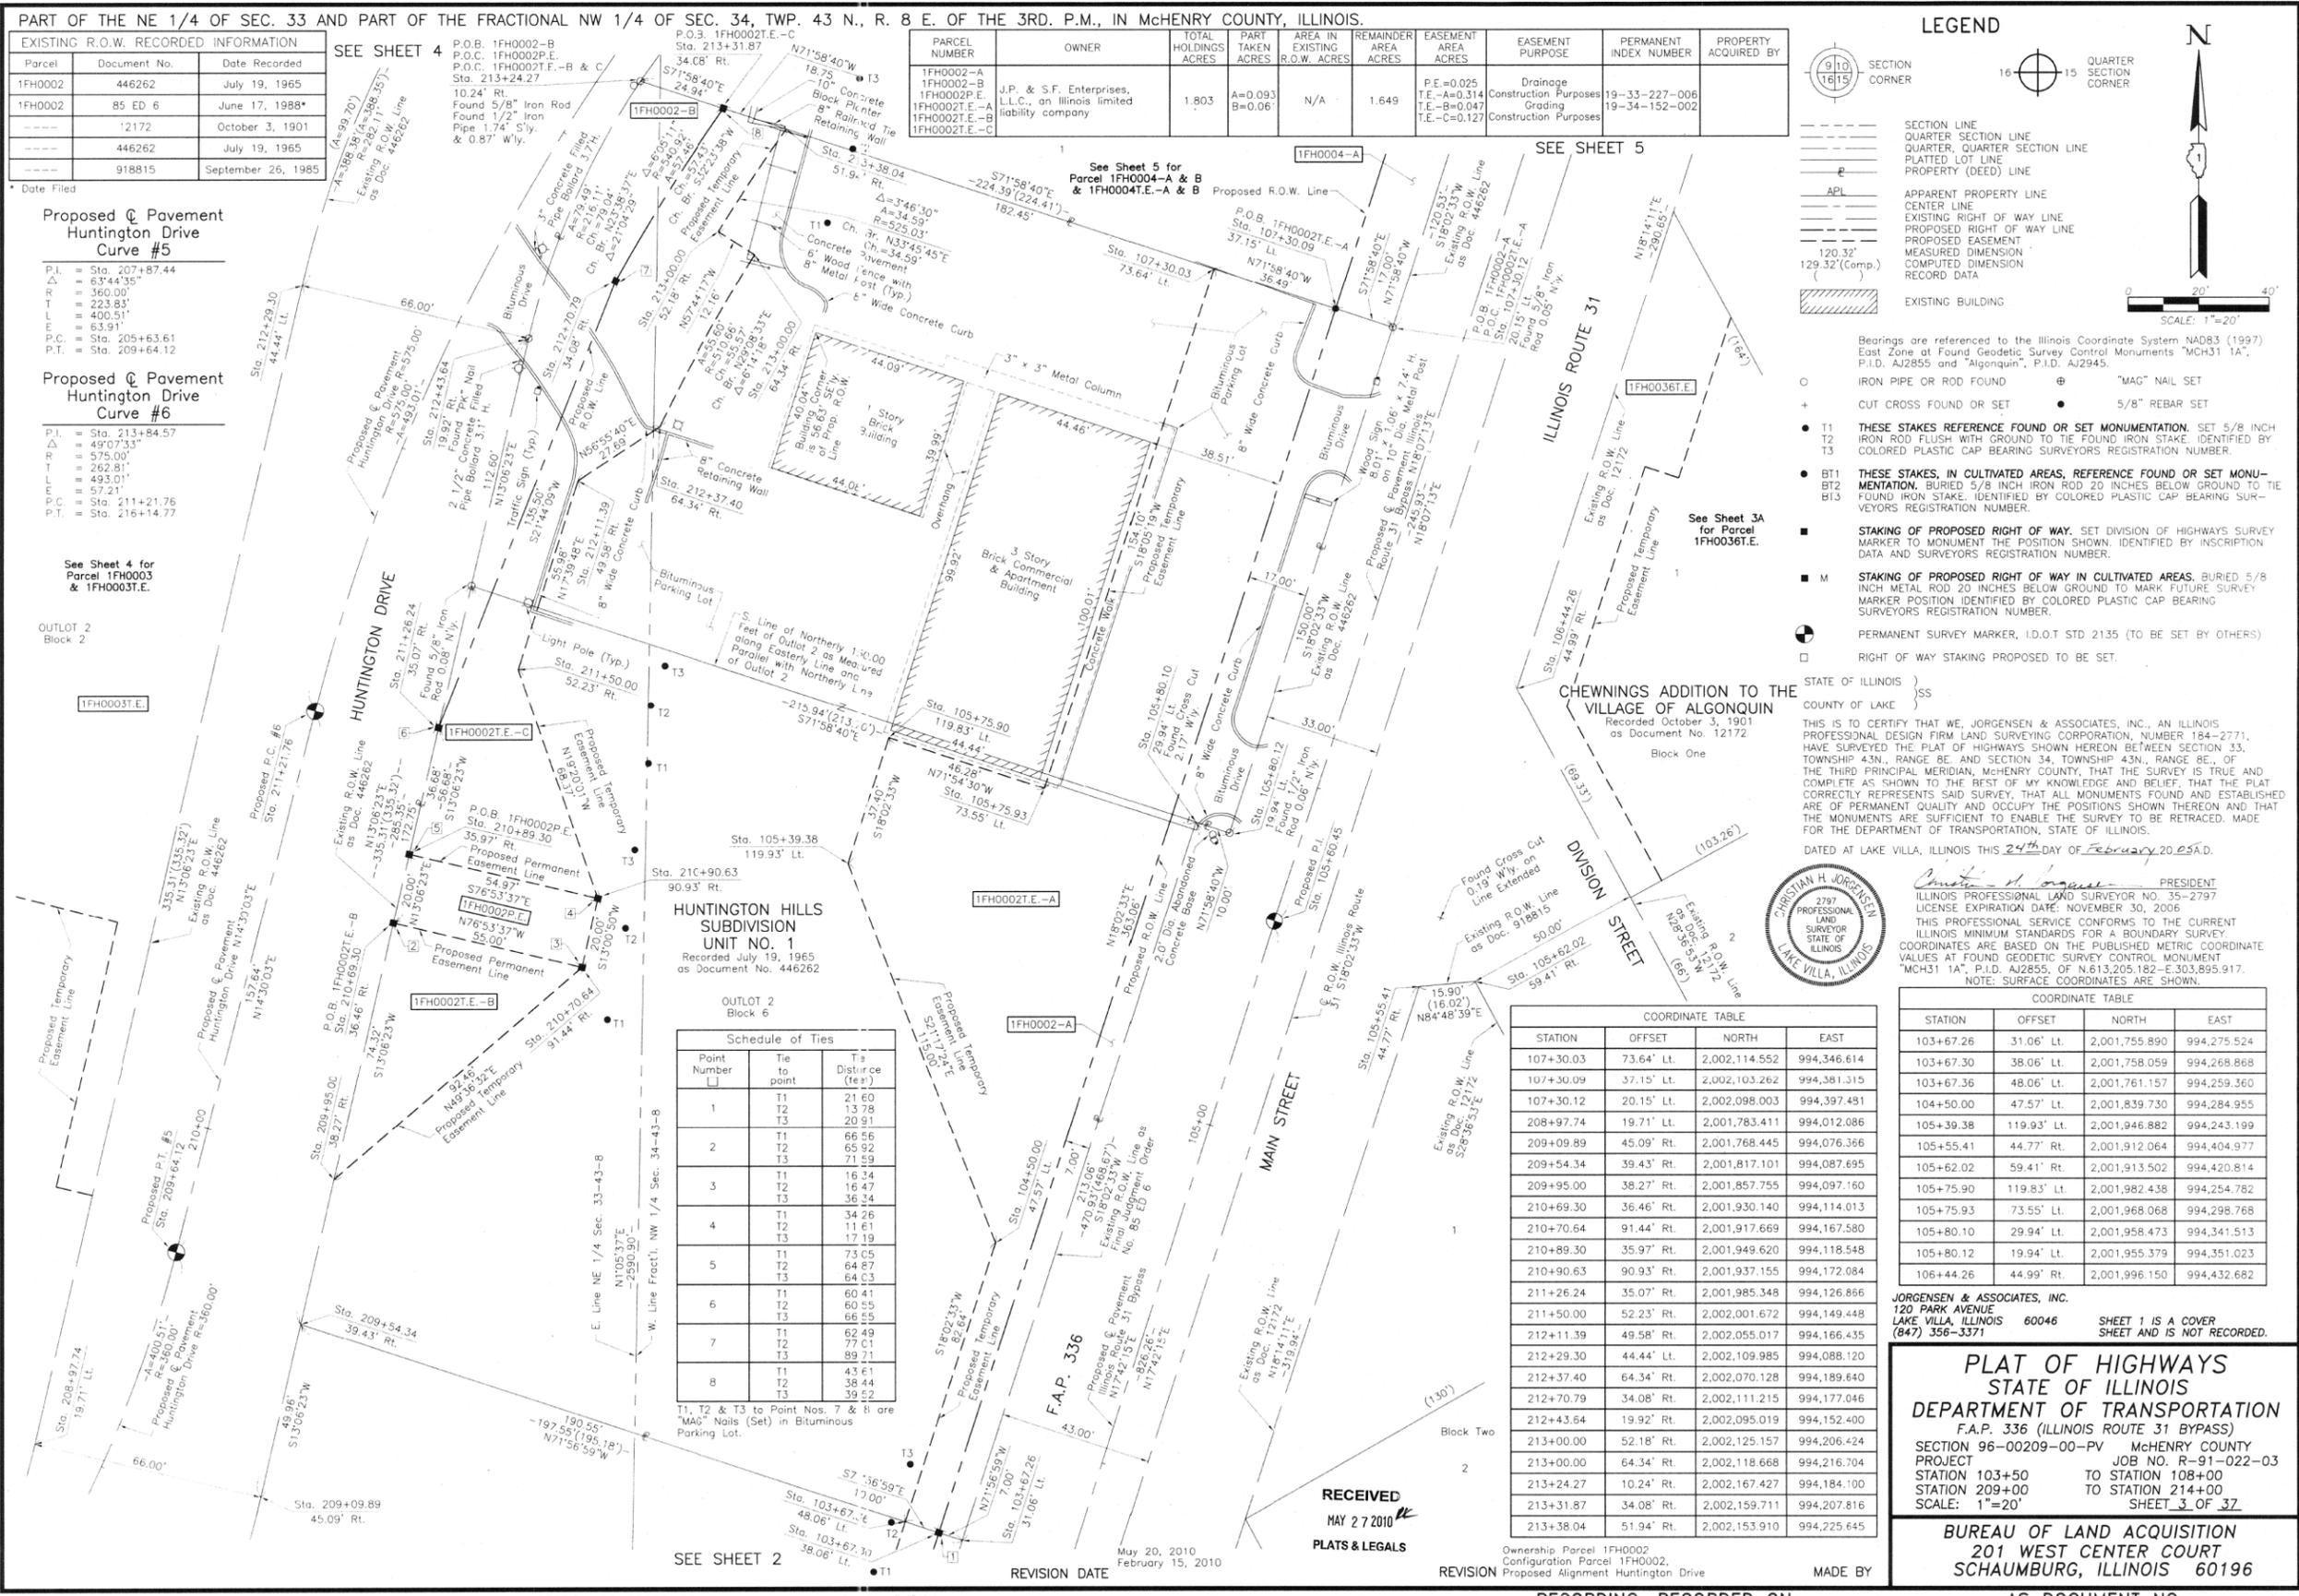

EXISTING R.O.W. RECORDED INFORMATION

Parcel	Document No.	Date Recorded
1FH0002	446262	July 19, 1965
1FH0002	85 ED 6	June 17, 1988*
---	12172	October 3, 1901
---	446262	July 19, 1965
---	918815	September 26, 1985

Proposed Pavement Huntington Drive Curve #5

P.I.	= Sta. 207+87.44
P.T.	= Sta. 207+87.44
T.P.	= Sta. 207+87.44
L	= 360.00'
T	= 223.83'
M	= 400.51'
C	= 63.91'
P.C.	= Sta. 205+63.61
P.T.	= Sta. 209+64.12

Proposed Pavement Huntington Drive Curve #6

P.I.	= Sta. 213+84.57
P.T.	= Sta. 213+84.57
T.P.	= Sta. 213+84.57
L	= 360.00'
T	= 262.81'
M	= 493.01'
C	= 57.21'
P.C.	= Sta. 211+21.76
P.T.	= Sta. 216+14.77

See Sheet 4 for Parcel 1FH0003 & 1FH0003T.E.

OUTLOT 2 Block 2

1FH0003T.E.

1FH0002T.E.-C

1FH0002T.E.-B

1FH0002T.E.-A

1FH0002T.E.-A

SEE SHEET 4

Proposed Pavement Huntington Drive Curve #5

Proposed Pavement Huntington Drive Curve #6

See Sheet 4 for Parcel 1FH0003 & 1FH0003T.E.

OUTLOT 2 Block 2

1FH0003T.E.

1FH0002T.E.-C

1FH0002T.E.-B

1FH0002T.E.-A

1FH0002T.E.-A

SEE SHEET 5

Proposed Pavement Huntington Drive Curve #5

Proposed Pavement Huntington Drive Curve #6

See Sheet 4 for Parcel 1FH0003 & 1FH0003T.E.

OUTLOT 2 Block 2

1FH0003T.E.

1FH0002T.E.-C

1FH0002T.E.-B

1FH0002T.E.-A

1FH0002T.E.-A

PARCEL INFORMATION

PARCEL NUMBER	OWNER	TOTAL HOLDINGS ACRES	PART TAKEN ACRES	AREA IN EXISTING R.O.W. ACRES	REMAINDER AREA ACRES	EASEMENT AREA ACRES	EASEMENT PURPOSE	PERMANENT INDEX NUMBER	PROPERTY ACQUIRED BY
1FH0002-A	J.P. & S.F. Enterprises, L.L.C., an Illinois limited liability company	1.803	A=0.093 B=0.06	N/A	1.649	P.E.=0.025 T.E.=A=0.314 T.E.=B=0.047 T.E.=C=0.127	Drainage Construction Purposes Grading Construction Purposes	19-33-227-006 19-34-152-002	

Proposed Pavement Huntington Drive Curve #5

Proposed Pavement Huntington Drive Curve #6

See Sheet 4 for Parcel 1FH0003 & 1FH0003T.E.

OUTLOT 2 Block 2

1FH0003T.E.

1FH0002T.E.-C

1FH0002T.E.-B

1FH0002T.E.-A

1FH0002T.E.-A

SEE SHEET 5

Proposed Pavement Huntington Drive Curve #5

Proposed Pavement Huntington Drive Curve #6

See Sheet 4 for Parcel 1FH0003 & 1FH0003T.E.

OUTLOT 2 Block 2

1FH0003T.E.

1FH0002T.E.-C

1FH0002T.E.-B

1FH0002T.E.-A

1FH0002T.E.-A

LEGEND

(Symbol)	SECTION CORNER
(Symbol)	QUARTER SECTION CORNER
(Symbol)	SECTION LINE
(Symbol)	QUARTER SECTION LINE
(Symbol)	EXISTING RIGHT OF WAY LINE
(Symbol)	PROPOSED RIGHT OF WAY LINE
(Symbol)	PROPOSED EASEMENT
(Symbol)	MEASURED DIMENSION
(Symbol)	COMPUTED DIMENSION
(Symbol)	RECORD DATA
(Symbol)	EXISTING BUILDING

Proposed Pavement Huntington Drive Curve #5

Proposed Pavement Huntington Drive Curve #6

See Sheet 4 for Parcel 1FH0003 & 1FH0003T.E.

OUTLOT 2 Block 2

1FH0003T.E.

1FH0002T.E.-C

1FH0002T.E.-B

1FH0002T.E.-A

1FH0002T.E.-A

LEGEND

Proposed Pavement Huntington Drive Curve #5

Proposed Pavement Huntington Drive Curve #6

See Sheet 4 for Parcel 1FH0003 & 1FH0003T.E.

OUTLOT 2 Block 2

1FH0003T.E.

1FH0002T.E.-C

1FH0002T.E.-B

1FH0002T.E.-A

1FH0002T.E.-A

BY	DATE	MAKE	CHECKED	INKED

ROW	PLAT	NOTEBOOK

Schedule of Ties

Point Number	Tie to point	Tie Distance (feet)
1	T1	21.60
	T2	13.78
	T3	20.91
2	T1	66.66
	T2	65.82
	T3	71.59
3	T1	16.34
	T2	16.47
	T3	36.24
4	T1	34.26
	T2	11.61
	T3	17.19
5	T1	73.05
	T2	64.87
	T3	64.03
6	T1	60.41
	T2	60.55
	T3	66.55
7	T1	62.49
	T2	77.01
	T3	89.71
8	T1	43.61
	T2	38.44
	T3	39.52

T1, T2 & T3 to Point Nos. 7 & 8 are "MAG" Nails (Set) in Bituminous Parking Lot.

COORDINATE TABLE

STATION	OFFSET	NORTH	EAST
107+30.03	73.64' Lt.	2,002,114.552	994,346.614
107+30.09	37.15' Lt.	2,002,103.262	994,381.315
107+30.12	20.15' Lt.	2,002,098.003	994,397.481
208+97.74	19.71' Lt.	2,001,783.411	994,012.086
209+09.89	45.09' Rt.	2,001,768.445	994,076.366
209+54.34	39.43' Rt.	2,001,817.101	994,087.695
209+95.00	38.27' Rt.	2,001,857.755	994,097.160
210+69.30	36.46' Rt.	2,001,930.140	994,114.013
210+70.64	91.44' Rt.	2,001,917.669	994,167.580
210+89.30	35.97' Rt.	2,001,949.620	994,118.548
210+90.63	90.93' Rt.	2,001,937.155	994,172.084
211+26.24	35.07' Rt.	2,001,985.348	994,126.856
211+50.00	52.23' Rt.	2,002,001.672	994,149.448
212+11.39	49.58' Rt.	2,002,055.017	994,166.435
212+29.30	44.44' Lt.	2,002,109.985	994,088.120
212+37.40	64.34' Rt.	2,002,070.128	994,189.640
212+70.79	34.08' Rt.	2,002,111.215	994,177.046
212+43.64	19.92' Rt.	2,002,095.019	994,152.400
213+00.00	52.18' Rt.	2,002,125.157	994,206.424
213+00.00	64.34' Rt.	2,002,116.668	994,216.704
213+24.27	10.24' Rt.	2,002,167.427	994,184.100
213+31.87	34.08' Rt.	2,002,159.711	994,207.816
213+38.04	51.94' Rt.	2,002,153.910	994,225.645

COORDINATE TABLE

STATION	OFFSET	NORTH	EAST
103+67.26	31.06' Lt.	2,001,755.890	994,275.524
103+67.30	38.06' Lt.	2,001,758.059	994,268.868
103+67.36	48.06' Lt.	2,001,761.157	994,259.360
104+50.00	47.57' Lt.	2,001,839.730	994,284.955
105+39.38	119.93' Lt.	2,001,946.882	994,243.199
105+55.41	44.77' Rt.	2,001,912.064	994,404.977
105+62.02	59.41' Rt.	2,001,913.502	994,420.814
105+75.90	119.83' Lt.	2,001,982.458	994,254.782
105+75.93	73.55' Lt.	2,001,968.068	994,298.768
105+80.10	29.94' Lt.	2,001,958.473	994,341.513
105+80.12	19.94' Lt.	2,001,955.379	994,351.023
106+44.26	44.99' Rt.	2,001,996.150	994,432.682

JORGENSEN & ASSOCIATES, INC.
120 PARK AVENUE
LAKE VILLA, ILLINOIS 60046
(847) 356-3371

PLAT OF HIGHWAYS
STATE OF ILLINOIS
DEPARTMENT OF TRANSPORTATION
F.A.P. 336 (ILLINOIS ROUTE 31 BYPASS)
SECTION 96-00209-00-PV McHENRY COUNTY
PROJECT JOB NO. R-91-022-03
STATION 103+50 TO STATION 108+00
STATION 209+00 TO STATION 214+00
SCALE: 1"=20' SHEET 3 OF 37

BUREAU OF LAND ACQUISITION
201 WEST CENTER COURT
SCHAUMBURG, ILLINOIS 60196


ROUTE F.A.P. 336 (ILLINOIS ROUTE 31 BYPASS) SECTION 96-00209-00-PV COUNTY McHENRY JOB NO. R-91-022-03 RECORDING: RECORDED ON AS DOCUMENT NO.

FILE NAME	USER NAME	DESIGNED	REVISED	STATE OF ILLINOIS DEPARTMENT OF TRANSPORTATION	PLAT OF HIGHWAYS	SCALE: GRAPHIC	SHEET NO. 4 OF 49 SHEETS	STA. TO STA.	O.R. RTE.	SECTION	COUNTY	TOTAL SHEETS	SHEET NO.
...\\D160F72-sht-PH-04.dgn	akw	-	-	STATE OF ILLINOIS DEPARTMENT OF TRANSPORTATION	PLAT OF HIGHWAYS	SCALE: GRAPHIC	SHEET NO. 4 OF 49 SHEETS	STA. TO STA.	0003	18A-2	McHENRY	825	413
		DRAWN - JORGENSEN & ASSOC.	REVISED -						FED. ROAD DIST. NO. 1 ILLINOIS FED. AID PROJECT				CONTRACT NO. 60F72
		PLOT SCALE = 70.0000' / in.	REVISED -										
		PLOT DATE = 5/2/2012	REVISED -										

PART OF THE FRACTIONAL NW 1/4 OF SEC. 34, TWP. 43 N., R. 8 E. OF THE 3RD. P.M., IN McHENRY COUNTY, ILLINOIS.

PARCEL NUMBER	OWNER	TOTAL HOLDINGS ACRES	PART TAKEN ACRES	AREA IN EXISTING R.O.W. ACRES	REMAINDER AREA ACRES	EASEMENT AREA ACRES	EASEMENT PURPOSE	PERMANENT INDEX NUMBER	PROPERTY ACQUIRED BY
1FH0036T.E.	North Star Trust Company as successor to Harris Trust and Savings Bank as Trustee under Trust Agreement dated August 2, 2002 and known as Trst No. HTX7047	0.281	N/A	N/A	0.281	0.073	Construction Purposes	19-34-155-001	

LEGEND

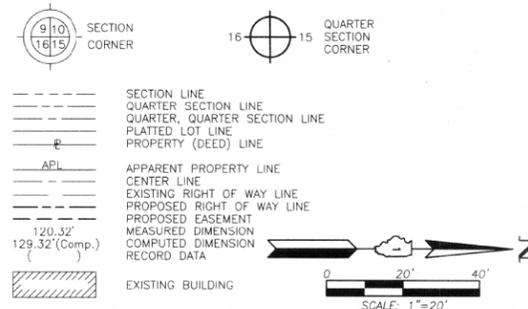

- Bearings are referenced to the Illinois Coordinate System NAD83 (1997) East Zone of Found Geodetic Survey Control Monuments "MCH31 1A", P.I.D. AJ2855 and "Algonquin", P.I.D. AJ2945.
- IRON PIPE OR ROD FOUND
- CUT CROSS FOUND OR SET
- THESE STAKES REFERENCED FOUND OR SET MONUMENTATION. SET 5/8 INCH IRON ROD FLUSH WITH GROUND TO THE FOUND IRON STAKE. IDENTIFIED BY COLORED PLASTIC CAP BEARING SURVEYORS REGISTRATION NUMBER.
- THESE STAKES, IN CULTIVATED AREAS, REFERENCED FOUND OR SET MONUMENTATION. BURIED 5/8 INCH IRON ROD 20 INCHES BELOW GROUND TO THE FOUND IRON STAKE. IDENTIFIED BY COLORED PLASTIC CAP BEARING SURVEYORS REGISTRATION NUMBER.
- STAKING OF PROPOSED RIGHT OF WAY. SET DIVISION OF HIGHWAYS SURVEY MARKER TO MONUMENT THE POSITION SHOWN. IDENTIFIED BY INSCRIPTION DATA AND SURVEYORS REGISTRATION NUMBER.
- STAKING OF PROPOSED RIGHT OF WAY IN CULTIVATED AREAS. BURIED 5/8 INCH METAL ROD 20 INCHES BELOW GROUND TO MARK FUTURE SURVEY MARKER POSITION IDENTIFIED BY COLORED PLASTIC CAP BEARING SURVEYORS REGISTRATION NUMBER.
- PERMANENT SURVEY MARKER, I.D.O.T STD 2135 (TO BE SET BY OTHERS)
- RIGHT OF WAY STAKING PROPOSED TO BE SET.

STATE OF ILLINOIS }
 COUNTY OF LAKE }
 THIS IS TO CERTIFY THAT WE, JORGENSEN & ASSOCIATES, INC., AN ILLINOIS PROFESSIONAL DESIGN FIRM, LAND SURVEYING CORPORATION, NUMBER 184-2771, HAVE SURVEYED THE PLAT OF HIGHWAYS SHOWN HEREON IN SECTION 34, TOWNSHIP 43N., RANGE 8E., OF THE THIRD PRINCIPAL MERIDIAN, McHENRY COUNTY, THAT THE SURVEY IS TRUE AND COMPLETE AS SHOWN TO THE BEST OF MY KNOWLEDGE AND BELIEF, THAT THE PLAT CORRECTLY REPRESENTS SAID SURVEY, THAT ALL MONUMENTS FOUND AND ESTABLISHED ARE OF PERMANENT QUALITY AND OCCUPY THE POSITIONS SHOWN THEREON AND THAT THE MONUMENTS ARE SUFFICIENT TO ENABLE THE SURVEY TO BE RETRACED. MADE FOR THE DEPARTMENT OF TRANSPORTATION, STATE OF ILLINOIS, DATED AT LAKE VILLA, ILLINOIS THIS 25th DAY OF March 2010 A.D.




Christian H. Jorgensen, PRESIDENT
 ILLINOIS PROFESSIONAL LAND SURVEYOR NO. 35-2797
 LICENSE EXPIRATION DATE: NOVEMBER 30, 2010
 THIS PROFESSIONAL SERVICE CONFORMS TO THE CURRENT ILLINOIS MINIMUM STANDARDS FOR A BOUNDARY SURVEY. COORDINATES ARE BASED ON THE PUBLISHED METRIC COORDINATE VALUES AT FOUND GEODETIC SURVEY CONTROL MONUMENT "MCH31 1A", P.I.D. AJ2855, OF N.613,205.182-E.303,895.917. NOTE: SURFACE COORDINATES ARE SHOWN.

STATION	OFFSET	NORTH	EAST
105+55.41	44.77' Rt.	2,001,912.064	994,404.977
105+62.02	59.41' Rt.	2,001,913.502	994,420.814
105+80.10	29.94' Lt.	2,001,958.473	994,341.513
105+80.12	19.94' Lt.	2,001,955.379	994,351.023
105+96.25	96.00' Rt.	2,001,934.652	994,466.233
106+03.54	102.84' Rt.	2,001,939.455	994,475.003
106+43.87	60.00' Rt.	2,001,991.101	994,446.828
106+44.26	44.99' Rt.	2,001,996.150	994,432.682
107+15.00	60.00' Rt.	2,002,058.707	994,468.951
107+15.00	70.00' Rt.	2,002,055.597	994,478.455
107+62.52	70.00' Rt.	2,002,100.760	994,493.234
107+85.76	45.27' Lt.	2,002,130.541	994,476.962
108+52.01	18.75' Lt.	2,002,212.606	994,434.812

JORGENSEN & ASSOCIATES, INC.
 120 PARK AVENUE
 LAKE VILLA, ILLINOIS 60046
 (847) 356-3371

PLAT OF HIGHWAYS
 STATE OF ILLINOIS
 DEPARTMENT OF TRANSPORTATION
 F.A.P. 336 (ILLINOIS ROUTE 31 BYPASS)
 SECTION 96-00209-00-PV McHENRY COUNTY
 PROJECT JOB NO. R-91-022-03
 STATION 105+00 TO STATION 109+50
 SCALE: 1"=20'
 SHEET 3A OF 37

BUREAU OF LAND ACQUISITION
 201 WEST CENTER COURT
 SCHAUMBURG, ILLINOIS 60196

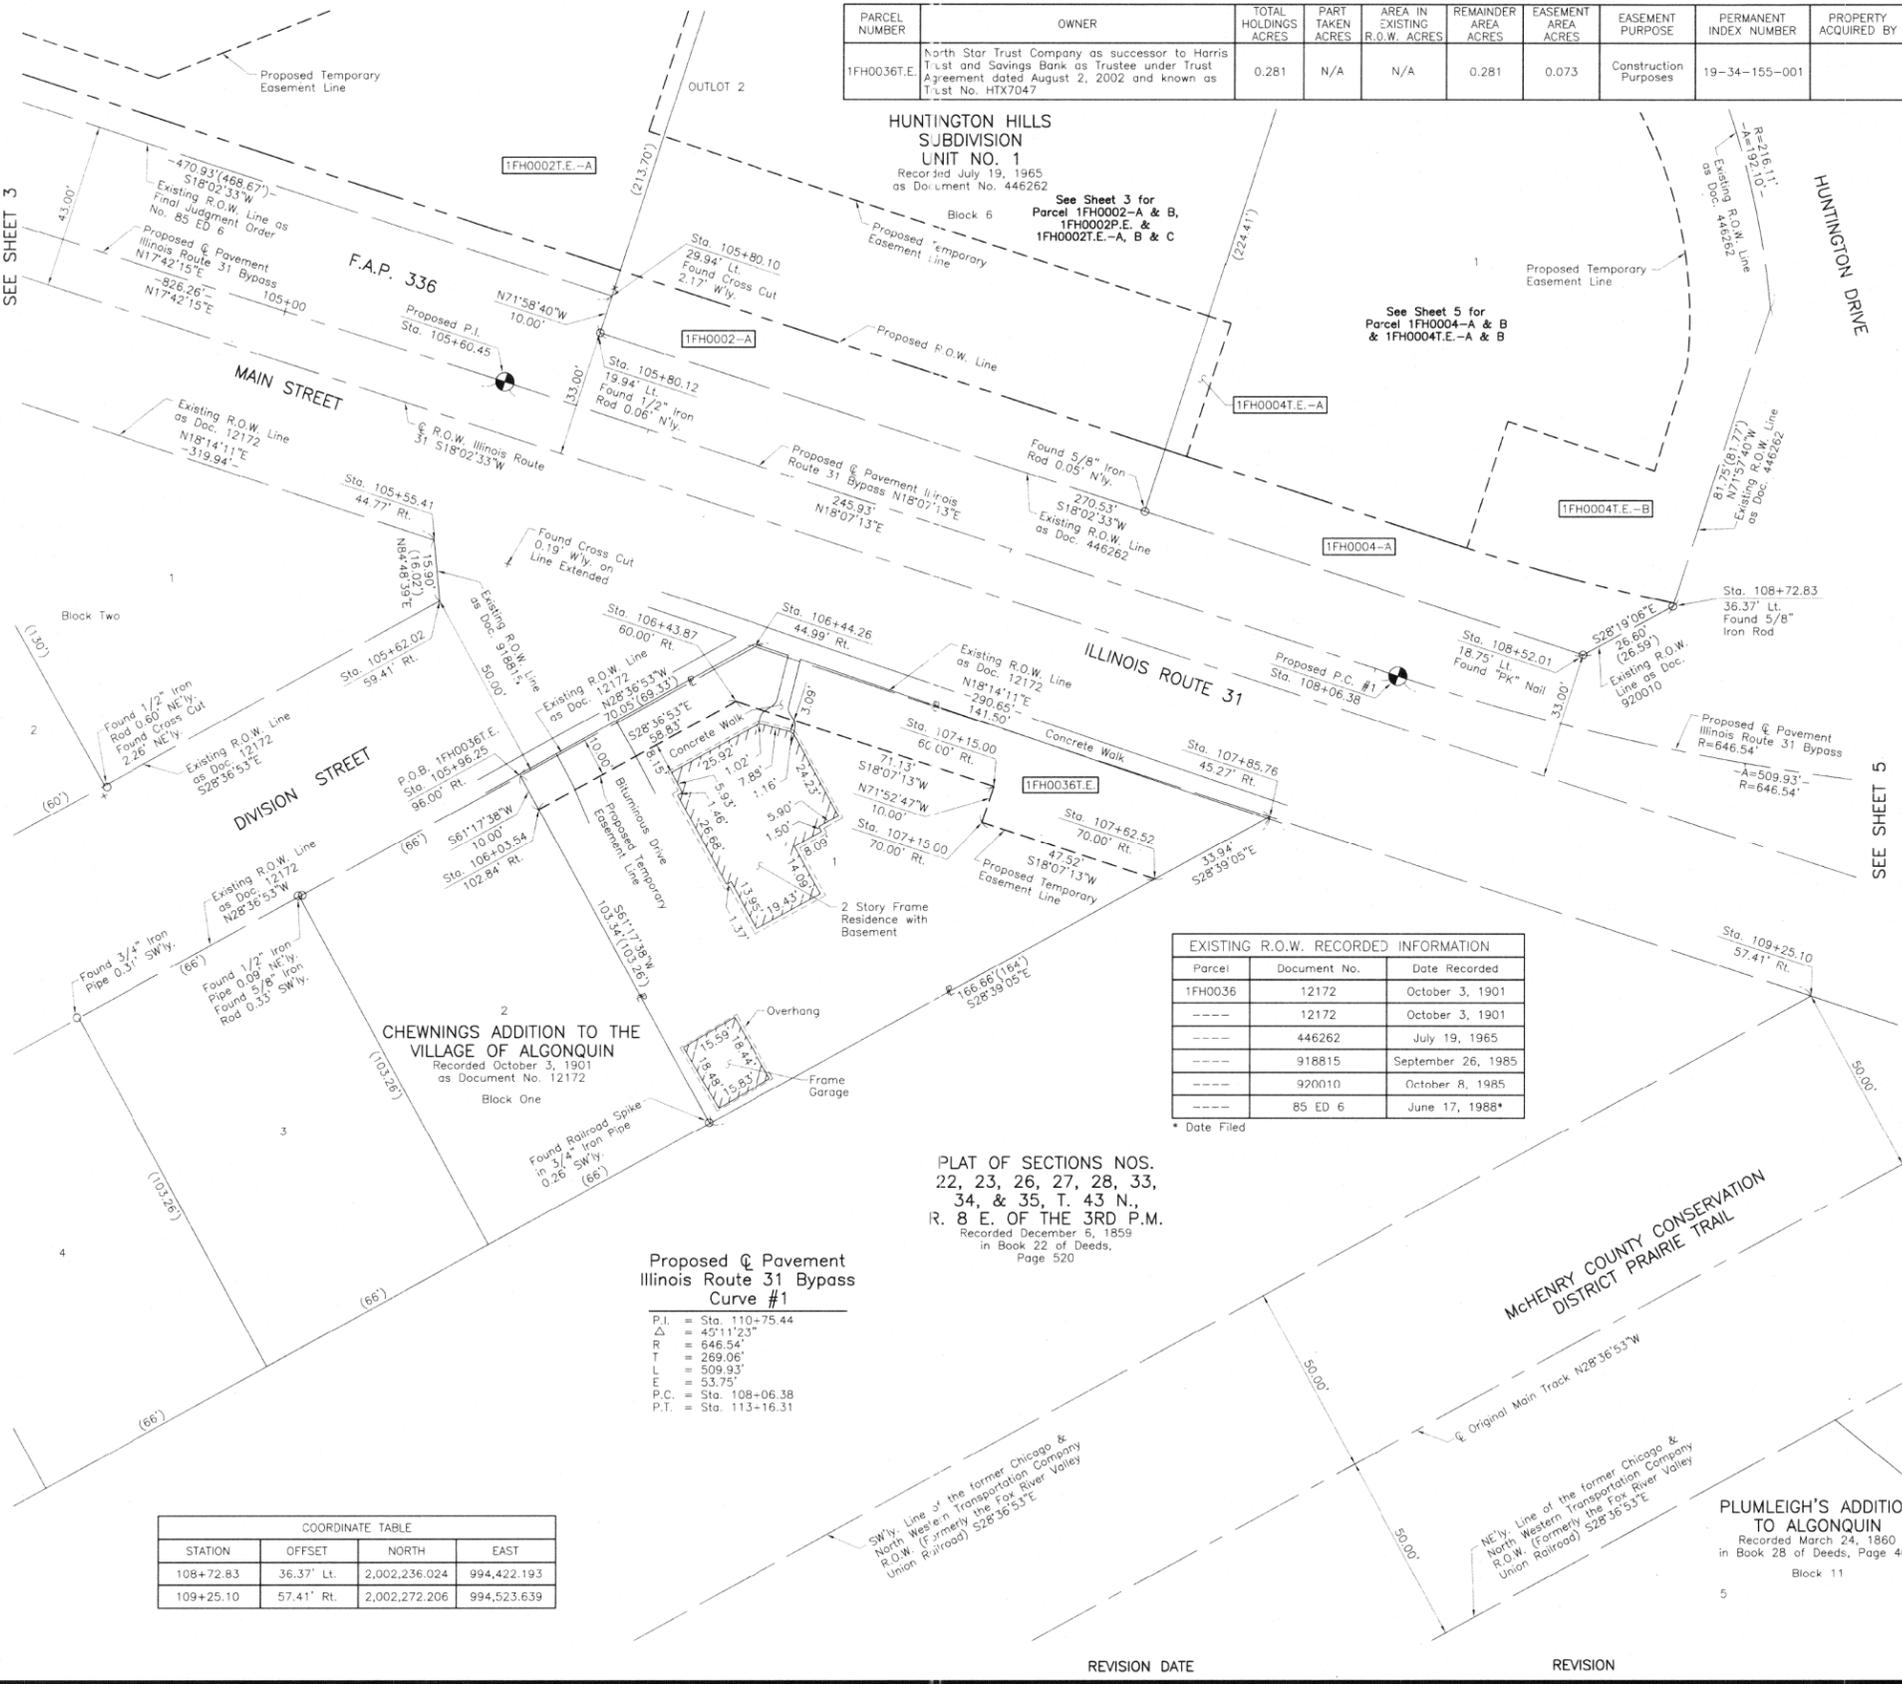

Parcel	Document No.	Date Recorded
1FH0036	12172	October 3, 1901
-----	12172	October 3, 1901
-----	446262	July 19, 1965
-----	918815	September 26, 1985
-----	920010	October 8, 1985
-----	85 ED 6	June 17, 1988*

PLAT OF SECTIONS NOS.
 22, 23, 26, 27, 28, 33,
 34, & 35, T. 43 N.,
 R. 8 E. OF THE 3RD P.M.
 Recorded December 6, 1859
 in Book 22 of Deeds,
 Page 520

Proposed Pavement
 Illinois Route 31 Bypass
 Curve #1
 P.I. = Sta. 110+75.44
 Δ = 45°11'23"
 R = 646.54'
 T = 269.06'
 L = 53.75'
 P.C. = Sta. 108+06.38
 P.T. = Sta. 113+16.31

STATION	OFFSET	NORTH	EAST
108+72.83	36.37' Lt.	2,002,236.024	994,422.193
109+25.10	57.41' Rt.	2,002,272.206	994,523.639

BY	DATE
MADE	
CHECKED	
INKED	
NOTED	
BOOK NO.	

PART OF THE NE 1/4 OF SEC. 33 AND PART OF THE FRACTIONAL NW 1/4 OF SEC. 34, TWP. 43 N., R. 8 E. OF THE 3RD. P.M., IN McHENRY COUNTY, ILLINOIS.

STATION	OFFSET	NORTH	EAST
108+72.83	36.37' Lt.	2,002,236.024	994,422.193
108+72.92	37.25' Lt.	2,002,236.299	994,421.349
108+74.82	16.36' Rt.	2,002,226.846	994,474.157
109+25.10	57.41' Rt.	2,002,272.206	994,523.639
109+57.91	2.85' Lt.	2,002,312.651	994,467.401
109+61.29	43.05' Lt.	2,002,319.081	994,427.592
212+29.30	44.44' Lt.	2,002,109.985	994,088.120
212+43.64	19.92' Rt.	2,002,095.019	994,152.400
213+24.27	10.24' Rt.	2,002,167.427	994,184.100
213+30.87	31.08' Rt.	2,002,160.683	994,204.826
213+36.04	51.94' Rt.	2,002,153.910	994,225.645
214+34.42	51.30' Rt.	2,002,220.605	994,282.481
214+49.91	31.08' Rt.	2,002,245.167	994,278.966
215+16.02	60.32' Rt.	2,002,261.338	994,344.463
215+80.47	19.74' Rt.	2,002,327.955	994,372.655
215+91.69	28.27' Rt.	2,002,325.766	994,386.204

Parcel	Document No.	Date Recorded
1FH0004	446262	July 19, 1965
1FH0004	920010	October 8, 1985
-----	12172	October 3, 1991
-----	446262	July 19, 1965
-----	489647	May 16, 1968
-----	920010	October 8, 1985

PARCEL NUMBER	OWNER	TOTAL HOLDINGS ACRES	PART TAKEN ACRES	AREA IN EXISTING R.O.W. ACRES	REMAINDER AREA ACRES	EASEMENT ACRES	EASEMENT AREA SQUARE FEET	EASEMENT PURPOSE	PERMANENT INDEX NUMBER	PROPERTY ACQUIRED BY
1FH0004-A	First Colonial Bank Northwest, formerly known as Aven Bank, formerly known as Dempster Plaza State Bank as Trustee under Trust dated September 23, 1963 known as Trust No. 822	0.575	A=0.058 B=0.038	N/A	0.485	A=0.005 B=0.140	218	Construction Purposes	19-34-152-001	
1FH0004-B										
1FH0004-E-B										

LEGEND

SECTION CORNER
QUARTER SECTION CORNER
PLATTED LOT LINE
PROPERTY (DEED) LINE
APPARENT PROPERTY LINE
CENTER LINE
EXISTING RIGHT OF WAY LINE
PROPOSED RIGHT OF WAY LINE
PROPOSED EASEMENT
MEASURED DIMENSION
COMPILED DIMENSION
RECORD DATA

EXISTING BUILDING

IRON PIPE OR ROD FOUND
CUT CROSS FOUND OR SET
T1
T2
T3
BT1
BT2
BT3
STAKING OF PROPOSED RIGHT OF WAY
STAKING OF PROPOSED RIGHT OF WAY IN CULTIVATED AREAS

STATE OF ILLINOIS
COUNTY OF LAKE


THIS IS TO CERTIFY THAT WE, JORGENSEN & ASSOCIATES, INC., AN ILLINOIS PROFESSIONAL DESIGN FIRM LAND SURVEYING CORPORATION, NUMBER 184-2771, HAVE SURVEYED THE PLAT OF HIGHWAYS SHOWN HEREON BETWEEN SECTION 33, TOWNSHIP 43N., RANGE 8E. AND SECTION 34, TOWNSHIP 43N., RANGE 8E., OF THE THIRD PRINCIPAL MERIDIAN, McHENRY COUNTY, ILLINOIS, THAT THE SURVEY IS TRUE AND COMPLETE AS SHOWN TO THE BEST OF MY KNOWLEDGE AND BELIEF, THAT THE PLAT CORRECTLY REPRESENTS SAID SURVEY, THAT ALL MONUMENTS FOUND AND ESTABLISHED ARE OF PERMANENT QUALITY AND OCCUPY THE POSITIONS SHOWN THEREON AND THAT THE MONUMENTS ARE SUFFICIENT TO ENABLE THE SURVEY TO BE RETRACED, MADE FOR THE DEPARTMENT OF TRANSPORTATION, STATE OF ILLINOIS.

DATED AT LAKE VILLA, ILLINOIS THIS 24TH DAY OF FEBRUARY 2006 A.D.

CHRISTIAN H. JORGENSEN
PRESIDENT
2797 PROFESSIONAL LAND SURVEYOR
STATE OF ILLINOIS
LICENSE EXPIRATION DATE: NOVEMBER 30, 2006
THIS PROFESSIONAL SERVICE CONFORMS TO THE CURRENT ILLINOIS MINIMUM STANDARDS FOR A BOUNDARY SURVEY.

COORDINATES ARE BASED ON THE PUBLISHED METRIC COORDINATE VALUES AT FOUND GEODETIC SURVEY CONTROL MONUMENT "MCH31 1A", P.I.D. AJ2855, OF N.613.205.182-E.303.895.917.

NOTE: SURFACE COORDINATES ARE SHOWN.

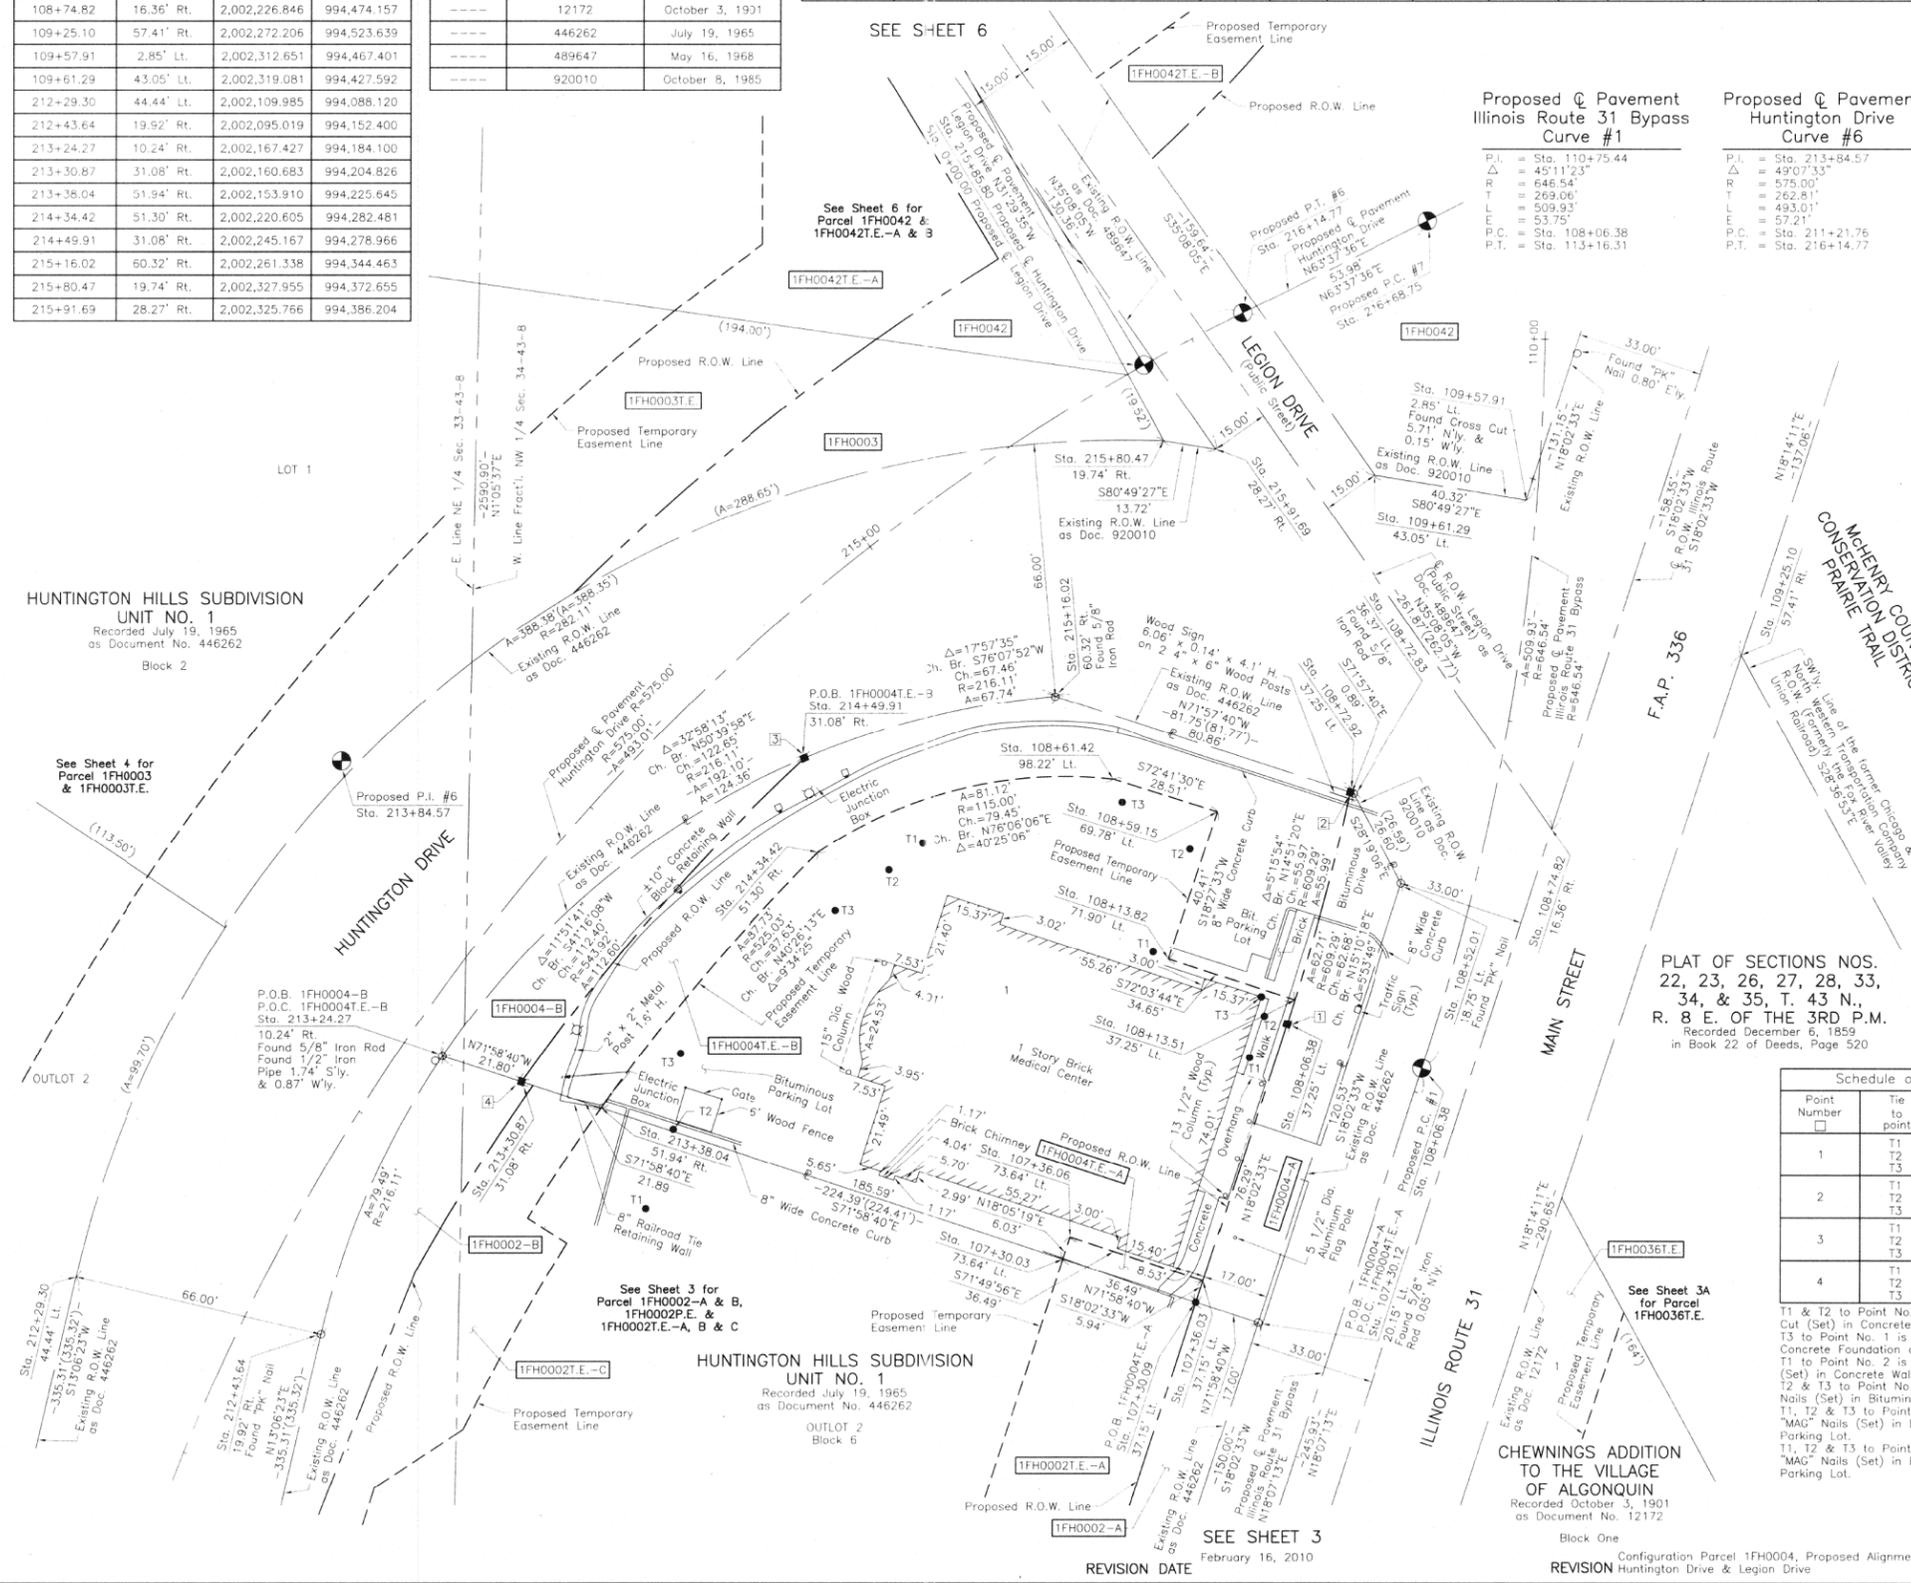

HUNTINGTON HILLS SUBDIVISION
UNIT NO. 1
Recorded July 19, 1965
as Document No. 446262
Block 2

ROW PLAT	MADE	CHECKED	INKED	NO.	BY	DATE

PLAT OF SECTIONS NOS.
22, 23, 26, 27, 28, 33,
34, & 35, T. 43 N.,
R. 8 E. OF THE 3RD P.M.
Recorded December 1, 1989
in Book 22 of Deeds, Page 520

RECEIVED
JUL 0 7 2010
PLATS & LEGALS

Point Number	Tie to point	Tie Distance (feet)
1	T1	6.35
	T2	13.23
	T3	9.92
2	T1	65.99
	T2	44.24
	T3	59.43
3	T1	38.07
	T2	36.56
	T3	40.46
4	T1	46.37
	T2	41.58
	T3	42.26

STATION	OFFSET	NORTH	EAST
107+30.03	73.64' Lt.	2,002,114.552	994,346.614
107+30.09	37.15' Lt.	2,002,103.262	994,381.315
107+30.12	20.15' Lt.	2,002,098.003	994,397.481
107+36.03	37.15' Lt.	2,002,108.908	994,383.154
107+36.06	73.64' Lt.	2,002,120.284	994,348.487
108+06.38	37.25' Lt.	2,002,175.802	994,404.944
108+13.51	37.25' Lt.	2,002,182.202	994,407.000
108+13.82	71.90' Lt.	2,002,192.874	994,374.033
108+52.01	18.75' Lt.	2,002,212.606	994,434.812
108+59.15	69.78' Lt.	2,002,231.207	994,386.828
108+61.42	98.22' Lt.	2,002,239.689	994,359.608

JORGENSEN & ASSOCIATES, INC.
120 PARK AVENUE
LAKE VILLA, ILLINOIS 60046
(847) 356-3371

SHEET 1 IS A COVER SHEET AND IS NOT RECORDED.

PLAT OF HIGHWAYS
STATE OF ILLINOIS
DEPARTMENT OF TRANSPORTATION
F.A.P. 336 (ILLINOIS ROUTE 31 BYPASS)
SECTION 96-00209-00-PV McHENRY COUNTY PROJECT
JOB NO. R-91-022-03
STATION 107+00 TO STATION 110+00
STATION 212+00 TO STATION 217+00
SCALE: 1"=20'
SHEET 5 OF 37

BUREAU OF LAND ACQUISITION
201 WEST CENTER COURT
SCHAUMBURG, ILLINOIS 60196

ROUTE F.A.P. 336 (ILLINOIS ROUTE 31 BYPASS) SECTION 96-00209-00-PV COUNTY McHENRY JOB NO. R-91-022-03 RECORDING: RECORDED ON AS DOCUMENT NO.

FILE NAME = ...\\D160F72-sht-PH-07.dgn	USER NAME = akw	DESIGNED -	REVISED -	STATE OF ILLINOIS DEPARTMENT OF TRANSPORTATION	PLAT OF HIGHWAYS	SCALE: GRAPHIC	SHEET NO. 7 OF 49 SHEETS	STA.	TO STA.	
		DRAWN - JORGENSEN & ASSOC.	REVISED -							
		CHECKED - CJ	REVISED -							
		DATE -	REVISED -							

O.R. RTE.	SECTION	COUNTY	TOTAL SHEETS	SHEET NO.
0003	18A-2	McHENRY	825	416
CONTRACT NO. 60F72				
FED. ROAD DIST. NO. 1 ILLINOIS FED. AID PROJECT				

PART OF THE NE 1/4 OF SEC. 33 AND PART OF THE FRACTIONAL NW 1/4 OF SEC. 34, TWP. 43 N., R. 8 E. OF THE 3RD. P.M., IN McHENRY COUNTY, ILLINOIS.

EXISTING R.O.W. RECORDED INFORMATION		
Parcel	Document No.	Date Recorded
1FH0042	489647	May 16, 1968
1FH0042	920010	October 8, 1985
----	446262	July 19, 1965
----	918817	September 26, 1985
----	920010	October 8, 1985

See Sheet 29 for Total Holdings Parcel 1FH0042 & 1FH0042T.E.-A & B

Proposed Q Pavement Legion Drive Curve #1
 P.I. = Sta. 1+55.18
 Δ = 19°07'41"
 R = 100.00'
 T = 16.85'
 L = 33.39'
 E = 1.41'
 P.C. = Sta. 1+38.33
 P.T. = Sta. 1+71.72

HUNTINGTON HILLS SUBDIVISION UNIT NO. 1
 Recorded July 19, 1965 as Document No. 446262
 LOT 1 Block 2

Schedule of Ties		
Point Number	Tie to point	Tie Distance (feet)
1	T1	78.94
	T2	77.82
	T3	60.63
2	T1	14.20
	T2	16.43
	T3	19.59
3	T1	39.65
	T2	37.79
	T3	36.11
4	T1	35.25
	T2	32.05
	T3	36.81
5	T1	39.81
	T2	32.06
	T3	32.57
6	T1	33.77
	T2	31.86
	T3	35.02


COORDINATE TABLE			
STATION	OFFSET	NORTH	EAST
215+67.48	42.94' Lt.	2,002,375.284	994,329.484
215+80.47	19.74' Rt.	2,002,327.955	994,372.655
215+80.97	0.23' Lt.	2,002,345.139	994,363.396
215+91.69	28.27' Rt.	2,002,325.766	994,386.204
217+78.40	57.63' Rt.	2,002,397.124	994,569.404
217+79.23	51.70' Rt.	2,002,402.387	994,566.532

PARCEL NUMBER	OWNER	TOTAL HOLDINGS ACRES	PART TAKEN ACRES	AREA IN EXISTING R.O.W. ACRES	REMAINDER AREA ACRES	EASEMENT AREA ACRES	EASEMENT PURPOSE	PERMANENT INDEX NUMBER	PROPERTY ACQUIRED BY
1FH0042	Creeks Crossing, Ltd.	5.834	0.940	0.339	4.894	A=0.106 B=0.085	Grading	19-33-227-029 19-34-151-001 19-34-151-008	

SEE SHEET 7

COORDINATE TABLE			
STATION	OFFSET	NORTH	EAST
108+18.98	12.86' Rt.	2,002,172.464	994,456.443
108+52.01	18.75' Lt.	2,002,212.606	994,434.812
108+72.83	36.37' Lt.	2,002,236.024	994,422.193
108+74.82	16.36' Rt.	2,002,226.846	994,474.157
109+21.28	23.14' Rt.	2,002,272.817	994,489.132
109+25.10	57.41' Rt.	2,002,272.206	994,523.639
109+57.91	2.85' Lt.	2,002,512.651	994,467.401
109+61.29	43.05' Lt.	2,002,319.081	994,427.592
110+29.58	18.69' Rt.	2,002,384.558	994,490.824
110+53.83	101.61' Lt.	2,002,401.493	994,369.597
110+80.38	114.46' Lt.	2,002,422.406	994,354.880
110+84.57	70.27' Lt.	2,002,430.857	994,398.401
110+97.34	62.86' Lt.	2,002,443.141	994,404.335
111+00.00	83.34' Lt.	2,002,442.708	994,383.729
111+50.00	74.29' Lt.	2,002,487.507	994,384.918
111+68.23	54.56' Lt.	2,002,507.980	994,400.402
112+51.48	85.14' Lt.	2,002,569.445	994,348.834
112+53.48	67.28' Lt.	2,002,577.613	994,364.816
214+97.45	80.00' Lt.	2,002,361.781	994,244.703
215+16.02	60.32' Rt.	2,002,261.338	994,344.463
215+22.86	80.00' Lt.	2,002,379.119	994,267.881
215+31.98	42.67' Lt.	2,002,354.366	994,297.591

LEGEND

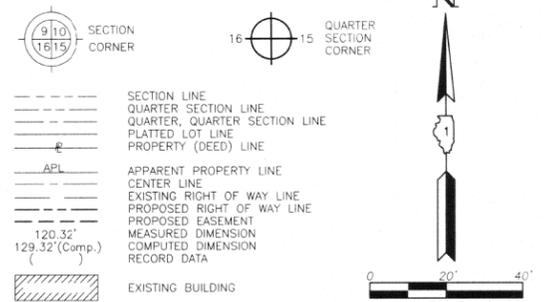

Bearings are referred to the Illinois Coordinate System NAD83 (1997) East Zone as Found Geodetic Survey Control Monuments "MCH31 1A", P.I.D. AJ2855 and "Algonquin", P.I.D. AJ2945.

○ IRON PIPE OR ROD FOUND
 ⊕ "MAG" NAIL SET
 + CUT CROSS FOUND OR SET
 ● 5/8" REBAR SET

● T1 THESE STAKES REFERENCE FOUND OR SET MONUMENTATION. SET 5/8 INCH IRON ROD FLUSH WITH GROUND TO MARK FUTURE PROPOSED EASEMENT. IDENTIFIED BY COLORED PLASTIC CAP BEARING SURVEYORS REGISTRATION NUMBER.
 ● T2
 ● T3

● BT1 THESE STAKES, IN CULTIVATED AREAS, REFERENCE FOUND OR SET MONUMENTATION. GROUND 15/16 INCH IRON ROD 20 INCHES BELOW GROUND TO IDENTIFY FOUND IRON STAKE. IDENTIFIED BY COLORED PLASTIC CAP BEARING SURVEYORS REGISTRATION NUMBER.
 ● BT2
 ● BT3

■ STAKING OF PROPOSED RIGHT OF WAY. SET DIVISION OF HIGHWAYS SURVEY MARKER TO MONUMENT THE POSITION SHOWN. IDENTIFIED BY INSCRIPTION DATA AND SURVEYORS REGISTRATION NUMBER.

■ M STAKING OF PROPOSED RIGHT OF WAY IN CULTIVATED AREAS. BURIED 5/8 INCH METAL ROD 20 INCHES BELOW GROUND TO MARK FUTURE PROPOSED EASEMENT POSITION IDENTIFIED BY COLORED PLASTIC CAP BEARING SURVEYORS REGISTRATION NUMBER.

⊙ PERMANENT SURVEY MARKER, I.D.O.T STD 2135 (TO BE SET BY OTHERS)

□ RIGHT OF WAY STAKING PROPOSED TO BE SET.

STATE OF ILLINOIS }
 COUNTY OF LAKE } SS

THIS IS TO CERTIFY THAT WE, JORGENSEN & ASSOCIATES, INC., AN ILLINOIS PROFESSIONAL LAND SURVEYING CORPORATION, NUMBER 184-2771, HAVE SURVEYED THE PLAT OF HIGHWAYS SHOWN HEREON BETWEEN SECTION 33, TOWNSHIP 43N., RANGE 8E. AND SECTION 34, TOWNSHIP 43N., RANGE 8E., OF THE THIRD PRINCIPAL MERIDIAN, McHENRY COUNTY, THAT THE SURVEY IS TRUE AND COMPLETE AS SHOWN TO THE BEST OF MY KNOWLEDGE AND BELIEF THAT THE PLAT CORRECTLY REPRESENTS SAID SURVEY, THAT ALL MONUMENTS FOUND AND ESTABLISHED ARE OF PERMANENT QUALITY AND OCCUPY THE POSITIONS SHOWN THEREON AND THAT THE MONUMENTS ARE SUFFICIENT TO ENABLE THE SURVEY TO BE RETRACED. MADE FOR THE DEPARTMENT OF TRANSPORTATION, STATE OF ILLINOIS.

DATED AT LAKE VILLA, ILLINOIS THIS 11th DAY OF March, 2010 A.D.

CHRISTIAN H. JORGENSEN
 PRESIDENT
 ILLINOIS PROFESSIONAL LAND SURVEYOR NO. 35-2797
 LICENSE EXPIRATION DATE: NOVEMBER 30, 2010
 THIS PROFESSIONAL SERVICE CONFORMS TO THE CURRENT ILLINOIS MINIMUM STANDARDS FOR A BOUNDARY SURVEY.
 COORDINATES ARE BASED ON THE PUBLISHED METRIC COORDINATE VALUES AT FOUND GEODETIC SURVEY CONTROL MONUMENT "MCH31 1A", P.I.D. AJ2855, OF N.613,205.182-E.303,895.917.
 NOTE: SURFACE COORDINATES ARE SHOWN.

COORDINATE TABLE			
STATION	OFFSET	NORTH	EAST
1+01.60	3.78' Lt.	2,002,432.371	994,311.184
1+03.50	26.16' Rt.	2,002,449.636	994,335.718
1+47.34	12.41' Lt.	2,002,465.722	994,280.216
1+53.54	16.93' Rt.	2,002,488.912	994,299.249
1+54.07	23.82' Lt.	2,002,462.918	994,267.871
1+62.34	15.51' Rt.	2,002,495.462	994,291.268
1+65.65	14.84' Lt.	2,002,475.856	994,267.870
1+70.60	13.54' Lt.	2,002,479.648	994,265.547
2+03.04	15.00' Rt.	2,002,522.196	994,258.698
2+03.04	15.00' Lt.	2,002,499.007	994,239.665
2+03.04	25.00' Lt.	2,002,491.277	994,233.320


JORGENSEN & ASSOCIATES, INC.
 120 PARK AVENUE
 LAKE VILLA, ILLINOIS 60046
 (847) 356-3371

PLAT OF HIGHWAYS
 STATE OF ILLINOIS
 DEPARTMENT OF TRANSPORTATION
 F.A.P. 336 (ILLINOIS ROUTE 31 BYPASS)
 SECTION 96-00209-00-PV McHENRY COUNTY
 PROJECT JOB NO. R-91-022-03
 STATION 0+00.00 TO STATION 3+00
 STATION 108+00 TO STATION 112+00
 STATION 214+00 TO STATION 218+00
 SCALE: 1"=20' SHEET 6 OF 37

BUREAU OF LAND ACQUISITION
 201 WEST CENTER COURT
 SCHAUMBURG, ILLINOIS 60196

ROUTE F.A.P. 336 (ILLINOIS ROUTE 31 BYPASS) SECTION 96-00209-00-PV COUNTY McHENRY JOB NO. R-91-022-03 RECORDING: RECORDED ON AS DOCUMENT NO.

FILE NAME	USER NAME	DESIGNED	REVISED	STATE OF ILLINOIS DEPARTMENT OF TRANSPORTATION	PLAT OF HIGHWAYS	O.R. RTE.	SECTION	COUNTY	TOTAL SHEETS	SHEET NO.
...\\D160F72-sht-PH-08.dgn	akw	-	-	STATE OF ILLINOIS DEPARTMENT OF TRANSPORTATION	PLAT OF HIGHWAYS	0003	18A-2	McHENRY	825	417
		DRAWN - JORGENSEN & ASSOC.	REVISED -							
		CHECKED - CJ	REVISED -							
		DATE -	REVISED -							
						SCALE: GRAPHIC	SHEET NO. 8 OF 49 SHEETS	STA.		TO STA.
									FED. ROAD DIST. NO. 1 ILLINOIS FED. AID PROJECT	

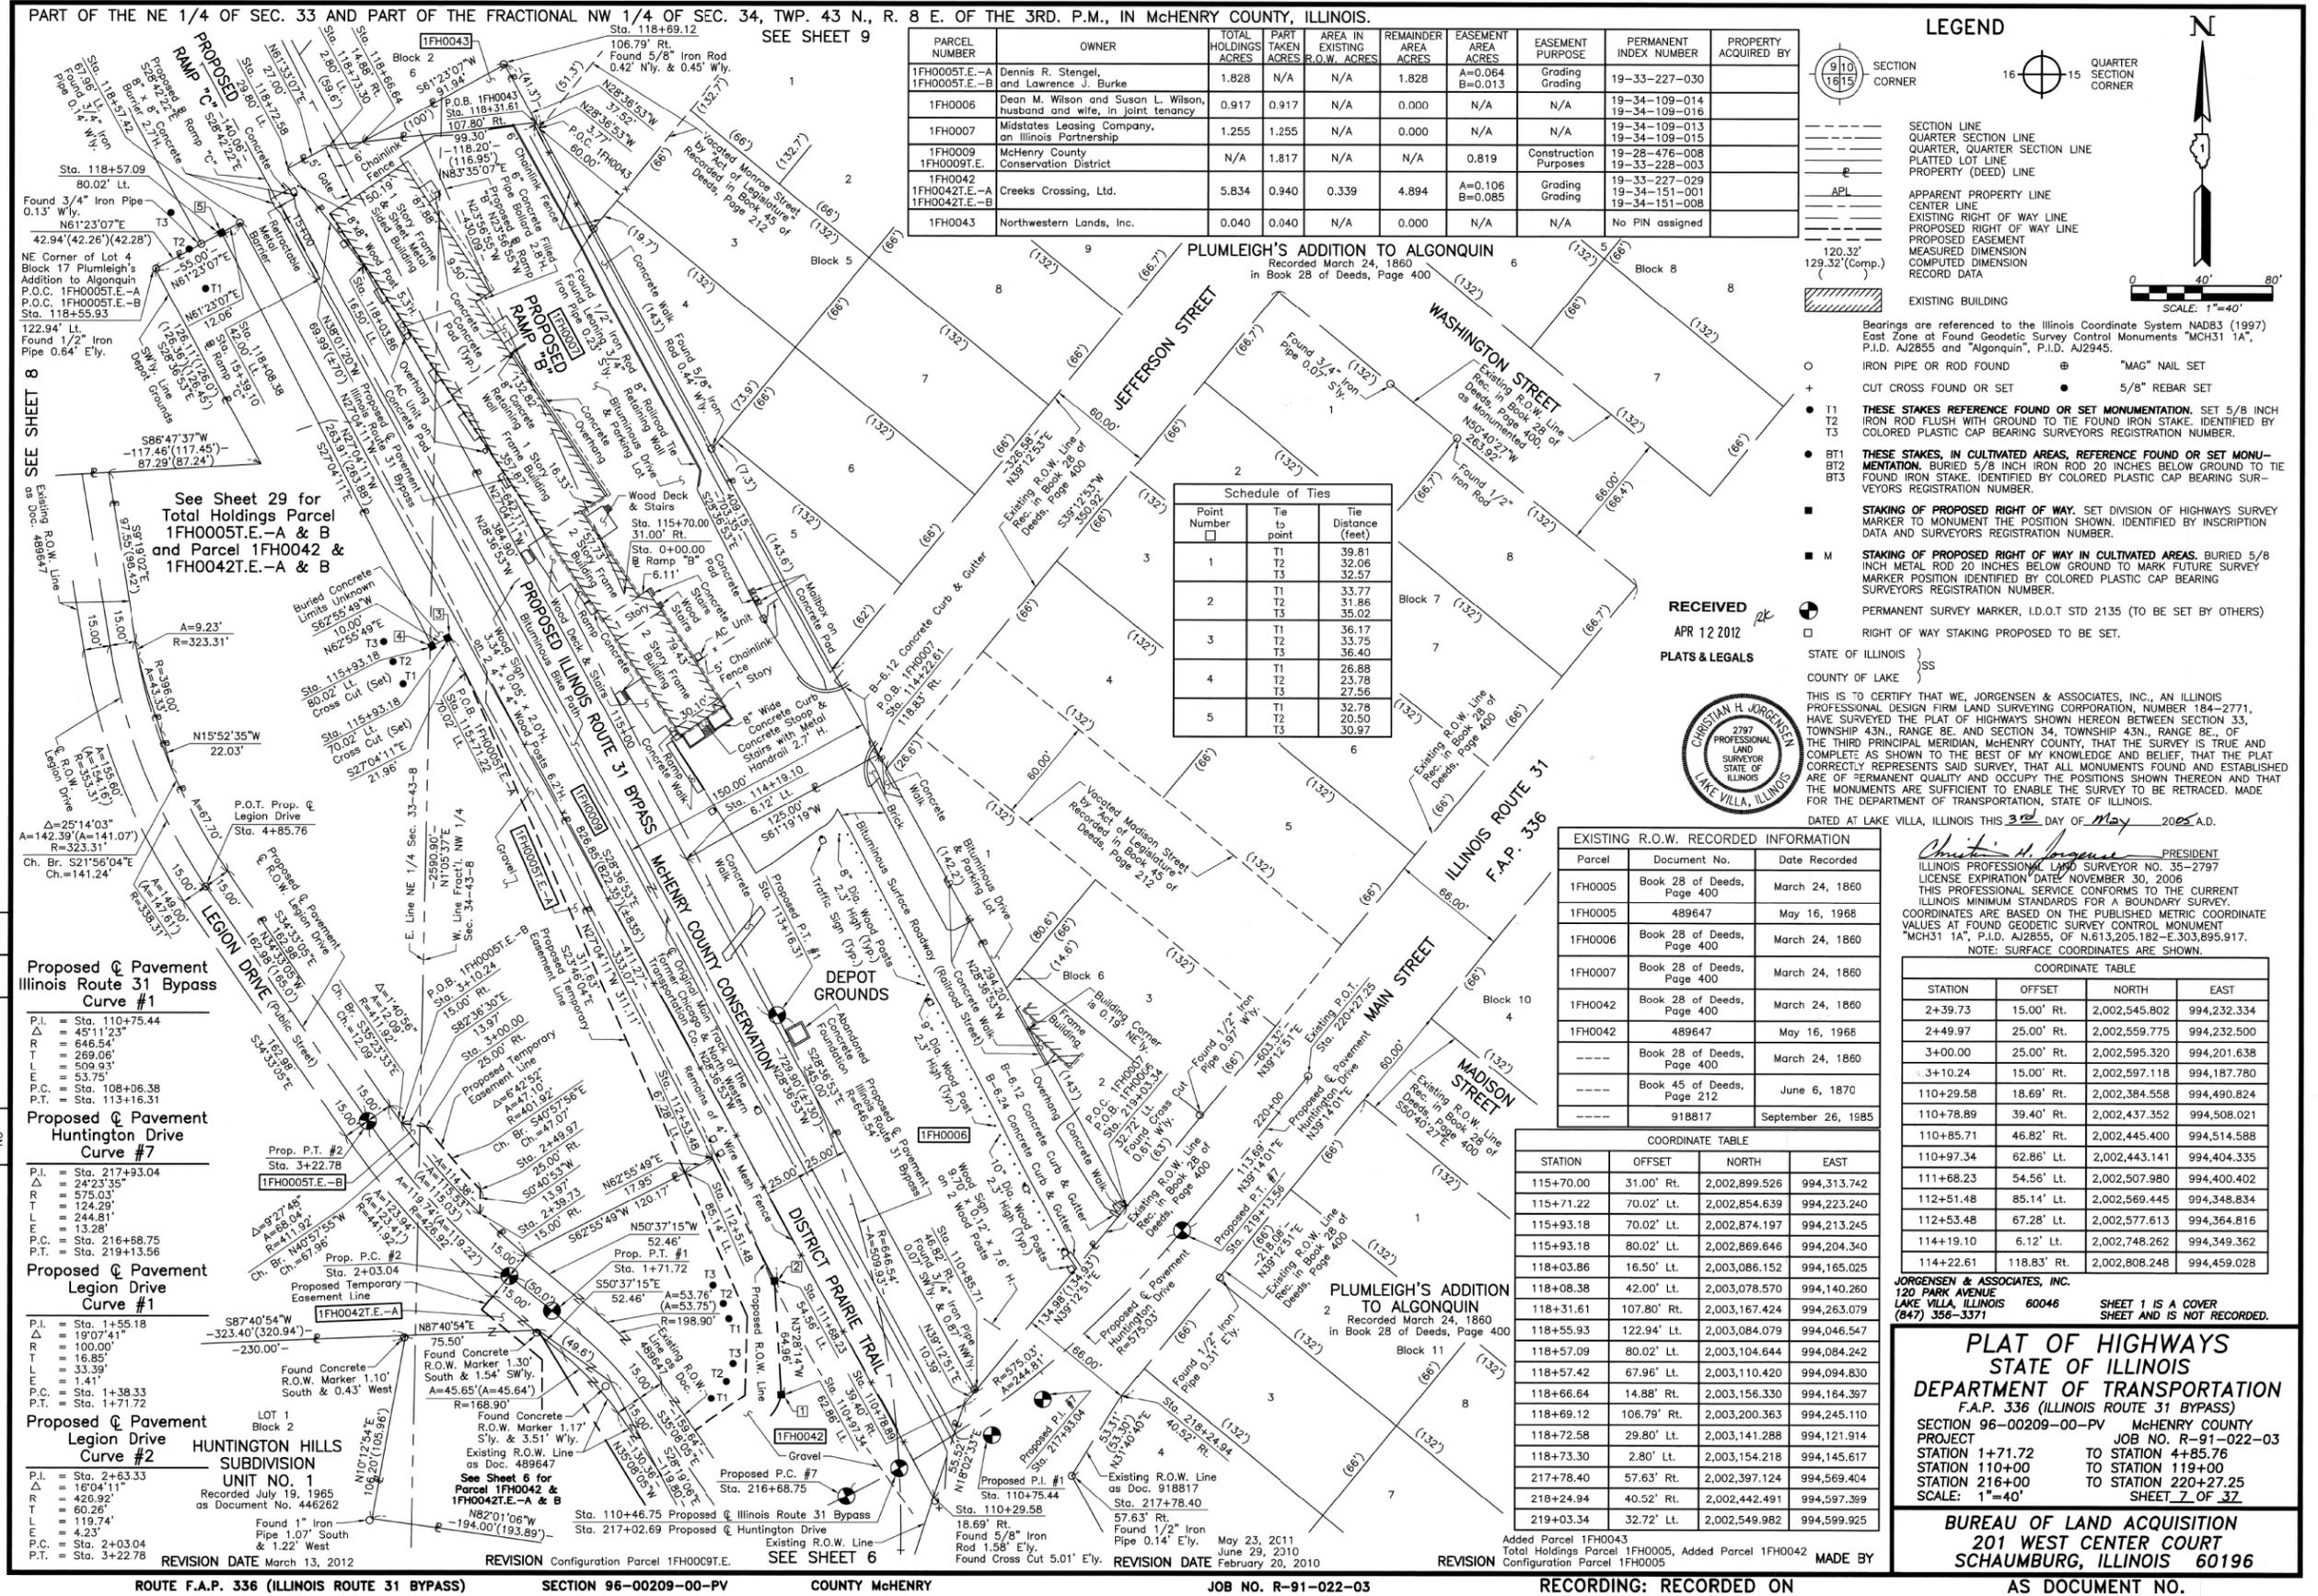

PARCEL NUMBER	OWNER	TOTAL HOLDINGS ACRES	PART TAKEN ACRES	AREA IN EXISTING R.O.W. ACRES	REMAINDER AREA ACRES	EASEMENT AREA ACRES	EASEMENT PURPOSE	PERMANENT INDEX NUMBER	PROPERTY ACQUIRED BY
1FH0005T.E.-A 1FH0005T.E.-B	Dennis R. Stengel, and Lawrence J. Burke	1.828	N/A	N/A	1.828	A=0.064 B=0.013	Grading Grading	19-33-227-030	
1FH0006	Dean M. Wilson and Susan L. Wilson, husband and wife, in joint tenancy	0.917	0.917	N/A	0.000	N/A	N/A	19-34-109-014 19-34-109-016	
1FH0007	Midstates Leasing Company, an Illinois Partnership	1.255	1.255	N/A	0.000	N/A	N/A	19-34-109-013 19-34-109-015	
1FH0009 1FH0009T.E.	McHenry County Conservation District	N/A	1.817	N/A	N/A	0.819	Construction Purposes	19-28-476-008 19-33-228-003	
1FH0042 1FH0042T.E.-A 1FH0042T.E.-B	Creeks Crossing, Ltd.	5.834	0.940	0.339	4.894	A=0.106 B=0.085	Grading Grading	19-33-227-029 19-34-151-001 19-34-151-008	
1FH0043	Northwestern Lands, Inc.	0.040	0.040	N/A	0.000	N/A	N/A	No PIN assigned	

LEGEND

SECTION CORNER
QUARTER SECTION CORNER

SECTION LINE
QUARTER SECTION LINE
QUARTER SECTION LINE
PLATTED LOT LINE
PROPERTY (DEED) LINE

APPARENT PROPERTY LINE
CENTER LINE
EXISTING RIGHT OF WAY LINE
PROPOSED RIGHT OF WAY LINE
PROPOSED EASEMENT
MEASURED DIMENSION
COMPUTED DIMENSION
RECORD DATA

EXISTING BUILDING

Bearings are referenced to the Illinois Coordinate System NAD83 (1997) East Zone at Found Geodetic Survey Control Monuments "MCH31 1A", P.I.D. AJ2855 and "Algonquin", P.I.D. AJ2945.

IRON PIPE OR ROD FOUND
CUT CROSS FOUND OR SET
T1
T2
T3
BT1
BT2
BT3
M

THESE STAKES REFERENCE FOUND OR SET MONUMENTATION. SET 5/8 INCH IRON ROD FLUSH WITH GROUND TO THE FOUND IRON STAKE. IDENTIFIED BY COLORED PLASTIC CAP BEARING SURVEYORS REGISTRATION NUMBER.

THESE STAKES, IN CULTIVATED AREAS, REFERENCE FOUND OR SET MONUMENTATION. BURIED 5/8 INCH IRON ROD 20 INCHES BELOW GROUND TO THE FOUND IRON STAKE. IDENTIFIED BY COLORED PLASTIC CAP BEARING SURVEYORS REGISTRATION NUMBER.

STAKING OF PROPOSED RIGHT OF WAY. SET DIVISION OF HIGHWAYS SURVEY MARKER TO MONUMENT THE POSITION SHOWN. IDENTIFIED BY INSCRIPTION DATA AND SURVEYORS REGISTRATION NUMBER.

STAKING OF PROPOSED RIGHT OF WAY IN CULTIVATED AREAS. BURIED 5/8 INCH METAL ROD 20 INCHES BELOW GROUND TO MARK FUTURE SURVEY MARKER POSITION IDENTIFIED BY COLORED PLASTIC CAP BEARING SURVEYORS REGISTRATION NUMBER.

PERMANENT SURVEY MARKER, I.D.O.T. STD 2135 (TO BE SET BY OTHERS)

RIGHT OF WAY STAKING PROPOSED TO BE SET.

STATE OF ILLINOIS
COUNTY OF LAKE

THIS IS TO CERTIFY THAT WE, JORGENSEN & ASSOCIATES, INC., AN ILLINOIS PROFESSIONAL DESIGN FIRM LAND SURVEYING CORPORATION, NUMBER 184-2771, HAVE SURVEYED THE PLAT OF HIGHWAYS SHOWN HEREIN BETWEEN SECTION 33, TOWNSHIP 43N., RANGE 8E., AND SECTION 34, TOWNSHIP 43N., RANGE 8E., OF THE THIRD PRINCIPAL MERIDIAN, McHENRY COUNTY, THAT THE SURVEY IS TRUE AND COMPLETES AS SHOWN TO THE BEST OF MY KNOWLEDGE AND BELIEF THAT THE PLAT CORRECTLY REPRESENTS SAID SURVEY, THAT ALL MONUMENTS FOUND AND ESTABLISHED ARE OF PERMANENT QUALITY AND OCCUPY THE POSITIONS SHOWN THEREON AND THAT THE MONUMENTS ARE SUFFICIENT TO ENABLE THE SURVEY TO BE RETRACED. MADE FOR THE DEPARTMENT OF TRANSPORTATION, STATE OF ILLINOIS.

DATED AT LAKE VILLA, ILLINOIS THIS 30th DAY OF May 2006 A.D.

RECEIVED
APR 12 2012
PLATS & LEGALS

Schedule of Ties

Point Number	Tie to point	Tie Distance (feet)
1	T1	39.81
	T2	32.08
	T3	32.57
2	T1	33.77
	T2	31.86
	T3	35.02
3	T1	36.17
	T2	33.75
	T3	36.40
4	T1	26.88
	T2	23.78
	T3	27.56
5	T1	32.78
	T2	20.50
	T3	30.97

EXISTING R.O.W. RECORDED INFORMATION

Parcel	Document No.	Date Recorded
1FH0005	Book 28 of Deeds, Page 400	March 24, 1860
1FH0005	489647	May 16, 1968
1FH0006	Book 28 of Deeds, Page 400	March 24, 1860
1FH0007	Book 28 of Deeds, Page 400	March 24, 1860
1FH0042	Book 28 of Deeds, Page 400	March 24, 1860
1FH0042	489647	May 16, 1968
-----	Book 28 of Deeds, Page 400	March 24, 1860
-----	Book 45 of Deeds, Page 212	June 6, 1870
-----	918817	September 26, 1985

COORDINATE TABLE

STATION	OFFSET	NORTH	EAST
115+70.00	31.00' Rt.	2,002,899.526	994,313.742
115+71.22	70.02' Lt.	2,002,854.639	994,223.240
115+93.18	70.02' Lt.	2,002,874.197	994,213.245
115+93.18	80.02' Lt.	2,002,869.646	994,204.340
118+03.86	16.50' Lt.	2,003,086.152	994,165.025
118+08.38	42.00' Lt.	2,003,078.570	994,140.280
118+31.61	107.80' Rt.	2,003,167.424	994,263.079
118+55.93	122.94' Lt.	2,003,084.079	994,046.547
118+57.09	80.02' Lt.	2,003,104.644	994,084.242
118+57.42	67.96' Lt.	2,003,110.420	994,094.830
118+66.64	14.88' Rt.	2,003,156.330	994,164.397
118+69.12	106.79' Rt.	2,003,200.363	994,245.110
118+72.58	29.80' Lt.	2,003,141.288	994,121.914
118+73.30	2.80' Lt.	2,003,154.218	994,145.617
217+78.40	57.63' Rt.	2,002,397.124	994,569.404
218+24.94	40.52' Rt.	2,002,442.491	994,597.399
219+03.34	32.72' Lt.	2,002,549.982	994,599.825

COORDINATE TABLE

STATION	OFFSET	NORTH	EAST
2+39.73	15.00' Rt.	2,002,545.802	994,232.334
2+49.97	25.00' Rt.	2,002,559.775	994,232.500
3+00.00	25.00' Rt.	2,002,595.320	994,201.638
3+10.24	15.00' Rt.	2,002,597.118	994,187.780
110+29.58	18.69' Rt.	2,002,384.558	994,490.824
110+78.89	39.40' Rt.	2,002,437.352	994,508.021
110+85.71	46.82' Rt.	2,002,445.400	994,514.588
110+97.34	62.86' Lt.	2,002,443.141	994,404.335
111+68.23	54.56' Lt.	2,002,507.980	994,400.402
112+51.48	85.14' Lt.	2,002,569.445	994,348.834
112+53.48	67.28' Lt.	2,002,577.613	994,364.816
114+19.10	6.12' Lt.	2,002,748.262	994,349.362
114+22.61	118.83' Rt.	2,002,808.248	994,459.028

JORGENSEN & ASSOCIATES, INC.
120 PARK AVENUE
LAKE VILLA, ILLINOIS 60046
(847) 356-3371

SHEET 1 IS A COVER SHEET AND IS NOT RECORDED.

PLAT OF HIGHWAYS
STATE OF ILLINOIS
DEPARTMENT OF TRANSPORTATION
F.A.P. 336 (ILLINOIS ROUTE 31 BYPASS)
SECTION 96-00209-00-PV McHENRY COUNTY
PROJECT JOB NO. R-91-022-03
STATION 1+71.72 TO STATION 4+85.76
STATION 110+00 TO STATION 119+00
STATION 216+00 TO STATION 220+27.25
SCALE: 1"=40' SHEET 7 OF 37

BUREAU OF LAND ACQUISITION
201 WEST CENTER COURT
SCHAUMBURG, ILLINOIS 60196

ROW	PLAT	MADE	CHECKED	IN	NO.	DATE

Proposed Pavement Illinois Route 31 Bypass Curve #1

P.I. = Sta. 110+75.44
 Δ = 45°11'23"
 R = 646.54'
 T = 269.06'
 L = 509.93'
 E = 53.75'
 P.C. = Sta. 108+06.38
 P.T. = Sta. 113+16.31

Proposed Pavement Huntington Drive Curve #7

P.I. = Sta. 217+93.04
 Δ = 24°23'35"
 R = 575.03'
 T = 124.29'
 L = 244.81'
 E = 13.28'
 P.C. = Sta. 216+68.75
 P.T. = Sta. 219+13.56

Proposed Pavement Legion Drive Curve #1

P.I. = Sta. 1+55.18
 Δ = 19°07'41"
 R = 100.00'
 T = 16.85'
 L = 33.39'
 E = 1.41'
 P.C. = Sta. 1+38.33
 P.T. = Sta. 1+71.72

Proposed Pavement Legion Drive Curve #2

P.I. = Sta. 2+63.33
 Δ = 16°04'11"
 R = 426.92'
 T = 60.26'
 L = 119.74'
 E = 4.23'
 P.C. = Sta. 2+03.04
 P.T. = Sta. 3+22.78


HUNTINGTON HILLS SUBDIVISION UNIT NO. 1
Recorded July 19, 1965 as Document No. 446262

Found 1" Iron Pipe 1.07' South & 1.22' West
 Found Concrete R.O.W. Marker 1.10' South & 0.43' West
 Found Concrete R.O.W. Marker 1.30' S'y. & 1.54' W'y. South & 1.54' S'y. W'y. A=45.65' (A=45.64') R=168.90'

PART OF THE NE 1/4 OF SEC. 33, TWP. 43 N., R. 8 E. OF THE 3RD. P.M., IN McHENRY COUNTY, ILLINOIS.

PARCEL NUMBER	OWNER	TOTAL HOLDINGS ACRES	PART TAKEN ACRES	AREA IN EXISTING R.O.W. ACRES	REMAINDER AREA ACRES	EASEMENT AREA ACRES	EASEMENT PURPOSE	PERMANENT INDEX NUMBER	PROPERTY ACQUIRED BY
1FH0009 1FH0009T.E.	McHenry County Conservation District	N/A	1.817	N/A	N/A	0.819	Construction Purposes	19-28-476-008 19-33-228-003	

EXISTING R.O.W. RECORDED INFORMATION		
Parcel	Document No.	Date Recorded
1FH0008	Book 28 of Deeds, Page 400	March 24, 1860
----	Book 28 of Deeds, Page 400	March 24, 1860
----	489647	May 16, 1968

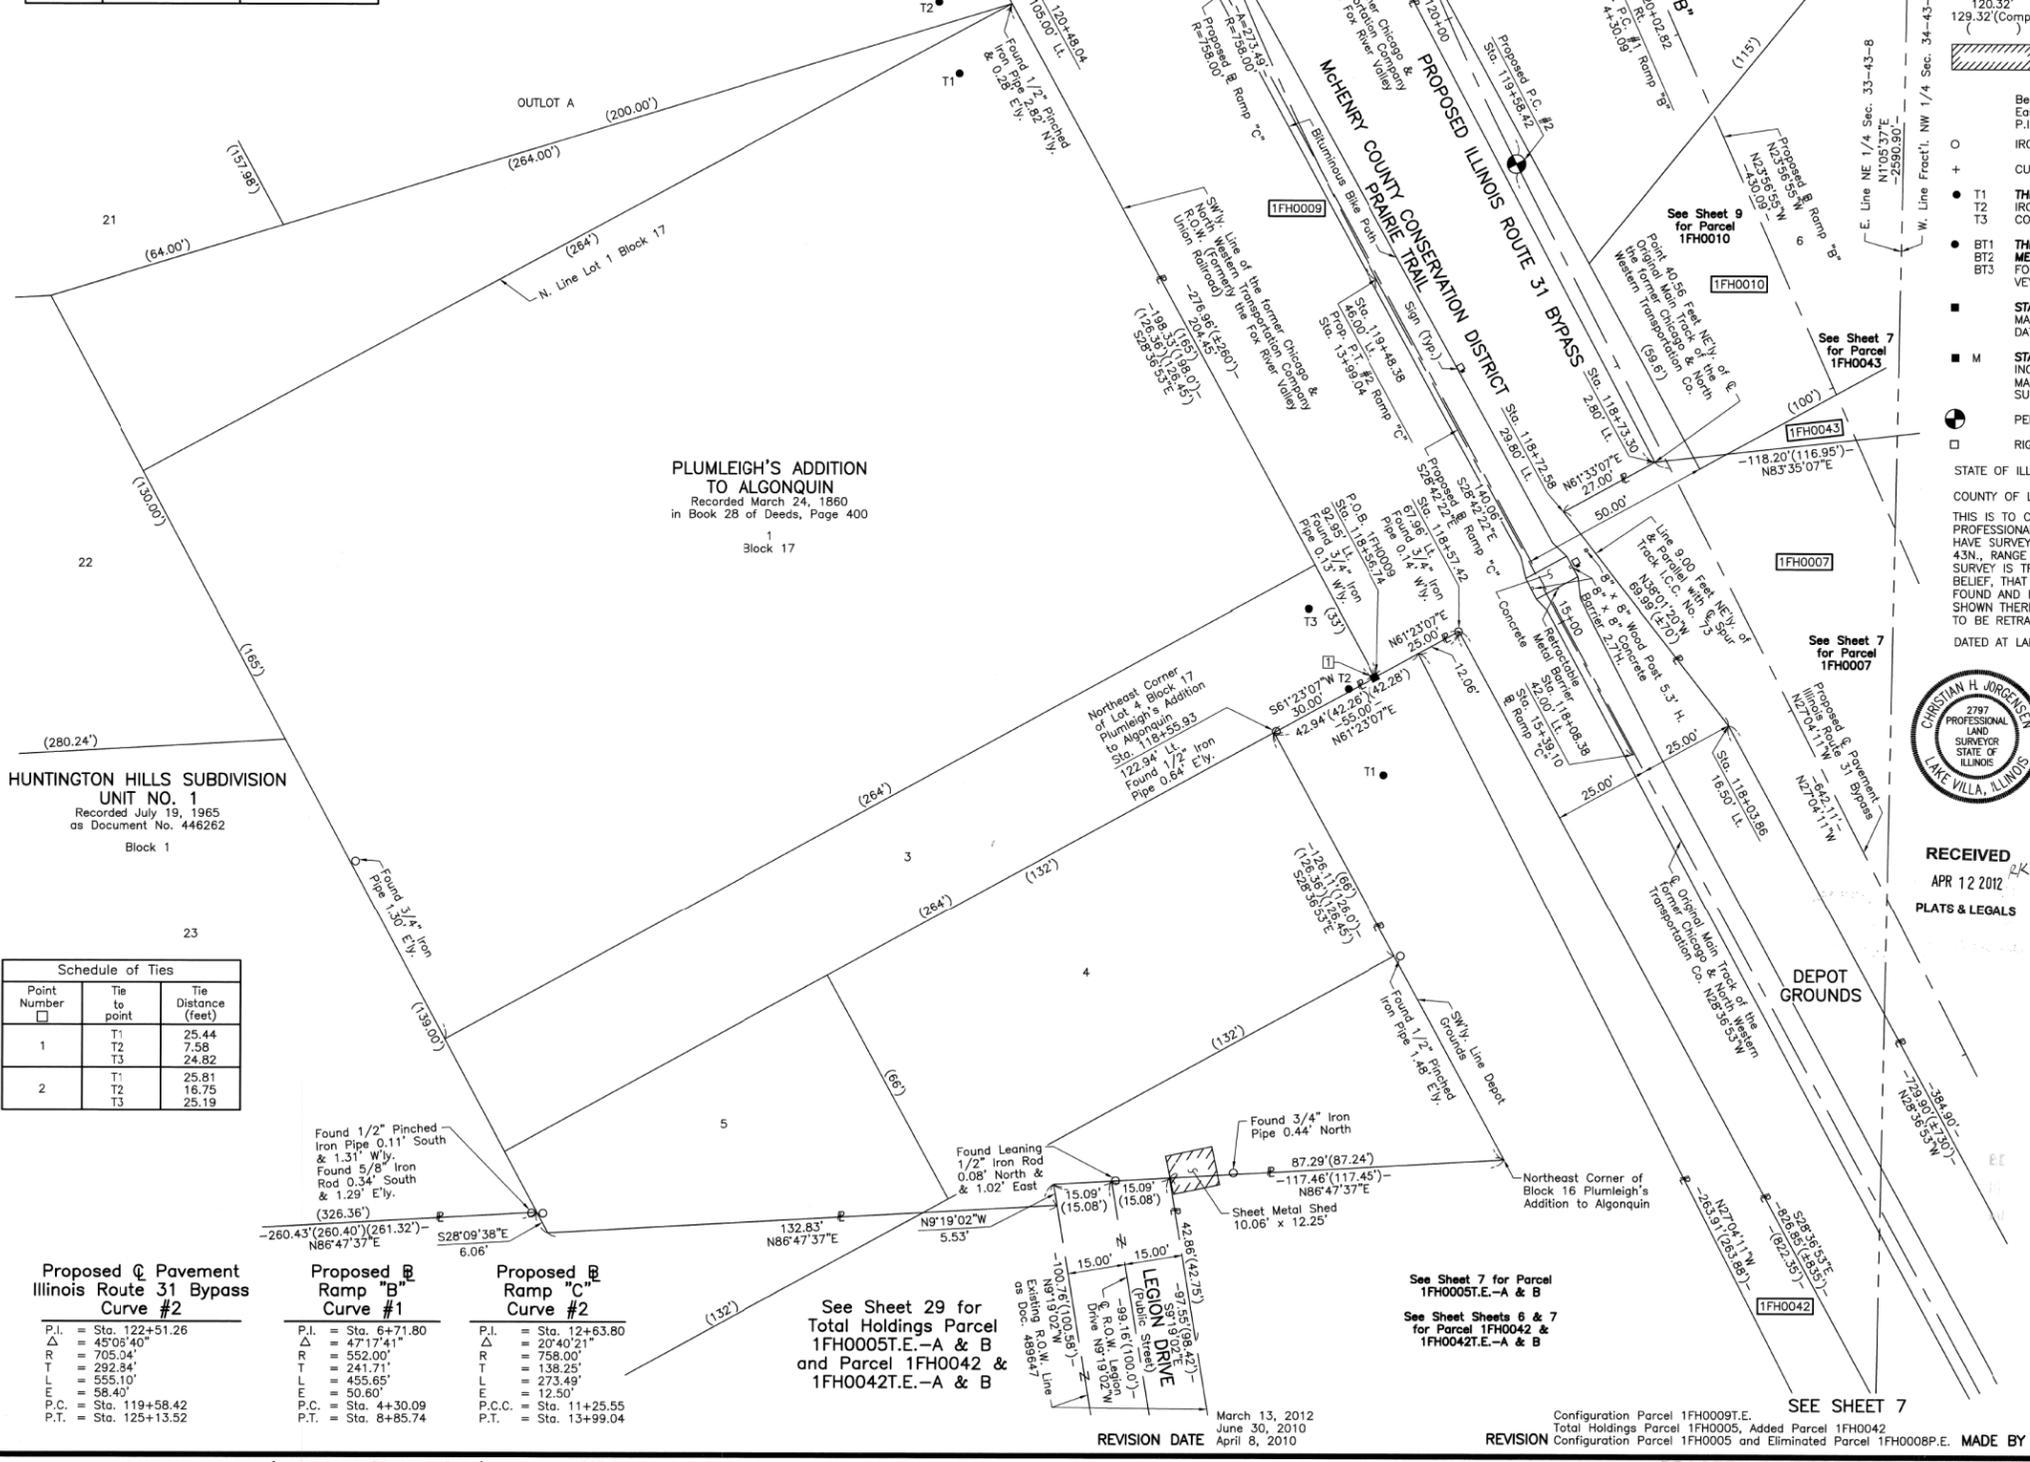

LEGEND

SECTION CORNER: 9 10 16 15
QUARTER SECTION CORNER: 16 15

SECTION LINE
QUARTER SECTION LINE
QUARTER, QUARTER SECTION LINE
PLATTED LOT LINE
PROPERTY (DEED) LINE

APL
APPARENT PROPERTY LINE
CENTER LINE
EXISTING RIGHT OF WAY LINE
PROPOSED RIGHT OF WAY LINE
PROPOSED EASEMENT
MEASURED DIMENSION
COMPUTED DIMENSION
RECORD DATA

EXISTING BUILDING

Bearings are referenced to the Illinois Coordinate System NAD83 (1997) East Zone at Found Geodetic Survey Control Monuments "MCH31 1A", P.I.D. AJ2855 and "Algonquin", P.I.D. AJ2945.

○ IRON PIPE OR ROD FOUND ⊕ "MAG" NAIL SET
+ CUT CROSS FOUND OR SET ● 5/8" REBAR SET

● T1 THESE STAKES REFERRED FOUND OR SET MONUMENTATION. SET 5/8 INCH IRON ROD FLUSH WITH GROUND TO THE FOUND IRON STAKE. IDENTIFIED BY COLORED PLASTIC CAP BEARING SURVEYORS REGISTRATION NUMBER.
● BT1 THESE STAKES, IN CULTIVATED AREAS, REFERRED FOUND OR SET MONUMENTATION. BURIED 5/8 INCH IRON ROD 20 INCHES BELOW GROUND TO THE FOUND IRON STAKE. IDENTIFIED BY COLORED PLASTIC CAP BEARING SURVEYORS REGISTRATION NUMBER.
■ STAKING OF PROPOSED RIGHT OF WAY. SET DIVISION OF HIGHWAYS SURVEY MARKER TO MONUMENT THE POSITION SHOWN. IDENTIFIED BY INSCRIPTION DATA AND SURVEYORS REGISTRATION NUMBER.
■ M STAKING OF PROPOSED RIGHT OF WAY IN CULTIVATED AREAS. BURIED 5/8 INCH METAL ROD 20 INCHES BELOW GROUND TO MARK FUTURE SURVEY MARKER POSITION IDENTIFIED BY COLORED PLASTIC CAP BEARING SURVEYORS REGISTRATION NUMBER.
● PERMANENT SURVEY MARKER, I.D.O.T STD 2135 (TO BE SET BY OTHERS)
□ RIGHT OF WAY STAKING PROPOSED TO BE SET.

STATE OF ILLINOIS }
COUNTY OF LAKE }
SS

THIS IS TO CERTIFY THAT WE, JORGENSEN & ASSOCIATES, INC., AN ILLINOIS PROFESSIONAL DESIGN FIRM LAND SURVEYING CORPORATION, NUMBER 184-2771, HAVE SURVEYED THE PLAT OF HIGHWAYS SHOWN HEREON IN SECTION 33, TOWNSHIP 43N., RANGE 8E., OF THE THIRD PRINCIPAL MERIDIAN, McHENRY COUNTY, THAT THE SURVEY IS TRUE AND COMPLETE AS SHOWN TO THE BEST OF MY KNOWLEDGE AND BELIEF, THAT THE PLAT CORRECTLY REPRESENTS SAID SURVEY, THAT ALL MONUMENTS FOUND AND ESTABLISHED ARE OF PERMANENT QUALITY AND OCCUPY THE POSITIONS SHOWN THEREON AND THAT THE MONUMENTS ARE SUFFICIENT TO ENABLE THE SURVEY TO BE RETRACED. MADE FOR THE DEPARTMENT OF TRANSPORTATION, STATE OF ILLINOIS, DATED AT LAKE VILLA, ILLINOIS THIS 14th DAY OF March 2008 A.D.

CHRISTIAN H. JORGENSEN PRESIDENT
ILLINOIS PROFESSIONAL LAND SURVEYOR NO. 35-2797
LICENSE EXPIRATION DATE: NOVEMBER 30, 2006
THIS PROFESSIONAL SERVICE CONFORMS TO THE CURRENT ILLINOIS MINIMUM STANDARDS FOR A BOUNDARY SURVEY.
COORDINATES ARE BASED ON THE PUBLISHED METRIC COORDINATE VALUES AT FOUND GEODETIC SURVEY CONTROL MONUMENT "MCH31 1A", P.I.D. AJ2855, OF N.613,205.182-E.303,895.917.
NOTE: SURFACE COORDINATES ARE SHOWN.

STATION	OFFSET	NORTH	EAST
118+03.86	16.50' Lt.	2,003,086.152	994,165.025
118+08.38	42.00' Lt.	2,003,078.570	994,140.260
118+55.93	122.94' Lt.	2,003,084.079	994,046.547
118+56.74	92.95' Lt.	2,003,098.447	994,072.883
118+57.42	67.96' Lt.	2,003,110.420	994,094.830
118+72.58	29.80' Lt.	2,003,141.288	994,121.914
118+73.30	2.80' Lt.	2,003,154.218	994,145.617
119+48.38	46.00' Lt.	2,003,201.415	994,072.987
120+02.82	53.12' Rt.	2,003,292.586	994,139.162
120+48.04	105.00' Lt.	2,003,277.923	993,974.970

RECEIVED APR 12 2012 PLATS & LEGALS

JORGENSEN & ASSOCIATES, INC.
120 PARK AVENUE
LAKE VILLA, ILLINOIS 60046
(847) 356-3371

PLAT OF HIGHWAYS
STATE OF ILLINOIS
DEPARTMENT OF TRANSPORTATION
F.A.P. 336 (ILLINOIS ROUTE 31 BYPASS)
SECTION 96-00209-00-PV McHENRY COUNTY
PROJECT JOB NO. R-91-022-03
STATION 117+00 TO STATION 121+00
SCALE: 1"=20' SHEET 8 OF 37

BUREAU OF LAND ACQUISITION
201 WEST CENTER COURT
SCHAUMBURG, ILLINOIS 60196

ROUTE F.A.P. 336 (ILLINOIS ROUTE 31 BYPASS) SECTION 96-00209-00-PV COUNTY McHENRY JOB NO. R-91-022-03 RECORDING: RECORDED ON AS DOCUMENT NO.

FILE NAME = ... \D160F72-sh-t-PH-10.dgn	USER NAME = akw	DESIGNED -	REVISED -	STATE OF ILLINOIS DEPARTMENT OF TRANSPORTATION	PLAT OF HIGHWAYS	SCALE: GRAPHIC SHEET NO. 10 OF 49 SHEETS STA. TO STA.	O.R. RTE.	SECTION	COUNTY	TOTAL SHEETS	SHEET NO.
		DRAWN - JORGENSEN & ASSOC.	REVISED -				0003	18A-2	McHENRY	825	419
		CHECKED - CJ	REVISED -				CONTRACT NO. 60F72				
		DATE -	REVISED -				FED. ROAD DIST. NO. 1 ILLINOIS FED. AID PROJECT				

PART OF THE NE 1/4 OF SEC. 33 AND PART OF THE FRACTIONAL NW 1/4 OF SEC. 34, TWP. 43 N., R. 8 E. OF THE 3RD. P.M., IN McHENRY COUNTY, ILLINOIS.

PARCEL NUMBER	OWNER	TOTAL HOLDINGS ACRES	PART TAKEN ACRES	AREA IN EXISTING R.O.W. ACRES	REMAINDER AREA ACRES	EASEMENT AREA ACRES	EASEMENT PURPOSE	PERMANENT INDEX NUMBER	PROPERTY ACQUIRED BY
1FH0010	Northwestern Lands, Inc.	6.057	6.057	N/A	0.000	N/A	N/A	19-33-228-002	
1FH0011 1FH0011P.E.	Village of Algonquin, an Illinois Municipal Corporation	11.870	1.412	N/A	10.458	P.E.=0.040	Highway Purposes	19-33-228-001 19-34-103-001	

Sta. 126+12.97
420.82' Lt.
Found 1" Iron Pipe 0.45' South & 0.27' E'y.
Found Leaning 5/8" Iron Rod 0.52' South & 0.24' E'y.

Parcel	Document No.	Date Recorded
1FH0010	Book 28 of Deeds, Page 400	March 24, 1860
1FH0010	Book 45 of Deeds, Page 212	June 6, 1870
1FH0011	Book 45 of Deeds, Page 212	June 6, 1870

Proposed Ramp "B" Curve #1
 P.I. = Sta. 6+71.80
 Δ = 47°17'41"
 R = 552.00'
 T = 241.71'
 L = 455.85'
 E = 50.60'
 P.C. = Sta. 4+30.09
 P.T. = Sta. 8+85.74

Proposed Ramp "C" Curve #1
 P.I. = Sta. 9+59.17
 Δ = 17°00'50"
 R = 1129.00'
 T = 168.87'
 L = 335.25'
 E = 12.56'
 P.C. = Sta. 7+90.30
 P.C.C. = Sta. 11+25.55

Proposed Pavement Illinois Route 31 Bypass Curve #2
 P.I. = Sta. 122+51.26
 Δ = 45°06'40"
 R = 705.04'
 T = 292.84'
 L = 555.10'
 E = 58.40'
 P.C. = Sta. 119+58.42
 P.T. = Sta. 125+13.52


Point Number	Tie to point	Tie Distance (feet)
1	T1	107.69
	T2	97.66
	T3	91.05
2	T1	97.63
	T2	97.72
	T3	102.71
3	T1	53.66
	T2	43.91
	T3	33.00

All Ties to Point Nos. 1 & 2 are a "MAG" Nail (Set) in Bituminous Parking Lot.

STATION	OFFSET	NORTH	EAST
125+90.31	123.08' Lt.	2,003,881.615	993,973.559
125+91.31	105.90' Rt.	2,003,811.651	994,191.591
126+12.97	420.82' Lt.	2,003,995.370	993,697.479
126+33.15	109.78' Rt.	2,003,850.227	994,208.241
127+12.58	142.58' Lt.	2,004,003.912	993,992.891
127+63.62	€	2,004,008.289	994,144.267
127+90.81	75.94' Rt.	2,004,010.620	994,224.888
128+08.47	131.13' Rt.	2,004,010.323	994,282.836

ROW PLAT	DATE	BY	MADE	CHECKED	INKED	NOTED

LEGEND

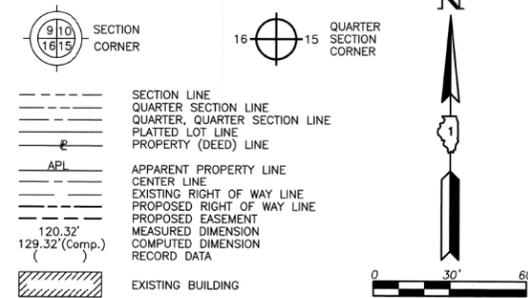

- IRON PIPE OR ROD FOUND
- ⊕ "MAG" NAIL SET
- + CUT CROSS FOUND OR SET
- 5/8" REBAR SET
- T1 THESE STAKES REFERENCE FOUND OR SET MONUMENTATION. SET 5/8 INCH IRON ROD FLUSH WITH GROUND TO TIE FOUND IRON STAKE. IDENTIFIED BY COLORED PLASTIC CAP BEARING SURVEYORS REGISTRATION NUMBER.
- T2
- T3
- BT1 THESE STAKES, IN CULTIVATED AREAS, REFERENCE FOUND OR SET MONUMENTATION. BURIED 5/8 INCH IRON ROD 20 INCHES BELOW GROUND TO MARK FUTURE SURVEY POSITION. IDENTIFIED BY COLORED PLASTIC CAP BEARING SURVEYORS REGISTRATION NUMBER.
- BT2
- BT3
- STAKING OF PROPOSED RIGHT OF WAY. SET DIVISION OF HIGHWAYS SURVEY MARKER TO MONUMENT THE POSITION SHOWN. IDENTIFIED BY INSCRIPTION DATA AND SURVEYORS REGISTRATION NUMBER.
- M STAKING OF PROPOSED RIGHT OF WAY IN CULTIVATED AREAS. BURIED 5/8 INCH METAL ROD 20 INCHES BELOW GROUND TO MARK FUTURE SURVEY MARKER POSITION IDENTIFIED BY COLORED PLASTIC CAP BEARING SURVEYORS REGISTRATION NUMBER.
- ⊕ PERMANENT SURVEY MARKER, I.D.O.T STD 2135 (TO BE SET BY OTHERS)
- RIGHT OF WAY STAKING PROPOSED TO BE SET.

STATE OF ILLINOIS }
 COUNTY OF LAKE }
 THIS IS TO CERTIFY THAT WE, JORGENSEN & ASSOCIATES, INC., AN ILLINOIS PROFESSIONAL DESIGN FIRM LAND SURVEYING CORPORATION, NUMBER 184-2771, HAVE SURVEYED THE PLAT OF HIGHWAYS SHOWN HEREON BETWEEN SECTION 33, TOWNSHIP 43N., RANGE 8E. AND SECTION 34, TOWNSHIP 43N., RANGE 8E., OF THE THIRD PRINCIPAL MERIDIAN, McHENRY COUNTY, THAT THE SURVEY IS TRUE AND COMPLETE AS SHOWN TO THE BEST OF MY KNOWLEDGE AND BELIEF, THAT THE PLAT CORRECTLY REPRESENTS SAID SURVEY, THAT ALL MONUMENTS FOUND AND ESTABLISHED ARE OF PERMANENT QUALITY AND OCCUPY THE POSITIONS SHOWN THEREON AND THAT THE MONUMENTS ARE SUFFICIENT TO ENABLE THE SURVEY TO BE RETRACED. MADE FOR THE DEPARTMENT OF TRANSPORTATION, STATE OF ILLINOIS.
 DATED AT LAKE VILLA, ILLINOIS THIS 8th DAY OF March 2005 A.D.



Christian H. Jorgensen - PRESIDENT
 ILLINOIS PROFESSIONAL LAND SURVEYOR NO. 35-2797
 LICENSE EXPIRATION DATE: DECEMBER 30, 2008
 THIS PROFESSIONAL SERVICE CONFORMS TO THE CURRENT ILLINOIS MINIMUM STANDARDS FOR A BOUNDARY SURVEY.
 COORDINATES ARE BASED ON THE PUBLISHED METRIC COORDINATE VALUES AT FOUND GEODETIC SURVEY CONTROL MONUMENT "MCH31 1A", P.I.D. AJ2855, OF N.613,205.182-E.303,895.917.
 NOTE: SURFACE COORDINATES ARE SHOWN.

STATION	OFFSET	NORTH	EAST
121+67.43	272.09' Rt.	2,003,476.321	994,310.921
122+04.93	50.57' Lt.	2,003,459.560	993,987.264
122+53.93	76.18' Lt.	2,003,510.505	993,957.077
122+55.62	72.28' Lt.	2,003,512.574	993,960.869
124+47.19	389.41' Rt.	2,003,621.257	994,429.215
125+00.41	77.34' Rt.	2,003,735.402	994,136.833
125+01.33	95.53' Rt.	2,003,730.850	994,154.464
125+08.71	60.30' Lt.	2,003,784.189	994,007.878
125+11.77	102.64' Rt.	2,003,737.272	994,163.942
125+11.88	80.16' Lt.	2,003,793.572	993,990.022
125+29.01	131.61' Lt.	2,003,825.968	993,946.470
125+87.00	160.88' Rt.	2,003,790.523	994,242.531

JORGENSEN & ASSOCIATES, INC.
 120 PARK AVENUE
 LAKE VILLA, ILLINOIS 60046
 (847) 356-3371

PLAT OF HIGHWAYS
 STATE OF ILLINOIS
 DEPARTMENT OF TRANSPORTATION
 F.A.P. 336 (ILLINOIS ROUTE 31 BYPASS)
 SECTION 96-00209-00-PV McHENRY COUNTY
 PROJECT JOB NO. R-91-022-03
 STATION 122+00 TO STATION 128+00
 SCALE: 1"=30'
 SHEET 10 OF 37

BUREAU OF LAND ACQUISITION
 201 WEST CENTER COURT
 SCHAUMBURG, ILLINOIS 60196

ROUTE F.A.P. 336 (ILLINOIS ROUTE 31 BYPASS) SECTION 96-00209-00-PV COUNTY McHENRY JOB NO. R-91-022-03 REVISION DATE April 8, 2010 RECORDING: RECORDED ON AS DOCUMENT NO.

FILE NAME	USER NAME	DESIGNED	REVISED	O.R. RTE.	SECTION	COUNTY	TOTAL SHEETS	SHEET NO.
...\\D160F72-sht-PH-12.dgn	akw	-	-	0003	18A-2	McHENRY	825	421
		DRAWN - JORGENSEN & ASSOC.	REVISED -	PLAT OF HIGHWAYS				
		CHECKED - CJ	REVISED -	SCALE: GRAPHIC SHEET NO. 12 OF 49 SHEETS STA. TO STA.				
		DATE -	REVISED -	FED. ROAD DIST. NO. 1 ILLINOIS FED. AID PROJECT				

STATE OF ILLINOIS
 DEPARTMENT OF TRANSPORTATION

PLAT OF HIGHWAYS

SCALE: GRAPHIC SHEET NO. 12 OF 49 SHEETS STA. TO STA.

FED. ROAD DIST. NO. 1 ILLINOIS FED. AID PROJECT

PART OF THE SE 1/4 OF SEC. 28 AND PART OF THE NE 1/4 OF SEC. 33, TWP. 43 N., R. 8 E. OF THE 3RD. P.M., IN McHENRY COUNTY, ILLINOIS.


Schedule of Ties		
Point Number	Tie to point	Tie Distance (feet)
1	T1	127.68
	T2	99.85
	T3	124.08
2	T1	94.85
	T2	105.38
	T3	143.66
3	T1	71.20
	T2	106.43
	T3	155.64
4	T1	84.07
	T2	70.71
	T3	57.52
5	T1	55.02
	T2	25.19
	T3	26.94
6	T1	29.29
	T2	53.10
	T3	77.98
7	T1	49.60
	T2	26.28
	T3	20.34
8	T1	36.35
	T2	32.18
	T3	36.31
9	T1	53.66
	T2	55.65
	T3	60.97
10	T1	63.53
	T2	49.98
	T3	43.08
11	T1	17.28
	T2	15.15
	T3	20.88
12	T1	36.45
	T2	36.33
	T3	67.60
13	T1	69.04
	T2	36.93
	T3	14.82

T1 to Point No. 1 is a Cross Cut (Set) in Concrete Curb.
T2 & T3 to Point Nos. 1, 2 & 3 are a Cross Cut (Set) in Concrete Walk.
T1 to Point Nos. 2 & 3 is a "MAG" Nail (Set) in Bituminous Drive.
T1 & T2 to Point Nos. 4 & 5 are a "MAG" Nail (Set) in Bituminous Parking Lot.
T3 to Point Nos. 4 & 5 is a Cross Cut (Set) in Concrete Curb.
All Ties to Point Nos. 6, 7, 8 & 9 are a "MAG" Nail (Set) in Bituminous Parking Lot.
Tie Distances to Point Nos. 10, 11, 12 & 13 are Computed.

See Sheet 13 for Parcel 1FH0015P.E. & 1FH0015T.E.-A & B

ROW	PLAT	MADE	CHECKED	DATE	BY	NOTED


McHENRY COUNTY CONSERVATION DISTRICT
HUNTINGTON HILLS SUBDIVISION
UNIT NO. 1
Recorded July 19, 1965 as Document No. 446262

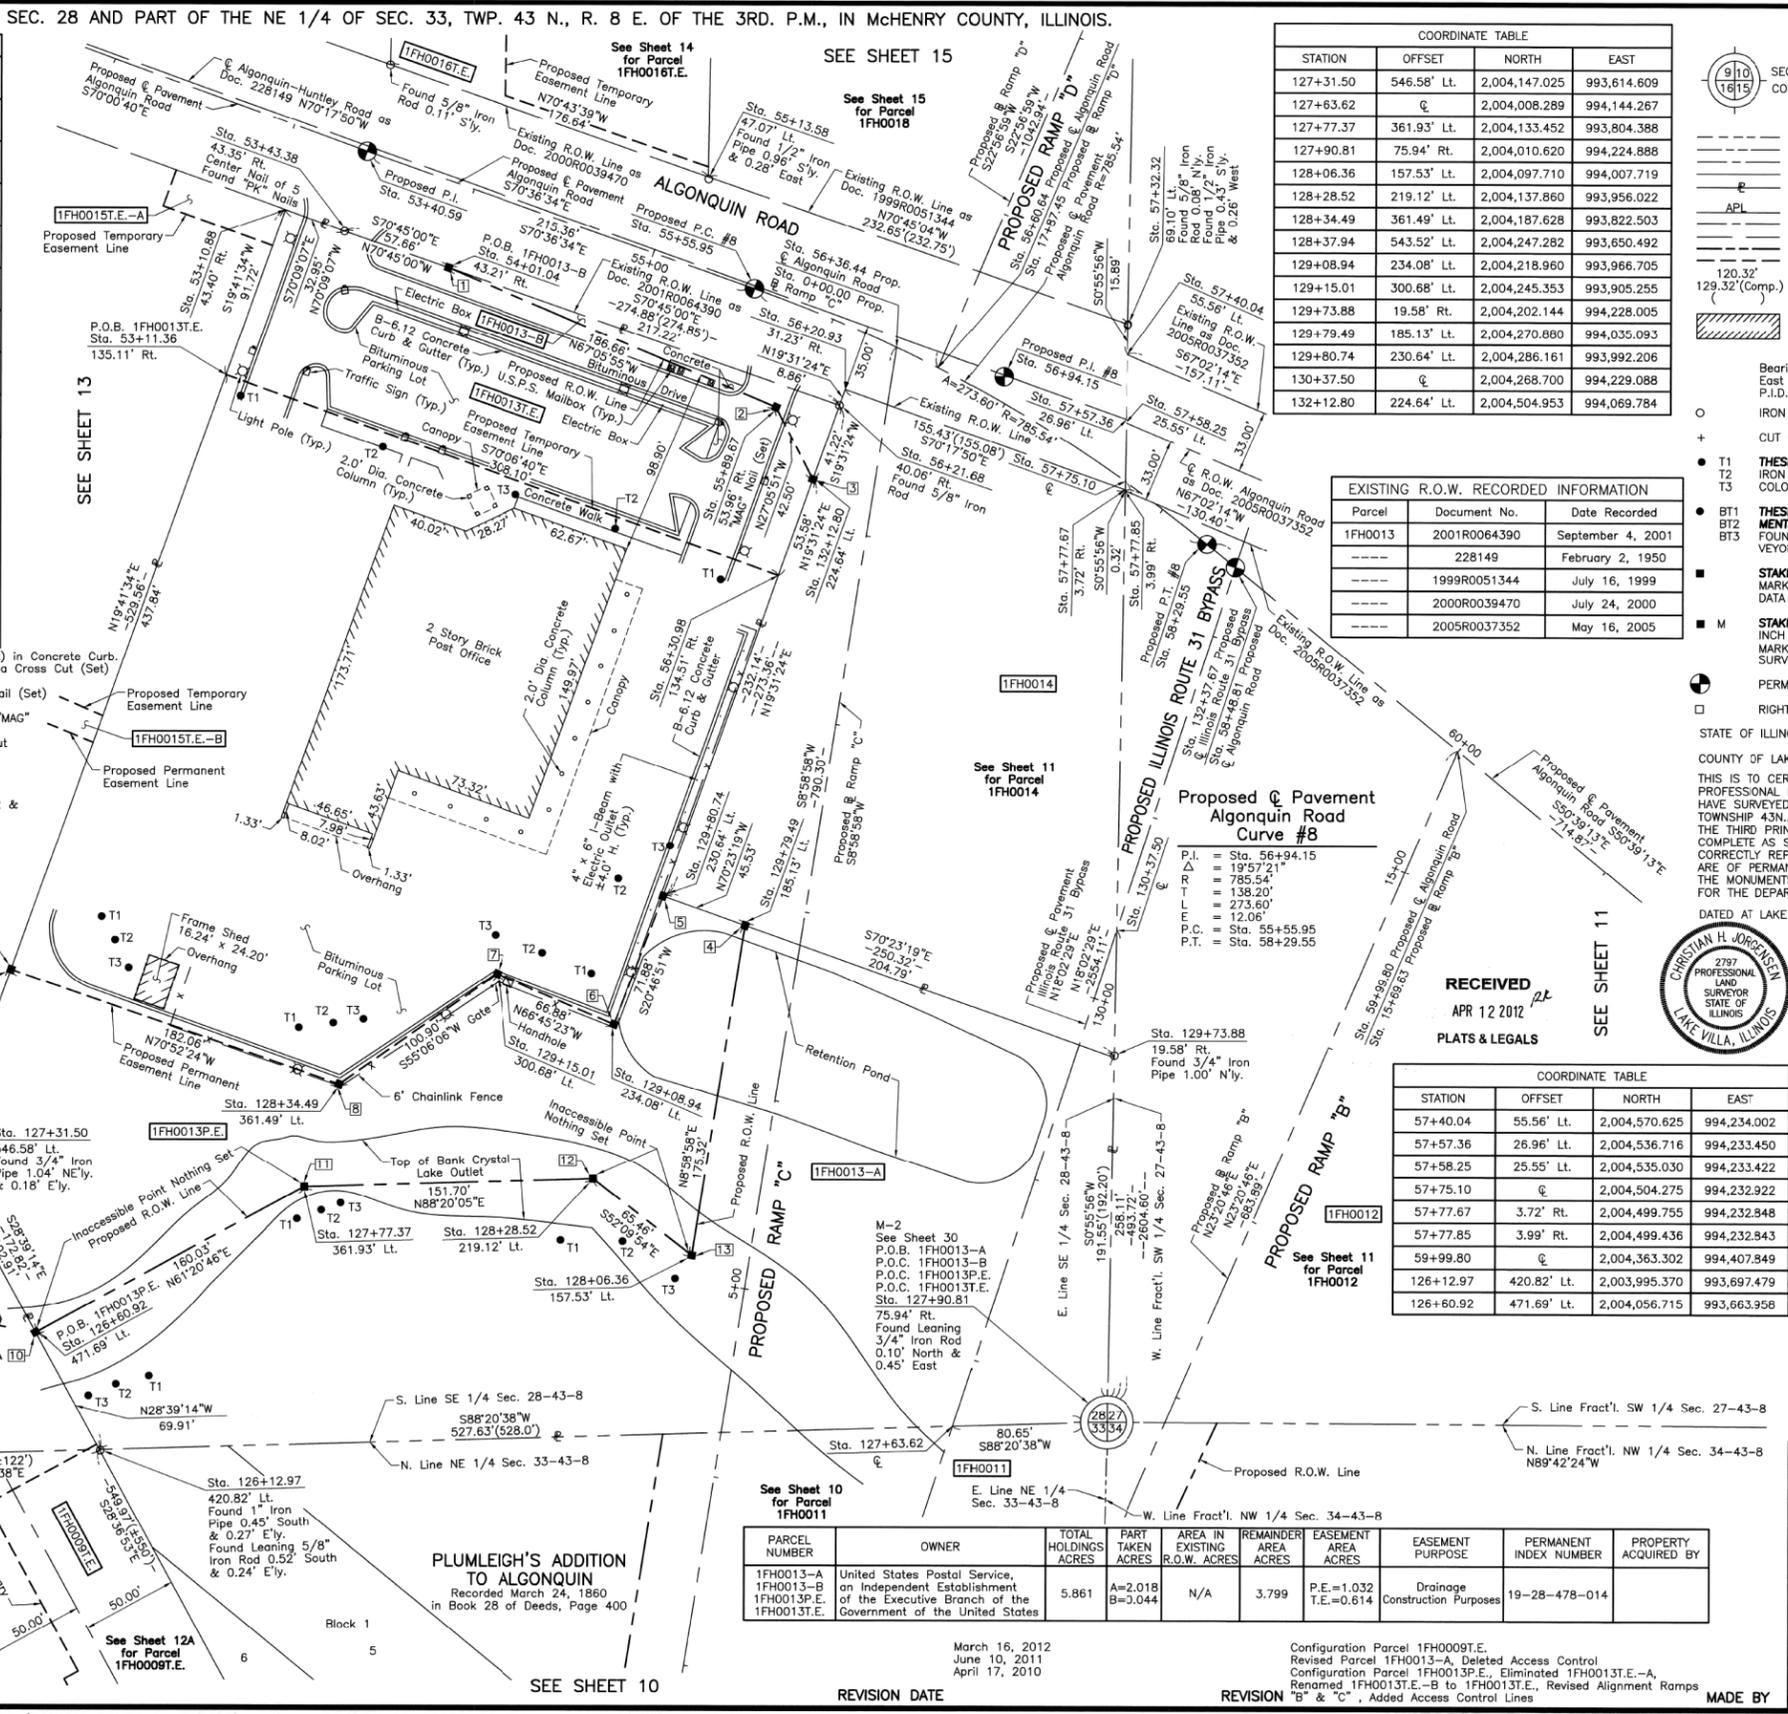

COORDINATE TABLE			
STATION	OFFSET	NORTH	EAST
127+31.50	546.58' Lt.	2,004,147.025	993,614.609
127+63.62	€	2,004,008.289	994,144.267
127+77.37	361.93' Lt.	2,004,133.452	993,804.388
127+90.81	75.94' Rt.	2,004,010.620	994,224.888
128+06.36	157.53' Lt.	2,004,097.710	994,007.719
128+28.52	219.12' Lt.	2,004,137.860	993,956.022
128+34.49	361.49' Lt.	2,004,187.628	993,822.503
128+37.94	543.52' Lt.	2,004,247.282	993,650.492
129+08.94	234.08' Lt.	2,004,218.960	993,966.705
129+15.01	300.68' Lt.	2,004,245.353	993,905.255
129+73.88	19.58' Rt.	2,004,202.144	994,228.005
129+79.49	185.13' Lt.	2,004,270.880	994,035.093
129+80.74	230.64' Lt.	2,004,286.161	993,992.206
130+37.50	€	2,004,268.700	994,229.088
132+12.80	224.64' Lt.	2,004,504.953	994,069.784

EXISTING R.O.W. RECORDED INFORMATION		
Parcel	Document No.	Date Recorded
1FH0013	2001R0064390	September 4, 2001
-----	228149	February 2, 1950
-----	1999R0051344	July 16, 1999
-----	2000R0039470	July 24, 2000
-----	2005R0037352	May 16, 2005

COORDINATE TABLE			
STATION	OFFSET	NORTH	EAST
57+40.04	55.56' Lt.	2,004,570.625	994,234.002
57+57.36	26.96' Lt.	2,004,536.716	994,233.450
57+58.25	25.55' Lt.	2,004,535.030	994,233.422
57+75.10	€	2,004,504.275	994,232.922
57+77.67	3.72' Rt.	2,004,499.755	994,232.948
57+77.85	3.99' Rt.	2,004,499.436	994,232.843
59+99.80	€	2,004,363.302	994,407.849
126+12.97	420.82' Lt.	2,003,995.370	993,697.479
126+60.92	471.69' Lt.	2,004,056.715	993,663.958

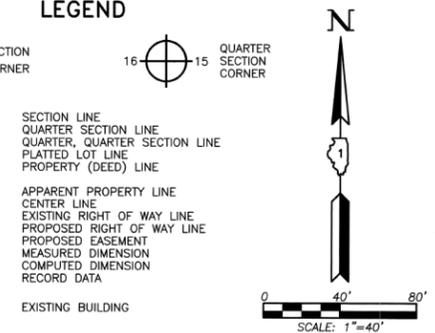

Bearings are referenced to the Illinois Coordinate System NAD83 (1997) East Zone at Found Geodetic Survey Control Monuments "MCH31 1A", P.I.D. AJ2855 and "Algonquin", P.I.D. AJ2945.

○ IRON PIPE OR ROD FOUND ● "MAG" NAIL SET
+ CUT CROSS FOUND OR SET ● 5/8" REBAR SET

● T1 THESE STAKES REFERENCE FOUND OR SET MONUMENTATION. SET 5/8 INCH IRON ROD FLUSH WITH GROUND TO THE FOUND IRON STAKE. IDENTIFIED BY COLORED PLASTIC CAP BEARING SURVEYORS REGISTRATION NUMBER.
● T2
● T3

● BT1 THESE STAKES, IN CULTIVATED AREAS, REFERENCE FOUND OR SET MONUMENTATION. BURIED 5/8 INCH IRON ROD 20 INCHES BELOW GROUND TO THE FOUND IRON STAKE. IDENTIFIED BY COLORED PLASTIC CAP BEARING SURVEYORS REGISTRATION NUMBER.
● BT2
● BT3

■ STAKING OF PROPOSED RIGHT OF WAY. SET DIVISION OF HIGHWAYS SURVEY MARKER TO MONUMENT THE POSITION SHOWN. IDENTIFIED BY INSCRIPTION DATA AND SURVEYORS REGISTRATION NUMBER.

■ M STAKING OF PROPOSED RIGHT OF WAY IN CULTIVATED AREAS. BURIED 5/8 INCH METAL ROD 20 INCHES BELOW GROUND TO MARK FUTURE SURVEY MARKER POSITION IDENTIFIED BY COLORED PLASTIC CAP BEARING SURVEYORS REGISTRATION NUMBER.

⊙ PERMANENT SURVEY MARKER, I.D.O.T STD 2135 (TO BE SET BY OTHERS)

⊠ RIGHT OF WAY STAKING PROPOSED TO BE SET.

STATE OF ILLINOIS }
COUNTY OF LAKE }SS

THIS IS TO CERTIFY THAT WE, JORGENSEN & ASSOCIATES, INC., AN ILLINOIS PROFESSIONAL DESIGN FIRM LAND SURVEYING CORPORATION, NUMBER 184-2771, HAVE SURVEYED THE PLAT OF HIGHWAYS SHOWN HEREON BETWEEN SECTION 28, TOWNSHIP 43N., RANGE 8E. AND SECTION 33, TOWNSHIP 43N., RANGE 8E. OF THE THIRD PRINCIPAL MERIDIAN, McHENRY COUNTY, THAT THE SURVEY IS TRUE AND COMPLETE AS SHOWN TO THE BEST OF MY KNOWLEDGE AND BELIEF; THAT THE PLAT CORRECTLY REPRESENTS SAID SURVEY, THAT ALL MONUMENTS FOUND AND ESTABLISHED ARE OF PERMANENT QUALITY AND OCCUPY THE POSITIONS SHOWN THEREON AND THAT THE MONUMENTS ARE SUFFICIENT TO ENABLE THE SURVEY TO BE RETRACED. MADE FOR THE DEPARTMENT OF TRANSPORTATION, STATE OF ILLINOIS.

DATED AT LAKE VILLA, ILLINOIS THIS 18th DAY OF May 20 2012.



Christian H. Jorgensen, PRESIDENT
ILLINOIS PROFESSIONAL LAND SURVEYOR NO. 35-2797
LICENSE EXPIRATION DATE: NOVEMBER 30, 2006
THIS PROFESSIONAL SERVICE CONFORMS TO THE CURRENT ILLINOIS MINIMUM STANDARDS FOR A BOUNDARY SURVEY.
COORDINATES ARE BASED ON THE PUBLISHED METRIC COORDINATE VALUES AT FOUND GEODETIC SURVEY CONTROL MONUMENT "MCH31 1A", P.I.D. AJ2855, OF N.613.205.182°-E.303.895.917.
NOTE: SURFACE COORDINATES ARE SHOWN.

COORDINATE TABLE			
STATION	OFFSET	NORTH	EAST
57+40.04	55.56' Lt.	2,004,570.625	994,234.002
57+57.36	26.96' Lt.	2,004,536.716	994,233.450
57+58.25	25.55' Lt.	2,004,535.030	994,233.422
57+75.10	€	2,004,504.275	994,232.922
57+77.67	3.72' Rt.	2,004,499.755	994,232.948
57+77.85	3.99' Rt.	2,004,499.436	994,232.843
59+99.80	€	2,004,363.302	994,407.849
126+12.97	420.82' Lt.	2,003,995.370	993,697.479
126+60.92	471.69' Lt.	2,004,056.715	993,663.958

COORDINATE TABLE			
STATION	OFFSET	NORTH	EAST
53+10.88	43.40' Rt.	2,004,645.617	993,793.059
53+11.36	135.11' Rt.	2,004,559.265	993,762.153
53+43.38	43.35' Rt.	2,004,634.429	993,824.051
54+01.04	43.21' Rt.	2,004,615.420	993,878.485
55+13.58	47.07' Lt.	2,004,663.211	994,014.617
55+89.67	53.96' Rt.	2,004,542.784	994,050.427
56+20.93	31.23' Rt.	2,004,552.155	994,086.521
56+21.68	40.06' Rt.	2,004,543.805	994,083.560
56+30.98	134.51' Rt.	2,004,454.449	994,051.877
56+36.44	€	2,004,574.181	994,113.380
56+60.64	€	2,004,563.518	994,135.104
57+32.32	69.10' Lt.	2,004,586.512	994,234.260

JORGENSEN & ASSOCIATES, INC.
120 PARK AVENUE
LAKE VILLA, ILLINOIS 60046
(847) 356-3371

SHEET 1 IS A COVER SHEET AND IS NOT RECORDED.

PLAT OF HIGHWAYS
STATE OF ILLINOIS
DEPARTMENT OF TRANSPORTATION
F.A.P. 336 (ILLINOIS ROUTE 31 BYPASS)
SECTION 96-00209-00-PV McHENRY COUNTY
PROJECT JOB NO. R-91-022-03
STATION 52+00 TO STATION 61+00
STATION 127+00 TO STATION 133+00
SCALE: 1"=40' SHEET 12 OF 32

BUREAU OF LAND ACQUISITION
201 WEST CENTER COURT
SCHAUMBURG, ILLINOIS 60196

PARCEL NUMBER	OWNER	TOTAL HOLDINGS ACRES	PART TAKEN ACRES	AREA IN EXISTING R.O.W. ACRES	REMAINDER AREA ACRES	EASEMENT AREA ACRES	EASEMENT PURPOSE	PERMANENT INDEX NUMBER	PROPERTY ACQUIRED BY
1FH0013-A	United States Postal Service, an Independent Establishment of the Executive Branch of the Government of the United States	5.861	A=2.018 B=3.044	N/A	3.799	P.E.=1.032 T.E.=0.614	Drainage Construction Purposes	19-28-478-014	
1FH0013-B									
1FH0013P.E.									
1FH0013T.E.									

March 16, 2012
June 10, 2011
April 17, 2010

Configuration Parcel 1FH0009T.E.
Revised Parcel 1FH0013-A, Deleted Access Control
Configuration Parcel 1FH0013P.E., Eliminated 1FH0013T.E.-A,
Renamed 1FH0013T.E.-B to 1FH0013T.E., Revised Alignment Ramps
"B" & "C", Added Access Control Lines

STATE OF ILLINOIS
DEPARTMENT OF TRANSPORTATION

PLAT OF HIGHWAYS

SCALE: GRAPHIC SHEET NO. 14 OF 49 SHEETS STA. TO STA.

O.R. RTE.	SECTION	COUNTY	TOTAL SHEETS	SHEET NO.
0003	18A-2	McHENRY	825	423
				CONTRACT NO. 60F72

FILE NAME	USER NAME	DESIGNED	REVISED
...\\D160F72-sht-PH-14.dgn	akw	-	-
		DRAWN - JORGENSEN & ASSOC.	REVISED -
		CHECKED - CJ	REVISED -
		DATE -	REVISED -



DATE	BY	REVISION
5/2/2012		

PART OF THE NE 1/4 OF SEC. 33 AND PART OF THE FRACTIONAL NW 1/4 OF SEC. 34, TWP. 43 N., R. 8 E. OF THE 3RD. P.M., IN McHENRY COUNTY, ILLINOIS.

SEE SHEET 12

SEE SHEET 11

LEGEND

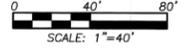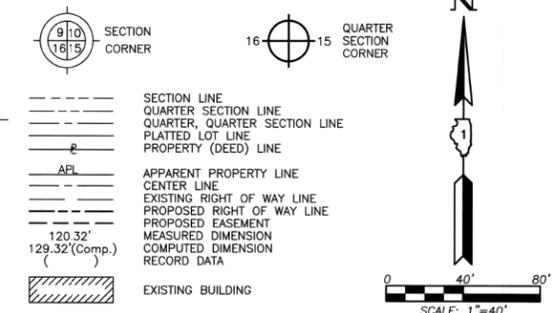

- Bearings are referenced to the Illinois Coordinate System NAD83 (1997) East Zone at Found Geodetic Survey Control Monuments "MCH31 1A", P.I.D. AJ2855 and "Algonquin", P.I.D. AJ2945.
- IRON PIPE OR ROD FOUND
 - ⊕ "MAG" NAIL SET
 - + CUT CROSS FOUND OR SET
 - 5/8" REBAR SET
 - T1 THESE STAKES REFERRED FOUND OR SET MONUMENTATION. SET 5/8 INCH IRON ROD FLUSH WITH GROUND TO THE FOUND IRON STAKE. IDENTIFIED BY COLORED PLASTIC CAP BEARING SURVEYORS REGISTRATION NUMBER.
 - T2
 - T3
 - BT1 THESE STAKES, IN CULTIVATED AREAS, REFERRED FOUND OR SET MONUMENTATION. BURIED 5/8 INCH IRON ROD 20 INCHES BELOW GROUND TO THE FOUND IRON STAKE. IDENTIFIED BY COLORED PLASTIC CAP BEARING SURVEYORS REGISTRATION NUMBER.
 - BT2
 - BT3
 - STAKING OF PROPOSED RIGHT OF WAY. SET DIVISION OF HIGHWAYS SURVEY MARKER TO MONUMENT THE POSITION SHOWN. IDENTIFIED BY INSCRIPTION DATA AND SURVEYORS REGISTRATION NUMBER.
 - M STAKING OF PROPOSED RIGHT OF WAY IN CULTIVATED AREAS. BURIED 5/8 INCH METAL ROD 20 INCHES BELOW GROUND TO MARK FUTURE SURVEY MARKER POSITION IDENTIFIED BY COLORED PLASTIC CAP BEARING SURVEYORS REGISTRATION NUMBER.
 - ⊙ PERMANENT SURVEY MARKER, I.D.O.T STD 2135 (TO BE SET BY OTHERS)
 - RIGHT OF WAY STAKING PROPOSED TO BE SET.

STATE OF ILLINOIS }
 COUNTY OF LAKE }
 THIS IS TO CERTIFY THAT WE, JORGENSEN & ASSOCIATES, INC., AN ILLINOIS PROFESSIONAL DESIGN FIRM LAND SURVEYING CORPORATION, NUMBER 184-2771, HAVE SURVEYED THE PLAT OF HIGHWAYS SHOWN HEREON BETWEEN SECTION 33, TOWNSHIP 43N., RANGE 8E. AND SECTION 34, TOWNSHIP 43N., RANGE 8E., OF THE THIRD PRINCIPAL MERIDIAN, McHENRY COUNTY, THAT THE SURVEY IS TRUE AND COMPLETE AS SHOWN TO THE BEST OF MY KNOWLEDGE AND BELIEF, THAT THE PLAT CORRECTLY REPRESENTS SAID SURVEY, THAT ALL MONUMENTS FOUND AND ESTABLISHED ARE OF PERMANENT QUALITY AND OCCUPY THE POSITIONS SHOWN THEREON AND THAT THE MONUMENTS ARE SUFFICIENT TO ENABLE THE SURVEY TO BE RETRACED. MADE FOR THE DEPARTMENT OF TRANSPORTATION, STATE OF ILLINOIS.

DATED AT LAKE VILLA, ILLINOIS THIS 18th DAY OF May 2012.

Christian H. Jorgensen PRESIDENT
 ILLINOIS PROFESSIONAL LAND SURVEYOR NO. 35-2797
 LICENSE EXPIRATION DATE: NOVEMBER 30, 2006

THIS PROFESSIONAL SERVICE CONFORMS TO THE CURRENT ILLINOIS MINIMUM STANDARDS FOR A BOUNDARY SURVEY.


COORDINATES ARE BASED ON THE PUBLISHED METRIC COORDINATE VALUES AT FOUND GEODETIC SURVEY CONTROL MONUMENT "MCH31 1A", P.I.D. AJ2855, OF N.613,205.182-E.303,895.917. NOTE: SURFACE COORDINATES ARE SHOWN.

STATION	OFFSET	NORTH	EAST
120+02.82	53.12' Rt.	2,003,292.586	994,139.162
121+09.41	119.25' Lt.	2,003,341.580	993,940.241
121+66.30	151.37' Lt.	2,003,400.825	993,894.251
122+00.22	125.02' Lt.	2,003,444.942	993,914.081
122+04.93	50.57' Lt.	2,003,459.560	993,987.264
122+53.93	76.18' Lt.	2,003,510.505	993,957.077
122+55.62	72.28' Lt.	2,003,512.574	993,960.869
123+00.22	135.01' Lt.	2,003,562.503	993,897.196
123+08.08	348.14' Lt.	2,003,576.875	993,684.293
123+56.08	138.47' Lt.	2,003,629.265	993,897.208
123+81.50	439.05' Lt.	2,003,697.747	993,602.403
124+28.08	473.29' Lt.	2,003,778.945	993,580.888

JORGENSEN & ASSOCIATES, INC.
 120 PARK AVENUE
 LAKE VILLA, ILLINOIS 60046
 (815) 356-3371

PLAT OF HIGHWAYS
 STATE OF ILLINOIS
 DEPARTMENT OF TRANSPORTATION
 F.A.P. 336 (ILLINOIS ROUTE 31 BYPASS)
 SECTION 96-00209-00-PV McHENRY COUNTY
 PROJECT STATION 119+58.42 TO STATION 128+00
 SCALE: 1"=40' SHEET 12A OF 37

BUREAU OF LAND ACQUISITION
 201 WEST CENTER COURT
 SCHAUMBURG, ILLINOIS 60196

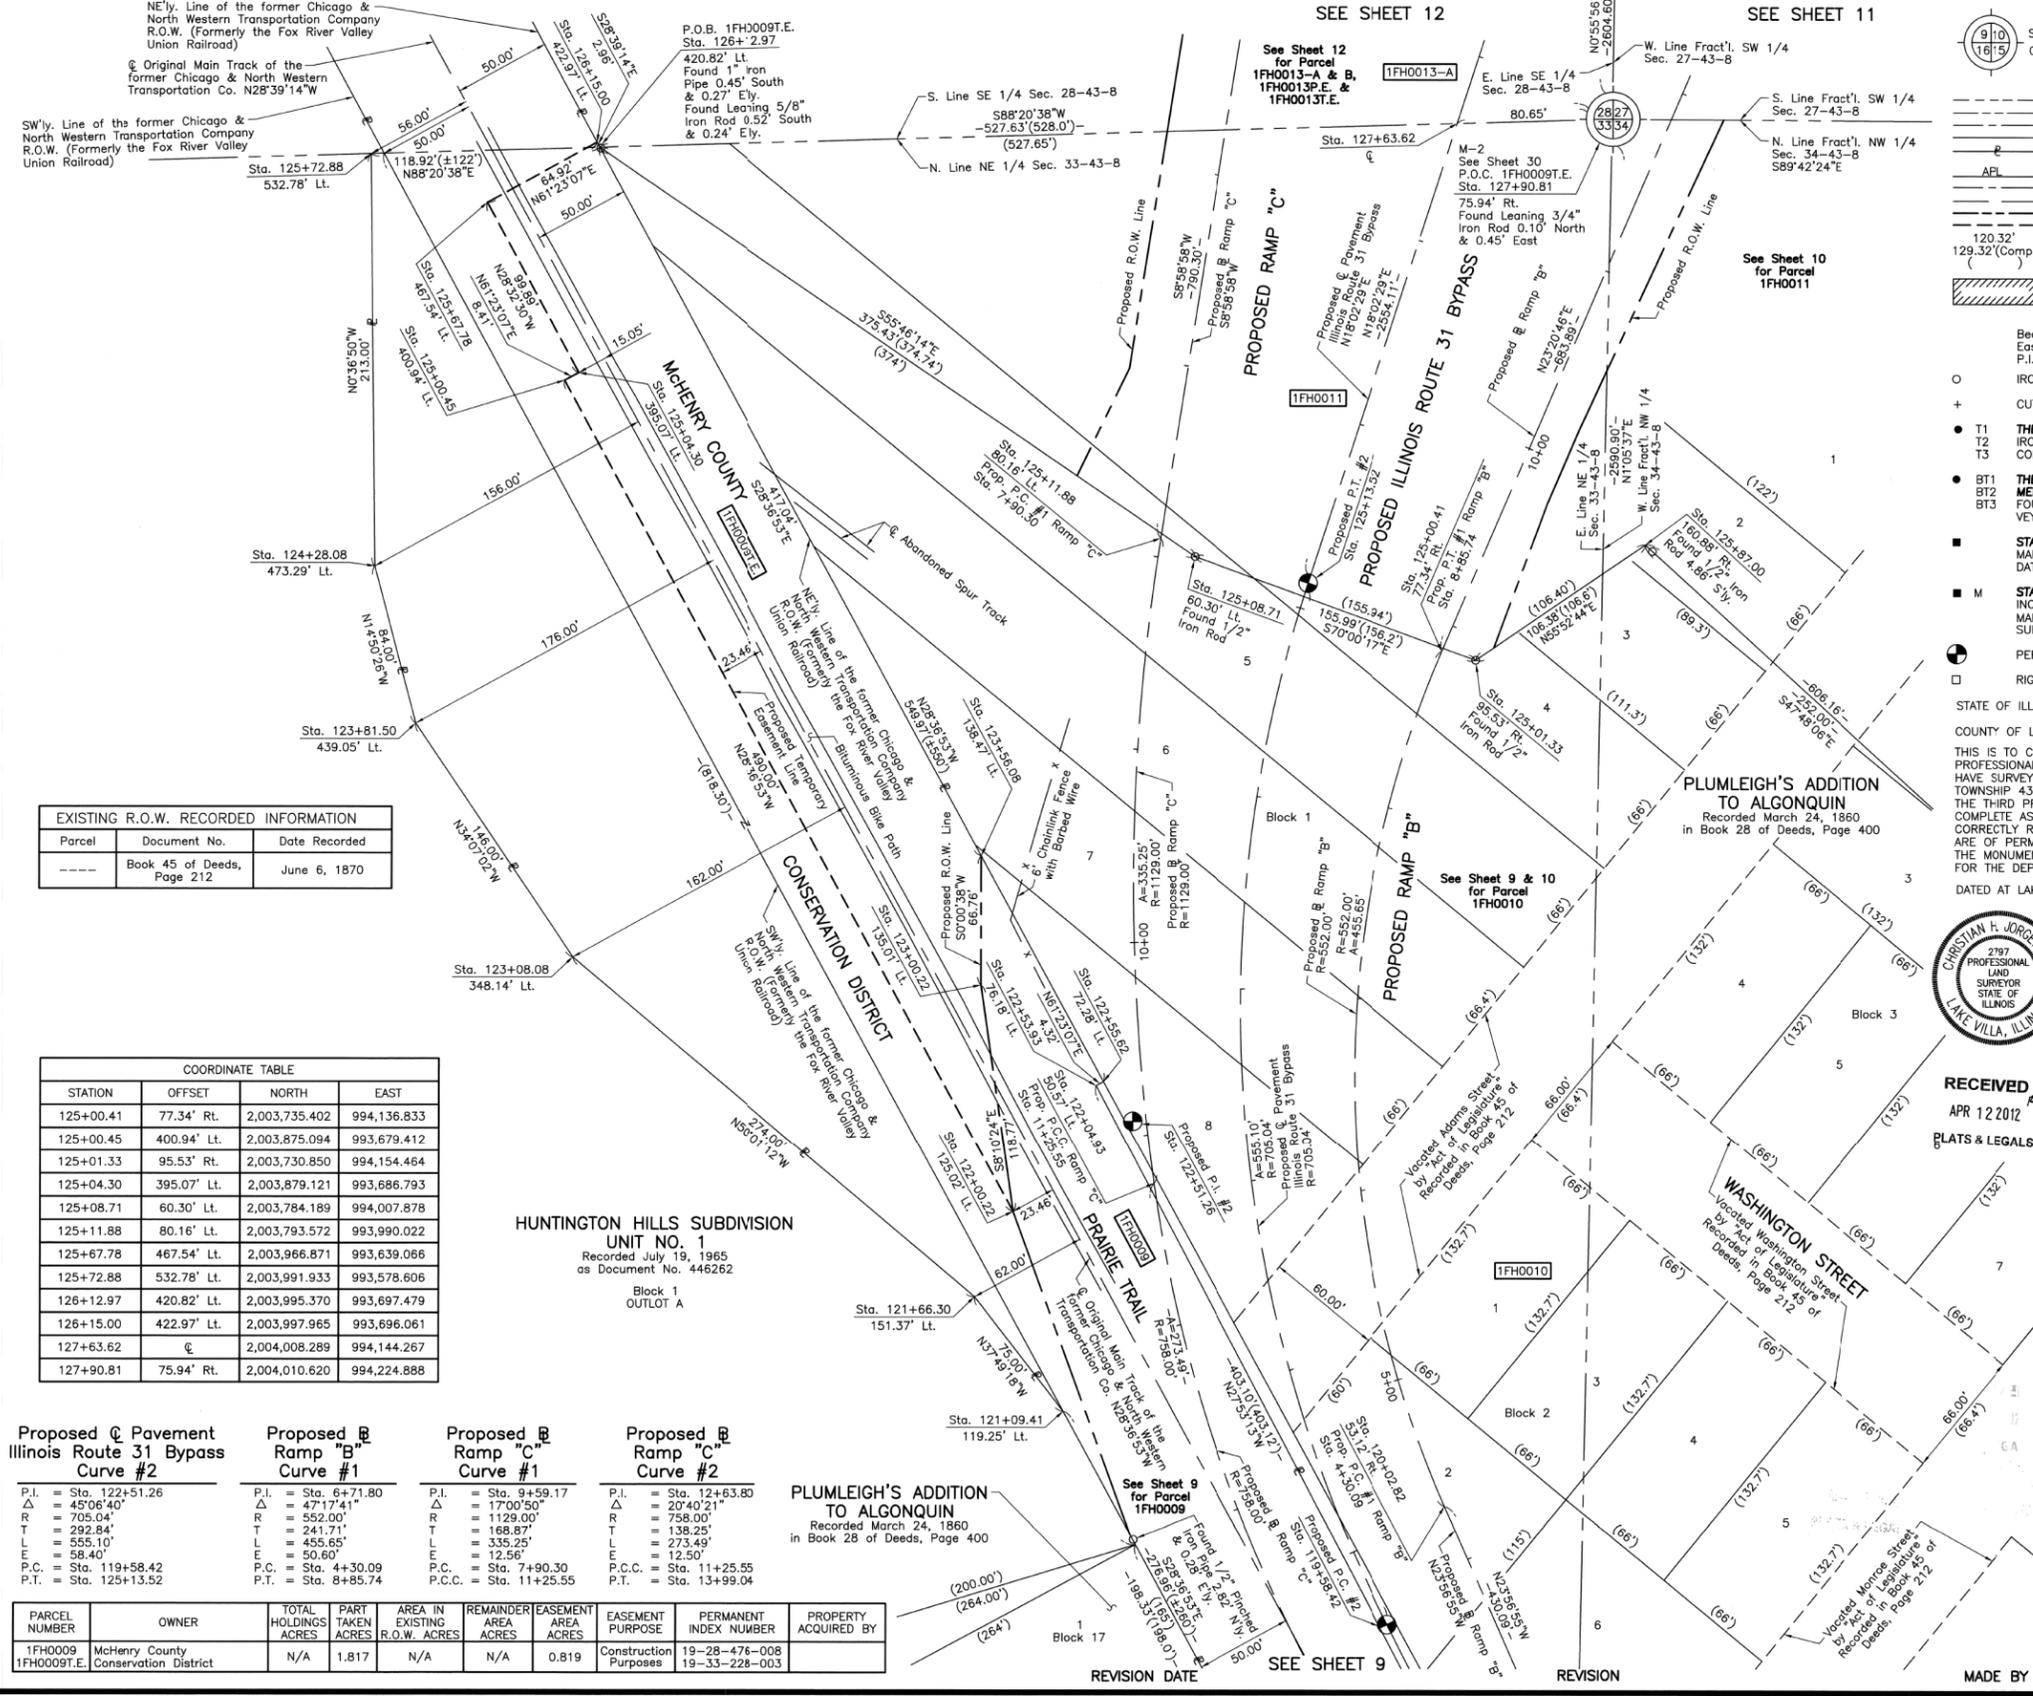

Parcel	Document No.	Date Recorded
---	Book 45 of Deeds, Page 212	June 6, 1870

STATION	OFFSET	NORTH	EAST
125+00.41	77.34' Rt.	2,003,735.402	994,136.833
125+00.45	400.94' Lt.	2,003,875.094	993,679.412
125+01.33	95.53' Rt.	2,003,730.850	994,154.464
125+04.30	395.07' Lt.	2,003,879.121	993,686.793
125+08.71	60.30' Lt.	2,003,784.189	994,007.878
125+11.88	80.16' Lt.	2,003,793.572	993,990.022
125+67.78	467.54' Lt.	2,003,966.871	993,639.066
125+72.88	532.78' Lt.	2,003,991.933	993,578.606
126+12.97	420.82' Lt.	2,003,995.370	993,697.479
126+15.00	422.97' Lt.	2,003,997.965	993,696.061
127+63.62	€	2,004,008.289	994,144.267
127+90.81	75.94' Rt.	2,004,010.620	994,224.888

Proposed Pavement Illinois Route 31 Bypass Curve #2	Proposed Ramp "B" Curve #1	Proposed Ramp "C" Curve #1	Proposed Ramp "C" Curve #2
P.I. = Sta. 122+51.26	P.I. = Sta. 6+71.80	P.I. = Sta. 9+59.17	P.I. = Sta. 12+63.80
Δ = 45°06'40"	Δ = 47°17'41"	Δ = 17°00'50"	Δ = 20°40'21"
R = 705.04'	R = 552.00'	R = 1129.00'	R = 758.00'
T = 292.84'	T = 241.71'	T = 168.87'	T = 138.25'
L = 555.10'	L = 455.65'	L = 335.25'	L = 273.49'
E = 58.40'	E = 50.60'	E = 12.56'	E = 12.50'
P.C. = Sta. 119+58.42	P.C. = Sta. 4+30.09	P.C. = Sta. 7+90.30	P.C.C. = Sta. 11+25.55
P.T. = Sta. 125+13.52	P.T. = Sta. 8+85.74	P.T. = Sta. 13+99.04	P.T. = Sta. 13+99.04

PARCEL NUMBER	OWNER	TOTAL HOLDINGS ACRES	PART TAKEN ACRES	AREA IN EXISTING R.O.W. ACRES	REMAINDER AREA ACRES	EASEMENT AREA ACRES	EASEMENT PURPOSE	PERMANENT INDEX NUMBER	PROPERTY ACQUIRED BY
1FH0009	McHenry County Conservation District	N/A	1.817	N/A	N/A	0.819	Construction Purposes	19-28-476-008 19-33-228-003	

ROUTE F.A.P. 336 (ILLINOIS ROUTE 31 BYPASS) SECTION 96-00209-00-PV COUNTY McHENRY JOB NO. R-91-022-03 RECORDING: RECORDED ON AS DOCUMENT NO.

PART OF THE SE 1/4 OF SEC. 28, TWP. 43 N., R. 8 E. OF THE 3RD. P.M., IN McHENRY COUNTY, ILLINOIS.

SEE SHEET 14

PARCEL NUMBER	OWNER	TOTAL HOLDINGS ACRES	PART TAKEN ACRES	AREA IN EXISTING R.O.W. ACRES	REMAINDER AREA ACRES	EASEMENT AREA ACRES	EASEMENT PURPOSE	PERMANENT INDEX NUMBER	PROPERTY ACQUIRED BY
1FH0015P.E.-A 1FH0015T.E.-A 1FH0015T.E.-B	Wauconda Tool & Engineering Company, Inc.	3.434	N/A	N/A	3.434	P.E.-0.716 T.E.-A=0.028 T.E.-B=0.141	Drainage Construction Purposes Construction Purposes	19-28-478-013	

LEGEND



Bearings are referenced to the Illinois Coordinate System NAD83 (1997) East Zone as Found Geodetic Survey Control Monuments "MCH31 1A", P.I.D. AJ2855 and "Algonquin", P.I.D. AJ2945.

- IRON PIPE OR ROD FOUND
- ⊕ "MAG" NAIL SET
- + CUT CROSS FOUND OR SET
- 5/8" REBAR SET
- THESE STAKES REFERENCE FOUND OR SET MONUMENTATION. SET 5/8 INCH IRON ROD FLUSH WITH GROUND TO THE FOUND IRON STAKE. IDENTIFIED BY COLORED PLASTIC CAP BEARING SURVEYORS REGISTRATION NUMBER.
- THESE STAKES, IN CULTIVATED AREAS, REFERENCE FOUND OR SET MONUMENTATION. BURIED 5/8 INCH IRON ROD 20 INCHES BELOW GROUND TO THE FOUND IRON STAKE. IDENTIFIED BY COLORED PLASTIC CAP BEARING SURVEYORS REGISTRATION NUMBER.
- STAKING OF PROPOSED RIGHT OF WAY. SET DIVISION OF HIGHWAYS SURVEY MARKER TO MONUMENT THE POSITION SHOWN. IDENTIFIED BY INSCRIPTION DATA AND SURVEYORS REGISTRATION NUMBER.
- M STAKING OF PROPOSED RIGHT OF WAY IN CULTIVATED AREAS. BURIED 5/8 INCH METAL ROD 20 INCHES BELOW GROUND TO MARK FUTURE SURVEY MARKER POSITION IDENTIFIED BY COLORED PLASTIC CAP BEARING SURVEYORS REGISTRATION NUMBER.
- PERMANENT SURVEY MARKER, I.D.O.T STD 2135 (TO BE SET BY OTHERS)
- RIGHT OF WAY STAKING PROPOSED TO BE SET.

STATE OF ILLINOIS }
COUNTY OF LAKE } SS

THIS IS TO CERTIFY THAT WE, JORGENSEN & ASSOCIATES, INC., AN ILLINOIS PROFESSIONAL DESIGN FIRM LAND SURVEYING CORPORATION, NUMBER 184-2771, HAVE SURVEYED THE PLAT OF HIGHWAYS SHOWN HEREON IN SECTION 28, TOWNSHIP 43N., RANGE 8E., OF THE THIRD PRINCIPAL MERIDIAN, McHENRY COUNTY, THAT THE SURVEY IS TRUE AND COMPLETE AS SHOWN TO THE BEST OF MY KNOWLEDGE AND BELIEF, THAT THE PLAT CORRECTLY REPRESENTS SAID SURVEY, THAT ALL MONUMENTS FOUND AND ESTABLISHED ARE OF PERMANENT QUALITY AND OCCUPY THE POSITIONS SHOWN THEREON AND THAT THE MONUMENTS ARE SUFFICIENT TO ENABLE THE SURVEY TO BE RETRACED. MADE FOR THE DEPARTMENT OF TRANSPORTATION, STATE OF ILLINOIS. DATED AT LAKE VILLA, ILLINOIS THIS 18TH DAY OF May 2012.



NOTE: SURFACE COORDINATES ARE SHOWN.

COORDINATE TABLE			
STATION	OFFSET	NORTH	EAST
48+53.01	44.52' Rt.	2,004,801.076	993,362.388
52+50.00	43.55' Rt.	2,004,666.287	993,735.794
52+50.05	63.55' Rt.	2,004,647.476	993,729.004
53+10.88	43.40' Rt.	2,004,645.617	993,793.059
53+10.98	63.40' Rt.	2,004,626.786	993,786.319
53+36.45	46.67' Lt.	2,004,721.513	993,847.876
53+43.38	43.35' Rt.	2,004,634.429	993,824.051
55+13.58	47.07' Lt.	2,004,663.211	994,014.617
56+20.93	31.23' Rt.	2,004,552.155	994,086.521
56+21.68	40.06' Rt.	2,004,543.805	994,083.560
56+36.44	€	2,004,574.181	994,113.380
56+60.64	€	2,004,563.518	994,135.104

JORGENSEN & ASSOCIATES, INC.
120 PARK AVENUE
LAKE VILLA, ILLINOIS 60046
(847) 356-3371

PLAT OF HIGHWAYS
STATE OF ILLINOIS
DEPARTMENT OF TRANSPORTATION
F.A.P. 336 (ILLINOIS ROUTE 31 BYPASS)
SECTION 96-00209-00-PV McHENRY COUNTY
PROJECT JOB NO. R-91-022-03
STATION 49+00 TO STATION 58+00
STATION 127+00 TO STATION 133+00
SCALE: 1"=40'
SHEET 13 OF 37

BUREAU OF LAND ACQUISITION
201 WEST CENTER COURT
SCHAUMBURG, ILLINOIS 60196
AS DOCUMENT NO.

STATION	OFFSET	NORTH	EAST
57+32.32	69.10' Lt.	2,004,586.512	994,234.260
57+40.04	55.56' Lt.	2,004,570.625	994,234.002
57+57.36	26.96' Lt.	2,004,536.716	994,233.450
57+58.25	25.55' Lt.	2,004,535.030	994,233.422
57+75.10	€	2,004,504.275	994,232.922
57+77.67	3.72' Rt.	2,004,499.755	994,232.848
57+77.85	3.99' Rt.	2,004,499.436	994,232.843
127+31.50	546.58' Lt.	2,004,147.025	993,614.609
127+63.62	€	2,004,008.289	994,144.267
127+90.81	75.94' Rt.	2,004,010.620	994,224.888
129+22.29	617.13' Lt.	2,004,350.283	993,606.620
129+24.86	651.59' Lt.	2,004,363.399	993,574.650
129+64.66	539.86' Lt.	2,004,366.638	993,693.210
129+70.16	613.56' Lt.	2,004,394.690	993,624.840
129+74.65	647.91' Lt.	2,004,409.596	993,593.568
129+79.44	539.44' Lt.	2,004,380.560	993,698.193
129+90.81	821.71' Lt.	2,004,478.788	993,433.320
130+08.00	839.95' Lt.	2,004,500.788	993,421.299
130+37.50	€	2,004,268.700	994,229.088

Point Number	Tie to point	Tie Distance (feet)
1	T1	53.25
	T2	33.72
	T3	52.90
2	T1	20.60
	T2	26.03
	T3	52.90
3	T1	69.47
	T2	72.25
	T3	86.58
4	T1	80.94
	T2	72.88
	T3	73.30
5	T1	47.19
	T2	29.16
	T3	27.56
6	T1	47.48
	T2	37.36
	T3	45.89

All Ties to Point Nos. 1, 2, 3, 4 & 5 are a "MAG" Nail (Set) in Bituminous Parking Lot.
All Ties to Point No. 6 are a Cross Cut (Set) in Concrete Curb.
All ties to Point No. 6 are a Cross Cut (Set) in Concrete Curb.

Parcel	Document No.	Date Recorded
1FH0015	2001R0016865	March 21, 2001
-----	228149	February 2, 1950
-----	1999R0051344	July 16, 1999
-----	2000R0039470	July 24, 2000
-----	2000R0065911	December 1, 2000
-----	2001R0064390	September 4, 2001
-----	2005R0037352	May 16, 2005

S. Line SE 1/4 Sec. 28-43-8
S88°20'38"W
527.63'(528.0')

N. Line NE 1/4 Sec. 33-43-8
October 28, 2011

ROW	DATE	BY	MADE	CHECKED	LINKED	NOTED
1						
2						
3						
4						
5						
6						
7						
8						
9						
10						

ROUTE F.A.P. 336 (ILLINOIS ROUTE 31 BYPASS) SECTION 96-00209-00-PV COUNTY McHENRY JOB NO. R-91-022-03 REVISION DATE April 15, 2010 REVISION TO STA. 127+63.62

PART OF THE SE 1/4 OF SEC. 28, TWP. 43 N., R. 8 E. OF THE 3RD. P.M., IN McHENRY COUNTY, ILLINOIS.

EXISTING R.O.W. RECORDED INFORMATION		
Parcel	Document No.	Date Recorded
1FH0016	94R 055444	September 23, 1994
1FH0016	2000R0039470	July 24, 2000
1FH0016	2000R0065911	December 1, 2000
-----	228149	February 2, 1950
-----	94R 055444	September 23, 1994
-----	1999R0051344	July 16, 1999
-----	2001R0016865	March 21, 2001
-----	2001R0064390	August 4, 2001

LEGEND

SECTION CORNER 910 1615
QUARTER SECTION CORNER 16 15

SECTION LINE
QUARTER SECTION LINE
QUARTER-SECTION LINE
PLATTED LOT LINE
PROPERTY (DEED) LINE

APL
APPARENT PROPERTY LINE
CENTER LINE
EXISTING RIGHT OF WAY LINE
PROPOSED RIGHT OF WAY LINE
PROPOSED EASEMENT
MEASURED DIMENSION
COMPUTED DIMENSION
RECORD DATA

EXISTING BUILDING


Scale: 1"=30'

Bearings are referenced to the Illinois Coordinate System NAD83 (1997) East Zone at Found Geodetic Survey Control Monuments "MCH31 1A", P.I.D. AJ2855 and "Algonquin", P.I.D. AJ2945.

IRON PIPE OR ROD FOUND "MAG" NAIL SET
+ OUT CROSS FOUND OR SET • 5/8" REBAR SET

● T1 THESE STAKES REFERENCE FOUND OR SET MONUMENTATION. SET 5/8" INCH IRON ROD FLUSH WITH GROUND TO THE FOUND IRON STAKE. IDENTIFIED BY COLORED PLASTIC CAP BEARING SURVEYORS REGISTRATION NUMBER.
● BT1 THESE STAKES, IN CULTIVATED AREAS, REFERENCE FOUND OR SET MONUMENTATION. BURIED 5/8" INCH IRON ROD 20 INCHES BELOW GROUND TO THE FOUND IRON STAKE. IDENTIFIED BY COLORED PLASTIC CAP BEARING SURVEYORS REGISTRATION NUMBER.
■ STAKING OF PROPOSED RIGHT OF WAY. SET DIVISION OF HIGHWAYS SURVEY MARKER TO MONUMENT THE POSITION SHOWN. IDENTIFIED BY INSCRIPTION DATA AND SURVEYORS REGISTRATION NUMBER.
■ M STAKING OF PROPOSED RIGHT OF WAY IN CULTIVATED AREAS. BURIED 5/8" INCH METAL ROD 20 INCHES BELOW GROUND TO MARK FUTURE SURVEY MARKER POSITION IDENTIFIED BY COLORED PLASTIC CAP BEARING SURVEYORS REGISTRATION NUMBER.
● PERMANENT SURVEY MARKER, I.D.O.T STD 2135 (TO BE SET BY OTHERS)
□ RIGHT OF WAY STAKING PROPOSED TO BE SET.

BY	DATE	MADE	CHECKED	NOTEBOOK	NO

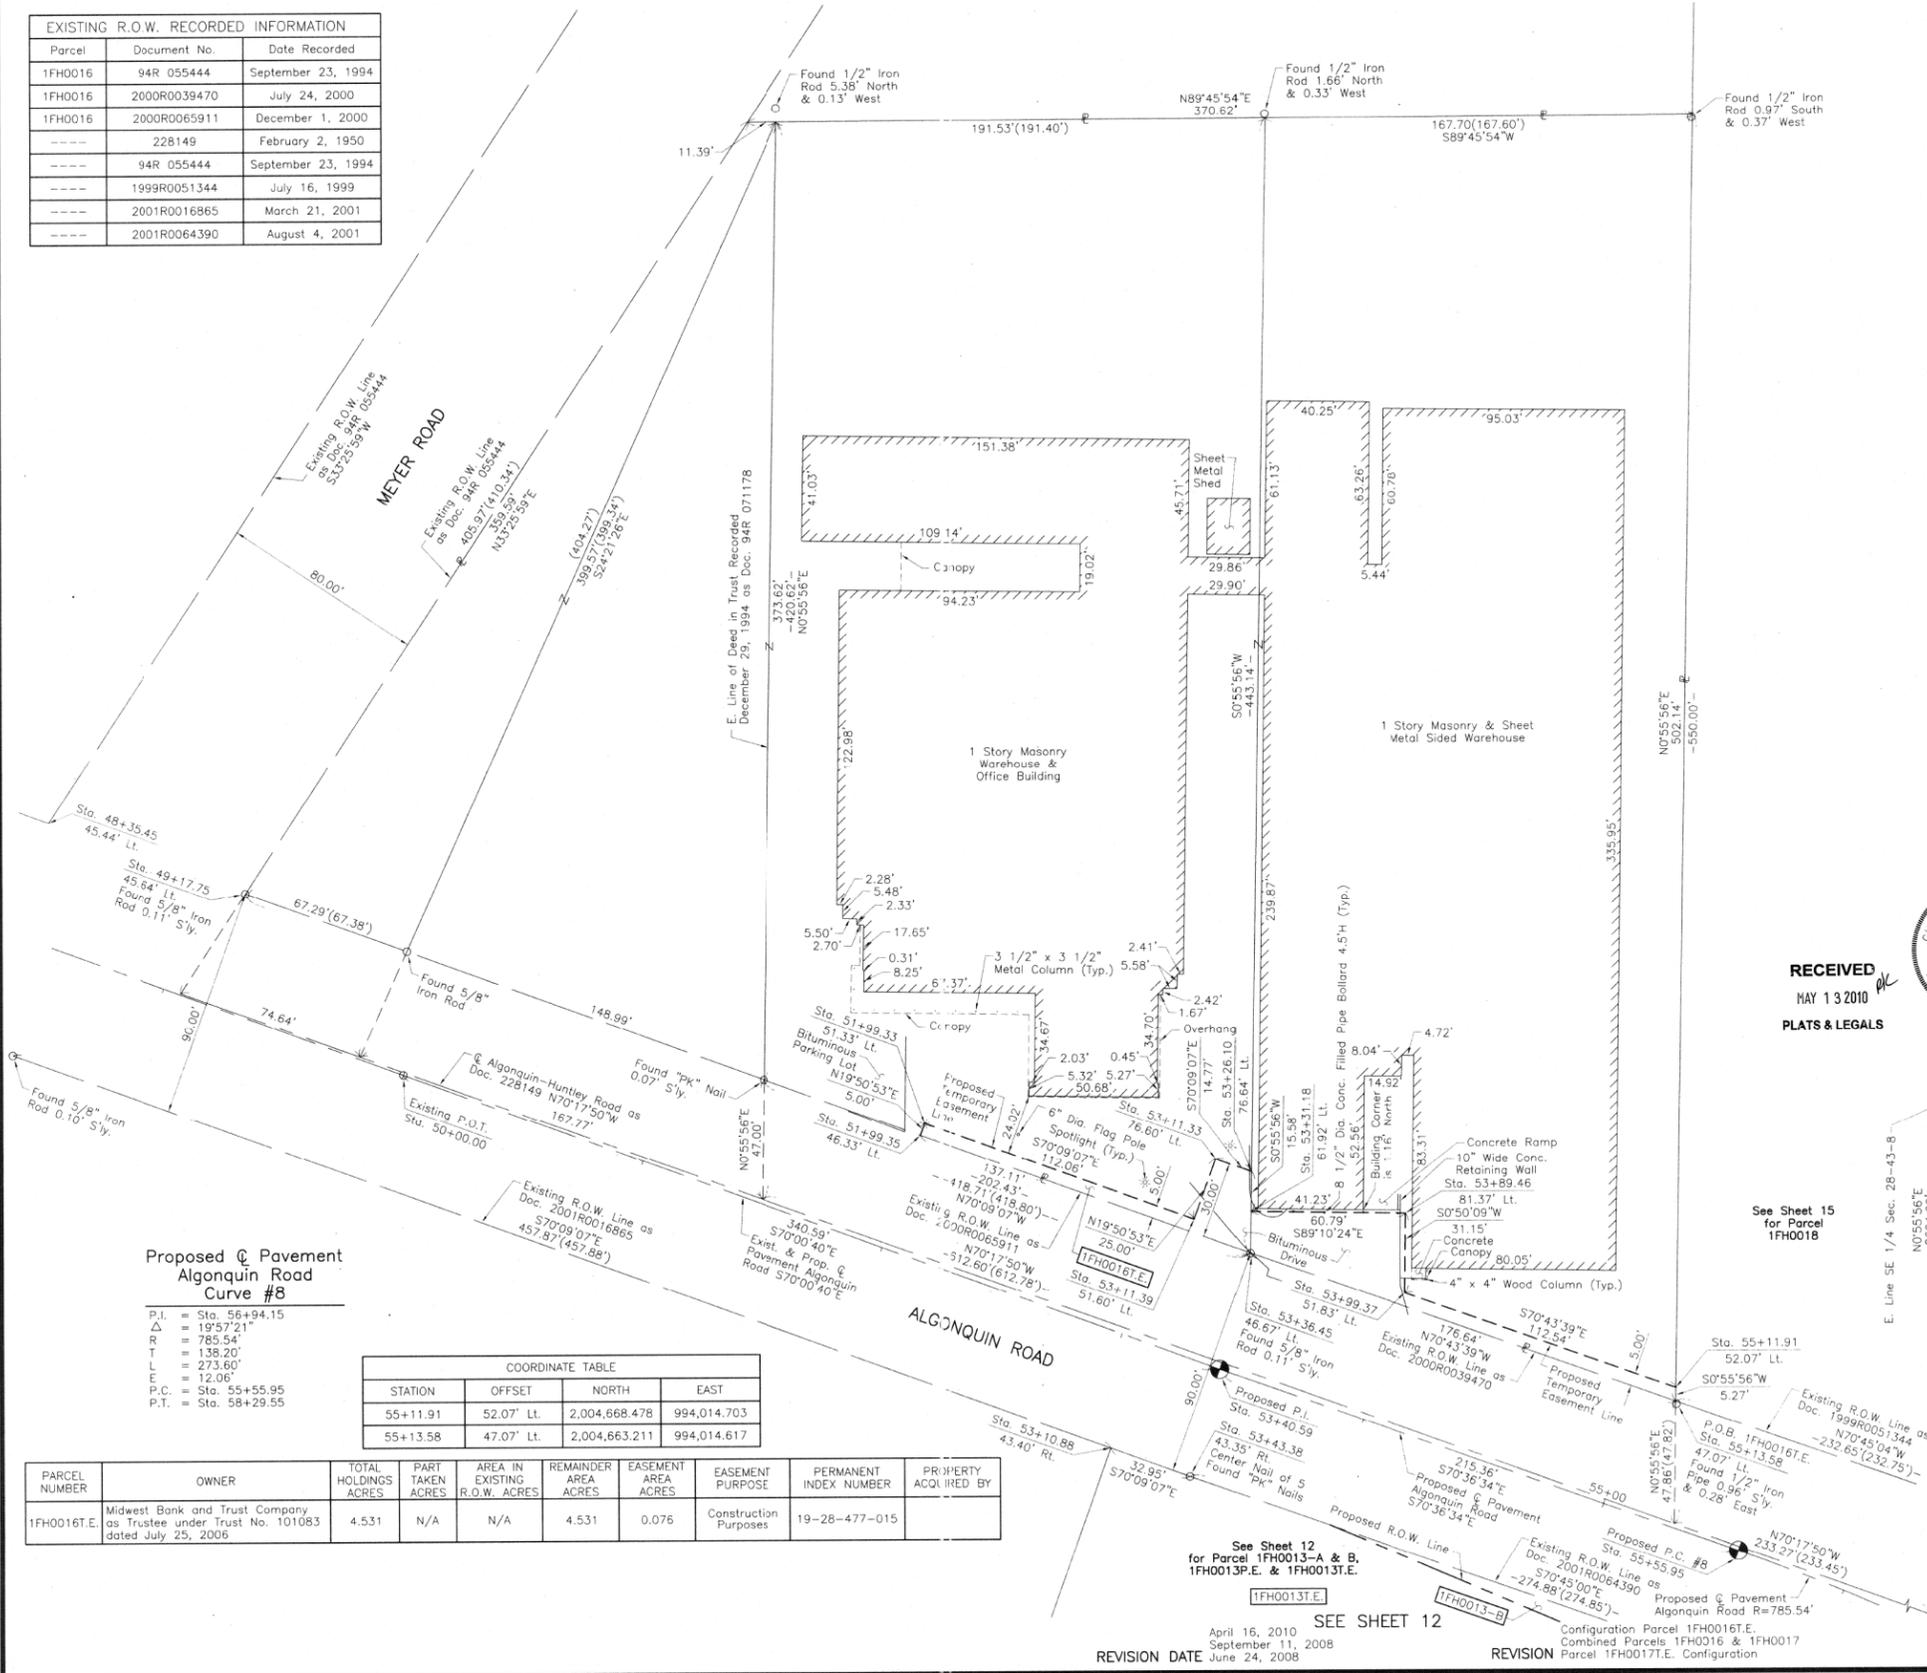

STATE OF ILLINOIS)
COUNTY OF LAKE)SS

THIS IS TO CERTIFY THAT WE, JORGENSEN & ASSOCIATES, INC., AN ILLINOIS PROFESSIONAL DESIGN FIRM LAND SURVEYING CORPORATION, NUMBER 184-2771, LICENSE EXPIRATION DATE: NOVEMBER 30, 2006, HAVE SURVEYED THE PLAT OF HIGHWAYS SHOWN HEREON IN SECTION 28, TOWNSHIP 43N., RANGE 8E., OF THE THIRD PRINCIPAL MERIDIAN, McHENRY COUNTY, THAT THE SURVEY IS TRUE AND COMPLETE AS SHOWN TO THE BEST OF MY KNOWLEDGE AND BELIEF, THAT THE PLAT CORRECTLY REPRESENTS SAID SURVEY, THAT ALL MONUMENTS FOUND AND ESTABLISHED ARE OF PERMANENT QUALITY AND OCCUPY THE POSITIONS SHOWN THEREON AND THAT THE MONUMENTS ARE SUFFICIENT TO ENABLE THE SURVEY TO BE RETRACED. MADE FOR THE DEPARTMENT OF TRANSPORTATION, STATE OF ILLINOIS. DATED AT LAKE VILLA, ILLINOIS THIS 28th DAY OF May 2006 A.D.

CHRISTIAN H. JORGENSEN
2797 PROFESSIONAL LAND SURVEYOR NO. 35-2797
STATE OF ILLINOIS
LAKE VILLA, ILLINOIS

RECEIVED
MAY 13 2010
PLATS & LEGALS

COORDINATE TABLE

STATION	OFFSET	NORTH	EAST
48+35.45	45.44' Lt.	2,004,891.619	993,376.630
49+17.75	45.64' Lt.	2,004,863.675	993,454.043
51+99.33	51.33' Lt.	2,004,772.767	993,720.613
51+99.35	46.33' Lt.	2,004,768.064	993,718.915
53+10.88	43.40' Rt.	2,004,645.617	993,793.059
53+11.33	76.60' Lt.	2,004,758.235	993,834.502
53+11.39	51.60' Lt.	2,004,734.720	993,826.014
53+26.10	76.64' Lt.	2,004,753.222	993,848.392
53+31.18	61.92' Lt.	2,004,737.648	993,848.139
53+36.45	46.67' Lt.	2,004,721.513	993,847.876
53+43.38	43.35' Rt.	2,004,634.429	993,824.051
53+89.46	81.37' Lt.	2,004,736.771	993,908.921
53+99.37	51.83' Lt.	2,004,705.624	993,908.467



ROUTE F.A.P. 336 (ILLINOIS ROUTE 31 BYPASS) SECTION 96-00209-00-PV COUNTY McHENRY JOB NO. R-91-022-03 RECORDING: RECORDED ON AS DOCUMENT NO.

FILE NAME	USER NAME	DESIGNED	REVISED	STATE OF ILLINOIS DEPARTMENT OF TRANSPORTATION	PLAT OF HIGHWAYS	O.R. RTE.	SECTION	COUNTY	TOTAL SHEETS	SHEET NO.
...ND160F72-sht-PH-17.dgn	akw	JORGENSEN & ASSOC.	-	STATE OF ILLINOIS DEPARTMENT OF TRANSPORTATION	PLAT OF HIGHWAYS	0003	18A-2	McHENRY	825	426
		CJ	-							
			-							
			-							

SCALE: GRAPHIC SHEET NO. 17 OF 49 SHEETS STA. TO STA. FED. ROAD DIST. NO. 1 ILLINOIS FED. AID PROJECT CONTRACT NO. 60F72

PART OF THE FRACTIONAL SW 1/4 OF SEC. 27 AND PART OF THE SE 1/4 OF SEC. 28, TWP. 43 N., R. 8 E. OF THE 3RD. P.M., IN McHENRY COUNTY, ILLINOIS.

LEGEND

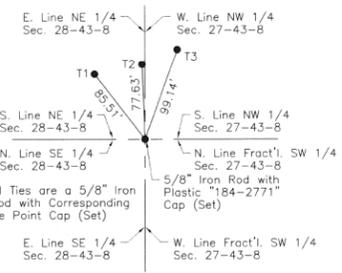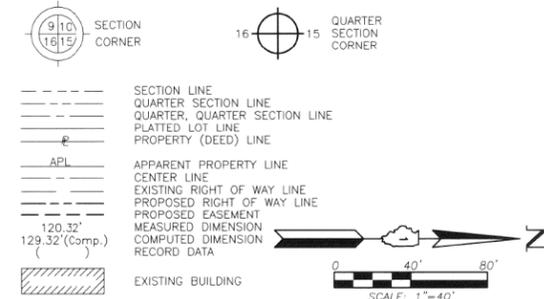


Proposed C Pavement Algonquin Road Curve #8

P.I. = Sta. 56+94.15
 Δ = 19°57'21"
 R = 785.54'
 T = 138.20'
 L = 273.60'
 E = 12.06'
 P.C. = Sta. 55+55.95
 P.T. = Sta. 58+29.55

M-3 "Monument Record"

West 1/4 Corner of Section 27-43-8
 N.2,006,614.879-E.994,267.269
 Recorded May 10, 2005
 Document No. 2005R0036018

STATION	OFFSET	NORTH	EAST
132+92.08	78.36' Lt.	2,004,535.030	994,233.422
132+93.69	78.86' Lt.	2,004,536.716	994,233.450
133+26.10	88.84' Lt.	2,004,570.625	994,234.002
133+41.29	93.51' Lt.	2,004,586.512	994,234.260
133+46.19	126.11' Lt.	2,004,663.211	994,014.617
134+80.57	136.38' Lt.	2,004,732.227	994,236.632

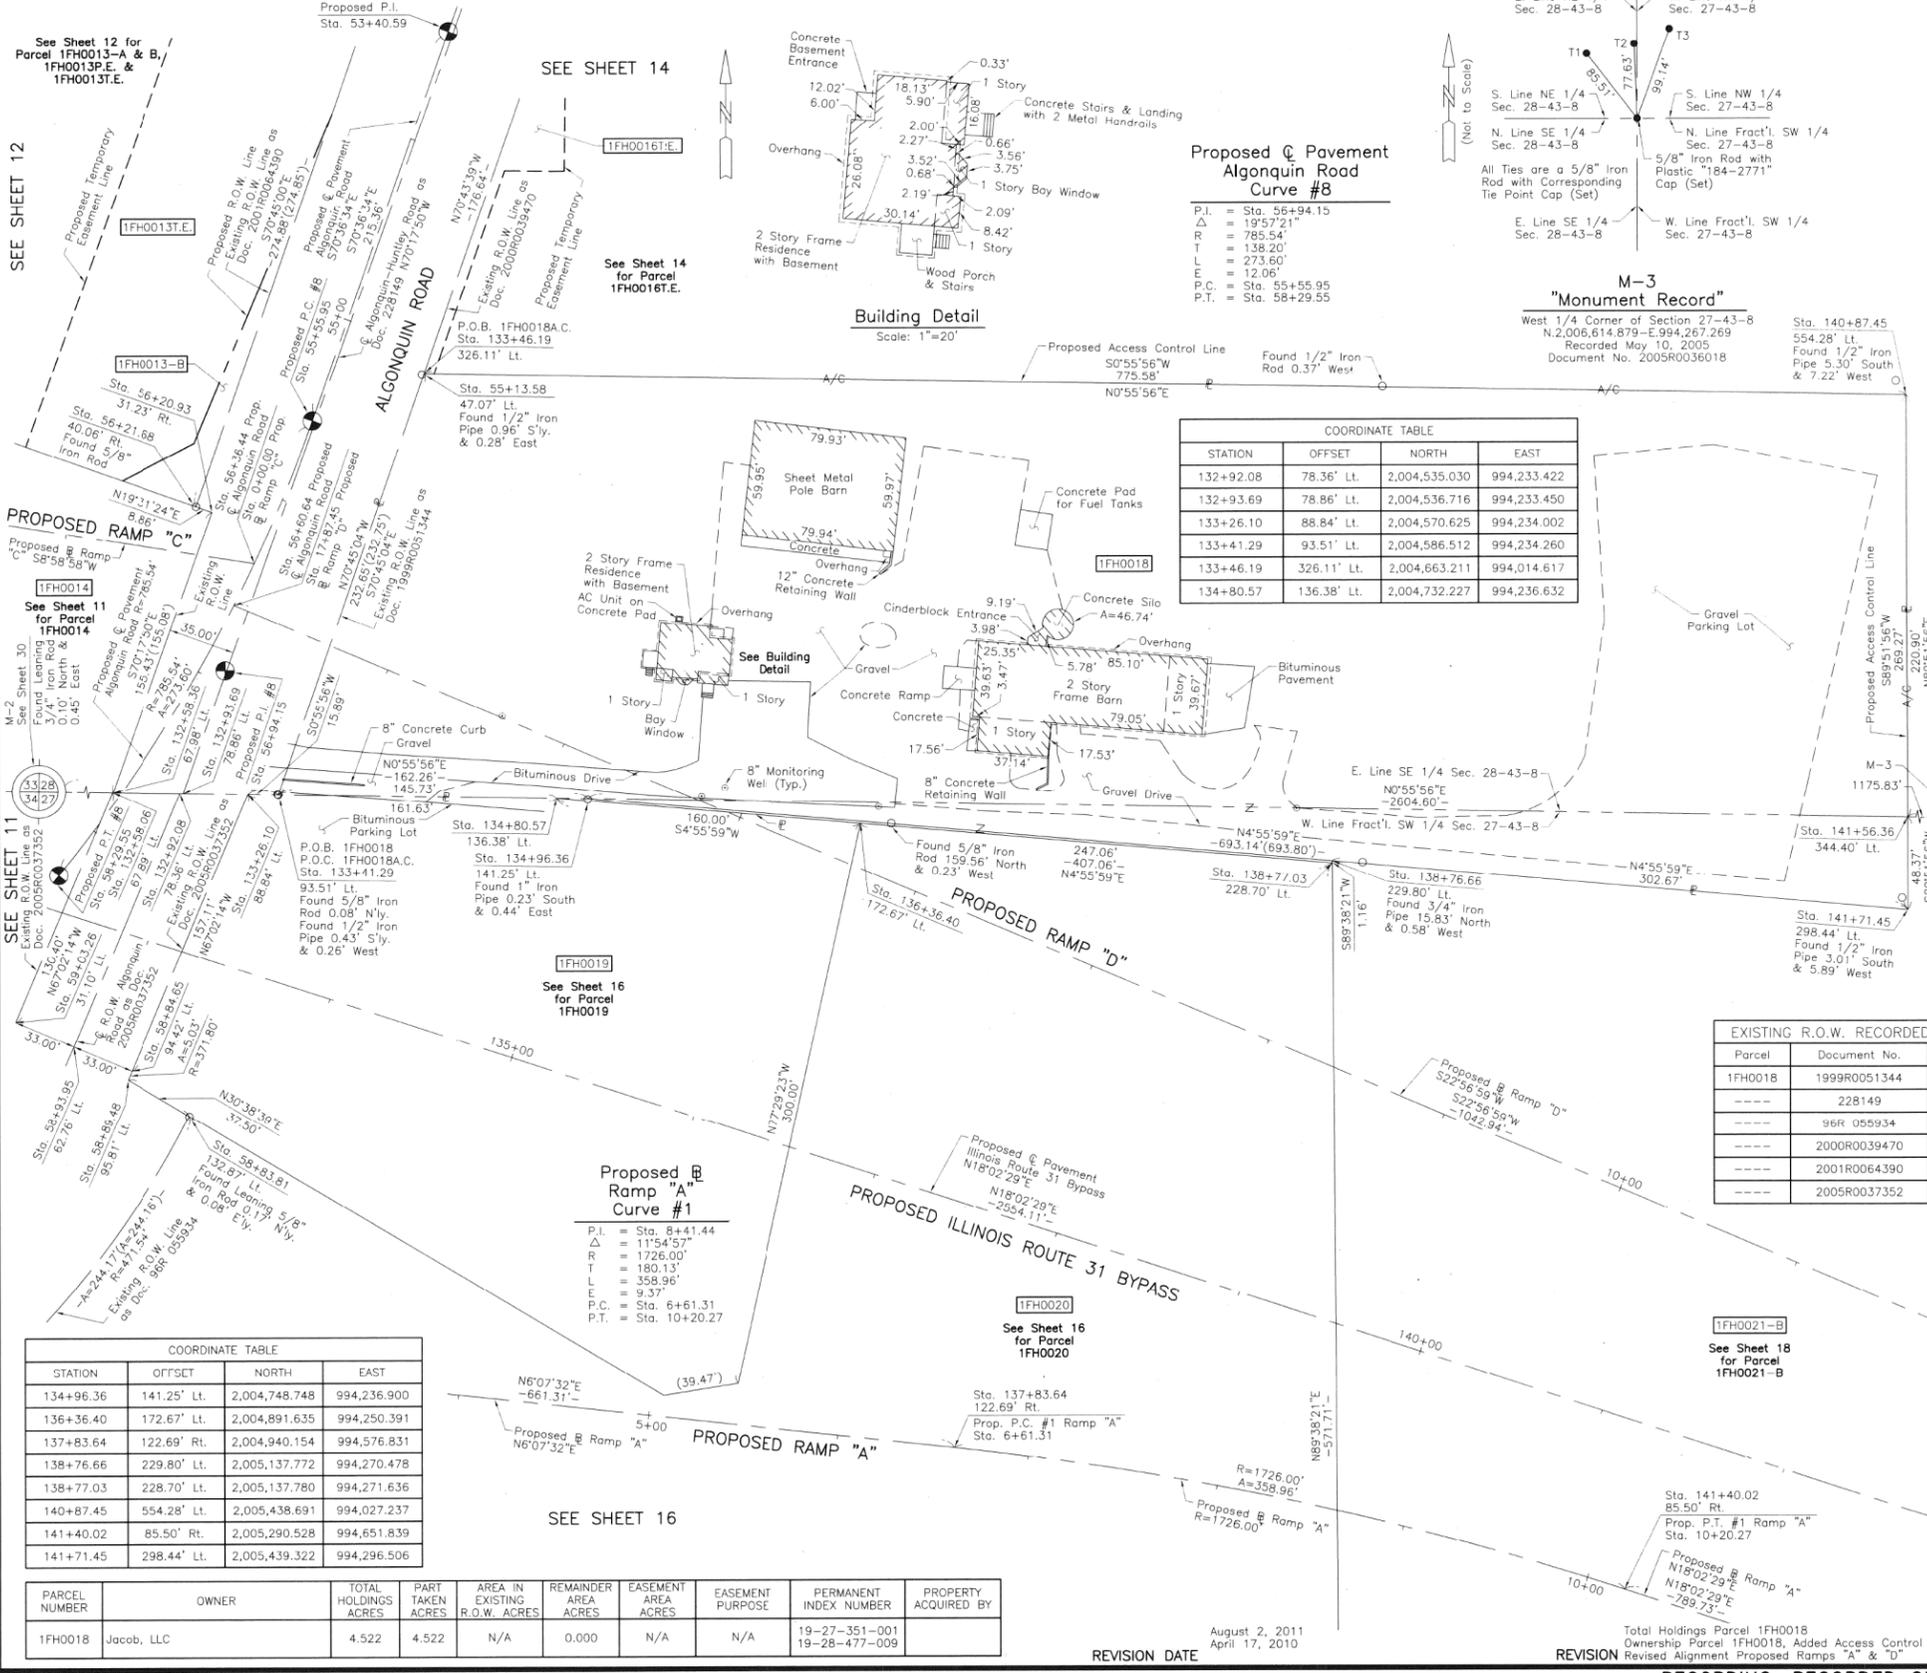

ROW	DATE	BY

STATION	OFFSET	NORTH	EAST
134+96.36	141.25' Lt.	2,004,748.748	994,236.900
136+36.40	172.67' Lt.	2,004,891.635	994,250.391
137+83.64	122.69' Rt.	2,004,940.154	994,576.831
138+76.66	229.80' Lt.	2,005,137.772	994,270.478
138+77.03	228.70' Lt.	2,005,137.780	994,271.636
140+87.45	554.28' Lt.	2,005,438.691	994,027.237
141+40.02	85.50' Rt.	2,005,290.528	994,651.839
141+71.45	298.44' Lt.	2,005,439.322	994,296.506

Proposed B Ramp #1 Curve #1

P.I. = Sta. 8+41.44
 Δ = 11°54'57"
 R = 1726.00'
 T = 180.13'
 L = 358.96'
 E = 9.37'
 P.C. = Sta. 6+61.31
 P.T. = Sta. 10+20.27

PARCEL NUMBER	OWNER	TOTAL HOLDINGS ACRES	PART TAKEN ACRES	AREA IN EXISTING R.O.W. ACRES	REMAINDER AREA ACRES	EASEMENT AREA ACRES	EASEMENT PURPOSE	PERMANENT INDEX NUMBER	PROPERTY ACQUIRED BY
1FH0018	Jacob, LLC	4.522	4.522	N/A	0.000	N/A	N/A	19-27-351-001 19-28-477-009	

Parcel	Document No.	Date Recorded
1FH0018	1999R0051344	July 16, 1999
-----	228149	February 2, 1950
-----	96R 055934	October 31, 1996
-----	2000R0039470	July 24, 2000
-----	2001R0064390	September 4, 2001
-----	2005R0037352	May 16, 2005

STATION	OFFSET	NORTH	EAST
55+13.58	47.07' Lt.	2,004,663.211	994,014.617
56+20.93	31.23' Rt.	2,004,552.155	994,086.521
56+21.68	40.06' Rt.	2,004,543.805	994,083.560
56+36.44	€	2,004,574.181	994,113.380
56+60.64	€	2,004,563.518	994,135.104
58+83.81	132.87' Lt.	2,004,539.596	994,402.392
58+84.65	94.42' Lt.	2,004,509.330	994,378.664
58+89.48	95.81' Lt.	2,004,507.337	994,383.280
58+93.95	62.76' Lt.	2,004,478.945	994,365.790
59+03.26	31.10' Lt.	2,004,448.560	994,352.915
132+58.06	67.89' Lt.	2,004,499.436	994,232.843
132+58.36	67.98' Lt.	2,004,499.755	994,232.848

RECEIVED
 MAR 2 12 2012
 PLATS & LEGALS

SEE SHEET 18

JORGENSEN & ASSOCIATES, INC.
 120 PARK AVENUE
 LAKE VILLA, ILLINOIS 60046
 (847) 336-3371

PLAT OF HIGHWAYS
 STATE OF ILLINOIS
 DEPARTMENT OF TRANSPORTATION
 F.A.P. 336 (ILLINOIS ROUTE 31 BYPASS)
 SECTION 96-00209-00-PV McHENRY COUNTY
 PROJECT JOB NO. R-91-022-03
 STATION 53+40.59 TO STATION 59+00
 STATION 132+00 TO STATION 143+00
 SCALE: 1"=40' SHEET 15 OF 37

BUREAU OF LAND ACQUISITION
 201 WEST CENTER COURT
 SCHAUMBURG, ILLINOIS 60196

REVISION DATE August 2, 2011
 April 17, 2010

REVISION Total Holdings Parcel 1FH0018
 Ownership Parcel 1FH0018, Added Access Control Lines,
 Revised Alignment Proposed Ramps "A" & "D"

MADE BY

ROUTE F.A.P. 336 (ILLINOIS ROUTE 31 BYPASS)

SECTION 96-00209-00-PV

COUNTY McHENRY

JOB NO. R-91-022-03

RECORDING: RECORDED ON

AS DOCUMENT NO.

FILE NAME = ...\\D160F72-sht-PH-18.dgn


USER NAME	DESIGNED	REVISED
akw	-	-
JORGENSEN & ASSOC.	-	-
CJ	-	-

STATE OF ILLINOIS
 DEPARTMENT OF TRANSPORTATION

PLAT OF HIGHWAYS

SCALE: GRAPHIC SHEET NO. 18 OF 49 SHEETS STA. TO STA.

O.R. RTE.	SECTION	COUNTY	TOTAL SHEETS	SHEET NO.
0003	18A-2	McHENRY	825	427
CONTRACT NO. 60F72				
FED. ROAD DIST. NO. 1 ILLINOIS FED. AID PROJECT				

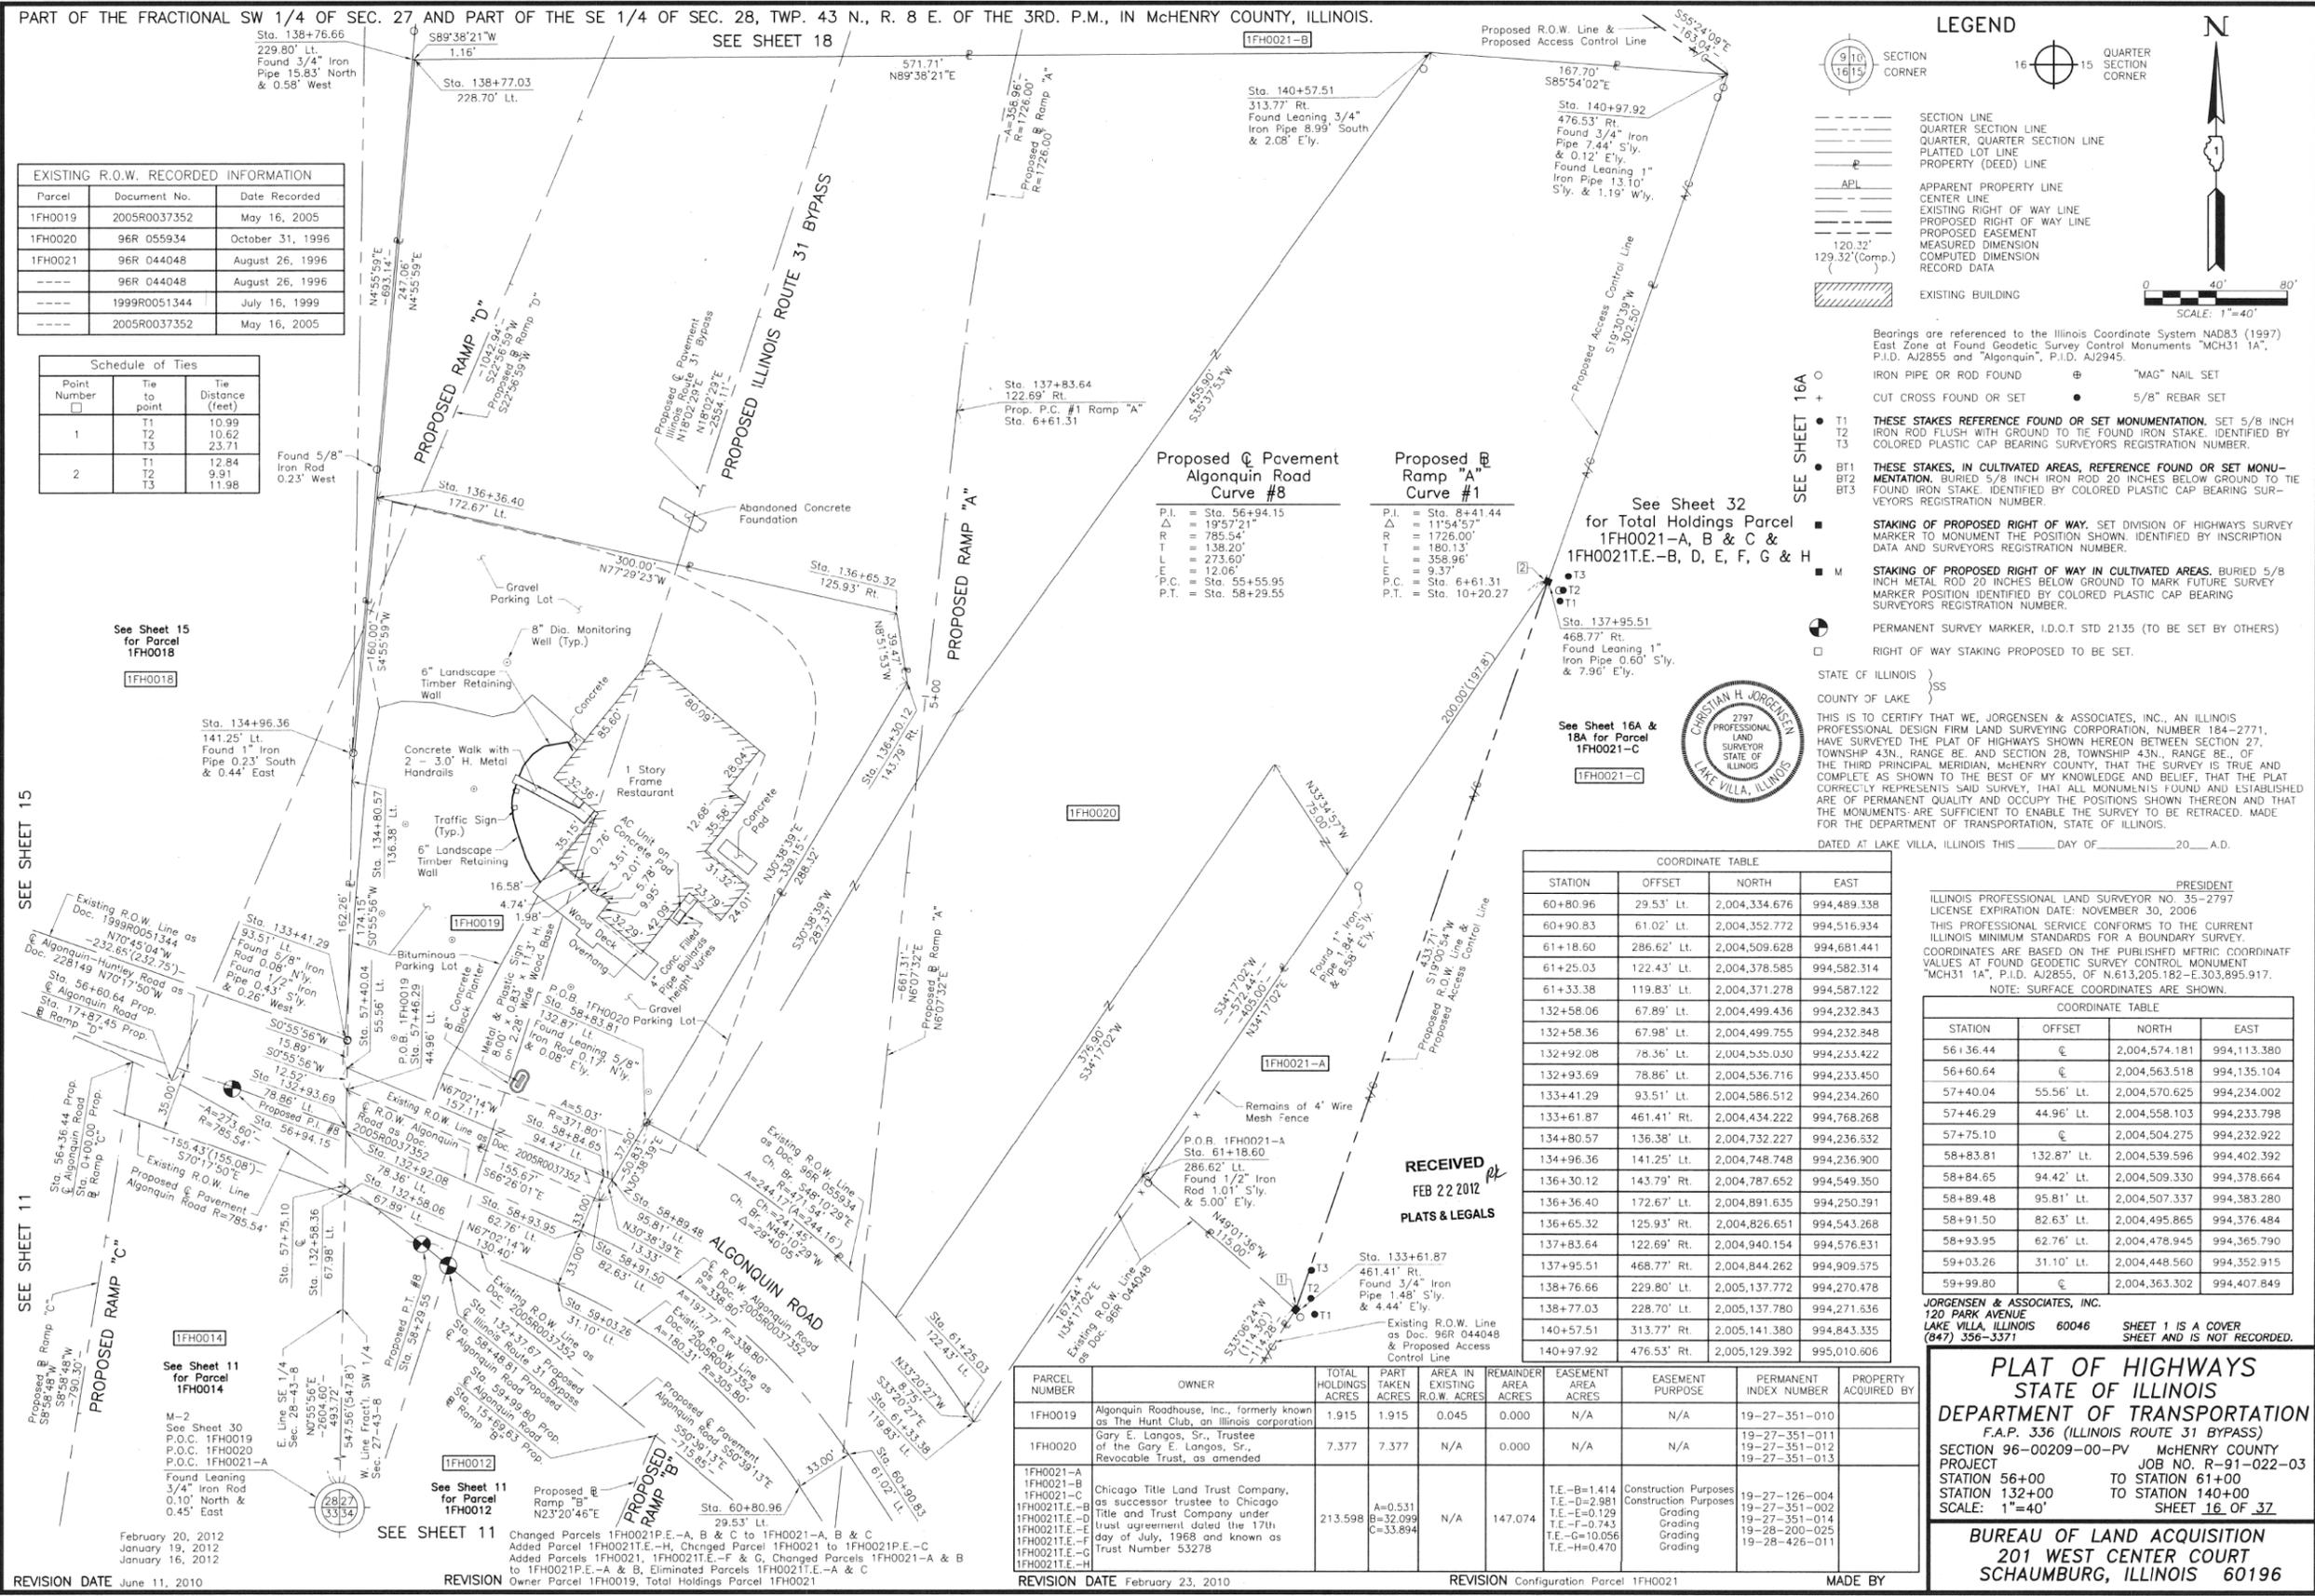

EXISTING R.O.W. RECORDED INFORMATION

Parcel	Document No.	Date Recorded
1FH0019	2005R0037352	May 16, 2005
1FH0020	96R 055934	October 31, 1996
1FH0021	96R 044048	August 26, 1996
----	96R 044048	August 26, 1996
----	1999R0051344	July 16, 1999
----	2005R0037352	May 16, 2005

Schedule of Ties

Point Number	Tie to	Tie Distance (feet)
1	T1	10.99
	T2	10.62
	T3	23.71
2	T1	12.84
	T2	9.91
	T3	11.98

See Sheet 15 for Parcel 1FH0018

SEE SHEET 15

SEE SHEET 11

February 20, 2012
January 19, 2012
January 16, 2012

SEE SHEET 11 for Parcel 1FH0012

REVISION DATE June 11, 2010

COORDINATE TABLE

STATION	OFFSET	NORTH	EAST
60+80.96	29.53' Lt.	2,004,334.676	994,489.338
60+90.83	61.02' Lt.	2,004,352.772	994,516.334
61+18.60	286.62' Lt.	2,004,509.628	994,681.441
61+25.03	122.43' Lt.	2,004,378.585	994,582.314
61+33.38	119.83' Lt.	2,004,371.278	994,587.122
132+58.06	67.89' Lt.	2,004,499.436	994,232.343
132+58.36	67.98' Lt.	2,004,499.755	994,232.348
132+92.08	78.36' Lt.	2,004,535.030	994,233.422
132+93.69	78.86' Lt.	2,004,536.716	994,233.450
133+41.29	93.51' Lt.	2,004,586.512	994,234.260
133+61.87	461.41' Rt.	2,004,434.222	994,768.268
134+80.57	136.38' Lt.	2,004,732.227	994,236.532
134+96.36	141.25' Lt.	2,004,748.748	994,236.900
136+30.12	143.79' Rt.	2,004,787.652	994,549.350
136+36.40	172.67' Lt.	2,004,891.635	994,250.391
136+65.32	125.93' Rt.	2,004,826.651	994,543.268
137+83.64	122.69' Rt.	2,004,940.154	994,576.531
137+95.51	468.77' Rt.	2,004,844.262	994,909.575
138+76.66	229.80' Lt.	2,005,137.772	994,270.478
138+77.03	228.70' Lt.	2,005,137.780	994,271.636
140+57.51	313.77' Rt.	2,005,141.380	994,843.335
140+97.92	476.53' Rt.	2,005,129.392	995,010.606

COORDINATE TABLE

STATION	OFFSET	NORTH	EAST
56+36.44	€	2,004,574.181	994,113.380
56+60.64	€	2,004,563.518	994,135.104
57+40.04	55.56' Lt.	2,004,570.625	994,234.002
57+46.29	44.96' Lt.	2,004,558.103	994,233.798
57+75.10	€	2,004,504.275	994,232.922
58+83.81	132.87' Lt.	2,004,539.596	994,402.392
58+84.65	94.42' Lt.	2,004,509.330	994,378.664
58+89.48	95.81' Lt.	2,004,507.337	994,383.280
58+91.50	82.63' Lt.	2,004,495.865	994,376.484
58+93.95	62.76' Lt.	2,004,478.945	994,365.790
59+03.26	31.10' Lt.	2,004,448.560	994,352.915
59+99.80	€	2,004,363.302	994,407.849

PARCEL NUMBER	OWNER	TOTAL HOLDINGS ACRES	PART TAKEN ACRES	AREA IN EXISTING R.O.W. ACRES	REMAINDER AREA ACRES	EASEMENT AREA ACRES	EASEMENT PURPOSE	PERMANENT INDEX NUMBER	PROPERTY ACQUIRED BY
1FH0019	Algonquin Roadhouse, Inc., formerly known as The Hunt Club, an Illinois corporation	1.915	1.915	0.045	0.000	N/A	N/A	19-27-351-010	
1FH0020	Gary E. Longos, Sr., Trustee of the Gary E. Longos, Sr., Revocable Trust, as amended	7.377	7.377	N/A	0.000	N/A	N/A	19-27-351-011 19-27-351-012 19-27-351-013	
1FH0021-A	Chicago Title Land Trust Company, as successor trustee to Chicago Title and Trust Company under trust agreement dated the 17th day of July, 1968 and known as Trust Number 53278	213.598	A=0.531 B=32.099 C=33.894	N/A	147.074	T.E.-B=1.414	Construction Purposes	19-27-126-004	
1FH0021-B						T.E.-D=2.981	Construction Purposes	19-27-351-002	
1FH0021-C						T.E.-E=0.129	Grading	19-27-351-014	
1FH0021-E						T.E.-F=0.743	Grading	19-28-200-025	
1FH0021-G						T.E.-G=10.056	Grading	19-28-426-011	


PLAT OF HIGHWAYS
STATE OF ILLINOIS
DEPARTMENT OF TRANSPORTATION
F.A.P. 336 (ILLINOIS ROUTE 31 BYPASS)
SECTION 96-00209-00-PV McHENRY COUNTY
PROJECT JOB NO. R-91-022-03
STATION 56+00 TO STATION 61+00
STATION 132+00 TO STATION 140+00
SCALE: 1"=40'
SHEET 16 OF 32

BUREAU OF LAND ACQUISITION
201 WEST CENTER COURT
SCHAUMBURG, ILLINOIS 60196

ROUTE F.A.P. 336 (ILLINOIS ROUTE 31 BYPASS) SECTION 96-00209-00-PV COUNTY McHENRY JOB NO. R-91-022-03 RECORDING: RECORDED ON AS DOCUMENT NO.

FILE NAME = ...\\D160F72-sht-19-11.dgn	USER NAME = akw	DESIGNED -	REVISED -	STATE OF ILLINOIS DEPARTMENT OF TRANSPORTATION	PLAT OF HIGHWAYS	SCALE: GRAPHIC SHEET NO. 19 OF 49 SHEETS STA. TO STA.	O.R. RTE.	SECTION	COUNTY	TOTAL SHEETS	SHEET NO.
		DRAWN - JORGENSEN & ASSOC.	REVISED -				0003	18A-2	MCHENRY	825	428
		CHECKED - CJ	REVISED -				CONTRACT NO. 60F72			FED. ROAD DIST. NO. 1 ILLINOIS FED. AID PROJECT	
		PLOT SCALE = 70.0000' / in.	REVISED -								
		PLOT DATE = 5/2/2012	REVISED -								

PART OF THE FRACTIONAL SW 1/4 OF SEC. 27, TWP. 43 N., R. 8 E. OF THE 3RD. P.M., IN McHENRY COUNTY, ILLINOIS.

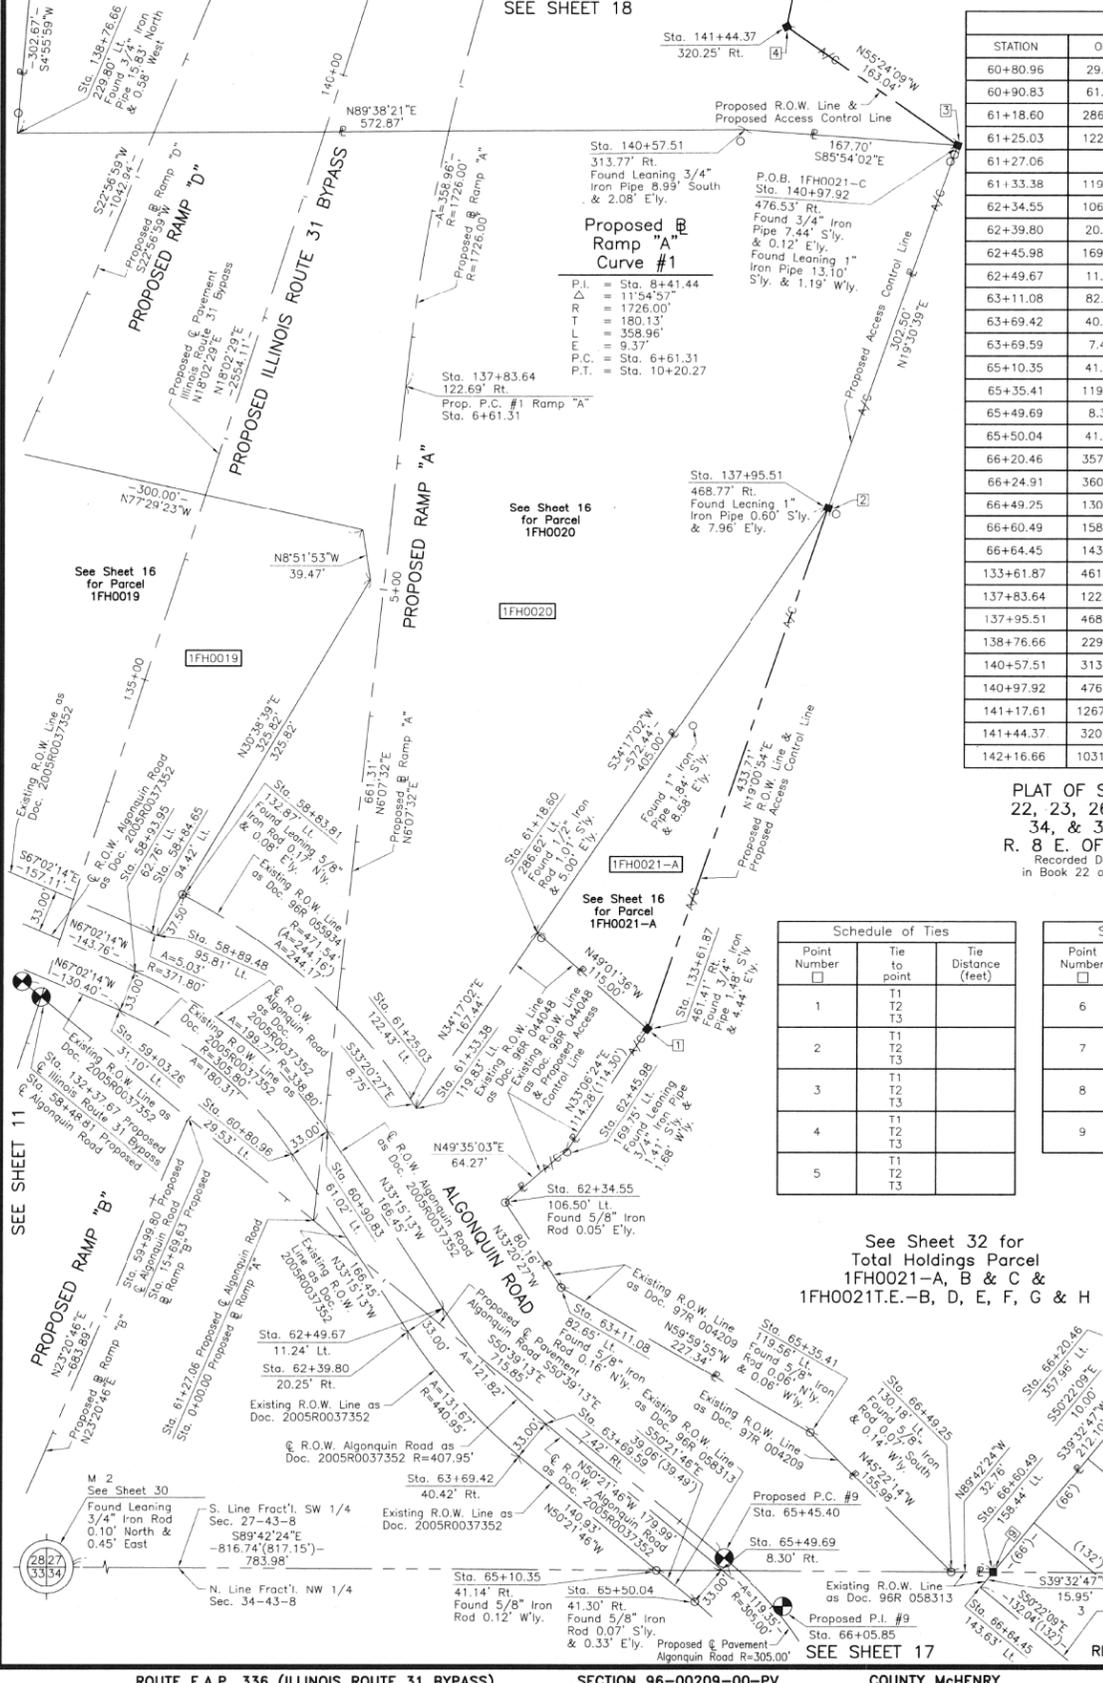

COORDINATE TABLE

STATION	OFFSET	NORTH	EAST
60+80.96	29.53' Lt.	2,004,334.676	994,489.338
60+90.83	61.02' Lt.	2,004,352.772	994,516.934
61+18.60	286.62' Lt.	2,004,509.628	994,681.441
61+25.03	122.43' Lt.	2,004,378.585	994,582.314
61+27.06	0	2,004,282.617	994,506.264
61+33.38	119.83' Lt.	2,004,371.278	994,587.122
62+34.55	106.50' Lt.	2,004,296.826	994,656.916
62+39.80	20.25' Rt.	2,004,195.481	994,580.611
62+45.98	169.75' Lt.	2,004,338.494	994,705.848
62+49.67	11.24' Lt.	2,004,213.576	994,608.207
63+11.08	82.65' Lt.	2,004,229.860	994,700.973
63+69.42	40.42' Rt.	2,004,097.699	994,668.063
63+69.59	7.42' Rt.	2,004,123.112	994,689.115
65+10.35	41.14' Rt.	2,004,007.795	994,776.595
65+35.41	119.56' Lt.	2,004,116.184	994,897.852
65+49.69	8.30' Rt.	2,004,008.293	994,827.723
65+50.04	41.30' Rt.	2,003,982.880	994,806.672
66+20.46	357.96' Lt.	2,004,176.369	995,168.957
66+24.91	360.42' Lt.	2,004,169.990	995,176.659
66+49.25	130.18' Lt.	2,004,006.606	995,008.858
66+60.49	158.44' Lt.	2,004,006.438	995,041.614
66+64.45	143.63' Lt.	2,003,994.135	995,031.456
133+61.87	461.41' Rt.	2,004,434.222	994,768.268
137+83.64	122.69' Rt.	2,004,940.154	994,576.831
137+95.51	468.77' Rt.	2,004,844.262	994,909.575
138+76.66	229.80' Lt.	2,005,137.772	994,270.478
140+57.51	313.77' Rt.	2,005,141.380	994,843.335
140+97.92	476.53' Rt.	2,005,129.392	995,010.606
141+17.61	1267.73' Rt.	2,004,903.082	995,769.001
141+44.37	320.25' Rt.	2,005,221.965	994,876.401
142+16.66	1031.76' Rt.	2,005,070.339	995,575.308

PLAT OF SECTIONS NOS. 22, 23, 26, 27, 28, 33, 34, & 35, T. 43 N., R. 8 E. OF THE 3RD. P.M. Recorded December 6, 1859 in Book 22 of Deeds, Page 520

Schedule of Ties

Point Number	Tie to point	Tie Distance (feet)
1	T1	T2
2	T1	T2
3	T1	T2
4	T1	T2
5	T1	T2

Schedule of Ties

Point Number	Tie to point	Tie Distance (feet)
6	T1	T2
7	T1	T2
8	T1	T2
9	T1	T2

See Sheet 32 for Total Holdings Parcel 1FH0021-A, B & C & 1FH0021E.-B, D, E, F, G & H

SEE SHEET 18A

SCENIC VIEW SUBDIVISION
Recorded May 24, 1977 as Document No. 695627
Corrected by Affidavits Recorded January 31, 1978 as Document No. 721996, Recorded February 1, 1978 as Document No. 722184 & Recorded April 6, 1983 as Document No. 852218
Sta. 142+16.66
1031.76' Rt.
Found 1/2" Iron Pipe

EXISTING R.O.W. RECORDED INFORMATION

Parcel	Document No.	Date Recorded
1FH0021	96R 044048	August 26, 1996
1FH0021	96R 058313	November 14, 1996
1FH0021	97R 004209	January 28, 1997
---	Book G of Deeds, Page 294	December 15, 1846
---	75292	October 9, 1926
---	96R 044048	August 26, 1996
---	96R 055934	October 31, 1996
---	96R 058313	November 14, 1996
---	96R 061883	December 6, 1996
---	2005R0037352	May 16, 2005

PARCEL NUMBER	OWNER	TOTAL HOLDINGS ACRES	PART TAKEN ACRES	AREA IN EXISTING R.O.W. ACRES	REMAINDER AREA ACRES	EASEMENT AREA ACRES	EASEMENT PURPOSE	PERMANENT INDEX NUMBER	PROPERTY ACQUIRED BY
1FH0021-A	Chicago Title Land Trust Company, as successor trustee to Chicago Title and Trust Company under trust agreement dated the 17th day of July, 1968 and known as Trust Number 53278	213.598	A=0.531 B=32.099 C=33.894	N/A	147.074	T.E.-B=1.414 T.E.-D=2.981 T.E.-E=0.129 T.E.-F=0.743 T.E.-G=10.056 T.E.-H=0.470	Construction Purposes Construction Purposes Grading Grading Grading	19-27-126-004 19-27-351-002 19-27-351-014 19-28-200-025 19-28-426-011	

Proposed Pavement Algonquin Road Curve #9
P.I. = Sta. 66+05.85
Δ = 22°25'15"
R = 305.00'
T = 60.45'
L = 119.35'
E = 5.93'
P.C. = Sta. 65+45.40
P.T. = Sta. 66+64.75

RECEIVED FEB 22 2012 PLATS & LEGALS
REVISION Changed Parcels 1FH0021E.-A, B & C to 1FH0021-A, B & C
REVISION Added Parcel 1FH0021E.-H, Changed Parcel 1FH0021 to 1FH0021E.-C MADE BY

LEGEND

- SECTION LINE
- QUARTER SECTION LINE
- QUARTER, QUARTER SECTION LINE
- PLATTED LOT LINE
- PROPERTY (DEED) LINE
- APL
- APPARENT PROPERTY LINE
- CENTER LINE
- EXISTING RIGHT OF WAY LINE
- PROPOSED EASEMENT
- MEASURED DIMENSION
- COMPUTED DIMENSION
- RECORD DATA
- EXISTING BUILDING

BEARINGS are referenced to the Illinois Coordinate System NAD83 (1997) East Zone at Found Geodetic Survey Control Monuments "MCH31 1A", P.I.D. AJ2855 and "Algonquin", P.I.D. AJ2945.

IRON PIPE OR ROD FOUND

CUT CROSS FOUND OR SET

THESE STAKES REFERENCE FOUND OR SET MONUMENTATION. SET 5/8 INCH IRON ROD FLUSH WITH GROUND TO THE FOUND IRON STAKE. IDENTIFIED BY COLORED PLASTIC CAP BEARING SURVEYORS REGISTRATION NUMBER.

THESE STAKES, IN CULTIVATED AREAS, REFERENCE FOUND OR SET MONUMENTATION. BURIED 5/8 INCH IRON ROD 20 INCHES BELOW GROUND TO THE FOUND IRON STAKE. IDENTIFIED BY COLORED PLASTIC CAP BEARING SURVEYORS REGISTRATION NUMBER.

STAKING OF PROPOSED RIGHT OF WAY. SET DIVISION OF HIGHWAYS SURVEY MARKER TO MONUMENT THE POSITION SHOWN. IDENTIFIED BY INSCRIPTION DATA AND SURVEYORS REGISTRATION NUMBER.

STAKING OF PROPOSED RIGHT OF WAY IN CULTIVATED AREAS. BURIED 5/8 INCH METAL ROD 20 INCHES BELOW GROUND TO MARK FUTURE SURVEY MARKER POSITION IDENTIFIED BY COLORED PLASTIC CAP BEARING SURVEYORS REGISTRATION NUMBER.

PERMANENT SURVEY MARKER, I.D.O. STD 2135 (TO BE SET BY OTHERS)

RIGHT OF WAY STAKING PROPOSED TO BE SET.

STATE OF ILLINOIS }
COUNTY OF LAKE }

THIS IS TO CERTIFY THAT WE, JORGENSEN & ASSOCIATES, INC., AN ILLINOIS PROFESSIONAL DESIGN FIRM LAND SURVEYING CORPORATION, NUMBER 184-2771, HAVE SURVEYED THE PLAT OF HIGHWAYS SHOWN HEREON IN SECTION 27, TOWNSHIP 43N., RANGE 8E., OF THE THIRD PRINCIPAL MERIDIAN, McHENRY COUNTY, THAT THE SURVEY IS TRUE AND COMPLETE AS SHOWN TO THE BEST OF MY KNOWLEDGE AND BELIEF, THAT THE PLAT CORRECTLY REPRESENTS SAID SURVEY, THAT ALL MONUMENTS FOUND AND ESTABLISHED ARE OF PERMANENT QUALITY AND OCCUPY THE POSITIONS SHOWN THEREON AND THAT THE MONUMENTS ARE SUFFICIENT TO ENABLE THE SURVEY TO BE RETRACED. MADE FOR THE DEPARTMENT OF TRANSPORTATION, STATE OF ILLINOIS. DATED AT LAKE VILLA, ILLINOIS THIS _____ DAY OF _____ 20____ A.D.

CHRISTIAN H. JORGENSEN
2797 PROFESSIONAL LAND SURVEYOR
STATE OF ILLINOIS
LAKE VILLA, ILLINOIS


ILLINOIS PROFESSIONAL LAND SURVEYOR NO. 35-2797
LICENSE EXPIRATION DATE: NOVEMBER 30, 2012
THIS PROFESSIONAL SERVICE CONFORMS TO THE CURRENT ILLINOIS MINIMUM STANDARDS FOR A BOUNDARY SURVEY.
COORDINATES ARE BASED ON THE PUBLISHED METRIC COORDINATE VALUES AT FOUND GEODETIC SURVEY CONTROL MONUMENT "MCH31 1A", P.I.D. AJ2855, OF N.613,205.182-E.303,895.917.
NOTE: SURFACE COORDINATES ARE SHOWN.

PLAT OF HIGHWAYS
STATE OF ILLINOIS
DEPARTMENT OF TRANSPORTATION
F.A.P. 336 (ILLINOIS ROUTE 31 BYPASS)
SECTION 96-00209-00-PV McHENRY COUNTY PROJECT JOB NO. R-91-022-03
STATION 58+00 TO STATION 67+00
STATION 132+00 TO STATION 142+00
SCALE: 1"=60'
SHEET 16A OF 37

BUREAU OF LAND ACQUISITION
201 WEST CENTER COURT
SCHAUMBURG, ILLINOIS 60196

ROUTE F.A.P. 336 (ILLINOIS ROUTE 31 BYPASS) SECTION 96-00209-00-PV COUNTY McHENRY JOB NO. R-91-022-03 RECORDING: RECORDED ON AS DOCUMENT NO.

FILE NAME = ...\\D160F72-sht-Plat-20.dgn	USER NAME = akw	DESIGNED -	REVISED -	STATE OF ILLINOIS DEPARTMENT OF TRANSPORTATION	PLAT OF HIGHWAYS	O.R. RTE.	SECTION	COUNTY	TOTAL SHEETS	SHEET NO.
		DRAWN - JORGENSEN & ASSOC.	REVISED -			0003	18A-2	McHENRY	825	429
		CHECKED - CJ	REVISED -			SCALE: GRAPHIC		SHEET NO. 20 OF 49 SHEETS		STATION TO STATION
		DATE -	REVISED -			REVISION		REVISION		FED. ROAD DIST. NO. 1 ILLINOIS FED. AID PROJECT
						CONTRACT NO. 60F72				

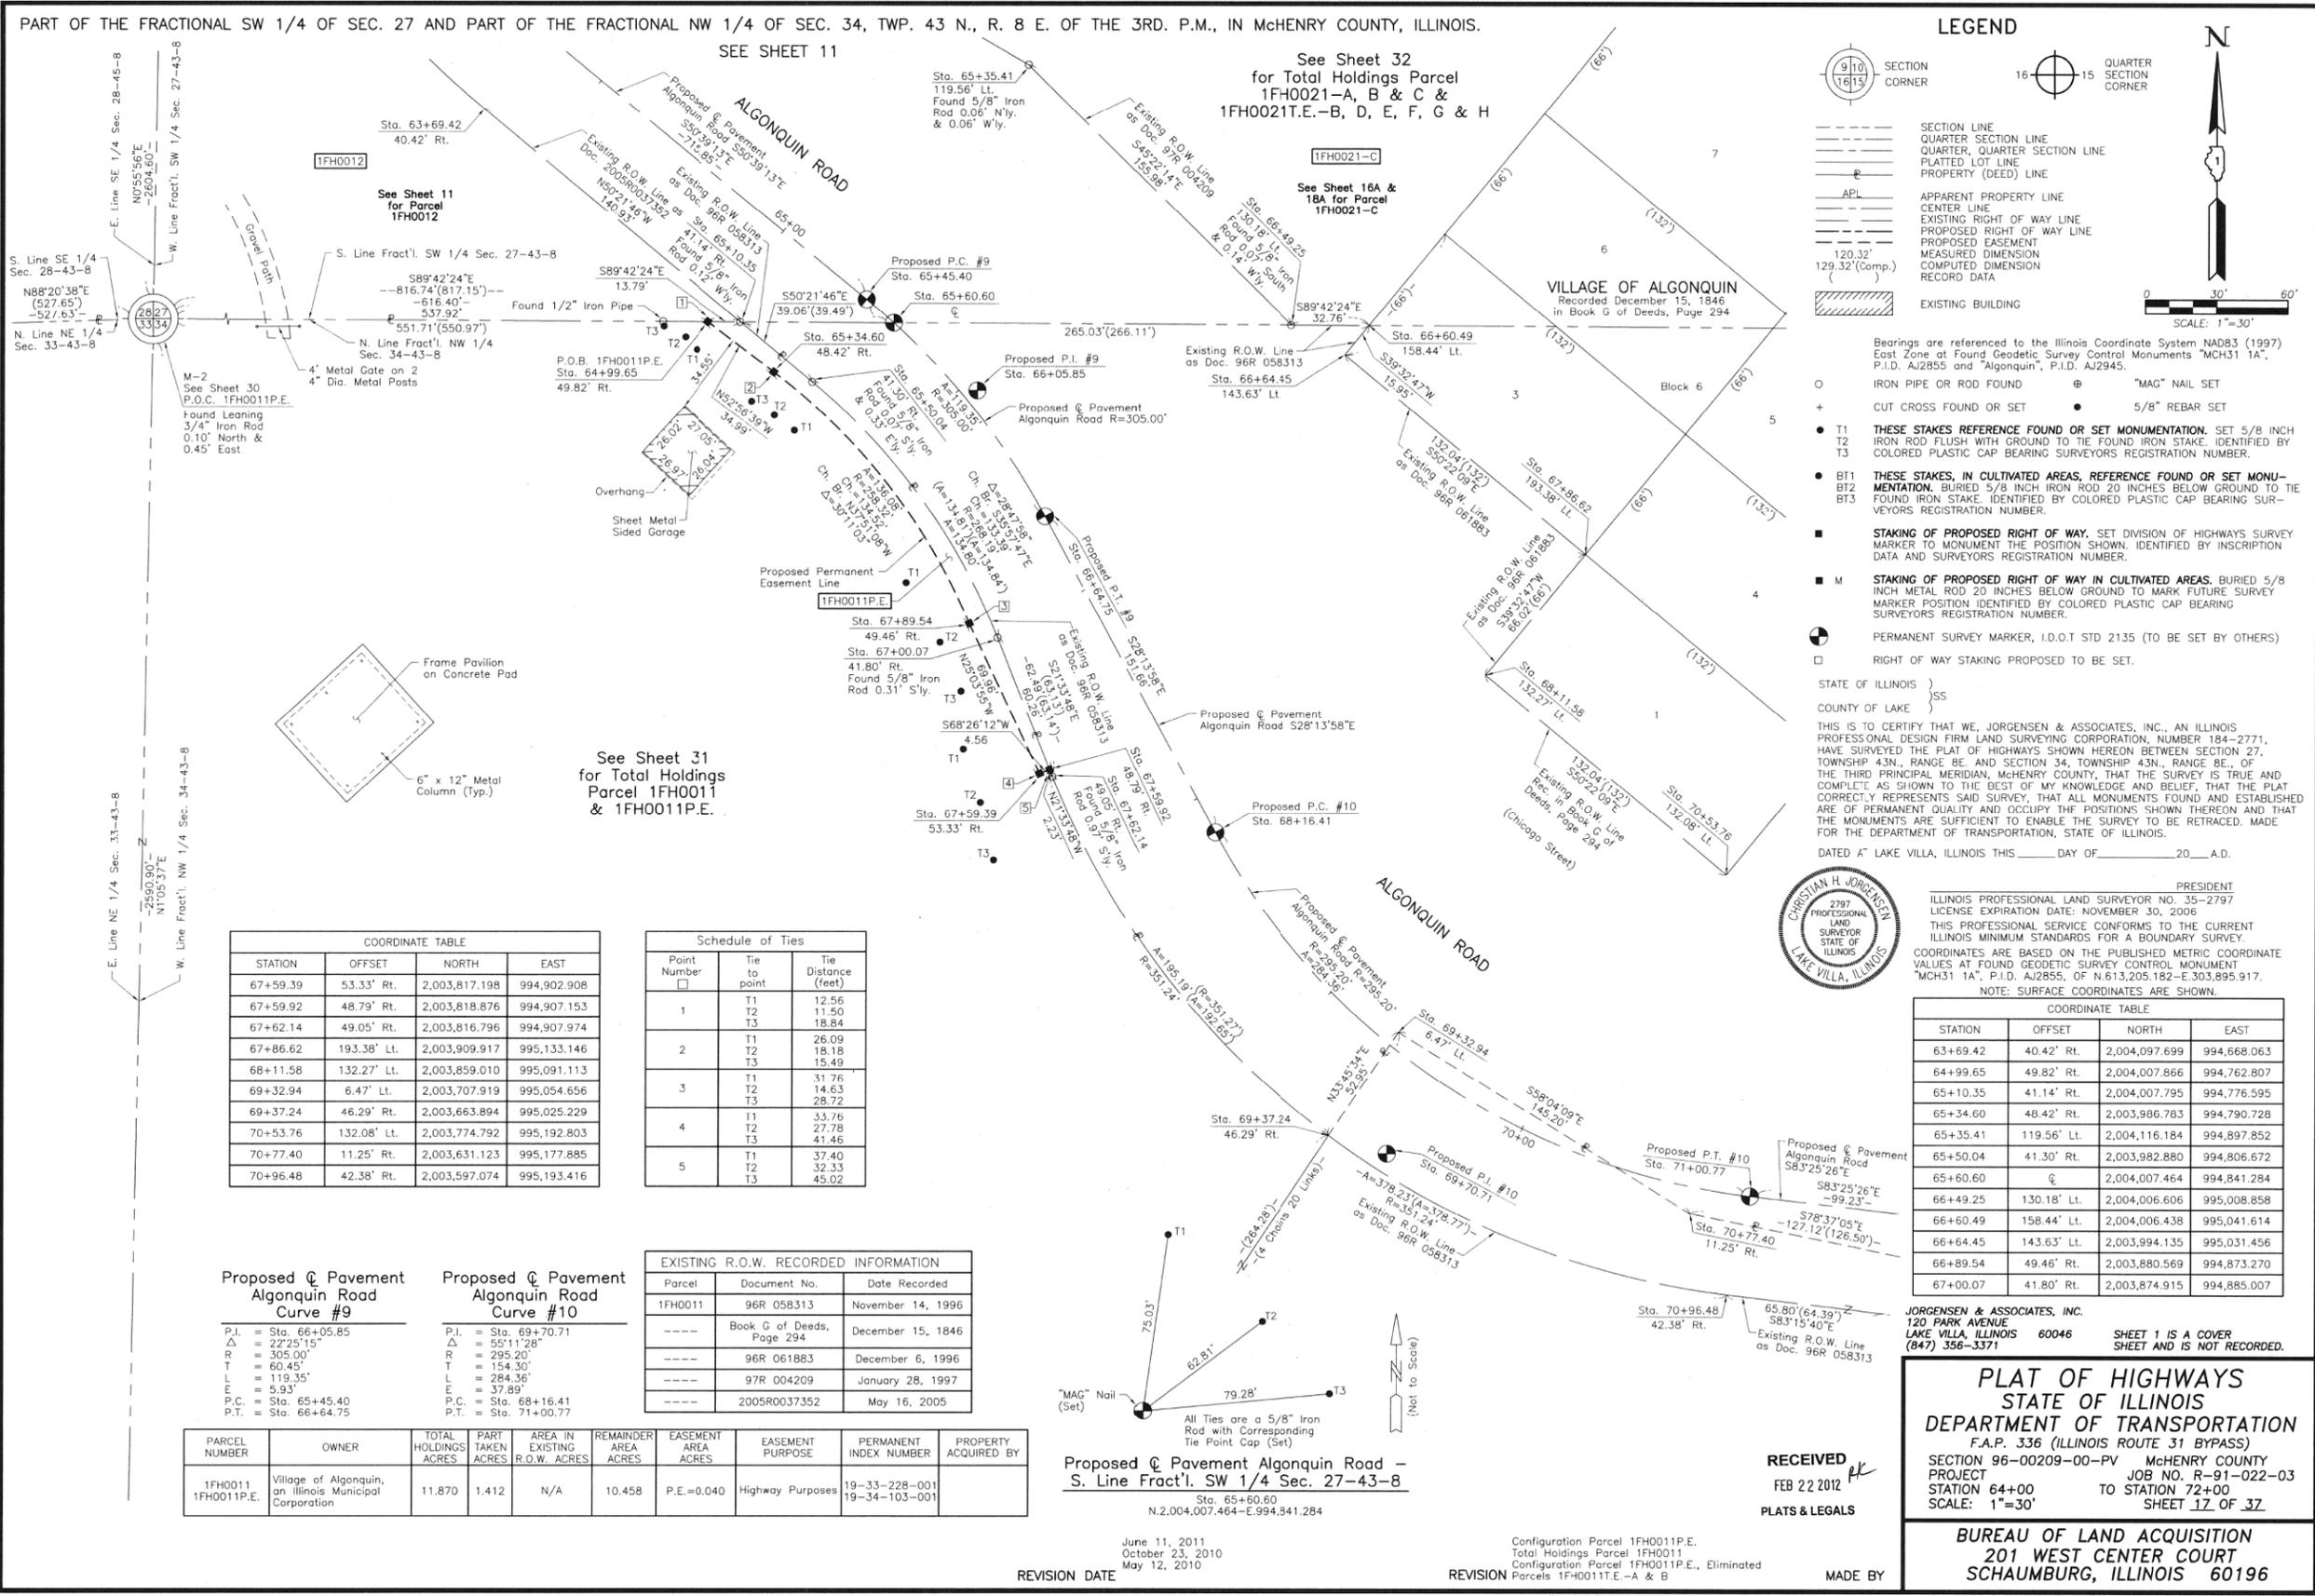

PART OF THE FRACTIONAL SW 1/4 OF SEC. 27 AND PART OF THE FRACTIONAL NW 1/4 OF SEC. 34, TWP. 43 N., R. 8 E. OF THE 3RD. P.M., IN McHENRY COUNTY, ILLINOIS.

LEGEND

SECTION CORNER
QUARTER SECTION CORNER

SECTION LINE
QUARTER SECTION LINE
QUARTER, QUARTER SECTION LINE
PLATTED LOT LINE
PROPERTY (DEED) LINE

APL
APPARENT PROPERTY LINE
CENTER LINE
EXISTING RIGHT OF WAY LINE
PROPOSED RIGHT OF WAY LINE
PROPOSED EASEMENT
MEASURED DIMENSION
COMPUTED DIMENSION
RECORD DATA

EXISTING BUILDING

SCALE: 1"=30'

Bearings are referenced to the Illinois Coordinate System NAD83 (1997) East Zone of Found Geodetic Survey Control Monuments "MCH31 1A", P.I.D. AJ2855 and "Algonquin", P.I.D. AJ2945.

○ IRON PIPE OR ROD FOUND ⊕ "MAG" NAIL SET
+ CUT CROSS FOUND OR SET ● 5/8" REBAR SET

● T1 THESE STAKES REFERENCE FOUND OR SET MONUMENTATION. SET 5/8" IRON ROD FLUSH WITH GROUND TO THE FOUND IRON STAKE, IDENTIFIED BY COLORED PLASTIC CAP BEARING SURVEYORS REGISTRATION NUMBER.
● T2
● T3

● BT1 THESE STAKES, IN CULTIVATED AREAS, REFERENCE FOUND OR SET MONUMENTATION. BURIED 5/8" IRON ROD 20 INCHES BELOW GROUND TO THE FOUND IRON STAKE, IDENTIFIED BY COLORED PLASTIC CAP BEARING SURVEYORS REGISTRATION NUMBER.
● BT2
● BT3

■ STAKING OF PROPOSED RIGHT OF WAY. SET DIVISION OF HIGHWAYS SURVEY MARKER TO MONUMENT THE POSITION SHOWN, IDENTIFIED BY INSCRIPTION DATA AND SURVEYORS REGISTRATION NUMBER.

■ M STAKING OF PROPOSED RIGHT OF WAY IN CULTIVATED AREAS. BURIED 5/8" IRON METAL ROD 20 INCHES BELOW GROUND TO MARK FUTURE SURVEY MARKER POSITION IDENTIFIED BY COLORED PLASTIC CAP BEARING SURVEYORS REGISTRATION NUMBER.

● PERMANENT SURVEY MARKER, I.D.O.T STD 2135 (TO BE SET BY OTHERS)

□ RIGHT OF WAY STAKING PROPOSED TO BE SET.

STATE OF ILLINOIS }
COUNTY OF LAKE }SS

THIS IS TO CERTIFY THAT WE, JORGENSEN & ASSOCIATES, INC., AN ILLINOIS PROFESSIONAL DESIGN FIRM LAND SURVEYING CORPORATION, NUMBER 184-2771, HAVE SURVEYED THE PLAT OF HIGHWAYS SHOWN HEREON BETWEEN SECTION 27, TOWNSHIP 43N., RANGE 8E. AND SECTION 34, TOWNSHIP 43N., RANGE 8E., OF THE THIRD PRINCIPAL MERIDIAN, McHENRY COUNTY, THAT THE SURVEY IS TRUE AND COMPLETE AS SHOWN TO THE BEST OF MY KNOWLEDGE AND BELIEF, THAT THE PLAT CORRECTLY REPRESENTS SAID SURVEY, THAT ALL MONUMENTS FOUND AND ESTABLISHED ARE OF PERMANENT QUALITY AND OCCUPY THE POSITIONS SHOWN THEREON AND THAT THE MONUMENTS ARE SUFFICIENT TO ENABLE THE SURVEY TO BE RETRACED, MADE FOR THE DEPARTMENT OF TRANSPORTATION, STATE OF ILLINOIS.

DATED AT LAKE VILLA, ILLINOIS THIS _____ DAY OF _____ 20____ A.D.

ILLINOIS PROFESSIONAL LAND SURVEYOR NO. 35-2797
LICENSE EXPIRATION DATE: NOVEMBER 30, 2008
THIS PROFESSIONAL SERVICE CONFORMS TO THE CURRENT ILLINOIS MINIMUM STANDARDS FOR A BOUNDARY SURVEY.
COORDINATES ARE BASED ON THE PUBLISHED METRIC COORDINATE VALUES AT FOUND GEODETIC SURVEY CONTROL MONUMENT "MCH31 1A", P.I.D. AJ2855, OF N.613.205.182-E.303.895.917.
NOTE: SURFACE COORDINATES ARE SHOWN.

CHRISTIAN H. JORGENSEN
2797 PROFESSIONAL LAND SURVEYOR
STATE OF ILLINOIS
LAKE VILLA, ILLINOIS

JORGENSEN & ASSOCIATES, INC.
120 PARK AVENUE
LAKE VILLA, ILLINOIS 60046
(647) 356-3371

SHEET 1 IS A COVER SHEET AND IS NOT RECORDED.

PLAT OF HIGHWAYS
STATE OF ILLINOIS
DEPARTMENT OF TRANSPORTATION
F.A.P. 336 (ILLINOIS ROUTE 31 BYPASS)
SECTION 96-00209-00-PV McHENRY COUNTY
PROJECT JOB NO. R-91-022-03
STATION 64+00 TO STATION 72+00
SCALE: 1"=30' SHEET 17 OF 37

BUREAU OF LAND ACQUISITION
201 WEST CENTER COURT
SCHAUMBURG, ILLINOIS 60196

COORDINATE TABLE

STATION	OFFSET	NORTH	EAST
67+59.39	53.33' Rt.	2,003,817.198	994,902.908
67+59.92	48.79' Rt.	2,003,818.876	994,907.153
67+62.14	49.05' Rt.	2,003,816.796	994,907.974
67+86.62	193.38' Lt.	2,003,909.917	995,133.146
68+11.58	132.27' Lt.	2,003,859.010	995,091.113
69+32.94	6.47' Lt.	2,003,707.919	995,054.656
69+37.24	46.29' Rt.	2,003,663.894	995,025.229
70+53.76	132.08' Lt.	2,003,774.792	995,192.803
70+77.40	11.25' Rt.	2,003,631.123	995,177.885
70+96.48	42.38' Rt.	2,003,597.074	995,193.416

Schedule of Ties

Point Number	Tie to point	Tie Distance (feet)
1	T1	12.56
	T2	11.50
	T3	18.84
2	T1	26.09
	T2	18.18
	T3	15.49
3	T1	31.76
	T2	14.63
	T3	28.72
4	T1	33.76
	T2	27.78
	T3	41.46
5	T1	37.40
	T2	32.33
	T3	45.02

EXISTING R.O.W. RECORDED INFORMATION

Parcel	Document No.	Date Recorded
1FH0011	96R 058313	November 14, 1996
----	Book G of Deeds, Page 294	December 15, 1846
----	96R 061883	December 6, 1996
----	97R 004209	January 28, 1997
----	2005R0037352	May 16, 2005

Proposed Pavement Algonquin Road Curve #9

P.I. = Sta. 66+05.85	P.I. = Sta. 69+70.71
Δ = 22°25'15"	Δ = 55°11'28"
R = 305.00'	R = 295.20'
T = 60.45'	T = 154.30'
L = 119.35'	L = 284.36'
E = 5.93'	E = 37.89'
P.C. = Sta. 65+45.40	P.C. = Sta. 68+16.41
P.T. = Sta. 66+64.75	P.T. = Sta. 71+00.77

PARCEL NUMBER	OWNER	TOTAL HOLDINGS ACRES	PART TAKEN ACRES	AREA IN EXISTING R.O.W. ACRES	REMAINDER AREA ACRES	EASEMENT AREA ACRES	EASEMENT PURPOSE	PERMANENT INDEX NUMBER	PROPERTY ACQUIRED BY
1FH0011 1FH0011P.E.	Village of Algonquin, an Illinois Municipal Corporation	11.870	1.412	N/A	10.458	P.E.=0.040	Highway Purposes	19-33-228-001 19-34-103-001	

ROW PLAT	MADE	DATE
	CHECKED	
	DRAWN	
	NOTED	
	NO	


PART OF THE FRACTIONAL SW 1/4 AND PART OF THE NW 1/4 OF SEC. 27 AND PART OF THE SE 1/4 OF SEC. 28, TWP. 43 N., R. 8 E. OF THE 3RD. P.M., IN McHENRY COUNTY, ILLINOIS.

PARCEL NUMBER	OWNER	TOTAL HOLDINGS ACRES	PART TAKEN ACRES	AREA IN EXISTING R.O.W. ACRES	REMAINDER AREA ACRES	EASEMENT AREA ACRES	EASEMENT PURPOSE	PERMANENT INDEX NUMBER	PROPERTY ACQUIRED BY
1FH0021-A 1FH0021-B 1FH0021-C 1FH0021-F 1FH0021-E 1FH0021-D 1FH0021-G 1FH0021-H	Chicago Title Land Trust Company, as successor trustee to Chicago Title and Trust Company under trust agreement dated the 17th day of July, 1968 and known as Trust Number 53278	213.598	A=0.531 B=32.099 C=33.894	N/A	147.074	T.E.-B=1.414 T.E.-D=2.981 T.E.-E=0.129 T.E.-F=0.743 T.E.-G=10.056 T.E.-H=0.470	Construction Purposes Construction Purposes Grading Grading Grading Grading	19-27-126-004 19-27-351-002 19-27-351-014 19-28-200-025 19-28-426-011	

Point Number	Tie to point	Tie Distance (feet)
1	T1 T2 T3	
2	T1 T2 T3	
3	T1 T2 T3	
4	T1 T2 T3	
5	T1 T2 T3	
6	T1 T2 T3	
7	T1 T2 T3	

P.I. = Sta. 156+26.02	P.I. = Sta. 24+76.71
Δ = 62°30'28"	Δ = 62°38'06"
R = 920.05'	R = 822.20'
L = 558.39'	L = 500.25'
T = 1003.75'	T = 898.82'
E = 156.19'	E = 140.22'
P.C. = Sta. 150+67.63	P.C. = Sta. 19+76.46
P.T. = Sta. 160+71.38	P.T. = Sta. 28+75.28

P.I. = Sta. 24+76.71	P.I. = Sta. 156+26.02
Δ = 62°38'06"	Δ = 62°30'28"
R = 822.20'	R = 920.05'
L = 500.25'	L = 558.39'
T = 898.82'	T = 1003.75'
E = 140.22'	E = 156.19'
P.C. = Sta. 19+76.46	P.C. = Sta. 150+67.63
P.T. = Sta. 28+75.28	P.T. = Sta. 160+71.38

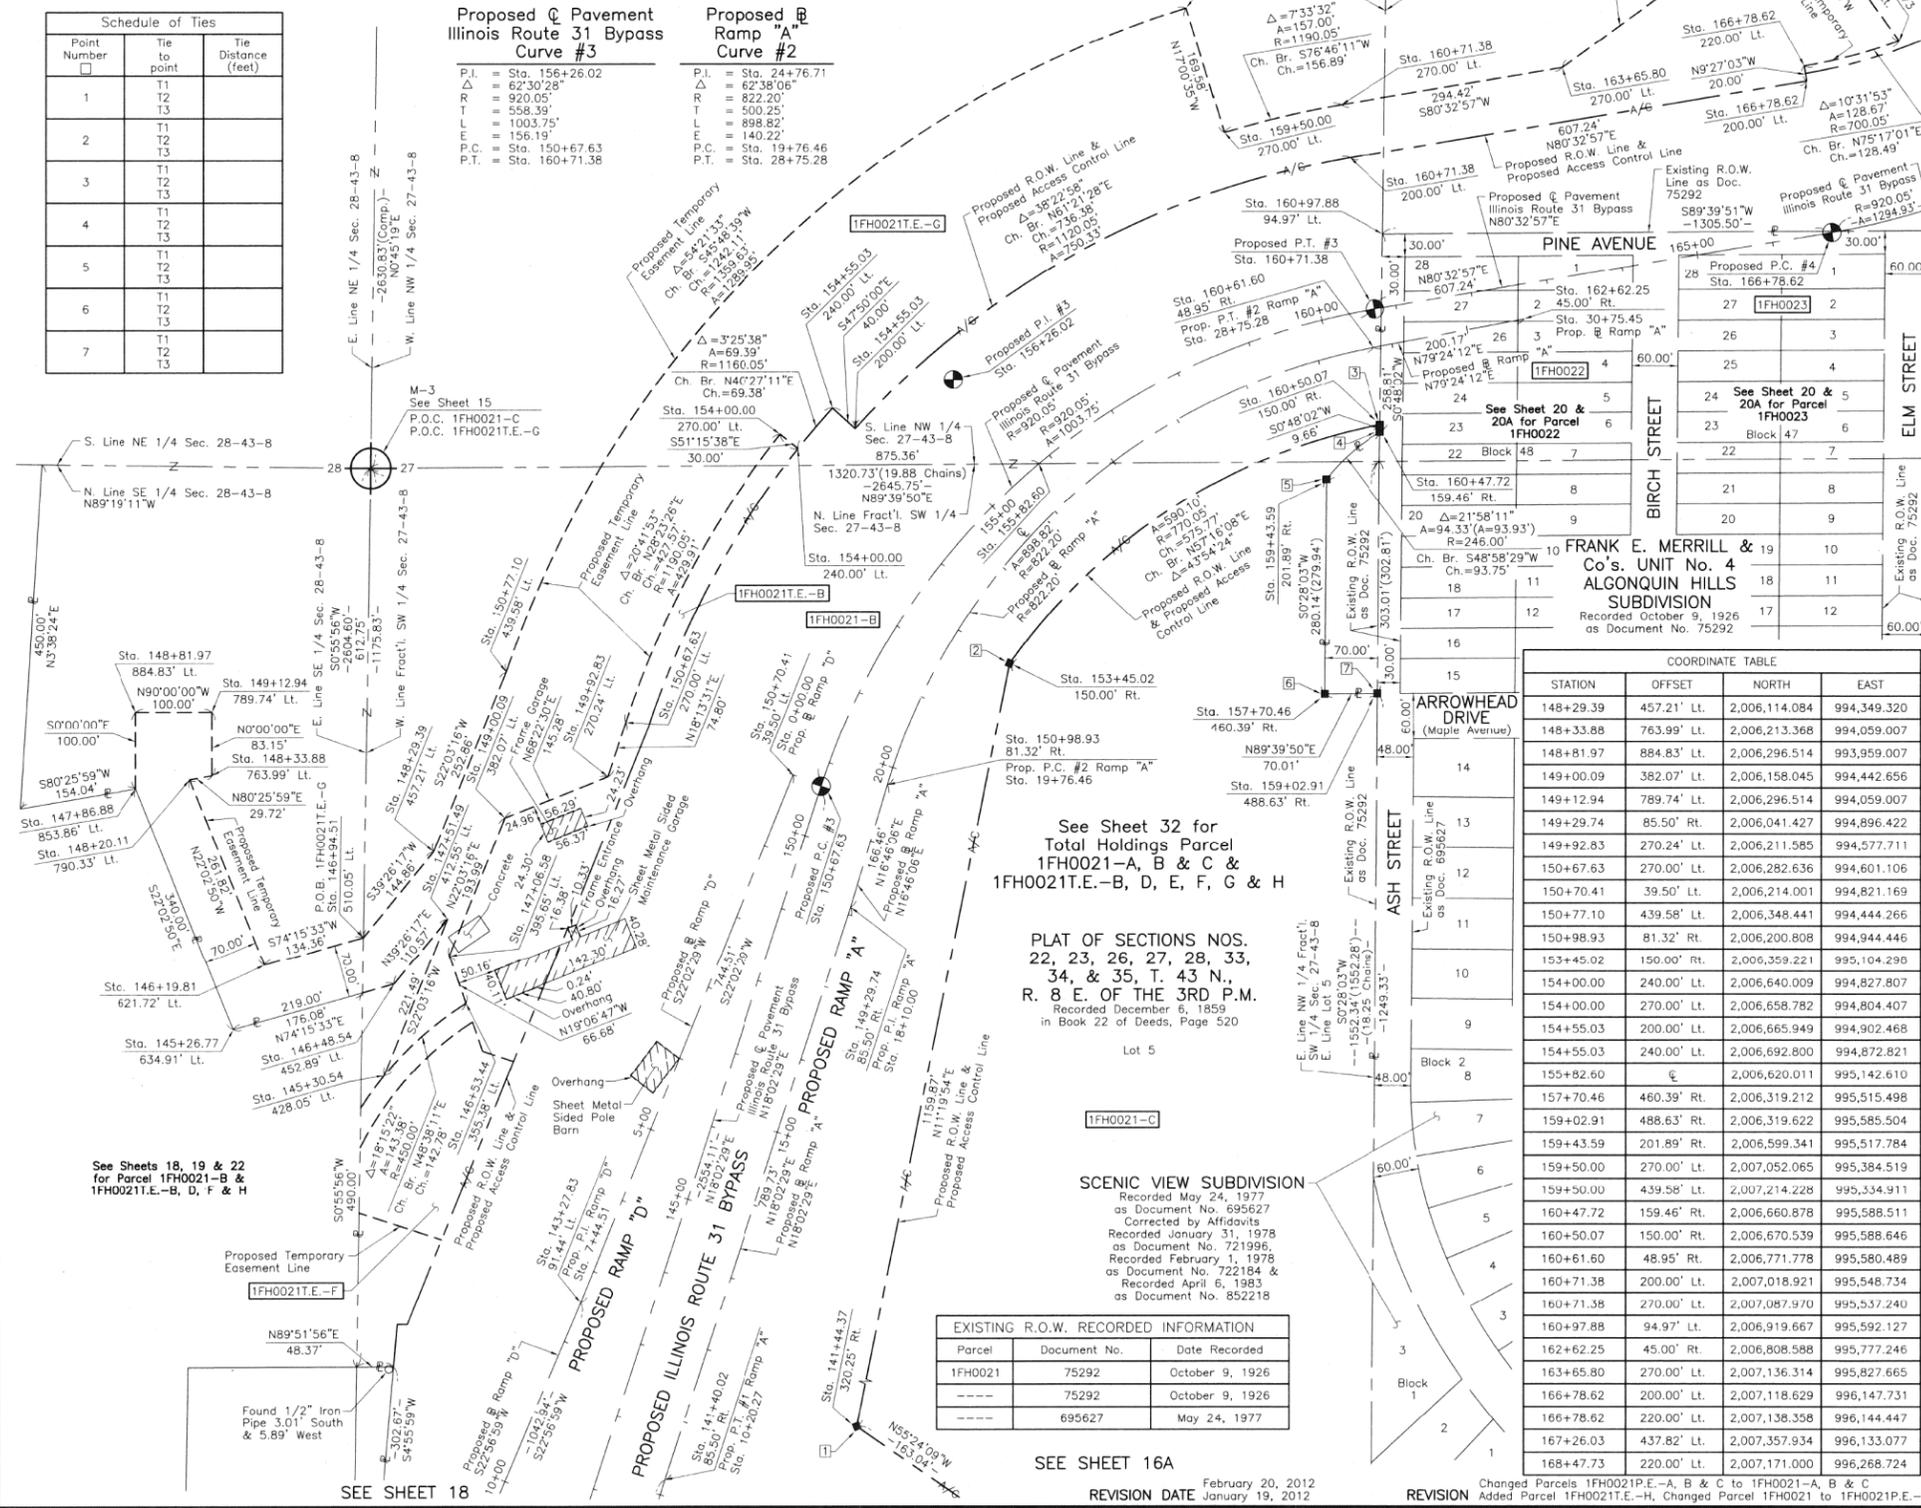

LEGEND

SECTION CORNER
QUARTER SECTION CORNER

SECTION LINE
QUARTER SECTION LINE
QUARTER SECTION LINE
PLATTED LOT LINE
PROPERTY (DEED) LINE

APL
APPARENT PROPERTY LINE
CENTER LINE
EXISTING RIGHT OF WAY LINE
PROPOSED RIGHT OF WAY LINE
PROPOSED EASEMENT
MEASURED DIMENSION
COMPUTED DIMENSION
RECORD DATA

EXISTING BUILDING

Bearings are referenced to the Illinois Coordinate System NAD83 (1997) East Zone of Found Geodetic Survey Control Monuments "MCH31 1A", P.I.D. AJ2855 and "Algonquin", P.I.D. AJ2945.

IRON PIPE OR ROD FOUND
CUT CROSS FOUND OR SET
THESE STAKES REFERENCE FOUND OR SET MONUMENTATION. SET 5/8 INCH IRON ROD FLUSH WITH GROUND TO THE FOUND IRON STAKE. IDENTIFIED BY COLORED PLASTIC CAP BEARING SURVEYORS REGISTRATION NUMBER.

THESE STAKES, IN CULTIVATED AREAS, REFERENCE FOUND OR SET MONUMENTATION. BURIED 5/8 INCH IRON ROD 20 INCHES BELOW GROUND TO THE FOUND IRON STAKE. IDENTIFIED BY COLORED PLASTIC CAP BEARING SURVEYORS REGISTRATION NUMBER.

STAKING OF PROPOSED RIGHT OF WAY. SET DIVISION OF HIGHWAYS SURVEY MARKER TO MONUMENT THE POSITION SHOWN. IDENTIFIED BY INSCRIPTION DATA AND SURVEYORS REGISTRATION NUMBER.

STAKING OF PROPOSED RIGHT OF WAY IN CULTIVATED AREAS. BURIED 5/8 INCH METAL ROD 20 INCHES BELOW GROUND TO MARK FUTURE SURVEY MARKER POSITION IDENTIFIED BY COLORED PLASTIC CAP BEARING SURVEYORS REGISTRATION NUMBER.

PERMANENT SURVEY MARKER, I.D.O.T STD 2135 (TO BE SET BY OTHERS)

RIGHT OF WAY STAKING PROPOSED TO BE SET.

STATE OF ILLINOIS }
COUNTY OF LAKE }
THIS IS TO CERTIFY THAT WE, JORGENSEN & ASSOCIATES, INC., AN ILLINOIS PROFESSIONAL DESIGN FIRM LAND SURVEYING CORPORATION, NUMBER 184-2771, HAVE SURVEYED THE PLAT OF HIGHWAYS SHOWN HEREON BETWEEN SECTION 27, TOWNSHIP 43N, RANGE 8E, AND SECTION 28, TOWNSHIP 43N, RANGE 8E, OF THE THIRD PRINCIPAL MERIDIAN, McHENRY COUNTY, THAT THE SURVEY IS TRUE AND COMPLETE AS SHOWN TO THE BEST OF MY KNOWLEDGE AND BELIEF, THAT THE PLAT CORRECTLY REPRESENTS SAID SURVEY, THAT ALL MONUMENTS FOUND AND ESTABLISHED ARE OF PERMANENT QUALITY AND OCCUPY THE POSITIONS SHOWN THEREON AND THAT THE MONUMENTS ARE SUFFICIENT TO ENABLE THE SURVEY TO BE RETRACED. MADE FOR THE DEPARTMENT OF TRANSPORTATION, STATE OF ILLINOIS.

DATED AT LAKE VILLA, ILLINOIS THIS ____ DAY OF _____ 20__ A.D.

RECEIVED
FEB 22 2012
PLATS & LEGALS

STATION	OFFSET	NORTH	EAST
148+29.39	457.21' Lt.	2,006,114.084	994,349.320
148+33.88	763.99' Lt.	2,006,213.368	994,059.007
148+81.97	884.83' Lt.	2,006,296.514	993,959.007
149+00.09	382.07' Lt.	2,006,158.045	994,442.656
149+12.94	789.74' Lt.	2,006,296.514	994,059.007
149+29.70	85.50' Rt.	2,006,041.427	994,896.422
149+92.83	270.24' Lt.	2,006,211.585	994,577.711
150+67.63	270.00' Lt.	2,006,282.636	994,601.106
150+70.41	39.50' Lt.	2,006,214.001	994,821.169
150+77.10	439.58' Lt.	2,006,348.441	994,444.266
150+98.93	81.32' Rt.	2,006,200.808	994,944.446
153+45.02	150.00' Lt.	2,006,359.221	995,104.290
154+00.00	240.00' Lt.	2,006,640.009	994,827.807
154+00.00	270.00' Lt.	2,006,658.782	994,804.407
154+55.03	200.00' Lt.	2,006,665.949	994,902.468
154+55.03	240.00' Lt.	2,006,692.800	994,872.821
155+82.60	€	2,006,620.011	995,142.610
157+70.46	460.39' Rt.	2,006,319.212	995,515.498
159+02.91	488.63' Rt.	2,006,319.212	995,585.504
159+43.59	201.89' Rt.	2,006,599.341	995,517.784
159+50.00	270.00' Lt.	2,007,052.065	995,384.519
159+50.00	439.58' Lt.	2,007,214.228	995,334.911
160+47.72	159.46' Rt.	2,006,660.878	995,588.511
160+50.07	150.00' Rt.	2,006,670.539	995,588.646
160+61.60	48.95' Rt.	2,006,771.778	995,580.489
160+71.38	200.00' Lt.	2,007,018.921	995,548.734
160+71.38	270.00' Lt.	2,007,087.970	995,537.240
160+97.88	94.97' Lt.	2,006,919.667	995,592.127
162+62.25	45.00' Rt.	2,006,808.588	995,777.246
163+65.80	270.00' Lt.	2,007,136.314	995,827.665
166+78.62	200.00' Lt.	2,007,118.629	996,147.731
166+78.62	220.00' Lt.	2,007,138.358	996,144.447
167+26.03	437.82' Lt.	2,007,357.934	996,133.077
168+47.73	220.00' Lt.	2,007,171.000	996,268.724

Parcel	Document No.	Date Recorded
1FH0021	75292	October 9, 1926
-----	75292	October 9, 1926
-----	695627	May 24, 1977

STATION	OFFSET	NORTH	EAST
141+40.02	85.50' Rt.	2,005,290.528	994,651.839
141+44.37	320.25' Rt.	2,005,221.965	994,876.401
143+27.83	91.44' Lt.	2,005,523.901	994,541.770
145+26.77	634.91' Lt.	2,005,881.376	994,086.633
145+30.54	428.05' Lt.	2,005,820.898	994,284.488
146+19.81	621.72' Lt.	2,005,965.758	994,127.982
146+48.54	452.89' Lt.	2,005,940.786	994,297.416
146+53.44	355.38' Lt.	2,005,915.251	994,391.647
146+94.51	510.05' Lt.	2,006,002.206	994,257.299
147+06.58	395.65' Lt.	2,005,978.251	994,369.816
147+51.49	412.55' Lt.	2,006,026.181	994,367.655
147+86.88	853.86' Lt.	2,006,196.514	993,959.007
148+20.11	790.33' Lt.	2,006,208.429	994,029.704

JORGENSEN & ASSOCIATES, INC.
120 PARK AVENUE
LAKE VILLA, ILLINOIS 60046
(847) 356-3371

STATE OF ILLINOIS
DEPARTMENT OF TRANSPORTATION
F.A.P. 336 (ILLINOIS ROUTE 31 BYPASS)
SECTION 96-00209-00-PV McHENRY COUNTY
PROJECT JOB NO. R-91-022-03
STATION 141+00 TO STATION 169+00
SCALE: 1"=100'
SHEET 18A OF 37


BUREAU OF LAND ACQUISITION
201 WEST CENTER COURT
SCHAUMBURG, ILLINOIS 60196

PLAT OF HIGHWAYS
STATE OF ILLINOIS
DEPARTMENT OF TRANSPORTATION
F.A.P. 336 (ILLINOIS ROUTE 31 BYPASS)
SECTION 96-00209-00-PV McHENRY COUNTY
PROJECT JOB NO. R-91-022-03
STATION 141+00 TO STATION 169+00
SCALE: 1"=100'
SHEET 18A OF 37

PART OF THE FRACTIONAL SW 1/4 AND PART OF THE NW 1/4 OF SEC. 27, TWP. 43 N., R. 8 E. OF THE 3RD. P.M., IN McHENRY COUNTY, ILLINOIS.

Point Number	Tie to point	Tie Distance (feet)
1	T1	74.66
	T2	72.45
	T3	80.64
2	T1	16.26
	T2	12.09
	T3	30.41
3	T1	47.06
	T2	52.06
	T3	61.89
4	T1	59.65
	T2	34.87
	T3	67.93
5	T1	17.77
	T2	24.75
	T3	38.93
6	T1	32.91
	T2	23.86
	T3	26.77

PARCEL NUMBER	OWNER	TOTAL HOLDINGS ACRES	PART TAKEN ACRES	AREA IN EXISTING R.O.W. ACRES	REMAINDER AREA ACRES	EASEMENT AREA ACRES	EASEMENT PURPOSE	PERMANENT INDEX NUMBER	PROPERTY ACQUIRED BY
1FH0021-A 1FH0021-B 1FH0021-C 1FH0021-D 1FH0021-E 1FH0021-F 1FH0021-G 1FH0021-H	Chicago Title Land Trust Company, as successor trustee to Chicago Title and Trust Company under trust agreement dated the 17th day of July, 1968 and known as Trust Number 53278	213.598	A=0.531 B=32.099 C=33.894	N/A	147.074	T.E.-B=1.414 T.E.-D=2.981 T.E.-E=0.129 T.E.-F=0.743 T.E.-G=10.056 T.E.-H=0.470	Construction Purposes Construction Purposes Grading Grading Grading Grading	19-27-126-004 19-27-351-002 19-27-351-014 19-28-200-025 19-28-426-011	

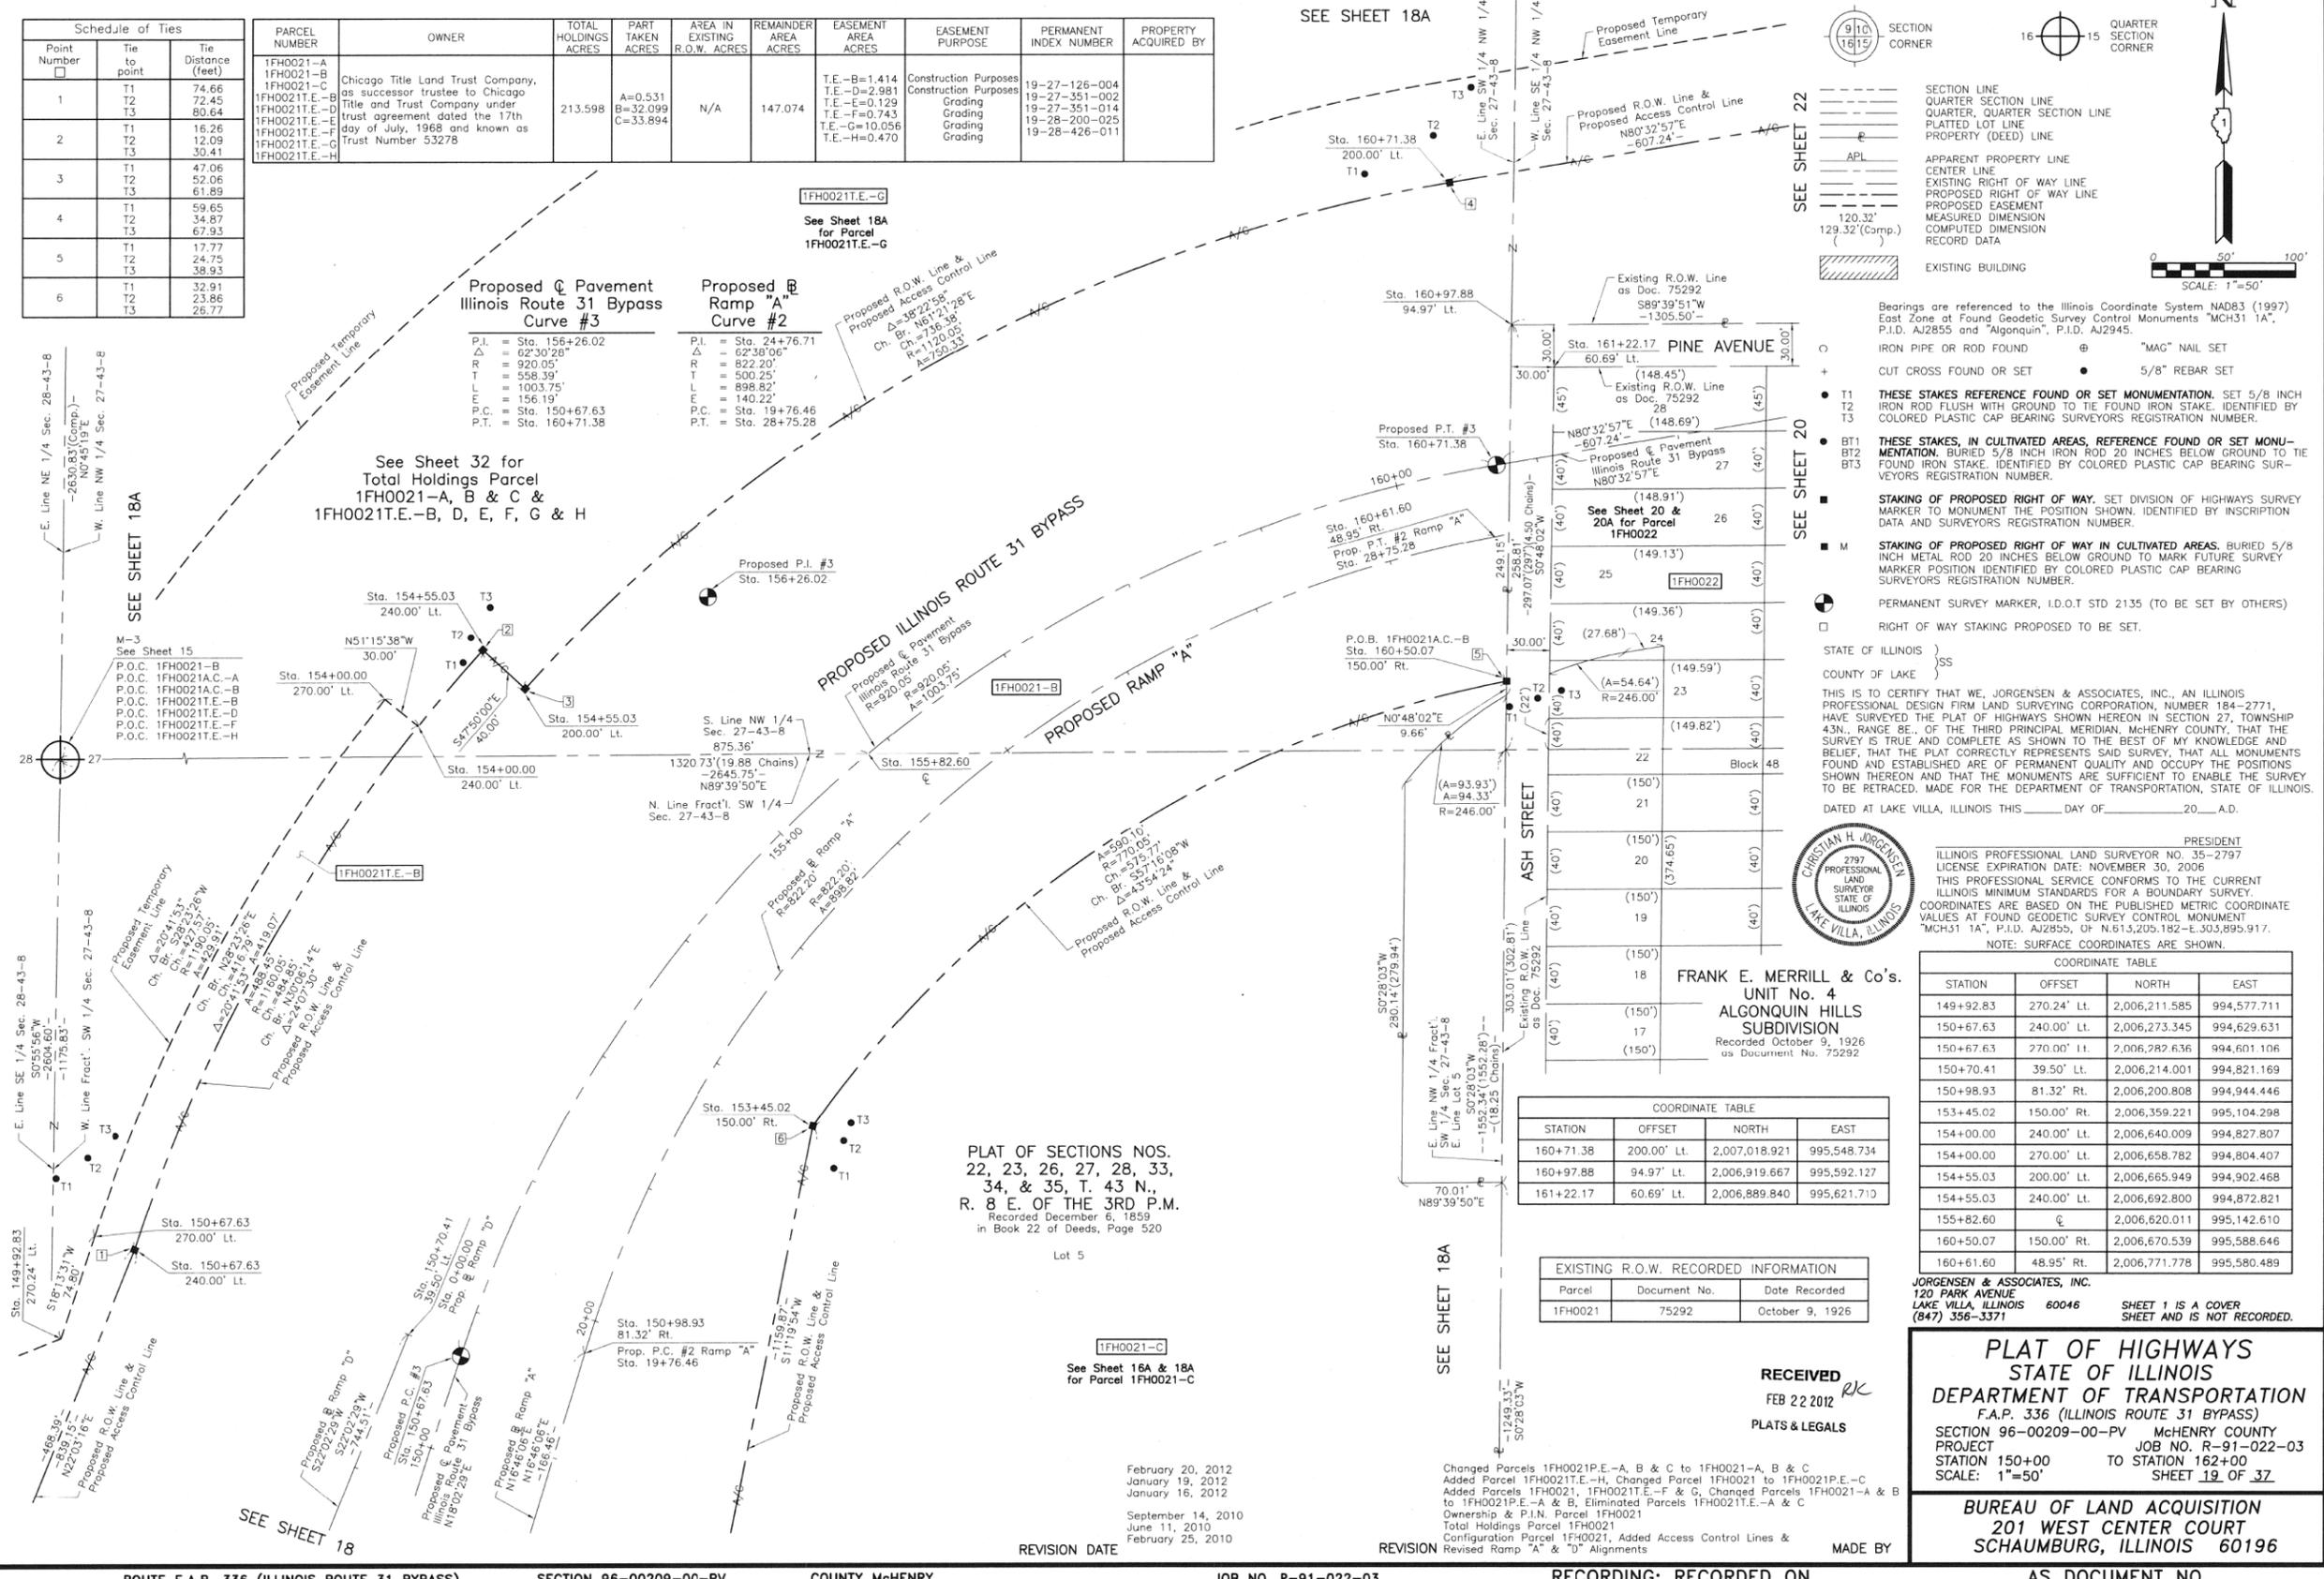

SEE SHEET 18A

SEE SHEET 18A

SEE SHEET 18

LEGEND

- SECTION CORNER
- QUARTER SECTION CORNER
- SECTION LINE
- QUARTER SECTION LINE
- PLATTED LOT LINE
- PROPERTY (DEED) LINE
- APL
- APPARENT PROPERTY LINE
- CENTER LINE
- EXISTING RIGHT OF WAY LINE
- PROPOSED RIGHT OF WAY LINE
- PROPOSED EASEMENT
- MEASURED DIMENSION
- COMPUTED DIMENSION
- RECORD DATA
- EXISTING BUILDING

Bearings are referenced to the Illinois Coordinate System NAD83 (1997) East Zone at Found Geodetic Survey Control Monuments "MCH31 1A", P.I.D. AJ2855 and "Algonquin", P.I.D. AJ2945.

IRON PIPE OR ROD FOUND "MAG" NAIL SET
 CUT CROSS FOUND OR SET 5/8" REBAR SET

● T1 THESE STAKES REFERENCE FOUND OR SET MONUMENTATION. SET 5/8 INCH IRON ROD FLUSH WITH GROUND TO THE FOUND IRON STAKE, IDENTIFIED BY COLORED PLASTIC CAP BEARING SURVEYORS REGISTRATION NUMBER.
 ● T2
 ● T3

● BT1 THESE STAKES, IN CULTIVATED AREAS, REFERENCE FOUND OR SET MONUMENTATION. BURIED 5/8 INCH IRON ROD 20 INCHES BELOW GROUND TO THE FOUND IRON STAKE, IDENTIFIED BY COLORED PLASTIC CAP BEARING SURVEYORS REGISTRATION NUMBER.
 ● BT2
 ● BT3

■ M STAKING OF PROPOSED RIGHT OF WAY. SET DIVISION OF HIGHWAYS SURVEY MARKER TO MONUMENT THE POSITION SHOWN, IDENTIFIED BY INSCRIPTION DATA AND SURVEYORS REGISTRATION NUMBER.

■ STAKING OF PROPOSED RIGHT OF WAY IN CULTIVATED AREAS. BURIED 5/8 INCH IRON ROD 20 INCHES BELOW GROUND TO MARK FUTURE SURVEY MARKER POSITION IDENTIFIED BY COLORED PLASTIC CAP BEARING SURVEYORS REGISTRATION NUMBER.

□ PERMANENT SURVEY MARKER, I.D.O.T STD 2135 (TO BE SET BY OTHERS)

□ RIGHT OF WAY STAKING PROPOSED TO BE SET.

STATE OF ILLINOIS }
 COUNTY OF LAKE } SS

THIS IS TO CERTIFY THAT WE, JORGENSEN & ASSOCIATES, INC., AN ILLINOIS PROFESSIONAL DESIGN FIRM LAND SURVEYING CORPORATION, NUMBER 184-2771, HAVE SURVEYED THE PLAT OF HIGHWAYS SHOWN HEREON IN SECTION 27, TOWNSHIP 43N., RANGE 8E., OF THE THIRD PRINCIPAL MERIDIAN, McHENRY COUNTY, THAT THE SURVEY IS TRUE AND COMPLETE AS SHOWN TO THE BEST OF MY KNOWLEDGE AND BELIEF, THAT THE PLAT CORRECTLY REPRESENTS SAID SURVEY, THAT ALL MONUMENTS FOUND AND ESTABLISHED ARE OF PERMANENT QUALITY AND OCCUPY THE POSITIONS SHOWN THEREON AND THAT THE MONUMENTS ARE SUFFICIENT TO ENABLE THE SURVEY TO BE RETRACED, MADE FOR THE DEPARTMENT OF TRANSPORTATION, STATE OF ILLINOIS, DATED AT LAKE VILLA, ILLINOIS THIS ____ DAY OF ____ 20__ A.D.

ILLINOIS PROFESSIONAL LAND SURVEYOR NO. 35-2797
 LICENSE EXPIRATION DATE: NOVEMBER 30, 2006
 THIS PROFESSIONAL SERVICE CONFORMS TO THE CURRENT ILLINOIS MINIMUM STANDARDS FOR A BOUNDARY SURVEY.
 COORDINATES ARE BASED ON THE PUBLISHED METRIC COORDINATE VALUES AT FOUND GEODETIC SURVEY CONTROL MONUMENT "MCH31 1A", P.I.D. AJ2855, OF N.815.205.182-E.503.895.917.
 NOTE: SURFACE COORDINATES ARE SHOWN.



FRANK E. MERRILL & Co's.
 UNIT No. 4
ALGONQUIN HILLS
 SUBDIVISION
 Recorded October 9, 1926
 as Document No. 75292

COORDINATE TABLE

STATION	OFFSET	NORTH	EAST
160+71.38	200.00' Lt.	2,007,018.921	995,548.734
160+97.88	94.97' Lt.	2,006,919.667	995,592.127
161+22.17	60.69' Lt.	2,006,889.840	995,621.710

EXISTING R.O.W. RECORDED INFORMATION

Parcel	Document No.	Date Recorded
1FH0021	75292	October 9, 1926

COORDINATE TABLE

STATION	OFFSET	NORTH	EAST
149+92.83	270.24' Lt.	2,006,211.585	994,577.711
150+67.63	240.00' Lt.	2,006,273.345	994,629.631
150+67.63	270.00' Lt.	2,006,282.636	994,601.106
150+70.41	30.50' Lt.	2,006,214.001	994,821.169
150+98.93	81.32' Rt.	2,006,200.808	994,944.446
153+45.02	150.00' Rt.	2,006,359.221	995,104.298
154+00.00	240.00' Lt.	2,006,640.009	994,827.807
154+00.00	270.00' Lt.	2,006,658.782	994,804.407
154+55.03	200.00' Lt.	2,006,665.949	994,902.468
154+55.03	240.00' Lt.	2,006,692.800	994,872.821
155+82.60	0	2,006,620.011	995,142.610
160+50.07	150.00' Rt.	2,006,670.539	995,588.646
160+61.60	48.95' Rt.	2,006,771.778	995,580.489

PLAT OF HIGHWAYS
 STATE OF ILLINOIS
 DEPARTMENT OF TRANSPORTATION
 F.A.P. 336 (ILLINOIS ROUTE 31 BYPASS)
 SECTION 96-00209-00-PV McHENRY COUNTY
 PROJECT JOB NO. R-91-022-03
 STATION 150+00 TO STATION 162+00
 SCALE: 1"=50' SHEET 19 OF 37

BUREAU OF LAND ACQUISITION
 201 WEST CENTER COURT
 SCHAUMBURG, ILLINOIS 60196

PART OF THE FRACTIONAL SW 1/4 AND PART OF THE NW 1/4 OF SEC. 27, TWP. 43 N., R. 8 E. OF THE 3RD. P.M., IN McHENRY COUNTY, ILLINOIS.

SEE SHEET 22


See Sheets 18, 19 & 22 for Parcel 1FH0021-E, B, D, F & H

PARCEL NUMBER	OWNER	TOTAL HOLDINGS ACRES	PART TAKEN ACRES	AREA IN EXISTING R.O.W. ACRES	REMAINDER AREA ACRES	EASEMENT AREA ACRES	EASEMENT PURPOSE	PERMANENT INDEX NUMBER	PROPERTY ACQUIRED BY
1FH0022	Chicago Title Land Trust Company, as successor trustee to Chicago Title and Trust Company under trust agreement dated the 17th day of July, 1968 and known as Trust Number 53278	2.970	2.970	N/A	0.000	N/A	N/A	19-27-176-001 19-27-176-003 19-27-176-004 19-27-176-005 19-27-176-006 19-27-176-007(Pl.) 19-27-326-006 19-27-326-007 19-27-326-009 19-27-326-010 19-27-326-011 19-27-326-012 19-27-326-013	
1FH0023	Chicago Title Land Trust Company, as successor trustee to Chicago Title and Trust Company under trust agreement dated the 17th day of July, 1968 and known as Trust Number 53278	2.262	2.262	N/A	0.000	N/A	N/A	19-27-177-001 19-27-177-003 19-27-327-006 19-27-327-007	

STATION	OFFSET	NORTH	EAST
164+13.23	355.68' Rt.	2,006,526.920	995,977.188
164+16.86	13.41' Lt.	2,006,891.588	995,920.162
164+20.12	316.27' Rt.	2,006,566.922	995,977.514
164+40.79	198.05' Rt.	2,006,686.929	995,978.494
164+49.20	150.00' Rt.	2,006,735.709	995,978.892
164+76.11	3.90' Lt.	2,006,891.940	995,980.167
165+46.53	377.06' Rt.	2,006,527.712	996,112.191
165+53.42	337.66' Rt.	2,006,567.714	996,112.517
165+74.09	219.44' Rt.	2,006,687.721	996,113.496
166+78.62	150.00' Rt.	2,006,773.380	996,205.201
167+17.17	150.00' Rt.	2,006,781.666	996,249.259
167+40.02	41.01' Rt.	2,006,893.522	996,250.172
167+95.16	56.20' Rt.	2,006,893.874	996,310.177


Point Number	Tie to point	Tie Distance (feet)
1	T1 T2 T3	36.05 18.77 14.14
2	T1 T2 T3	16.54 24.65 43.06
3	T1 T2 T3	35.12 22.02 23.51
4	T1 T2 T3	11 T2 T3
5	T1 T2 T3	12 T2 T3
6	T1 T2 T3	13 T2 T3
7	T1 T2 T3	

Point Number	Tie to point	Tie Distance (feet)
8	T1 T2 T3	
9	T1 T2 T3	
10	T1 T2 T3	
11	T1 T2 T3	
12	T1 T2 T3	
13	T1 T2 T3	

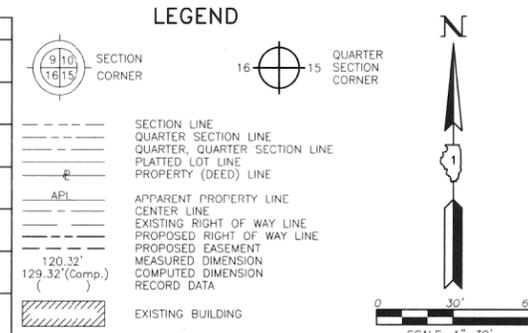

Parcel	Document No.	Date Recorded
1FH0022	75292	October 9, 1926
1FH0023	75292	October 9, 1926
-----	75292	October 9, 1926

Proposed $\frac{3}{4}$ Pavement Illinois Route 31 Bypass Curve #4
 P.I. = Sta. 174+59.45
 Δ = 80°38'27"
 R = 920.05'
 T = 780.83'
 L = 1294.93'
 P.C. = Sta. 165+78.62
 P.T. = Sta. 173+73.55

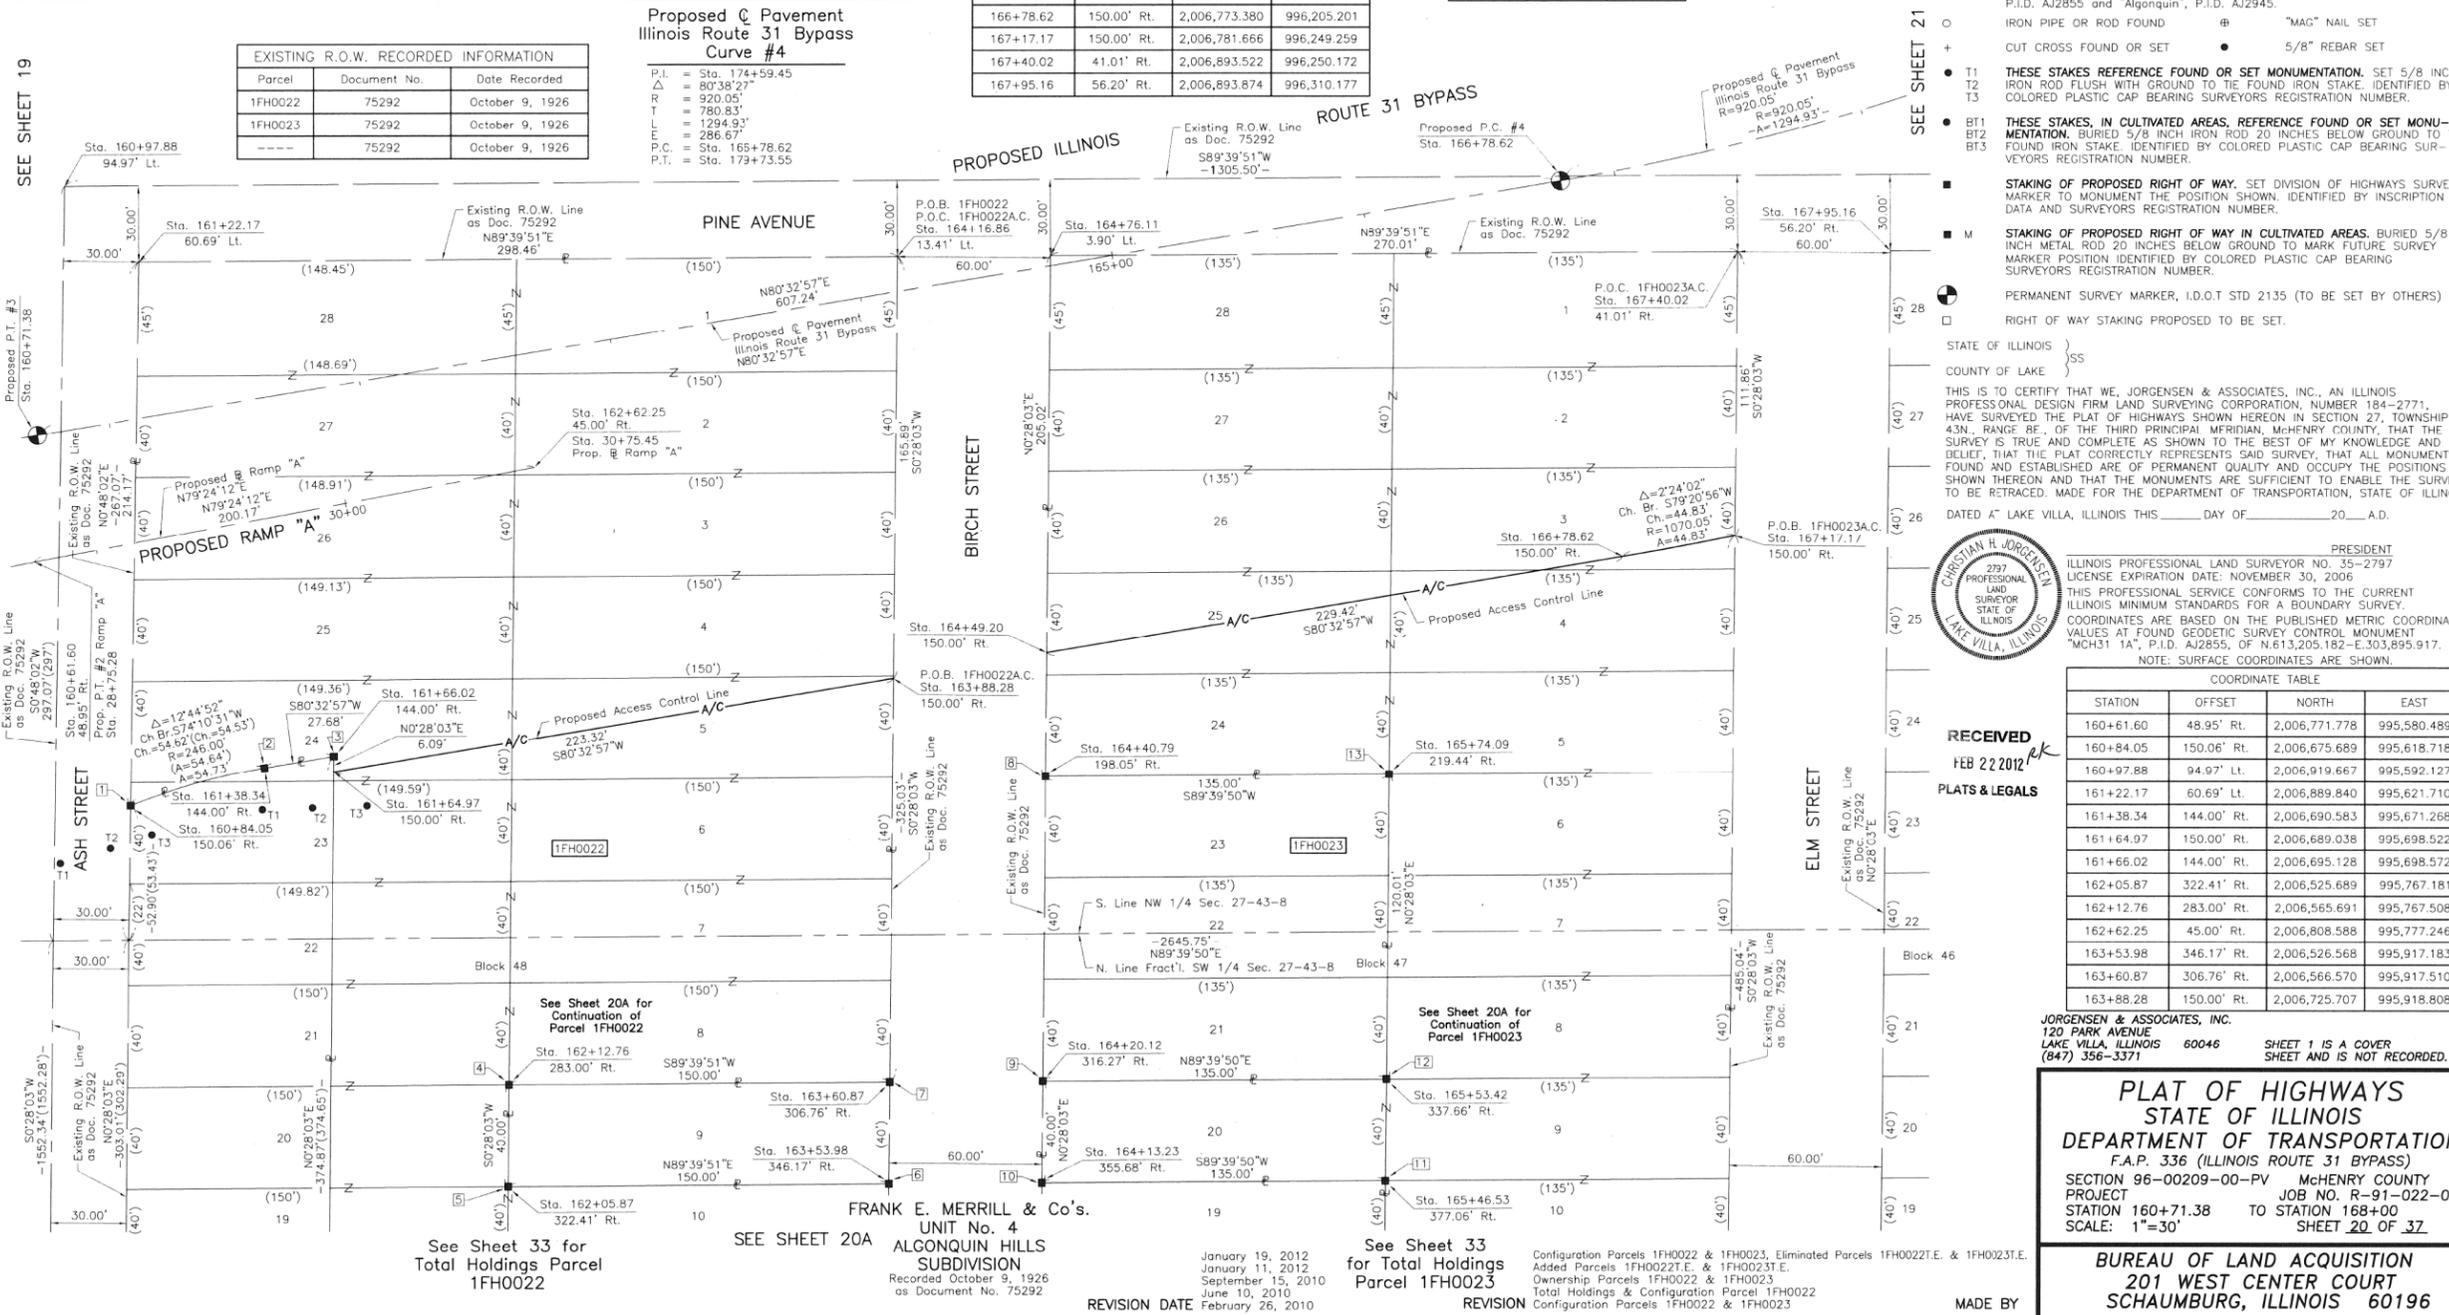

ROW PLAT	DATE	BY
MADE		
CHECKED		
LINKED		
NOTEBOOK		
NO		

BEARINGS ARE REFERENCED TO THE ILLINOIS COORDINATE SYSTEM NAD83 (1997) EAST ZONE AT FOUND GEODETIC SURVEY CONTROL MONUMENTS "MCH31 1A", P.I.D. AJ2855 AND "ALGONQUIN", P.I.D. AJ2945.

○ IRON PIPE OR ROD FOUND # "MAG" NAIL SET
 + CUT CROSS FOUND OR SET • 5/8" REBAR SET

● T1 THESE STAKES REFERENCE FOUND OR SET MONUMENTATION. SET 5/8 INCH IRON ROD FLUSH WITH GROUND TO THE FOUND IRON STAKE. IDENTIFIED BY COLORED PLASTIC CAP BEARING SURVEYORS REGISTRATION NUMBER.
 ● T2
 ● T3

● BT1 THESE STAKES, IN CULTIVATED AREAS, REFERENCE FOUND OR SET MONUMENTATION. BURIED 5/8 INCH IRON ROD 20 INCHES BELOW GROUND TO THE FOUND IRON STAKE. IDENTIFIED BY COLORED PLASTIC CAP BEARING SURVEYORS REGISTRATION NUMBER.
 ● BT2
 ● BT3

■ STAKING OF PROPOSED RIGHT OF WAY. SET DIVISION OF HIGHWAYS SURVEY MARKER TO MONUMENT THE POSITION SHOWN. IDENTIFIED BY INSCRIPTION DATA AND SURVEYORS REGISTRATION NUMBER.

■ M STAKING OF PROPOSED RIGHT OF WAY IN CULTIVATED AREAS. BURIED 5/8 INCH METAL ROD 20 INCHES BELOW GROUND TO MARK FUTURE SURVEY MARKER POSITION IDENTIFIED BY COLORED PLASTIC CAP BEARING SURVEYORS REGISTRATION NUMBER.

□ PERMANENT SURVEY MARKER, I.D.O.T. STD 2135 (TO BE SET BY OTHERS)

□ RIGHT OF WAY STAKING PROPOSED TO BE SET.

STATE OF ILLINOIS }
 COUNTY OF LAKE } SS

THIS IS TO CERTIFY THAT WE, JORGENSEN & ASSOCIATES, INC., AN ILLINOIS PROFESSIONAL DESIGN FIRM LAND SURVEYING CORPORATION, NUMBER 184-2771, HAVE SURVEYED THE PLAT OF HIGHWAYS SHOWN HEREON IN SECTION 27, TOWNSHIP 43N., RANGE 8E., OF THE THIRD PRINCIPAL MERIDIAN, McHENRY COUNTY, THAT THE SURVEY IS TRUE AND COMPLETE AS SHOWN TO THE BEST OF MY KNOWLEDGE AND BELIEF, THAT THE PLAT CORRECTLY REPRESENTS SAID SURVEY, THAT ALL MONUMENTS FOUND AND ESTABLISHED ARE OF PERMANENT QUALITY AND OCCUPY THE POSITIONS SHOWN THEREON AND THAT THE MONUMENTS ARE SUFFICIENT TO ENABLE THE SURVEY TO BE RETRACED. MADE FOR THE DEPARTMENT OF TRANSPORTATION, STATE OF ILLINOIS. DATED AT LAKE VILLA, ILLINOIS THIS ____ DAY OF ____ 20__ A.D.

ILLINOIS PROFESSIONAL LAND SURVEYOR NO. 35-2797
 LICENSE EXPIRATION DATE: NOVEMBER 30, 2006
 THIS PROFESSIONAL SERVICE CONFORMS TO THE CURRENT ILLINOIS MINIMUM STANDARDS FOR A BOUNDARY SURVEY. COORDINATES ARE BASED ON THE PUBLISHED METRIC COORDINATE VALUES AT FOUND GEODETIC SURVEY CONTROL MONUMENT "MCH31 1A", P.I.D. AJ2855, OF N.613,205.182-E.303,895.917. NOTE: SURFACE COORDINATES ARE SHOWN.



STATION	OFFSET	NORTH	EAST
160+61.60	48.95' Rt.	2,006,771.778	995,580.489
160+84.05	150.06' Rt.	2,006,675.689	995,618.718
160+97.88	94.97' Lt.	2,006,919.667	995,592.127
161+22.17	60.69' Lt.	2,006,889.840	995,621.710
161+38.34	144.00' Rt.	2,006,690.583	995,671.268
161+64.07	150.00' Rt.	2,006,689.038	995,698.522
161+66.02	144.00' Rt.	2,006,695.128	995,698.572
162+05.87	322.41' Rt.	2,006,525.689	995,767.181
162+12.76	283.00' Rt.	2,006,565.691	995,767.508
162+62.25	45.00' Rt.	2,006,808.588	995,777.246
163+53.98	346.17' Rt.	2,006,526.568	995,917.183
163+60.87	306.76' Rt.	2,006,566.570	995,917.510
163+88.28	150.00' Rt.	2,006,725.707	995,918.808

JORGENSEN & ASSOCIATES, INC.
 120 PARK AVENUE
 LAKE VILLA, ILLINOIS 60046
 (847) 356-3371

PLAT OF HIGHWAYS
 STATE OF ILLINOIS
 DEPARTMENT OF TRANSPORTATION
 F.A.P. 336 (ILLINOIS ROUTE 31 BYPASS)
 SECTION 96-00209-00-PV McHENRY COUNTY
 PROJECT JOB NO. R-91-022-03
 STATION 160+71.38 TO STATION 168+00
 SCALE: 1"=30' SHEET 20 OF 37

BUREAU OF LAND ACQUISITION
 201 WEST CENTER COURT
 SCHAUMBURG, ILLINOIS 60196

ROUTE F.A.P. 336 (ILLINOIS ROUTE 31 BYPASS) SECTION 96-00209-00-PV COUNTY McHENRY JOB NO. R-91-022-03 RECORDING: RECORDED ON AS DOCUMENT NO.

FILE NAME = ...\\D160F72-sht-PH-25.dgn	USER NAME = akw	DESIGNED -	REVISED -	STATE OF ILLINOIS DEPARTMENT OF TRANSPORTATION	PLAT OF HIGHWAYS	O.R. RTE.	SECTION	COUNTY	TOTAL SHEETS	SHEET NO.
		DRAWN - JORGENSEN & ASSOC.	REVISED -			0003	18A-2	McHENRY	825	434
		CHECKED - CJ	REVISED -			CONTRACT NO. 60F72				
		DATE -	REVISED -			FED. ROAD DIST. NO. 1 ILLINOIS FED. AID PROJECT				
						SCALE: GRAPHIC	SHEET NO. 25 OF 49 SHEETS	STA.	TO STA.	

PART OF THE FRACTIONAL SW 1/4 AND PART OF THE NW 1/4 OF SEC. 27, TWP. 43 N., R. 8 E. OF THE 3RD. P.M., IN McHENRY COUNTY, ILLINOIS.

PARCEL NUMBER	OWNER	TOTAL HOLDINGS ACRES	PART TAKEN ACRES	AREA IN EXISTING R.O.W. ACRES	REMAINDER AREA ACRES	EASEMENT AREA ACRES	EASEMENT PURPOSE	PERMANENT INDEX NUMBER	PROPERTY ACQUIRED BY
1FH0022	Chicago Title Land Trust Company, as successor trustee to Chicago Title and Trust Company under trust agreement dated the 17th day of July, 1968 and known as Trust Number 53278	2.970	2.970	N/A	0.000	N/A	N/A	19-27-176-001 19-27-176-003 19-27-176-004 19-27-176-005 19-27-176-006 19-27-176-007(P.L.) 19-27-326-006 19-27-326-007 19-27-326-009 19-27-326-010 19-27-326-011 19-27-326-012 19-27-326-013	
1FH0023	Chicago Title Land Trust Company, as successor trustee to Chicago Title and Trust Company under trust agreement dated the 17th day of July, 1968 and known as Trust Number 53278	2.262	2.262	N/A	0.000	N/A	N/A	19-27-177-001 19-27-177-003 19-27-327-006 19-27-327-007	


EXISTING R.O.W. RECORDED INFORMATION		
Parcel	Document No.	Date Recorded
1FH0022	75292	October 9, 1926
1FH0023	75292	October 9, 1926
---	75292	October 9, 1926

Proposed Pavement Illinois Route 31 Bypass Curve #4


P.I. = Sta. 174+59.45
 Δ = 80°38'27"
 R = 920.05'
 T = 780.83'
 L = 1294.93'
 E = 286.67'
 P.C. = Sta. 166+78.62
 P.T. = Sta. 179+73.55

SEE SHEET 22

LEGEND

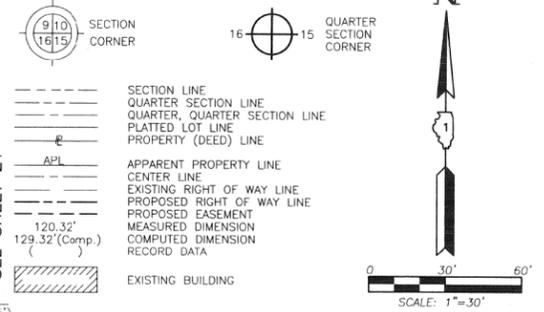

SCALE: 1"=30'

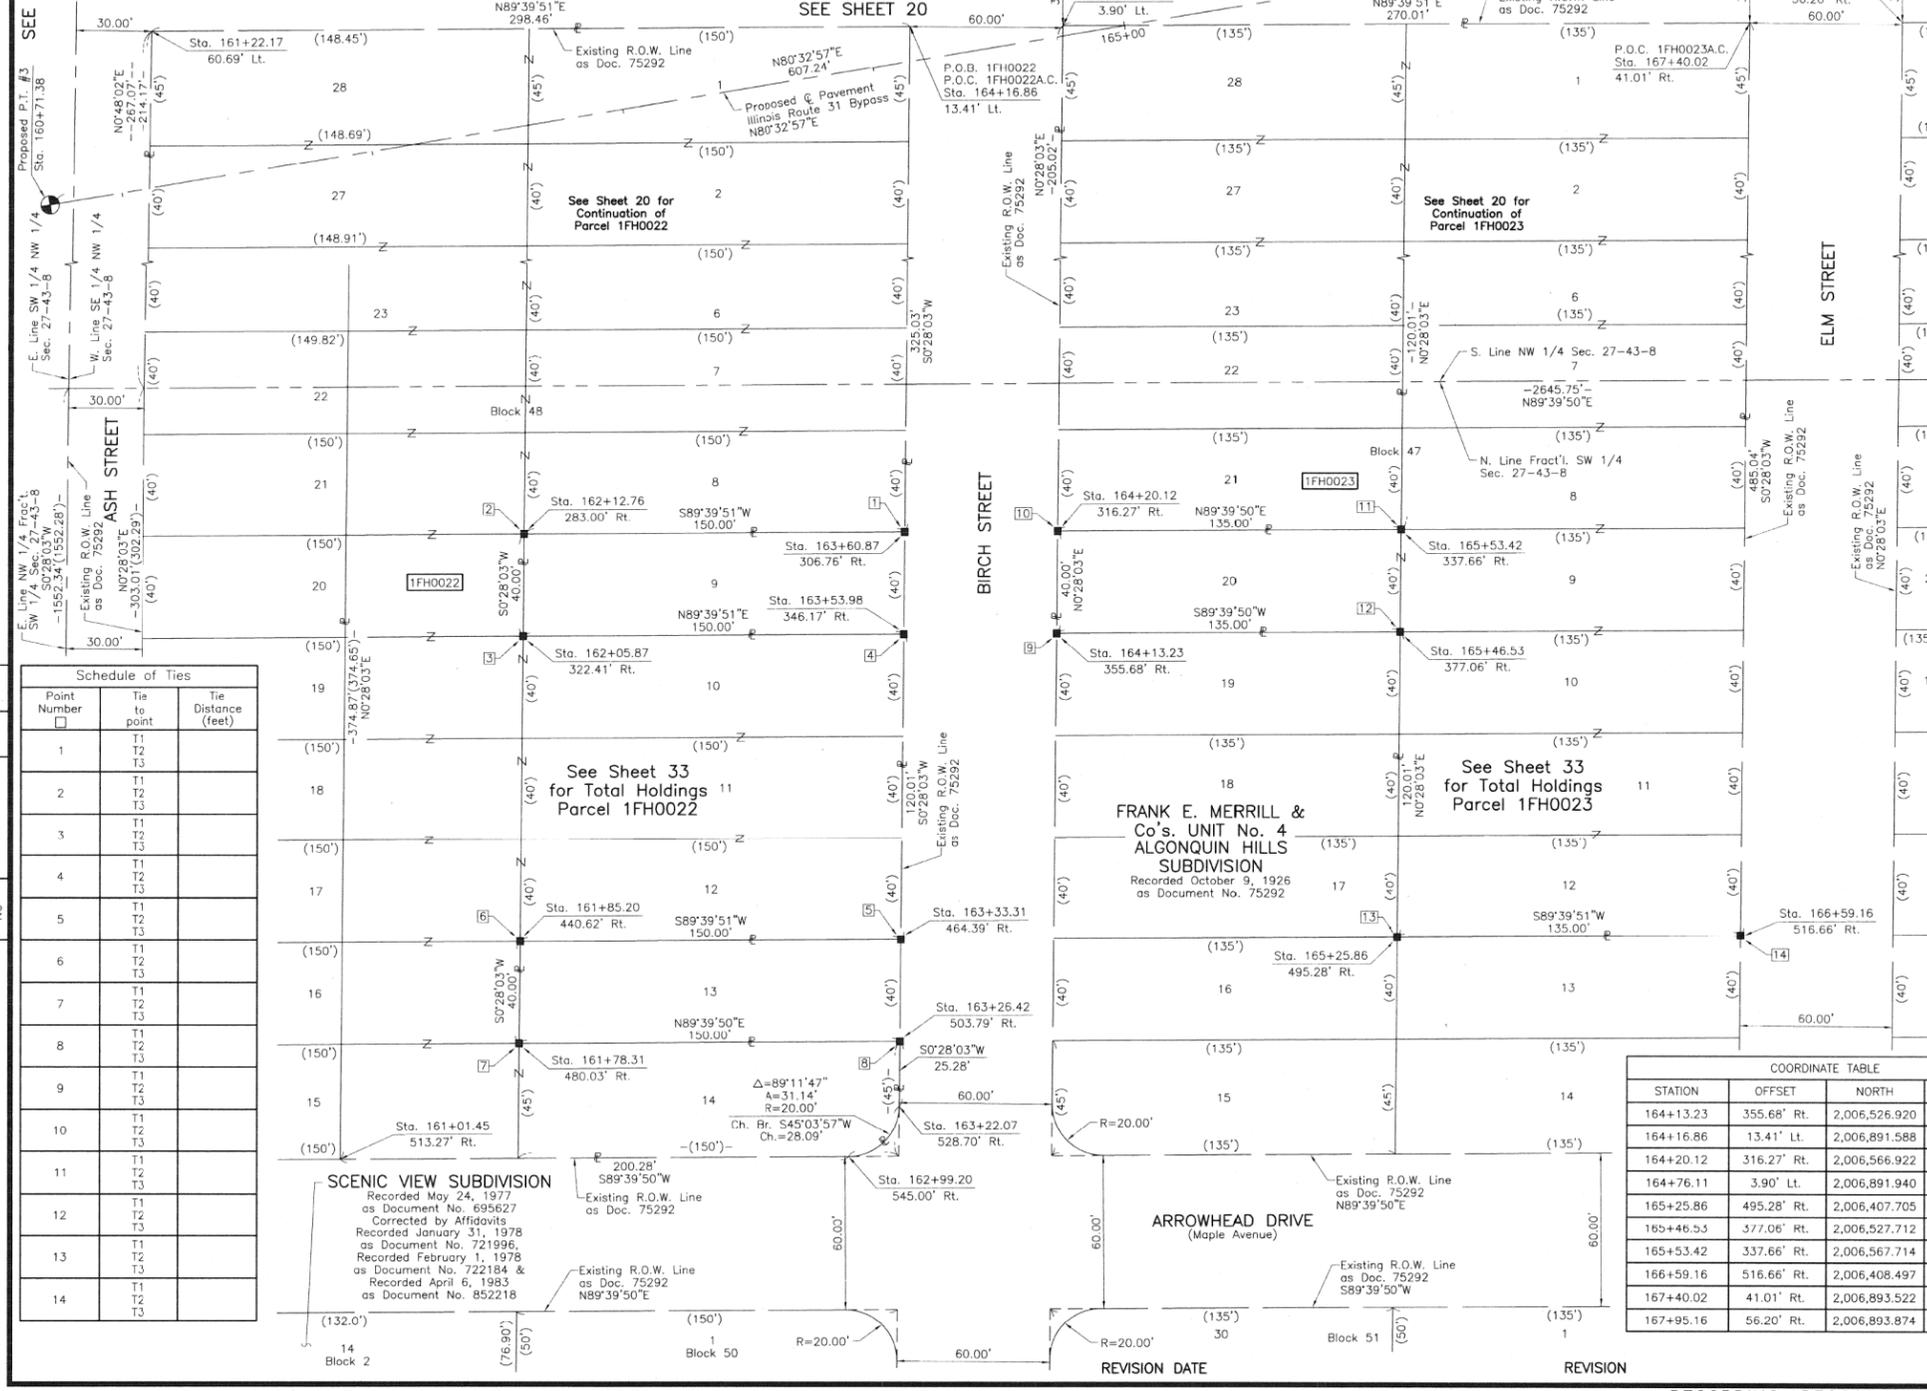

Point Number	Tie to point	Tie Distance (feet)
1	T1 T2 T3	
2	T1 T2 T3	
3	T1 T2 T3	
4	T1 T2 T3	
5	T1 T2 T3	
6	T1 T2 T3	
7	T1 T2 T3	
8	T1 T2 T3	
9	T1 T2 T3	
10	T1 T2 T3	
11	T1 T2 T3	
12	T1 T2 T3	
13	T1 T2 T3	
14	T1 T2 T3	

ROW PLAT	MADE	CHECKED	INKED	DATE	BY

Bearings are referenced to the Illinois Coordinate System NAD83 (1997) East Zone at Found Geodetic Survey Control Monuments "MCH31 1A", P.I.D. AJ2855 and "Algonquin", P.I.D. AJ2945.

IRON PIPE OR ROD FOUND \oplus "MAG" NAIL SET
 CUT CROSS FOUND OR SET \bullet 5/8" REBAR SET

THESE STAKES REFERENCE FOUND OR SET MONUMENTATION. SET 5/8 INCH IRON ROD FLUSH WITH GROUND TO THE FOUND IRON STAKE IDENTIFIED BY COLORED PLASTIC CAP BEARING SURVEYORS REGISTRATION NUMBER.

THESE STAKES, IN CULTIVATED AREAS, REFERENCE FOUND OR SET MONUMENTATION. BURIED 5/8 INCH IRON ROD 20 INCHES BELOW GROUND TO THE FOUND IRON STAKE IDENTIFIED BY COLORED PLASTIC CAP BEARING SURVEYORS REGISTRATION NUMBER.

STAKING OF PROPOSED RIGHT OF WAY. SET DIVISION OF HIGHWAYS SURVEY MARKER TO MONUMENT THE POSITION SHOWN, IDENTIFIED BY INSCRIPTION DATA AND SURVEYORS REGISTRATION NUMBER.

STAKING OF PROPOSED RIGHT OF WAY IN CULTIVATED AREAS. BURIED 5/8 INCH METAL ROD 20 INCHES BELOW GROUND TO MARK FUTURE SURVEY MARKER POSITION IDENTIFIED BY COLORED PLASTIC CAP BEARING SURVEYORS REGISTRATION NUMBER.

PERMANENT SURVEY MARKER, I.D.O.T STD 2135 (TO BE SET BY OTHERS)

RIGHT OF WAY STAKING PROPOSED TO BE SET.

RECEIVED *pk*
 FEB 22 2012

PLATS & LEGALS

THIS IS TO CERTIFY THAT WE, JORGENSEN & ASSOCIATES, INC., AN ILLINOIS PROFESSIONAL DESIGN FIRM, LAND SURVEYING CORPORATION, NUMBER 184-2771, HAVE SURVEYED THE PLAT OF HIGHWAYS SHOWN HEREON IN SECTION 27, TOWNSHIP 43N., RANGE 8E., OF THE THIRD PRINCIPAL MERIDIAN, McHENRY COUNTY, THAT THE SURVEY IS TRUE AND COMPLETE AS SHOWN TO THE BEST OF MY KNOWLEDGE AND BELIEF, THAT THE PLAT CORRECTLY REPRESENTS SAID SURVEY, THAT ALL MONUMENTS FOUND AND ESTABLISHED ARE OF PERMANENT QUALITY AND OCCUPY THE POSITIONS SHOWN THEREON AND THAT THE MONUMENTS ARE SUFFICIENT TO ENABLE THE SURVEY TO BE RE-TRACED. MADE FOR THE DEPARTMENT OF TRANSPORTATION, STATE OF ILLINOIS.

DATED AT LAKE VILLA, ILLINOIS THIS ____ DAY OF ____ 20__ A.D.

STATE OF ILLINOIS }
 COUNTY OF LAKE } SS

CHRISTIAN H. JORGENSEN
 2791
 PROFESSIONAL LAND SURVEYOR
 STATE OF ILLINOIS
 LAKE VILLA, ILLINOIS

PRESIDENT
 ILLINOIS PROFESSIONAL LAND SURVEYOR NO. 35-2797
 LICENSE EXPIRATION DATE: NOVEMBER 30, 2012
 THIS PROFESSIONAL SERVICE CONFORMS TO THE CURRENT ILLINOIS MINIMUM STANDARDS FOR A BOUNDARY SURVEY.
 COORDINATES ARE BASED ON THE PUBLISHED METRIC COORDINATE VALUES AT FOUND GEODETIC SURVEY CONTROL MONUMENT "MCH31 1A", P.I.D. AJ2855, OF N.613,205.182-E.303,895.917.
 NOTE: SURFACE COORDINATES ARE SHOWN.

COORDINATE TABLE			
STATION	OFFSET	NORTH	EAST
164+13.23	355.68' Rt.	2,006,526.920	995,977.188
164+16.86	13.41' Lt.	2,006,891.588	995,920.162
164+20.12	316.27' Rt.	2,006,566.922	995,977.514
164+76.11	3.90' Lt.	2,006,891.940	995,980.167
165+25.86	495.28' Rt.	2,006,407.705	996,111.211
165+46.53	377.06' Rt.	2,006,527.712	996,112.191
165+53.42	337.66' Rt.	2,006,567.714	996,112.517
166+59.16	516.66' Rt.	2,006,408.497	996,246.214
167+40.02	41.01' Rt.	2,006,893.522	996,250.172
167+95.16	56.20' Rt.	2,006,893.874	996,310.177

STATION	OFFSET	NORTH	EAST
161+01.45	513.27' Rt.	2,006,320.267	995,695.512
161+22.17	60.69' Lt.	2,006,889.840	995,621.710
161+78.31	480.03' Rt.	2,006,365.680	995,765.875
161+85.20	440.62' Rt.	2,006,405.682	995,766.202
162+05.87	322.41' Rt.	2,006,525.689	995,767.181
162+12.76	283.00' Rt.	2,006,565.691	995,767.508
162+99.20	545.00' Rt.	2,006,321.442	995,895.789
163+22.07	528.70' Rt.	2,006,341.278	995,915.671
163+26.42	503.79' Rt.	2,006,366.560	995,915.877
163+33.31	464.39' Rt.	2,006,406.562	995,916.204
163+53.98	346.17' Rt.	2,006,526.568	995,917.183
163+60.87	306.76' Rt.	2,006,566.570	995,917.510

JORGENSEN & ASSOCIATES, INC.
 120 PARK AVENUE
 LAKE VILLA, ILLINOIS 60046
 (815) 356-3371

SHEET 1 IS A COVER SHEET AND IS NOT RECORDED.

PLAT OF HIGHWAYS
 STATE OF ILLINOIS
 DEPARTMENT OF TRANSPORTATION
 F.A.P. 336 (ILLINOIS ROUTE 31 BYPASS)
 SECTION 96-00209-00-PV McHENRY COUNTY
 PROJECT JOB NO. R-91-022-03
 STATION 160+71.38 TO STATION 168+00
 SCALE: 1"=30' SHEET 20A OF 37

BUREAU OF LAND ACQUISITION
 201 WEST CENTER COURT
 SCHAUMBURG, ILLINOIS 60196

AS DOCUMENT NO.

FILE NAME = ...\\D160F72-sht-PH-26.dgn

USER NAME = akw
 PLOT SCALE = 70.0000' / in.
 PLOT DATE = 5/2/2012

DESIGNED -
 DRAWN - JORGENSEN & ASSOC.
 CHECKED - CJ
 DATE -

REVISED -
 REVISED -
 REVISED -
 REVISED -

STATE OF ILLINOIS
 DEPARTMENT OF TRANSPORTATION

PLAT OF HIGHWAYS
 SCALE: GRAPHIC SHEET NO. 26 OF 49 SHEETS STA. TO STA.

O.R. RTE.	SECTION	COUNTY	TOTAL SHEETS	SHEET NO.
0003	18A-2	McHENRY	825	435
CONTRACT NO. 60F72				
FED. ROAD DIST. NO. 1 ILLINOIS FED. AID PROJECT				

PART OF THE FRACTIONAL SW 1/4 AND PART OF THE NW 1/4 OF SEC. 27, TWP. 43 N., R. 8 E. OF THE 3RD. P.M., IN McHENRY COUNTY, ILLINOIS.

SEE SHEET 22

**Proposed @ Pavement
Illinois Route 31 Bypass
Curve #4**

P.I. = Sta. 174+59.45
Δ = 80°38'27"
R = 920.05'
T = 780.83'
L = 1294.93'
E = 286.67'
P.C. = Sta. 166+78.62
P.T. = Sta. 179+73.55

Proposed @ Pavement
Illinois Route 31 Bypass
R=920.05'
R=920.05'
-A=1294.93'

EXISTING R.O.W. RECORDED INFORMATION			
Parcel	Document No.	Date Recorded	
1FH0024	75292	October 9, 1926	
-----	75292	October 9, 1926	
-----	97R 037525	August 6, 1997	

See Sheet 22
for Parcel 1FH0021-B,
1FH0021T.E.-D & 1FH0021T.E.-H

PARCEL NUMBER	OWNER	TOTAL HOLDINGS ACRES	PART TAKEN ACRES	AREA IN EXISTING R.O.W. ACRES	REMAINDER AREA ACRES	EASEMENT AREA ACRES	EASEMENT PURPOSE	PERMANENT INDEX NUMBER	PROPERTY ACQUIRED BY
1FH0024	Chicago Title Land Trust Company, as successor trustee to Chicago Title and Trust Company under trust agreement dated the 17th day of July, 1968 and known as Trust Number 53278	2.634	2.634	N/A	0.000	N/A	N/A	19-27-178-001 19-27-178-002 19-27-328-001 19-27-328-002 19-27-328-003 19-27-328-005	

LEGEND

SECTION CORNER
QUARTER SECTION CORNER

SECTION LINE
QUARTER SECTION LINE
QUARTER, QUARTER SECTION LINE
PLATTED LOT LINE
PROPERTY (DEED) LINE

APL
APPARENT PROPERTY LINE
CENTER LINE
EXISTING RIGHT OF WAY LINE
PROPOSED RIGHT OF WAY LINE
PROPOSED EASEMENT
MEASURED DIMENSION
COMPUTED DIMENSION
RECORD DATA

EXISTING BUILDING

0 20' 40'
SCALE: 1"=20'

Bearings are referenced to the Illinois Coordinate System NAD83 (1997) East Zone at Found Geodetic Survey Control Monuments "MCH31 1A", P.I.D. AJ2855 and "Algonquin", P.I.D. AJ2945.

○ IRON PIPE OR ROD FOUND
+ CUT CROSS FOUND OR SET
● "MAG" NAIL SET
● 5/8" REBAR SET

● T1 THESE STAKES REFERENCE FOUND OR SET MONUMENTATION. SET 5/8 INCH IRON ROD FLUSH WITH GROUND TO THE FOUND IRON STAKE, IDENTIFIED BY COLORED PLASTIC CAP BEARING SURVEYORS REGISTRATION NUMBER.
● T2
● T3

● BT1 THESE STAKES, IN CULTIVATED AREAS, REFERENCE FOUND OR SET MONUMENTATION. BURIED 5/8 INCH IRON ROD 20 INCHES BELOW GROUND TO THE FOUND IRON STAKE, IDENTIFIED BY COLORED PLASTIC CAP BEARING SURVEYORS REGISTRATION NUMBER.
● BT2
● BT3

■ STAKING OF PROPOSED RIGHT OF WAY. SET DIVISION OF HIGHWAYS SURVEY MARKER TO MONUMENT THE POSITION SHOWN. IDENTIFIED BY INSCRIPTION DATA AND SURVEYORS REGISTRATION NUMBER.

■ M STAKING OF PROPOSED RIGHT OF WAY IN CULTIVATED AREAS. BURIED 5/8 INCH METAL ROD 20 INCHES BELOW GROUND TO MARK FUTURE SURVEY MARKER POSITION IDENTIFIED BY COLORED PLASTIC CAP BEARING SURVEYORS REGISTRATION NUMBER.

● PERMANENT SURVEY MARKER, I.D.O.T. STD 2135 (TO BE SET BY OTHERS)

□ RIGHT OF WAY STAKING PROPOSED TO BE SET.

STATE OF ILLINOIS }
COUNTY OF LAKE }SS


THIS IS TO CERTIFY THAT WE, JORGENSEN & ASSOCIATES, INC., AN ILLINOIS PROFESSIONAL DESIGN FIRM LAND SURVEYING CORPORATION, NUMBER 184-2771, HAVE SURVEYED THE PLAT OF HIGHWAYS SHOWN HEREON IN SECTION 27, TOWNSHIP 43N., RANGE 8E., OF THE THIRD PRINCIPAL MERIDIAN, McHENRY COUNTY, THAT THE SURVEY IS TRUE AND COMPLETE AS SHOWN TO THE BEST OF MY KNOWLEDGE AND BELIEF, THAT THE PLAT CORRECTLY REPRESENTS SAID SURVEY, THAT ALL MONUMENTS FOUND AND ESTABLISHED ARE OF PERMANENT QUALITY AND OCCUPY THE POSITIONS SHOWN THEREON AND THAT THE MONUMENTS ARE SUFFICIENT TO ENABLE THE SURVEY TO BE RETRACED, MADE FOR THE DEPARTMENT OF TRANSPORTATION, STATE OF ILLINOIS, DATED AT LAKE VILLA, ILLINOIS THIS ____ DAY OF ____ 20__ A.D.

ILLINOIS PROFESSIONAL LAND SURVEYOR NO. 35-2797
LICENSE EXPIRATION DATE: NOVEMBER 30, 2006
THIS PROFESSIONAL SERVICE CONFORMS TO THE CURRENT ILLINOIS MINIMUM STANDARDS FOR A BOUNDARY SURVEY.

COORDINATES ARE BASED ON THE PUBLISHED METRIC COORDINATE VALUES AT FOUND GEODETIC SURVEY CONTROL MONUMENT "MCH31 1A", P.I.D. AJ2855, OF N.613,205.182-E.303,895.917.
NOTE: SURFACE COORDINATES ARE SHOWN.

COORDINATE TABLE			
STATION	OFFSET	NORTH	EAST
167+40.02	41.01' Rt.	2,006,893.522	996,250.172
167+70.34	150.00' Rt.	2,006,796.107	996,309.379
167+95.16	56.20' Rt.	2,006,893.874	996,310.177
169+96.55	150.00' Rt.	2,006,895.293	996,552.350
170+17.24	163.73' Rt.	2,006,895.456	996,580.182
170+38.94	179.13' Rt.	2,006,895.632	996,610.184

ROW	DATE	BY
PLAT		
CHECKED		
IN		
NO		

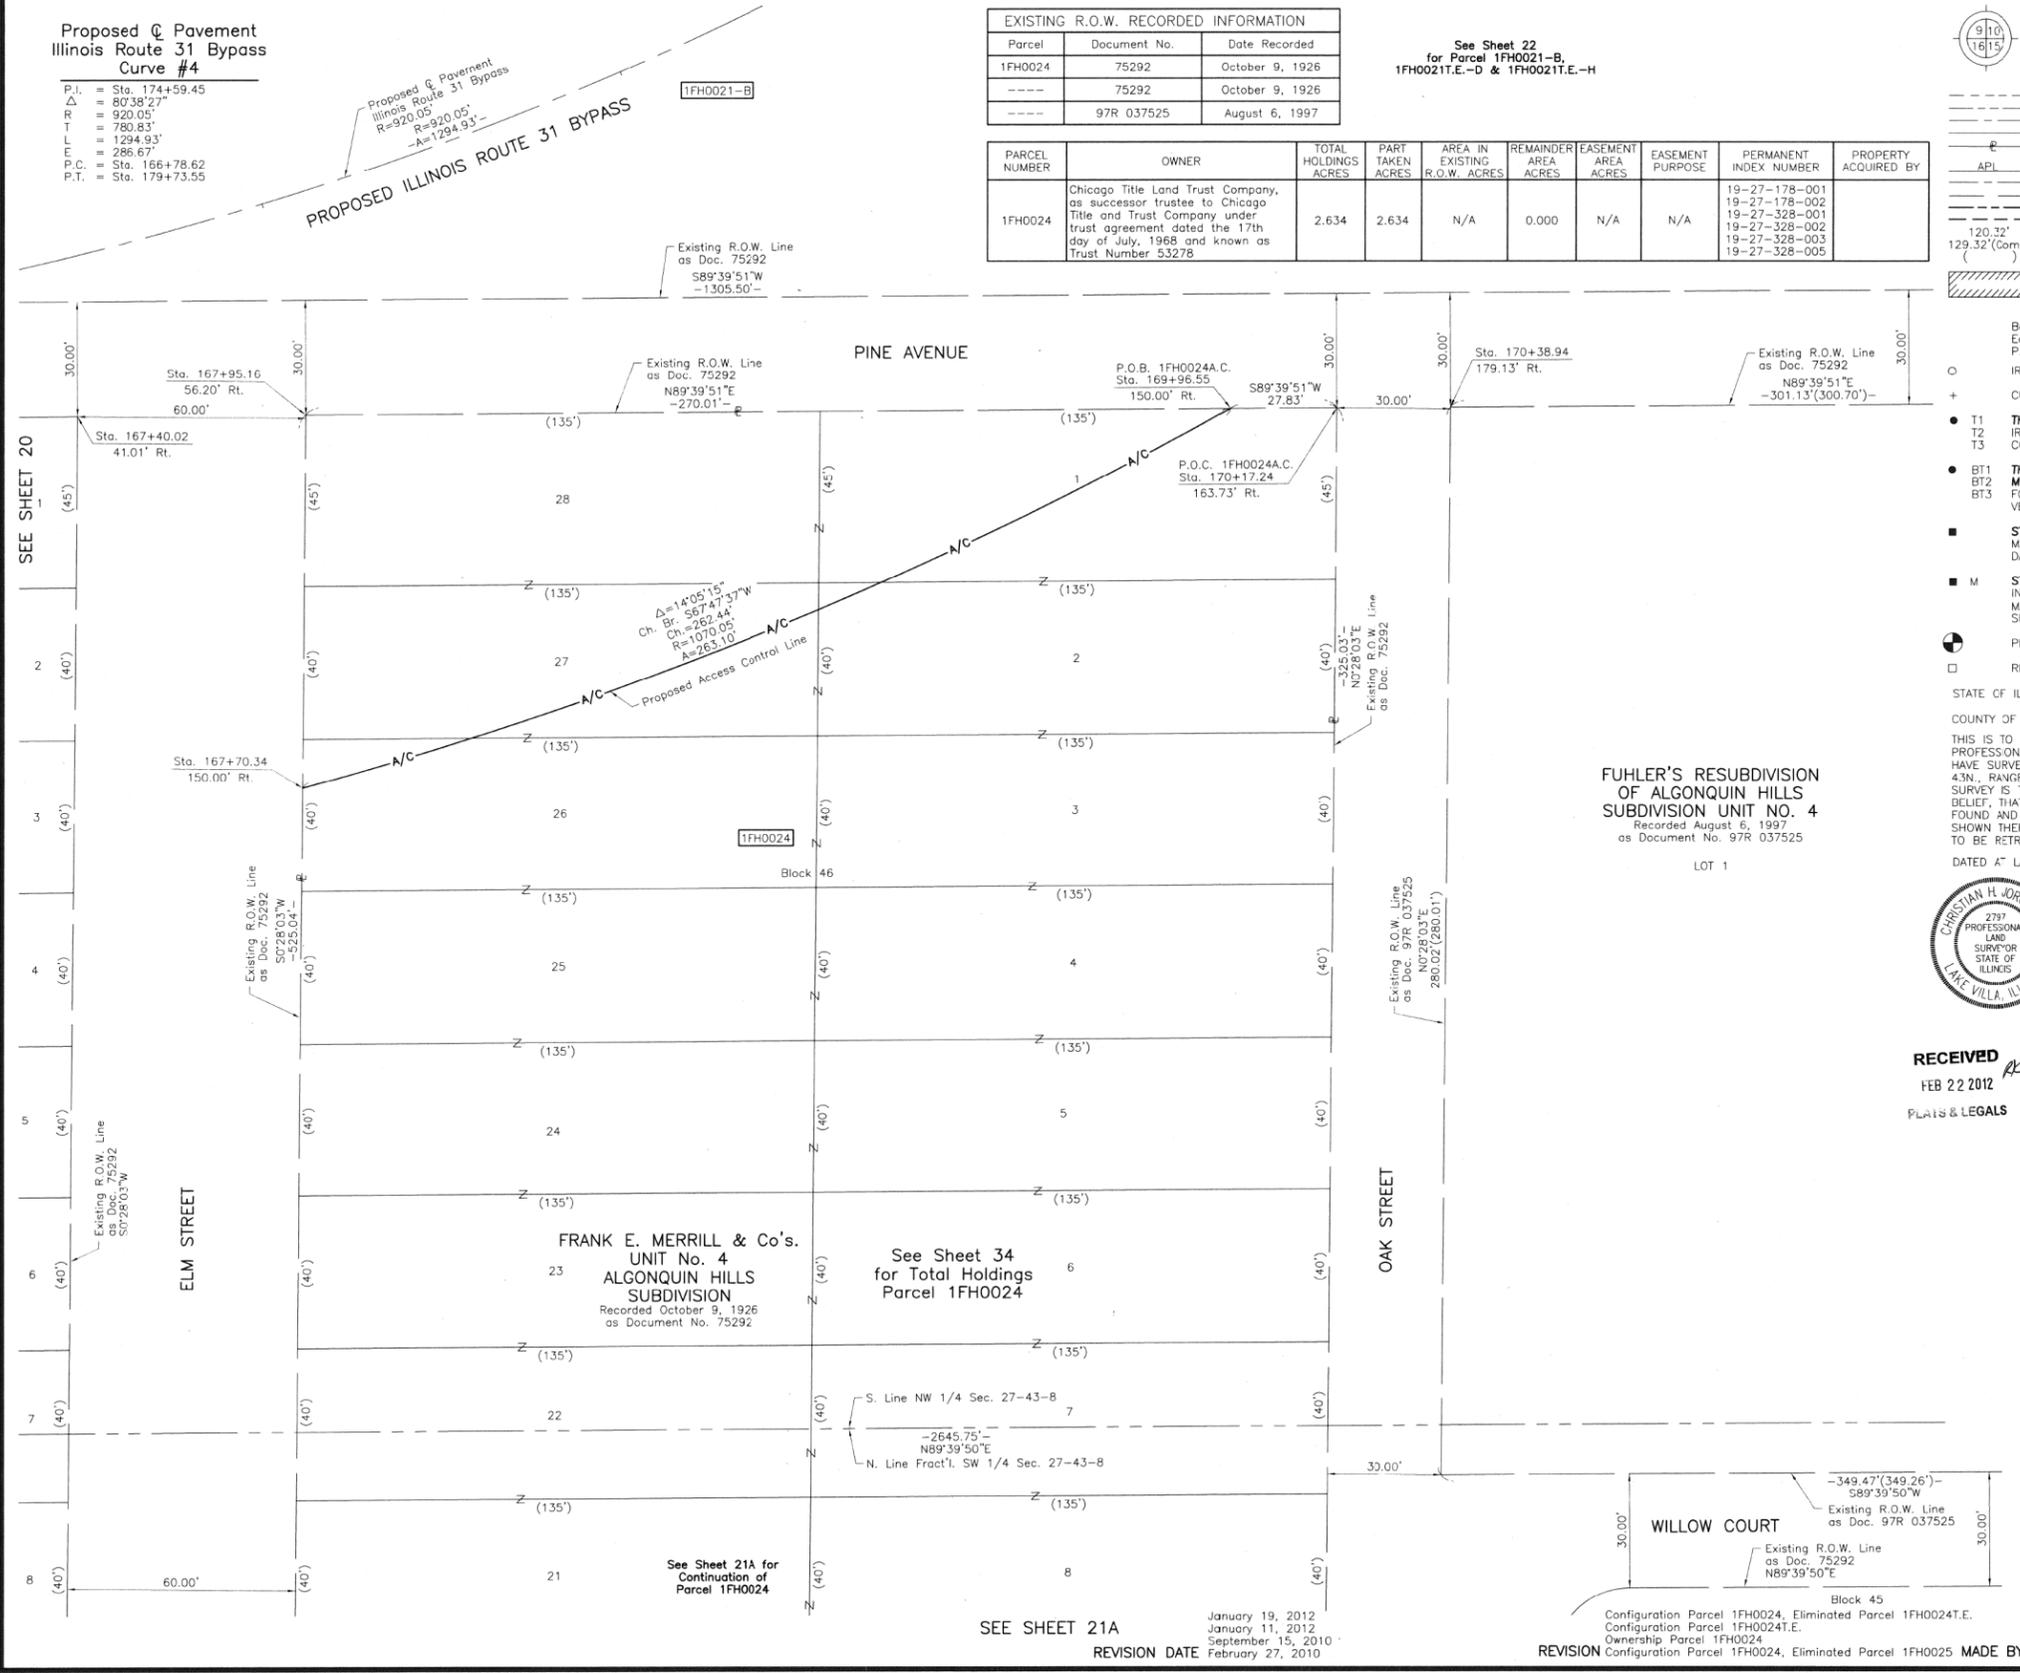

**FUHLER'S RESUBDIVISION
OF ALGONQUIN HILLS
SUBDIVISION UNIT NO. 4**
Recorded August 6, 1997
as Document No. 97R 037525

LOT 1



RECEIVED
FEB 22 2012
PLATS & LEGALS

JORGENSEN & ASSOCIATES, INC.
120 PARK AVENUE
LAKE VILLA, ILLINOIS 60046
(847) 356-3371

SHEET 1 IS A COVER SHEET AND IS NOT RECORDED.

**PLAT OF HIGHWAYS
STATE OF ILLINOIS
DEPARTMENT OF TRANSPORTATION**
F.A.P. 336 (ILLINOIS ROUTE 31 BYPASS)
SECTION 96-00209-00-PV McHENRY COUNTY
PROJECT JOB NO. R-91-022-03
STATION 167+00 TO STATION 170+00
SCALE: 1"=20' SHEET 21 OF 37

**BUREAU OF LAND ACQUISITION
201 WEST CENTER COURT
SCHAUMBURG, ILLINOIS 60196**

ROUTE F.A.P. 336 (ILLINOIS ROUTE 31 BYPASS) SECTION 96-00209-00-PV COUNTY McHENRY JOB NO. R-91-022-03 RECORDING: RECORDED ON AS DOCUMENT NO.

FILE NAME =
...\\D160F72-sht-PH-27.dgn

USER NAME =	DESIGNED -	REVISED -
okw	JORGENSEN & ASSOC.	
	CJ	

**STATE OF ILLINOIS
DEPARTMENT OF TRANSPORTATION**

PLAT OF HIGHWAYS

SCALE: GRAPHIC SHEET NO. 27 OF 49 SHEETS STA. TO STA.

O.R. RTE.	SECTION	COUNTY	TOTAL SHEETS	SHEET NO.
0003	18A-2	McHENRY	825	436
CONTRACT NO. 60F72				
FED. ROAD DIST. NO. 1 ILLINOIS FED. AID PROJECT				

PART OF THE NORTH 1/2 OF SEC. 27, TWP. 43 N., R. 8 E. OF THE 3RD. P.M., IN McHENRY COUNTY, ILLINOIS.

PARCEL NUMBER	OWNER	TOTAL HOLDINGS ACRES	PART TAKEN ACRES	AREA IN EXISTING R.O.W. ACRES	REMAINDER AREA ACRES	EASEMENT AREA ACRES	EASEMENT PURPOSE	PERMANENT INDEX NUMBER	PROPERTY ACQUIRED BY
1FH0021-A	Chicago Title Land Trust Company, as successor trustee to Chicago Title and Trust Company under trust agreement dated the 17th day of July, 1968 and known as Trust Number 53278	213.598	A=0.531 B=32.099 C=33.894	N/A	147.074	T.E.-B=1.414	Construction Purposes	19-27-126-004	
1FH0021-B									
1FH0021-C									
1FH0021-E-D									
1FH0021-E-E									
1FH0021-E-F									
1FH0021-E-G									

COORDINATE TABLE			
STATION	OFFSET	NORTH	EAST
164+76.11	3.90' Lt.	2,006,891.940	995,980.167
166+78.62	200.00' Lt.	2,007,118.629	996,147.731
166+78.62	210.00' Lt.	2,007,128.494	996,146.089
166+78.62	220.00' Lt.	2,007,138.358	996,144.447
167+40.02	41.01' Rt.	2,006,893.522	996,250.172
167+95.16	56.20' Rt.	2,006,893.874	996,310.177
168+47.73	220.00' Lt.	2,007,171.000	996,268.724
170+17.24	163.73' Rt.	2,006,895.456	996,580.182
170+38.94	179.13' Rt.	2,006,895.632	996,610.184

Schedule of Ties		
Point Number	Tie to point	Tie Distance (feet)
1	T1	60.18
	T2	28.28
	T3	50.96
2	T1	55.71
	T2	18.27
	T3	45.20
3	T1	287.48
	T2	250.20
	T3	216.29
4	T1	293.04
	T2	244.47
	T3	198.50
5	T1	128.15
	T2	11.25
	T3	127.43
6	T1	12.98
	T2	125.31
	T3	246.31
7	T1	16.35
	T2	136.60
	T3	258.85
8	T1	43.98
	T2	53.45
	T3	69.17
9	T1	16.79
	T2	38.25
	T3	59.31

Proposed Q Pavement Illinois Route 31 Bypass Curve #4

P.I. = Sta. 174+59.45
 Δ = 80°38'27"
 R = 920.05'
 T = 780.83'
 L = 1294.93'
 E = 286.67'
 P.C. = Sta. 166+78.62
 P.T. = Sta. 179+73.55

Proposed Q Pavement Quarry Access Curve #13

P.I. = Sta. 63+99.57
 Δ = 72°07'00"
 R = 112.01'
 T = 81.55'
 L = 140.98'
 E = 26.54'
 P.C. = Sta. 63+18.02
 P.T. = Sta. 64+59.00

COORDINATE TABLE			
STATION	OFFSET	NORTH	EAST
171+16.81	210.00' Lt.	2,007,259.896	996,454.232
171+16.81	235.00' Lt.	2,007,279.930	996,439.278
171+16.81	436.42' Lt.	2,007,441.341	996,318.794
171+16.81	460.39' Lt.	2,007,460.546	996,304.458
171+46.54	518.63' Lt.	2,007,515.148	996,279.883
172+51.90	531.40' Lt.	2,007,554.816	996,305.045
172+74.58	482.44' Lt.	2,007,528.033	996,347.267
174+27.14	100.00' Lt.	2,007,371.106	996,709.868
174+29.61	111.12' Lt.	2,007,379.118	996,701.856
174+31.95	235.00' Lt.	2,007,449.452	996,599.857
176+88.08	441.60' Lt.	2,007,683.557	996,485.334
177+45.58	482.62' Lt.	2,007,722.308	996,453.737
177+62.80	395.84' Lt.	2,007,710.699	996,540.204
177+63.43	0	2,007,622.047	996,925.994
177+93.97	69.76' Rt.	2,007,638.500	997,000.824
178+44.62	416.14' Lt.	2,007,759.328	996,528.579
178+50.52	69.77' Rt.	2,007,698.522	997,010.693
178+53.47	100.00' Lt.	2,007,723.487	996,842.746

EXISTING R.O.W. RECORDED INFORMATION			
Parcel	Document No.	Date Recorded	
1FH0021	75292	October 9, 1926	
1FH0021	484443	January 29, 1968	
----	73664	June 17, 1926	
----	75292	October 9, 1926	

REVISION DATE

1	February 20, 2012
2	January 19, 2012
3	January 16, 2012

FRANK E. MERRILL & Co's. UNIT No. 4 ALGONQUIN HILLS SUBDIVISION
 Recorded October 9, 1926 as Document No. 75292


SEE SHEET 21 September 14, 2010
 June 12, 2010
 REVISION DATE February 27, 2010

FRANK E. MERRILL & Co's. ALGONQUIN HILLS UNIT No. 1
 Recorded June 17, 1926 as Document No. 73664

FUHLER'S RESUBDIVISION OF ALGONQUIN HILLS SUBDIVISION UNIT No. 4
 Recorded August 6, 1997 as Document No. 97R 037525

SEE SHEET 24

LEGEND

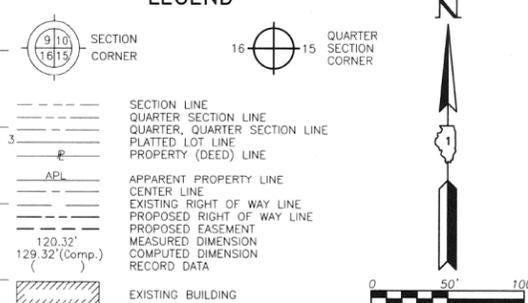

Bearings are referenced to the Illinois Coordinate System NAD83 (1997) East Zone of Found Geodetic Survey Control Monuments "MCH31 1A", P.I.D. AJ2855 and "Algonquin", P.I.D. AJ2945.

IRON PIPE OR ROD FOUND (MAG) NAIL SET
 CUT CROSS FOUND OR SET (5/8" REBAR SET)

THESE STAKES REFERENCE FOUND OR SET MONUMENTATION. SET 5/8 INCH IRON ROD FLUSH WITH GROUND TO THE FOUND IRON STAKE. IDENTIFIED BY COLORED PLASTIC CAP BEARING SURVEYORS REGISTRATION NUMBER.

THESE STAKES, IN CULTIVATED AREAS, REFERENCE FOUND OR SET MONUMENTATION. BURIED 5/8 INCH IRON ROD 20 INCHES BELOW GROUND TO THE FOUND IRON STAKE. IDENTIFIED BY COLORED PLASTIC CAP BEARING SURVEYORS REGISTRATION NUMBER.

STAKING OF PROPOSED RIGHT OF WAY. SET DIVISION OF HIGHWAYS SURVEY MARKER TO MONUMENT THE POSITION SHOWN. IDENTIFIED BY INSCRIPTION DATA AND SURVEYORS REGISTRATION NUMBER.

STAKING OF PROPOSED RIGHT OF WAY IN CULTIVATED AREAS. BURIED 5/8 INCH METAL ROD 20 INCHES BELOW GROUND TO MARK SURVEY MARKER POSITION IDENTIFIED BY COLORED PLASTIC CAP BEARING SURVEYORS REGISTRATION NUMBER.

PERMANENT SURVEY MARKER, I.D.O.T. STD 2135 (TO BE SET BY OTHERS)

RIGHT OF WAY STAKING PROPOSED TO BE SET.

STATE OF ILLINOIS }
 COUNTY OF LAKE } SS

THIS IS TO CERTIFY THAT WE, JORGENSEN & ASSOCIATES, INC., AN ILLINOIS PROFESSIONAL DESIGN FIRM LAND SURVEYING CORPORATION, NUMBER 184-2771, HAVE SURVEYED THE PLAT OF HIGHWAYS SHOWN HEREON IN SECTION 27, TOWNSHIP 43N, RANGE 8E, OF THE THIRD PRINCIPAL MERIDIAN, McHENRY COUNTY, THAT THE SURVEY IS TRUE AND COMPLETE AS SHOWN TO THE BEST OF MY KNOWLEDGE AND BELIEF, THAT THE PLAT CORRECTLY REPRESENTS SAID SURVEY, THAT ALL MONUMENTS FOUND AND ESTABLISHED ARE OF PERMANENT QUALITY AND OCCUPY THE POSITIONS SHOWN THEREON AND THAT THE MONUMENTS ARE SUFFICIENT TO ENABLE THE SURVEY TO BE RETRACED. MADE FOR THE DEPARTMENT OF TRANSPORTATION, STATE OF ILLINOIS.

DATED AT LAKE VILLA, ILLINOIS THIS _____ DAY OF _____ 20__ A.D.

ILLINOIS PROFESSIONAL LAND SURVEYOR NO. 35-2797
 LICENSE EXPIRATION DATE: NOVEMBER 30, 2006

THIS PROFESSIONAL SERVICE CONFORMS TO THE CURRENT ILLINOIS MINIMUM STANDARDS FOR A BOUNDARY SURVEY.

COORDINATES ARE BASED ON THE PUBLISHED METRIC COORDINATE VALUES AT FOUND GEODETIC SURVEY CONTROL MONUMENT "MCH31 1A", P.I.D. AJ2855, OF N.613,205.182-E.303,895.917.

NOTE: SURFACE COORDINATES ARE SHOWN.

COORDINATE TABLE

STATION	OFFSET	NORTH	EAST
56+01.82	111.75' Rt.	2,007,078.484	997,002.045
56+40.47	140.72' Rt.	2,007,138.484	997,001.914
56+41.52	11.71' Rt.	2,007,070.810	996,892.061
60+87.79	70.00' Rt.	2,007,432.721	996,588.365
62+95.75	70.00' Rt.	2,007,446.564	996,334.727
63+17.68	70.10' Rt.	2,007,439.633	996,313.587
64+59.03	70.00' Rt.	2,007,454.839	996,266.622
65+00.05	50.00' Rt.	2,007,476.296	996,226.342
65+00.05	70.00' Rt.	2,007,488.042	996,242.529
68+00.05	50.00' Rt.	2,007,719.105	996,050.149
68+00.05	95.00' Lt.	2,007,633.945	995,932.791
164+16.86	13.41' Lt.	2,006,891.588	995,920.162

JORGENSEN & ASSOCIATES, INC.
 120 PARK AVENUE
 LAKE VILLA, ILLINOIS 60046
 (847) 356-3371

SHEET 1 IS A COVER SHEET AND IS NOT RECORDED.

PLAT OF HIGHWAYS
 STATE OF ILLINOIS
 DEPARTMENT OF TRANSPORTATION
 F.A.P. 336 (ILLINOIS ROUTE 31 BYPASS)
 SECTION 96-00209-00-PV McHENRY COUNTY PROJECT
 JOB NO. R-91-022-03
 STATION 55+00 TO STATION 70+00.11
 STATION 163+00 TO STATION 163+00
 SCALE: 1"=50'
 SHEET 22 OF 37

BUREAU OF LAND ACQUISITION
 201 WEST CENTER COURT
 SCHAUMBURG, ILLINOIS 60196

RECEIVED FEB 22 2012 PLATS & LEGALS MADE BY



ROUTE F.A.P. 336 (ILLINOIS ROUTE 31 BYPASS) SECTION 96-00209-00-PV COUNTY McHENRY JOB NO. R-91-022-03 RECORDING: RECORDED ON AS DOCUMENT NO.

FILE NAME = ...\\D160F72-sht-PH-29.dgn	USER NAME = akw	DESIGNED -	REVISED -	STATE OF ILLINOIS DEPARTMENT OF TRANSPORTATION	PLAT OF HIGHWAYS	O.R. RTE.	SECTION	COUNTY	TOTAL SHEETS	SHEET NO.
		DRAWN - JORGENSEN & ASSOC.	REVISED -			0003	18A-2	McHENRY	825	438
		CHECKED - CJ	REVISED -			CONTRACT NO. 60F72				
		DATE -	REVISED -			FED. ROAD DIST. NO. 1 ILLINOIS FED. AID PROJECT				

SCALE: GRAPHIC SHEET NO. 29 OF 49 SHEETS STA. TO STA.

PART OF THE NORTH 1/2 OF SEC. 27, TWP. 43 N., R. 8 E. OF THE 3RD. P.M., IN McHENRY COUNTY, ILLINOIS.

LEGEND

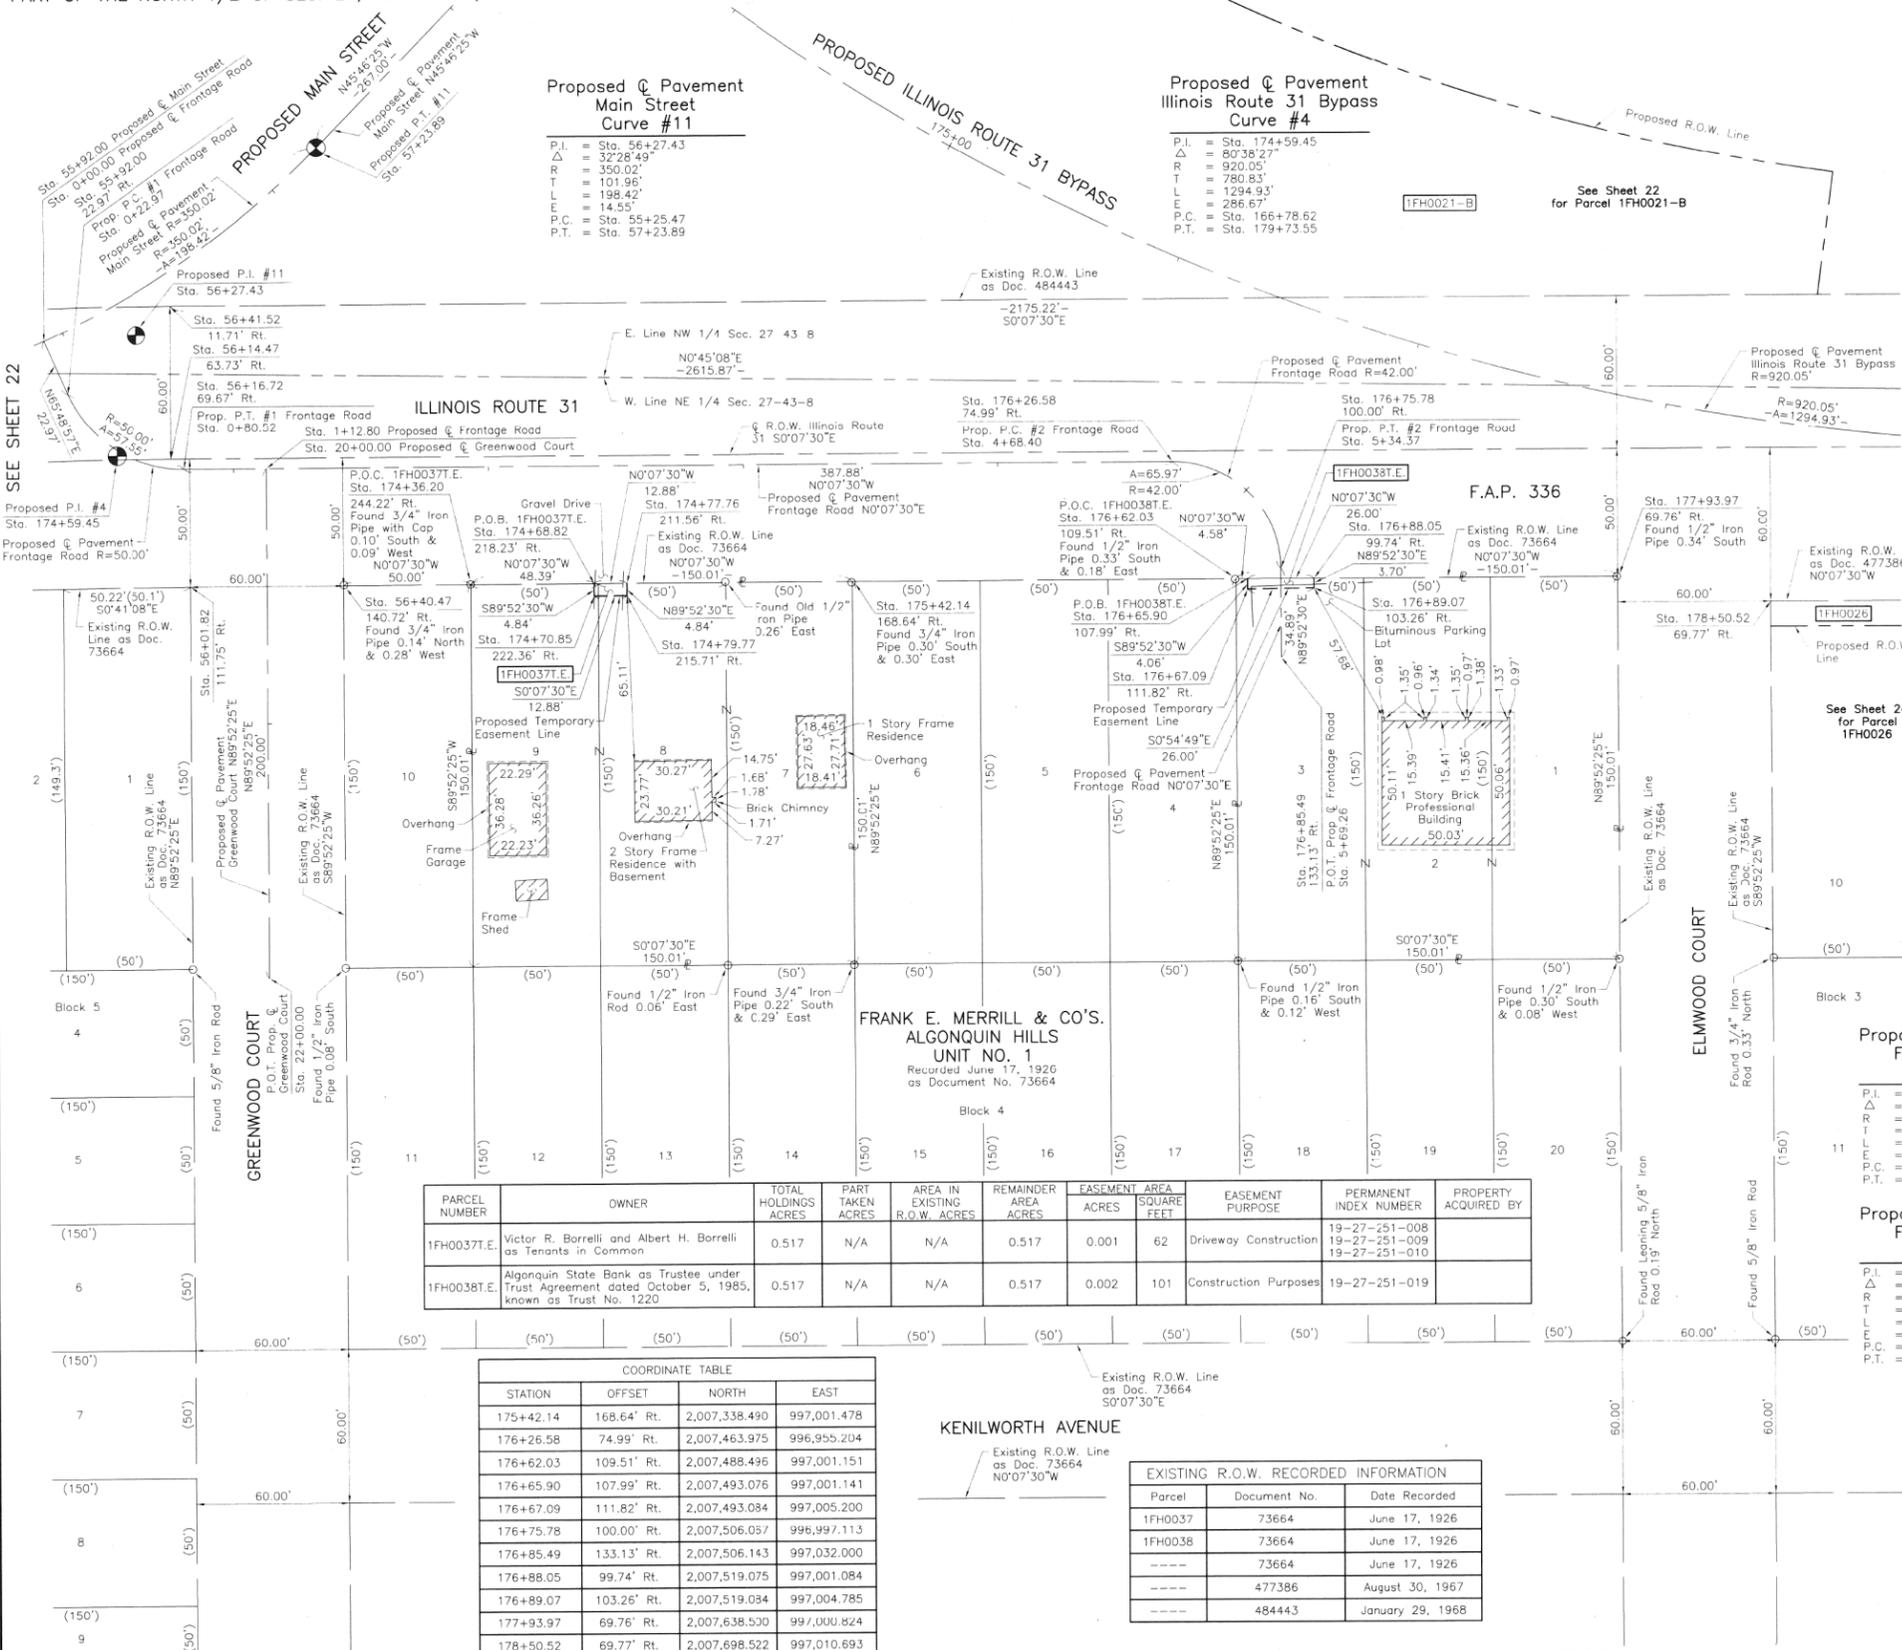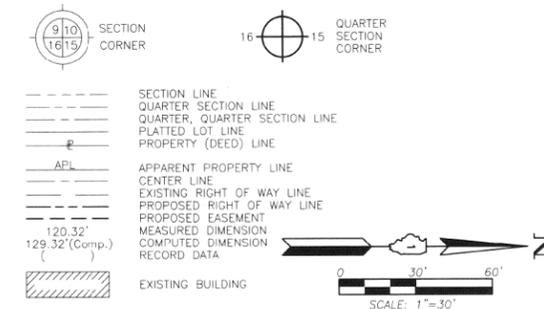

Bearings are referenced to the Illinois Coordinate System NAD83 (1997) East Zone at 1 second Geodetic Survey Control Monuments "MCH31 1A", P.I.D. AJ2855 and "Algonquin", P.I.D. AJ2945.

THESE STAKES REFERENCE FOUND OR SET MONUMENTATION. SET 5/8 INCH IRON ROD FLUSH WITH GROUND TO THE FOUND IRON STAKE. IDENTIFIED BY COLORED PLASTIC CAP BEARING SURVEYORS REGISTRATION NUMBER.

THESE STAKES, IN CULTIVATED AREAS, REFERENCE FOUND OR SET MONUMENTATION. BURIED 5/8 INCH IRON ROD 20 INCHES BELOW GROUND TO THE FOUND IRON STAKE. IDENTIFIED BY COLORED PLASTIC CAP BEARING SURVEYORS REGISTRATION NUMBER.

STAKING OF PROPOSED RIGHT OF WAY. SET DIVISION OF HIGHWAYS SURVEY MARKER TO MONUMENT THE POSITION SHOWN. IDENTIFIED BY INSCRIPTION DATA AND SURVEYORS REGISTRATION NUMBER.

STAKING OF PROPOSED RIGHT OF WAY IN CULTIVATED AREAS. BURIED 5/8 INCH METAL ROD 20 INCHES BELOW GROUND TO MARK FUTURE SURVEY MARKER POSITION IDENTIFIED BY COLORED PLASTIC CAP BEARING SURVEYORS REGISTRATION NUMBER.

PERMANENT SURVEY MARKER, I.D.O.I STD 2135 (TO BE SET BY OTHERS)

RIGHT OF WAY STAKING POSITION TO BE SET.

STATE OF ILLINOIS } SS
COUNTY OF LAKE

THIS IS TO CERTIFY THAT WE, JORGENSEN & ASSOCIATES, INC., AN ILLINOIS PROFESSIONAL DESIGN FIRM LAND SURVEYING CORPORATION, NUMBER 184-2771, HAVE SURVEYED THE PLAT OF HIGHWAYS SHOWN HEREON IN SECTION 27, TOWNSHIP 43N., RANGE 8E., OF THE THIRD PRINCIPAL MERIDIAN, McHENRY COUNTY, THAT THE SURVEY IS TRUE AND COMPLETE AS SHOWN TO THE BEST OF MY KNOWLEDGE AND BELIEF, THAT THE PLAT CORRECTLY REPRESENTS SAID SURVEY, THAT ALL MONUMENTS FOUND AND ESTABLISHED ARE OF PERMANENT QUALITY AND OCCUPY THE POSITIONS SHOWN THEREON AND THAT THE MONUMENTS ARE SUFFICIENT TO ENABLE THE SURVEY TO BE RETRACED. MADE FOR THE DEPARTMENT OF TRANSPORTATION, STATE OF ILLINOIS.

DATED AT LAKE VILLA, ILLINOIS THIS 23RD DAY OF MARCH 2012.

CHRISTIAN H. JORGENSEN
2797 PROFESSIONAL LAND SURVEYOR
STATE OF ILLINOIS
LAKE VILLA, ILLINOIS
PRESIDENT
ILLINOIS PROFESSIONAL LAND SURVEYOR NO. 35-2797
LICENSE EXPIRATION DATE: NOVEMBER 30, 2010
THIS PROFESSIONAL SERVICE CONFORMS TO THE CURRENT ILLINOIS MINIMUM STANDARDS FOR A BOUNDARY SURVEY.
COORDINATES ARE BASED ON THE PUBLISHED METRIC COORDINATE VALUE AT FOUND GEODETIC SURVEY CONTROL MONUMENT "MCH31 1A", P.I.D. AJ2855, OF N.613,205.182-E.303,895.917.
NOTE: SURFACE COORDINATES ARE SHOWN.

Proposed Pavement Frontage Road Curve #1

STATION	OFFSET	NORTH	EAST
55+92.00	0	2,007,020.963	996,905.577
55+92.00	22.97' Rt.	2,007,030.374	996,926.533
56+01.82	111.75' Rt.	2,007,078.484	997,002.045
56+14.47	63.73' Rt.	2,007,070.939	996,952.061
56+16.72	69.67' Rt.	2,007,076.094	996,956.050
56+40.47	140.72' Rt.	2,007,138.484	997,001.914
56+41.52	11.71' Rt.	2,007,070.810	996,892.061
174+36.20	244.22' Rt.	2,007,188.485	997,001.805
174+68.82	218.23' Rt.	2,007,236.875	997,001.699
174+70.85	222.36' Rt.	2,007,236.885	997,006.539
174+77.76	211.56' Rt.	2,007,249.759	997,001.671
174+79.77	215.71' Rt.	2,007,249.770	997,006.511

Proposed Pavement Frontage Road Curve #2

STATION	OFFSET	NORTH	EAST
174+36.20	244.22' Rt.	2,007,188.485	997,001.805
174+68.82	218.23' Rt.	2,007,236.875	997,001.699
174+70.85	222.36' Rt.	2,007,236.885	997,006.539
174+77.76	211.56' Rt.	2,007,249.759	997,001.671
174+79.77	215.71' Rt.	2,007,249.770	997,006.511

ROW PLAT	MADE	CHECKED	INKED	NO.
1				
2				
3				
4				
5				
6				
7				
8				
9				

PARCEL NUMBER	OWNER	TOTAL HOLDINGS ACRES	PART TAKEN ACRES	AREA IN EXISTING R.O.W. ACRES	REMAINDER AREA ACRES	EASEMENT AREA ACRES	SQUARE FEET	EASEMENT PURPOSE	PERMANENT INDEX NUMBER	PROPERTY ACQUIRED BY
1FH0037T.E	Victor R. Borrelli and Albert H. Borrelli as Tenants in Common	0.517	N/A	N/A	0.517	0.001	62	Driveway Construction	19-27-251-008 19-27-251-009 19-27-251-010	
1FH0038T.E	Algonquin State Bank as Trustee under Trust Agreement dated October 5, 1985, known as Trust No. 1220	0.517	N/A	N/A	0.517	0.002	101	Construction Purposes	19-27-251-019	

COORDINATE TABLE

STATION	OFFSET	NORTH	EAST
175+42.14	168.64' Rt.	2,007,338.490	997,001.478
176+26.58	74.99' Rt.	2,007,463.975	996,955.204
176+62.03	109.51' Rt.	2,007,488.496	997,001.151
176+65.90	107.99' Rt.	2,007,493.076	997,001.141
176+67.09	111.82' Rt.	2,007,493.084	997,005.200
176+75.78	100.00' Rt.	2,007,506.057	996,997.113
176+85.49	133.13' Rt.	2,007,506.143	997,032.000
176+88.05	99.74' Rt.	2,007,519.075	997,001.084
176+89.07	103.26' Rt.	2,007,519.084	997,004.785
177+93.97	69.76' Rt.	2,007,638.530	997,000.824
178+50.52	69.77' Rt.	2,007,698.522	997,010.693

EXISTING R.O.W. RECORDED INFORMATION

Parcel	Document No.	Date Recorded
1FH0037	73664	June 17, 1926
1FH0038	73664	June 17, 1926
----	73664	June 17, 1926
----	477386	August 30, 1967
----	484443	January 29, 1968

ROUTE F.A.P. 336 (ILLINOIS ROUTE 31 BYPASS) SECTION 96-00209-00-PV COUNTY McHENRY JOB NO. R-91-022-03 RECORDING: RECORDED ON AS DOCUMENT NO.

FILE NAME = ...\\D160F72-sht-30-00.dgn	USER NAME = akw	DESIGNED -	REVISED -	STATE OF ILLINOIS DEPARTMENT OF TRANSPORTATION	PLAT OF HIGHWAYS	SCALE: GRAPHIC SHEET NO. 30 OF 49 SHEETS STA. TO STA.	RECEIVED MAR 21 2012 PLATS & LEGALS	MADE BY	SHEET 1 IS A COVER SHEET AND IS NOT RECORDED.	BUREAU OF LAND ACQUISITION 201 WEST CENTER COURT SCHAUMBURG, ILLINOIS 60196	CONTRACT NO. 60F72
		DRAWN - JORGENSEN & ASSOC.	REVISED -								
		CHECKED - CJ	REVISED -								
		DATE -	REVISED -								

PART OF THE NORTH 1/2 OF SEC. 27, TWP. 43 N., R. 8 E. OF THE 3RD. P.M., IN McHENRY COUNTY, ILLINOIS.

Schedule of Ties		
Point Number	Tie to point	Tie Distance (feet)
1	T1	14.07
	T2	18.28
	T3	23.36

PARCEL NUMBER	OWNER	TOTAL HOLDINGS ACRES	PART TAKEN ACRES	AREA IN EXISTING R.O.W. ACRES	REMAINDER AREA ACRES	EASEMENT AREA ACRES	EASEMENT PURPOSE	PERMANENT INDEX NUMBER	PROPERTY ACQUIRED BY
1FH0028 1FH0028T.E	David Hinz	0.804	0.029	N/A	0.775	0.028	Construction Purposes	19-27-205-005 19-27-205-006 19-27-205-020	

LEGEND

SECTION CORNER 9 10 15 16 QUARTER SECTION CORNER

SECTION LINE
QUARTER SECTION LINE
PLATTED LOT LINE
PROPERTY (DEED) LINE

APL APPARENT PROPERTY LINE
CENTER LINE
EXISTING RIGHT OF WAY LINE
PROPOSED RIGHT OF WAY LINE
PROPOSED EASEMENT
MEASURED DIMENSION
COMPUTED DIMENSION
RECORD DATA

EXISTING BUILDING

Scale: 1"=20'

Bearings are referenced to the Illinois Coordinate System NAD83 (1997) East Zone at Found Geodetic Survey Control Monuments "MCH31 1A", P.D. AJ2855 and "Algonquin", P.I.D. AJ2945.

IRON PIPE OR ROD FOUND
"MAG" NAIL SET
CUT CROSS FOUND OR SET
5/8" REBAR SET

THESE STAKES REFERENCE FOUND OR SET MONUMENTATION. SET 5/8 INCH IRON ROD FLUSH WITH GROUND TO TIE FOUND IRON STAKE, IDENTIFIED BY COLORED PLASTIC CAP BEARING SURVEYORS REGISTRATION NUMBER.

THESE STAKES, IN CULTIVATED AREAS, REFERENCE FOUND OR SET MONUMENTATION. BURIED 5/8 INCH IRON ROD 20 INCHES BELOW GROUND TO TIE FOUND IRON STAKE, IDENTIFIED BY COLORED PLASTIC CAP BEARING SURVEYORS REGISTRATION NUMBER.

STAKING OF PROPOSED RIGHT OF WAY. SET DIVISION OF HIGHWAYS SURVEY MARKER TO MONUMENT THE POSITION SHOWN, IDENTIFIED BY INSCRIPTION DATA AND SURVEYORS REGISTRATION NUMBER.

STAKING OF PROPOSED RIGHT OF WAY IN CULTIVATED AREAS. BURIED 5/8 INCH IRON ROD 20 INCHES BELOW GROUND TO MARK FUTURE SURVEY MARKER POSITION IDENTIFIED BY COLORED PLASTIC CAP BEARING SURVEYORS REGISTRATION NUMBER.

PERMANENT SURVEY MARKER, I.D.O.T STD 2135 (TO BE SET BY OTHERS)

RIGHT OF WAY STAKING PROPOSED TO BE SET.

STATE OF ILLINOIS }
COUNTY OF LAKE } SS

THIS IS TO CERTIFY THAT WE, JORGENSEN & ASSOCIATES, INC., AN ILLINOIS PROFESSIONAL DESIGN FIRM LAND SURVEYING CORPORATION, NUMBER 184-2771, HAVE SURVEYED THE PLAT OF HIGHWAYS SHOWN HEREON IN SECTION 27, TOWNSHIP 43N., RANGE 8E., OF THE THIRD PRINCIPAL MERIDIAN, McHENRY COUNTY, THAT THE SURVEY IS TRUE AND COMPLETE AS SHOWN TO THE BEST OF MY KNOWLEDGE AND BELIEF, THAT THE PLAT CORRECTLY REPRESENTS SAID SURVEY, THAT ALL MONUMENTS FOUND AND ESTABLISHED ARE OF PERMANENT QUALITY AND OCCUPY THE POSITIONS SHOWN THEREON AND THAT THE MONUMENTS ARE SUFFICIENT TO ENABLE THE SURVEY TO BE RETRACED. MADE FOR THE DEPARTMENT OF TRANSPORTATION, STATE OF ILLINOIS. DATED AT LAKE VILLA, ILLINOIS THIS 12th DAY OF May 20, 2010 A.D.


CHRISTIAN H. JORGENSEN, PRESIDENT
2797 PROFESSIONAL LAND SURVEYOR STATE OF ILLINOIS
LICENSE EXPIRATION DATE: NOVEMBER 30, 2006
THIS PROFESSIONAL SERVICE CONFORMS TO THE CURRENT ILLINOIS MINIMUM STANDARDS FOR A BOUNDARY SURVEY.

COORDINATE TABLE

STATION	OFFSET	NORTH	EAST
206+49.42	60.64' Rt.	2,008,198.539	997,009.603
207+09.42	60.61' Rt.	2,008,258.539	997,009.472
207+09.42	65.61' Rt.	2,008,258.550	997,014.472
207+09.42	70.61' Rt.	2,008,258.561	997,019.472
207+68.14	69.57' Rt.	2,008,317.276	997,018.344
207+68.14	70.57' Rt.	2,008,317.278	997,019.344
208+00.37	69.55' Rt.	2,008,349.507	997,018.274
208+00.37	70.55' Rt.	2,008,349.509	997,019.274
209+59.43	60.46' Rt.	2,008,508.548	997,008.927
209+59.43	65.46' Rt.	2,008,508.558	997,013.927
209+59.43	70.46' Rt.	2,008,508.570	997,018.927

JORGENSEN & ASSOCIATES, INC.
120 PARK AVENUE LAKE VILLA, ILLINOIS 60046 (847) 356-3371

SHEET 1 IS A COVER SHEET AND IS NOT RECORDED.

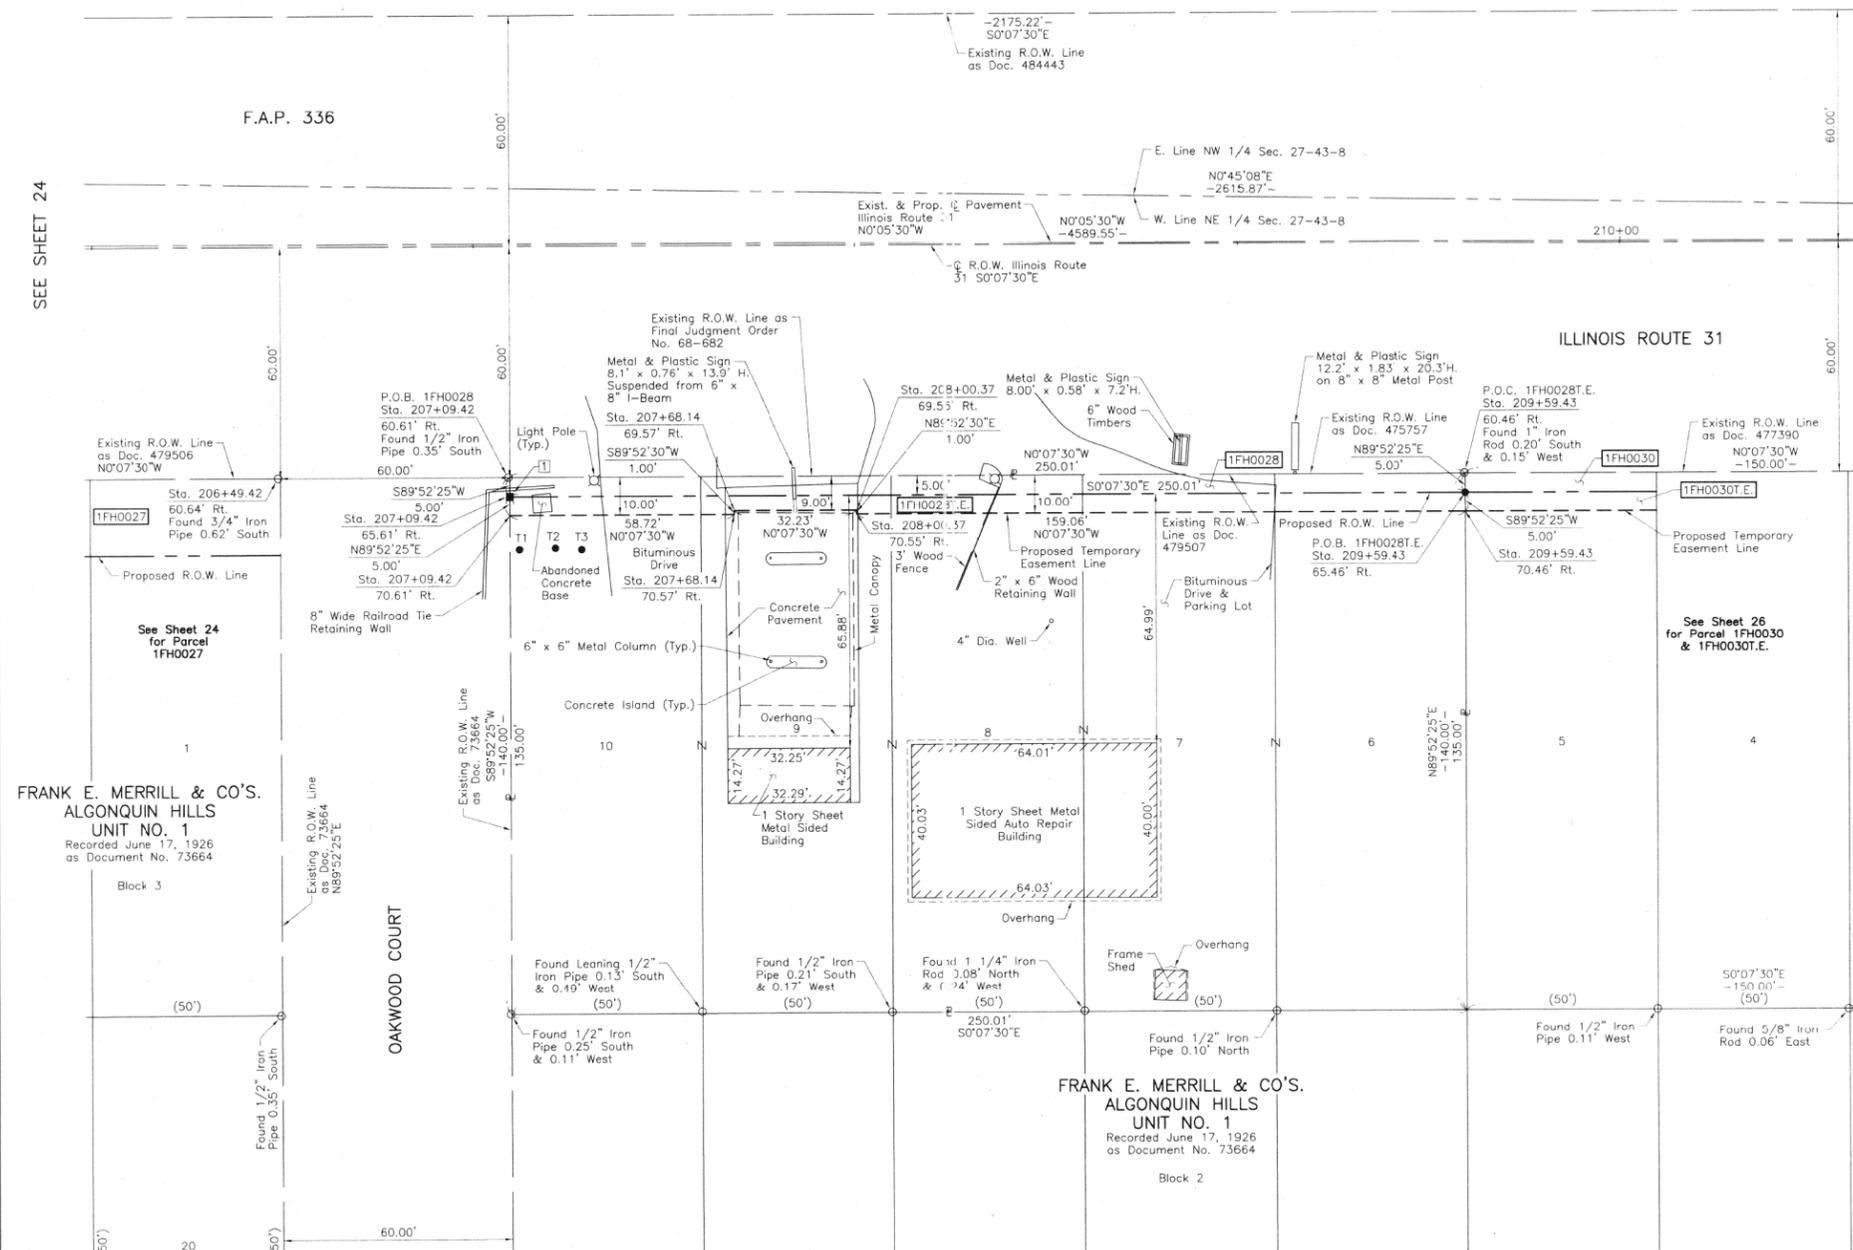

FRANK E. MERRILL & CO'S.
ALGONQUIN HILLS
UNIT NO. 1
Recorded June 17, 1926
as Document No. 73664

FRANK E. MERRILL & CO'S.
ALGONQUIN HILLS
UNIT NO. 1
Recorded June 17, 1926
as Document No. 73664

EXISTING R.O.W. RECORDED INFORMATION

Parcel	Document No.	Date Recorded
1FH0028	73664	June 17, 1926
1FH0028	475757	July 26, 1967
1FH0028	479507	October 11, 1967
1FH0028	68-682	June 3, 1976*
----	73664	June 17, 1926
----	477390	August 30, 1967
----	479506	October 11, 1967
----	484443	January 29, 1968

* Date Filed

DATE	BY

DATE	BY

ROUTE F.A.P. 336 (ILLINOIS ROUTE 31 BYPASS) SECTION 96-00209-00-PV COUNTY McHENRY JOB NO. R-91-022-03 REVISION DATE September 11, 2008 REVISION Configuration Parcel 1FH0028 Combined Parcels 1FH0028 & 1FH0029 RECORDING: RECORDED ON AS DOCUMENT NO.

FILE NAME = ...\\D160F72-sht-PH-32.dgn	USER NAME = akw	DESIGNED -	REVISED -	STATE OF ILLINOIS DEPARTMENT OF TRANSPORTATION	PLAT OF HIGHWAYS	SCALE: GRAPHIC SHEET NO. 32 OF 49 SHEETS STA. TO STA.	O.R. RTE.	SECTION	COUNTY	TOTAL SHEETS	SHEET NO.
		DRAWN - JORGENSEN & ASSOC.	REVISED -				0003	18A-2	McHENRY	825	441
		CHECKED - CJ	REVISED -				CONTRACT NO. 60F72				
		PLOT SCALE = 70.0000' / in.	REVISOR -				FED. ROAD DIST. NO. 1 ILLINOIS FED. AID PROJECT				
		PLOT DATE = 5/2/2012	DATE -								


PART OF THE SOUTH 1/2 OF SEC. 22 AND PART OF THE NORTH 1/2 OF SEC. 27, TWP. 43 N., R. 8 E. OF THE 3RD. P.M., IN McHENRY COUNTY, ILLINOIS.

PARCEL NUMBER	OWNER	TOTAL HOLDINGS ACRES	PART TAKEN ACRES	AREA IN EXISTING R.O.W. ACRES	REMAINDER AREA ACRES	EASEMENT AREA ACRES	EASEMENT PURPOSE	PERMANENT INDEX NUMBER	PROPERTY ACQUIRED BY
1FH0021-A 1FH0021-B 1FH0021-C 1FH0021E.-B 1FH0021E.-D 1FH0021E.-E 1FH0021E.-F 1FH0021E.-G 1FH0021E.-H	Chicago Title Land Trust Company, as successor trustee to Chicago Title and Trust Company under trust agreement dated the 17th day of July, 1968 and known as Trust Number 53278	213.598	A=0.531 B=32.099 C=33.894	N/A	147.074	T.E.-B=1.414 T.E.-D=2.981 T.E.-E=0.129 T.E.-F=0.743 T.E.-G=10.056 T.E.-H=0.470	Construction Purposes Grading Grading Grading	19-27-126-004 19-27-351-002 19-27-351-014 19-28-200-025 19-28-426-011	
1FH0033	Bryan Syens	0.161	0.023	N/A	0.138	N/A	N/A	19-27-201-009	
1FH0039	Andrzej Pierzynski and Daria B. Pierzynska, husband and wife, as by the entirety	0.505	0.023	N/A	0.482	N/A	N/A	19-27-201-008	
1FH0040	Chicago Title Land Trust Company as successor to Chicago Title and Trust Company as Trustee under Trust Agreement dated July 17, 1968 known as Trust No. 53278	*132.507	2.109	0.413	*130.398	A=1.068 B=0.241 C=0.433	Grading Grading Grading	19-22-401-002 19-27-201-021	

* Area based on that part lying in the SE 1/4 of Sec. 22-43-8 & that part lying in Frank E. Merrill & Co's. Algonquin Hills Unit No. 1 Only.

COORDINATE TABLE			
STATION	OFFSET	NORTH	EAST
217+13.61	60.02' Rt.	2,009,262.732	997,007.283
217+19.14	80.02' Rt.	2,009,268.297	997,027.271

See Sheet 32 for Total Holdings Parcel 1FH0021-A, B & C & 1FH0021E.-B, D, E, F, G & H

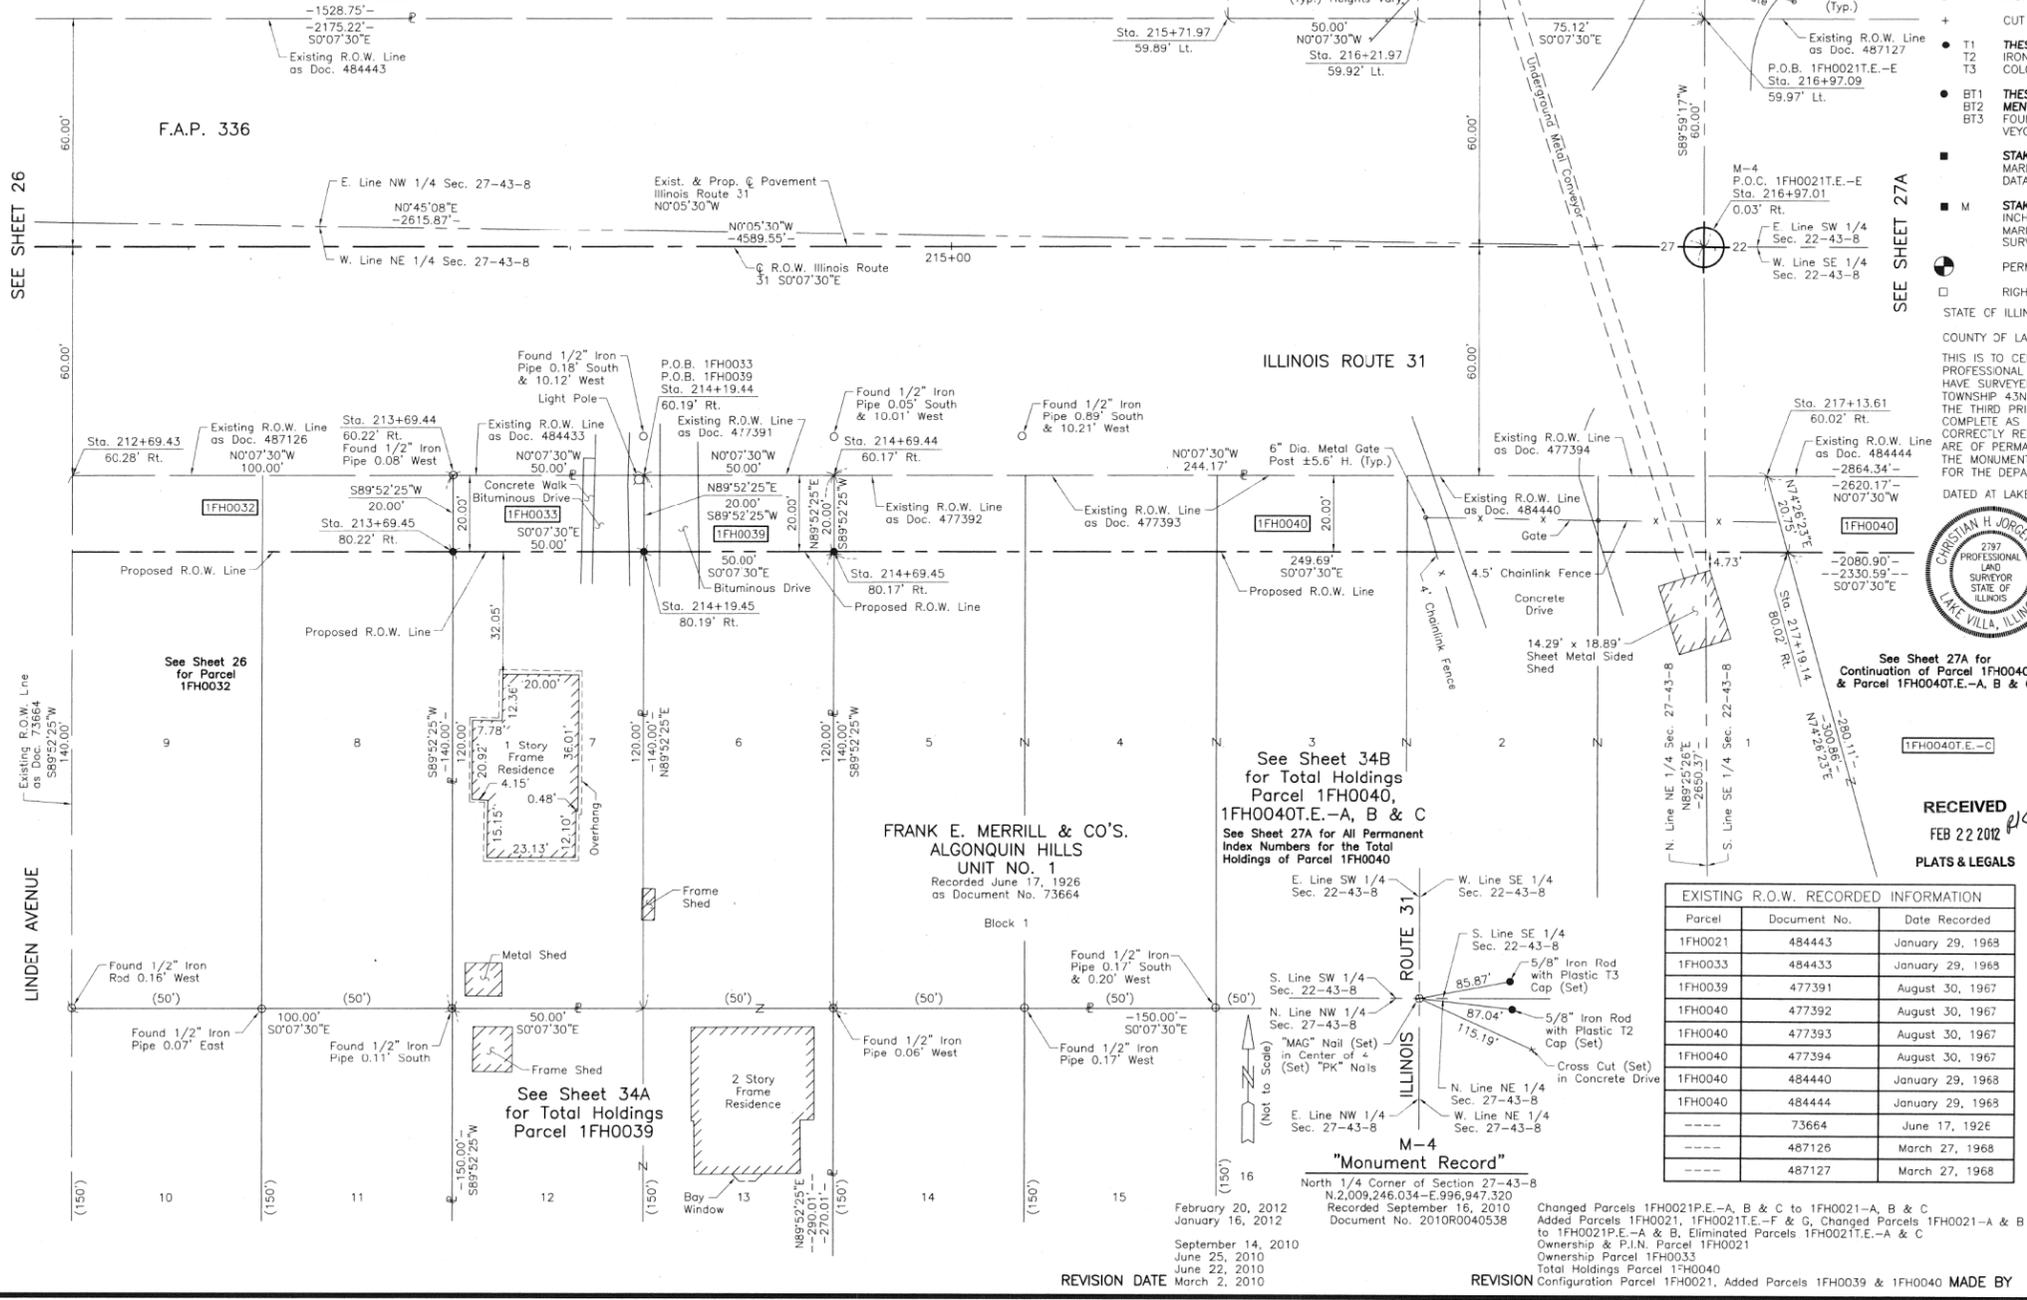

LEGEND

SECTION CORNER
QUARTER SECTION CORNER

SECTION LINE
QUARTER SECTION LINE
PLATTED LOT LINE
PROPERTY (DEED) LINE

APL
APPARENT PROPERTY LINE
CENTER LINE
EXISTING RIGHT OF WAY LINE
PROPOSED RIGHT OF WAY LINE
PROPOSED EASEMENT
MEASURED DIMENSION
COMPUTED DIMENSION
RECORD DATA

EXISTING BUILDING

Scale: 1"=20'

Bearings are referenced to the Illinois Coordinate System NAD83 (1997) East Zone at Found Geodetic Survey Control Monuments "MCH31 1A", P.I.D. AJ2855 and "Algonquin", P.I.D. AJ2945.

IRON PIPE OR ROD FOUND ⊕ "MAG" NAIL SET
CUT CROSS FOUND OR SET ⊕ 5/8" REBAR SET

T1 THESE STAKES REFERENCE FOUND OR SET MONUMENTATION. SET 5/8" INCH IRON ROD FLUSH WITH GROUND TO THE FOUND IRON STAKE, IDENTIFIED BY COLORED PLASTIC CAP BEARING SURVEYORS REGISTRATION NUMBER.
T2
T3

BT1 THESE STAKES, IN CULTIVATED AREAS, REFERENCE FOUND OR SET MONUMENTATION. BURIED 5/8" INCH IRON ROD 20 INCHES BELOW GROUND TO THE FOUND IRON STAKE, IDENTIFIED BY COLORED PLASTIC CAP BEARING SURVEYORS REGISTRATION NUMBER.
BT2
BT3

STAKING OF PROPOSED RIGHT OF WAY. SET DIVISION OF HIGHWAYS SURVEY MARKER TO MONUMENT THE POSITION SHOWN, IDENTIFIED BY INSCRIPTION DATA AND SURVEYORS REGISTRATION NUMBER.

STAKING OF PROPOSED RIGHT OF WAY IN CULTIVATED AREAS. BURIED 5/8" INCH METAL ROD 20 INCHES BELOW GROUND TO MARK FUTURE SURVEY MARKER POSITION IDENTIFIED BY COLORED PLASTIC CAP BEARING SURVEYORS REGISTRATION NUMBER.

PERMANENT SURVEY MARKER, I.D.O.T STD 2135 (TO BE SET BY OTHERS)

RIGHT OF WAY STAKING PROPOSED TO BE SET.

STATE OF ILLINOIS }
COUNTY OF LAKE }

THIS IS TO CERTIFY THAT WE, JORGENSEN & ASSOCIATES, INC., AN ILLINOIS PROFESSIONAL DESIGN FIRM LAND SURVEYING CORPORATION, NUMBER 184-2771, HAVE SURVEYED THE PLAT OF HIGHWAYS SHOWN HEREON BETWEEN SECTION 22, TOWNSHIP 43N., RANGE 8E. AND SECTION 27, TOWNSHIP 43N., RANGE 8E., OF THE THIRD PRINCIPAL MERIDIAN, McHENRY COUNTY, THAT THE SURVEY IS TRUE AND COMPLETE AS SHOWN TO THE BEST OF MY KNOWLEDGE AND BELIEF, THAT THE PLAT CORRECTLY REPRESENTS SAID SURVEY, THAT ALL MONUMENTS FOUND AND ESTABLISHED ARE OF PERMANENT QUALITY AND OCCUPY THE POSITIONS SHOWN THEREON AND THAT THE MONUMENTS ARE SUFFICIENT TO ENABLE THE SURVEY TO BE RETRACED. MADE FOR THE DEPARTMENT OF TRANSPORTATION, STATE OF ILLINOIS.

DATED AT LAKE VILLA, ILLINOIS THIS _____ DAY OF _____ 20____ A.D.

ILLINOIS PROFESSIONAL LAND SURVEYOR NO. 35-2797
LICENSE EXPIRATION DATE: NOVEMBER 30, 2010
THIS PROFESSIONAL SERVICE CONFORMS TO THE CURRENT ILLINOIS MINIMUM STANDARDS FOR A BOUNDARY SURVEY. COORDINATES ARE BASED ON THE PUBLISHED METRIC COORDINATE VALUES AT FOUND GEODETIC SURVEY CONTROL MONUMENT "MCH31 1A", P.I.D. AJ2855, OF N.613,205.182-E.303,895.917. NOTE: SURFACE COORDINATES ARE SHOWN.

BY	DATE
MADE	
REVISED	
NO. 1	
NO. 2	
NO. 3	
NO. 4	
NO. 5	
NO. 6	
NO. 7	
NO. 8	
NO. 9	
NO. 10	
NO. 11	
NO. 12	
NO. 13	
NO. 14	
NO. 15	
NO. 16	



RECEIVED
FEB 22 2012
PLATS & LEGALS

EXISTING R.O.W. RECORDED INFORMATION		
Parcel	Document No.	Date Recorded
1FH0021	484443	January 29, 1968
1FH0033	484433	January 29, 1968
1FH0039	477391	August 30, 1967
1FH0040	477392	August 30, 1967
1FH0040	477393	August 30, 1967
1FH0040	477394	August 30, 1967
1FH0040	484440	January 29, 1968
1FH0040	484444	January 29, 1968
----	487126	March 27, 1968
----	487127	March 27, 1968

COORDINATE TABLE			
STATION	OFFSET	NORTH	EAST
212+69.43	60.28' Rt.	2,008,818.556	997,008.252
213+69.44	60.22' Rt.	2,008,818.559	997,008.034
213+69.45	80.22' Rt.	2,008,818.603	997,028.034
214+19.44	60.19' Rt.	2,008,968.561	997,007.925
214+19.45	80.19' Rt.	2,008,968.605	997,027.924
214+69.44	60.17' Rt.	2,009,018.562	997,007.816
214+69.45	80.17' Rt.	2,009,018.607	997,027.816
215+71.93	134.89' Lt.	2,009,120.740	996,812.592
215+71.97	59.89' Lt.	2,009,120.904	996,887.592
216+21.93	134.92' Lt.	2,009,170.740	996,812.483
216+21.97	59.92' Lt.	2,009,170.903	996,887.483
216+97.09	59.97' Lt.	2,009,246.022	996,887.320
216+97.20	134.97' Lt.	2,009,246.006	996,812.319

JORGENSEN & ASSOCIATES, INC.
120 PARK AVENUE
LAKE VILLA, ILLINOIS 60046
(847) 356-3371

SHEET 1 IS A COVER SHEET AND IS NOT RECORDED.


PLAT OF HIGHWAYS
STATE OF ILLINOIS
DEPARTMENT OF TRANSPORTATION
F.A.P. 336 (ILLINOIS ROUTE 31 BYPASS)
SECTION 96-00209-00-PV McHENRY COUNTY PROJECT
STATION 213+00 TO STATION 217+00
SCALE: 1"=20'
SHEET 27 OF 37

BUREAU OF LAND ACQUISITION
201 WEST CENTER COURT
SCHAUMBURG, ILLINOIS 60196

FILE NAME = ... \D160F72-sht-PH-34.dgn	USER NAME = akw	DESIGNED -	REVISED -	STATE OF ILLINOIS DEPARTMENT OF TRANSPORTATION	PLAT OF HIGHWAYS	SCALE: GRAPHIC	SHEET NO. 34 OF 49 SHEETS	STA. TO STA.	O.R. RTE.	SECTION	COUNTY	TOTAL SHEETS	SHEET NO.
		DRAWN - JORGENSEN & ASSOC.	REVISED -						0003	18A-2	McHENRY	825	443
		CHECKED - CJ	REVISED -						CONTRACT NO. 60F72				
		DATE -	REVISED -						FED. ROAD DIST. NO. 1 ILLINOIS FED. AID PROJECT				

PART OF THE SOUTH 1/2 OF SEC. 22 AND PART OF THE NORTH 1/2 OF SEC. 27, TWP. 43 N., R. 8 E. OF THE 3RD. P.M., IN McHENRY COUNTY, ILLINOIS.

LEGEND

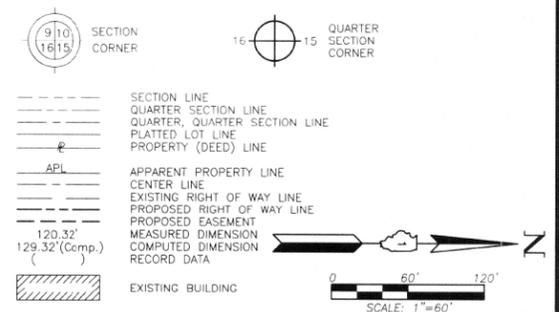


EXISTING R.O.W. RECORDED INFORMATION		
Parcel	Document No.	Date Recorded
1FH0040	73664	June 17, 1926
1FH0040	477394	August 30, 1967
1FH0040	484440	January 29, 1968
1FH0040	484444	January 29, 1968
----	484443	January 29, 1968
----	487127	March 27, 1968
----	68-682	*May 28, 1968
----	531481	October 8, 1970

PARCEL NUMBER	OWNER	TOTAL HOLDINGS ACRES	PART TAKEN ACRES	AREA IN EXISTING R.O.W. ACRES	REMAINING AREA ACRES	EASEMENT AREA ACRES	EASEMENT PURPOSE	PERMANENT INDEX NUMBER	PROPERTY ACQUIRED BY
1FH0040	Chicago Title Land Trust Company as successor to Chicago Title and Trust Company as Trustee under Trust Agreement dated July 17, 1968 known as Trust No. 53278	*132.507	2.109	0.413	*130.398	T.E.-A=1.068 T.E.-B=0.241 T.E.-C=0.433	Grading Grading Grading	19-22-401-002 19-22-426-001 19-22-452-001 19-22-452-004 19-22-452-005 19-22-453-002 19-22-453-009 19-22-453-010 19-22-454-001 19-22-476-008 19-22-476-009 19-22-477-001 19-27-201-021	

COORDINATE TABLE			
STATION	OFFSET	NORTH	EAST
223+00.00	79.68' Rt.	2,009,849.151	997,026.005
223+00.00	89.68' Rt.	2,009,849.167	997,036.005
226+00.05	79.51' Rt.	2,010,149.196	997,025.351
226+00.06	109.51' Rt.	2,010,149.262	997,055.351
226+95.09	60.55' Lt.	2,010,245.018	996,885.142
229+00.06	99.34' Rt.	2,010,449.239	997,044.697
229+00.06	109.34' Rt.	2,010,449.261	997,054.697
234+00.06	99.05' Rt.	2,010,949.238	997,043.607
234+00.07	119.05' Rt.	2,010,949.282	997,063.607
238+00.01	118.81' Rt.	2,011,349.217	997,062.735
238+00.01	128.81' Rt.	2,011,349.239	997,072.735
238+00.05	78.81' Rt.	2,011,349.193	997,022.735
238+00.06	98.81' Rt.	2,011,349.237	997,042.735

Schedule of Ties		
Point Number	Tie to point	Tie Distance (feet)
1	T1	74.31
	T2	71.35
	T3	80.53
2	T1	56.97
	T2	51.35
	T3	62.50

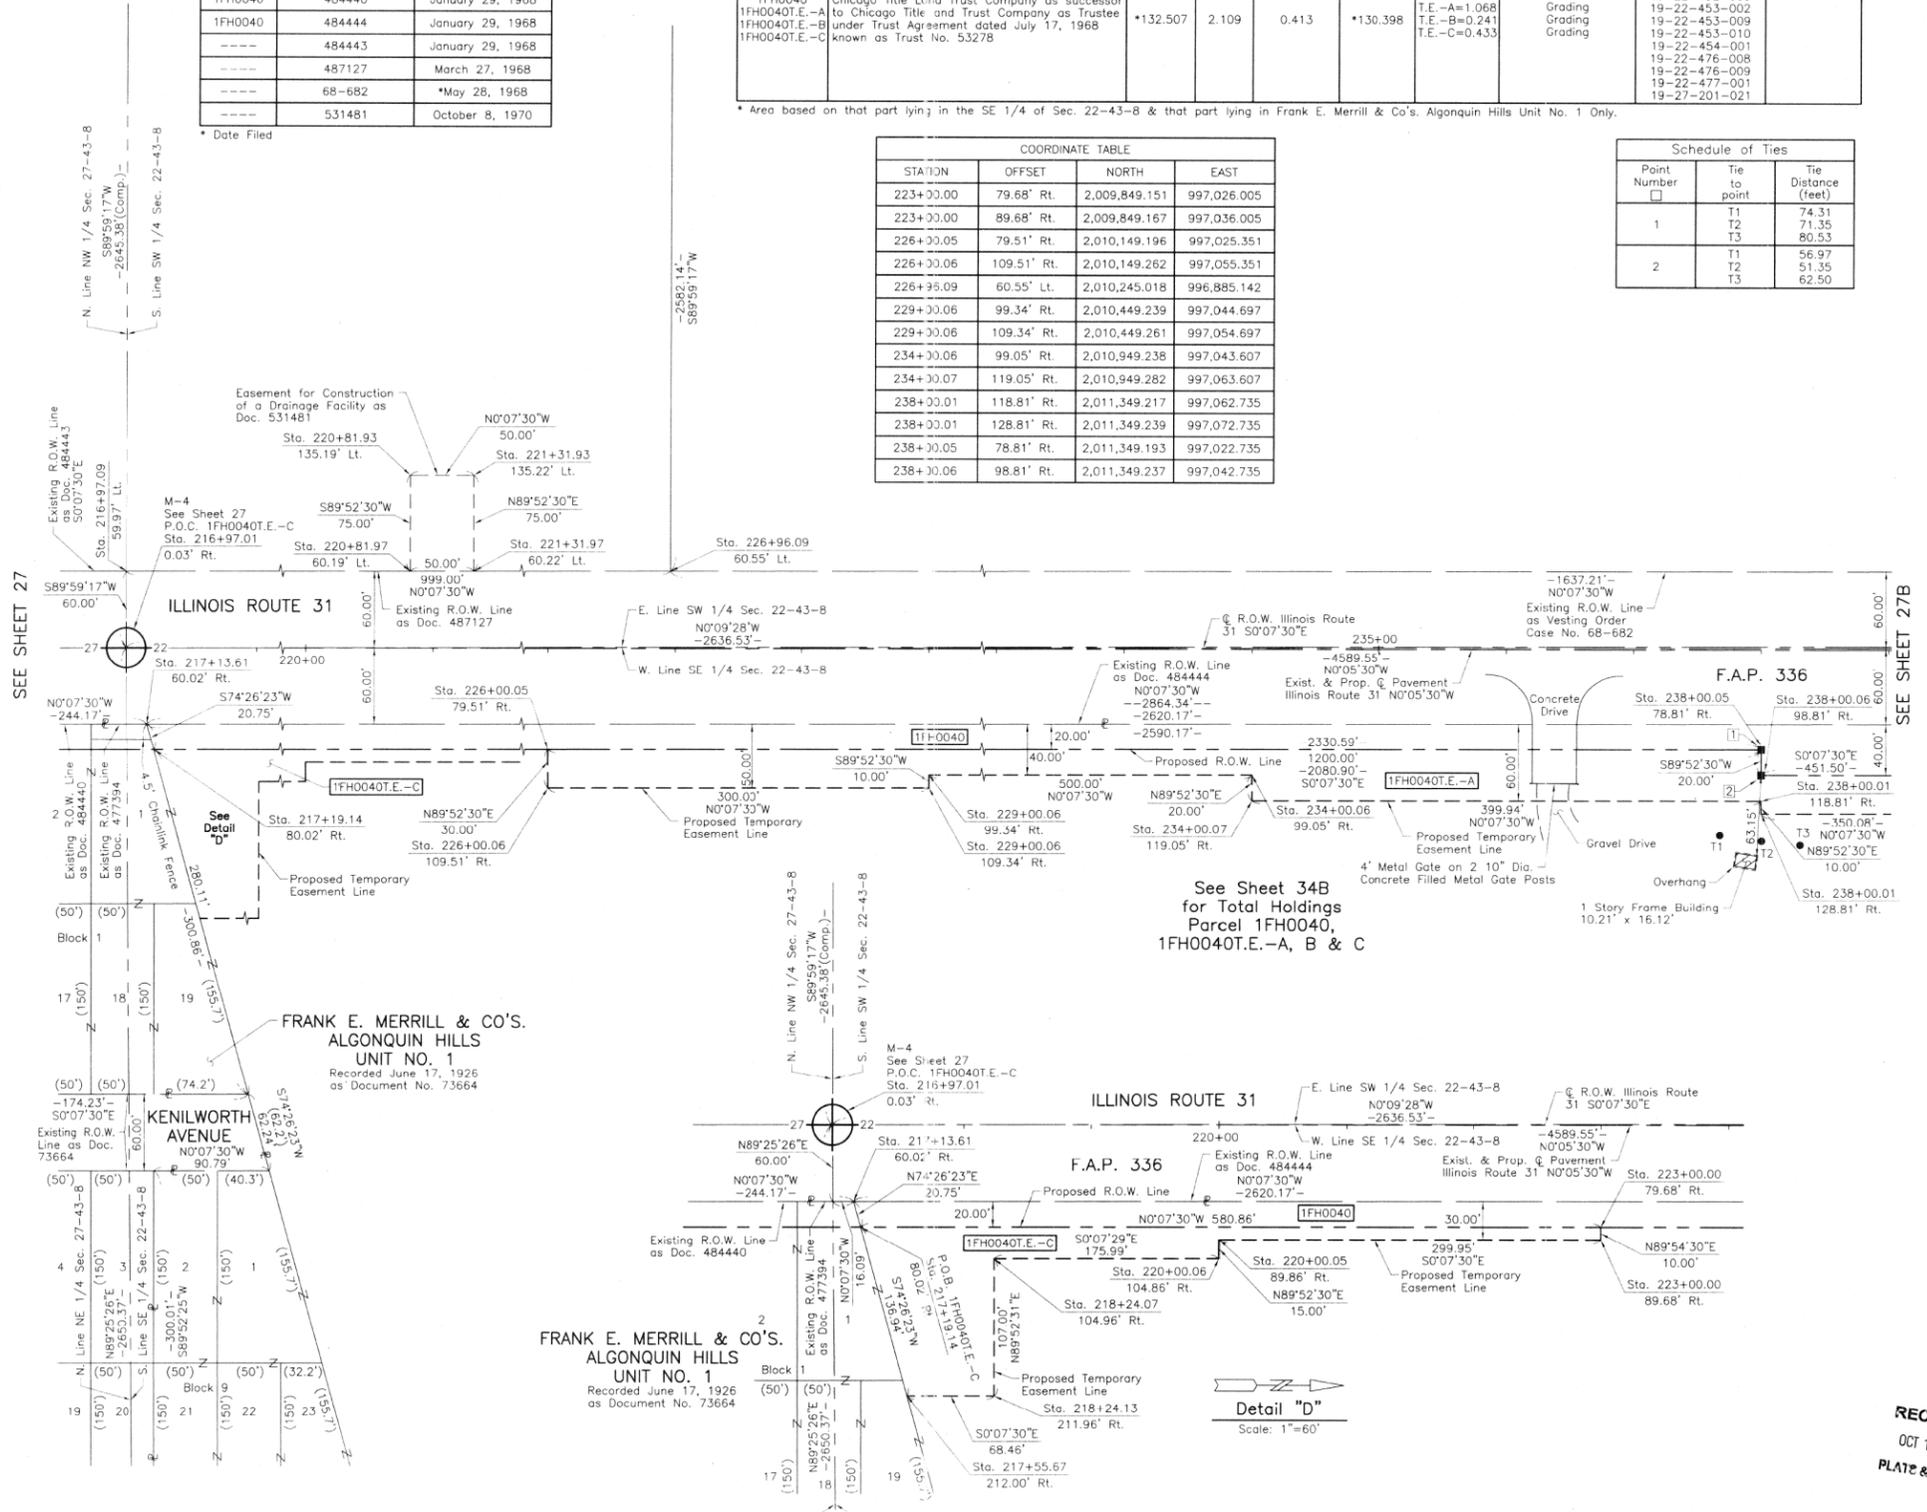

ROW PLAT	MADE	CHECKED	INDEXED	DATE	BY

Bearings are referenced to the Illinois Coordinate System NAD83 (1997) East Zone at Found Geodetic Survey Control Monuments "MCH31 1A" P.I.D. AJ2855 and "Algonquin", P.I.D. AJ2945.

● T1 T2 T3 THESE STAKES REFERENCE FOUND OR SET MONUMENTATION. SET 5/8 INCH IRON ROD FLUSH WITH GROUND TO THE FOUND IRON STAKE IDENTIFIED BY COLORED PLASTIC CAP BEARING SURVEYORS REGISTRATION NUMBER.

● B11 B12 B13 THESE STAKES, IN CULTIVATED AREAS, REFERENCE FOUND OR SET MONUMENTATION. BURIED 5/8 INCH IRON ROD 20 INCHES BELOW GROUND TO THE FOUND IRON STAKE IDENTIFIED BY COLORED PLASTIC CAP BEARING SURVEYORS REGISTRATION NUMBER.

■ STAKING OF PROPOSED RIGHT OF WAY. SET DIVISION OF HIGHWAYS SURVEY MARKER TO MONUMENT THE POSITION SHOWN, IDENTIFIED BY INSCRIPTION DATA AND SURVEYORS REGISTRATION NUMBER.

■ M STAKING OF PROPOSED RIGHT OF WAY IN CULTIVATED AREAS. BURIED 5/8 INCH METAL ROD 20 INCHES BELOW GROUND TO MARK FUTURE SURVEY MARKER POSITION IDENTIFIED BY COLORED PLASTIC CAP BEARING SURVEYORS REGISTRATION NUMBER.

● PERMANENT SURVEY MARKER, I.D.O.T STD 2135 (TO BE SET BY OTHERS)

□ RIGHT OF WAY STAKING PROPOSED TO BE SET.

STATE OF ILLINOIS }
COUNTY OF LAKE }
SS

THIS IS TO CERTIFY THAT WE, JORGENSEN & ASSOCIATES, INC., AN ILLINOIS PROFESSIONAL DESIGN FIRM LAND SURVEYING CORPORATION, NUMBER 184-2771, HAVE SURVEYED THE PLAT OF HIGHWAYS SHOWN HEREON BETWEEN SECTION 22, TOWNSHIP 43N., RANGE 8E. AND SECTION 27, TOWNSHIP 43N., RANGE 8E., OF THE THIRD PRINCIPAL MERIDIAN, McHENRY COUNTY, ILLINOIS. THAT THE PLAT CORRECTLY REPRESENTS SAID SURVEY, THAT ALL MONUMENTS FOUND AND ESTABLISHED ARE OF PERMANENT QUALITY AND OCCUPY THE POSITIONS SHOWN THEREON AND THAT THE MONUMENTS ARE SUFFICIENT TO ENABLE THE SURVEY TO BE RETRACED, MADE FOR THE DEPARTMENT OF TRANSPORTATION, STATE OF ILLINOIS.

DATED AT LAKE VILLA, ILLINOIS THIS 23rd DAY OF June 2010 A.D.

Christian H. Jorgensen
PRESIDENT
ILLINOIS PROFESSIONAL LAND SURVEYOR NO. 35-2797
LICENSE EXPIRATION DATE: NOVEMBER 30, 2010

THIS PROFESSIONAL SERVICE CONFORMS TO THE CURRENT ILLINOIS MINIMUM STANDARDS FOR A BOUNDARY SURVEY. COORDINATES ARE BASED ON THE PUBLISHED METRIC COORDINATE VALUES AT FOUND GEODETIC SURVEY CONTROL MONUMENT "MCH31 1A", P.I.D. AJ2855, OF N.613,205.182-E.303,895.917. NOTE: SURFACE COORDINATES ARE SHOWN.

COORDINATE TABLE			
STATION	OFFSET	NORTH	EAST
216+97.01	0.03' Rt.	2,009,246.034	996,947.320
216+97.09	59.97' Lt.	2,009,246.022	996,887.320
217+13.61	60.02' Rt.	2,009,262.732	997,007.283
217+19.14	80.02' Rt.	2,009,268.297	997,027.271
217+55.67	212.00' Rt.	2,009,305.032	997,159.192
218+24.07	104.96' Rt.	2,009,373.262	997,052.038
218+24.13	211.96' Rt.	2,009,373.496	997,159.042
220+00.05	89.86' Rt.	2,009,549.220	997,036.659
220+00.06	104.85' Rt.	2,009,549.252	997,051.655
220+81.93	135.19' Lt.	2,009,630.739	996,811.481
220+81.97	60.19' Lt.	2,009,630.902	996,886.480
221+31.93	135.22' Lt.	2,009,680.739	996,811.372
221+31.97	60.22' Lt.	2,009,680.902	996,886.372

JORGENSEN & ASSOCIATES, INC.
120 PARK AVENUE
LAKE VILLA, ILLINOIS 60046
(847) 356-3371

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PLAT & LEGALS

PLAT OF HIGHWAYS
STATE OF ILLINOIS
DEPARTMENT OF TRANSPORTATION
F.A.P. 336 (ILLINOIS ROUTE 31 BYPASS)
SECTION 96-00209-00-PV McHENRY COUNTY
PROJECT JOB NO. R-91-022-03
STATION 216+00 TO STATION 239+00
SCALE: 1"=60' SHEET 27A OF 37

BUREAU OF LAND ACQUISITION
201 WEST CENTER COURT
SCHAUMBURG, ILLINOIS 60196

ROUTE F.A.P. 336 (ILLINOIS ROUTE 31 BYPASS) SECTION 96-00209-00-PV COUNTY McHENRY JOB NO. R-91-022-03 RECORDING: RECORDED ON AS DOCUMENT NO.

FILE NAME = ...\\D160F72-sht-Ph-35.dgn

USER NAME = akw	DESIGNED -	REVISED -
	DRAWN - JORGENSEN & ASSOC.	REVISED -
	CHECKED - CJ	REVISED -
	DATE -	REVISED -

STATE OF ILLINOIS
DEPARTMENT OF TRANSPORTATION


PLAT OF HIGHWAYS
SCALE: GRAPHIC SHEET NO. 35 OF 49 SHEETS STA. TO STA.

O.R. RTE.	SECTION	COUNTY	TOTAL SHEETS	SHEET NO.
0003	18A-2	McHENRY	825	444
				CONTRACT NO. 60F72

FED. ROAD DIST. NO. 1 ILLINOIS FED. AID PROJECT

PART OF THE SOUTH 1/2 AND PART OF THE NORTH 1/2 OF SEC. 22, TWP. 43 N., R. 8 E. OF THE 3RD. P.M., IN McHENRY COUNTY, ILLINOIS.

LEGEND

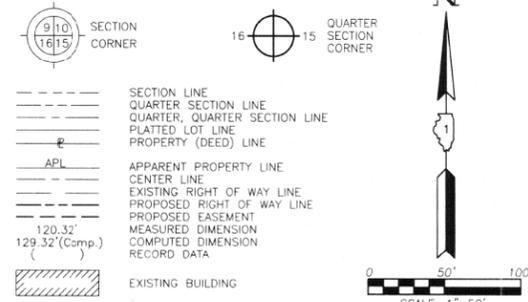

- Bearings are referenced to the Illinois Coordinate System NAD83 (1997) East Zone at Found Geodetic Survey Control Monuments "MCH31 1A", P.I.D. AJ2855 and "Algonquin", P.I.D. AJ2945.
- IRON PIPE OR ROD FOUND
- "MAG" NAIL SET
- CUT CROSS FOUND OR SET
- 5/8" REBAR SET
- THESE STAKES REFERENCE FOUND OR SET MONUMENTATION. SET 5/8 INCH IRON ROD FLUSH WITH GROUND TO THE FOUND IRON STAKE. IDENTIFIED BY COLORED PLASTIC CAP BEARING SURVEYORS REGISTRATION NUMBER.
- THESE STAKES, IN CULTIVATED AREAS, REFERENCE FOUND OR SET MONUMENTATION. BURIED 5/8 INCH IRON ROD 20 INCHES BELOW GROUND TO THE FOUND IRON STAKE. IDENTIFIED BY COLORED PLASTIC CAP BEARING SURVEYORS REGISTRATION NUMBER.
- STAKING OF PROPOSED RIGHT OF WAY. SET DIVISION OF HIGHWAYS SURVEY MARKER TO MONUMENT THE POSITION SHOWN. IDENTIFIED BY INSCRIPTION DATA AND SURVEYORS REGISTRATION NUMBER.
- STAKING OF PROPOSED RIGHT OF WAY IN CULTIVATED AREAS. BURIED 5/8 INCH METAL ROD 20 INCHES BELOW GROUND TO MARK FUTURE SURVEY MARKER POSITION IDENTIFIED BY COLORED PLASTIC CAP BEARING SURVEYORS REGISTRATION NUMBER.
- PERMANENT SURVEY MARKER, I.D.O.T. STD 2135 (TO BE SET BY OTHERS)
- RIGHT OF WAY STAKING PROPOSED TO BE SET.

STATE OF ILLINOIS }
 COUNTY OF LAKE }
 THIS IS TO CERTIFY THAT WE, JORGENSEN & ASSOCIATES, INC., AN ILLINOIS PROFESSIONAL DESIGN FIRM LAND SURVEYING CORPORATION, NUMBER 184-2771, HAVE SURVEYED THE PLAT OF HIGHWAYS SHOWN HEREON IN SECTION 22, TOWNSHIP 43N., RANGE 8E., OF THE THIRD PRINCIPAL MERIDIAN, McHENRY COUNTY, THAT THE SURVEY IS TRUE AND COMPLETE AS SHOWN TO THE BEST OF MY KNOWLEDGE AND BELIEF, THAT THE PLAT CORRECTLY REPRESENTS SAID SURVEY, THAT ALL MONUMENTS FOUND AND ESTABLISHED ARE OF PERMANENT QUALITY AND OCCUPY THE POSITIONS SHOWN THEREON AND THAT THE MONUMENTS ARE SUFFICIENT TO ENABLE THE SURVEY TO BE RETRACED. MADE FOR THE DEPARTMENT OF TRANSPORTATION, STATE OF ILLINOIS, DATED AT LAKE VILLA, ILLINOIS THIS 20th DAY OF June 2010.




Christian H. Jorgensen, PRESIDENT
 ILLINOIS PROFESSIONAL LAND SURVEYOR NO. 35-2797
 LICENSE EXPIRATION DATE: NOVEMBER 30, 2010
 THIS PROFESSIONAL SERVICE CONFORMS TO THE CURRENT ILLINOIS MINIMUM STANDARDS FOR A BOUNDARY SURVEY. COORDINATES ARE BASED ON THE PUBLISHED METRIC COORDINATE VALUES AT FOUND GEODETIC SURVEY CONTROL MONUMENT "MCH31 1A", P.I.D. AJ2855, OF N.613,205.182-E.303,895.917. NOTE: SURFACE COORDINATES ARE SHOWN.

STATION	OFFSET	NORTH	EAST
100+01.05	3.20' Lt.	2,011,882.894	997,001.572
100+99.99	36.80' Rt.	2,011,843.448	997,100.741
100+99.99	46.80' Rt.	2,011,833.448	997,100.797
101+41.28	43.20' Lt.	2,011,923.678	997,141.578
101+61.28	43.20' Lt.	2,011,923.790	997,161.578
103+11.38	43.20' Lt.	2,011,924.629	997,311.672
103+71.38	43.20' Lt.	2,011,924.964	997,371.672
105+99.97	3.20' Lt.	2,011,886.243	997,600.488
105+99.97	26.80' Rt.	2,011,856.243	997,600.656
105+99.97	36.80' Rt.	2,011,846.244	997,600.712
106+71.57	43.20' Lt.	2,011,926.642	997,671.859
107+31.57	43.20' Lt.	2,011,926.978	997,731.858
108+74.96	26.80' Rt.	2,011,857.781	997,875.640

Existing & Proposed @ Illinois Route 31
 Existing & Proposed @ Klases Road
 Sta. 243+30.35 @ Illinois Route 31
 as Doc. 79497
 N.2,011,871.367-E.998,943.074

Existing P.O.T.
 Klases Road
 Sta. 110+61.61
 N.2,011,885.624-E.998,062.140

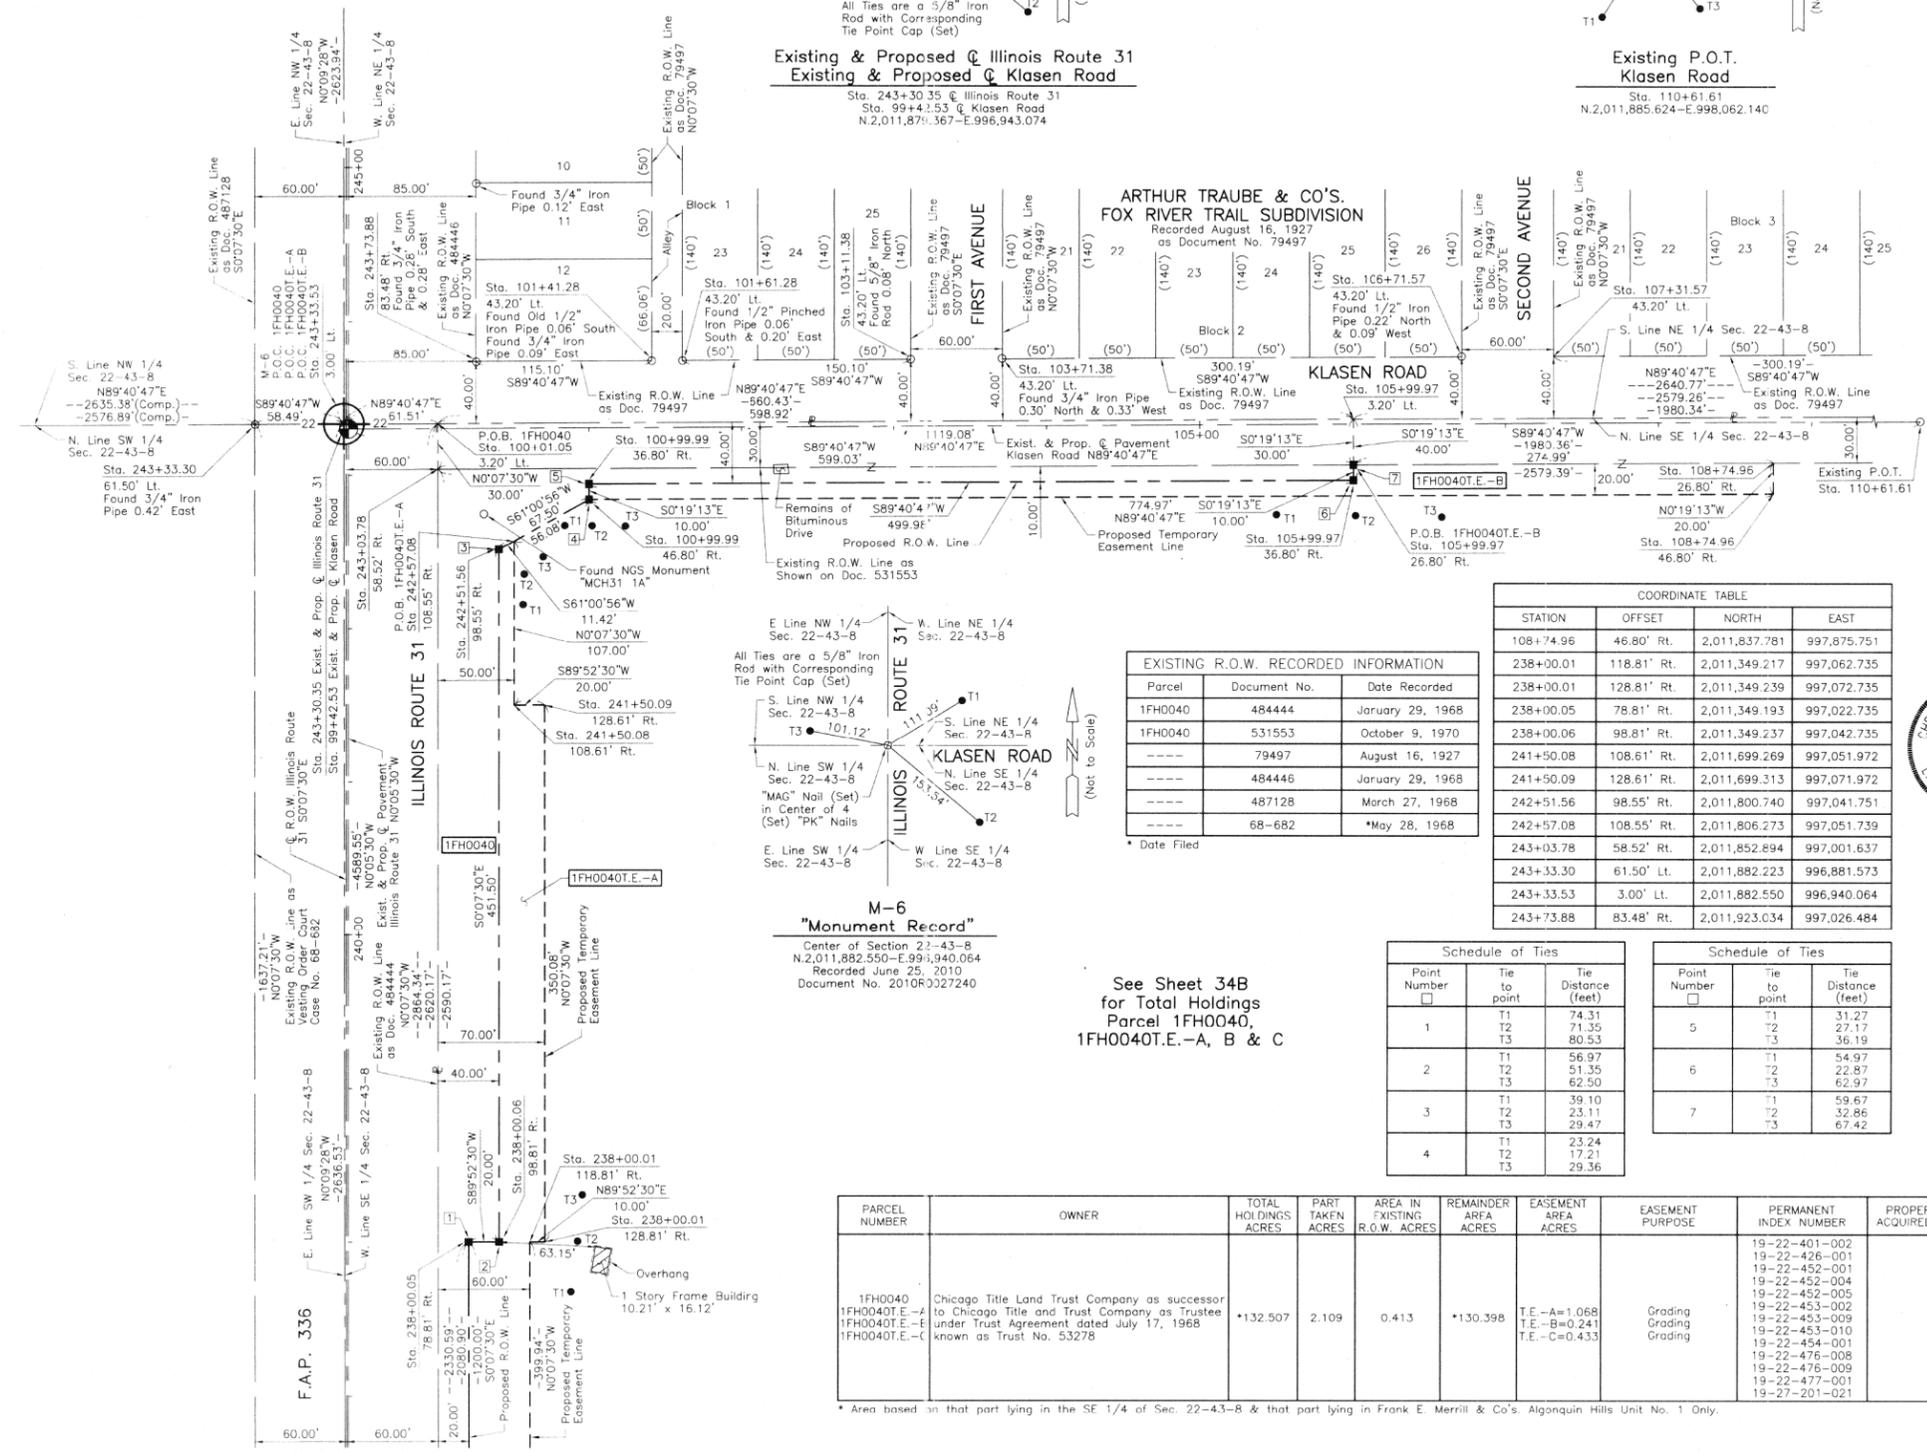

Parcel	Document No.	Date Recorded
1FH0040	484444	January 29, 1968
1FH0040	531553	October 9, 1970
----	79497	August 16, 1927
----	484444	January 29, 1968
----	487128	March 27, 1968
----	68-682	*May 28, 1968

COORDINATE TABLE			
STATION	OFFSET	NORTH	EAST
108+74.96	46.80' Rt.	2,011,837.781	997,875.751
238+00.01	118.81' Rt.	2,011,349.217	997,062.735
238+00.01	128.81' Rt.	2,011,349.239	997,072.735
238+00.05	78.81' Rt.	2,011,349.193	997,022.735
238+00.06	98.81' Rt.	2,011,349.237	997,042.735
241+50.08	108.61' Rt.	2,011,699.269	997,051.972
241+50.09	128.61' Rt.	2,011,699.313	997,071.972
242+51.56	98.55' Rt.	2,011,800.740	997,041.751
242+57.08	108.55' Rt.	2,011,806.273	997,051.739
243+03.78	58.52' Rt.	2,011,852.894	997,001.637
243+33.30	61.50' Lt.	2,011,882.223	996,881.573
243+33.53	3.00' Lt.	2,011,882.550	996,940.064
243+73.88	83.48' Rt.	2,011,923.034	997,026.484

Schedule of Ties		
Point Number	Tie to point	Tie Distance (feet)
1	T1	74.31
	T2	71.35
	T3	80.53
2	T1	56.97
	T2	51.35
	T3	62.50
3	T1	39.10
	T2	23.11
	T3	29.47
4	T1	23.24
	T2	17.21
	T3	29.36

Schedule of Ties		
Point Number	Tie to point	Tie Distance (feet)
5	T1	31.27
	T2	27.17
	T3	36.19
6	T1	54.97
	T2	22.87
	T3	62.97
7	T1	59.67
	T2	32.86
	T3	67.42

M-6
 "Monument Record"
 Center of Section 22-43-8
 N.2,011,882.550-E.991,940.064
 Recorded June 25, 2010
 Document No. 2010R0327240

See Sheet 34B
 for Total Holdings
 Parcel 1FH0040,
 1FH0040T.E.-A, B & C


PARCEL NUMBER	OWNER	TOTAL HOLDINGS ACRES	PART TAKEN ACRES	AREA IN EXISTING R.O.W. ACRES	REMAINDER AREA ACRES	EASEMENT AREA ACRES	EASEMENT PURPOSE	PERMANENT INDEX NUMBER	PROPERTY ACQUIRED BY
1FH0040	Chicago Title Land Trust Company as successor to Chicago Title and Trust Company as Trustee under Trust Agreement dated July 17, 1968 known as Trust No. 53278	*132.507	2.109	0.413	*130.398	T.E.-A=1.068 T.E.-B=0.241 T.E.-C=0.433	Grading Grading Grading	19-22-401-002 19-22-426-001 19-22-452-001 19-22-452-004 19-22-452-005 19-22-453-002 19-22-453-009 19-22-453-010 19-22-454-001 19-22-476-008 19-22-476-009 19-22-477-001 19-27-201-021	

* Area based on that part lying in the SE 1/4 of Sec. 22-43-8 & that part lying in Frank E. Merrill & Co's. Algonquin Hills Unit No. 1 Only.

ROW PLAT	MADE	CHECKED	INCHES	DATE	BY

PART OF THE NE 1/4 OF SEC. 33 AND PART OF THE FRACTIONAL NW 1/4 OF SEC. 34, TWP. 43 N., R. 8 E. OF THE 3RD. P.M., IN McHENRY COUNTY, ILLINOIS.

LEGEND

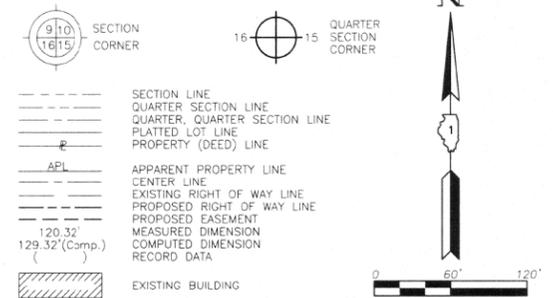

- Bearings are referenced to the Illinois Coordinate System NAD83 (1997) East Zone at Found Geodetic Survey Control Monuments "MCH31 1A", P.I.D. AJ2855 and "Algonquin", P.I.D. AJ2945.
- IRON PIPE OR ROD FOUND ⊕ "MAG" NAIL SET
- + CUT CROSS FOUND OR SET ● 5/8" REBAR SET
- T1 THESE STAKES REFERENCE FOUND OR SET MONUMENTATION. SET 5/8 INCH IRON ROD FLUSH WITH GROUND TO THE FOUND IRON STAKE. IDENTIFIED BY COLORED PLASTIC CAP BEARING SURVEYORS REGISTRATION NUMBER.
- T2
- T3
- BT1 THESE STAKES, IN CULTIVATED AREAS, REFERENCE FOUND OR SET MONUMENTATION. BURIED 5/8 INCH IRON ROD 20 INCHES BELOW GROUND TO THE FOUND IRON STAKE. IDENTIFIED BY COLORED PLASTIC CAP BEARING SURVEYORS REGISTRATION NUMBER.
- BT2
- BT3
- STAKING OF PROPOSED RIGHT OF WAY. SET DIVISION OF HIGHWAYS SURVEY MARKER TO MONUMENT THE POSITION SHOWN. IDENTIFIED BY INSCRIPTION, DATA AND SURVEYORS REGISTRATION NUMBER.
- M STAKING OF PROPOSED RIGHT OF WAY IN CULTIVATED AREAS. BURIED 5/8 INCH METAL ROD 20 INCHES BELOW GROUND TO MARK FUTURE SURVEY MARKER POSITION IDENTIFIED BY COLORED PLASTIC CAP BEARING SURVEYORS REGISTRATION NUMBER.
- ⊕ PERMANENT SURVEY MARKER, I.D.O.T STD 2135 (TO BE SET BY OTHERS)
- RIGHT OF WAY STAKING PROPOSED TO BE SET.

STATE OF ILLINOIS }
 COUNTY OF LAKE }
 THIS IS TO CERTIFY THAT WE, JORGENSEN & ASSOCIATES, INC., AN ILLINOIS PROFESSIONAL DESIGN FIRM LAND SURVEYING CORPORATION, NUMBER 184-2771, HAVE SURVEYED THE PLAT OF HIGHWAYS SHOWN HEREON BETWEEN SECTION 33, TOWNSHIP 43N., RANGE 8E. AND SECTION 34, TOWNSHIP 43N., RANGE 8E., OF THE THIRD PRINCIPAL MERIDIAN, McHENRY COUNTY, THAT THE SURVEY IS TRUE AND COMPLETE AS SHOWN TO THE BEST OF MY KNOWLEDGE AND BELIEF, THAT THE PLAT CORRECTLY REPRESENTS SAID SURVEY, THAT ALL MONUMENTS FOUND AND ESTABLISHED ARE OF PERMANENT QUALITY AND OCCUPY THE POSITIONS SHOWN THEREON AND THAT THE MONUMENTS ARE SUFFICIENT TO ENABLE THE SURVEY TO BE RETRACED. MADE FOR THE DEPARTMENT OF TRANSPORTATION, STATE OF ILLINOIS.
 DATED AT LAKE VILLA, ILLINOIS THIS 15th DAY OF March, 2008 A.D.
 CHRISTIAN H. JORGENSEN, PRESIDENT
 2797 PROFESSIONAL LAND SURVEYOR NO. 35-2797
 LICENSE EXPIRATION DATE: NOVEMBER 30, 2006
 THIS PROFESSIONAL SERVICE CONFORMS TO THE CURRENT ILLINOIS MINIMUM STANDARDS FOR A BOUNDARY SURVEY.


RECEIVED
 JUL 0 7 2010
 PLATS & LEGALS

JORGENSEN & ASSOCIATES, INC.
 120 PARK AVENUE
 LAKE VILLA, ILLINOIS 60046
 (847) 356-3371

PLAT OF HIGHWAYS
 STATE OF ILLINOIS
 DEPARTMENT OF TRANSPORTATION
 F.A.P. 336 (ILLINOIS ROUTE 31 BYPASS)
 SECTION 96-00209-00-PV McHENRY COUNTY
 PROJECT JOB NO. R-91-022-03
 STATION NONE TO STATION
 SCALE: 1"=60' SHEET 28 OF 37

BUREAU OF LAND ACQUISITION
 201 WEST CENTER COURT
 SCHAUMBURG, ILLINOIS 60196

ROW	PLAT	MADE	CHECKED	INKE	DATE

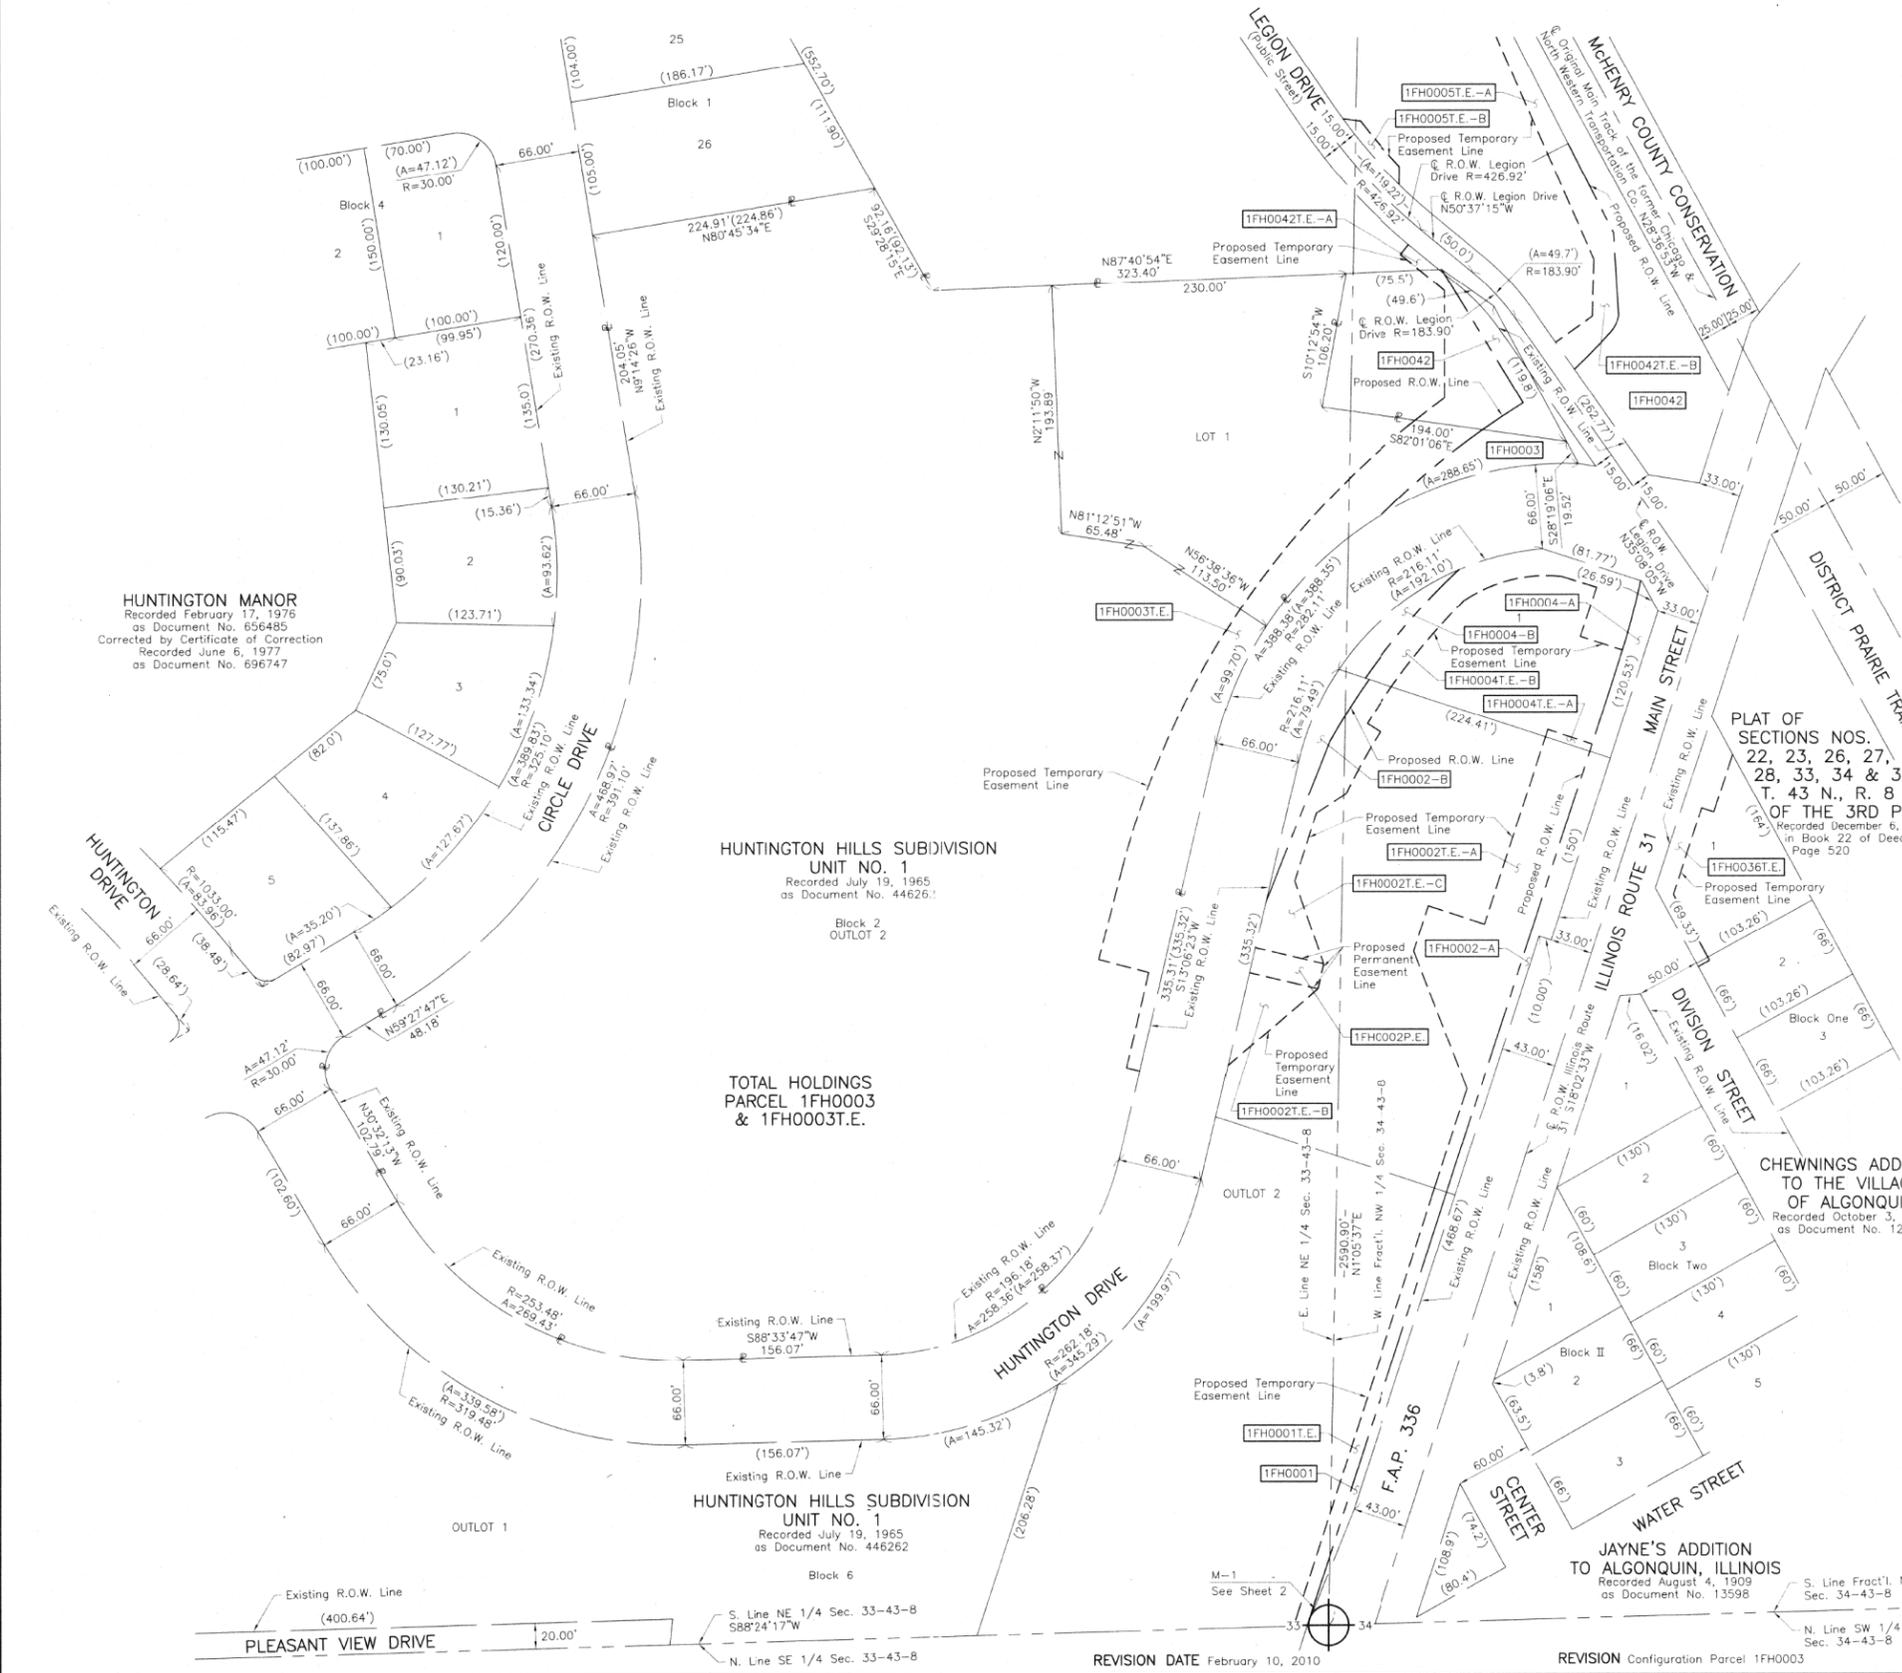

ROUTE F.A.P. 336 (ILLINOIS ROUTE 31 BYPASS) SECTION 96-00209-00-PV COUNTY McHENRY JOB NO. R-91-022-03 RECORDING: RECORDED ON AS DOCUMENT NO.

REVISION DATE February 10, 2010

REVISION Configuration Parcel 1FH0003

MADE BY

FILE NAME = ...\\D160F72-sht-PH-37.dgn


USER NAME	DESIGNED	REVISED
akw	-	-
JORGENSEN & ASSOC.	-	-
CJ	-	-

STATE OF ILLINOIS
 DEPARTMENT OF TRANSPORTATION

PLAT OF HIGHWAYS
 SCALE: GRAPHIC SHEET NO. 37 OF 49 SHEETS STA. TO STA.

O.R. RTE.	SECTION	COUNTY	TOTAL SHEETS	SHEET NO.
0003	18A-2	McHENRY	825	446
CONTRACT NO. 60F72				
FED. ROAD DIST. NO. 1 ILLINOIS FED. AID PROJECT				

PART OF THE NE 1/4 OF SEC. 33 AND PART OF THE FRACTIONAL NW 1/4 SEC. 34, TWP. 43 N., R. 8 E. OF THE 3RD. P.M., IN McHENRY COUNTY, ILLINOIS.

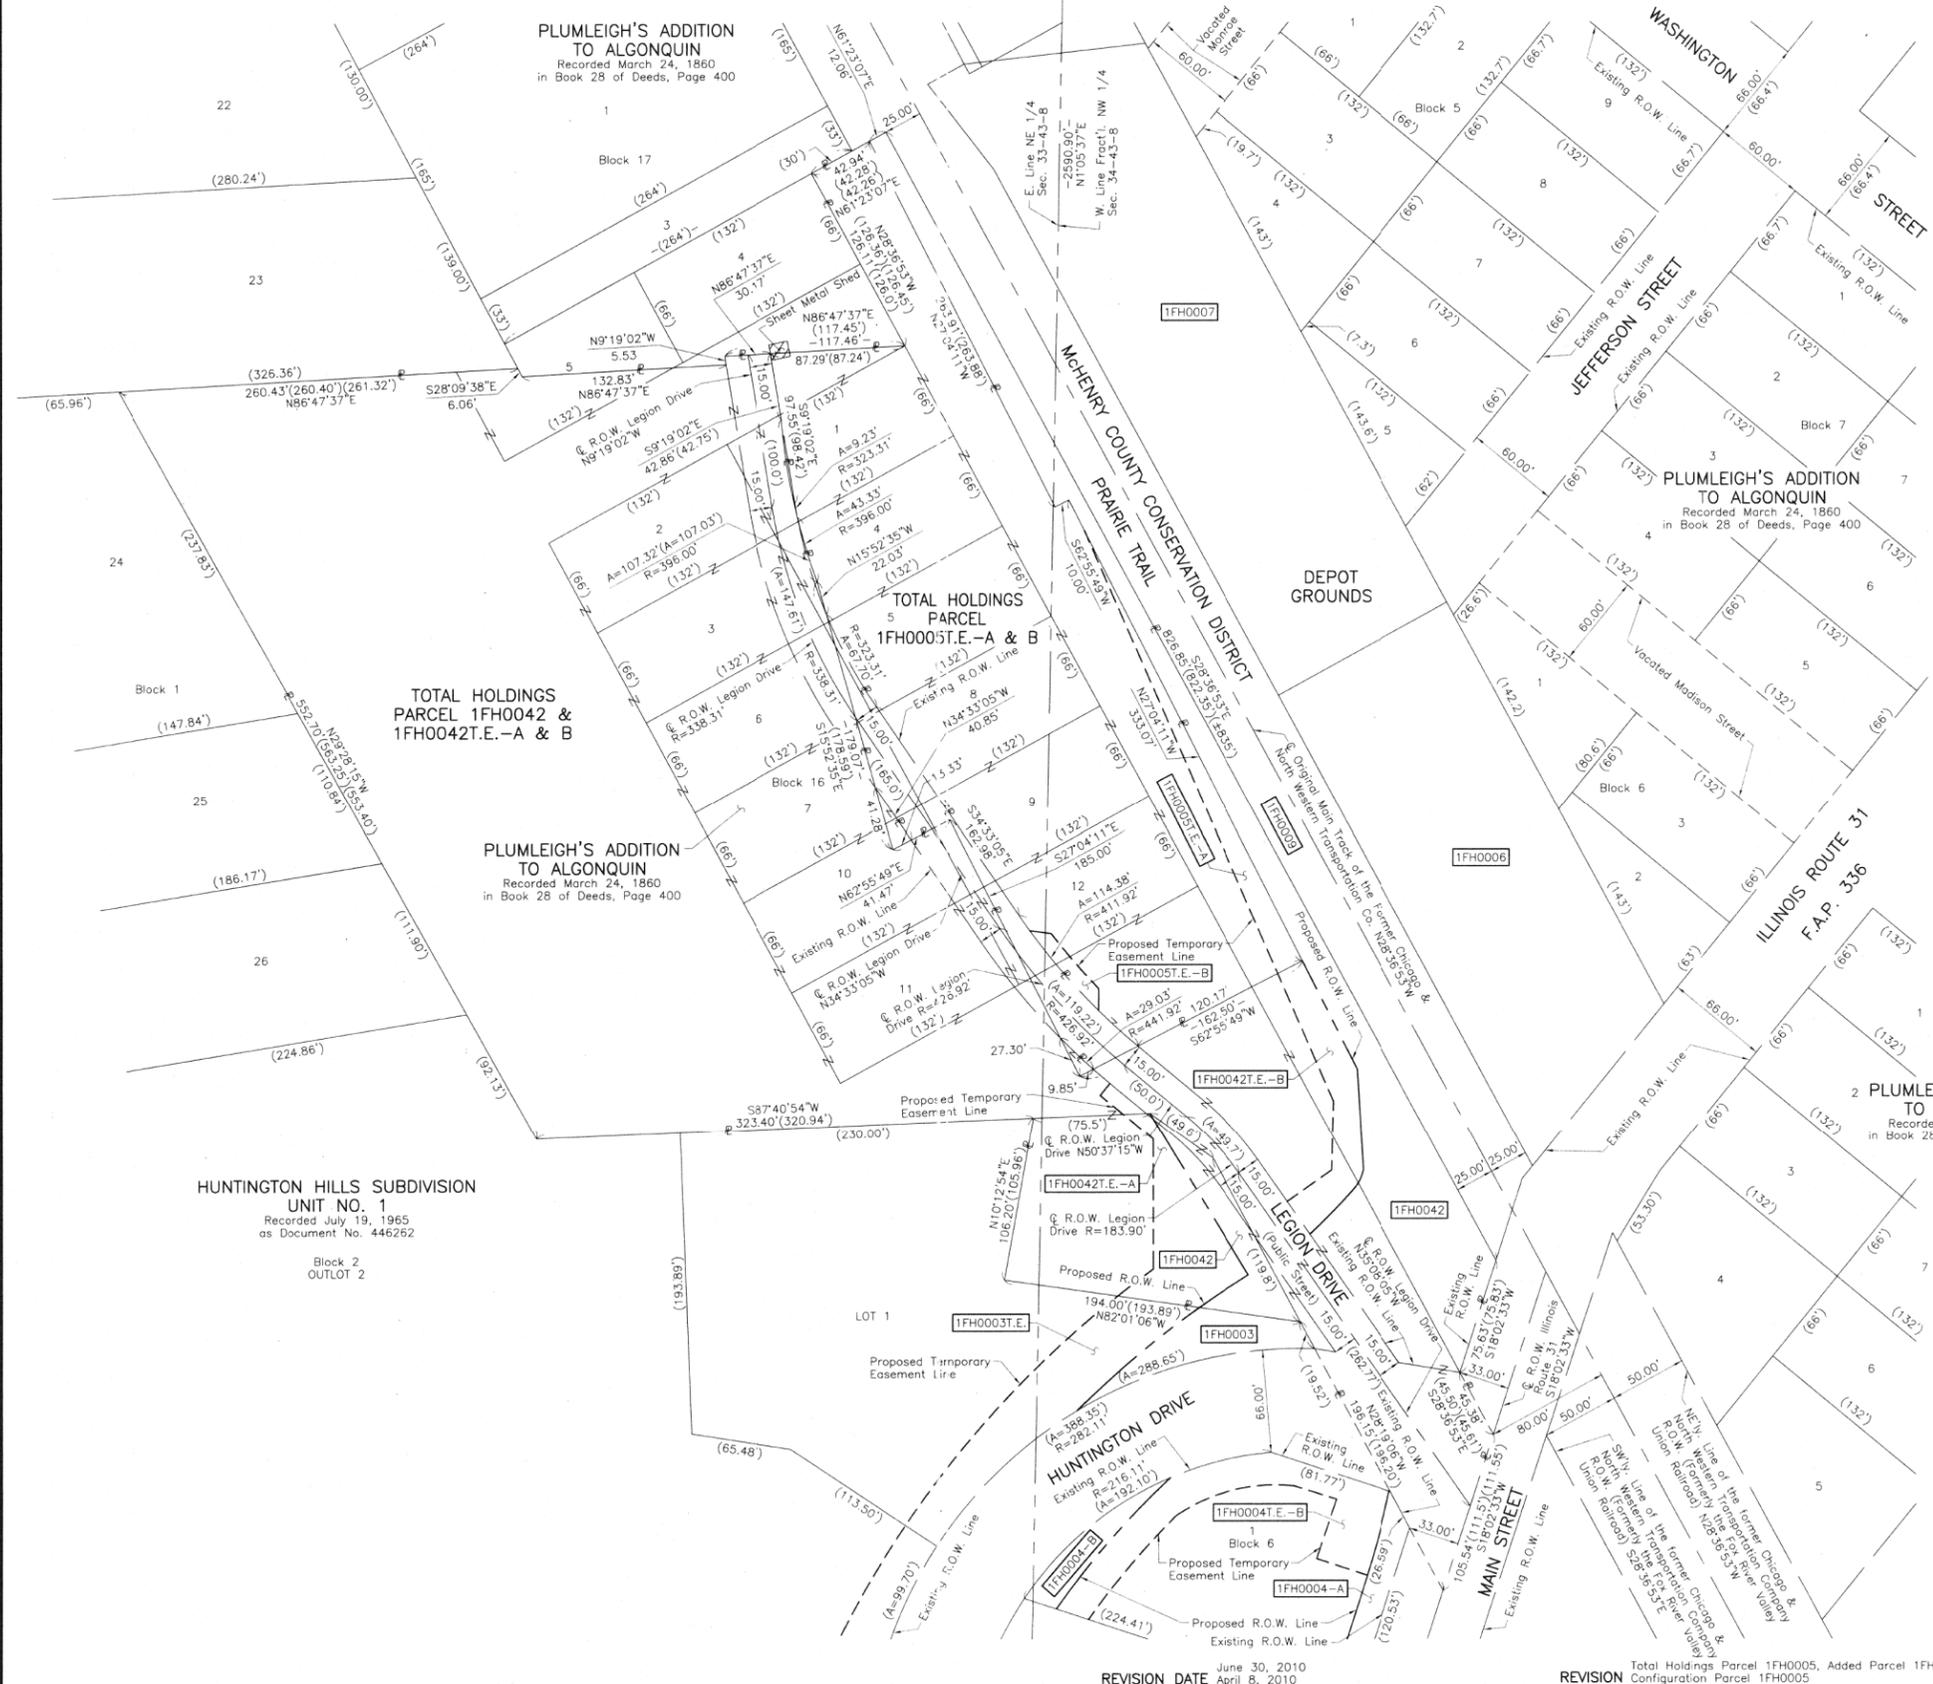

LEGEND

SECTION CORNER: 9 10 15
 QUARTER SECTION CORNER: 16 15

SECTION LINE
 QUARTER SECTION LINE
 QUARTER, QUARTER SECTION LINE
 PLATTED LOT LINE
 PROPERTY (DEED) LINE

APL
 APPARENT PROPERTY LINE
 CENTER LINE
 EXISTING RIGHT OF WAY LINE
 PROPOSED RIGHT OF WAY LINE
 PROPOSED EASEMENT

120.32'
 129.32'(Comp.)
 MEASURED DIMENSION
 COMPUTED DIMENSION
 RECORD DATA

EXISTING BUILDING

Scale: 1"=50'

Bearings are referenced to the Illinois Coordinate System NAD83 (1997) East Zone at Found Geodetic Survey Control Monuments "MCH31 1A", P.I.D. AJ2855 and "Algonquin", P.I.D. AJ2945.

○ IRON PIPE OR ROD FOUND ⊕ "MAG" NAIL SET
 + CUT CROSS FOUND OR SET ● 5/8" REBAR SET

● T1 THESE STAKES REFERRED FOUND OR SET MONUMENTATION. SET 5/8 INCH IRON ROD FLUSH WITH GROUND TO THE FOUND IRON STAKE. IDENTIFIED BY COLORED PLASTIC CAP BEARING SURVEYORS REGISTRATION NUMBER.
 T2
 T3

● BT1 THESE STAKES, IN CULTIVATED AREAS, REFERRED FOUND OR SET MONUMENTATION. BURIED 5/8 INCH IRON ROD 20 INCHES BELOW GROUND TO THE FOUND IRON STAKE. IDENTIFIED BY COLORED PLASTIC CAP BEARING SURVEYORS REGISTRATION NUMBER.
 BT2
 BT3

■ STAKING OF PROPOSED RIGHT OF WAY. SET DIVISION OF HIGHWAYS SURVEY MARKER TO MONUMENT THE POSITION SHOWN. IDENTIFIED BY INSCRIPTION DATA AND SURVEYORS REGISTRATION NUMBER.

■ M STAKING OF PROPOSED RIGHT OF WAY IN CULTIVATED AREAS. BURIED 5/8 INCH METAL ROD 20 INCHES BELOW GROUND TO MARK FUTURE SURVEY MARKER POSITION IDENTIFIED BY COLORED PLASTIC CAP BEARING SURVEYORS REGISTRATION NUMBER.

● PERMANENT SURVEY MARKER, I.D.O.T. STD 2135 (TO BE SET BY OTHERS)

□ RIGHT OF WAY STAKING PROPOSED TO BE SET.

STATE OF ILLINOIS } SS
 COUNTY OF LAKE

THIS IS TO CERTIFY THAT WE, JORGENSEN & ASSOCIATES, INC., AN ILLINOIS PROFESSIONAL DESIGN FIRM LAND SURVEYING CORPORATION, NUMBER 184-2771, HAVE SURVEYED THE PLAT OF HIGHWAYS SHOWN HEREON BETWEEN SECTION 33, TOWNSHIP 43N., RANGE 8E. AND SECTION 34, TOWNSHIP 43N., RANGE 8E., OF THE THIRD PRINCIPAL MERIDIAN, McHENRY COUNTY, THAT THE SURVEY IS TRUE AND COMPLETE AS SHOWN TO THE BEST OF MY KNOWLEDGE AND BELIEF, THAT THE PLAT CORRECTLY REPRESENTS SAID SURVEY, THAT ALL MONUMENTS FOUND AND ESTABLISHED ARE OF PERMANENT QUALITY AND OCCUPY THE POSITIONS SHOWN THEREON AND THAT THE MONUMENTS ARE SUFFICIENT TO ENABLE THE SURVEY TO BE RETRACED, MADE FOR THE DEPARTMENT OF TRANSPORTATION, STATE OF ILLINOIS.

DATED AT LAKE VILLA, ILLINOIS THIS 1st DAY OF June 20, 2010.

CHRISTIAN H. JORGENSEN
 2797
 PROFESSIONAL LAND SURVEYOR
 STATE OF ILLINOIS
 LAKE VILLA, ILLINOIS

CHRISTIAN H. JORGENSEN, PRESIDENT
 ILLINOIS PROFESSIONAL LAND SURVEYOR NO. 35-2797
 LICENSE EXPIRATION DATE: NOVEMBER 30, 2006

THIS PROFESSIONAL SERVICE CONFORMS TO THE CURRENT ILLINOIS MINIMUM STANDARDS FOR A BOUNDARY SURVEY.

RECEIVED
 JUL 07 2010
 PLATS & LEGALS

2 PLUMLEIGH'S ADDITION TO ALGONQUIN
 Recorded March 24, 1860
 in Book 28 of Deeds, Page 400

HUNTINGTON HILLS SUBDIVISION
 UNIT NO. 1
 Recorded July 19, 1965
 as Document No. 446262

TOTAL HOLDINGS PARCEL 1FH0005T.E.-A & B

TOTAL HOLDINGS PARCEL 1FH0042T.E.-A & B

PLUMLEIGH'S ADDITION TO ALGONQUIN
 Recorded March 24, 1860
 in Book 28 of Deeds, Page 400

DATE	BY	MADE	CHECKED	INKED	NOTED
ROW	PLAT	NOTED	BOOK	NO.	

JORGENSEN & ASSOCIATES, INC.
 120 PARK AVENUE
 LAKE VILLA, ILLINOIS 60046 (847) 356-3371

SHEET 1 IS A COVER SHEET AND IS NOT RECORDED.


PLAT OF HIGHWAYS
 STATE OF ILLINOIS
 DEPARTMENT OF TRANSPORTATION
 F.A.P. 336 (ILLINOIS ROUTE 31 BYPASS)
 SECTION 96-00209-00-PV McHENRY COUNTY
 PROJECT JOB NO. R-91-022-03
 STATION NONE TO STATION
 SCALE: 1"=50' SHEET 29 OF 37

BUREAU OF LAND ACQUISITION
 201 WEST CENTER COURT
 SCHAUMBURG, ILLINOIS 60196

ROUTE F.A.P. 336 (ILLINOIS ROUTE 31 BYPASS) SECTION 96-00209-00-PV COUNTY McHENRY JOB NO. R-91-022-03 RECORDING: RECORDED ON AS DOCUMENT NO.

FILE NAME = ... \D160F72-sht-ph-38.dgn	USER NAME = akw	DESIGNED -	REVISED -	STATE OF ILLINOIS DEPARTMENT OF TRANSPORTATION	PLAT OF HIGHWAYS	SCALE: GRAPHIC	SHEET NO. 38 OF 49 SHEETS	STA. TO STA.	O.R. RTE.	SECTION	COUNTY	TOTAL SHEETS	SHEET NO.
		DRAWN - JORGENSEN & ASSOC.	REVISED -						0003	18A-2	MCHEMRY	825	447
		PLOT SCALE = 70.0000' / in.	REVISED -						CONTRACT NO. 60F72				
		PLOT DATE = 5/2/2012	REVISED -						FED. ROAD DIST. NO. 1 ILLINOIS FED. AID PROJECT				

PART OF THE NE 1/4 OF SEC. 33 AND PART OF THE FRACTIONAL NW 1/4 OF SEC. 34, TWP. 43 N., R. 8 E. OF THE 3RD. P.M., IN McHENRY COUNTY, ILLINOIS.

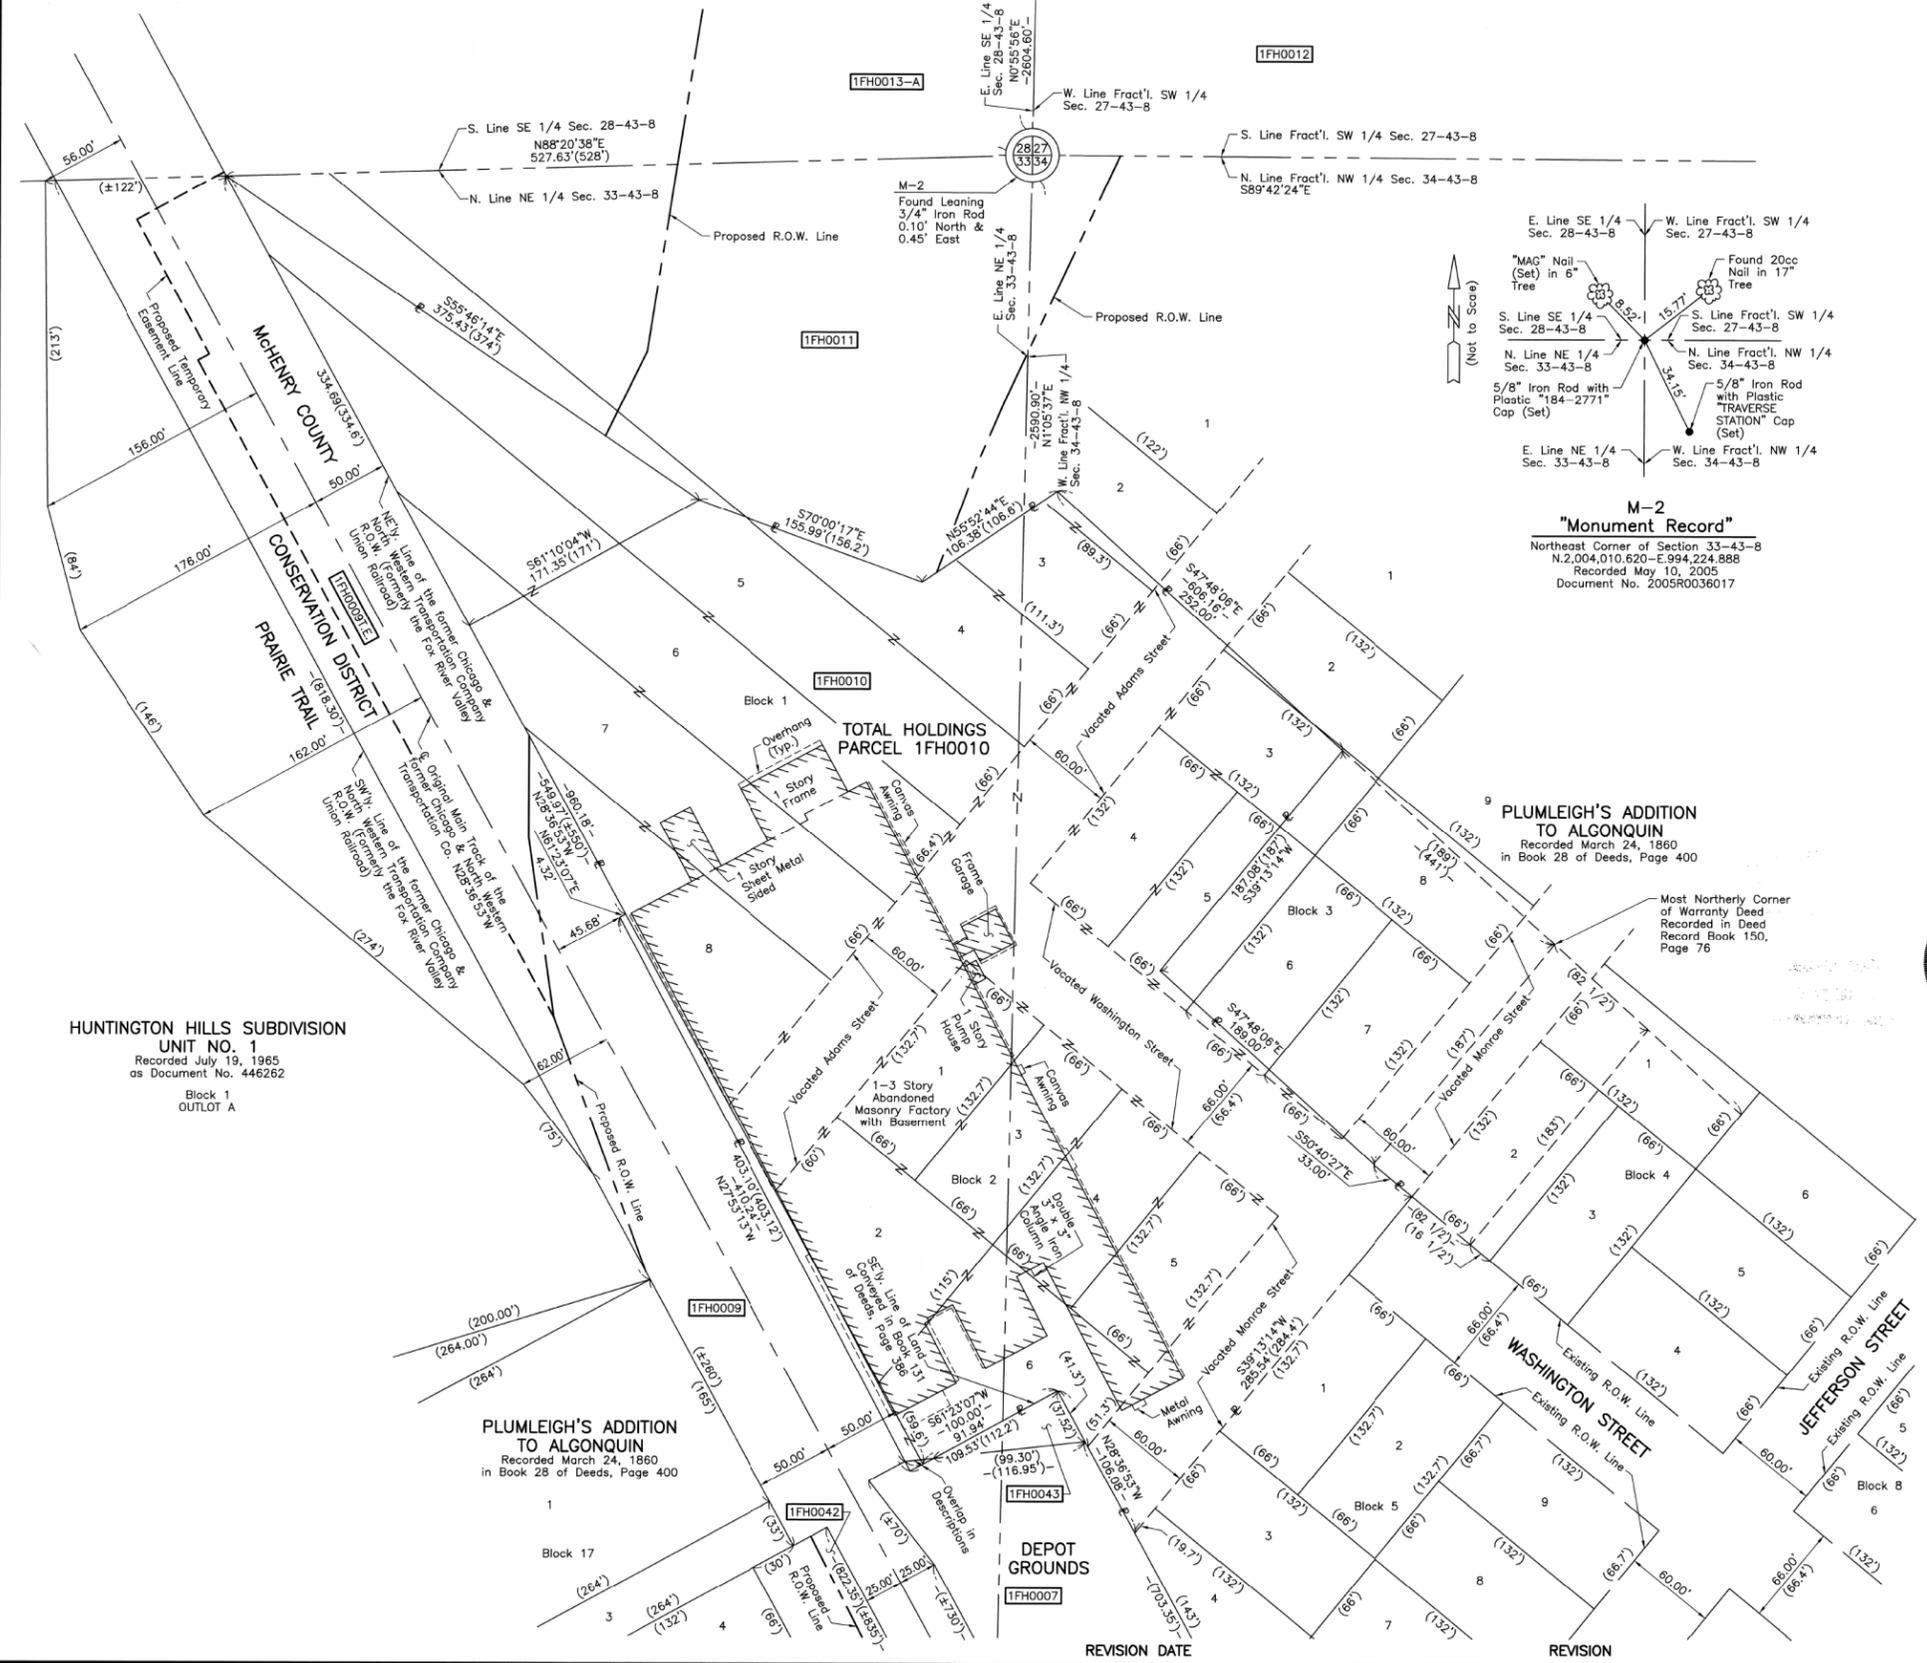

LEGEND

SECTION CORNER
 QUARTER SECTION CORNER
 SECTION LINE
 QUARTER SECTION LINE
 PLATTED LOT LINE
 PROPERTY (DEED) LINE
 APPARENT PROPERTY LINE
 CENTER LINE
 EXISTING RIGHT OF WAY LINE
 PROPOSED EASEMENT
 MEASURED DIMENSION
 COMPUTED DIMENSION
 RECORD DATA
 EXISTING BUILDING

Bearings are referenced to the Illinois Coordinate System NAD83 (1997) East Zone at Found Geodetic Survey Control Monuments "MCH31 1A", P.I.D. AJ2855 and "Algonquin", P.I.D. AJ2945.

O IRON PIPE OR ROD FOUND ⊕ "MAG" NAIL SET
 + CUT CROSS FOUND OR SET ● 5/8" REBAR SET
 ● T1 THESE STAKES REFERENCE FOUND OR SET MONUMENTATION. SET 5/8 INCH IRON ROD FLUSH WITH GROUND TO THE FOUND IRON STAKE. IDENTIFIED BY COLORED PLASTIC CAP BEARING SURVEYORS REGISTRATION NUMBER.
 ● BT1 THESE STAKES, IN CULTIVATED AREAS, REFERENCE FOUND OR SET MONUMENTATION. BURIED 5/8 INCH IRON ROD 20 INCHES BELOW GROUND TO THE FOUND IRON STAKE. IDENTIFIED BY COLORED PLASTIC CAP BEARING SURVEYORS REGISTRATION NUMBER.
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 ⊕ PERMANENT SURVEY MARKER, I.D.O.T STD 2135 (TO BE SET BY OTHERS)
 □ RIGHT OF WAY STAKING PROPOSED TO BE SET.

STATE OF ILLINOIS }
 COUNTY OF LAKE }SS

THIS IS TO CERTIFY THAT WE, JORGENSEN & ASSOCIATES, INC., AN ILLINOIS PROFESSIONAL DESIGN FIRM LAND SURVEYING CORPORATION, NUMBER 184-2771, HAVE SURVEYED THE PLAT OF HIGHWAYS SHOWN HEREON BETWEEN SECTION 33, TOWNSHIP 43N., RANGE 8E. AND SECTION 34, TOWNSHIP 43N., RANGE 8E., OF THE THIRD PRINCIPAL MERIDIAN, McHENRY COUNTY, THAT THE SURVEY IS TRUE AND COMPLETE AS SHOWN TO THE BEST OF MY KNOWLEDGE AND BELIEF, THAT THE PLAT CORRECTLY REPRESENTS SAID SURVEY, THAT ALL MONUMENTS FOUND AND ESTABLISHED ARE OF PERMANENT QUALITY AND OCCUPY THE POSITIONS SHOWN THEREON AND THAT THE MONUMENTS ARE SUFFICIENT TO ENABLE THE SURVEY TO BE RETRACED. MADE FOR THE DEPARTMENT OF TRANSPORTATION, STATE OF ILLINOIS.

DATED AT LAKE VILLA, ILLINOIS THIS 10th DAY OF May 2006 A.D.

RECEIVED
 APR 12 2012
 PLATS & LEGALS

M-2 "Monument Record"

Northeast Corner of Section 33-43-8
 N.2,004,010.620-E.994,224.888
 Recorded May 10, 2005
 Document No. 2005R036017

BY	DATE	MADE	CHECKED	INKED	NOTED

HUNTINGTON HILLS SUBDIVISION
UNIT NO. 1
 Recorded July 19, 1965
 as Document No. 446262
 Block 1
 OUTLOT A

PLUMLEIGH'S ADDITION TO ALGONQUIN
 Recorded March 24, 1860
 in Book 28 of Deeds, Page 400

JORGENSEN & ASSOCIATES, INC.
 120 PARK AVENUE
 LAKE VILLA, ILLINOIS 60046
 (847) 356-3371

PLAT OF HIGHWAYS
STATE OF ILLINOIS
DEPARTMENT OF TRANSPORTATION
 F.A.P. 336 (ILLINOIS ROUTE 31 BYPASS)
 SECTION 96-00209-00-PV McHENRY COUNTY
 PROJECT JOB NO. R-91-022-03
 STATION NONE TO STATION
 SCALE: 1"=50'
 SHEET 30 OF 32

BUREAU OF LAND ACQUISITION
201 WEST CENTER COURT
SCHAUMBURG, ILLINOIS 60196

ROUTE F.A.P. 336 (ILLINOIS ROUTE 31 BYPASS) SECTION 96-00209-00-PV COUNTY McHENRY JOB NO. R-91-022-03 RECORDING: RECORDED ON AS DOCUMENT NO.

FILE NAME = ...\\D160F72-sht-PH-39.dgn	USER NAME = akw	DESIGNED -	REVISED -	STATE OF ILLINOIS DEPARTMENT OF TRANSPORTATION	PLAT OF HIGHWAYS	O.R. RTE.	SECTION	COUNTY	TOTAL SHEETS	SHEET NO.	
		DRAWN - JORGENSEN & ASSOC.	REVISED -			0003	18A-2	McHENRY	825	448	
		CHECKED - CJ	REVISED -			CONTRACT NO. 60F72					
		DATE -	REVISED -			SCALE: GRAPHIC	SHEET NO. 39 OF 49 SHEETS	STA.	TO STA.	FED. ROAD DIST. NO. 1 ILLINOIS FED. AID PROJECT	

PART OF THE NE 1/4 OF SEC. 33 AND PART OF THE FRACTIONAL NW 1/4 OF SEC. 34, TWP. 43 N., R. 8 E. OF THE 3RD. P.M., IN McHENRY COUNTY, ILLINOIS.

LEGEND

SECTION CORNER
QUARTER SECTION CORNER

SECTION LINE
QUARTER SECTION LINE
PLATTED LOT LINE
PROPERTY (DEED) LINE

APPL
APPARENT PROPERTY LINE
CENTER LINE
EXISTING RIGHT OF WAY LINE
PROPOSED RIGHT OF WAY LINE
PROPOSED EASEMENT
MEASURED DIMENSION
COMPUTED DIMENSION
RECORD DATA

EXISTING BUILDING

SCALE: 1"=100'

Bearings are referenced to the Illinois Coordinate System NAD83 (1997) East Zone at Found Geodetic Survey Control Monuments "MCH31 1A" P.I.D. AJ2855 and "Algonquin", P.I.D. AJ2945.

○ IRON PIPE OR ROD FOUND ⊗ "MAG" NAIL SET
+ CUT CROSS FOUND OR SET ● 5/8" REBAR SET

● T1 THESE STAKES REFERENCE FOUND OR SET MONUMENTATION. SET 5/8 INCH IRON ROD FLUSH WITH GROUND TO TIE FOUND IRON STAKE. IDENTIFIED BY COLORED PLASTIC CAP BEARING SURVEYORS REGISTRATION NUMBER.
● T2
● T3

● BT1 THESE STAKES, IN CULTIVATED AREAS, REFERENCE FOUND OR SET MONUMENTATION. BURIED 5/8 INCH IRON ROD 20 INCHES BELOW GROUND TO TIE FOUND IRON STAKE. IDENTIFIED BY COLORED PLASTIC CAP BEARING SURVEYORS REGISTRATION NUMBER.
● BT2
● BT3

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■ M STAKING OF PROPOSED RIGHT OF WAY IN CULTIVATED AREAS. BURIED 5/8 INCH METAL ROD 20 INCHES BELOW GROUND TO MARK FUTURE SURVEY MARKER POSITION IDENTIFIED BY COLORED PLASTIC CAP BEARING SURVEYORS REGISTRATION NUMBER.

⊕ PERMANENT SURVEY MARKER, I.D.O.T STD 2135 (TO BE SET BY OTHERS)

□ RIGHT OF WAY STAKING PROPOSED TO BE SET.

STATE OF ILLINOIS }
COUNTY OF LAKE }SS

THIS IS TO CERTIFY THAT WE, JORGENSEN & ASSOCIATES, INC., AN ILLINOIS PROFESSIONAL DESIGN FIRM LAND SURVEYING CORPORATION, NUMBER 184-2771, HAVE SURVEYED THE PLAT OF HIGHWAYS SHOWN HEREON BETWEEN SECTION 33, TOWNSHIP 43N., RANGE 8E. AND SECTION 34, TOWNSHIP 43N., RANGE 8E., OF THE THIRD PRINCIPAL MERIDIAN, McHENRY COUNTY, THAT THE SURVEY IS TRUE AND COMPLETE AS SHOWN TO THE BEST OF MY KNOWLEDGE AND BELIEF, THAT THE PLAT CORRECTLY REPRESENTS SAID SURVEY, THAT ALL MONUMENTS FOUND AND ESTABLISHED ARE OF PERMANENT QUALITY AND OCCUPY THE POSITIONS SHOWN THEREON AND THAT THE MONUMENTS ARE SUFFICIENT TO ENABLE THE SURVEY TO BE RETRACED. MADE FOR THE DEPARTMENT OF TRANSPORTATION, STATE OF ILLINOIS.


DATED AT LAKE VILLA, ILLINOIS THIS _____ DAY OF _____ 20__ A.D.



PRESIDENT
ILLINOIS PROFESSIONAL LAND SURVEYOR NO. 35-2797
LICENSE EXPIRATION DATE: NOVEMBER 30, 2006

THIS PROFESSIONAL SERVICE CONFORMS TO THE CURRENT ILLINOIS MINIMUM STANDARDS FOR A BOUNDARY SURVEY.

BY	DATE
MADE	
CHECKED	
RECORDED	
ROW PLAT	
NOTEBOOK NO.	

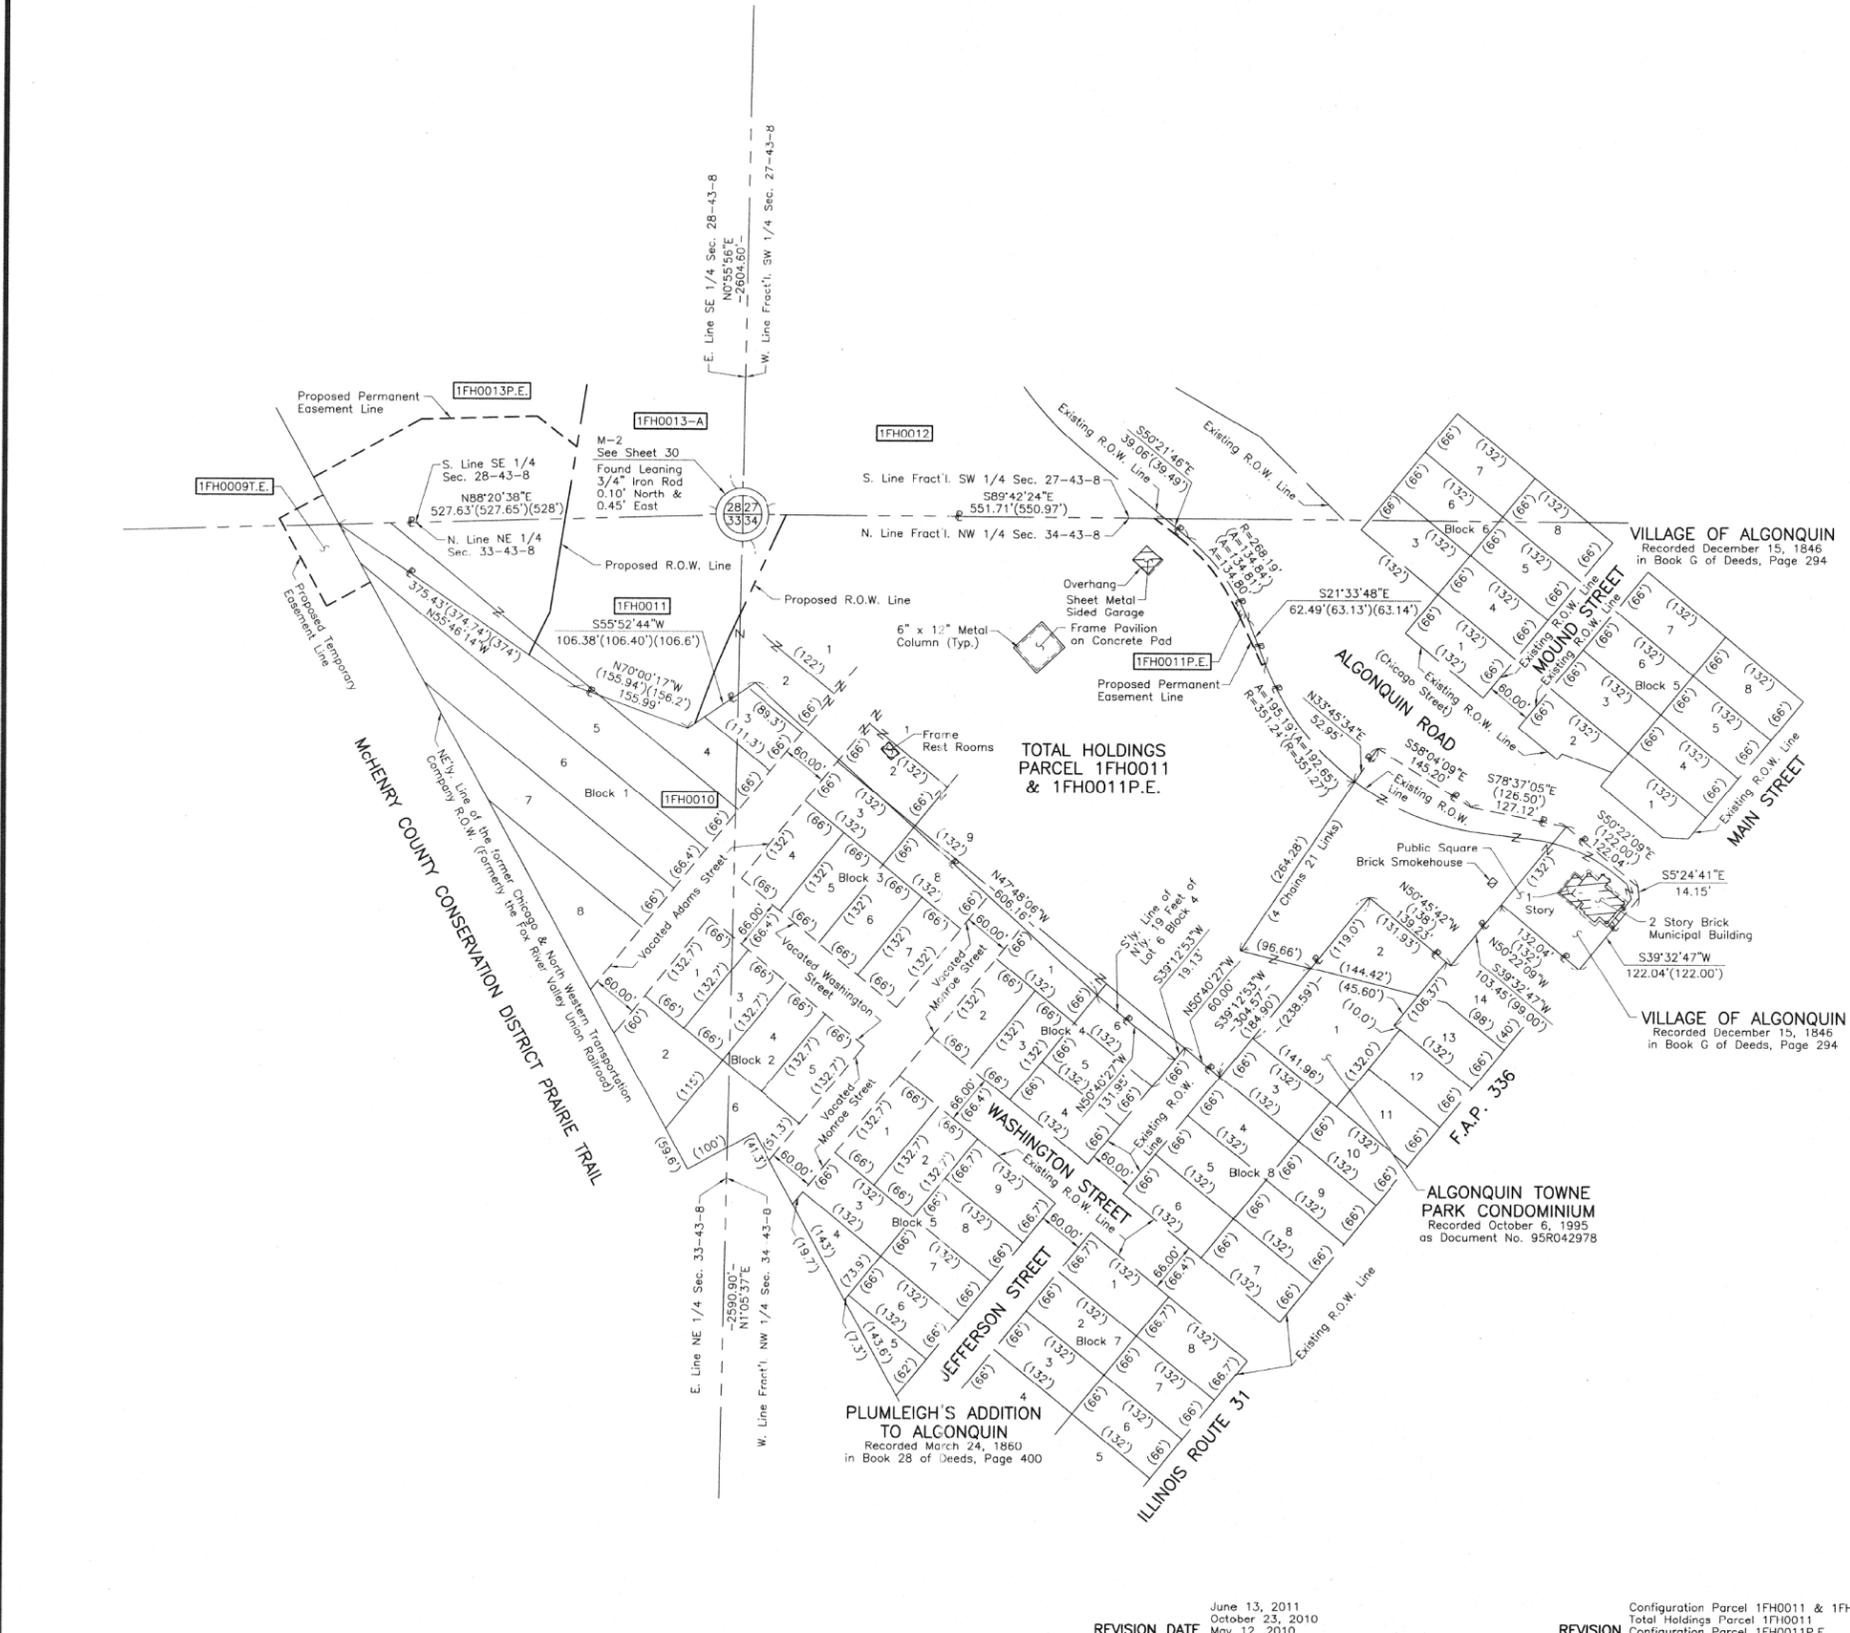

ROUTE F.A.P. 336 (ILLINOIS ROUTE 31 BYPASS) SECTION 96-00209-00-PV COUNTY McHENRY JOB NO. R-91-022-03 RECORDING: RECORDED ON AS DOCUMENT NO.

FILE NAME = ... \D160F72-sht-PH-40.dgn	USER NAME = akw	DESIGNED -	REVISED -	STATE OF ILLINOIS DEPARTMENT OF TRANSPORTATION	PLAT OF HIGHWAYS	O.R. RTE.	SECTION	COUNTY	TOTAL SHEETS	SHEET NO.	
		DRAWN - JORGENSEN & ASSOC.	REVISED -			0003	18A-2	McHENRY	825	449	
		CHECKED - CJ	REVISED -			CONTRACT NO. 60F72					
		DATE -	REVISED -			FED. ROAD DIST. NO. 1 ILLINOIS FED. AID PROJECT					
						SCALE: GRAPHIC	SHEET NO. 40 OF 49 SHEETS	STA.	TO STA.		

RECEIVED
JUN 14 2011
PLATS & LEGALS

JORGENSEN & ASSOCIATES, INC.
120 PARK AVENUE
LAKE VILLA, ILLINOIS 60046
(847) 356-3371

SHEET 1 IS A COVER
SHEET AND IS NOT RECORDED.

PLAT OF HIGHWAYS
STATE OF ILLINOIS
DEPARTMENT OF TRANSPORTATION
F.A.P. 336 (ILLINOIS ROUTE 31 BYPASS)
SECTION 96-00209-00-PV McHENRY COUNTY
PROJECT JOB NO. R-91-022-03
STATION NONE TO STATION
SCALE: 1"=100' SHEET 31 OF 37

BUREAU OF LAND ACQUISITION
201 WEST CENTER COURT
SCHAUMBURG, ILLINOIS 60196

June 13, 2011
October 23, 2010
May 12, 2010

REVISION DATE


Configuration Parcel 1FH0011 & 1FH0011P.E.
Total Holdings Parcel 1FH0011
Configuration Parcel 1FH0011P.E.

REVISION


MADE BY

PART OF THE SW 1/4 OF SEC. 22, PART OF THE WEST 1/2 OF SEC. 27 AND PART OF THE EAST 1/2 OF SEC. 28, TWP. 43 N., R. 8 E. OF THE 3RD. P.M., IN McHENRY COUNTY, ILLINOIS.

LEGEND

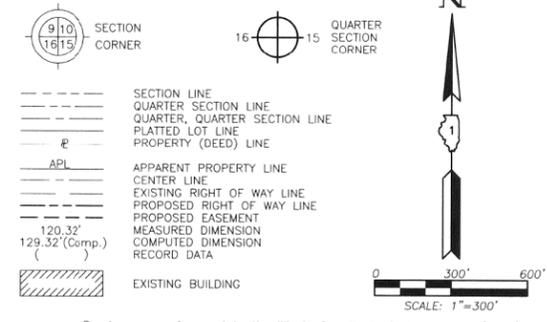

- SECTION LINE
 - QUARTER SECTION LINE
 - PLATTED LOT LINE
 - PROPERTY (DEED) LINE
 - APL
 - APPARENT PROPERTY LINE
 - CENTER LINE
 - EXISTING RIGHT OF WAY LINE
 - PROPOSED RIGHT OF WAY LINE
 - PROPOSED EASEMENT
 - MEASURED DIMENSION
 - COMPUTED DIMENSION
 - RECORD DATA
 - EXISTING BUILDING
- Bearings are referenced to the Illinois Coordinate System NAD83 (1997) East Zone at Found Geodetic Survey Control Monuments "MCH31 1A", P.I.D. AJ2855 and "Algonquin", P.I.D. AJ2945.
- IRON PIPE OR ROD FOUND
 - ⊕ "MAG" NAIL SET
 - + CUT CROSS FOUND OR SET
 - 5/8" REBAR SET
 - T1 THESE STAKES REFERENCE FOUND OR SET MONUMENTATION. SET 5/8 INCH IRON ROD FLUSH WITH GROUND TO THE FOUND IRON STAKE. IDENTIFIED BY COLORED PLASTIC CAP BEARING SURVEYORS REGISTRATION NUMBER.
 - T2
 - T3
 - BT1 THESE STAKES, IN CULTIVATED AREAS, REFERENCE FOUND OR SET MONUMENTATION. BURIED 5/8 INCH IRON ROD 20 INCHES BELOW GROUND TO THE FOUND IRON STAKE. IDENTIFIED BY COLORED PLASTIC CAP BEARING SURVEYORS REGISTRATION NUMBER.
 - BT2
 - BT3
 - STAKING OF PROPOSED RIGHT OF WAY. SET DIVISION OF HIGHWAYS SURVEY MARKER TO MONUMENT THE POSITION SHOWN. IDENTIFIED BY INSCRIPTION DATA AND SURVEYORS REGISTRATION NUMBER.
 - M STAKING OF PROPOSED RIGHT OF WAY IN CULTIVATED AREAS. BURIED 5/8 INCH METAL ROD 20 INCHES BELOW GROUND TO MARK FUTURE SURVEY MARKER POSITION IDENTIFIED BY COLORED PLASTIC CAP BEARING SURVEYORS REGISTRATION NUMBER.
 - PERMANENT SURVEY MARKER, I.D.O.T STD 2135 (TO BE SET BY OTHERS)
 - RIGHT OF WAY STAKING PROPOSED TO BE SET.

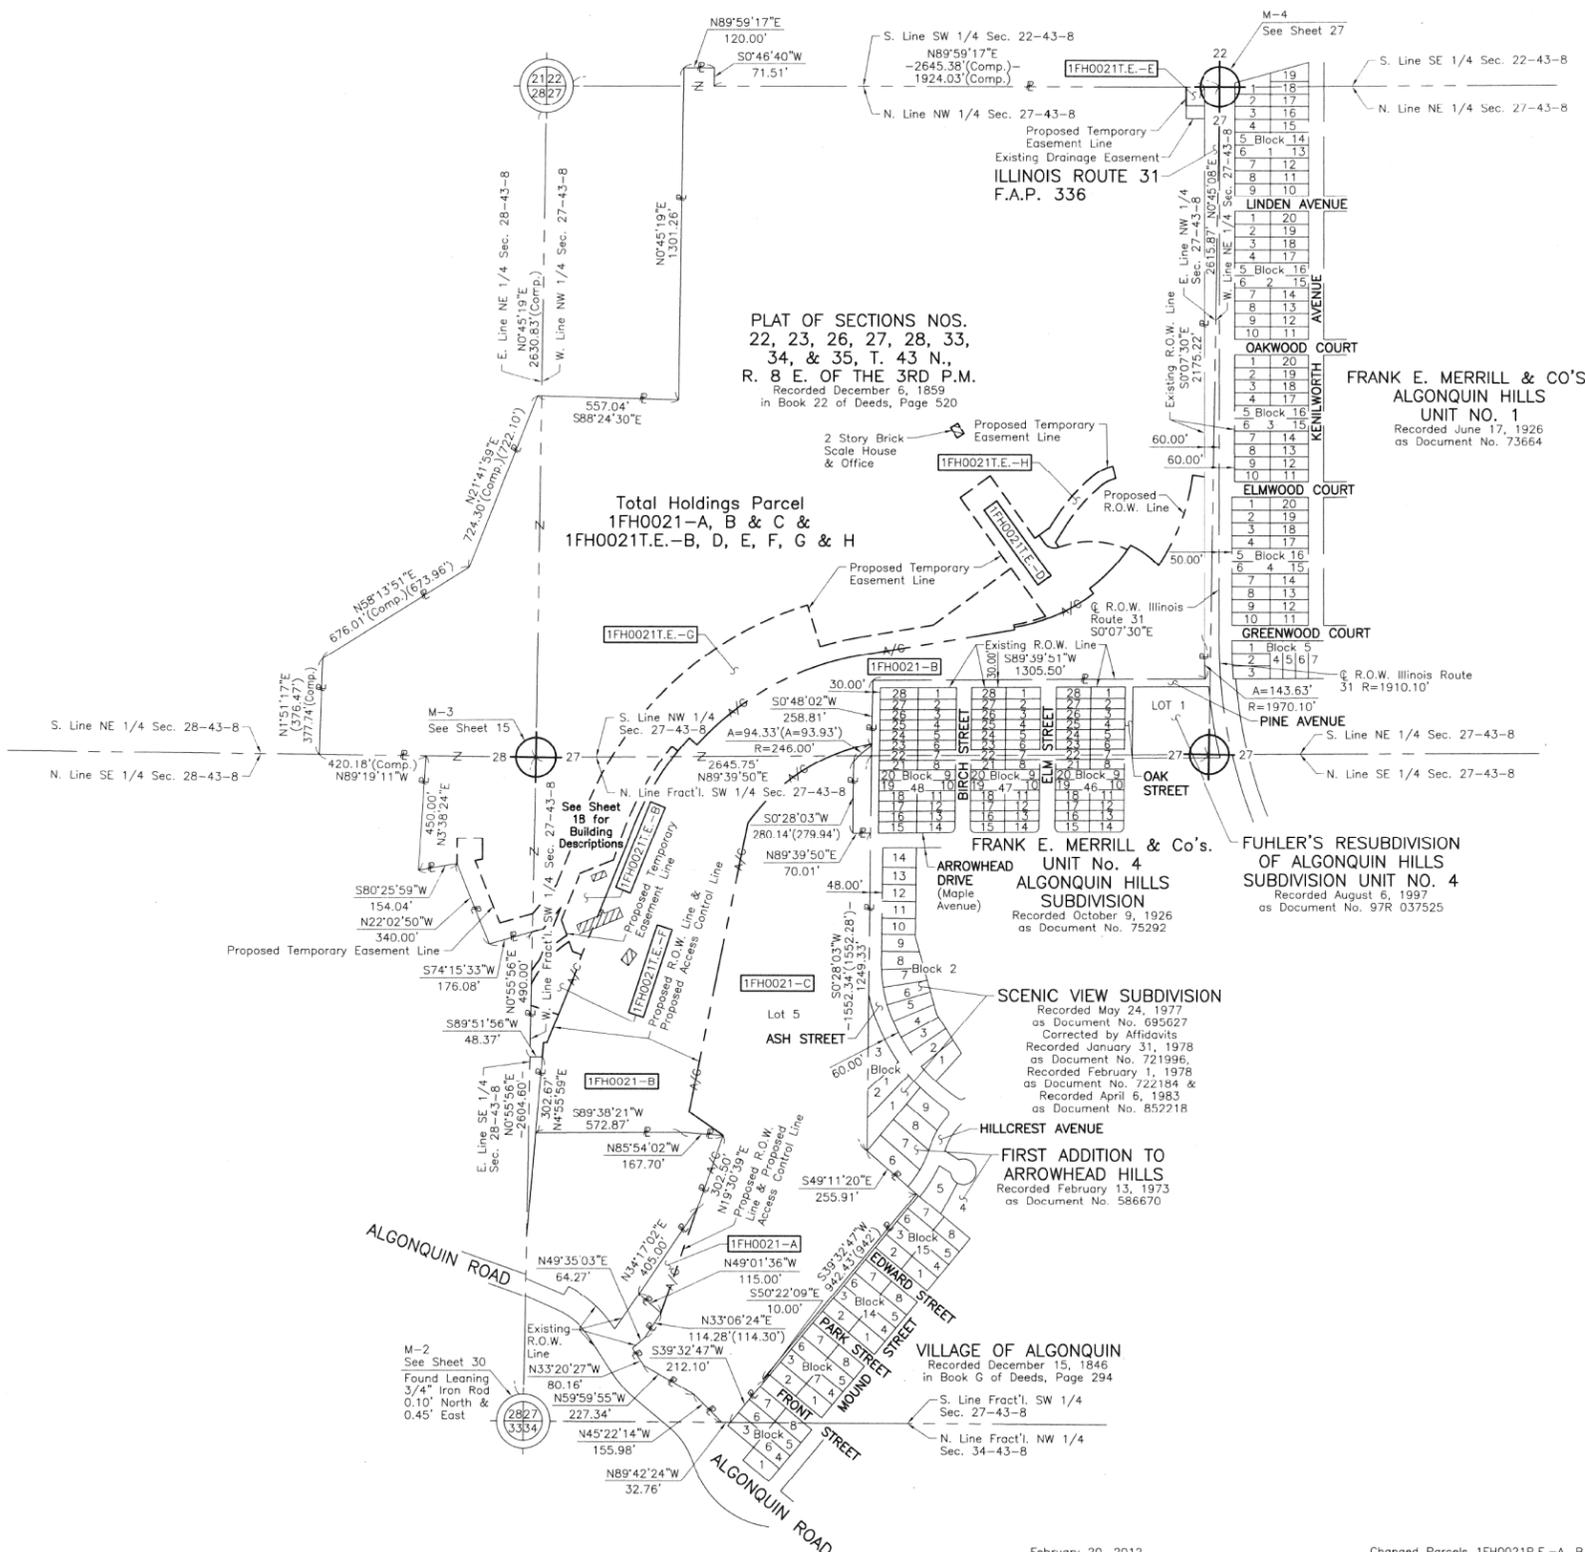

DATE	BY
MADE	CHECKED
INKED	
NOTEBOOK NO.	



RECEIVED
FEB 22 2012
PLATS & LEGALS

ILLINOIS PROFESSIONAL LAND SURVEYOR NO. 35-2797
LICENSE EXPIRATION DATE: NOVEMBER 30, 2006
THIS PROFESSIONAL SERVICE CONFORMS TO THE CURRENT ILLINOIS MINIMUM STANDARDS FOR A BOUNDARY SURVEY.

JORGENSEN & ASSOCIATES, INC.
120 PARK AVENUE
LAKE VILLA, ILLINOIS 60046
(847) 356-3371

PLAT OF HIGHWAYS
STATE OF ILLINOIS
DEPARTMENT OF TRANSPORTATION
F.A.P. 336 (ILLINOIS ROUTE 31 BYPASS)
SECTION 96-00209-00-PV McHENRY COUNTY
PROJECT JOB NO. R-91-022-03
STATION NONE TO STATION
SCALE: 1"=300' SHEET 32 OF 32

BUREAU OF LAND ACQUISITION
201 WEST CENTER COURT
SCHAUMBURG, ILLINOIS 60196

ROUTE F.A.P. 336 (ILLINOIS ROUTE 31 BYPASS) SECTION 96-00209-00-PV COUNTY McHENRY JOB NO. R-91-022-03 RECORDING: RECORDED ON AS DOCUMENT NO.

FILE NAME =
...ND160F72-sht-PH-41.dgn

USER NAME = akw	DESIGNED -	REVISED -
PLOT SCALE = 70.0000' / in.	DRAWN - JORGENSEN & ASSOC.	REVISED -
PLOT DATE = 5/2/2012	CHECKED - CJ	REVISED -
	DATE -	REVISED -


STATE OF ILLINOIS
DEPARTMENT OF TRANSPORTATION

SCALE: GRAPHIC	SHEET NO. 41 OF 49 SHEETS	STA. TO STA.
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O.R. RTE.	SECTION	COUNTY	TOTAL SHEETS	SHEET NO.
0003	18A-2	McHENRY	825	450
CONTRACT NO. 60F72				
FED. ROAD DIST. NO. 1 ILLINOIS FED. AID PROJECT				

PART OF THE NORTH 1/2 OF SEC. 27 AND PART OF THE FRACTIONAL SOUTH 1/2 OF SEC. 27, TWP. 43 N., R. 8 E. OF THE 3RD. P.M., IN McHENRY COUNTY, ILLINOIS.

LEGEND

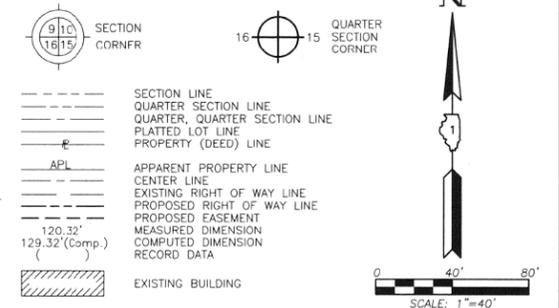

- Beatings are referenced to the Illinois Coordinate System NAD83 (1997) East Zone at Found Geodetic Survey Control Monuments "MCH31 1A", P.I.D. AJ2855 and "Algonquin", P.I.D. AJ2945.
- IRON PIPE OR ROD FOUND ⊕ "MAG" NAIL SET
- + CUT CROSS FOUND OR SET ● 5/8" REBAR SET
- T1 THESE STAKES REFERENCE FOUND OR SET MONUMENTATION. SET 5/8 INCH IRON ROD FLUSH WITH GROUND TO THE FOUND IRON STAKE, IDENTIFIED BY COLORED PLASTIC CAP BEARING SURVEYORS REGISTRATION NUMBER.
- BT1 THESE STAKES, IN CULTIVATED AREAS, REFERENCE FOUND OR SET MONUMENTATION. BURIED 5/8 INCH IRON ROD 20 INCHES BELOW GROUND TO THE FOUND IRON STAKE, IDENTIFIED BY COLORED PLASTIC CAP BEARING SURVEYORS REGISTRATION NUMBER.
- STAKING OF PROPOSED RIGHT OF WAY. SET DIVISION OF HIGHWAYS SURVEY MARKER TO MONUMENT THE POSITION SHOWN, IDENTIFIED BY INSCRIPTION DATA AND SURVEYORS REGISTRATION NUMBER.
- M STAKING OF PROPOSED RIGHT OF WAY IN CULTIVATED AREAS. BURIED 5/8 INCH METAL ROD 20 INCHES BELOW GROUND TO MARK FUTURE SURVEY MARKER POSITION IDENTIFIED BY COLORED PLASTIC CAP BEARING SURVEYORS REGISTRATION NUMBER.
- ⊙ PERMANENT SURVEY MARKER, I.D.O.T. STD 2135 (TO BE SET BY OTHERS)
- RIGHT OF WAY STAKING PROPOSED TO BE SET.

STATE OF ILLINOIS }
 COUNTY OF LAKE }SS

THIS IS TO CERTIFY THAT WE, JORGENSEN & ASSOCIATES, INC., AN ILLINOIS PROFESSIONAL DESIGN FIRM LAND SURVEYING CORPORATION, NUMBER 184-2771, HAVE SURVEYED THE PLAT OF HIGHWAYS SHOWN HEREIN IN SECTION 27, TOWNSHIP 43N., RANGE 8E. OF THE THIRD PRINCIPAL MERIDIAN, McHENRY COUNTY, THAT THE SURVEY IS TRUE AND COMPLETE AS SHOWN TO THE BEST OF MY KNOWLEDGE AND BELIEF, THAT THE PLAT CORRECTLY REPRESENTS SAID SURVEY, THAT ALL MONUMENTS FOUND AND ESTABLISHED ARE OF PERMANENT QUALITY AND OCCUPY THE POSITIONS SHOWN THEREON AND THAT THE MONUMENTS ARE SUFFICIENT TO ENABLE THE SURVEY TO BE RETRACED, MADE FOR THE DEPARTMENT OF TRANSPORTATION, STATE OF ILLINOIS.

DATED AT LAKE VILLA, ILLINOIS THIS _____ DAY OF _____ 20__ A.D.



RECEIVED
 FEB 22 2012
 PLATS & LEGALS


PRESIDENT
 ILLINOIS PROFESSIONAL LAND SURVEYOR NO. 35-2797
 LICENSE EXPIRATION DATE: NOVEMBER 30, 2006
 THIS PROFESSIONAL SERVICE CONFORMS TO THE CURRENT ILLINOIS MINIMUM STANDARDS FOR A BOUNDARY SURVEY.

JORGENSEN & ASSOCIATES, INC.
 120 PARK AVENUE
 LAKE VILLA, ILLINOIS 60046
 (847) 356-3371

PLAT OF HIGHWAYS
 STATE OF ILLINOIS
 DEPARTMENT OF TRANSPORTATION
 F.A.P. 336 (ILLINOIS ROUTE 31 BYPASS)
 SECTION 96-00209-00-PV McHENRY COUNTY
 PROJECT JOB NO. R-91-022-03
 STATION NONE TO STATION
 SCALE: 1"=40' SHEET 34 OF 37

BUREAU OF LAND ACQUISITION
 201 WEST CENTER COURT
 SCHAUMBURG, ILLINOIS 60196

BY	DATE
MADE	
CHECKED	
INDEXED	
NOTEBOOK	
NO	

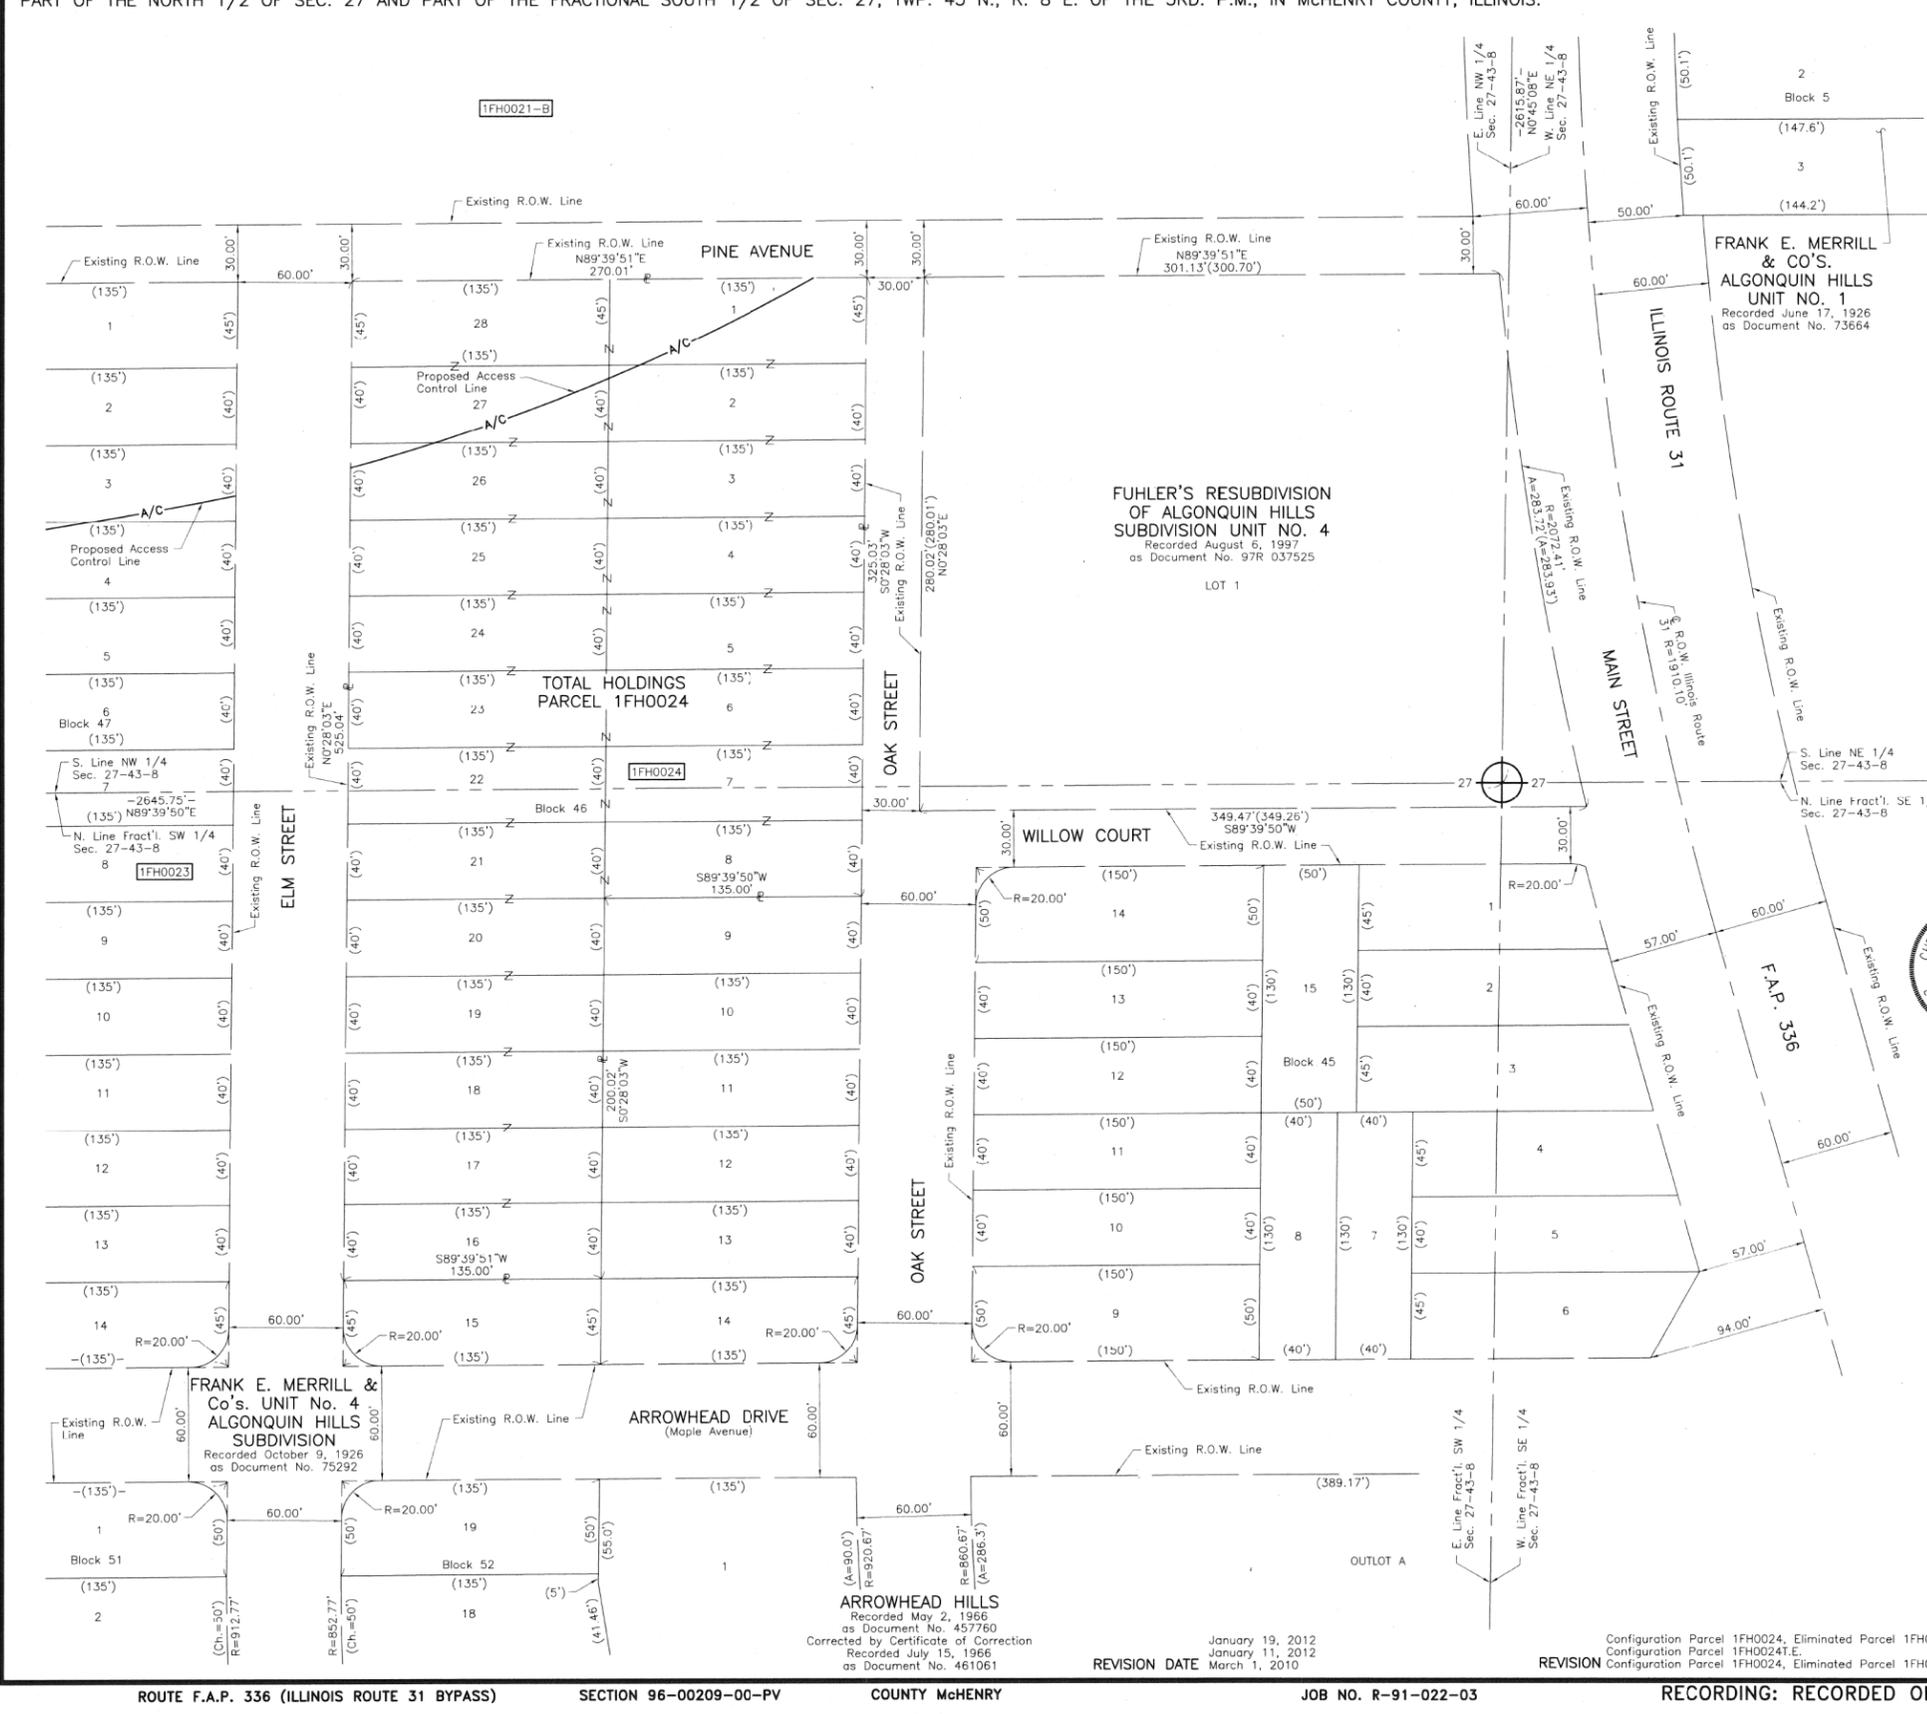

ROUTE F.A.P. 336 (ILLINOIS ROUTE 31 BYPASS) SECTION 96-00209-00-PV COUNTY McHENRY JOB NO. R-91-022-03 RECORDING: RECORDED ON AS DOCUMENT NO.

FILE NAME = ...\\D160F72-sht-PH-43.dgn


USER NAME = akw	DESIGNED -	REVISED -
PLOT SCALE = 70.0000' / in.	DRAWN - JORGENSEN & ASSOC.	REVISED -
PLOT DATE = 5/2/2012	CHECKED - CJ	REVISED -
	DATE -	REVISED -

STATE OF ILLINOIS
 DEPARTMENT OF TRANSPORTATION

PLAT OF HIGHWAYS
 SCALE: GRAPHIC SHEET NO. 43 OF 49 SHEETS STA. TO STA.

O.R. RTE.	SECTION	COUNTY	TOTAL SHEETS	SHEET NO.
0003	18A-2	McHENRY	825	452
CONTRACT NO. 60F72				
FED. ROAD DIST. NO. 1 ILLINOIS FED. AID PROJECT				

PART OF THE SOUTH 1/2 OF SEC. 22 AND PART OF THE NORTH 1/2 OF SEC. 27, TWP. 43 N., R. 8 E. OF THE 3RD. P.M., IN McHENRY COUNTY, ILLINOIS.

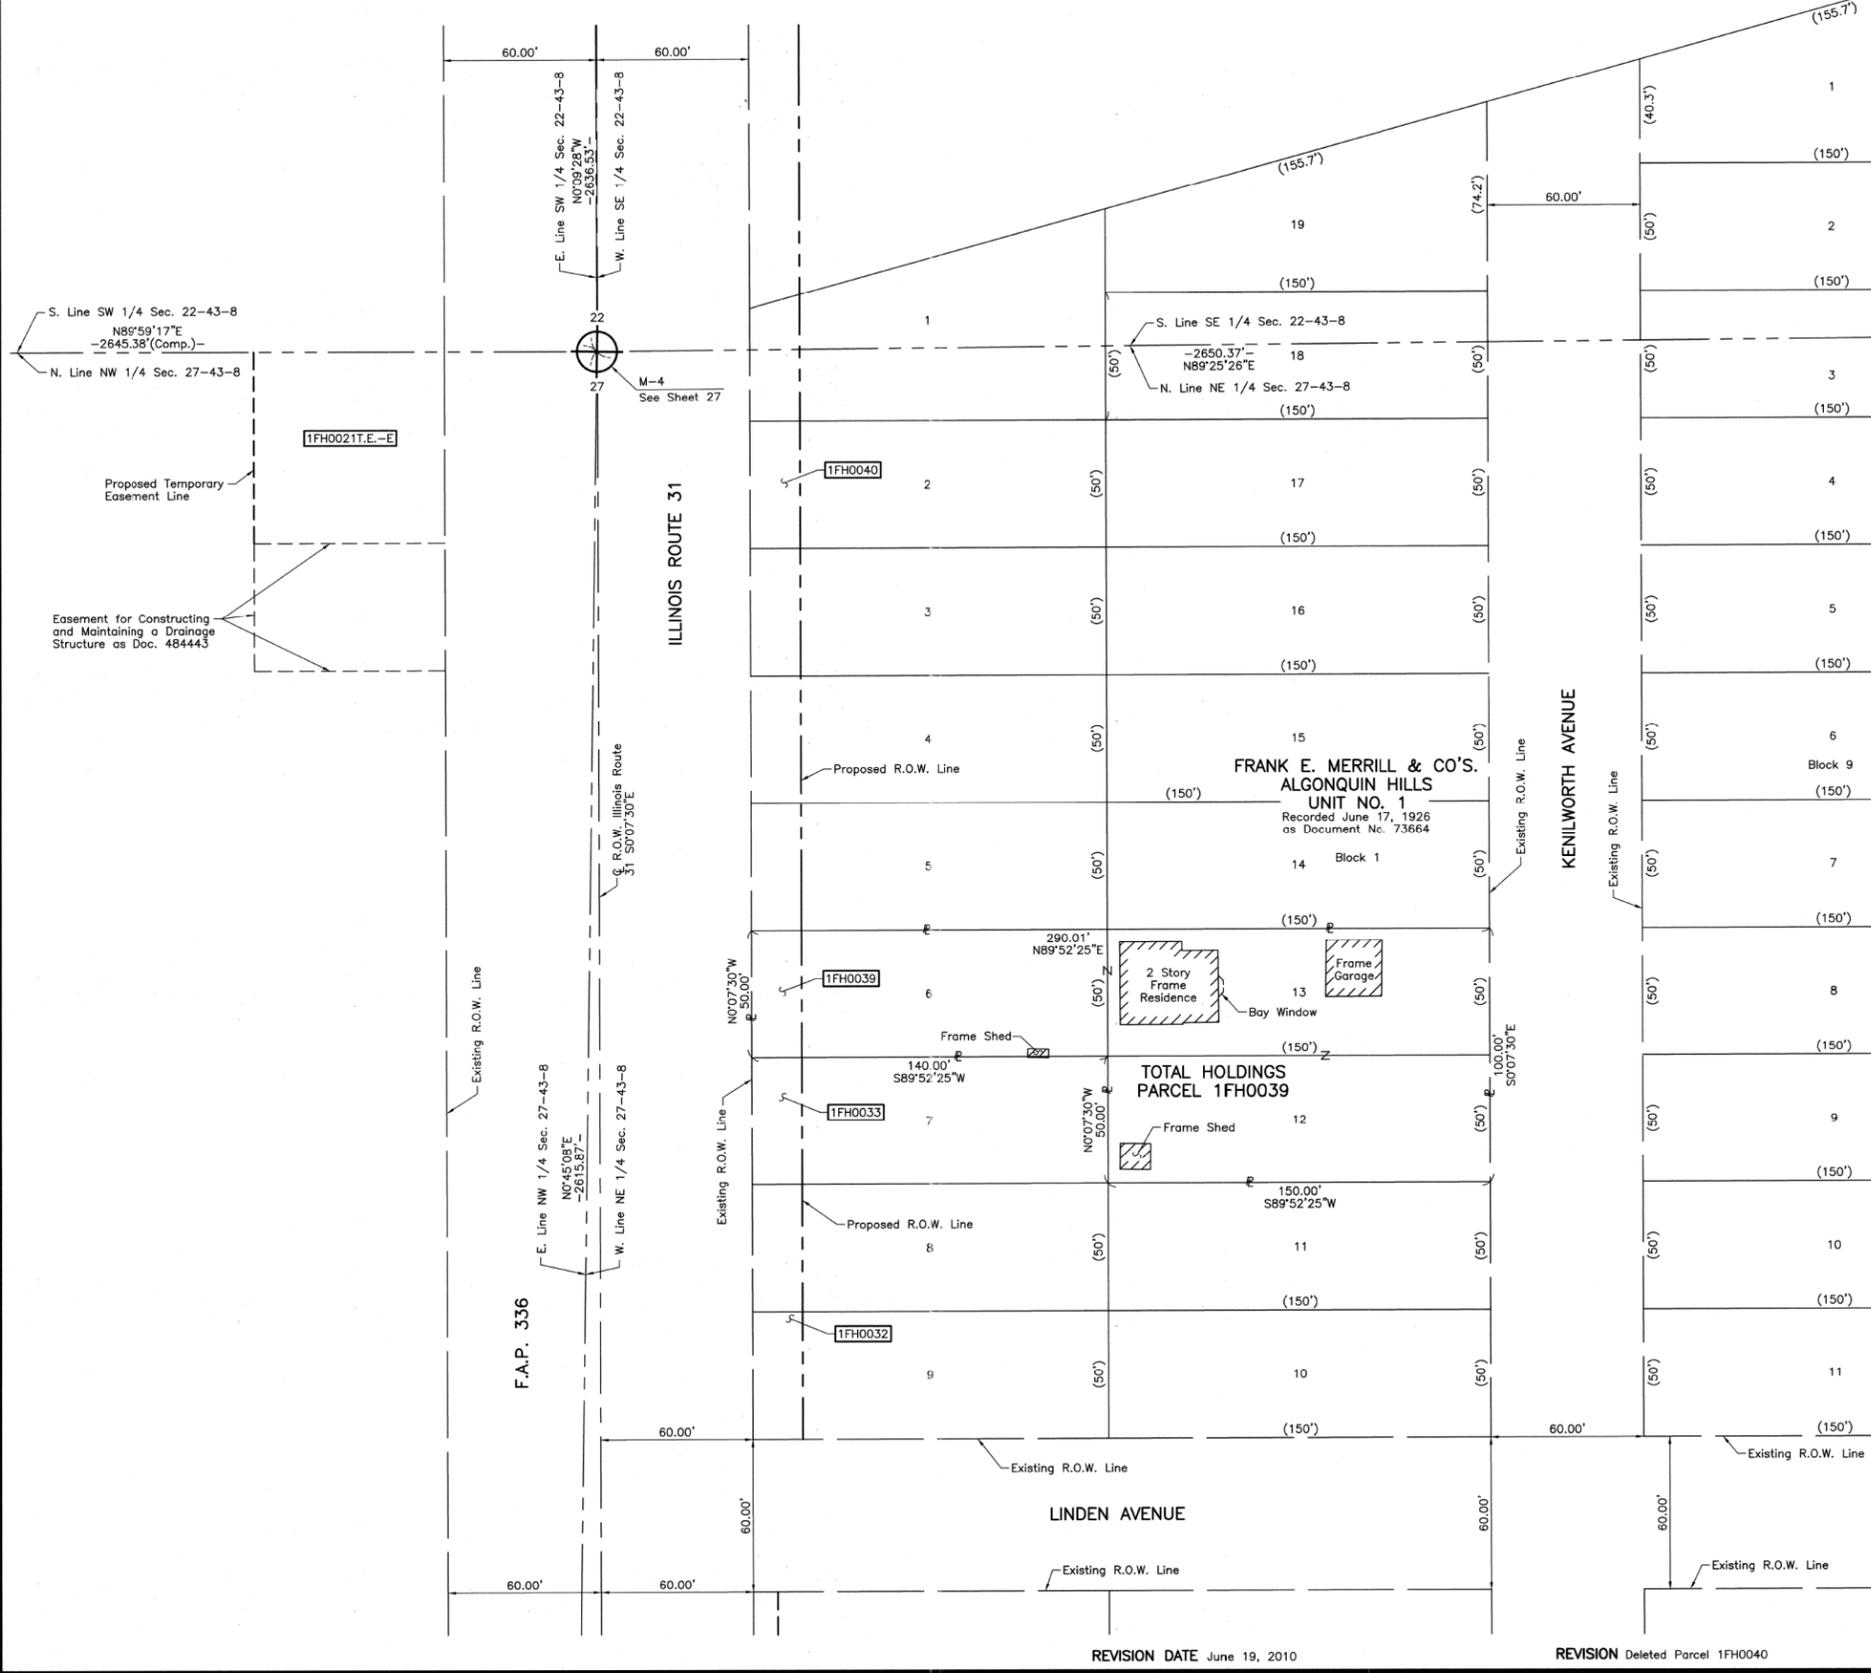

LEGEND

- SECTION CORNER
- QUARTER SECTION CORNER
- SECTION LINE
- QUARTER SECTION LINE
- PLATTED LOT LINE
- PROPERTY (DEED) LINE
- APPARENT PROPERTY LINE
- CENTER LINE
- EXISTING RIGHT OF WAY LINE
- PROPOSED RIGHT OF WAY LINE
- PROPOSED EASEMENT
- MEASURED DIMENSION
- COMPUTED DIMENSION
- RECORD DATA
- EXISTING BUILDING

Bearings are referenced to the Illinois Coordinate System NAD83 (1997) East Zone at Found Geodetic Survey Control Monuments "MCH31 1A", P.I.D. AJ2855 and "Algonquin", P.I.D. AJ2945.

SCALE: 1"=30'

- IRON PIPE OR ROD FOUND
- ⊕ "MAG" NAIL SET
- + CUT CROSS FOUND OR SET
- 5/8" REBAR SET
- T1 THESE STAKES REFERENCE FOUND OR SET MONUMENTATION. SET 5/8 INCH IRON ROD FLUSH WITH GROUND TO THE FOUND IRON STAKE. IDENTIFIED BY COLORED PLASTIC CAP BEARING SURVEYORS REGISTRATION NUMBER.
- T2
- T3
- BT1 THESE STAKES, IN CULTIVATED AREAS, REFERENCE FOUND OR SET MONUMENTATION. BURIED 5/8 INCH IRON ROD 20 INCHES BELOW GROUND TO THE FOUND IRON STAKE. IDENTIFIED BY COLORED PLASTIC CAP BEARING SURVEYORS REGISTRATION NUMBER.
- BT2
- BT3
- STAKING OF PROPOSED RIGHT OF WAY. SET DIVISION OF HIGHWAYS SURVEY MARKER TO MONUMENT THE POSITION SHOWN. IDENTIFIED BY INSCRIPTION DATA AND SURVEYORS REGISTRATION NUMBER.
- M STAKING OF PROPOSED RIGHT OF WAY IN CULTIVATED AREAS. BURIED 5/8 INCH METAL ROD 20 INCHES BELOW GROUND TO MARK FUTURE SURVEY MARKER POSITION IDENTIFIED BY COLORED PLASTIC CAP BEARING SURVEYORS REGISTRATION NUMBER.
- ⊙ PERMANENT SURVEY MARKER, I.D.O.T STD 2135 (TO BE SET BY OTHERS)
- RIGHT OF WAY STAKING PROPOSED TO BE SET.

STATE OF ILLINOIS }
 COUNTY OF LAKE }
 THIS IS TO CERTIFY THAT WE, JORGENSEN & ASSOCIATES, INC., AN ILLINOIS PROFESSIONAL DESIGN FIRM LAND SURVEYING CORPORATION, NUMBER 184-2771, HAVE SURVEYED THE PLAT OF HIGHWAYS SHOWN HEREON BETWEEN SECTION 22, TOWNSHIP 43N., RANGE 8E. AND SECTION 27, TOWNSHIP 43N., RANGE 8E. OF THE THIRD PRINCIPAL MERIDIAN, McHENRY COUNTY, THAT THE SURVEY IS TRUE AND COMPLETE AS SHOWN TO THE BEST OF MY KNOWLEDGE AND BELIEF, THAT THE PLAT CORRECTLY REPRESENTS SAID SURVEY, THAT ALL MONUMENTS FOUND AND ESTABLISHED ARE OF PERMANENT QUALITY AND OCCUPY THE POSITIONS SHOWN THEREON AND THAT THE MONUMENTS ARE SUFFICIENT TO ENABLE THE SURVEY TO BE RETRACED. MADE FOR THE DEPARTMENT OF TRANSPORTATION, STATE OF ILLINOIS.

DATED AT LAKE VILLA, ILLINOIS THIS 5th DAY OF March 20 2011 A.D.

PRESIDENT
 ILLINOIS PROFESSIONAL LAND SURVEYOR NO. 35-2797
 LICENSE EXPIRATION DATE: NOVEMBER 30, 2010
 THIS PROFESSIONAL SERVICE CONFORMS TO THE CURRENT ILLINOIS MINIMUM STANDARDS FOR A BOUNDARY SURVEY.

RECEIVED
 MAY 02 2011
 PLATS & LEGALS

JORGENSEN & ASSOCIATES, INC.
 120 PARK AVENUE
 LAKE VILLA, ILLINOIS 60046
 (847) 356-3371

SHEET 1 IS A COVER SHEET AND IS NOT RECORDED.

PLAT OF HIGHWAYS
 STATE OF ILLINOIS
 DEPARTMENT OF TRANSPORTATION
 F.A.P. 336 (ILLINOIS ROUTE 31 BYPASS)
 SECTION 96-00209-00-PV McHENRY COUNTY
 PROJECT JOB NO. R-91-022-03
 STATION NONE TO STATION
 SCALE: 1"=30' SHEET 34A OF 37.

BUREAU OF LAND ACQUISITION
 201 WEST CENTER COURT
 SCHAUMBURG, ILLINOIS 60196



ROW PLAT	MADE	DATE
	CHECKED	
NOTEBOOK	LINKED	
NO.		

ROUTE F.A.P. 336 (ILLINOIS ROUTE 31 BYPASS) SECTION 96-00209-00-PV COUNTY McHENRY JOB NO. R-91-022-03 RECORDING: RECORDED ON AS DOCUMENT NO.

FILE NAME = ...\\D160F72-sht-PH-44.dgn	USER NAME = akw	DESIGNED -	REVISED -	STATE OF ILLINOIS DEPARTMENT OF TRANSPORTATION	PLAT OF HIGHWAYS	O.R. RTE.	SECTION	COUNTY	TOTAL SHEETS	SHEET NO.
		DRAWN - JORGENSEN & ASSOC.	REVISED -			0003	18A-2	McHENRY	825	453
		CHECKED - CJ	REVISED -			CONTRACT NO. 60F72				
		DATE -	REVISED -			SCALE: GRAPHIC	SHEET NO. 44 OF 49 SHEETS	STA.	TO STA.	FED. ROAD DIST. NO. 1 ILLINOIS FED. AID PROJECT

PART OF THE SOUTH 1/2 OF SEC. 22 AND PART OF THE NORTH 1/2 OF SEC. 27, TWP. 43 N., R. 8 E. OF THE 3RD. P.M., IN McHENRY COUNTY, ILLINOIS.

LEGEND

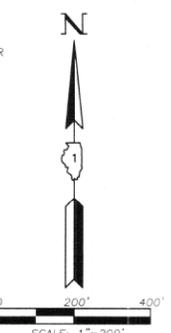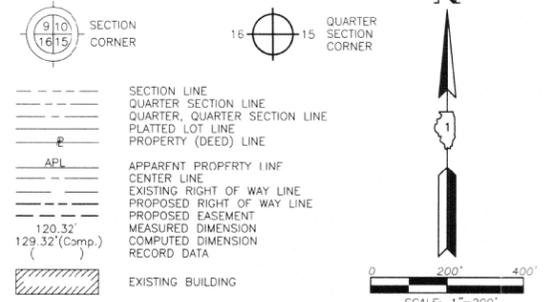

Bearings are referenced to the Illinois Coordinate System NAD83 (1997) East Zone at Found Geodetic Survey Control Monuments "MCH31 1A", P.I.D. AJ2855 and "Algonquin", P.I.D. AJ2945.

○ IRON PIPE OR ROD FOUND ⊕ "MAG" NAIL SET
 + CUT CROSS FOUND OR SET ● 5/8" REBAR SET

● T1 THESE STAKES REFERENCE FOUND OR SET MONUMENTATION. SET 5/8 INCH IRON ROD FLUSH WITH GROUND TO TIE FOUND IRON STAKE, IDENTIFIED BY COLORED PLASTIC CAP BEARING SURVEYORS REGISTRATION NUMBER.
 T2
 T3

● BT1 THESE STAKES, IN CULTIVATED AREAS, REFERENCE FOUND OR SET MONUMENTATION. BURIED 5/8 INCH IRON ROD 20 INCHES BELOW GROUND TO TIE FOUND IRON STAKE, IDENTIFIED BY COLORED PLASTIC CAP BEARING SURVEYORS REGISTRATION NUMBER.
 BT2
 BT3

■ STAKING OF PROPOSED RIGHT OF WAY. SET DIVISION OF HIGHWAYS SURVEY MARKER TO MONUMENT THE POSITION SHOWN, IDENTIFIED BY INSCRIPTION DATA AND SURVEYORS REGISTRATION NUMBER.

■ M STAKING OF PROPOSED RIGHT OF WAY IN CULTIVATED AREAS. BURIED 5/8 INCH METAL ROD 20 INCHES BELOW GROUND TO MARK FUTURE SURVEY MARKER POSITION IDENTIFIED BY COLORED PLASTIC CAP BEARING SURVEYORS REGISTRATION NUMBER.

● PERMANENT SURVEY MARKER, I.D.O.T STD 2135 (TO BE SET BY OTHERS)

□ RIGHT OF WAY STAKING PROPOSED TO BE SET.


STATE OF ILLINOIS }
 COUNTY OF LAKE }SS

THIS IS TO CERTIFY THAT WE, JORGENSEN & ASSOCIATES, INC., AN ILLINOIS PROFESSIONAL DESIGN FIRM LAND SURVEYING CORPORATION, NUMBER 184-2771, HAVE SURVEYED THE PLAT OF HIGHWAYS SHOWN HEREON BETWEEN SECTION 22, TOWNSHIP 43N., RANGE 8E. AND SECTION 27, TOWNSHIP 43N., RANGE 8E. OF THE THIRD PRINCIPAL MERIDIAN, McHENRY COUNTY, THAT THE SURVEY IS TRUE AND COMPLETE AS SHOWN TO THE BEST OF MY KNOWLEDGE AND BELIEF, THAT THE PLAT CORRECTLY REPRESENTS SAID SURVEY, THAT ALL MONUMENTS FOUND AND ESTABLISHED ARE OF PERMANENT QUALITY AND OCCUPY THE POSITIONS SHOWN THEREON AND THAT THE MONUMENTS ARE SUFFICIENT TO ENABLE THE SURVEY TO BE RETRACED. MADE FOR THE DEPARTMENT OF TRANSPORTATION, STATE OF ILLINOIS.

DATED AT LAKE VILLA, ILLINOIS THIS 26th DAY OF June 2010 A.D.

Christian H. Jorgensen PRESIDENT
 2797 PROFESSIONAL LAND SURVEYOR STATE OF ILLINOIS
 LICENSE EXPIRATION DATE: NOVEMBER 30, 2010
 THIS PROFESSIONAL SERVICE CONFORMS TO THE CURRENT ILLINOIS MINIMUM STANDARDS FOR A BOUNDARY SURVEY.

COORDINATES ARE BASED ON THE PUBLISHED METRIC COORDINATE VALUES AT FOUND NATIONAL GEODETIC SURVEY CONTROL MONUMENT "MCH31 1A", P.I.D. AJ2855, OF N.613,205.182-E.303,895.917.
 NOTE: SURFACE COORDINATES ARE SHOWN.

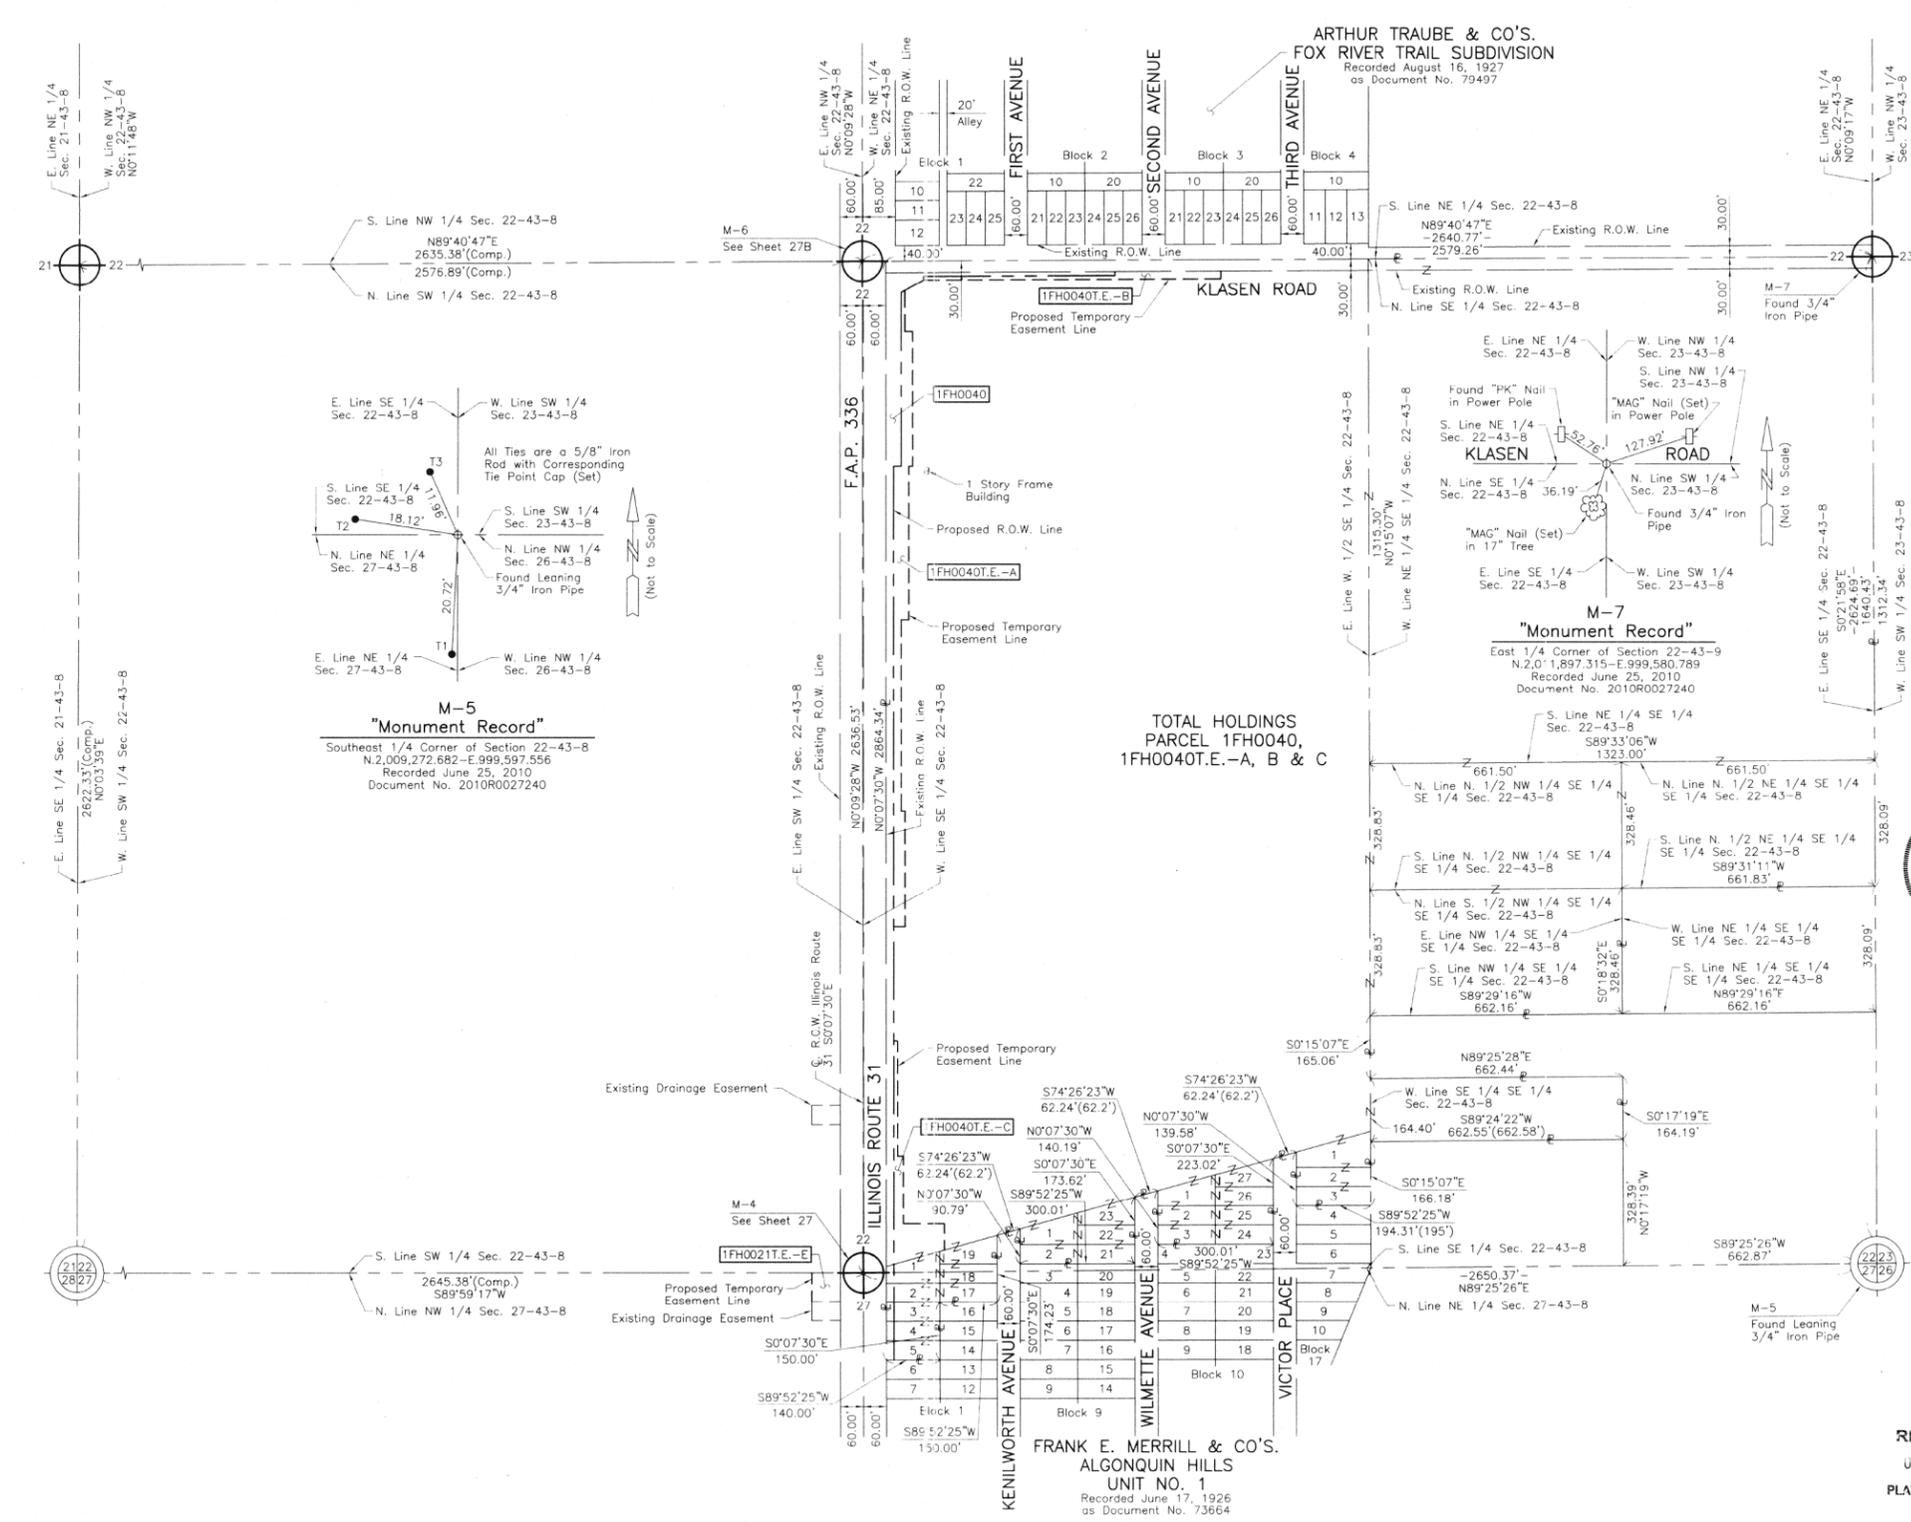

ROW PLAT	MADE	DATE
	CHECKED	
	IN/REV	
NOTEBOOK NO.		

FRANK E. MERRILL & CO'S.
 ALGONQUIN HILLS
 UNIT NO. 1
 Recorded June 17, 1926
 as Document No. 73664

TOTAL HOLDINGS
 PARCEL 1FH0040,
 1FH0040T.E.-A, B & C

RECEIVED
 OCT 19 2010
 PLATS & LEGALS

JORGENSEN & ASSOCIATES, INC.
 120 PARK AVENUE
 LAKE VILLA, ILLINOIS 60046
 (847) 356-3371

SHEET 1 IS A COVER SHEET AND IS NOT RECORDED.

PLAT OF HIGHWAYS
 STATE OF ILLINOIS
 DEPARTMENT OF TRANSPORTATION
 F.A.P. 336 (ILLINOIS ROUTE 31 BYPASS)
 SECTION 96-00209-00-PV McHENRY COUNTY
 PROJECT STATION NONE TO STATION NONE
 SCALE: 1"=200' SHEET 34B OF 37

BUREAU OF LAND ACQUISITION
 201 WEST CENTER COURT
 SCHAUMBURG, ILLINOIS 60196

ROUTE F.A.P. 336 (ILLINOIS ROUTE 31 BYPASS) SECTION 96-00209-00-PV COUNTY McHENRY JOB NO. R-91-022-03 REVISION DATE October 18, 2010 REVISION Added Parcel 1FH0040T.E.-C MADE BY AS DOCUMENT NO.

FILE NAME = ...\\D160F72-sht-PH-45.dgn

USER NAME = okw	DESIGNED -	REVISED -
	DRAWN - JORGENSEN & ASSOC.	REVISED -
PLOT SCALE = 70.0000' / in.	CHECKED - CJ	REVISED -
PLOT DATE = 5/2/2012	DATE -	REVISED -

STATE OF ILLINOIS
 DEPARTMENT OF TRANSPORTATION


PLAT OF HIGHWAYS

SCALE: GRAPHIC SHEET NO. 45 OF 49 SHEETS STA. TO STA.

O.R. RTE.	SECTION	COUNTY	TOTAL SHEETS	SHEET NO.
0003	18A-2	McHENRY	825	454
CONTRACT NO. 60F72				
FED. ROAD DIST. NO. 1 ILLINOIS FED. AID PROJECT				

PART OF THE NE 1/4 OF SEC. 33 AND PART OF THE FRACTIONAL NW 1/4 OF SEC. 34, TWP. 43 N., R. 8 E. OF THE 3RD. P.M., IN McHENRY COUNTY, ILLINOIS.

LEGEND

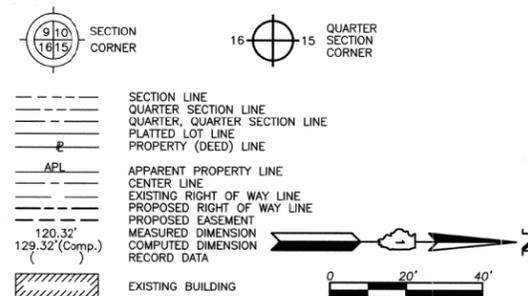

Bearings are referenced to the Illinois Coordinate System NAD83 (1997) East Zone at Found Geodetic Survey Control Monuments "MCH31 1A", P.I.D. AJ2855 and "Algonquin", P.I.D. AJ2945.

○ IRON PIPE OR ROD FOUND ⊕ "MAG" NAIL SET
 + CUT CROSS FOUND OR SET ● 5/8" REBAR SET

● T1 THESE STAKES REFERENCE FOUND OR SET MONUMENTATION. SET 5/8 INCH IRON ROD FLUSH WITH GROUND TO THE FOUND IRON STAKE. IDENTIFIED BY COLORED PLASTIC CAP BEARING SURVEYORS REGISTRATION NUMBER.
 ● BT1 THESE STAKES, IN CULTIVATED AREAS, REFERENCE FOUND OR SET MONUMENTATION. BURIED 5/8 INCH IRON ROD 20 INCHES BELOW GROUND TO THE FOUND IRON STAKE. IDENTIFIED BY COLORED PLASTIC CAP BEARING SURVEYORS REGISTRATION NUMBER.
 ■ STAKING OF PROPOSED RIGHT OF WAY. SET DIVISION OF HIGHWAYS SURVEY MARKER TO MONUMENT THE POSITION SHOWN. IDENTIFIED BY INSCRIPTION DATA AND SURVEYORS REGISTRATION NUMBER.
 ■ M STAKING OF PROPOSED RIGHT OF WAY IN CULTIVATED AREAS. BURIED 5/8 INCH METAL ROD 20 INCHES BELOW GROUND TO MARK FUTURE SURVEY MARKER POSITION IDENTIFIED BY COLORED PLASTIC CAP BEARING SURVEYORS REGISTRATION NUMBER.
 ⊕ PERMANENT SURVEY MARKER, I.D.O.T STD 2135 (TO BE SET BY OTHERS)
 □ RIGHT OF WAY STAKING PROPOSED TO BE SET.

STATE OF ILLINOIS }
 COUNTY OF LAKE }
 THIS IS TO CERTIFY THAT WE, JORGENSEN & ASSOCIATES, INC., AN ILLINOIS PROFESSIONAL DESIGN FIRM LAND SURVEYING CORPORATION, NUMBER 184-2771, HAVE SURVEYED THE PLAT OF HIGHWAYS SHOWN HEREON BETWEEN SECTION 33, TOWNSHIP 43N., RANGE 8E. AND SECTION 34, TOWNSHIP 43N., RANGE 8E., OF THE THIRD PRINCIPAL MERIDIAN, McHENRY COUNTY, THAT THE SURVEY IS TRUE AND COMPLETE AS SHOWN TO THE BEST OF MY KNOWLEDGE AND BELIEF, THAT THE PLAT CORRECTLY REPRESENTS SAID SURVEY, THAT ALL MONUMENTS FOUND AND ESTABLISHED ARE OF PERMANENT QUALITY AND OCCUPY THE POSITIONS SHOWN THEREON AND THAT THE MONUMENTS ARE SUFFICIENT TO ENABLE THE SURVEY TO BE RETRACED. MADE FOR THE DEPARTMENT OF TRANSPORTATION, STATE OF ILLINOIS.



DATED AT LAKE VILLA, ILLINOIS THIS 14th DAY OF March, 2010 A.D.

Christian H. Jorgensen PRESIDENT
 2767 PROFESSIONAL LAND SURVEYOR NO. 35-2797
 LICENSE EXPIRATION DATE: NOVEMBER 30, 2010
 THIS PROFESSIONAL SERVICE CONFORMS TO THE CURRENT ILLINOIS MINIMUM STANDARDS FOR A BOUNDARY SURVEY.

COORDINATES ARE BASED ON THE PUBLISHED METRIC COORDINATE VALUES AT FOUND GEODETIC SURVEY CONTROL MONUMENT "MCH31 1A", P.I.D. AJ2855, OF N.613,205.182-E.303,895.917. NOTE: SURFACE COORDINATES ARE SHOWN.

RECEIVED
 MAY 02 2011
 LEGALS

JORGENSEN & ASSOCIATES, INC.
 120 PARK AVENUE
 LAKE VILLA, ILLINOIS 60046 SHEET 1 IS A COVER SHEET AND IS NOT RECORDED.
 (847) 356-3371


PLAT OF HIGHWAYS
 STATE OF ILLINOIS
 DEPARTMENT OF TRANSPORTATION
 F.A.P. 336 (ILLINOIS ROUTE 31 BYPASS)
 SECTION 96-00209-00-PV McHENRY COUNTY
 PROJECT JOB NO. R-91-022-03
 STATION 0+00.00 TO STATION 4+85.76
 SCALE: 1"=20' SHEET 35A OF 37

BUREAU OF LAND ACQUISITION
 201 WEST CENTER COURT
 SCHAUMBURG, ILLINOIS 60196

DATE	
BY	
MADE	
CHECKED	
INCHES	
ROW	
PLAT	
NOTEBOOK	
NO.	

Proposed Q Pavement Legion Drive Curve #1
 P.I. = Sta. 1+55.18
 Δ = 19°07'41"
 R = 100.00'
 T = 16.85'
 L = 33.39'
 E = 1.41'
 P.C. = Sta. 1+38.33
 P.T. = Sta. 1+71.72

Proposed Q Pavement Legion Drive Curve #2
 P.I. = Sta. 2+63.33
 Δ = 16°04'11"
 R = 426.92'
 T = 60.26'
 L = 119.74'
 E = 4.23'
 P.C. = Sta. 2+03.04
 P.T. = Sta. 3+22.78

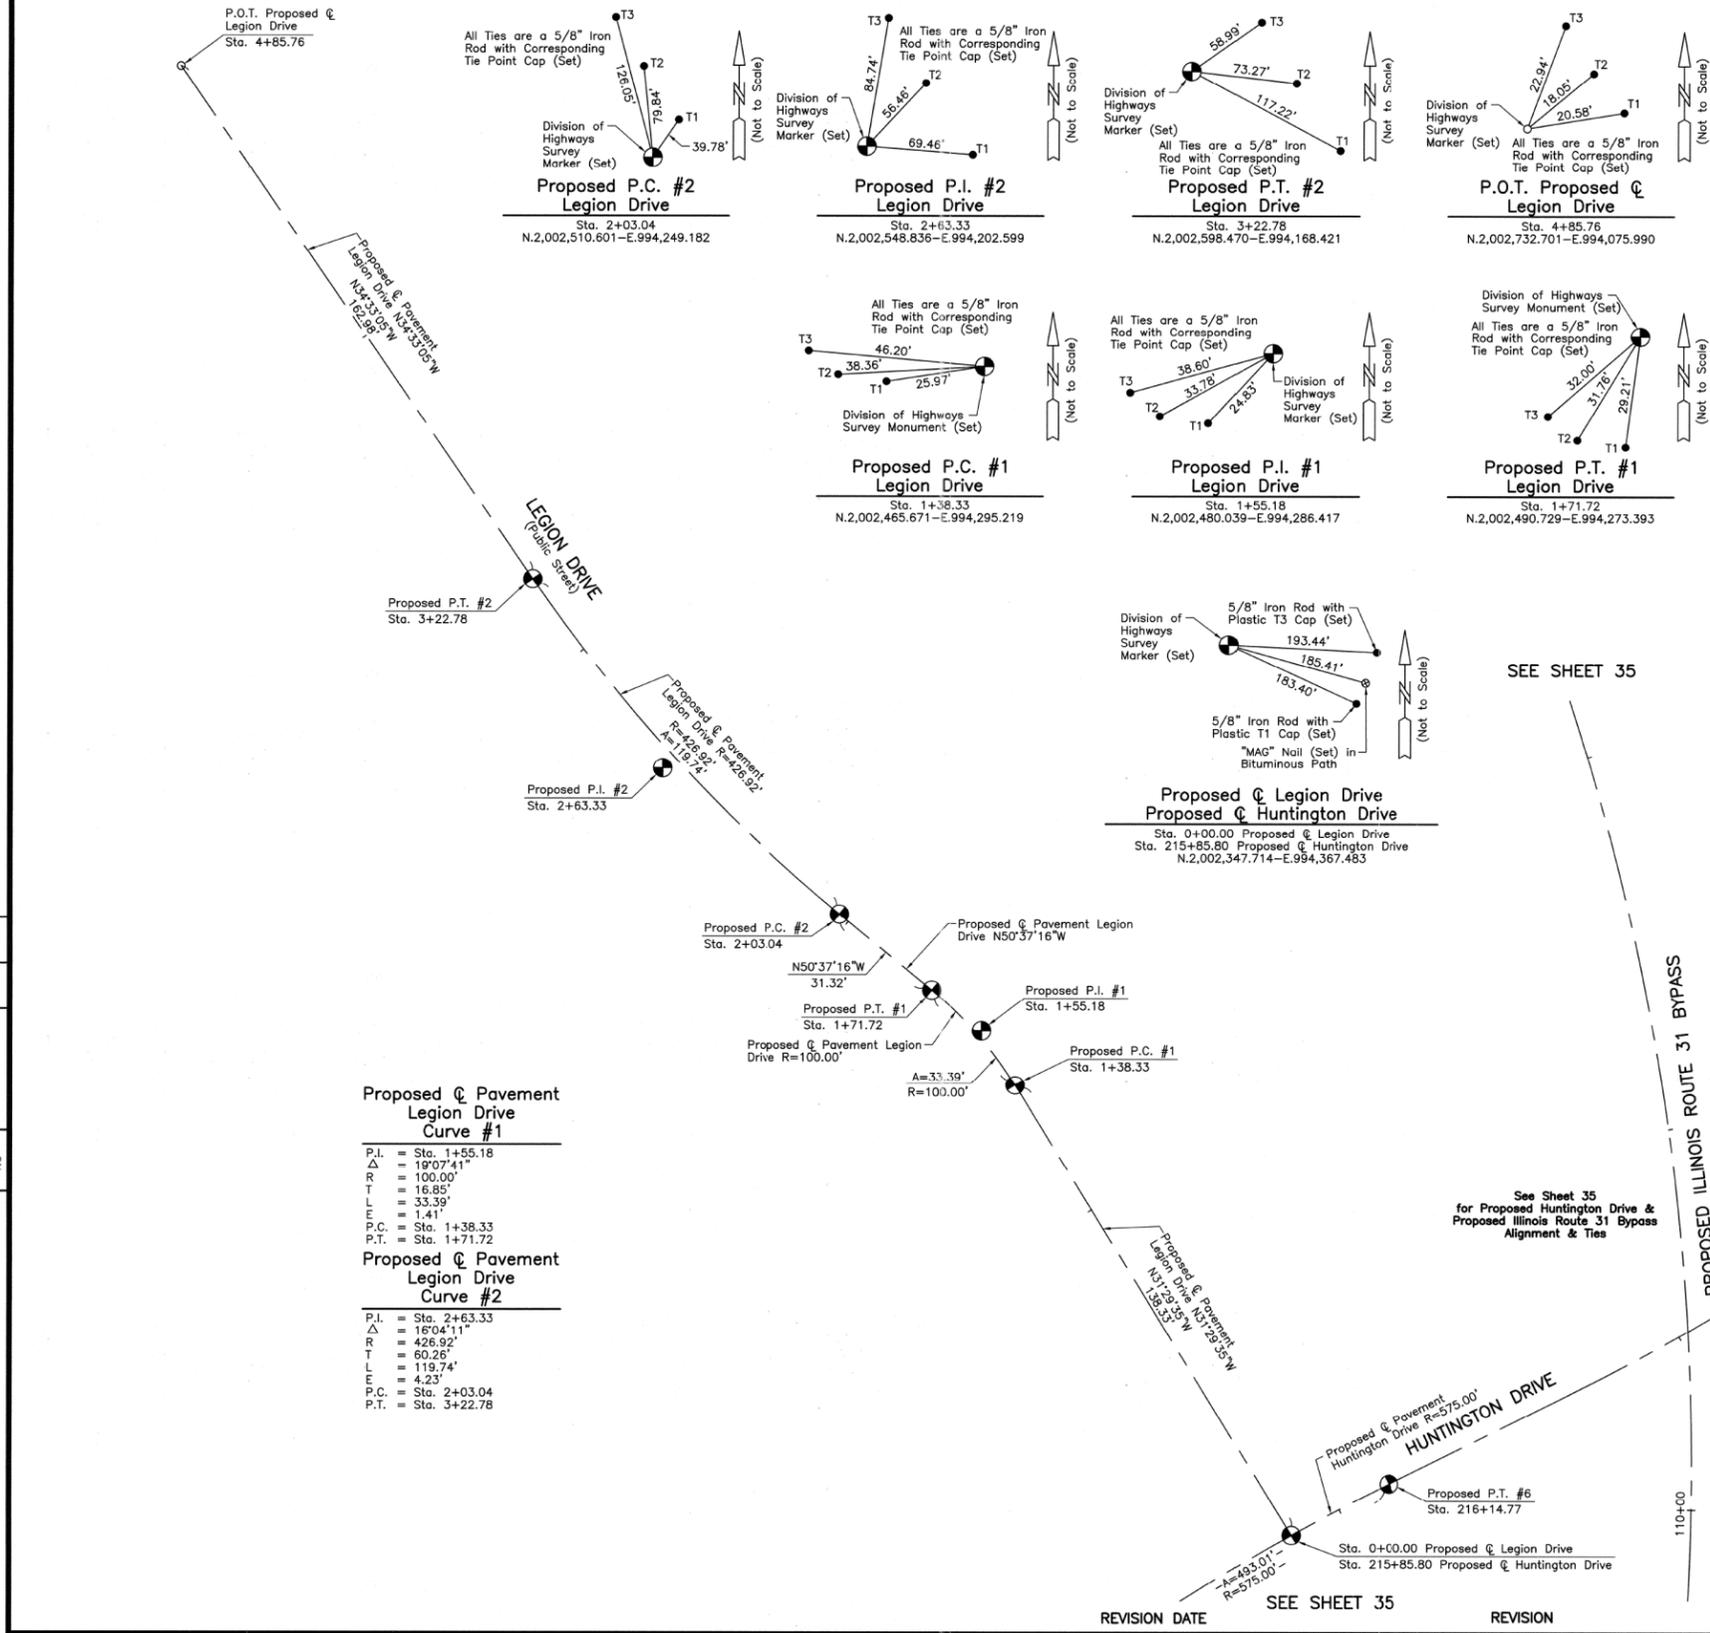

ROUTE F.A.P. 336 (ILLINOIS ROUTE 31 BYPASS) SECTION 96-00209-00-PV COUNTY McHENRY JOB NO. R-91-022-03 RECORDING: RECORDED ON AS DOCUMENT NO.

FILE NAME = ...\\D160F72-sht-PH-47.dgn

USER NAME = akw	DESIGNED -	REVISED -
PLOT SCALE = 70.0000' / in.	DRAWN - JORGENSEN & ASSOC.	REVISED -
PLOT DATE = 5/2/2012	CHECKED - CJ	REVISED -
	DATE -	REVISED -


STATE OF ILLINOIS
 DEPARTMENT OF TRANSPORTATION

PLAT OF HIGHWAYS
 SCALE: GRAPHIC SHEET NO. 47 OF 49 SHEETS STA. TO STA.

O.R. RTE.	SECTION	COUNTY	TOTAL SHEETS	SHEET NO.
0003	18A-2	McHENRY	825	456
CONTRACT NO. 60F72				
FED. ROAD DIST. NO. 1 ILLINOIS FED. AID PROJECT				

PART OF THE FRACTIONAL SW 1/4 OF SEC. 27, PART OF THE SE 1/4 OF SEC. 28, PART OF THE NE 1/4 OF SEC. 33 AND PART OF THE FRACTIONAL NW 1/4 OF SEC. 34, TWP. 43 N., R. 8 E. OF THE 3RD. P.M., IN McHENRY COUNTY, ILLINOIS.

LEGEND

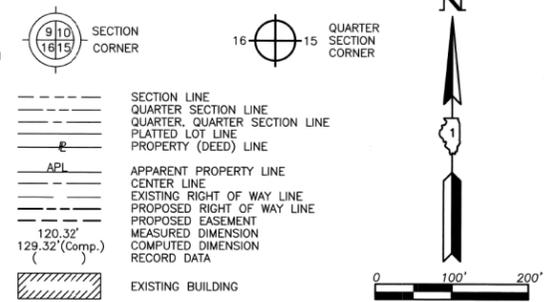

Bearings are referenced to the Illinois Coordinate System NAD83 (1997) East Zone at Found Geodetic Survey Control Monuments "MCH31 1A", P.I.D. AJ2855 and "Algonquin", P.I.D. AJ2945.

○ IRON PIPE OR ROD FOUND ⊕ "MAG" NAIL SET
 + CUT CROSS FOUND OR SET ● 5/8" REBAR SET

● T1 THESE STAKES REFERENCE FOUND OR SET MONUMENTATION. SET 5/8 INCH IRON ROD FLUSH WITH GROUND TO THE FOUND IRON STAKE. IDENTIFIED BY COLORED PLASTIC CAP BEARING SURVEYORS REGISTRATION NUMBER.
 ● T2
 ● T3

● BT1 THESE STAKES, IN CULTIVATED AREAS, REFERENCE FOUND OR SET MONUMENTATION. BURIED 5/8 INCH IRON ROD 20 INCHES BELOW GROUND TO THE FOUND IRON STAKE. IDENTIFIED BY COLORED PLASTIC CAP BEARING SURVEYORS REGISTRATION NUMBER.
 ● BT2
 ● BT3

■ STAKING OF PROPOSED RIGHT OF WAY. SET DIVISION OF HIGHWAYS SURVEY MARKER TO MONUMENT THE POSITION SHOWN. IDENTIFIED BY INSCRIPTION DATA AND SURVEYORS REGISTRATION NUMBER.

■ M STAKING OF PROPOSED RIGHT OF WAY IN CULTIVATED AREAS. BURIED 5/8 INCH METAL ROD 20 INCHES BELOW GROUND TO MARK FUTURE SURVEY MARKER POSITION IDENTIFIED BY COLORED PLASTIC CAP BEARING SURVEYORS REGISTRATION NUMBER.


⊕ PERMANENT SURVEY MARKER, I.D.O.T STD 2135 (TO BE SET BY OTHERS)

□ RIGHT OF WAY STAKING PROPOSED TO BE SET.

STATE OF ILLINOIS
 COUNTY OF LAKE

THIS IS TO CERTIFY THAT WE, JORGENSEN & ASSOCIATES, INC., AN ILLINOIS PROFESSIONAL DESIGN FIRM LAND SURVEYING CORPORATION, NUMBER 184-2771, HAVE SURVEYED THE PLAT OF HIGHWAYS SHOWN HEREON BETWEEN SECTION 27, TOWNSHIP 43N., RANGE 8E. AND SECTION 33, TOWNSHIP 43N., RANGE 8E., OF THE THIRD PRINCIPAL MERIDIAN, McHENRY COUNTY, THAT THE SURVEY IS TRUE AND COMPLETE AS SHOWN TO THE BEST OF MY KNOWLEDGE AND BELIEF. THAT THE PLAT CORRECTLY REPRESENTS SAID SURVEY, THAT ALL MONUMENTS FOUND AND ESTABLISHED ARE OF PERMANENT QUALITY AND OCCUPY THE POSITIONS SHOWN THEREON AND THAT THE MONUMENTS ARE SUFFICIENT TO ENABLE THE SURVEY TO BE RETRACED. MADE FOR THE DEPARTMENT OF TRANSPORTATION, STATE OF ILLINOIS.

DATED AT LAKE VILLA, ILLINOIS THIS 3rd DAY OF May 20 2012.

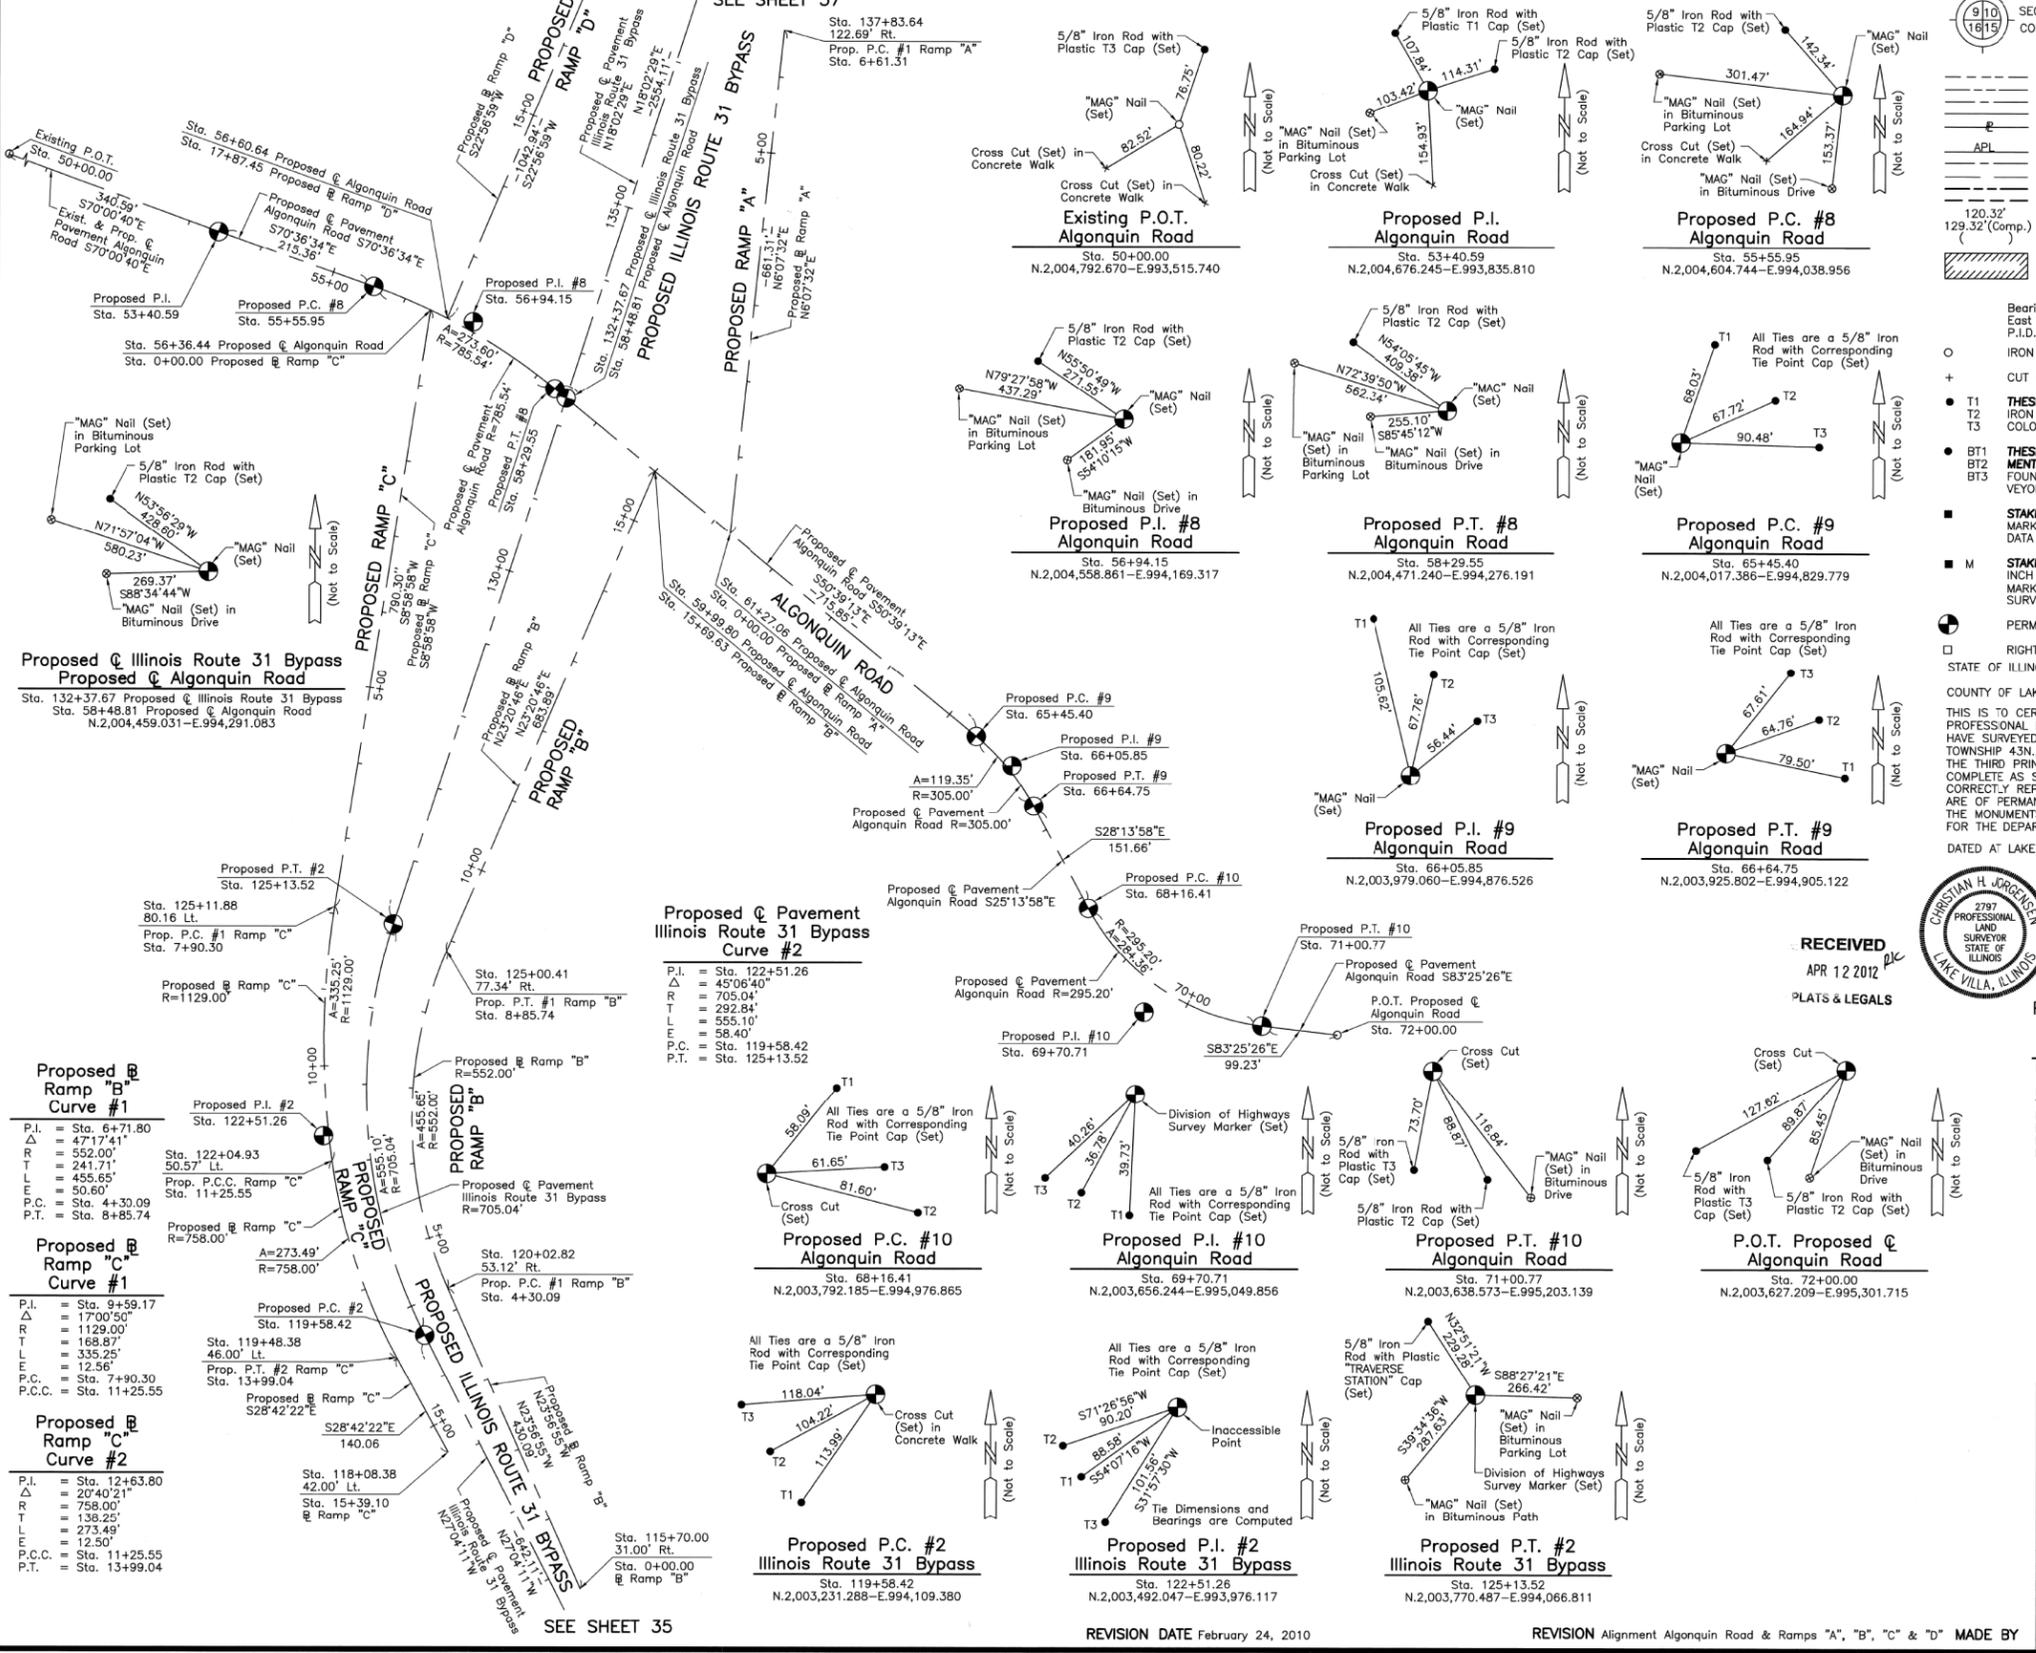

DATE	BY
MADE	CHECKED
NO. BOOK	NO.



RECEIVED
 APR 12 2012
 PLATS & LEGALS

Proposed Pavement Algonquin Road Curve #8

P.I. = Sta. 56+94.15	P.I. = Sta. 66+05.85
Δ = 19°57'21"	Δ = 22°25'15"
R = 785.54'	R = 305.00'
T = 138.20'	L = 60.45'
L = 273.80'	L = 119.35'
L = 12.06'	L = 5.93'
P.C. = Sta. 55+55.95	P.C. = Sta. 65+45.40
P.T. = Sta. 58+29.55	P.T. = Sta. 66+64.75

Proposed Pavement Algonquin Road Curve #9

P.I. = Sta. 69+70.71	P.I. = Sta. 71+00.77
Δ = 55°11'28"	Δ = 29°52'15"
R = 295.20'	R = 305.00'
T = 154.30'	L = 60.45'
L = 284.36'	L = 119.35'
L = 37.89'	L = 5.93'
P.C. = Sta. 68+16.41	P.C. = Sta. 65+45.40
P.T. = Sta. 71+00.77	P.T. = Sta. 66+64.75

Proposed Pavement Algonquin Road Curve #10

P.I. = Sta. 122+51.26	P.I. = Sta. 125+13.52
Δ = 45°06'40"	Δ = 17°00'50"
R = 705.04'	R = 1129.00'
T = 292.84'	L = 60.45'
L = 555.10'	L = 119.35'
L = 58.40'	L = 5.93'
P.C. = Sta. 119+58.42	P.C. = Sta. 122+51.26
P.T. = Sta. 125+13.52	P.T. = Sta. 125+13.52

JORGENSEN & ASSOCIATES, INC.
 120 PARK AVENUE
 LAKE VILLA, ILLINOIS 60046
 (847) 356-3371

SHEET 1 IS A COVER
 SHEET AND IS NOT RECORDED.

PLAT OF HIGHWAYS
 STATE OF ILLINOIS
 DEPARTMENT OF TRANSPORTATION
 F.A.P. 336 (ILLINOIS ROUTE 31 BYPASS)
 SECTION 96-00209-00-PV McHENRY COUNTY
 PROJECT JOB NO. R-91-022-03
 STATION 50+00.00 TO STATION 72+00.00
 STATION 116+00 TO STATION 138+00
 SCALE: 1"=100' SHEET 36 OF 37

BUREAU OF LAND ACQUISITION
 201 WEST CENTER COURT
 SCHAUMBURG, ILLINOIS 60196

ROUTE F.A.P. 336 (ILLINOIS ROUTE 31 BYPASS) SECTION 96-00209-00-PV COUNTY McHENRY JOB NO. R-91-022-03 RECORDING: RECORDED ON AS DOCUMENT NO.

REVISION DATE February 24, 2010

REVISION Alignment Algonquin Road & Ramps "A", "B", "C" & "D" MADE BY

FILE NAME = ...\\D160F72-sh-t-PH-48.dgn

USER NAME = akw	DESIGNED -	REVISED -
PLOT SCALE = 70.0000' / in.	DRAWN - JORGENSEN & ASSOC.	REVISED -
PLOT DATE = 5/2/2012	CHECKED - CJ	REVISED -
	DATE -	REVISED -


STATE OF ILLINOIS
DEPARTMENT OF TRANSPORTATION

PLAT OF HIGHWAYS

SCALE: GRAPHIC SHEET NO. 48 OF 49 SHEETS STA. TO STA.

O.R. RTE.	SECTION	COUNTY	TOTAL SHEETS	SHEET NO.
0003	18A-2	McHENRY	825	456A
CONTRACT NO. 60F72				
FED. ROAD DIST. NO. 1 ILLINOIS FED. AID PROJECT				

PART OF SEC. 22, PART OF THE FRACTIONAL SW 1/4 OF SEC. 27 AND PART OF THE NORTH 1/2 OF SEC. 27, TWP. 43 N., R. 8 E. OF THE 3RD. P.M., IN McHENRY COUNTY, ILLINOIS.

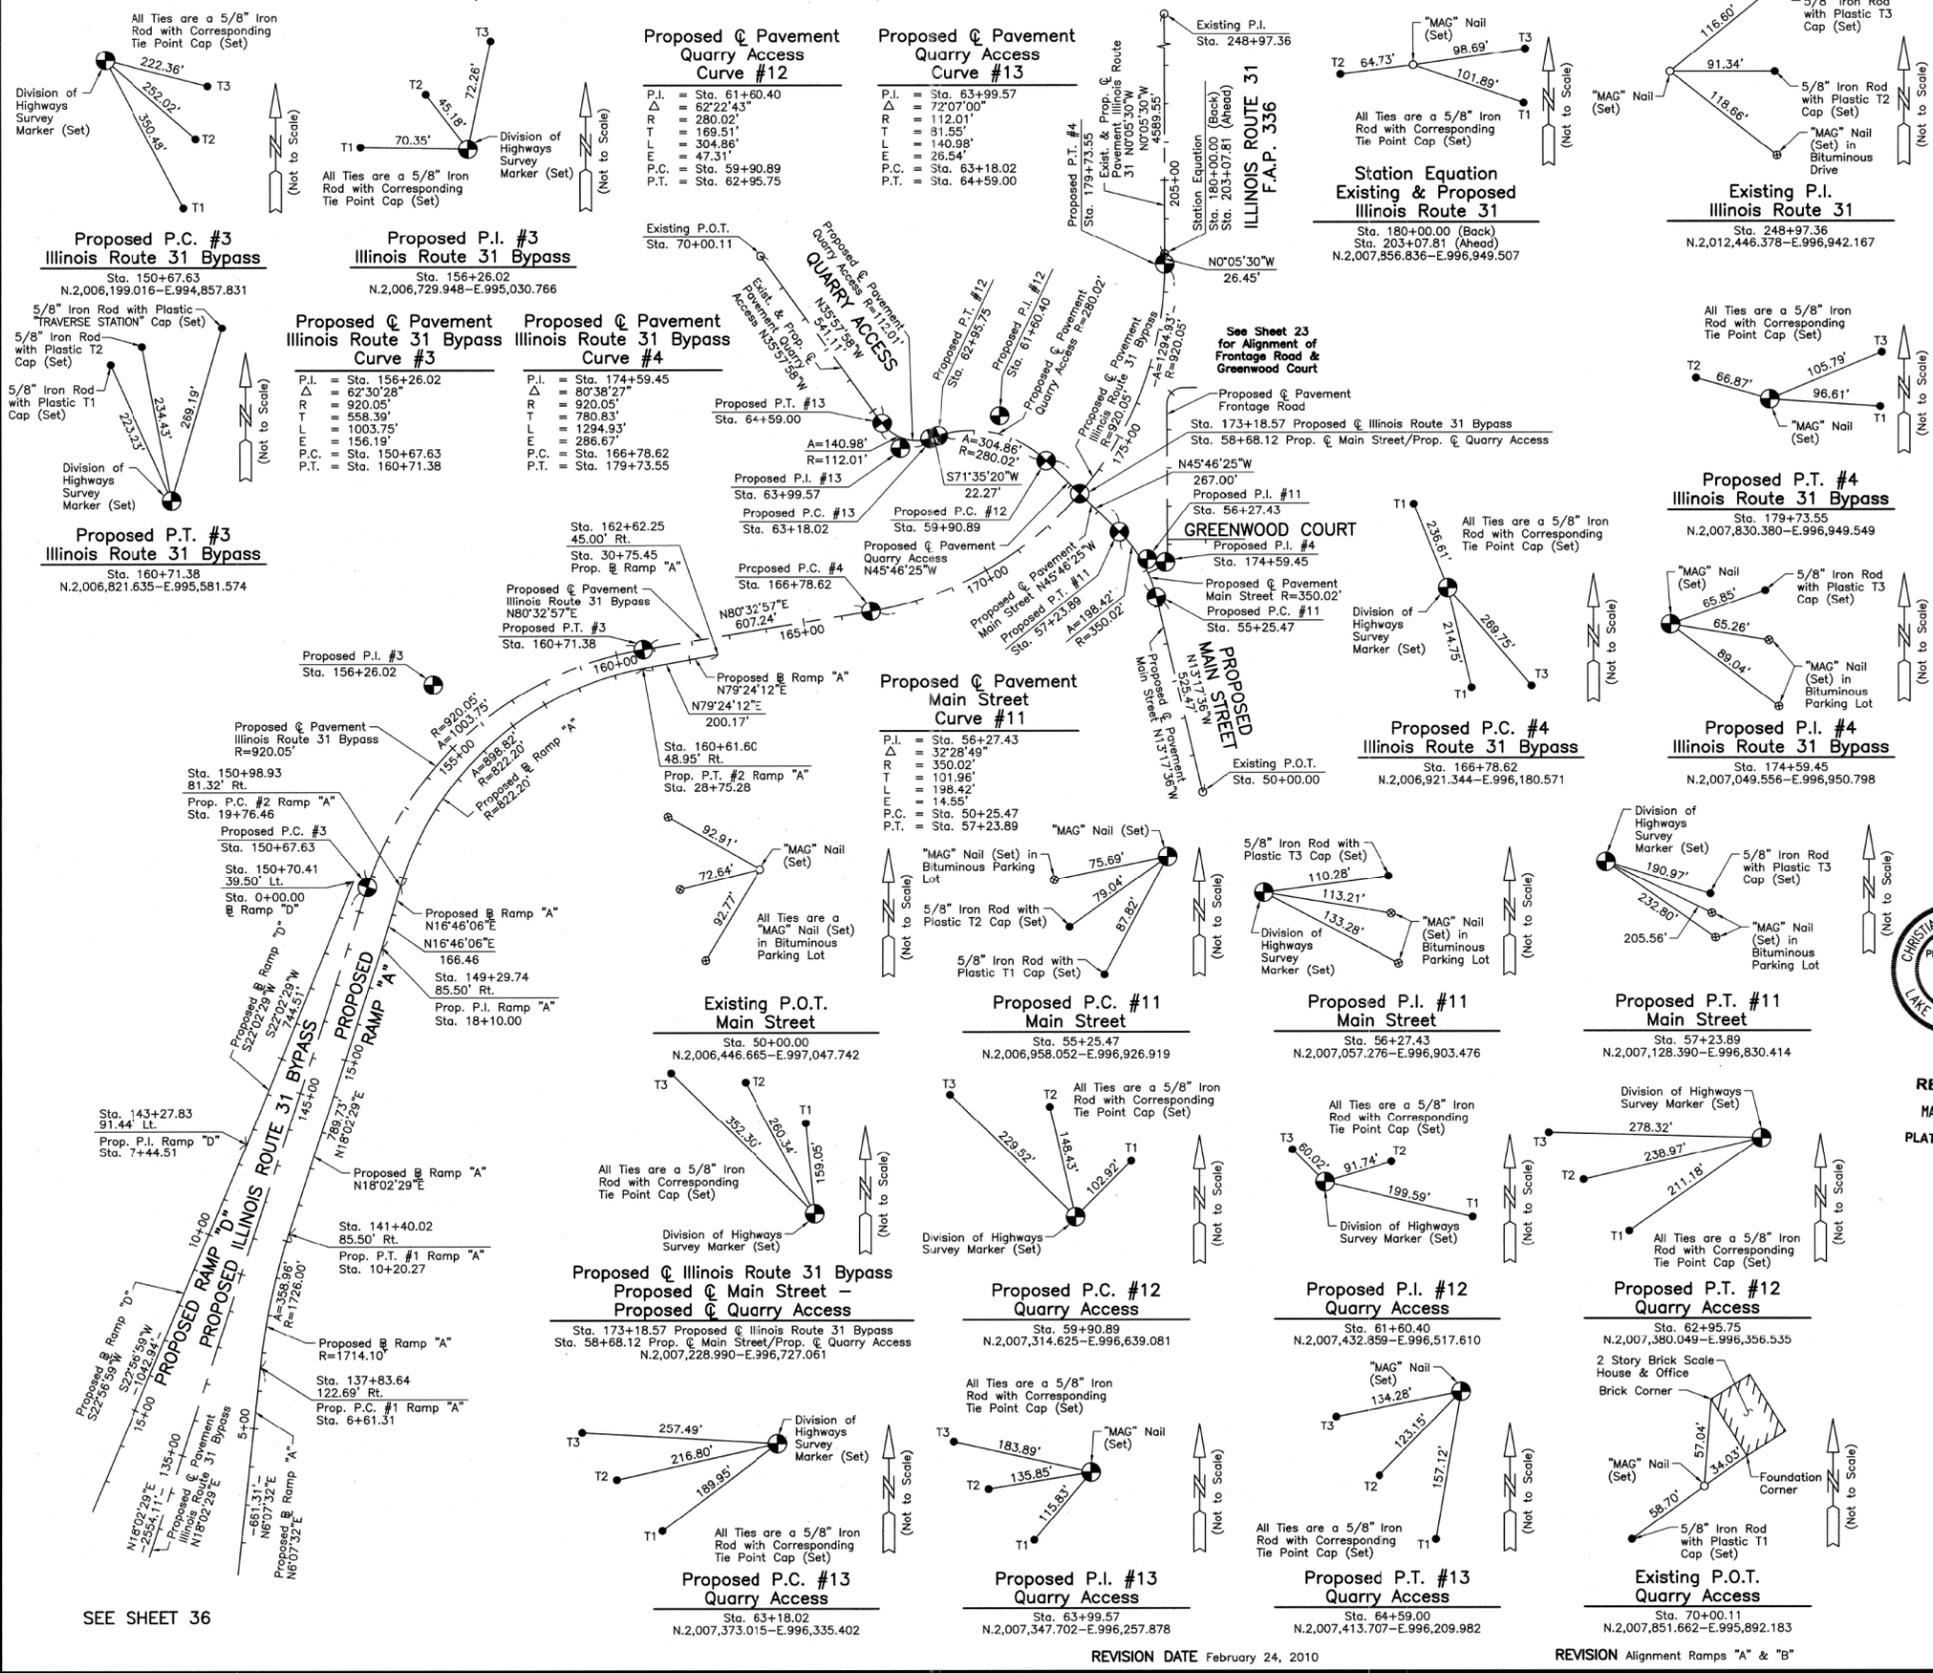

LEGEND

SECTION CORNER: 9 10 16 15

QUARTER SECTION CORNER: 16 15

SECTION LINE
QUARTER SECTION LINE
PLATTED LOT LINE
PROPERTY (DEED) LINE

APL
CENTER LINE
EXISTING RIGHT OF WAY LINE
PROPOSED RIGHT OF WAY LINE
PROPOSED EASEMENT
MEASURED DIMENSION
COMPUTED DIMENSION
RECORD DATA

EXISTING BUILDING

SCALE: 1"=200'

Bearings are referenced to the Illinois Coordinate System NAD83 (1997) East Zone at Found Geodetic Survey Control Monuments "MCH31 1A", P.I.D. AJ2855 and "Algonquin", P.I.D. AJ2945.

○ IRON PIPE OR ROD FOUND
⊕ "MAG" NAIL SET
+ CUT CROSS FOUND OR SET
● 5/8" REBAR SET

● T1
● T2
● T3

● BT1
● BT2
● BT3

■ STAKING OF PROPOSED RIGHT OF WAY. SET DIVISION OF HIGHWAYS SURVEY MARKER TO MONUMENT THE POSITION SHOWN. IDENTIFIED BY INSCRIPTION DATA AND SURVEYORS REGISTRATION NUMBER.

■ M STAKING OF PROPOSED RIGHT OF WAY IN CULTIVATED AREAS. BURIED 5/8 INCH METAL ROD 20 INCHES BELOW GROUND TO MARK FUTURE SURVEY MARKER POSITION IDENTIFIED BY COLORED PLASTIC CAP BEARING SURVEYORS REGISTRATION NUMBER.

□ RIGHT OF WAY STAKING PROPOSED TO BE SET.

STATE OF ILLINOIS }
COUNTY OF LAKE } SS

THIS IS TO CERTIFY THAT WE, JORGENSEN & ASSOCIATES, INC., AN ILLINOIS PROFESSIONAL DESIGN FIRM LAND SURVEYING CORPORATION, NUMBER 184-2771, HAVE SURVEYED THE PLAT OF HIGHWAYS SHOWN HEREON BETWEEN SECTION 22, TOWNSHIP 43N., RANGE 8E. AND SECTION 27, TOWNSHIP 43N., RANGE 8E., OF THE THIRD PRINCIPAL MERIDIAN, McHENRY COUNTY, THAT THE SURVEY IS TRUE AND COMPLETE AS SHOWN TO THE BEST OF MY KNOWLEDGE AND BELIEF, THAT THE PLAT CORRECTLY REPRESENTS SAID SURVEY, THAT ALL MONUMENTS FOUND AND ESTABLISHED ARE OF PERMANENT QUALITY AND OCCUPY THE POSITIONS SHOWN THEREON AND THAT THE MONUMENTS ARE SUFFICIENT TO ENABLE THE SURVEY TO BE RETRACED. MADE FOR THE DEPARTMENT OF TRANSPORTATION, STATE OF ILLINOIS.

DATED AT LAKE VILLA, ILLINOIS THIS 3rd DAY OF May 2010 A.D.

Christian H. Jorgensen PRESIDENT
ILLINOIS PROFESSIONAL LAND SURVEYOR NO. 35-2797
LICENSE EXPIRATION DATE: NOVEMBER 30, 2006

THIS PROFESSIONAL SERVICE CONFORMS TO THE CURRENT ILLINOIS MINIMUM STANDARDS FOR A BOUNDARY SURVEY.

COORDINATES ARE BASED ON THE PUBLISHED METRIC COORDINATE VALUES AT FOUND GEODETIC SURVEY CONTROL MONUMENT "MCH31 1A", P.I.D. AJ2855, OF N.613,205.182'-E.303,895.917'. NOTE: SURFACE COORDINATES ARE SHOWN.

ROW	PLAT	DATE	BY
MADE	CHECKED		
INBOOK			
NO.			



RECEIVED
MAY 02 2011
PLATS & LEGALS

Proposed Ramp "A" Curve #1	Proposed Ramp "A" Curve #2
P.I. = Sta. 8+41.44	P.I. = Sta. 24+76.71
Δ = 11°54'57"	Δ = 62°38'06"
R = 1726.00'	R = 822.20'
T = 180.13'	T = 500.25'
L = 358.96'	L = 898.82'
E = 9.37'	E = 140.22'
P.C. = Sta. 6+61.31	P.C. = Sta. 19+76.46
P.T. = Sta. 10+20.27	P.T. = Sta. 28+75.28

JORGENSEN & ASSOCIATES, INC.
120 PARK AVENUE
LAKE VILLA, ILLINOIS 60046
(847) 356-3371

SHEET 1 IS A COVER SHEET AND IS NOT RECORDED.

PLAT OF HIGHWAYS
STATE OF ILLINOIS
DEPARTMENT OF TRANSPORTATION
F.A.P. 336 (ILLINOIS ROUTE 31 BYPASS)
SECTION 96-00209-00-PV McHENRY COUNTY
PROJECT JOB NO. R-91-022-03
STATION 50+00.00 TO STATION 70+00.11
STATION 133+00 TO STATION 248+97.36
SCALE: 1"=200' SHEET 37 OF 37

BUREAU OF LAND ACQUISITION
201 WEST CENTER COURT
SCHAUMBURG, ILLINOIS 60196

ROUTE F.A.P. 336 (ILLINOIS ROUTE 31 BYPASS) SECTION 96-00209-00-PV COUNTY McHENRY JOB NO. R-91-022-03 RECORDING: RECORDED ON AS DOCUMENT NO.

FILE NAME = ... \D160F72-sht-PH-49.dgn	USER NAME = akw	DESIGNED -	REVISED -	STATE OF ILLINOIS DEPARTMENT OF TRANSPORTATION	PLAT OF HIGHWAYS	SCALE: GRAPHIC	SHEET NO. 49 OF 49 SHEETS	STA. TO STA.	FED. ROAD DIST. NO. 1 ILLINOIS FED. AID PROJECT
	PLOT SCALE = 70.0000' / in.	DRAWN - JORGENSEN & ASSOC.	REVISED -						
	PLOT DATE = 5/2/2012	CHECKED - CJ	REVISED -						
		DATE -	REVISED -						

O.R. RTE.	SECTION	COUNTY	TOTAL SHEETS	SHEET NO.
0003	18A-2	MCHENRY	825	458
FED. ROAD DIST. NO. 1	ILLINOIS	CONTRACT NO. 60F72		

VOLUME III

FOR INDEX OF SHEETS, SEE SHEET NO. 459

SUBSURFACE UTILITY ENGINEERING (S.U.E.)
UTILIZED ON THIS PROJECT

PROJECT LOCATED IN THE
VILLAGE OF ALGONQUIN

DESIGN DESIGNATION

34,000(30) OTHER PRINCIPAL ARTERIAL 6.03 (PCC-20)


TRAFFIC DATA

	ADT (2030)	DESIGN SPEED	POSTED SPEED
IL ROUTE 31 (EDGEWOOD DRIVE TO HUNTINGTON DRIVE)	26,000	40 MPH	35 MPH
IL ROUTE 31 (HUNTINGTON DRIVE TO IL ROUTE 62)	16,000	40 MPH	40 MPH
IL ROUTE 31 (IL ROUTE 62 TO CARY-ALGONQUIN ROAD)	34,000	50 MPH	45 MPH
IL ROUTE 31 (CARY-ALGONQUIN ROAD TO KLASEN ROAD)	43,000	50 MPH	45 MPH
EDGEWOOD DRIVE	9,000	35 MPH	30 MPH
HUNTINGTON DRIVE	7,000	35 MPH	30 MPH
IL ROUTE 62 (EAST OF PROPOSED IL ROUTE 31)	48,000	35 MPH	30 MPH
IL ROUTE 62 (WEST OF PROPOSED IL ROUTE 31)	32,000	35 MPH	30 MPH

STATE OF ILLINOIS
DEPARTMENT OF TRANSPORTATION
DIVISION OF HIGHWAYS

**PROPOSED
HIGHWAY PLANS**

O.R. ROUTE 0003 (ALGONQUIN BYPASS)
SECTION 18A-2
ILLINOIS ROUTE 31 (N. JCT) TO ILLINOIS ROUTE 31 (S. JCT)
PROJECT NO.:
NEW CONSTRUCTION, BRIDGE (NEW), RETAINING WALL
McHENRY COUNTY

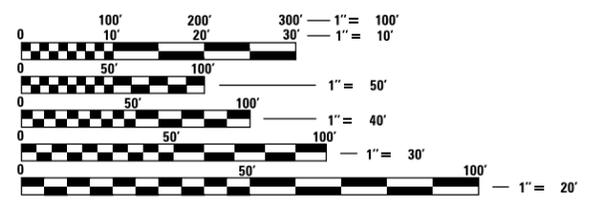


FULL SIZE PLANS HAVE BEEN PREPARED USING STANDARD ENGINEERING SCALES. REDUCED SIZED PLANS WILL NOT CONFORM TO STANDARD SCALES. IN MAKING MEASUREMENTS ON REDUCED PLANS, THE ABOVE SCALES MAY BE USED.

J.U.L.I.E.
JOINT UTILITY LOCATION INFORMATION FOR EXCAVATION
1-800-892-0123
OR 811

DISTRICT ONE - DESIGN
PROJECT MANAGER: ISAAC KWARTENG (847) 705-4230
PROJECT ENGINEER: ALIX BRICE (847) 705-4552

CONTRACT NO. 60F72

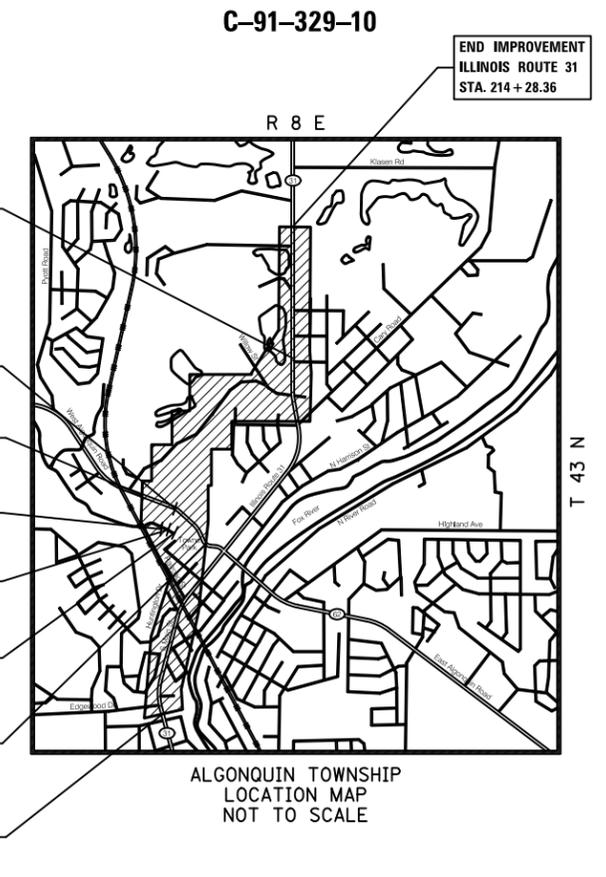

GROSS LENGTH = 11,153.55 FT. = 2.112 MILES
NET LENGTH = 11,153.55 FT. = 2.112 MILES

PLANS PREPARED BY:
CIVILTECH
450 E. Devon Ave, Suite 300 - Itasca, Illinois 60143
Tel: 630.773.3900 - Fax: 630.773.3975
www.civiltechinc.com



STATE OF ILLINOIS
DEPARTMENT OF TRANSPORTATION
DIVISION OF HIGHWAYS

SUBMITTED _____ 20 _____
DEPUTY DIRECTOR OF HIGHWAYS, REGION ENGINEER

_____ 20 _____
ENGINEER OF DESIGN AND ENVIRONMENT

_____ 20 _____
DIRECTOR OF HIGHWAYS, CHIEF ENGINEER

**PRINTED BY THE AUTHORITY
OF THE STATE OF ILLINOIS**

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VOLUME I

SHEET NO.	DESCRIPTION
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2	INDEX OF SHEETS
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6 -23C	SUMMARY OF QUANTITIES
24 - 38	TYPICAL SECTIONS
39 - 49	SCHEDULE OF QUANTITIES
50 - 56	ALIGNMENT, TIES & BENCHMARKS
57 - 69	REMOVAL PLANS
70 - 83	ROADWAY PLANS
84 -102	ROADWAY PROFILES
103 - 147	MAINTENANCE OF TRAFFIC
148 #MT47	DETOUR PLANS
149 - 176	EROSION AND SEDIMENT CONTROL PLANS
177 - 191	DRAINAGE AND UTILITIES PLANS
192 - 210	DRAINAGE AND UTILITIES PROFILES
211 - 212	DRAINAGE AND UTILITIES WATERMAIN PROFILES
213 - 228	SUB-SURFACE UTILITY ENGINEERING

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231 - 244	PAVEMENT MARKING PLANS
245 - 256	LANDSCAPING PLANS
257 - 262	LANDSCAPING DETAILS
263 - 297	TRAFFIC SIGNAL PLANS
298 - 328	LIGHTING PLANS
329 - 344	JOINTING AND GRADING PLANS
345 - 397	DETAILS
398 - 399	TOWNE PARK PLANS
400 - 409	CRYSTAL CREEK RELOCATION PLANS
410 - 457	PLAT OF HIGHWAYS


VOLUME III

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494 - 525	SN 056-0081 - IL ROUTE 31 OVER IL ROUTE 62
526 - 554	SN 056-0079 - RAMP B OVER CRYSTAL CREEK
555 - 584	SN 056-0080 - RAMP C OVER CRYSTAL CREEK
585 - 593	SN 056-2507 - IL ROUTE 31 WALL A
594 - 596	IL ROUTE 31 WALL B
597 - 604	SN 056-2500 - IL ROUTE 31 WALL C
605 - 612	SN 056-2501 - IL ROUTE 31 WALL D
613 - 619	SN 056-2502 - RAMP C WALL E
620 - 634	SN 056-2505 - IL ROUTE 31 WALL F
635 - 639	SN 056-2506 - IL ROUTE 31 WALL G
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650 - 655	SN 056-2503 - HUNTINGTON DRIVE WALL J
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676 - 679	CROSS SECTIONS ROADSIDE GRADING PLAN
680 - 743	CROSS SECTIONS - ILLINOIS ROUTE 31
744	CROSS SECTIONS - EDGEWOOD DRIVE
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793 - 798	CROSS SECTIONS - RAMP D
799 - 804	CROSS SECTIONS - ACCESS DRIVE
805 - 808	CROSS SECTIONS - NORTH MAIN STREET
809 - 812	CROSS SECTIONS - QUARRY ACCESS
813 - 815	CROSS SECTIONS - FRONTAGE ROAD
816 - 825	CROSS SECTIONS - MCCD PRAIRIE PATH

FILE NAME = ...\\D160F72-sht-indexIII.dgn	USER NAME = k1b	DESIGNED - CTB	REVISED -	STATE OF ILLINOIS DEPARTMENT OF TRANSPORTATION	INDEX OF SHEETS			O.R. RTE.	SECTION	COUNTY	TOTAL SHEETS	SHEET NO.
		DRAWN - CTB	REVISED -					0003	18A-2	MCHENRY	825	459
		CHECKED - GAB	REVISED -					CONTRACT NO. 60F72				
		DATE - 3/23/2012	REVISED -			SCALE:	SHEET NO. 1 OF 1 SHEETS	STA.	TO STA.	FED. ROAD DIST. NO. 1 ILLINOIS FED. AID PROJECT		



FILE NAME =
 ...\\D160F72-str_1loc.dgn

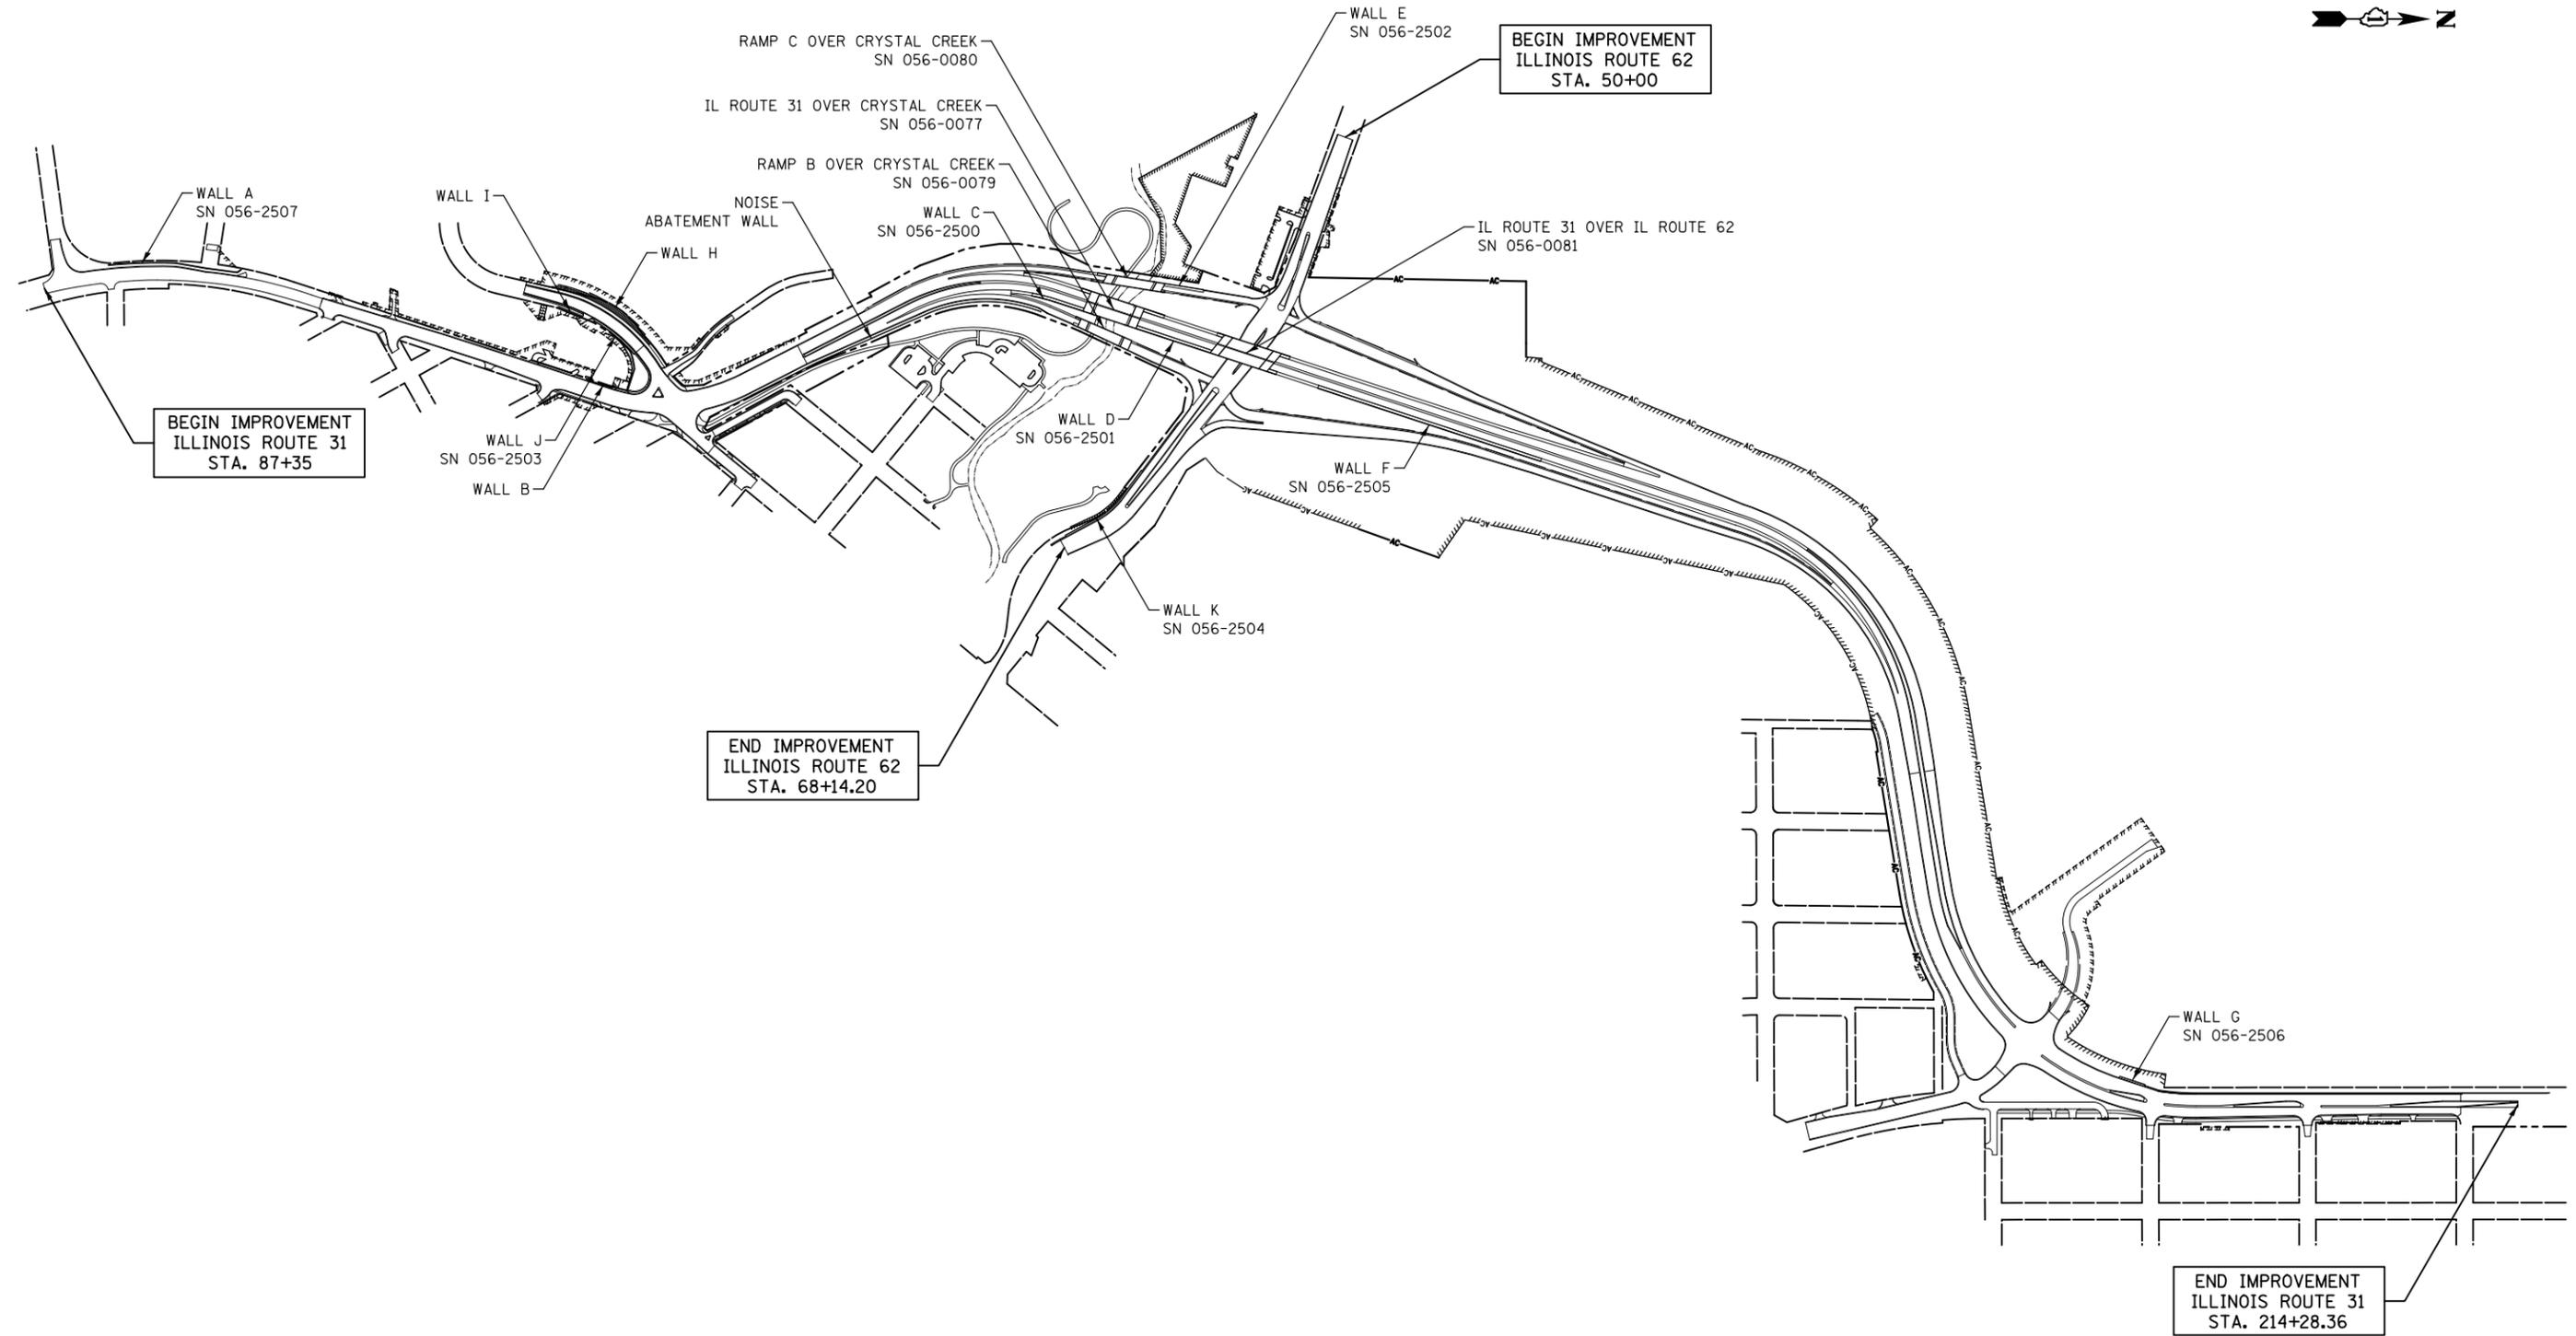USER NAME = k1b
 PLOT SCALE = 300.0000' / in.
 PLOT DATE = 5/2/2012

DESIGNED - CTB
 DRAWN - CTB
 CHECKED - GAB
 DATE - 05-12-2011

REVISED -
 REVISED -
 REVISED -
 REVISED -

**STATE OF ILLINOIS
 DEPARTMENT OF TRANSPORTATION**

STRUCTURE LOCATIONS

SCALE: 1" = 300' SHEET NO. 1 OF 1 SHEETS STA. TO STA.

F.A.P. RTE.	SECTION	COUNTY	TOTAL SHEETS	SHEET NO.
860	18A-2	MCHENRY	825	460
CONTRACT NO. 60F72				
FED. ROAD DIST. NO. 1 ILLINOIS FED. AID PROJECT				

GENERAL NOTES

- Fasteners shall be AASHTO M164 Type 1, mechanically galvanized bolts. Bolts 7/8" in. φ, holes 15/16" in. φ, unless otherwise noted.
- Calculated weight of Structural Steel = 352,450 lbs (AASHTO M270 GR. 50)
Calculated weight of Structural Steel = 28,930 lbs (AASHTO M270 GR. 36)
- No field welding is permitted except as specified in the contract documents.
- Reinforcement bars designated (E) shall be epoxy coated.
- If the Contractor elects to use cantilever forming brackets on the exterior beams or girders, the brackets shall be placed at the same locations as required for the hardwood blocks in Article 503.06(b) of the Standard Specifications. If additional cantilever forming brackets are required, hardwood blocking shall be wedged between the exterior and first interior beam at each of these additional bracket locations.
- Concrete Sealer shall be applied to the designated areas of the backwalls and bridge seats of the abutments.
- The Organic Zinc Rich Primer / Epoxy / Urethane Paint System shall be used for painting of new structural steel except where otherwise noted. The entire system shall be shop applied, with the exception that masked off connection surfaces, field installed fasteners and damaged areas shall be touched up in the field. The color of the final finish coat for all steel surfaces shall be Gray, Munsell No. 5B 7/1.
- The embankment configuration shown shall be the minimum that must be placed and compacted prior to construction of the abutments.
- Slipforming of the parapets is not allowed.
- Layout of slope protection system may be varied to suit ground conditions in the field as directed by the Engineer.
- Neither the MSE wall cast-in-place concrete facing, anchorage slab & parapet, approach slabs, nor approach roadway pavements shall be constructed until after the roadway embankment and reinforced select fill have been in place for 7 1/2 months, after which time less than 1 inch of the total anticipated 5 3/4 inches settlement is assumed to remain, without the prior approval of the Engineer. The settlement period may be shortened at the discretion of the Engineer if the monitoring data indicates a lesser than predicted settlement.

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- SA2 General Data
- SA3 Riprap Details
- SA4 Top of Slab Elevations I
- SA5 Top of Slab Elevations II
- SA6 Top of Slab Elevations III
- SA7 Top of Approach Slab Elevations
- SA8 Superstructure
- SA9 Superstructure Details I
- SA10 Superstructure Details II
- SA11 Ornamental Aluminum Lattice
- SA12 Architectural Details
- SA13 Bridge Approach Slab
- SA14 Bridge Approach Slab Details
- SA15 Parapet Railing, Special
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- SA28 Anchorage Slabs Details
- SA29 Bar Splicer Assembly Details
- SA30 Boring Logs I
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- SA33 Boring Logs IV

TOTAL BILL OF MATERIAL

ITEM	UNIT	SUPER	SUB	TOTAL
Stone Riprap, Class A5	Sq. Yd.	-	646	646
Filter Fabric	Sq. Yd.	-	646	646
Cofferdam Excavation	Cu. Yd.	-	970	970
Cofferdam (Type 1) (Location 1)	Each	-	1	1
Cofferdam (Type 1) (Location 2)	Each	-	1	1
Concrete Structures	Cu. Yd.	-	226.9	226.9
Concrete Superstructures	Cu. Yd.	669.2	-	669.2
Bridge Deck Grooving	Sq. Yd.	1,587	-	1,587
Form Liner Textured Surface	Sq. Ft.	-	6,979	6,979
Protective Coat	Sq. Yd.	2,033	-	2,033
Furnishing and Erecting Structural Steel	L. Sum	0.32	-	0.32
Stud Shear Connectors	Each	2,130	-	2,130
Reinforcement Bars, Epoxy Coated	Pound	49,340	22,880	72,220
Bar Splicers	Each	-	154	154
Furnishing Steel Piles HP 14X73	Foot	-	3,900	3,900
Driving piles	Foot	-	3,900	3,900
Test Pile Steel HP 14x73	Each	-	2	2
Pile Shoes	Each	-	52	52
Name Plates	Each	1	-	1
Preformed Joint Strip Seal	Foot	157	-	157
Elastomeric Bearing Assembly, Type I	Each	10	-	10
Anchor Bolts, 1"	Each	20	-	20
Anchor Bolts, 1 1/4"	Each	20	-	20
Concrete Sealer	Sq. Ft.	-	1,307	1,307
Geocomposite Wall Drain	Sq. Yd.	-	54	54
Parapet Railing, Special	Foot	270	-	270
Drainage Scuppers, DS-33	Each	2	-	2
Mechanically Stabilized Earth Retaining Wall	Sq. Ft.	-	9,311	9,311
Staining Concrete Structures	Sq. Yd.	-	775	775
Form Liner Textured Surface, Special	Sq. Ft.	676	-	676
Ornamental Aluminum Lattice	Foot	265	-	265

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450 E Devon Ave, Suite 300
Itasca, Illinois 60143
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www.civiltechinc.com

DRAWN	- M. LANGE	REVISED	- 5/3/12 M.F.L.
DESIGNED	- D. ATKINS	REVISED	-
CHECKED	- G. HATLESTAD	REVISED	-
DATE	- 5/3/2012	REVISED	-


**STATE OF ILLINOIS
DEPARTMENT OF TRANSPORTATION**

**GENERAL DATA
ILLINOIS ROUTE 31 OVER CRYSTAL CREEK
STRUCTURE NO. 056-0077**


O.R. RTE.	SECTION	COUNTY	TOTAL SHEETS	SHEET NO.
0003	18A-2	MCHENRY	825	462
CONTRACT NO. 60F72				
ILLINOIS FED. AID PROJECT				

SHEET NO. SA2 OF SA33 SHEETS

4/26/14 cad sheet Roadway\20-Structures & Walls\01.SN 056-0077\0560077-60F72-03-RRD.dgn
 4/16/13 PM
 5/2/2012

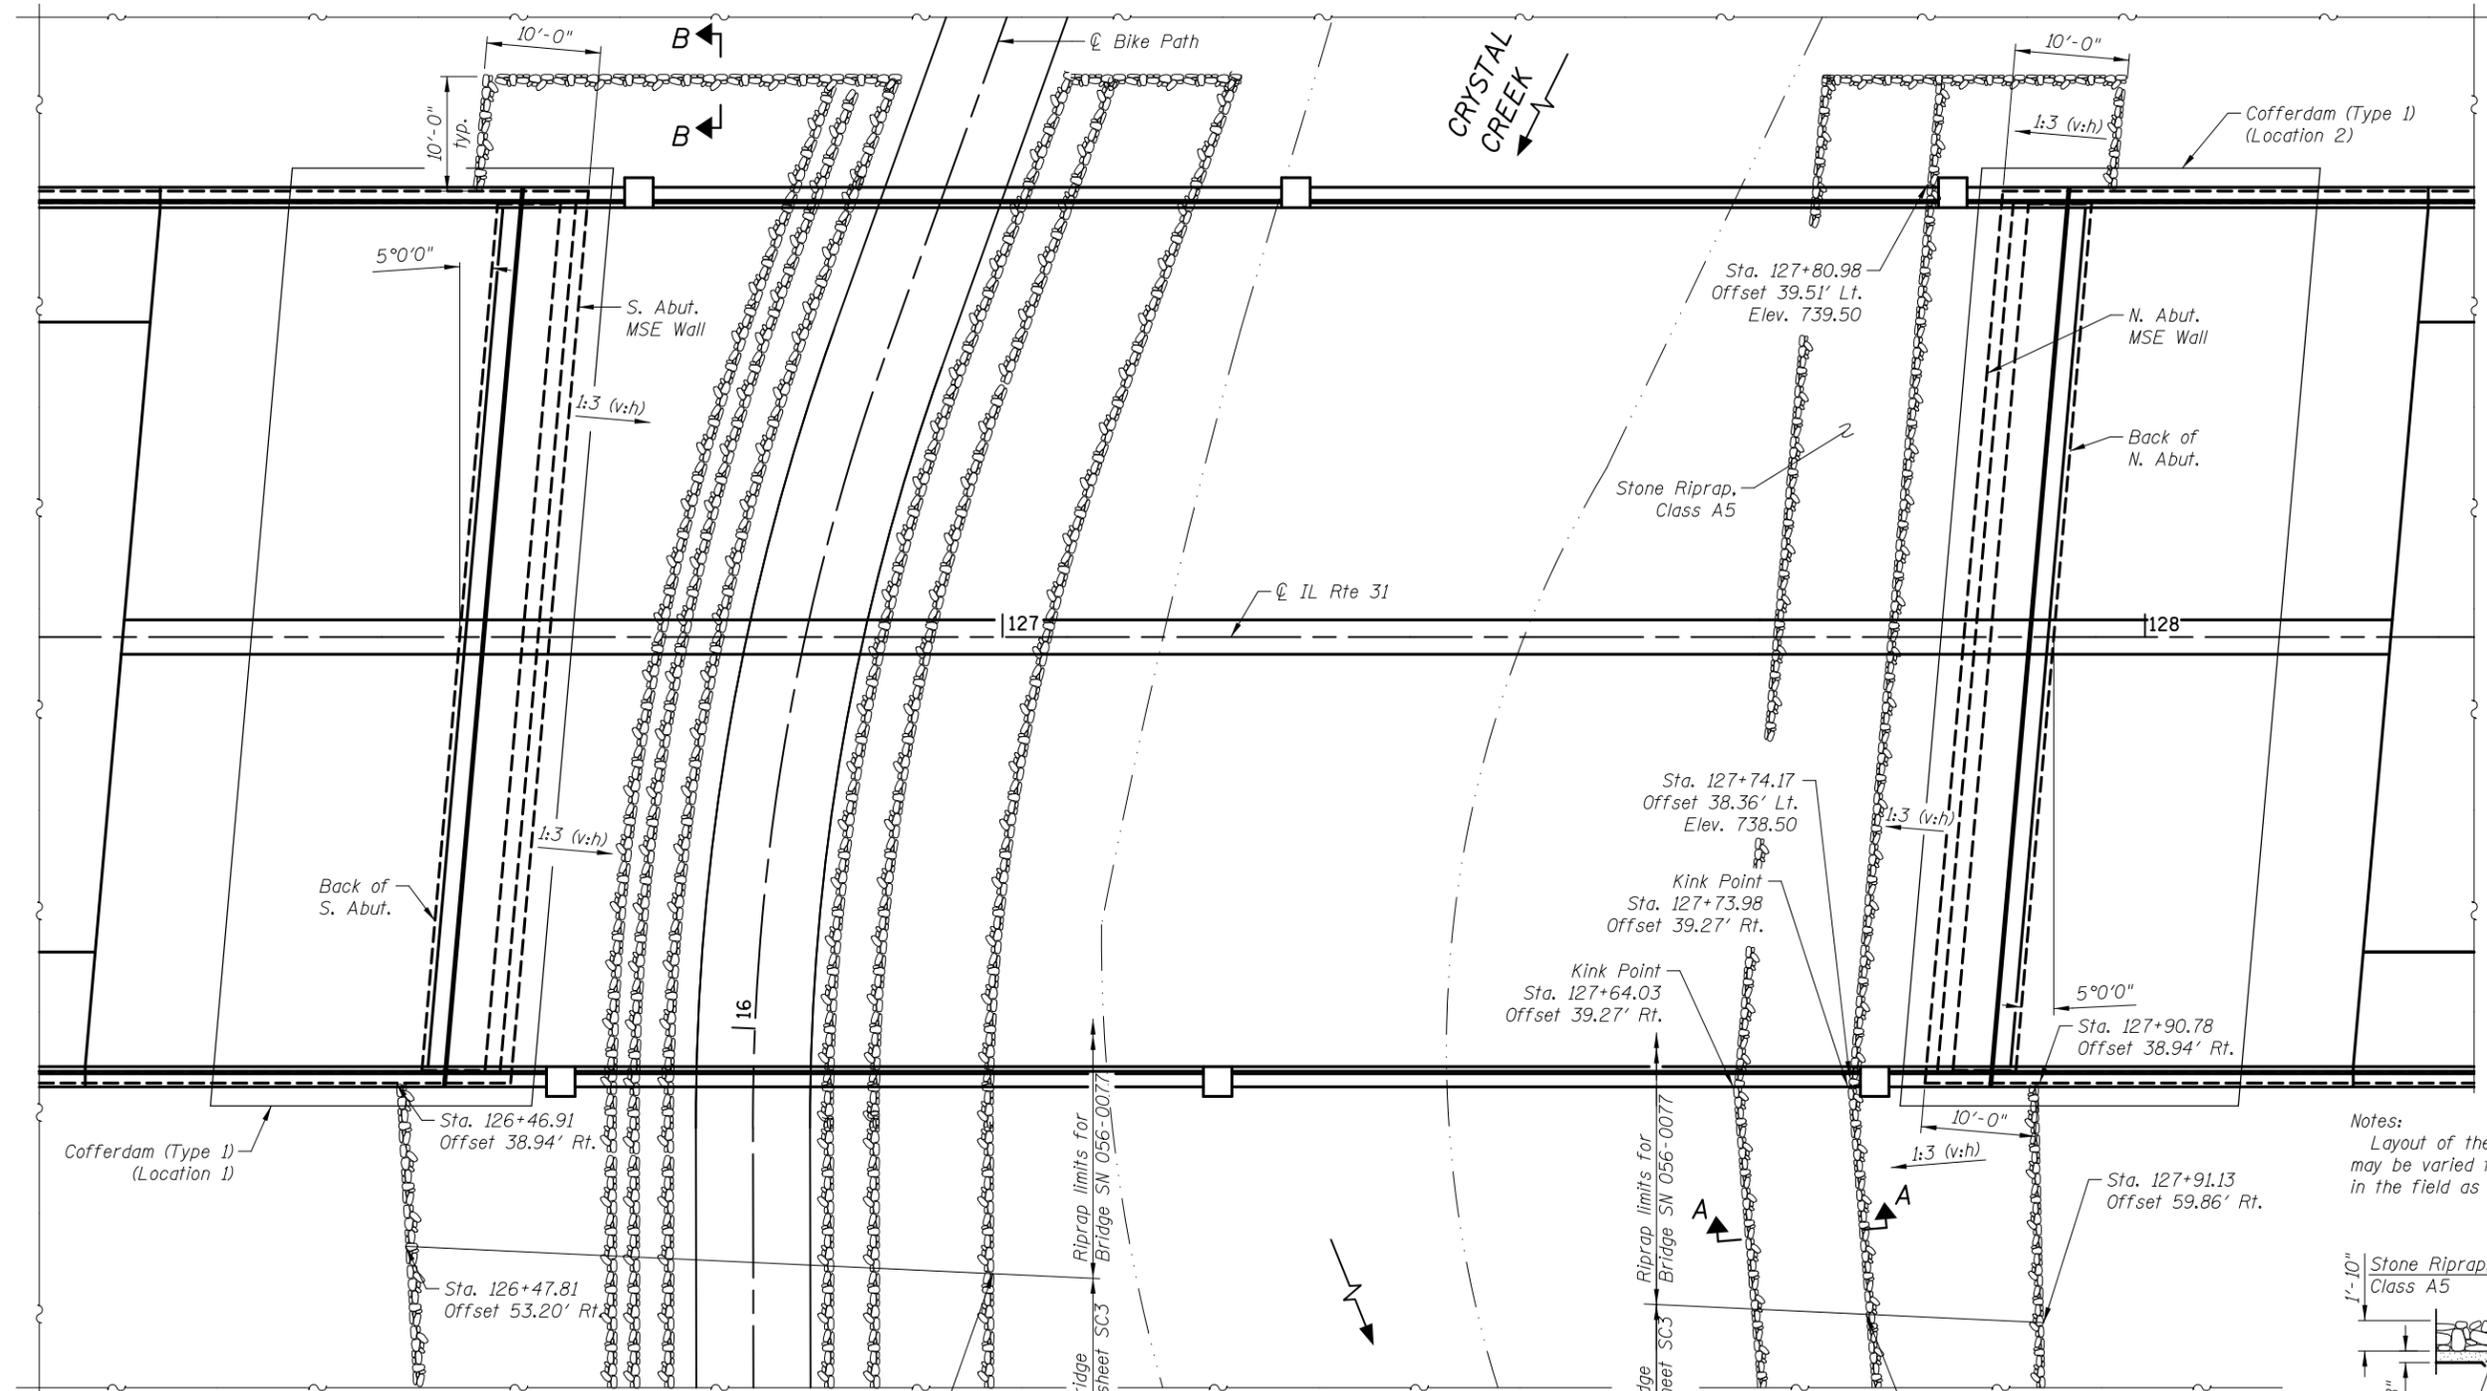




Notes:
Layout of the slope protection system may be varied to suit ground conditions in the field as directed by the Engineer.

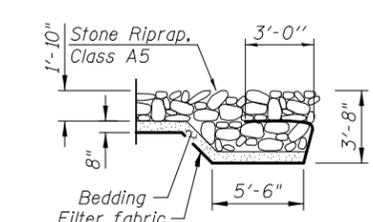

Bedding to be included in the cost of Stone Riprap, Class A5.

BILL OF MATERIAL

Item	Unit	Total
Stone Riprap, Class A5	Sq. Yd.	646
Filter Fabric	Sq. Yd.	646
Cofferdam Excavation	Cu. Yd.	970
Cofferdam (Type 1) (Location 1)	Each	1
Cofferdam (Type 1) (Location 2)	Each	1

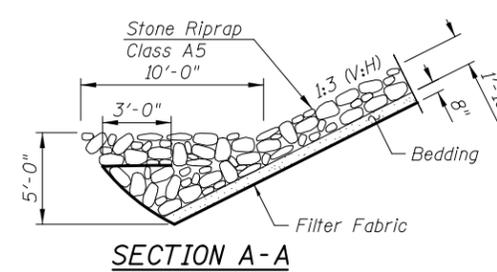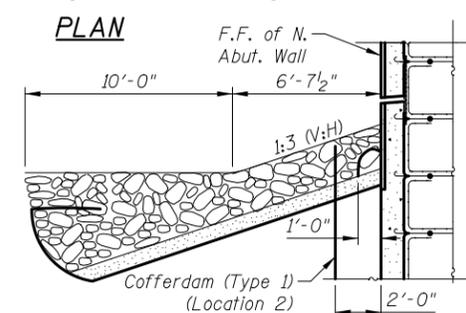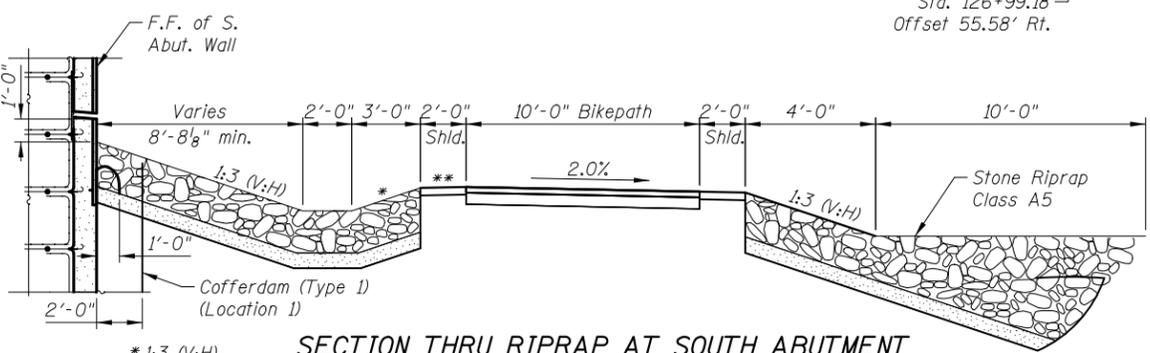


STATE OF ILLINOIS
DEPARTMENT OF TRANSPORTATION

RIPRAP DETAILS
 ILLINOIS ROUTE 31 OVER CRYSTAL CREEK
 STRUCTURE NO. 056-0077
 SHEET NO. SA3 OF SA33 SHEETS

CIVILTECH
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DRAWN - M. LANGE	REVISED -
DESIGNED - D. ATKINS	REVISED -
CHECKED - G. HATLESTAD	REVISED -
DATE - 5/3/2012	REVISED -

O.R. RTE.	SECTION	COUNTY	TOTAL SHEETS	SHEET NO.
0003	18A-2	MCHENRY	825	463
				CONTRACT NO. 60F72
ILLINOIS FED. AID PROJECT				

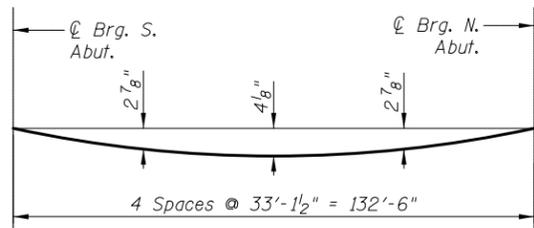


DEAD LOAD DEFLECTION DIAGRAM

(Includes weight of concrete only.)

Note:

The above deflections are not for use in the field if the Engineer is working from the "Theoretical Grade Elevations Adjusted for Dead Load Deflection" on sheets SA5 & SA6.

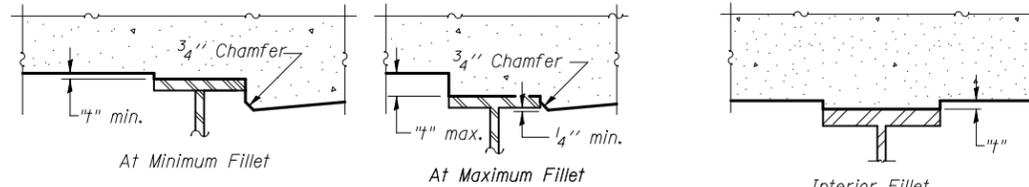


Exterior Beams

Interior Beams

To determine "t": After all structural steel has been erected, elevations of the top flanges of the beams shall be taken at intervals shown below. These elevations subtracted from the "Theoretical Grade Elevations Adjusted for Dead Load Deflection" shown on sheets SA5 & SA6, minus slab thickness, equals the fillet heights "t" above top flange of beams.

FILLET HEIGHTS

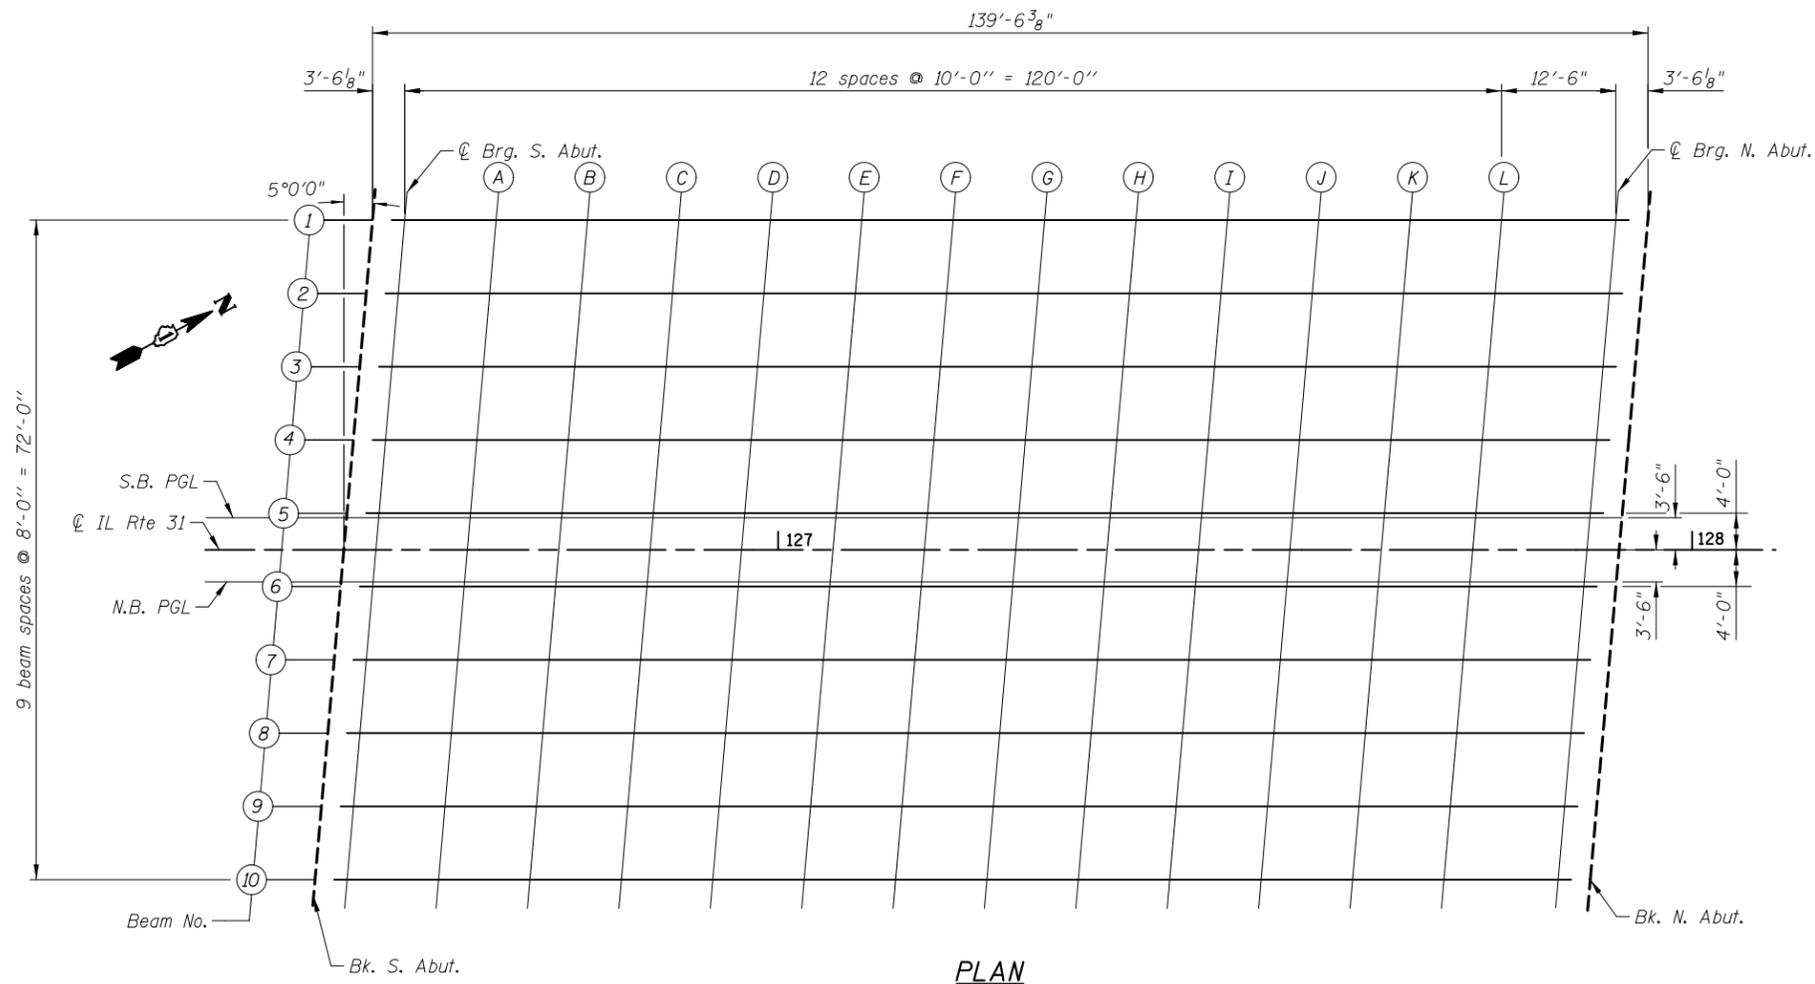

PLAN

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DRAWN	- M. LANGE	REVISED	-
DESIGNED	- D. ATKINS	REVISED	-
CHECKED	- G. HATLESTAD	REVISED	-
DATE	- 5/3/2012	REVISED	-

O.R. RTE.	SECTION	COUNTY	TOTAL SHEETS	SHEET NO.
0003	18A-2	MCHENRY	825	464
CONTRACT NO. 60F72				
ILLINOIS FED. AID PROJECT				

BEAM 1

Location	Station	Offset	Theoretical Grade Elevation	Theoretical Grade Elev Adj for Dead Load Deflection
Bk. S Abut.	126+55.64	-36.00	768.55	768.55
⊙ Brg. S Abut.	126+59.15	-36.00	768.59	768.59
A	126+69.15	-36.00	768.70	768.78
B	126+79.15	-36.00	768.81	768.97
C	126+89.15	-36.00	768.92	769.15
D	126+99.15	-36.00	769.03	769.31
E	127+09.15	-36.00	769.14	769.46
F	127+19.15	-36.00	769.25	769.59
G	127+29.15	-36.00	769.36	769.70
H	127+39.15	-36.00	769.47	769.80
I	127+49.15	-36.00	769.58	769.87
J	127+59.15	-36.00	769.69	769.93
K	127+69.15	-36.00	769.80	769.98
L	127+79.15	-36.00	769.91	770.01
⊙ Brg. N Abut.	127+91.65	-36.00	770.05	770.05
Bk. N Abut.	127+95.16	-36.00	770.09	770.09

BEAM 2

Location	Station	Offset	Theoretical Grade Elevation	Theoretical Grade Elev Adj for Dead Load Deflection
Bk. S Abut.	126+54.94	-28.00	768.71	768.71
⊙ Brg. S Abut.	126+58.45	-28.00	768.75	768.75
A	126+68.45	-28.00	768.86	768.94
B	126+78.45	-28.00	768.97	769.13
C	126+88.45	-28.00	769.08	769.31
D	126+98.45	-28.00	769.19	769.47
E	127+08.45	-28.00	769.30	769.62
F	127+18.45	-28.00	769.41	769.75
G	127+28.45	-28.00	769.52	769.86
H	127+38.45	-28.00	769.63	769.96
I	127+48.45	-28.00	769.74	770.03
J	127+58.45	-28.00	769.85	770.09
K	127+68.45	-28.00	769.96	770.14
L	127+78.45	-28.00	770.07	770.17
⊙ Brg. N Abut.	127+90.95	-28.00	770.21	770.21
Bk. N Abut.	127+94.46	-28.00	770.25	770.25

BEAM 3

Location	Station	Offset	Theoretical Grade Elevation	Theoretical Grade Elev Adj for Dead Load Deflection
Bk. S Abut.	126+54.24	-20.00	768.87	768.87
⊙ Brg. S Abut.	126+57.75	-20.00	768.91	768.91
A	126+67.75	-20.00	769.02	769.10
B	126+77.75	-20.00	769.13	769.29
C	126+87.75	-20.00	769.24	769.47
D	126+97.75	-20.00	769.35	769.63
E	127+07.75	-20.00	769.46	769.78
F	127+17.75	-20.00	769.57	769.91
G	127+27.75	-20.00	769.68	770.02
H	127+37.75	-20.00	769.79	770.12
I	127+47.75	-20.00	769.90	770.19
J	127+57.75	-20.00	770.01	770.25
K	127+67.75	-20.00	770.12	770.30
L	127+77.75	-20.00	770.23	770.33
⊙ Brg. N Abut.	127+90.25	-20.00	770.37	770.37
Bk. N Abut.	127+93.76	-20.00	770.40	770.40

BEAM 4

Location	Station	Offset	Theoretical Grade Elevation	Theoretical Grade Elev Adj for Dead Load Deflection
Bk. S Abut.	126+53.54	-12.00	769.03	769.03
⊙ Brg. S Abut.	126+57.05	-12.00	769.07	769.07
A	126+67.05	-12.00	769.18	769.26
B	126+77.05	-12.00	769.29	769.45
C	126+87.05	-12.00	769.40	769.62
D	126+97.05	-12.00	769.51	769.79
E	127+07.05	-12.00	769.62	769.94
F	127+17.05	-12.00	769.73	770.07
G	127+27.05	-12.00	769.84	770.18
H	127+37.05	-12.00	769.95	770.28
I	127+47.05	-12.00	770.06	770.35
J	127+57.05	-12.00	770.17	770.41
K	127+67.05	-12.00	770.28	770.45
L	127+77.05	-12.00	770.39	770.49
⊙ Brg. N Abut.	127+89.55	-12.00	770.52	770.52
Bk. N Abut.	127+93.06	-12.00	770.56	770.56

BEAM 5

Location	Station	Offset	Theoretical Grade Elevation	Theoretical Grade Elev Adj for Dead Load Deflection
Bk. S Abut.	126+52.84	-4.00	769.19	769.19
⊙ Brg. S Abut.	126+56.35	-4.00	769.23	769.23
A	126+66.35	-4.00	769.34	769.42
B	126+76.35	-4.00	769.45	769.61
C	126+86.35	-4.00	769.56	769.78
D	126+96.35	-4.00	769.67	769.95
E	127+06.35	-4.00	769.78	770.10
F	127+16.35	-4.00	769.89	770.23
G	127+26.35	-4.00	770.00	770.34
H	127+36.35	-4.00	770.11	770.44
I	127+46.35	-4.00	770.22	770.51
J	127+56.35	-4.00	770.33	770.57
K	127+66.35	-4.00	770.44	770.61
L	127+76.35	-4.00	770.55	770.65
⊙ Brg. N Abut.	127+88.85	-4.00	770.68	770.68
Bk. N Abut.	127+92.36	-4.00	770.72	770.72

SB PGL

Location	Station	Offset	Theoretical Grade Elevation	Theoretical Grade Elev Adj for Dead Load Deflection
Bk. S Abut.	126+52.79	-3.50	769.20	769.20
⊙ Brg. S Abut.	126+56.31	-3.50	769.24	769.24
A	126+66.31	-3.50	769.35	769.43
B	126+76.31	-3.50	769.46	769.62
C	126+86.31	-3.50	769.57	769.79
D	126+96.31	-3.50	769.68	769.96
E	127+06.31	-3.50	769.79	770.11
F	127+16.31	-3.50	769.90	770.24
G	127+26.31	-3.50	770.01	770.35
H	127+36.31	-3.50	770.12	770.45
I	127+46.31	-3.50	770.23	770.52
J	127+56.31	-3.50	770.34	770.58
K	127+66.31	-3.50	770.45	770.62
L	127+76.31	-3.50	770.56	770.66
⊙ Brg. N Abut.	127+88.81	-3.50	770.69	770.69
Bk. N Abut.	127+92.32	-3.50	770.73	770.73

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NB PGL

Location	Station	Offset	Theoretical Grade Elevation	Theoretical Grade Elev Adj for Dead Load Deflection
Bk. S Abut.	126+52.18	3.50	769.19	769.19
☉ Brg. S Abut.	126+55.69	3.50	769.23	769.23
A	126+65.69	3.50	769.34	769.42
B	126+75.69	3.50	769.45	769.61
C	126+85.69	3.50	769.56	769.79
D	126+95.69	3.50	769.67	769.95
E	127+05.69	3.50	769.78	770.10
F	127+15.69	3.50	769.89	770.23
G	127+25.69	3.50	770.00	770.34
H	127+35.69	3.50	770.11	770.44
I	127+45.69	3.50	770.22	770.51
J	127+55.69	3.50	770.33	770.57
K	127+65.69	3.50	770.44	770.62
L	127+75.69	3.50	770.55	770.65
☉ Brg. N Abut.	127+88.19	3.50	770.69	770.69
Bk. N Abut.	127+91.71	3.50	770.73	770.73

BEAM 6

Location	Station	Offset	Theoretical Grade Elevation	Theoretical Grade Elev Adj for Dead Load Deflection
Bk. S Abut.	126+52.14	4.00	769.18	769.18
☉ Brg. S Abut.	126+55.65	4.00	769.22	769.22
A	126+65.65	4.00	769.33	769.41
B	126+75.65	4.00	769.44	769.60
C	126+85.65	4.00	769.55	769.78
D	126+95.65	4.00	769.66	769.94
E	127+05.65	4.00	769.77	770.09
F	127+15.65	4.00	769.88	770.22
G	127+25.65	4.00	769.99	770.33
H	127+35.65	4.00	770.10	770.43
I	127+45.65	4.00	770.21	770.50
J	127+55.65	4.00	770.32	770.56
K	127+65.65	4.00	770.43	770.61
L	127+75.65	4.00	770.54	770.64
☉ Brg. N Abut.	127+88.15	4.00	770.68	770.68
Bk. N Abut.	127+91.66	4.00	770.71	770.71

BEAM 7

Location	Station	Offset	Theoretical Grade Elevation	Theoretical Grade Elev Adj for Dead Load Deflection
Bk. S Abut.	126+51.44	12.00	769.01	769.01
☉ Brg. S Abut.	126+54.95	12.00	769.05	769.05
A	126+64.95	12.00	769.16	769.24
B	126+74.95	12.00	769.27	769.42
C	126+84.95	12.00	769.38	769.60
D	126+94.95	12.00	769.49	769.77
E	127+04.95	12.00	769.60	769.91
F	127+14.95	12.00	769.71	770.04
G	127+24.95	12.00	769.82	770.16
H	127+34.95	12.00	769.93	770.25
I	127+44.95	12.00	770.04	770.33
J	127+54.95	12.00	770.15	770.39
K	127+64.95	12.00	770.26	770.43
L	127+74.95	12.00	770.36	770.47
☉ Brg. N Abut.	127+87.45	12.00	770.50	770.50
Bk. N Abut.	127+90.96	12.00	770.54	770.54

BEAM 8

Location	Station	Offset	Theoretical Grade Elevation	Theoretical Grade Elev Adj for Dead Load Deflection
Bk. S Abut.	126+50.74	20.00	768.83	768.83
☉ Brg. S Abut.	126+54.25	20.00	768.87	768.87
A	126+64.25	20.00	768.98	769.06
B	126+74.25	20.00	769.09	769.25
C	126+84.25	20.00	769.20	769.43
D	126+94.25	20.00	769.31	769.59
E	127+04.25	20.00	769.42	769.74
F	127+14.25	20.00	769.53	769.87
G	127+24.25	20.00	769.64	769.98
H	127+34.25	20.00	769.75	770.08
I	127+44.25	20.00	769.86	770.15
J	127+54.25	20.00	769.97	770.21
K	127+64.25	20.00	770.08	770.26
L	127+74.25	20.00	770.19	770.29
☉ Brg. N Abut.	127+86.75	20.00	770.33	770.33
Bk. N Abut.	127+90.26	20.00	770.37	770.37

BEAM 9

Location	Station	Offset	Theoretical Grade Elevation	Theoretical Grade Elev Adj for Dead Load Deflection
Bk. S Abut.	126+50.04	28.00	768.66	768.66
☉ Brg. S Abut.	126+53.55	28.00	768.70	768.70
A	126+63.55	28.00	768.81	768.89
B	126+73.55	28.00	768.92	769.08
C	126+83.55	28.00	769.03	769.25
D	126+93.55	28.00	769.14	769.42
E	127+03.55	28.00	769.25	769.57
F	127+13.55	28.00	769.36	769.70
G	127+23.55	28.00	769.47	769.81
H	127+33.55	28.00	769.58	769.91
I	127+43.55	28.00	769.69	769.98
J	127+53.55	28.00	769.80	770.04
K	127+63.55	28.00	769.91	770.08
L	127+73.55	28.00	770.02	770.12
☉ Brg. N Abut.	127+86.05	28.00	770.15	770.15
Bk. N Abut.	127+89.56	28.00	770.19	770.19

BEAM 10

Location	Station	Offset	Theoretical Grade Elevation	Theoretical Grade Elev Adj for Dead Load Deflection
Bk. S Abut.	126+49.34	36.00	768.49	768.49
☉ Brg. S Abut.	126+52.85	36.00	768.52	768.52
A	126+62.85	36.00	768.63	768.72
B	126+72.85	36.00	768.74	768.90
C	126+82.85	36.00	768.85	769.08
D	126+92.85	36.00	768.96	769.25
E	127+02.85	36.00	769.07	769.39
F	127+12.85	36.00	769.18	769.52
G	127+22.85	36.00	769.29	769.63
H	127+32.85	36.00	769.40	769.73
I	127+42.85	36.00	769.51	769.80
J	127+52.85	36.00	769.62	769.86
K	127+62.85	36.00	769.73	769.91
L	127+72.85	36.00	769.84	769.95
☉ Brg. N Abut.	127+85.35	36.00	769.98	769.98
Bk. N Abut.	127+88.86	36.00	770.02	770.02

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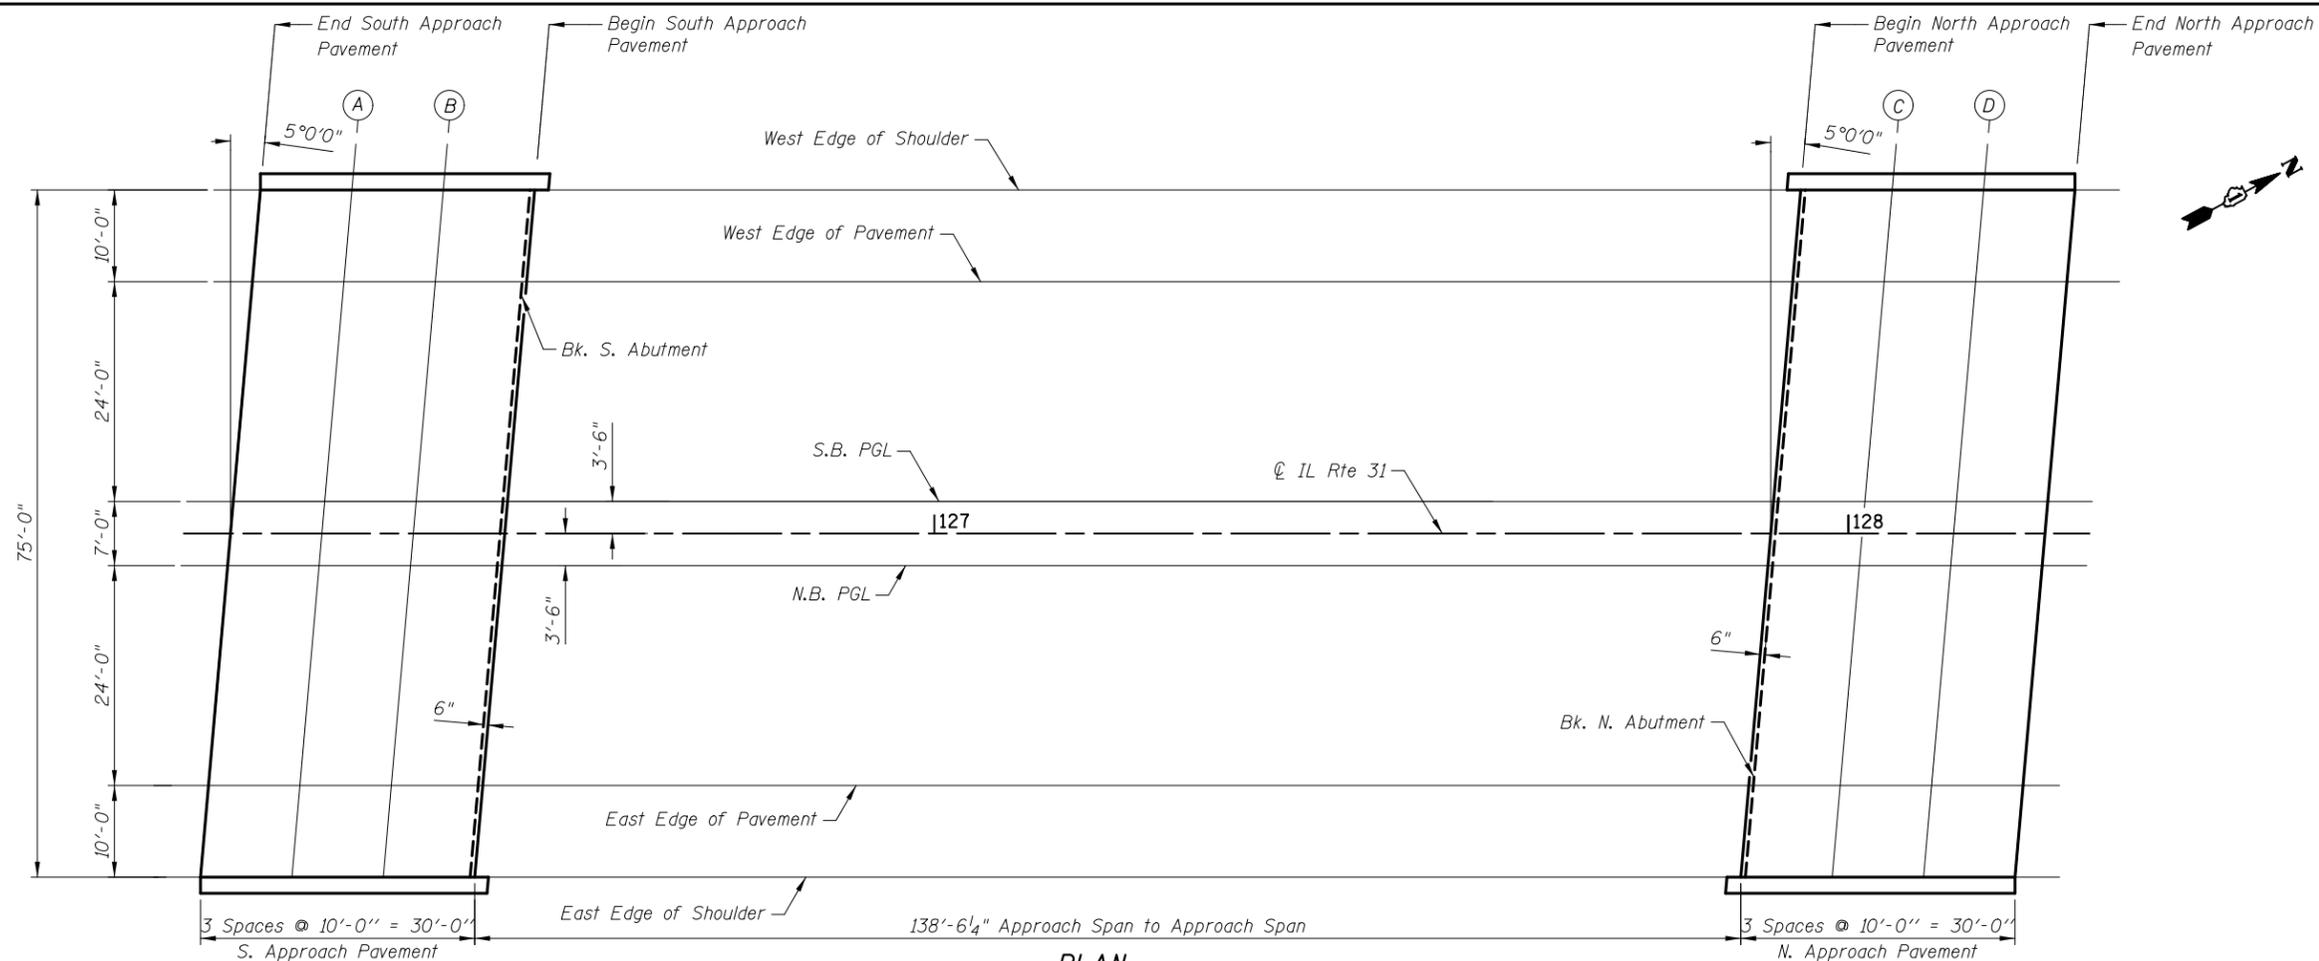
DRAWN	- M. LANGE	REVISED	-
DESIGNED	- D. ATKINS	REVISED	-
CHECKED	- G. HATLESTAD	REVISED	-
DATE	- 5/3/2012	REVISED	-

STATE OF ILLINOIS
DEPARTMENT OF TRANSPORTATION

TOP OF SLAB ELEVATIONS III
ILLINOIS ROUTE 31 OVER CRYSTAL CREEK
STRUCTURE NO. 056-0077

SHEET NO. SA6 OF SA33 SHEETS

O.R. RTE.	SECTION	COUNTY	TOTAL SHEETS	SHEET NO.
0003	18A-2	MCHENRY	825	466
CONTRACT NO. 60F72				
ILLINOIS FED. AID PROJECT				



PLAN

WEST EDGE OF SHOULDER

Location	Station	Offset	Theoretical Grade Elevations
End S. Appr. Pav't	126+26.27	-37.50	768.31
A	126+36.27	-37.50	768.37
B	126+46.27	-37.50	768.44
Begin S. Appr. Pav't	126+56.27	-37.50	768.53
Begin N. Appr. Pav't	127+94.79	-37.50	770.05
C	128+04.79	-37.50	770.16
D	128+14.79	-37.50	770.27
End N. Appr. Pav't	128+24.79	-37.50	770.38

WEST EDGE OF PAVEMENT

Location	Station	Offset	Theoretical Grade Elevations
End S. Appr. Pav't	126+25.39	-27.50	768.58
A	126+35.39	-27.50	768.61
B	126+45.39	-27.50	768.65
Begin S. Appr. Pav't	126+55.39	-27.50	768.73
Begin N. Appr. Pav't	127+93.92	-27.50	770.25
C	128+03.92	-27.50	770.36
D	128+13.92	-27.50	770.47
End N. Appr. Pav't	128+23.92	-27.50	770.58

SOUTHBOUND PGL

Location	Station	Offset	Theoretical Grade Elevations
End S. Appr. Pav't	126+23.29	-3.50	768.88
A	126+33.29	-3.50	768.99
B	126+43.29	-3.50	769.10
Begin S. Appr. Pav't	126+53.29	-3.50	769.21
Begin N. Appr. Pav't	127+91.82	-3.50	770.73
C	128+01.82	-3.50	770.84
D	128+11.82	-3.50	770.95
End N. Appr. Pav't	128+21.82	-3.50	771.06

NORTHBOUND PGL

Location	Station	Offset	Theoretical Grade Elevations
End S. Appr. Pav't	126+22.68	3.50	768.87
A	126+32.68	3.50	768.98
B	126+42.68	3.50	769.09
Begin S. Appr. Pav't	126+52.68	3.50	769.20
Begin N. Appr. Pav't	127+91.21	3.50	770.72
C	128+01.21	3.50	770.83
D	128+11.21	3.50	770.94
End N. Appr. Pav't	128+21.21	3.50	771.05

EAST EDGE OF PAVEMENT

Location	Station	Offset	Theoretical Grade Elevations
End S. Appr. Pav't	126+20.58	27.50	768.35
A	126+30.58	27.50	768.46
B	126+40.58	27.50	768.57
Begin S. Appr. Pav't	126+50.58	27.50	768.68
Begin N. Appr. Pav't	127+89.11	27.50	770.20
C	127+99.11	27.50	770.31
D	128+09.11	27.50	770.42
End N. Appr. Pav't	128+19.11	27.50	770.53

EAST EDGE OF SHOULDER

Location	Station	Offset	Theoretical Grade Elevations
End S. Appr. Pav't	126+19.71	37.50	768.13
A	126+29.71	37.50	768.24
B	126+39.71	37.50	768.35
Begin S. Appr. Pav't	126+49.71	37.50	768.46
Begin N. Appr. Pav't	127+88.23	37.50	769.98
C	127+98.23	37.50	770.09
D	128+08.23	37.50	770.20
End N. Appr. Pav't	128+18.23	37.50	770.31

STATE OF ILLINOIS
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TOP OF APPROACH SLAB ELEVATIONS
ILLINOIS ROUTE 31 OVER CRYSTAL CREEK
STRUCTURE NO. 056-0077



O.R. RTE.	SECTION	COUNTY	TOTAL SHEETS	SHEET NO.
0003	18A-2	MCHENRY	825	467
CONTRACT NO. 60F72				

SHEET NO. SA7 OF SA33 SHEETS

ILLINOIS FED. AID PROJECT


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DRAWN	- M. LANGE	REVISED	-
DESIGNED	- D. ATKINS	REVISED	-
CHECKED	- G. HATLESTAD	REVISED	-
DATE	- 5/3/2012	REVISED	-

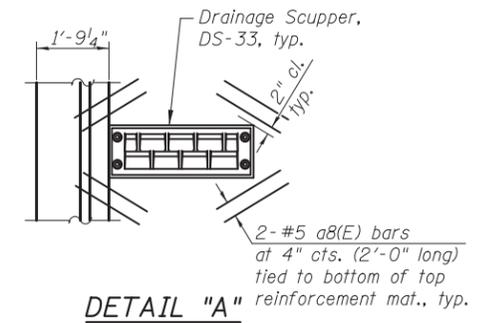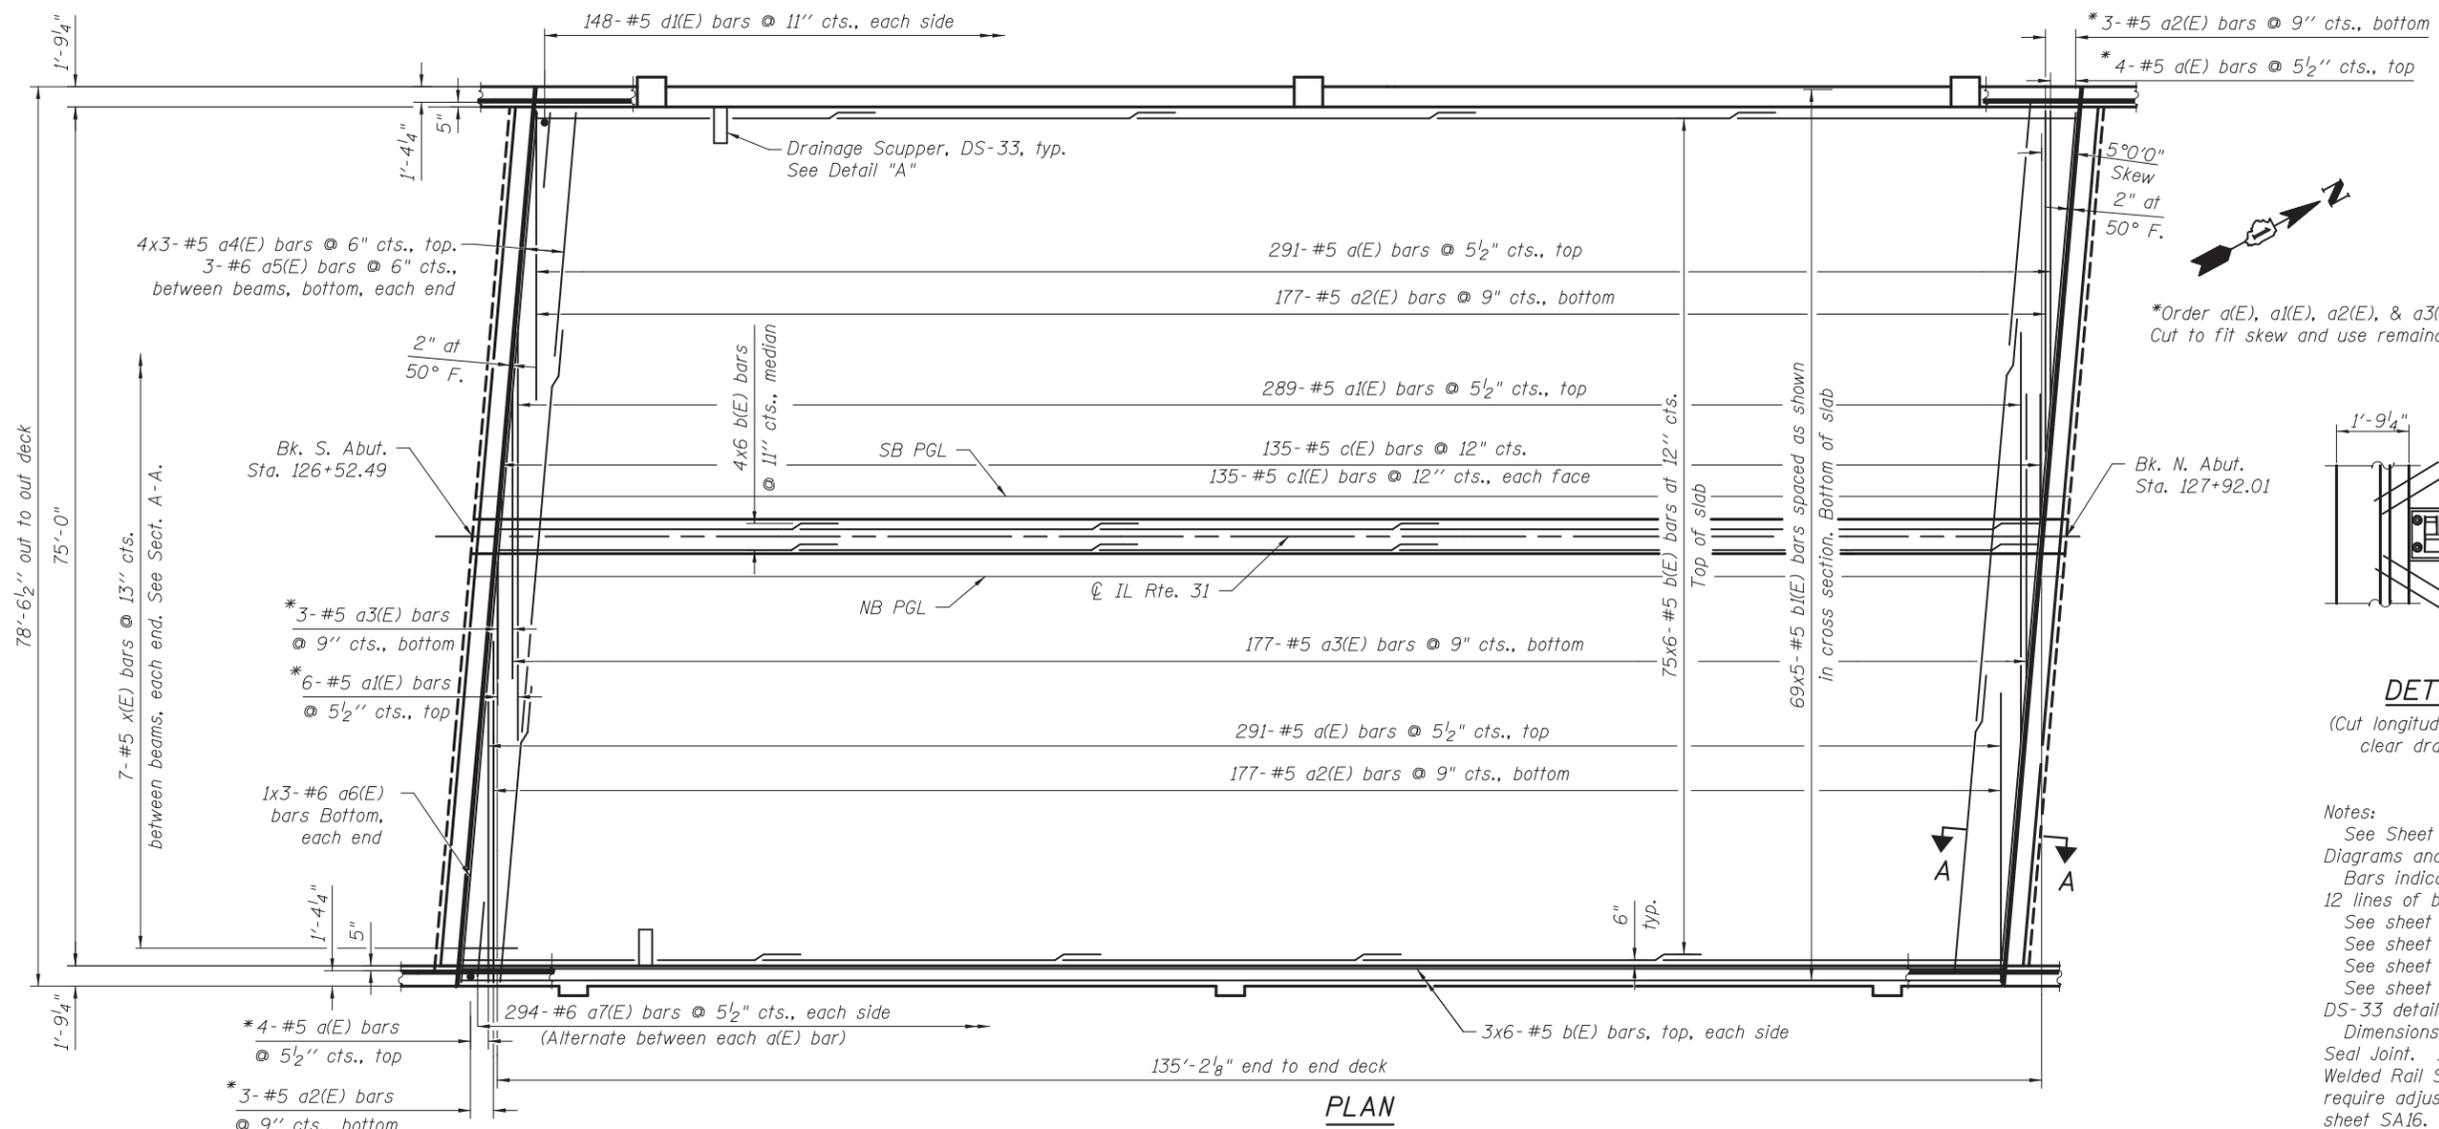

DETAIL "A"
(Cut longitudinal reinforcement to clear drainage scuppers.)

Notes:
 See Sheet SA10 for Bill of Materials, Bar Diagrams and Reinforcement Schedule.
 Bars indicated thus 12 x 2-#5 etc. indicates 12 lines of bars with 2 lengths per line.
 See sheet SA9 for Section A-A.
 See sheet SA9 for Section Thru Parapet.
 See sheet SA9 for parapet reinforcement.
 See sheet SA17 for Drainage Scupper DS-33 details.
 Dimensions are based on a Rolled Rail Strip Seal Joint. If the Contractor elects to use the Welded Rail Strip Seal Joint, deck dimensions may require adjustments to satisfy the details on sheet SA16.
 Drains shall be located clear of all diaphragms.

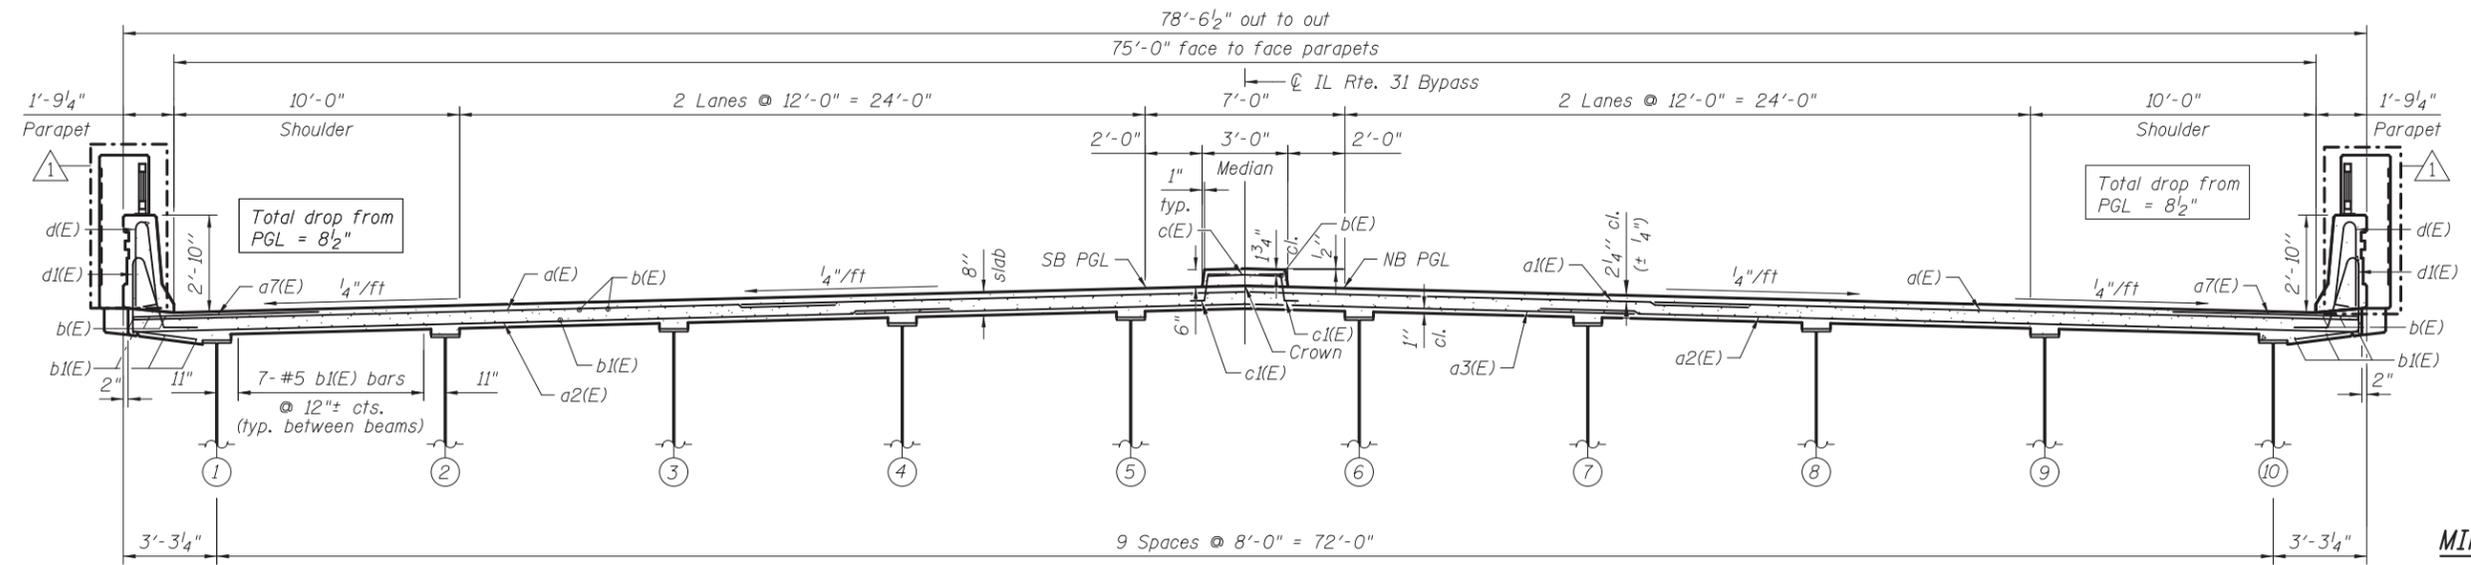

CROSS SECTION
(Looking North)
(Drainage Scuppers not shown)

MINIMUM BAR LAP
(Deck)
 #5 bar = 3'-3"
 #6 bar = 3'-10"

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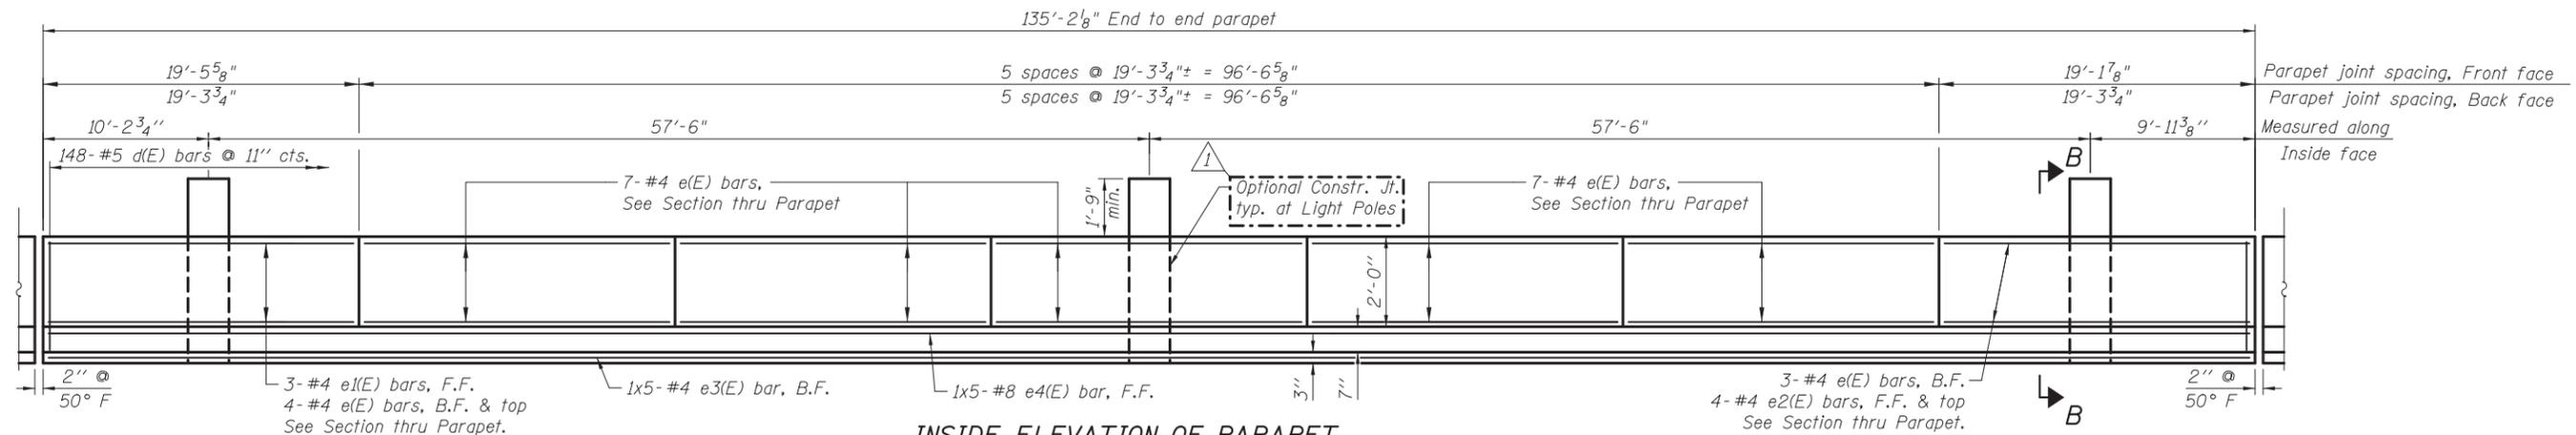
DRAWN - M. LANGE	REVISED - 5/4/12 K.L.B.
DESIGNED - D. ATKINS	REVISED -
CHECKED - G. HATLESTAD	REVISED -
DATE - 5/3/2012	REVISED -

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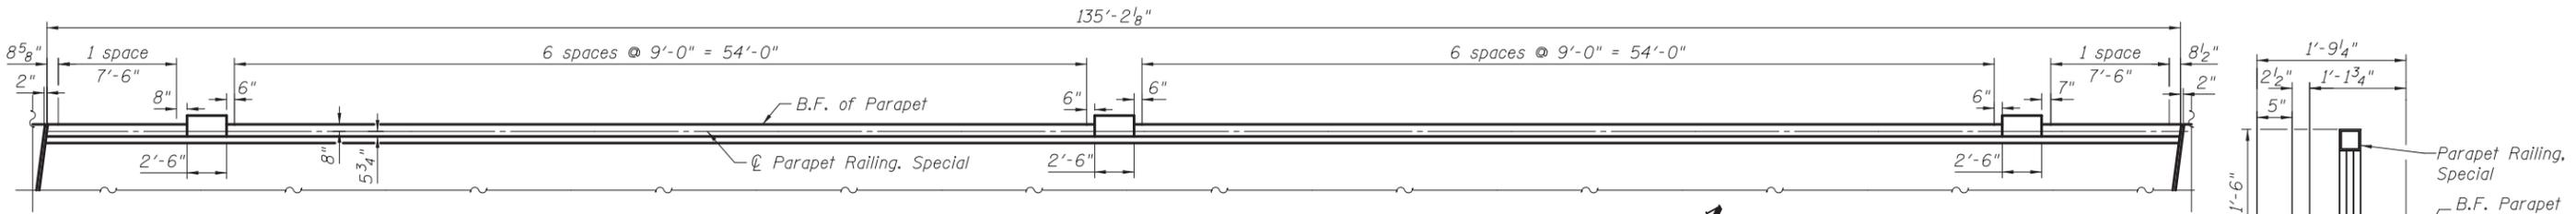
SUPERSTRUCTURE
ILLINOIS ROUTE 31 OVER CRYSTAL CREEK
STRUCTURE NO. 056-0077

O.R. RTE. 0003	SECTION 18A-2	COUNTY MCHENRY	TOTAL SHEETS 825	SHEET NO. 468
CONTRACT NO. 60F72				
ILLINOIS FED. AID PROJECT				


SHEET NO. SA8 OF SA33 SHEETS



INSIDE ELEVATION OF PARAPET
(West parapet shown - East parapet is a mirror image)



PLAN - PARAPET AND PARAPET RAILING
(Parapet Railing Post Spacing along ϕ Parapet Railing)
(West Parapet shown - East Parapet is a mirror image)

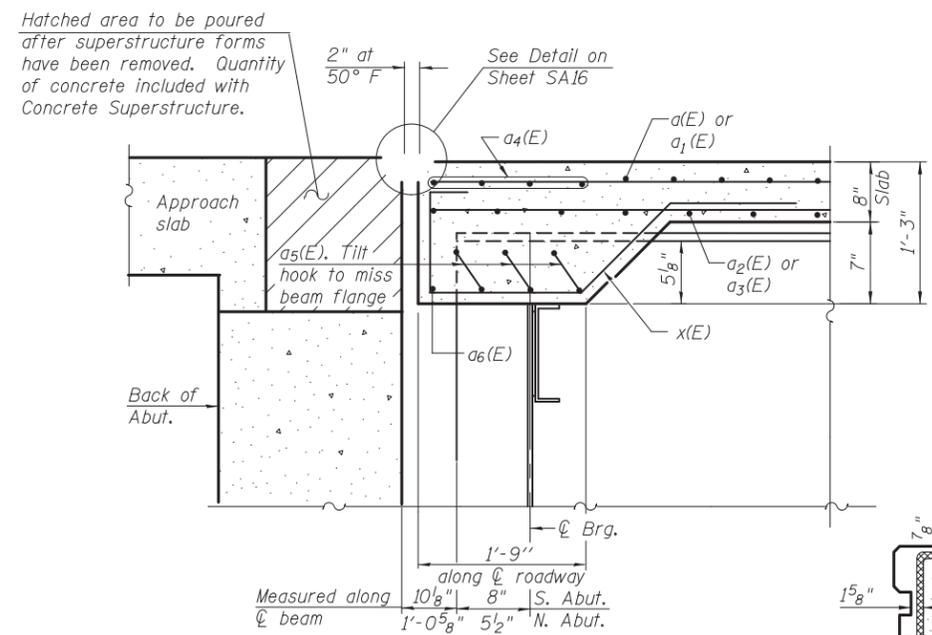


SECTION A-A


MINIMUM BAR LAP

- (Parapet)
- #4 bar = 2'-0"
- #8 bar = 5'-2"

Notes:
See sheet SA12 for Parapet Form Liner details.
See sheet SA15 for Parapet Railing details.
See sheet SA17 for Drainage Scupper, DS-33 details.
See sheet SA10 for Section B-B.
Bars indicated thus 1x5-#8 etc. indicates 1 lines of bars with 5 lengths per line.

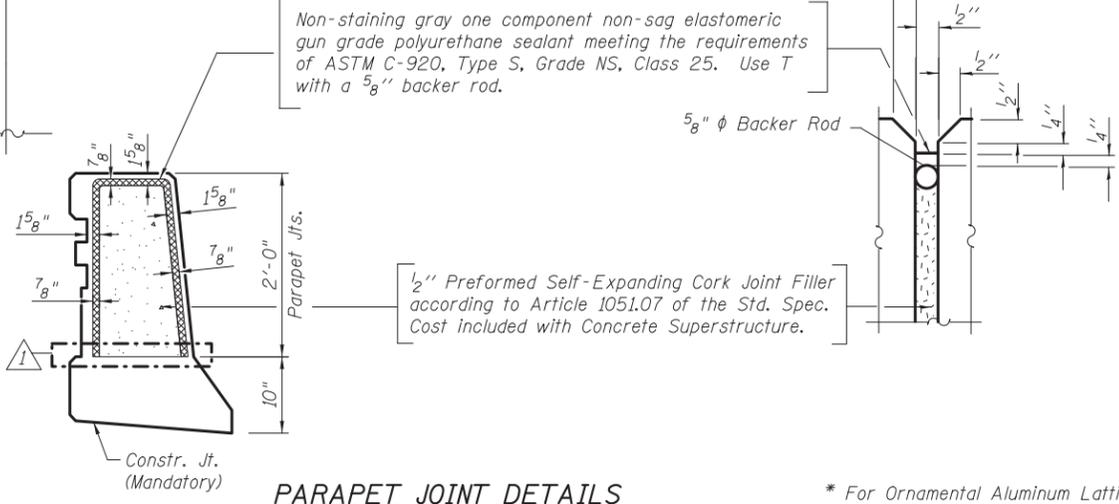

PARAPET JOINT DETAILS

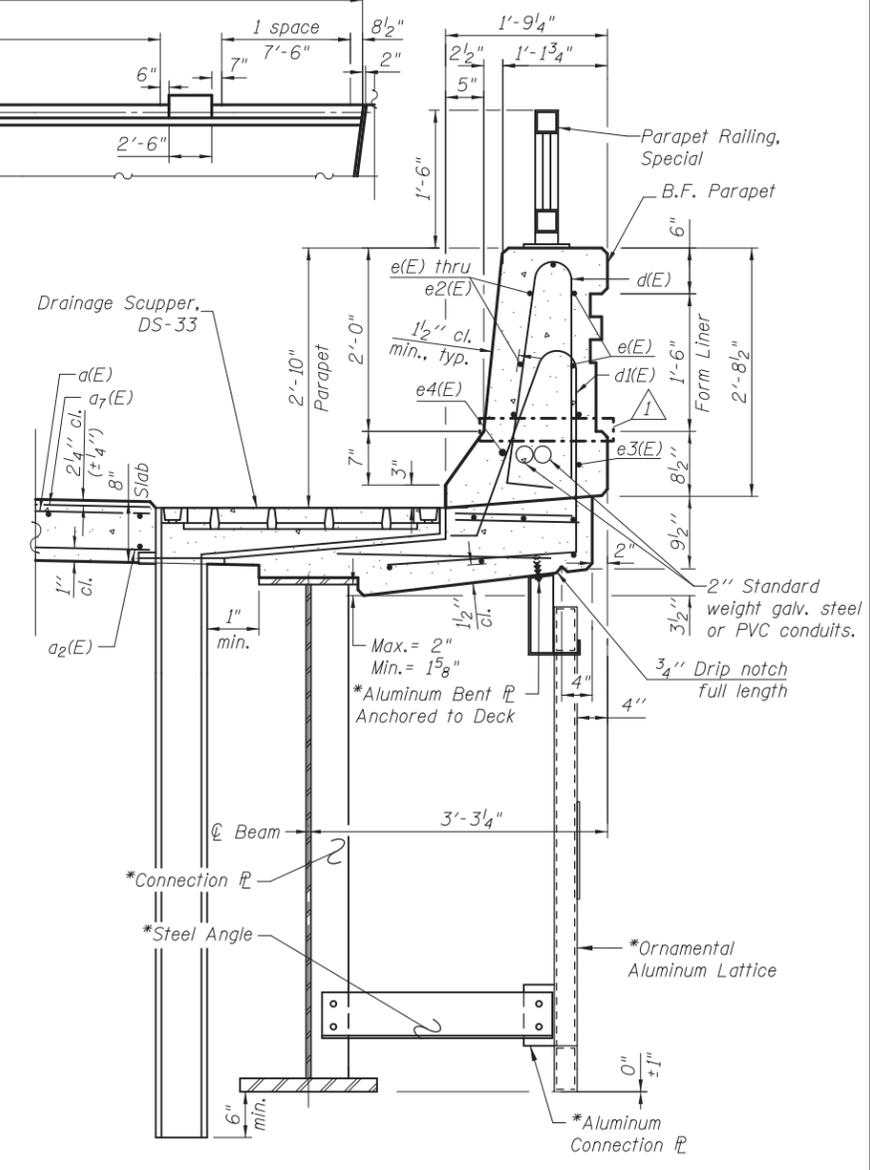

SECTION THRU PARAPET

(All edges have a 3/4" chamfer-Except at Form Liner locations)

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DATE	- 5/3/2012	REVISED	-

**STATE OF ILLINOIS
DEPARTMENT OF TRANSPORTATION**

**SUPERSTRUCTURE DETAILS I
ILLINOIS ROUTE 31 OVER CRYSTAL CREEK
STRUCTURE NO. 056-0077**



SHEET NO. SA9 OF SA33 SHEETS

O.R. RTE.	SECTION	COUNTY	TOTAL SHEETS	SHEET NO.
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CONTRACT NO. 60F72			ILLINOIS FED. AID PROJECT	



**SUPERSTRUCTURE
BILL OF MATERIAL**

Bar	No.	Size	Length	Shape
a(E)	590	#5	24'-7"	—
a1(E)	295	#5	35'-3"	—
a2(E)	360	#5	28'-7"	—
a3(E)	180	#5	27'-3"	—
a4(E)	24	#5	28'-4"	—
a5(E)	54	#6	9'-1"	—
a6(E)	6	#6	28'-9"	—
a7(E)	588	#6	6'-6"	—
a8(E)	16	#5	2'-0"	—
b(E)	510	#5	25'-3"	—
b1(E)	345	#5	29'-7"	—
c(E)	135	#5	2'-8"	—
c1(E)	270	#5	2'-4"	—
d(E)	296	#5	5'-7"	—
d1(E)	296	#5	7'-11"	—
d2(E)	18	#6	6'-2"	—
d3(E)	30	#6	8'-11"	—
d4(E)	18	#6	3'-5"	—
d5(E)	18	#6	3'-8"	—
e(E)	84	#4	19'-0"	—
e1(E)	6	#4	19'-2"	—
e2(E)	8	#4	18'-10"	—
e3(E)	10	#4	28'-7"	—
e4(E)	10	#8	31'-1"	—
x(E)	126	#5	6'-5"	—
Item	Unit	Quantity		
Concrete Superstructure	Cu. Yds.	322.5		
Bridge Deck Grooving	Sq. Yds.	1,082		
Protective Coat	Sq. Yds.	1,271		
Reinforcement Bars, Epoxy Coated	Pound	82,580		
Form Liner Textured Surface, Special	Sq. Ft.	353		


Bars indicated thus 1 x 3-#8 etc. indicates 1 line of bars with 3 lengths per line.

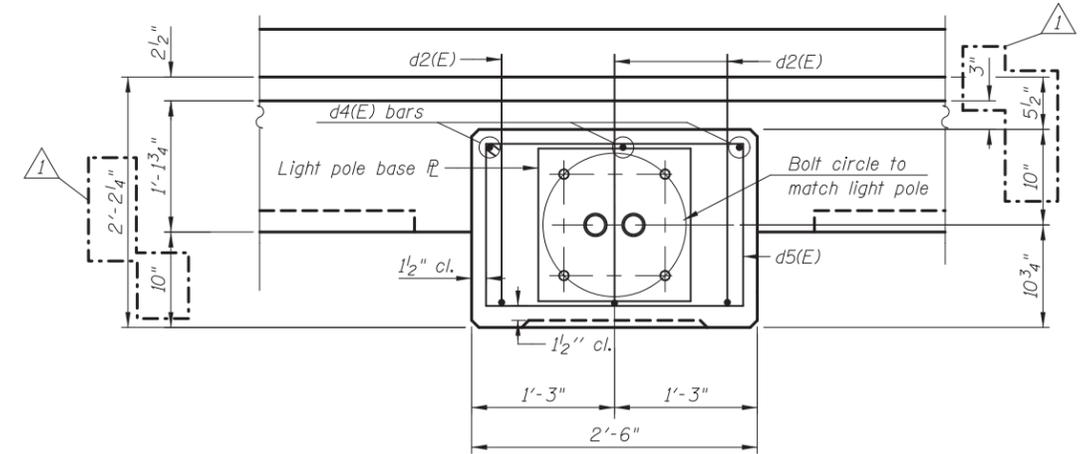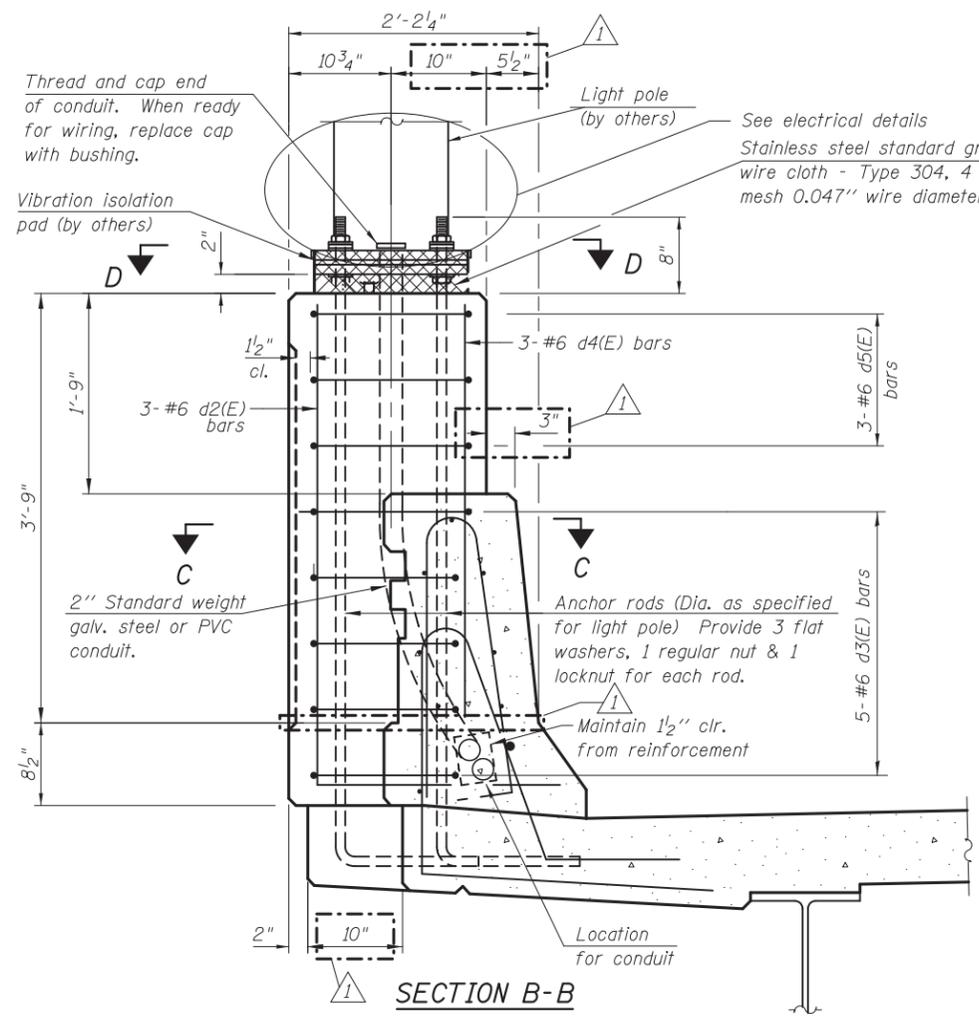


**VIEW D-D
LIGHT POLE FOUNDATION PLAN**

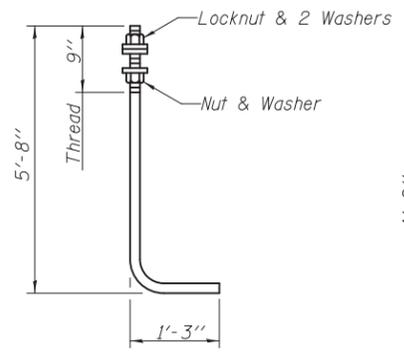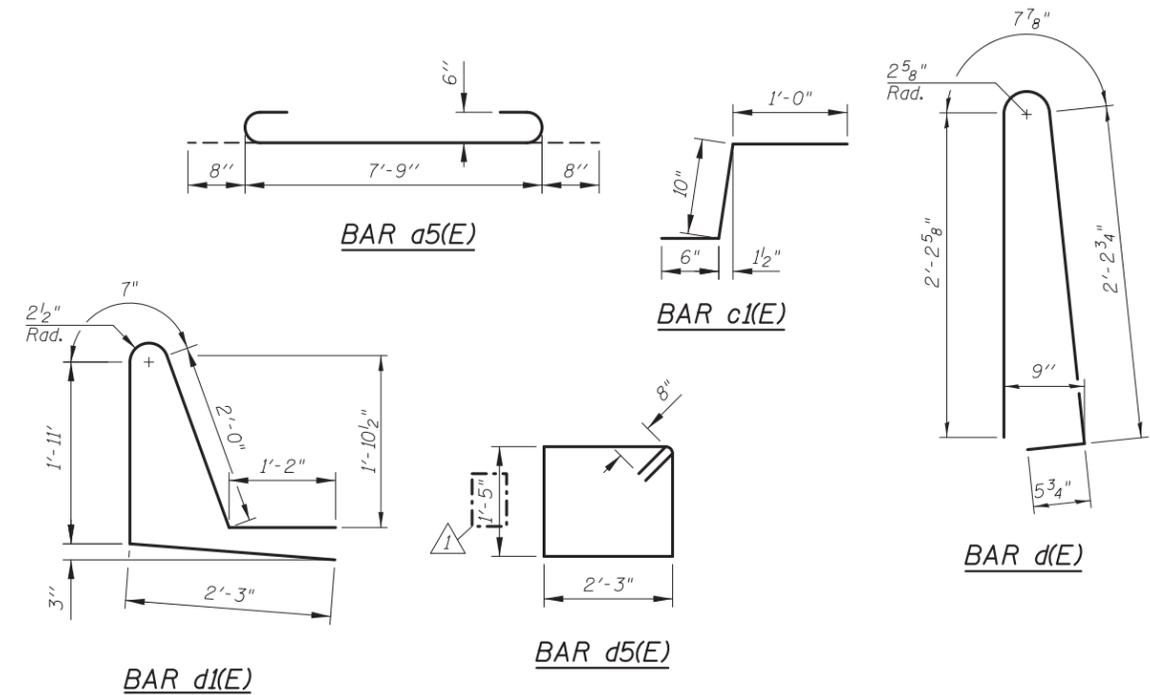


ANCHOR ROD
Diameter as specified for light poles.
(ASTM F 1554 Grade 105)

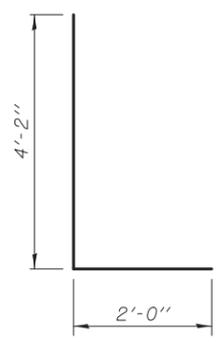


BAR d2(E)

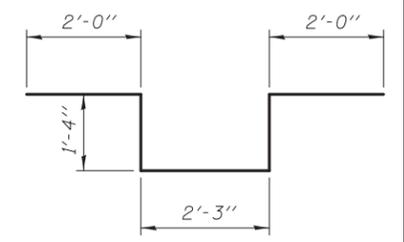

BAR d3(E)

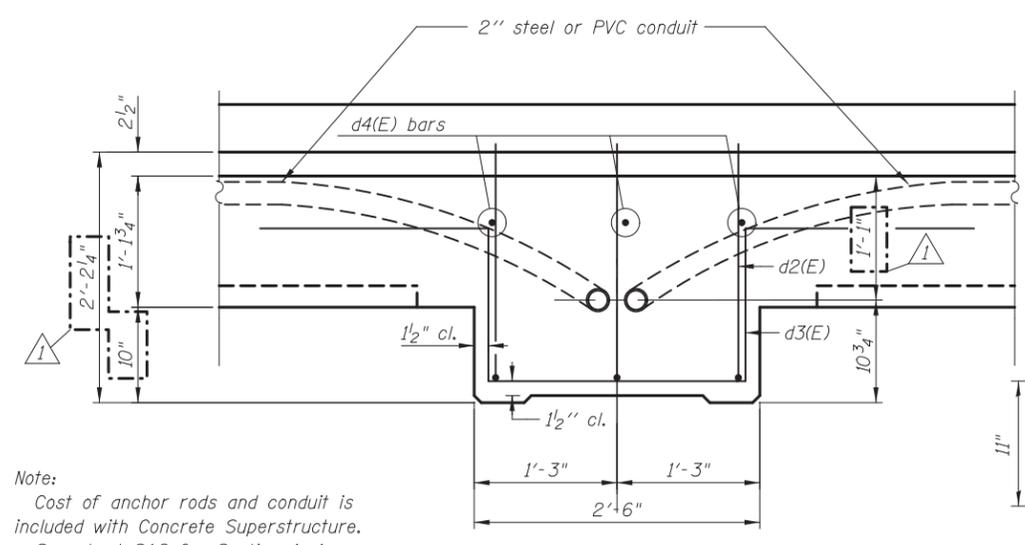


SECTION C-C

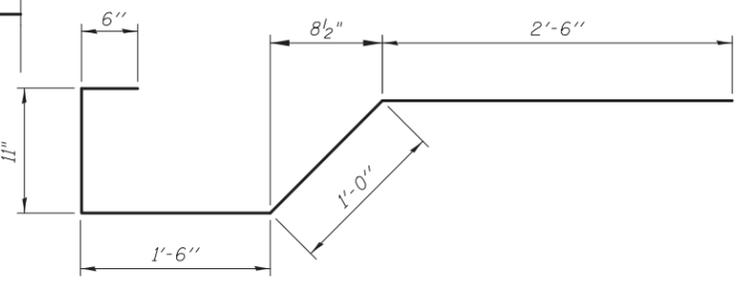


BAR x(E)

Note:
Cost of anchor rods and conduit is included with Concrete Superstructure. See sheet SA9 for Section A-A.


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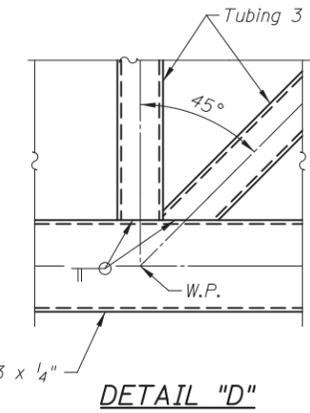
HORIZONTAL BAR SPLICE

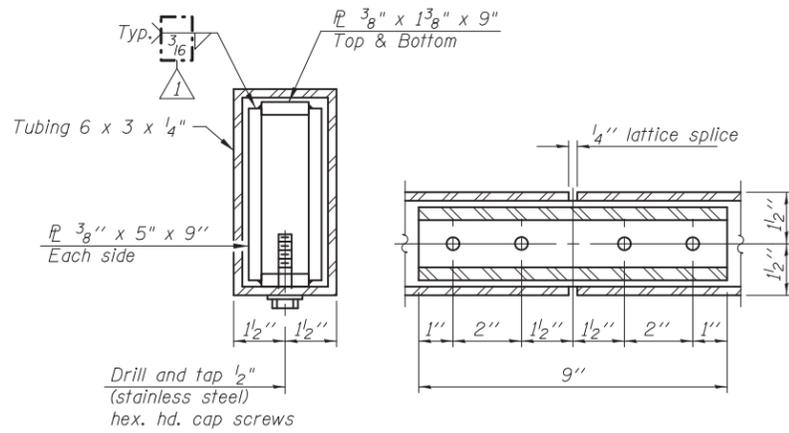


DETAIL "B"

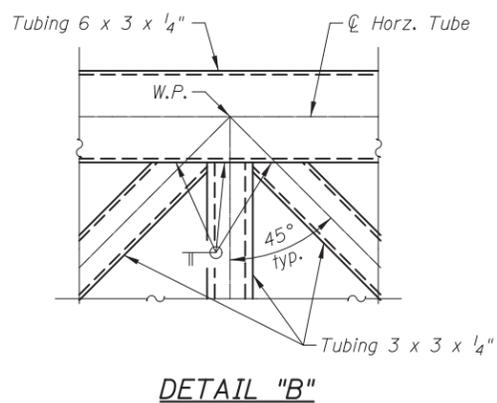


DETAIL "C"
(Aluminum Disk not shown)

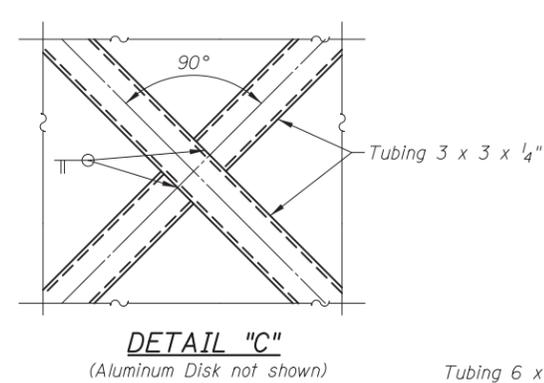


DETAIL "D"

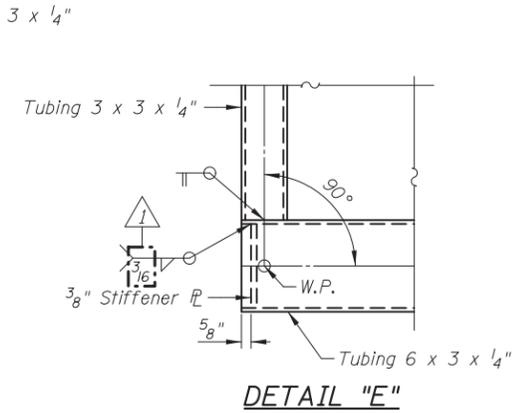


DETAIL "E"

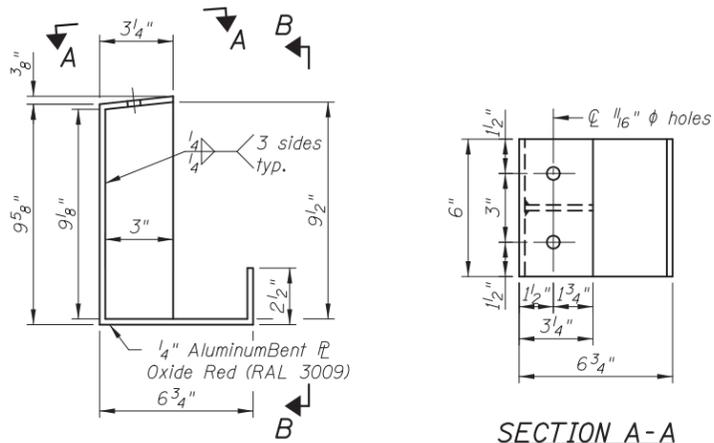


HANGER DETAIL

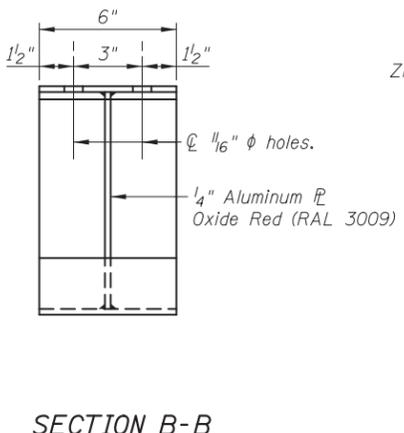


SECTION B-B

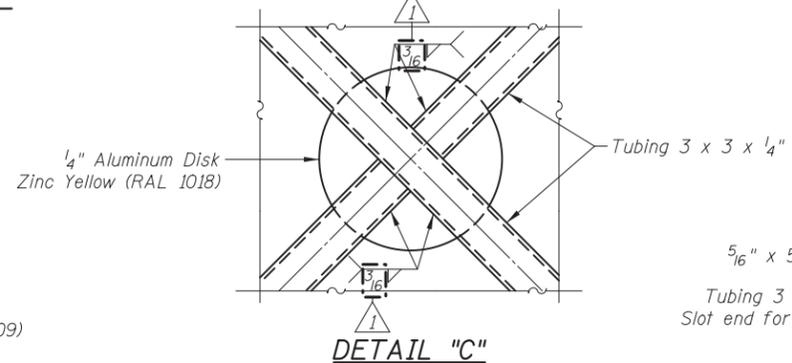


DETAIL "C"

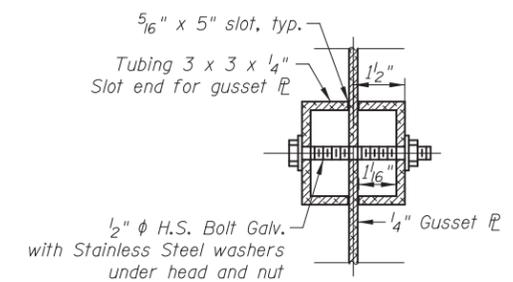

CROSS BAR CONNECTION

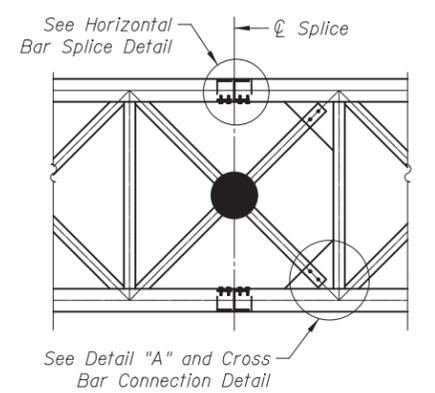


LATTICE SPLICE

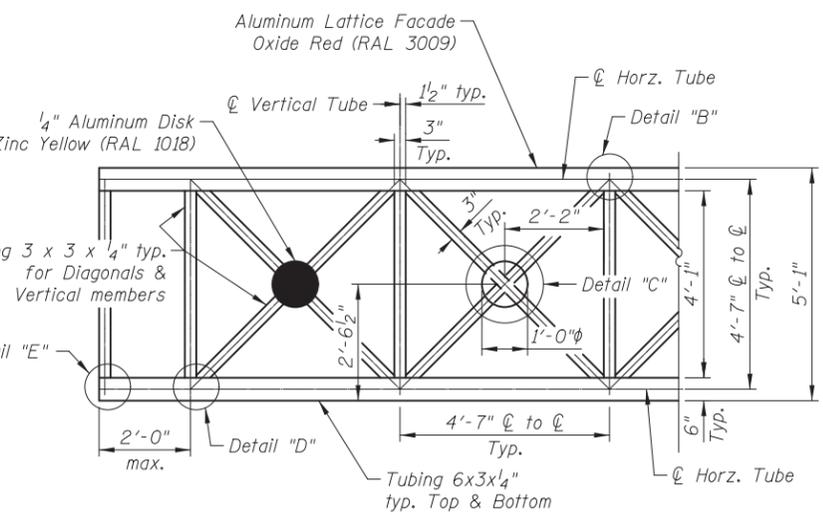


ALUMINUM LATTICE ELEVATION


* Coordinate locations of Connection Plate with Steel Fabricator. Cost included with Furnishing and Erecting Structural Steel

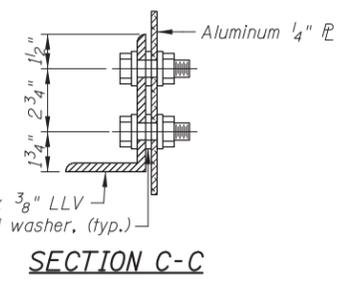

SECTION C-C

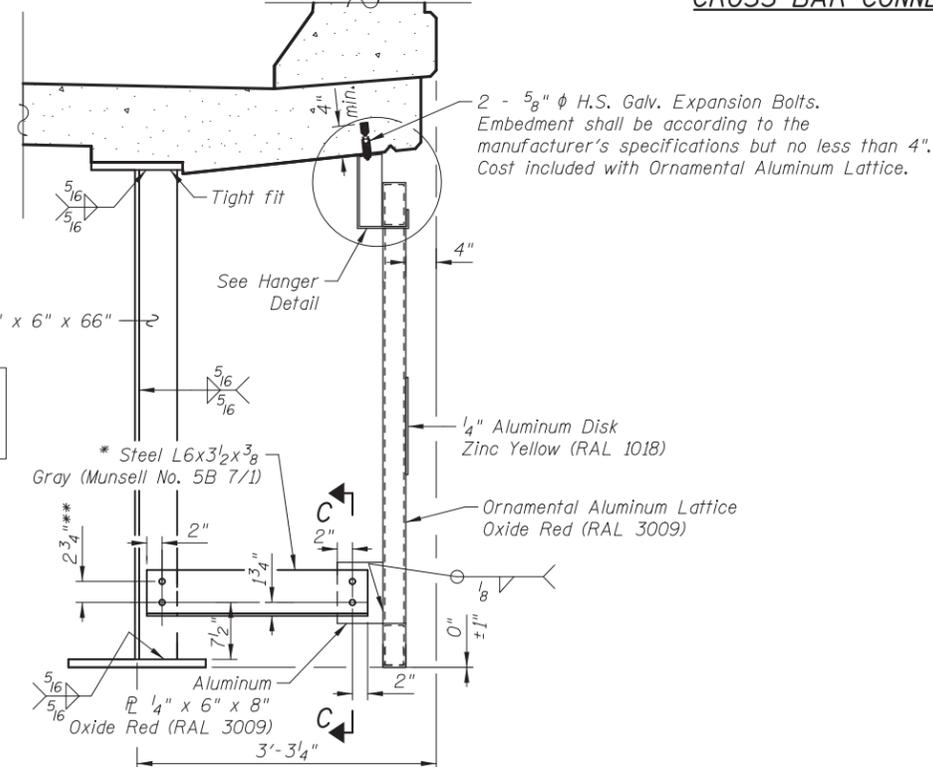

TYPICAL ALUMINUM LATTICE LATERAL BRACING

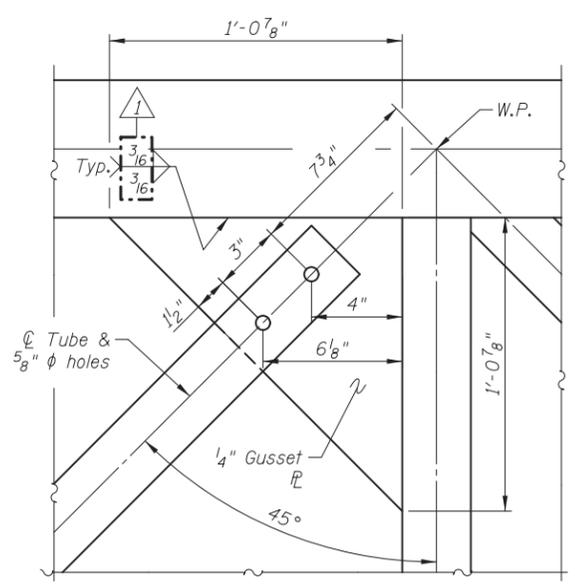

DETAIL "A"

BILL OF MATERIAL

ITEM	UNIT	QUANTITY
Ornamental Aluminum Lattice	Foot	265

Notes:
Hangers and aluminum plates to be included in the cost of Ornamental Aluminum Lattice.
All aluminum welds shall be Filler Alloy 5356 with a min. allowable stress of 7 ksi.
See sheet SA12 for Elevation View of the Exterior Fascia of the beams.
W.P. indicates work point.

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DATE	- 5/3/2012	REVISED	-

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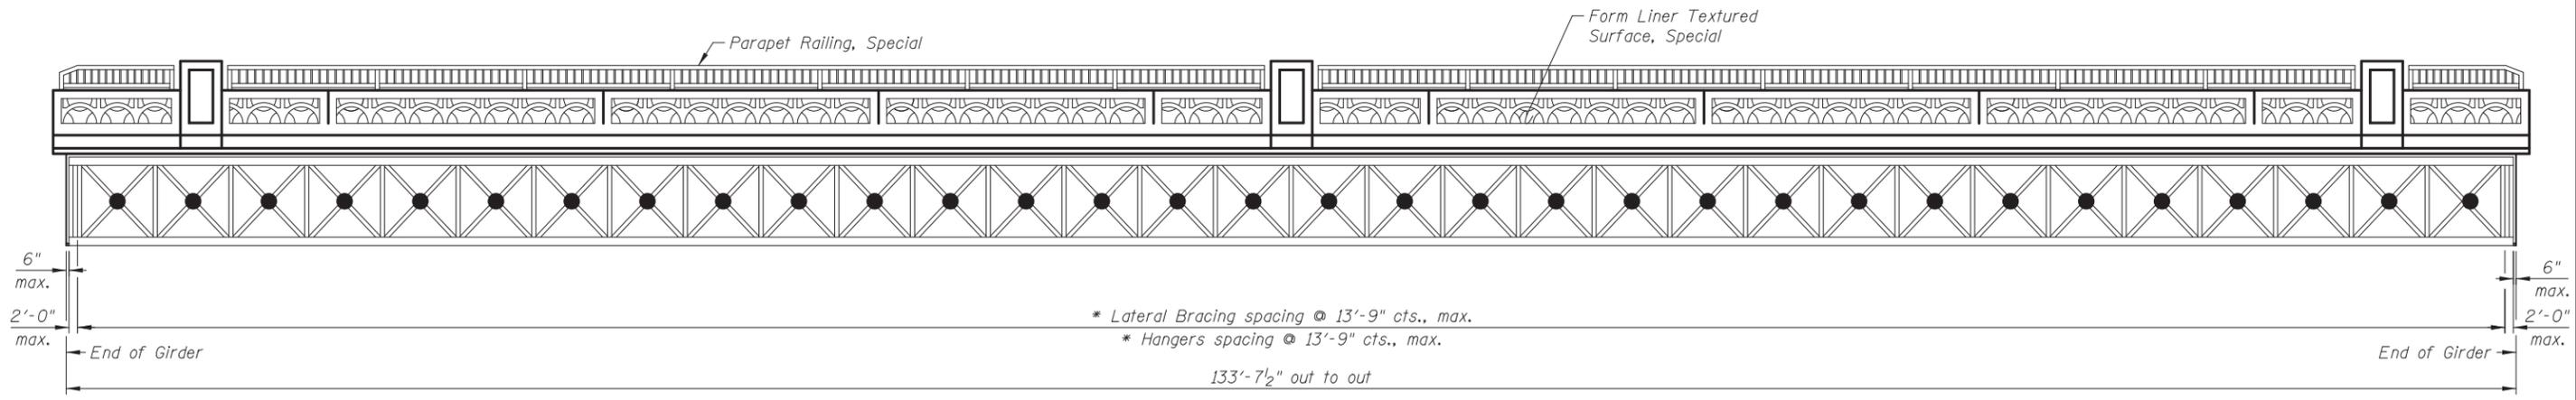
ORNAMENTAL ALUMINUM LATTICE ILLINOIS ROUTE 31 OVER CRYSTAL CREEK STRUCTURE NO. 056-0077

O.R. RTE.	SECTION	COUNTY	TOTAL SHEETS	SHEET NO.
0003	18A-2	MCHENRY	825	471
			CONTRACT NO. 60F72	

SHEET NO. SA11 OF SA33 SHEETS


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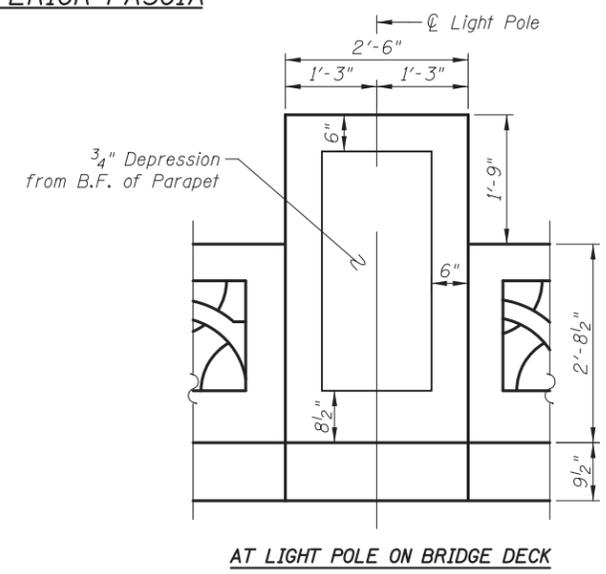
ELEVATION - EXTERIOR FASCIA

* Lateral Bracing connections shall occur at the vertical aluminum tubes and Hangers shall occur in mid span of lattice. Contractor to layout locations and submit shop drawings for approval.




ELEVATION - OUTSIDE FACE OF PARAPET


** Pay Limits of Form Liner Texture Surface, Special

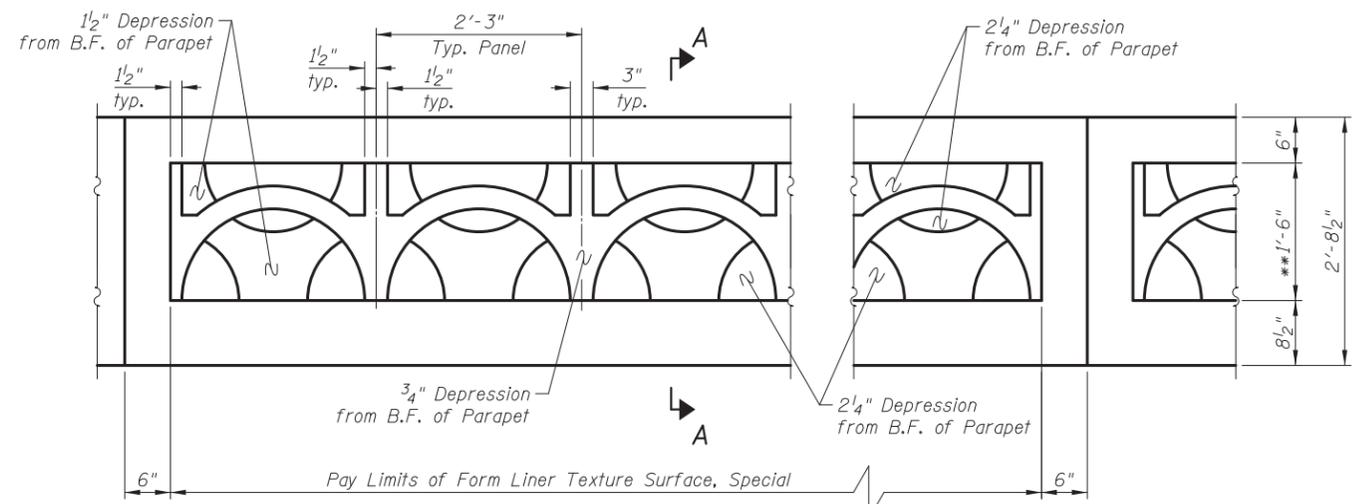


AT LIGHT POLE ON BRIDGE DECK

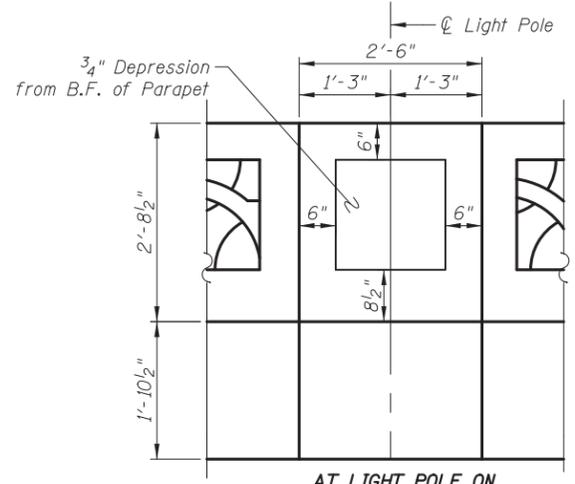

AT LIGHT POLE ON ANCHORAGE SLAB

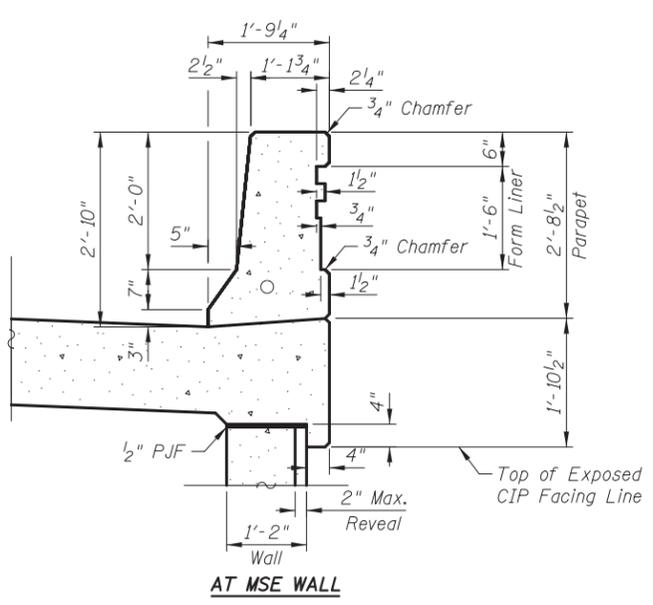


AT MSE WALL

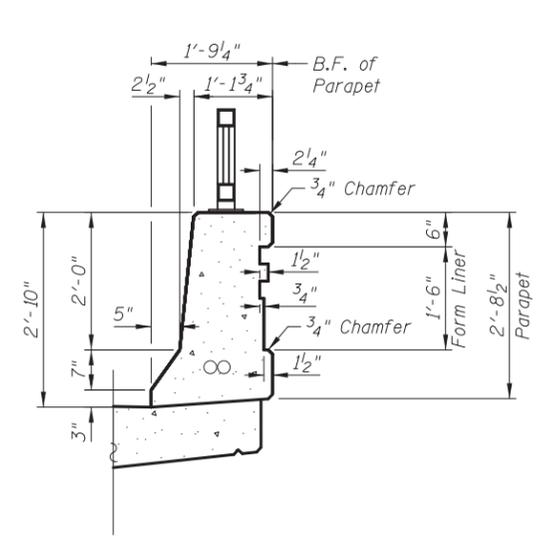


AT BRIDGE DECK

SECTION A-A

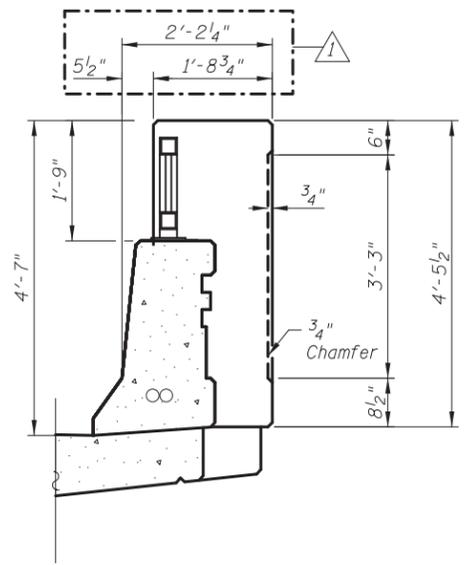

AT LIGHT POLE

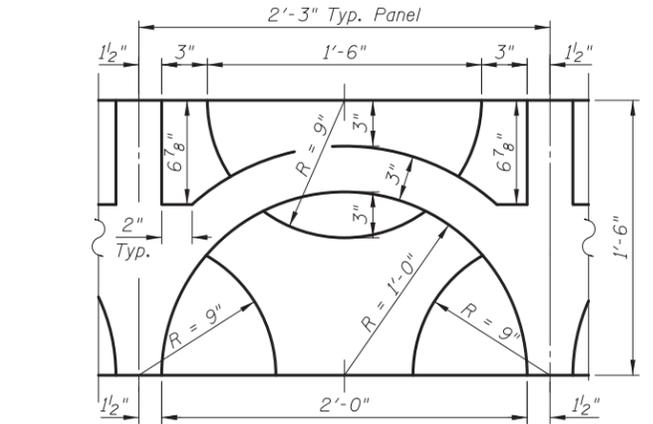

FORM LINER TEXTURE SURFACE, SPECIAL DETAIL

Notes:
Parapet, railing, lighting and all other details not specifically pertaining to the lattice are shown for graphics purposes only.
See Sheet SA11 for Hanger and Lateral Bracing Details.

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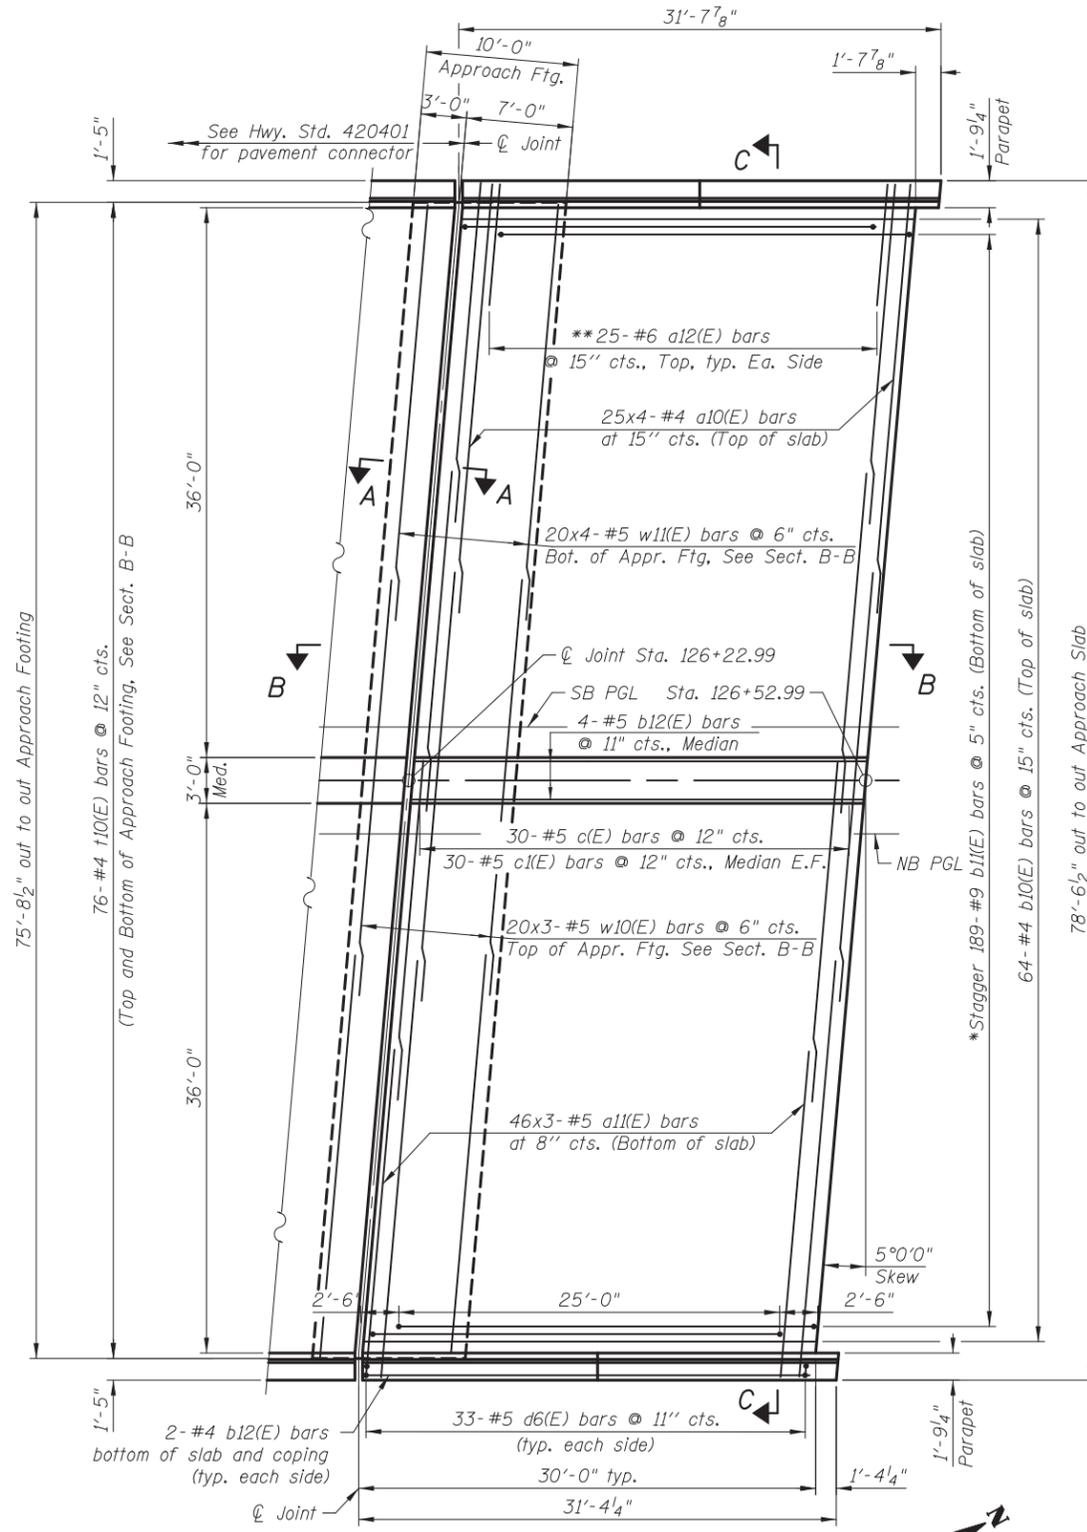
DRAWN	- M. LANGE	REVISED	- 5/4/12 K.L.B.
DESIGNED	- D. ATKINS	REVISED	-
CHECKED	- G. HATLESTAD	REVISED	-
DATE	- 5/3/2012	REVISED	-

**STATE OF ILLINOIS
 DEPARTMENT OF TRANSPORTATION**

**ARCHITECTURAL DETAILS
 ILLINOIS ROUTE 31 OVER CRYSTAL CREEK
 STRUCTURE NO. 056-0077**


SHEET NO. SA12 OF SA33 SHEETS

O.R. RTE.	SECTION	COUNTY	TOTAL SHEETS	SHEET NO.
0003	18A-2	MCHENRY	825	472
CONTRACT NO. 60F72			ILLINOIS FED. AID PROJECT	




PLAN - SOUTH APPROACH

*Tilt #9 b11(E) bars as required to maintain clearance.
 **Space between a10(E), typ. each parapet.

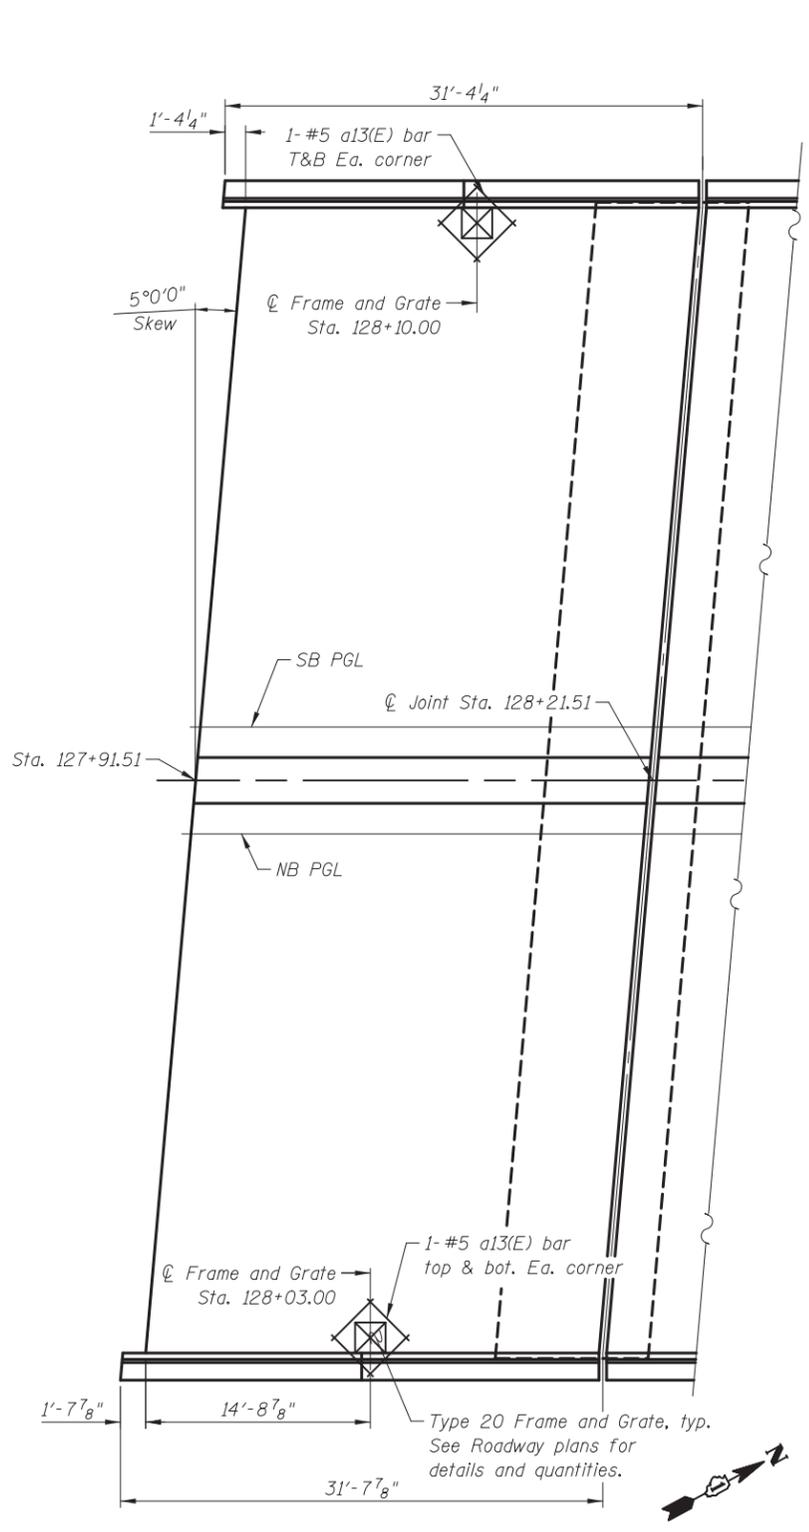


PLAN - NORTH APPROACH

(See South Approach for remainder of dimensions and reinforcement)

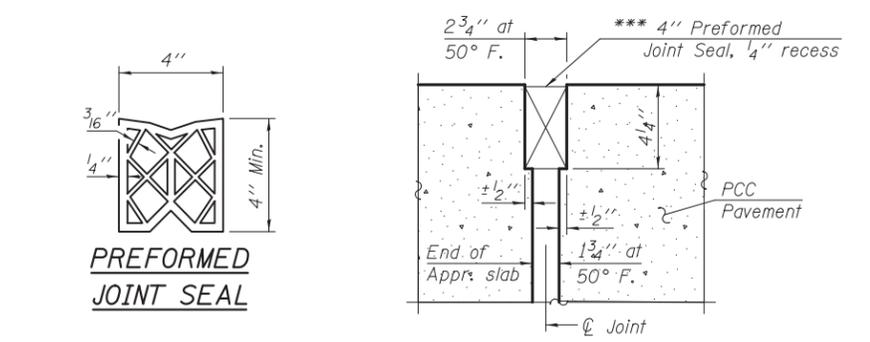


SECTION A-A


*** Cost included with Concrete Superstructures

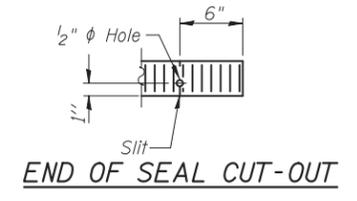

END OF SEAL CUT-OUT

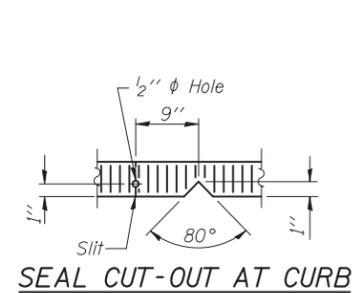


SEAL CUT-OUT AT CURB

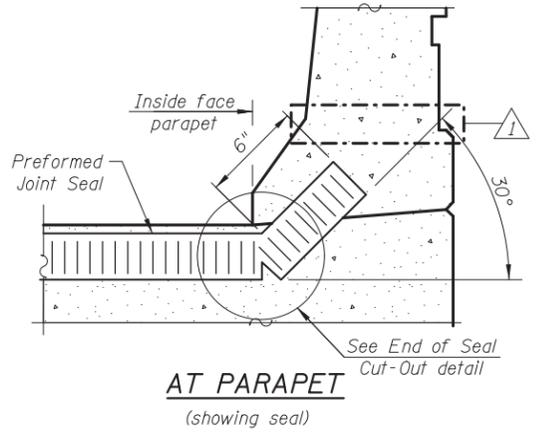

AT PARAPET

(showing seal)

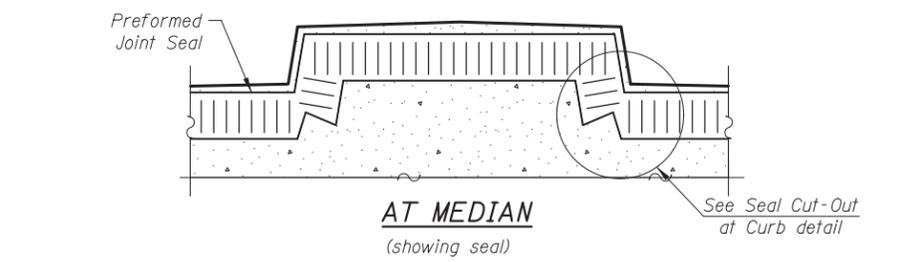

AT MEDIAN

(showing seal)

MINIMUM BAR LAP

(Approach Slab)
 #4 bar = 2'-7"
 #5 bar = 3'-3"

Notes:
 See sheet SA14 for Bar Bending Diagrams, Reinforcement Schedule & Bill of Materials.
 See sheet SA14 for Sections B-B and C-C. a10(E), a11(E), b12(E), c10(E) and c11(E) measured along \varnothing IL Rte 31

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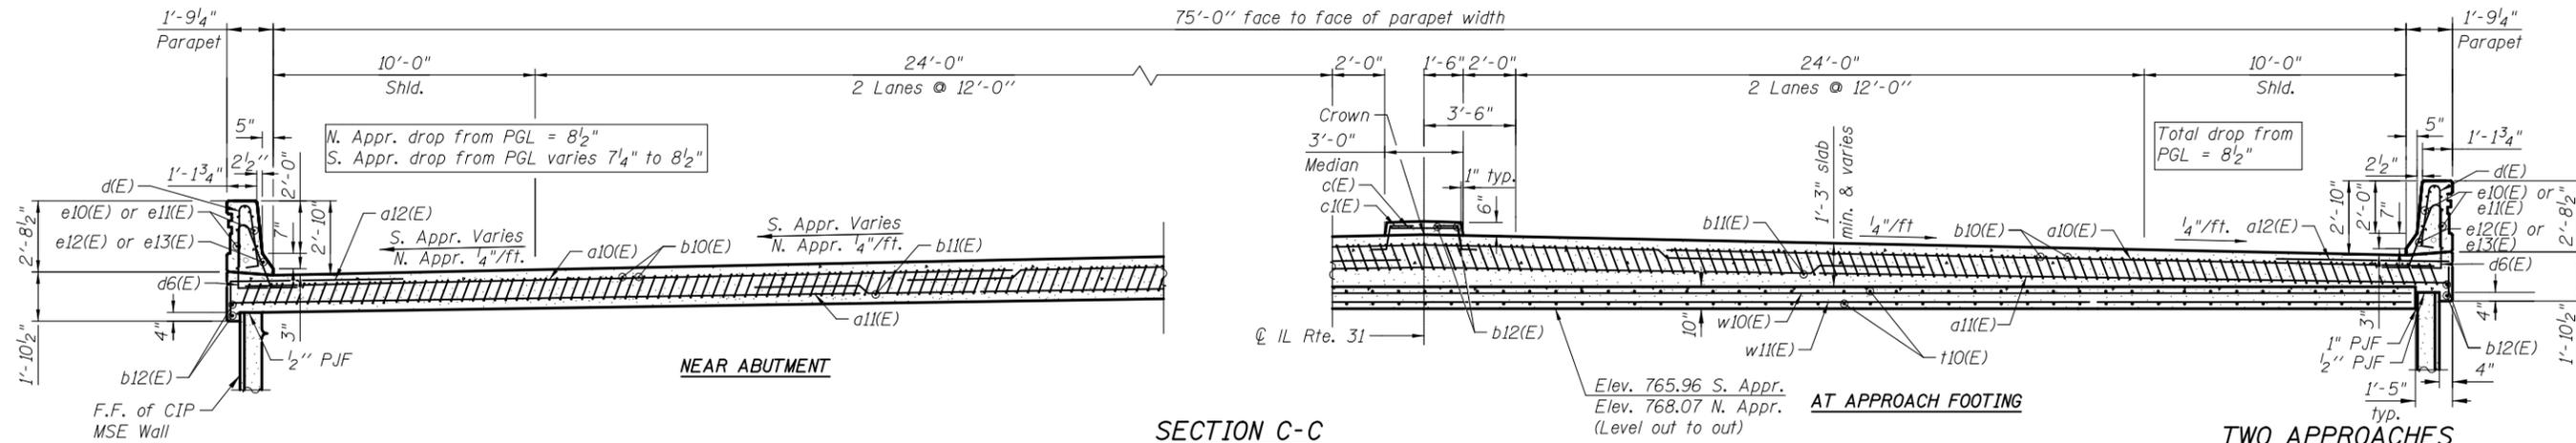
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DRAWN	- M. LANGE	REVISED	- 5/3/12 D.L.A.
DESIGNED	- D. ATKINS	REVISED	-
CHECKED	- G. HATLESTAD	REVISED	-
DATE	- 5/3/2012	REVISED	-

STATE OF ILLINOIS
DEPARTMENT OF TRANSPORTATION

BRIDGE APPROACH SLAB
ILLINOIS ROUTE 31 OVER CRYSTAL CREEK
STRUCTURE NO. 056-0077
 SHEET NO. SA13 OF SA33 SHEETS

O.R. RTE.	SECTION	COUNTY	TOTAL SHEETS	SHEET NO.
0003	18A-2	MCHENRY	825	473
CONTRACT NO. 60F72				
ILLINOIS FED. AID PROJECT				



Notes:

See sheet SA13 for Section A-A.

Approach slab and parapet concrete shall be paid for as Concrete Superstructure.

Approach footing concrete shall be paid for as Concrete Structures.

Reinforcement shall be paid for as Reinforcement Bars, Epoxy Coated.


For v(E) bar details, see sheet SA23.

The approach footing maximum applied service bearing pressure (Qmax) = 2.0 ksf.

For bar splicer details, see sheet SA29.

Cost of excavation for approach footing included with Concrete Structures.





For additional parapet details see sheet SA12 for formliner details and dimensions and SA28 for parapet joint details.

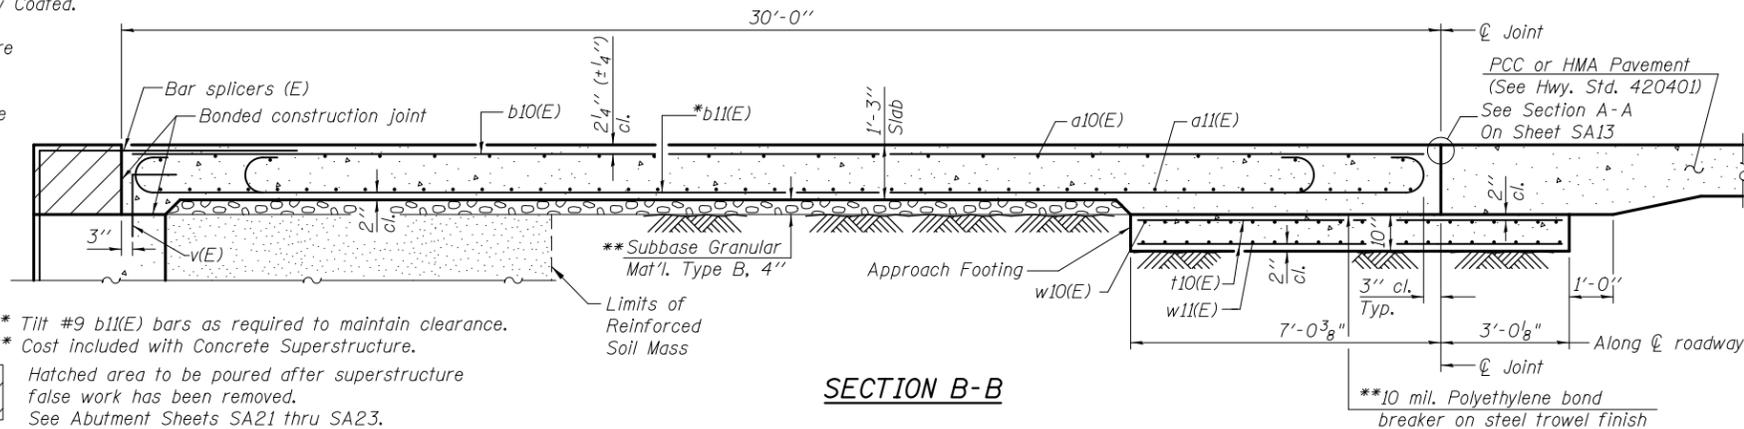

* Tilt #9 b11(E) bars as required to maintain clearance.

** Cost included with Concrete Superstructure.

Hatched area to be poured after superstructure false work has been removed. See Abutment Sheets SA21 thru SA23.

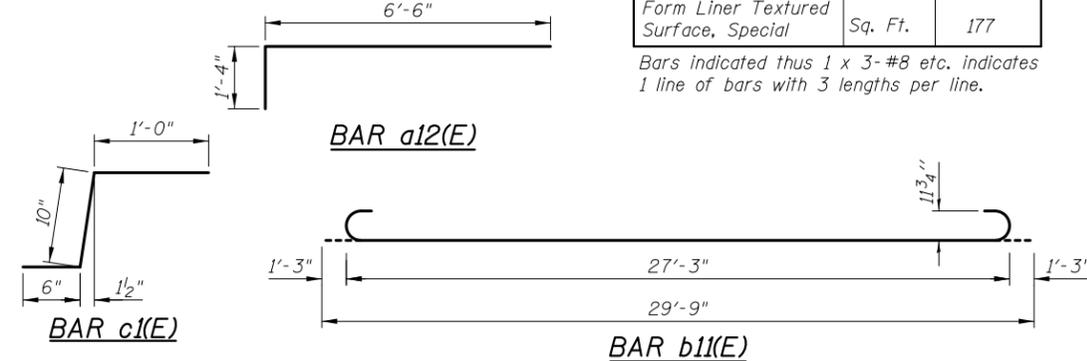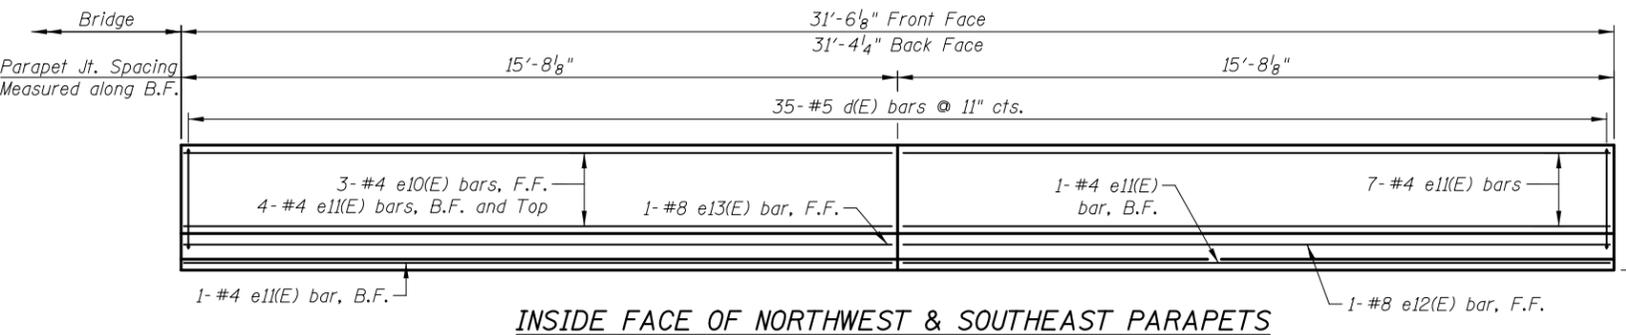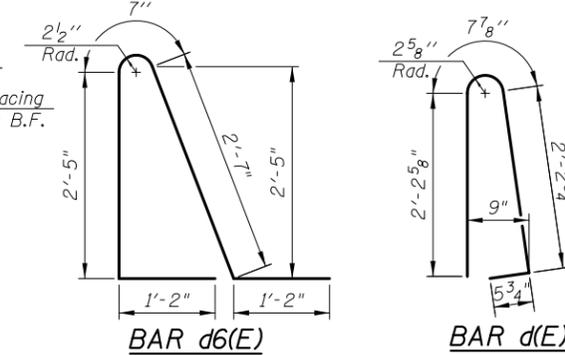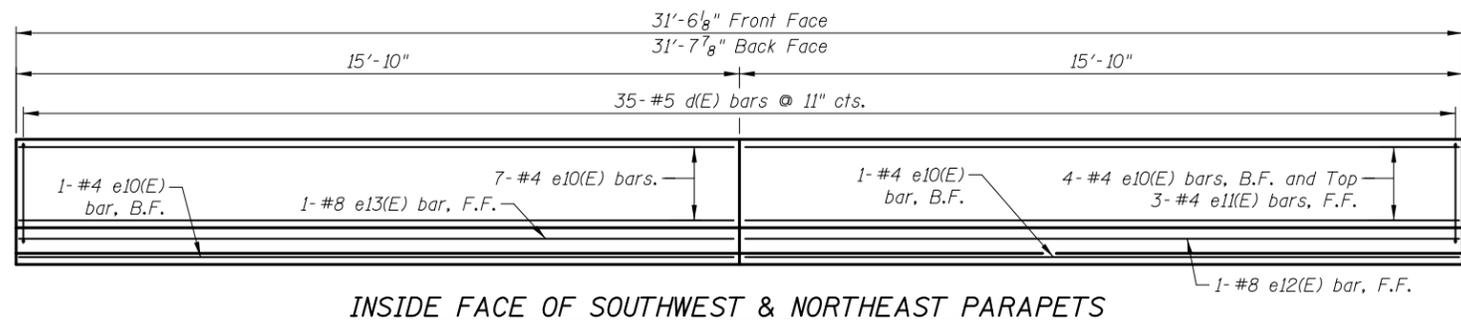


TWO APPROACHES
BILL OF MATERIAL

Bar	No.	Size	Length	Shape
a10(E)	200	#4	21'-7"	—
a11(E)	276	#5	28'-4"	—
a12(E)	100	#6	7'-10"	—
a13(E)	16	#5	3'-6"	—
b10(E)	128	#4	29'-8"	—
b11(E)	378	#9	29'-9"	—
b12(E)	8	#5	29'-8"	—
c(E)	60	#5	2'-8"	—
c1(E)	120	#5	2'-4"	—
d(E)	140	#5	5'-7"	—
d6(E)	132	#5	7'-11"	—
e10(E)	32	#4	15'-6"	—
e11(E)	32	#4	15'-4"	—
e12(E)	4	#8	15'-4"	—
e13(E)	4	#8	15'-6"	—
t10(E)	304	#4	9'-8"	—
w10(E)	120	#5	27'-5"	—
w11(E)	160	#5	21'-5"	—


Item	Unit	Quantity
Concrete Structures	Cu. Yd.	47.0
Concrete Superstructure	Cu. Yd.	257.1
Bridge Deck Grooving	Sq. Yd.	480
Protective Coat	Sq. Yd.	563
Reinforcement Bars, Epoxy Coated	Pound	65,620
Form Liner Textured Surface, Special	Sq. Ft.	177

Bars indicated thus 1 x 3-#8 etc. indicates 1 line of bars with 3 lengths per line.

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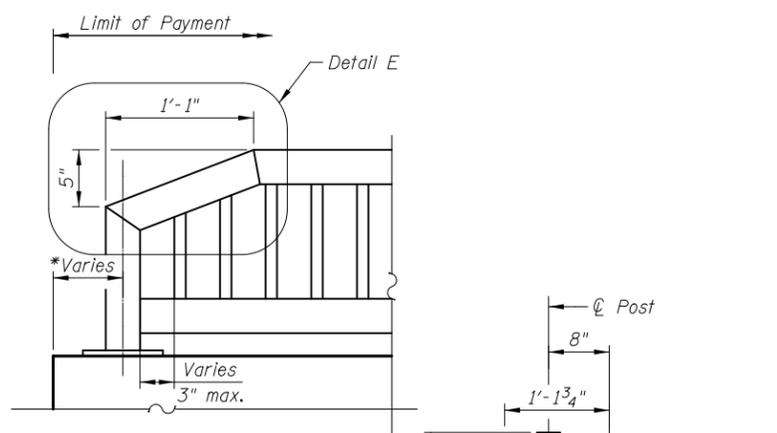


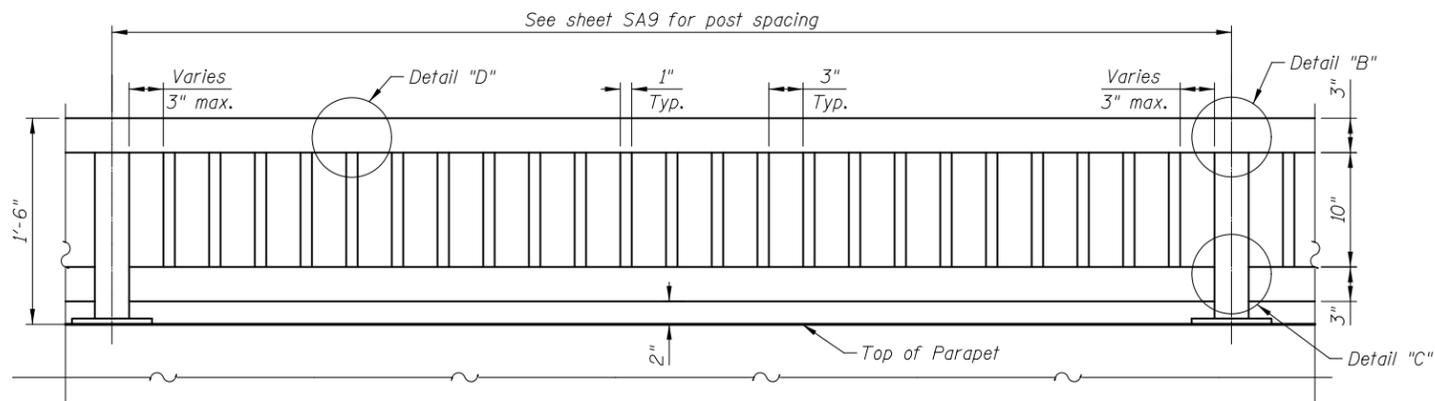ELEVATION

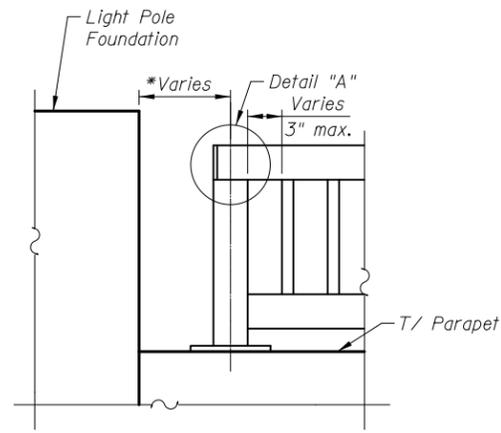


END TREATMENT AT LIGHT POLE FOUNDATION

* See sheet SA9 for dimensions



TERMINAL SECTION

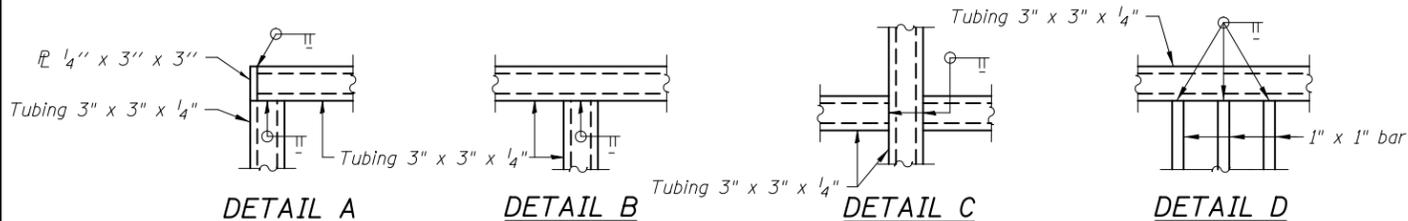


DETAIL A


DETAIL B

DETAIL C


DETAIL D

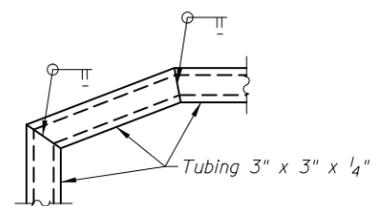


DETAIL E

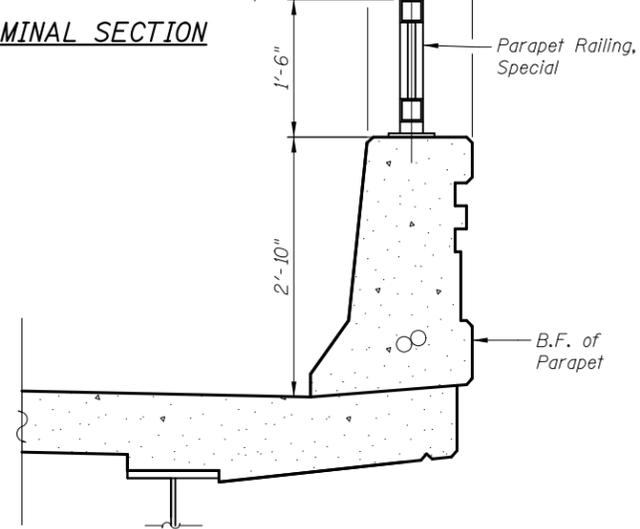


SECTION THRU PARAPET

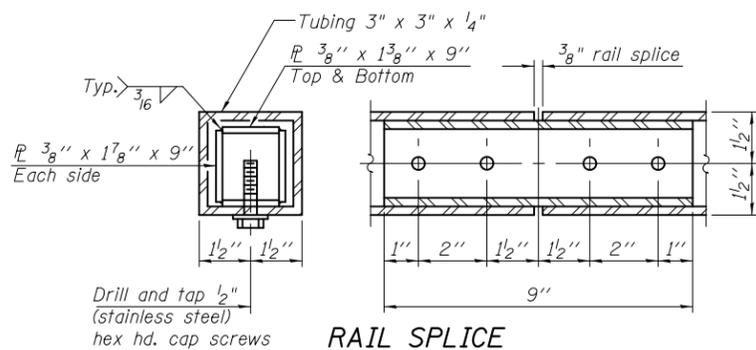

RAIL SPLICE

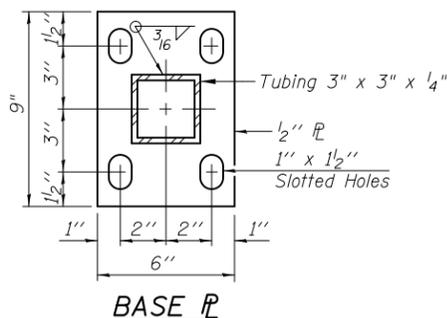


BASE PL

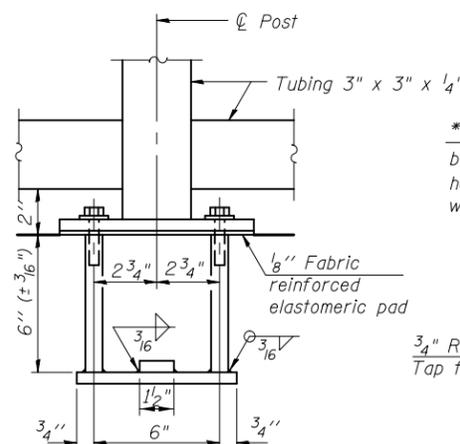

ANCHOR BOLT DETAILS

** In lieu of the cast-in-place anchor device shown, the Contractor has the option of drilling and setting stainless steel anchor rods of the same diameter and grade as the specified cap screws according to Article 509.06 of the Standard Specifications. Embedment shall be according to the manufacturer's specifications.



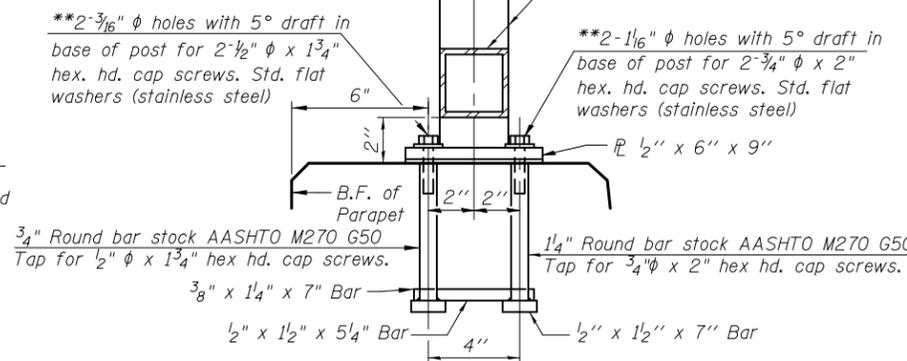


Notes:
 All post, railing, splices, anchor devices, and plates shall be painted the color Traffic Black (RAL 9017).
 All posts shall be normal to the parapet.
 All joints in rail shall be spliced detail.
 All exposed rail ends shall be capped per detail.
 Provide (1) 1/8" and (2) 1/16" aluminum shims for 25% of the posts.
 Rail elements shall be parallel to grade - High spots shall be ground and low spots shimmed. Cost included in Parapet Railing, Special.

BILL OF MATERIAL


ITEM	UNIT	QUANTITY
Parapet Railing, Special	Foot	270

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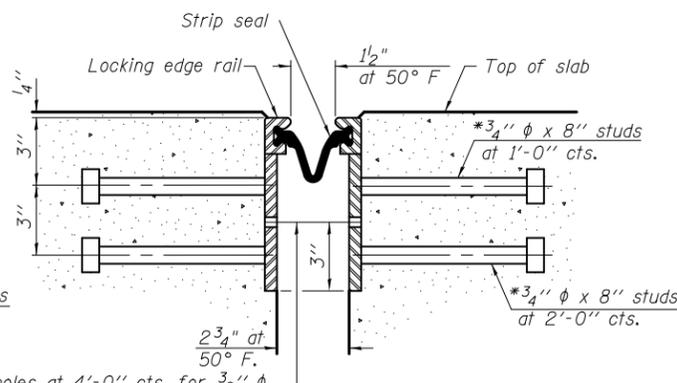


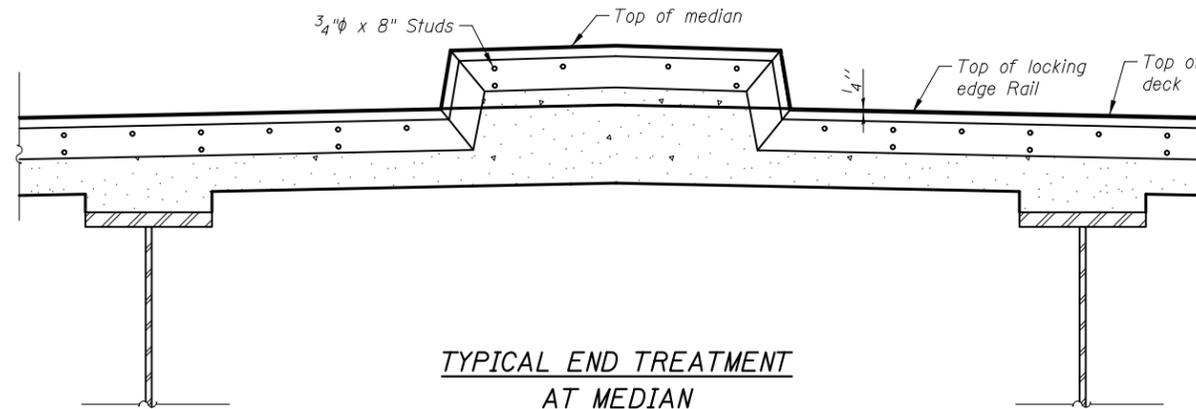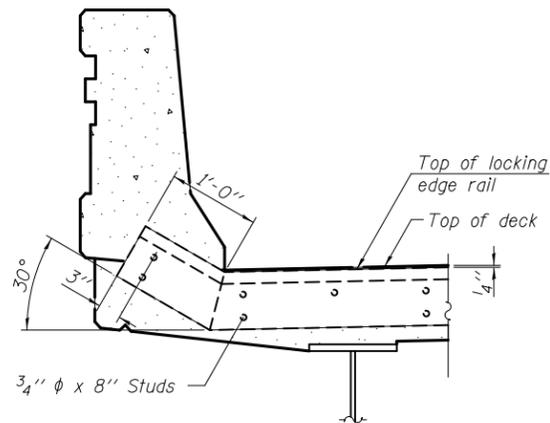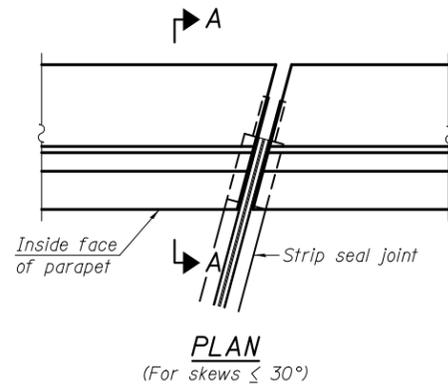Shorter plates with a single row of studs at 12" cts. may be necessary on medians which are shallower than 9". See manufacturer's recommendation.

Notes:
The strip seal shall be made continuous and shall have a minimum thickness of 1/4". The configuration of the strip seal shall match the configuration of the Locking Edge Rails. Open or "webbed" strip seal gland configurations are not permitted. The gland shall be sized for a maximum rated movement of 4 inches.
The Locking Edge Rails depicted are conceptual only, except for the minimum dimensions shown. The actual configuration of the Locking Edge Rails and matching strip seal may vary from manufacturer to manufacturer. Flanged edge rails will not be allowed. Locking Edge Rails may be spliced at slope discontinuities.
The manufacturer's recommended installation methods shall be followed.
The joint opening and deck dimensions detailed on the superstructure are based on a rolled rail expansion joint. If the Contractor elects to use the welded rail expansion joint, the opening and deck dimensions shall be modified according to the dimensions detailed on this sheet. Required modifications shall be made at no additional cost to the State.
All steel components shall be galvanized after fabrication according to Article 520.03 of the Standard Specifications.



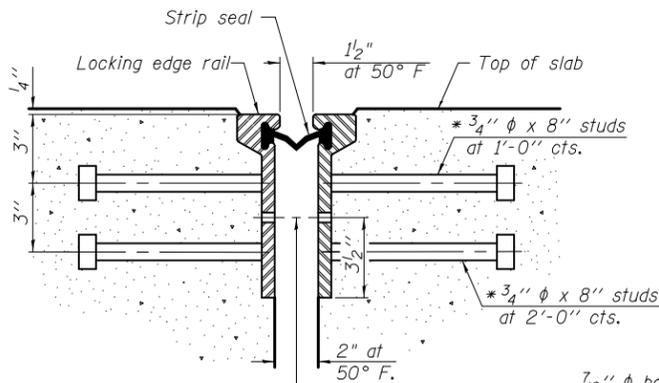


7/16" φ holes at 4'-0" cts. for 3/8" φ bolts. All bolts shall be burned, sawed, or chipped off flush with the plates after forms are removed, typ.



7/16" φ holes at 4'-0" cts. for 3/8" φ bolts. All bolts shall be burned, sawed, or chipped off flush with the plates after forms are removed, typ.

* Granular or solid flux filled headed studs conforming to Article 1006.32 of the Std. Specs., automatically end welded.

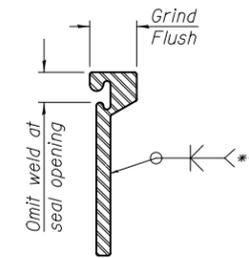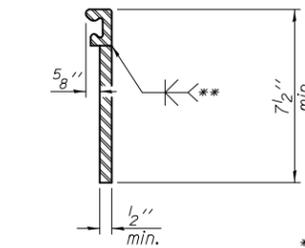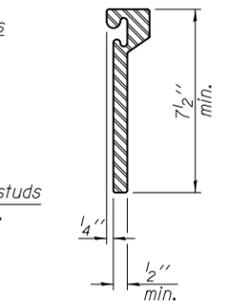

*** Back gouge not required if complete joint penetration is verified by mock-up.


LOCKING EDGE RAILS

The inside of the locking edge rail groove shall be free of weld residue.
Rolled rail shown, welded rail similar.


BILL OF MATERIAL

Item	Unit	Total
Preformed Joint Strip Seal	Foot	157

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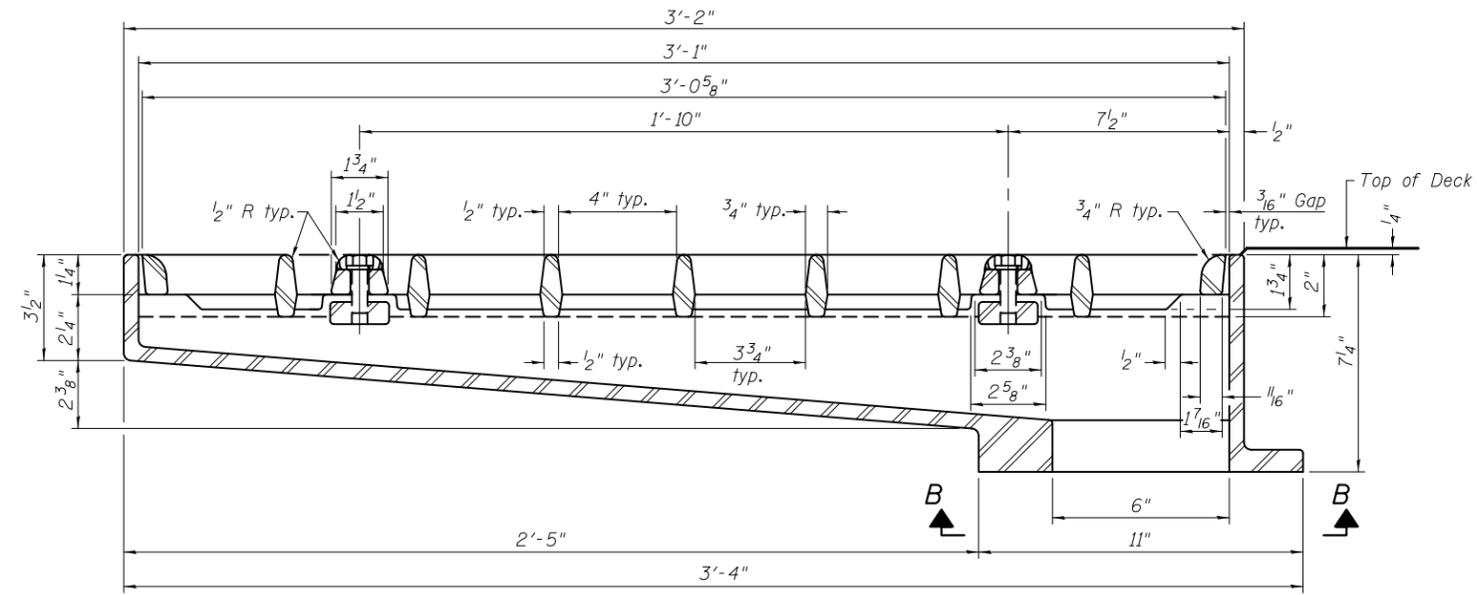


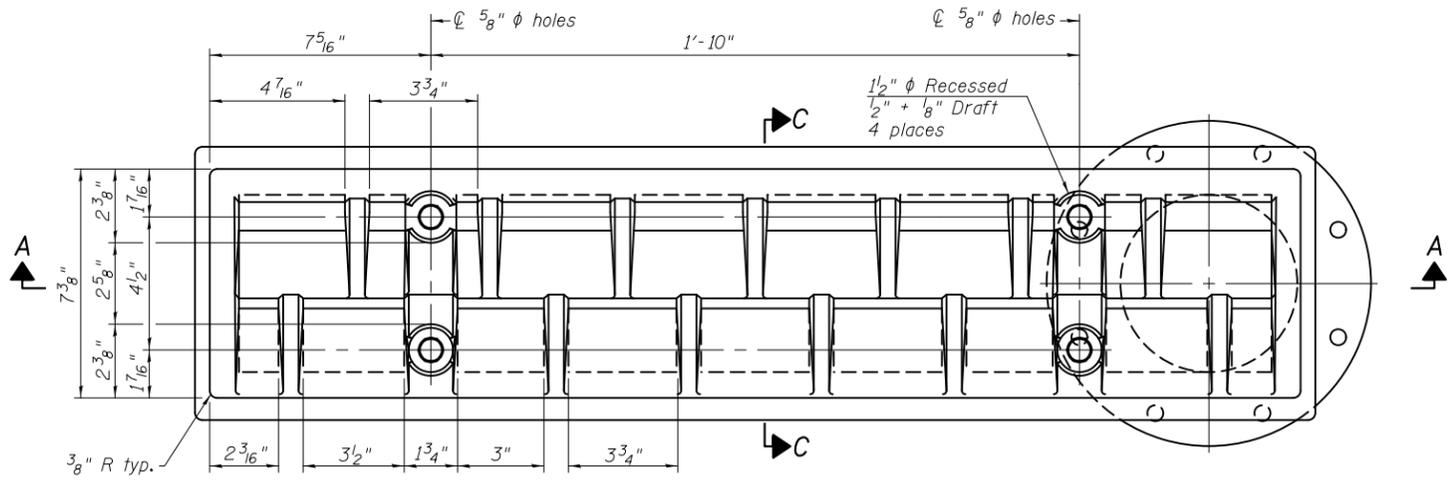PLAN

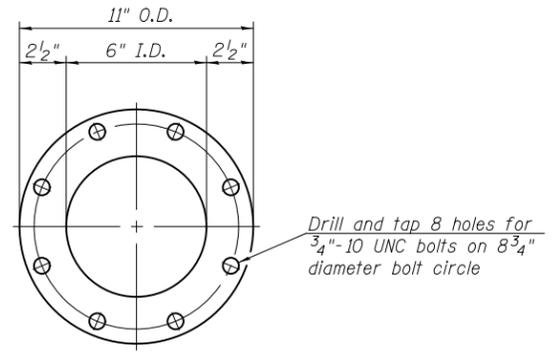


VIEW B-B

Drill and tap 8 holes for 3/4"-10 UNC bolts on 8 3/4" diameter bolt circle




SECTION A-A


See sheet SA9 for scupper location relative to parapet.

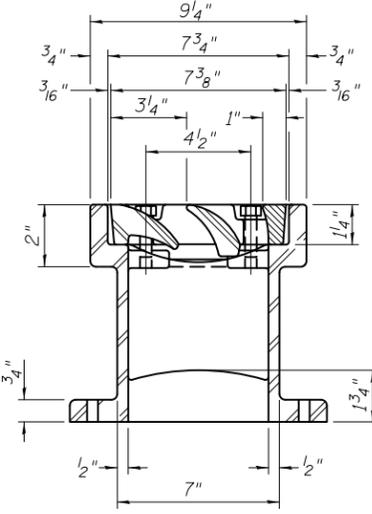


SECTION C-C

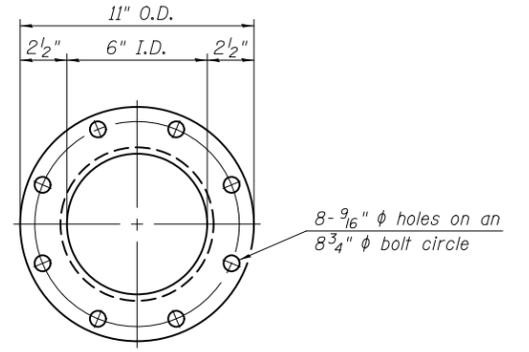


DOWNSPOUT

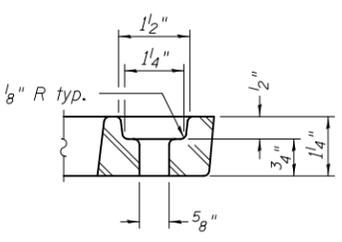

BOLT HOLE DETAIL

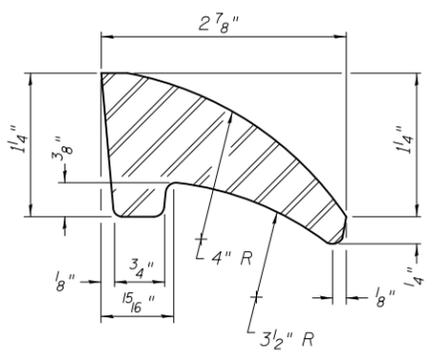

FIRST VANE DETAIL

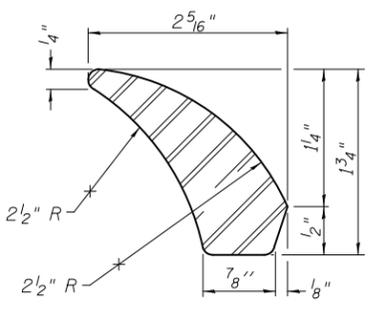

SECOND VANE DETAIL

BILL OF MATERIAL

ITEM	UNIT	QUANTITY
Drainage Scupper, DS-33	Each	2

DS-33

7-1-10



DRAWN - M. LANGE	REVISED -
DESIGNED - D. ATKINS	REVISED -
CHECKED - G. HATLESTAD	REVISED -
DATE - 5/3/2012	REVISED -

STATE OF ILLINOIS
DEPARTMENT OF TRANSPORTATION


DRAINAGE SCUPPER, DS-33
ILLINOIS ROUTE 31 OVER CRYSTAL CREEK
STRUCTURE NO. 056-0077

O.R. RTE.	SECTION	COUNTY	TOTAL SHEETS	SHEET NO.
0003	18A-2	MCHENRY	825	477
CONTRACT NO. 60F72				

SHEET NO. SA17 OF SA33 SHEETS

ILLINOIS FED. AID PROJECT

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INTERIOR GIRDER MOMENT TABLE		
		0.5 Span
I_s	(in ⁴)	52,529
$I_c(n)$	(in ⁴)	125,389
$I_c(3n)$	(in ⁴)	89,961
S_s	(in ³)	1,770
$S_c(n)$	(in ³)	2,405
$S_c(3n)$	(in ³)	2,181
DC1	(k/')	1.126
M _{DC1}	(k)	2,471
DC2	(k/')	0.143
M _{DC2}	(k)	314
DW	(k/')	0.360
M _{DW}	(k)	790
$M_\xi + IM$	(k)	2,523
M_u (Strength I)	(k)	9,081
$\phi_f M_n$	(k)	12,853
f_s DC1	(ksi)	16.76
f_s DC2	(ksi)	1.73
f_s DW	(ksi)	4.35
f_s 1.3($\xi + IM$)	(ksi)	16.36
f_s (Service II)	(ksi)	39.19
f_s (Total)(Strength I)	(ksi)	51.65
V_f	(k)	30.8

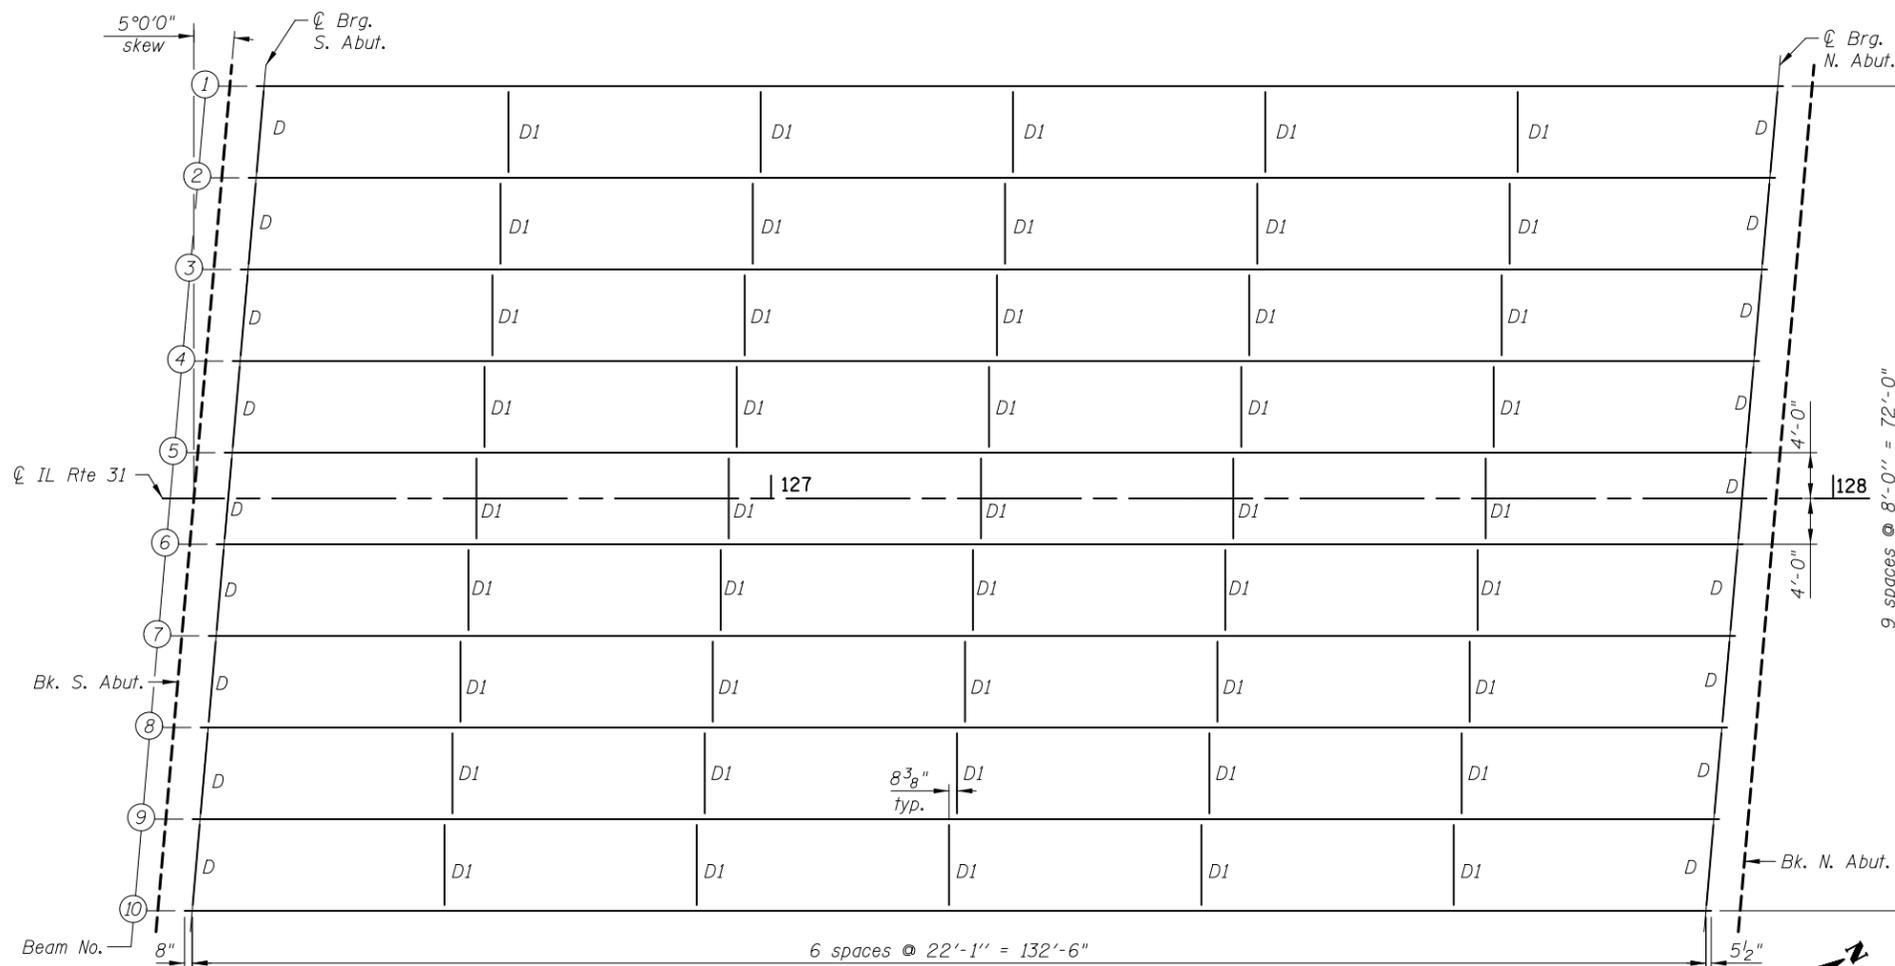INTERIOR GIRDER REACTION TABLE		
		Abutment
R _{DC1}	(k)	74.61
R _{DC2}	(k)	9.47
R _{DW}	(k)	23.85
R $\xi + IM$	(k)	109.2
R _{Total}	(k)	217.1

I_s, S_s : Non-composite moment of inertia and section modulus of the steel section used for computing f_s (Total-Strength I, and Service II) due to non-composite dead loads (in⁴ and in³).

$I_c(n), S_c(n)$: Composite moment of inertia and section modulus of the steel and deck based upon the modular ratio, "n", used for computing f_s (Total-Strength I, and Service II) due to long-term composite (superimposed) dead loads (in⁴ and in³).

$I_c(3n), S_c(3n)$: Composite moment of inertia and section modulus of the steel and deck based upon 3 times the modular ratio, "3n", used for computing f_s (Total-Strength I, and Service II) due to long-term composite (superimposed) dead loads (in⁴ and in³).

DC1: Un-factored non-composite dead load (kips/ft.).

M_{DC1}: Un-factored moment due to non-composite dead load (kip-ft.).

DC2: Un-factored long-term composite (superimposed excluding future wearing surface) dead load (kips/ft.).

M_{DC2}: Un-factored moment due to long-term composite (superimposed excluding future wearing surface) dead load (kip-ft.).

DW: Un-factored long-term composite (superimposed future wearing surface only) dead load (kips/ft.).

M_{DW}: Un-factored moment due to long-term composite (superimposed future wearing surface only) dead load (kip-ft.).

$M_\xi + IM$: Un-factored live load moment plus dynamic load allowance (impact) (kip-ft.).

M_u (Strength I): Factored design moment (kip-ft.).

$1.25(M_{DC1} + M_{DC2}) + 1.5 M_{DW} + 1.75 M_\xi + IM$

$\phi_f M_n$: Compact composite positive moment capacity computed according to Article 6.10.7.1 (kip-ft.).


f_s (Service II): Sum of stresses as computed from the moments below (ksi).

$M_{DC1} + M_{DC2} + M_{DW} + 1.3 M_\xi + IM$


f (Total)(Strength I): Sum of stresses as computed from the moments below on non-compact section (ksi).

$1.25(M_{DC1} + M_{DC2}) + 1.5 M_{DW} + 1.75 M_\xi + IM$

V_f : Maximum factored shear range in composite portion of span computed according to Article 6.10.10.

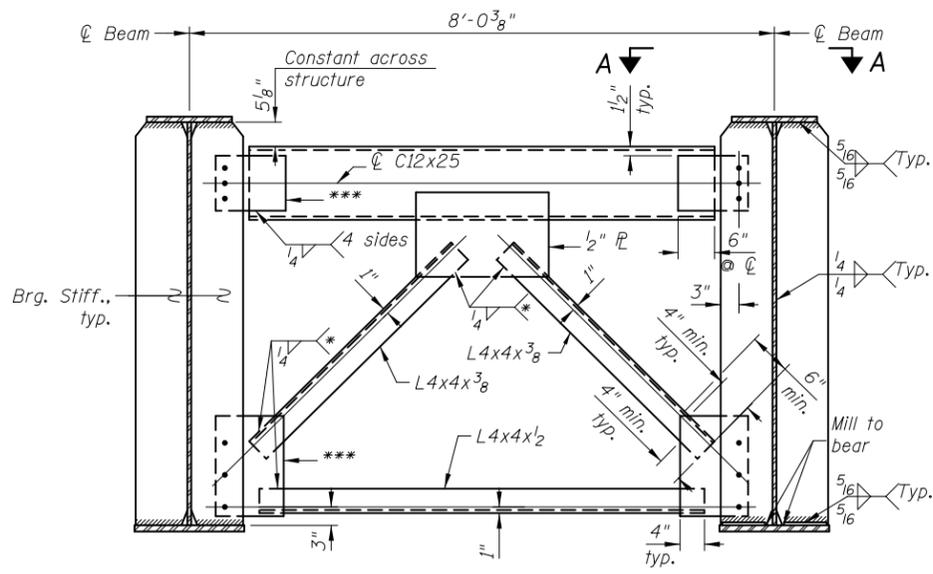

END CROSS FRAME D
(18 Required)

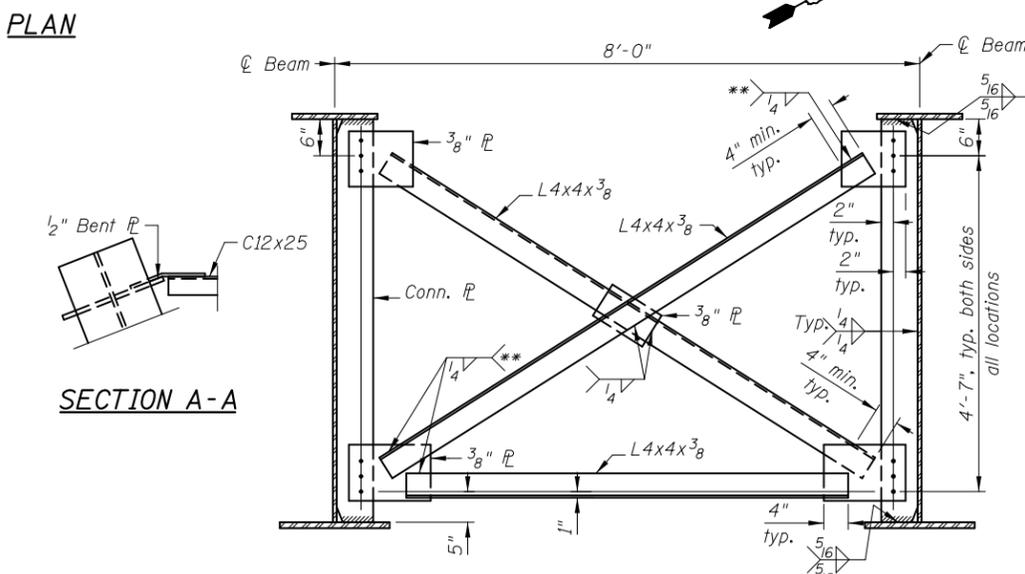

INTERIOR CROSS FRAME D1
(45 Required)


- * Weld on near side of 1/2" plate.
- ** Fillet weld angles along 3 sides on one face of gusset plate.
- *** 1/2" Plates to be bent for skew.

Notes:
Detail 15/16" ϕ holes for all 3/4" ϕ bolts.
Two hardened washers required for each set of oversized holes.
Place diaphragm with channel flanges and outstanding angle legs outward from abutment backwall.


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DRAWN	- M. LANGE	REVISED	-
DESIGNED	- D. ATKINS	REVISED	-
CHECKED	- G. HATLESTAD	REVISED	-
DATE	- 5/3/2012	REVISED	-

O.R. RTE.	SECTION	COUNTY	TOTAL SHEETS	SHEET NO.
0003	18A-2	MCHENRY	825	478
CONTRACT NO. 60F72				
ILLINOIS FED. AID PROJECT				

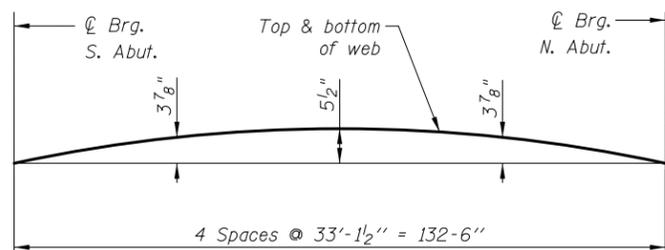

CAMBER DIAGRAM

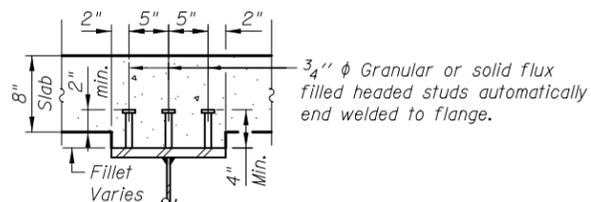


SECTION A-A


TOP OF WEB ELEVATIONS

(For Fabrication Only)

GIRDER	℄ Brg. S. Abut.	℄ Brg. N. Abut.
1	767.77	769.23
2	767.93	769.38
3	768.09	769.54
4	768.25	769.70
5	768.41	769.86
6	768.40	769.85
7	768.22	769.68
8	768.05	769.51
9	767.88	769.33
10	767.70	769.16

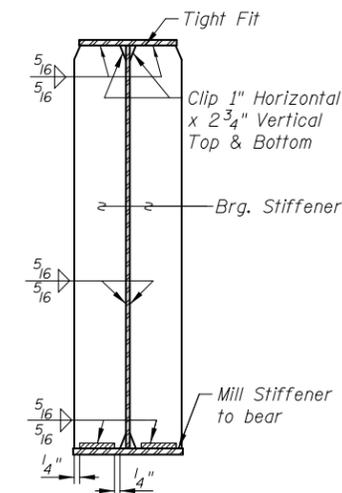

SECTION AT ABUTMENT

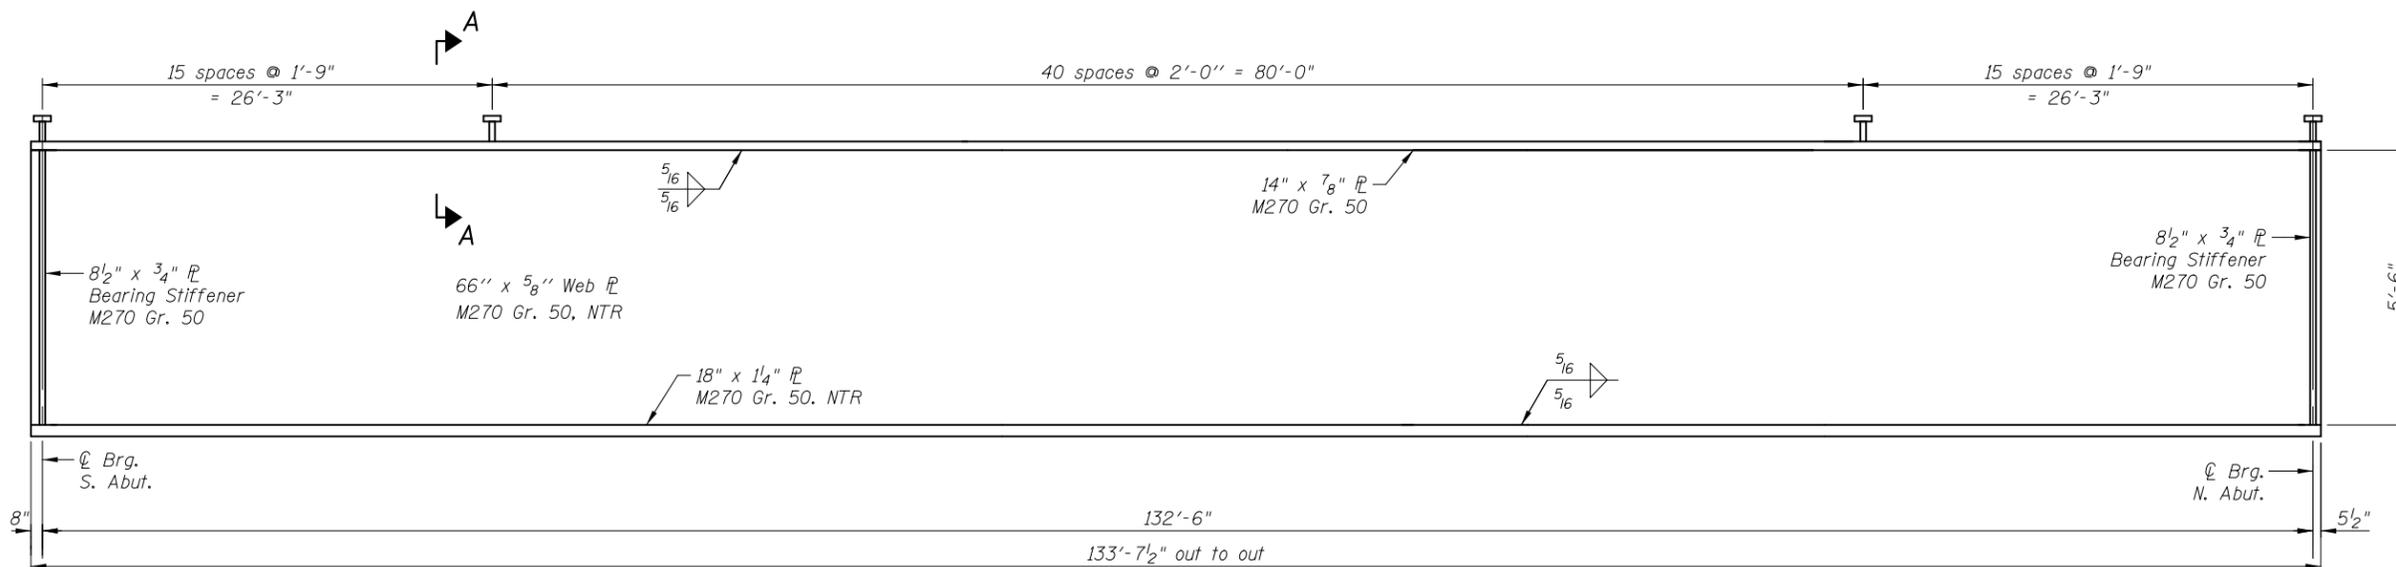

GIRDER ELEVATION

TOTAL BILL OF MATERIAL

ITEM	UNIT	TOTAL
Furnishing and Erecting Structural Steel	L. Sum	0.32
Stud Shear Connectors	Each	2,130

Note:

Load carrying components designated "NTR" shall conform to the Impact Testing Requirements, Zone 2.
Refer to sheets SA11 & SA12 for the Ornamental Aluminum Lattice for the West Fascia of Beam 1 and the East Fascia of Beam 10.

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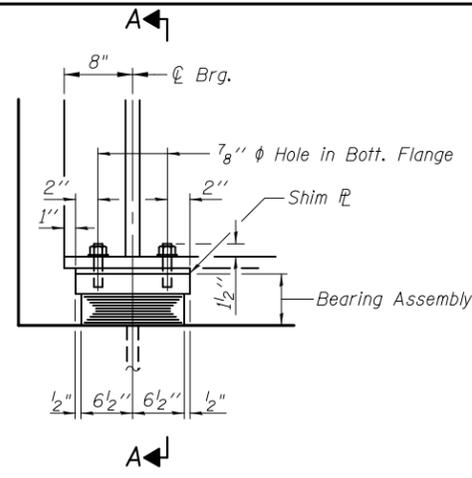
DRAWN	- M. LANGE	REVISED	-
DESIGNED	- D. ATKINS	REVISED	-
CHECKED	- G. HATLESTAD	REVISED	-
DATE	- 5/3/2012	REVISED	-

**STATE OF ILLINOIS
DEPARTMENT OF TRANSPORTATION**


**PLATE GIRDER DETAILS
ILLINOIS ROUTE 31 OVER CRYSTAL CREEK
STRUCTURE NO. 056-0077**

SHEET NO. SA19 OF SA33 SHEETS

O.R. RTE.	SECTION	COUNTY	TOTAL SHEETS	SHEET NO.
0003	18A-2	MCHENRY	825	479
CONTRACT NO. 60F72			ILLINOIS FED. AID PROJECT	




ELEVATION AT S. ABUT.

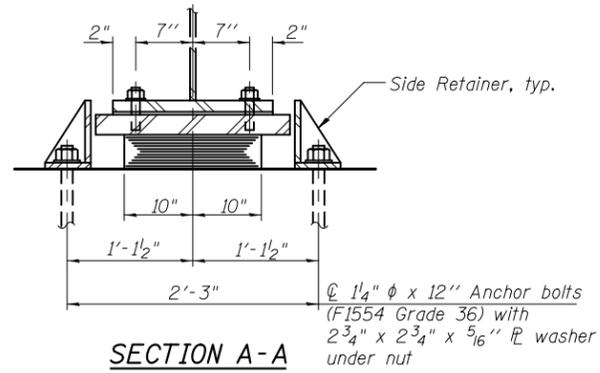


SECTION A-A

TYPE I ELASTOMERIC EXP. BRG.

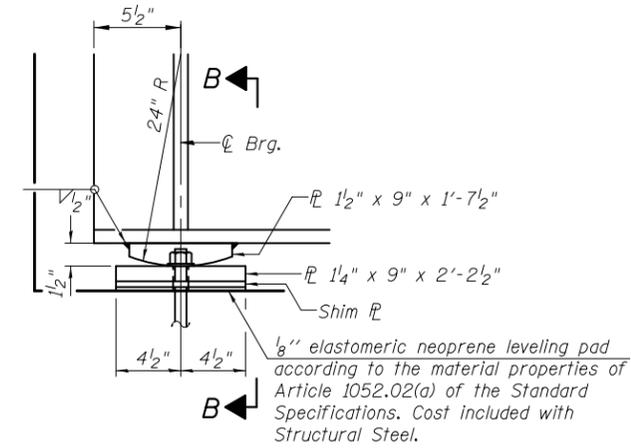

ELEVATION AT N. ABUTMENT

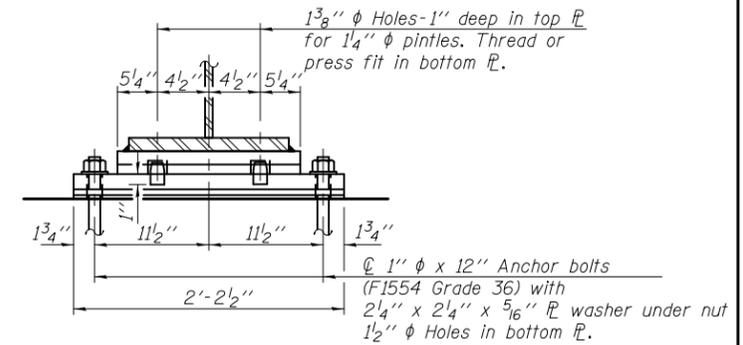

SECTION B-B

FIXED BEARING

(No. Required = 10)

Notes:

Anchor bolts shall be ASTM F1554 all-thread (or an Engineer-approved alternate material) of the grade(s) and diameter(s) specified. The corresponding specified grade of AASHTO M314 anchor bolts may be used in lieu of ASTM F1554.


Anchor bolts at fixed bearings may be either cast in place or installed in holes drilled after the supported member is in place.

Anchor bolts for side retainers may be cast in place or installed in holes drilled before or after members are in place.

Drilled and set anchor bolts shall be installed according to Article 521.06 of the Standard Specifications.

Side retainers and other steel members required for the elastomeric bearing assembly shall be included in the cost of Elastomeric Bearing Assembly, Type I.


The structural steel plates of the Bearing Assembly shall conform to the requirements of AASHTO M 270 Grade 50.

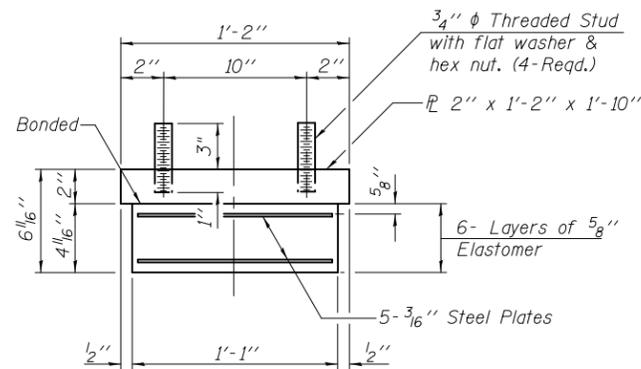


BEARING ASSEMBLY

Note:

Shim plates shall not be placed under Bearing Assembly.

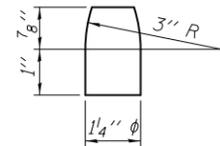

PINTLE

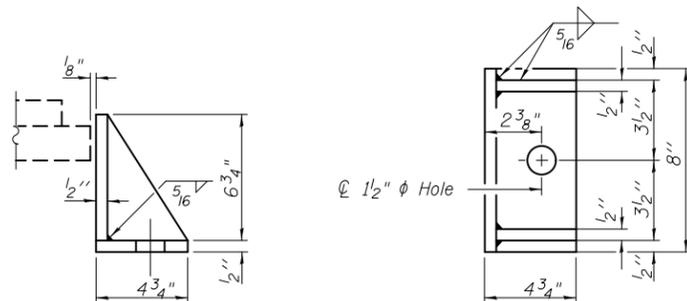

SIDE RETAINER

Equivalent rolled angle with stiffeners will be allowed in lieu of welded plates.

BILL OF MATERIAL

Item	Unit	Total
Elastomeric Bearing Assembly Type I	Each	10
Anchor Bolts, 1"	Each	20
Anchor Bolts, 1 1/4"	Each	20

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DATE	- 5/3/2012	REVISED	-

STATE OF ILLINOIS
DEPARTMENT OF TRANSPORTATION

BEARING DETAILS
ILLINOIS ROUTE 31 OVER CRYSTAL CREEK
STRUCTURE NO. 056-0077

SHEET NO. SA20 OF SA33 SHEETS

O.R. RTE.	SECTION	COUNTY	TOTAL SHEETS	SHEET NO.
0003	18A-2	MCHENRY	825	480
CONTRACT NO. 60F72				
ILLINOIS FED. AID PROJECT				


BILL OF MATERIAL

(For 2 Abutments)


Bar	No.	Size	Length	Shape
b13(E)	8	#5	1'-3"	—
c(E)	4	#5	2'-8"	—
c1(E)	8	#5	2'-4"	└
d6(E)	8	#5	7'-11"	└
h(E)	24	#6	29'-2"	—
h1(E)	6	#5	28'-8"	—
h2(E)	66	#5	27'-8"	—
h3(E)	8	#4	1'-3"	—
h4(E)	8	#5	4'-7"	└
p(E)	60	#7	29'-2"	—
p1(E)	16	#5	18'-10"	—
p2(E)	8	#5	15'-9"	—
s(E)	176	#5	17'-7"	└
s1(E)	98	#4	9'-4"	└
u(E)	16	#6	12'-9"	└
v(E)	154	#5	3'-9"	└
v1(E)	154	#4	3'-9"	└
v2(E)	154	#4	6'-6"	└
v3(E)	77	#4	7'-11"	└
v4(E)	77	#4	7'-7"	└

ITEM	UNIT	QUANTITY
Concrete Structures	Cu. Yd.	177.4
Concrete Superstructure	Cu. Yd.	12.0
Bridge Deck Grooving	Sq. Yd.	25
Protective Coat	Sq. Yd.	25
Reinforcement Bars, Epoxy Coated	Pound	13,910
Furnishing Steel Piles HP 14x73	Foot	3,900
Driving Piles	Foot	3,900
Test Pile HP 14x73	Each	2
Pile Shoes	Each	52
Concrete Sealer	Sq. Ft.	1,307


Bars indicated thus 4x3-#5 etc. indicates 4 lines of bars with 3 lengths per line.

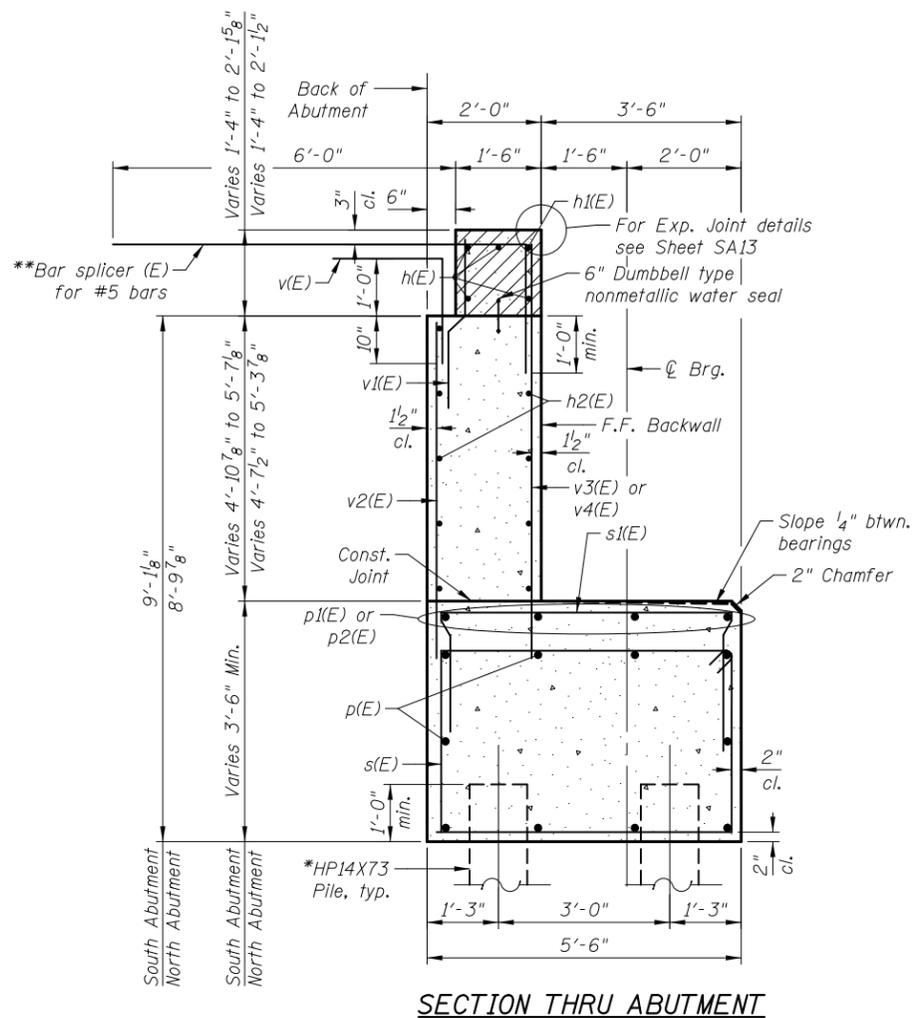


SECTION THRU ABUTMENT

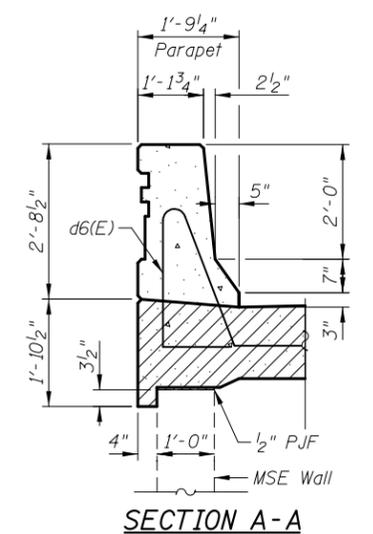

SECTION A-A

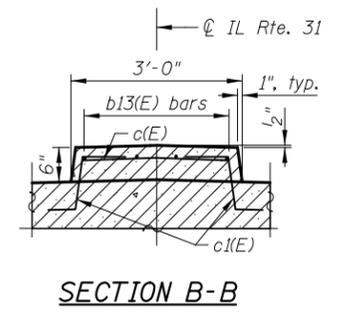


SECTION B-B

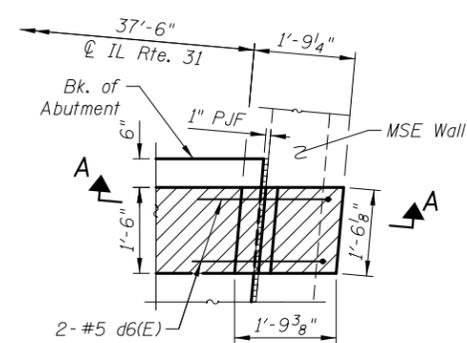


DETAIL "A"

(All Parapets are similar or mirror views)

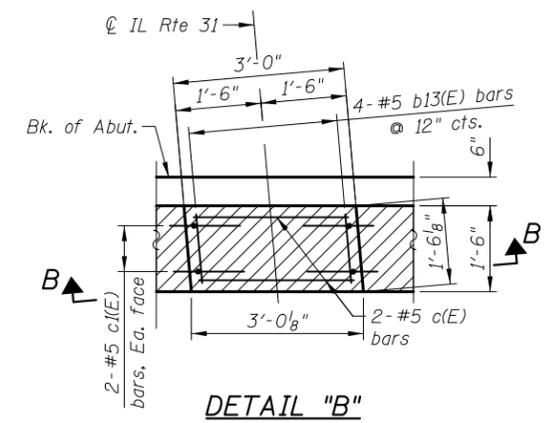


DETAIL "B"


(S. Abut. shown, N. Abut. is mirror image)

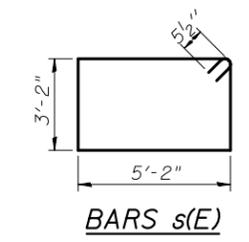


BARS s(E)

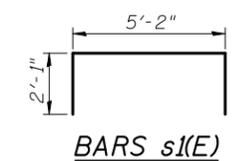


BARS s1(E)

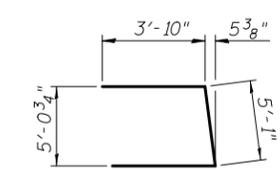


BAR u(E)

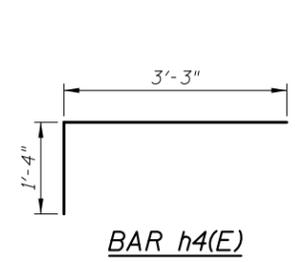


BAR h4(E)

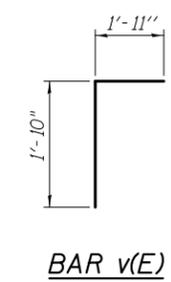


BAR v(E)

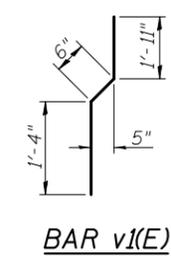

BAR v1(E)

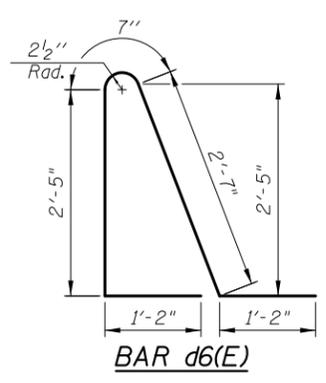

BAR d6(E)

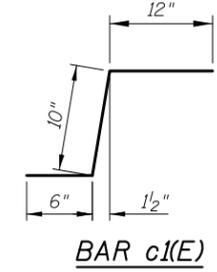

BAR c1(E)

* Piles shall be driven prior to placement of the reinforced select fill and coated with coal tar epoxy from the bottom of the select fill to 1" above the base of the abutment. The cost of the coal tar epoxy coating shall be included with the cost of the Furnishing Piles.

** Bar Splicers shall be parallel to the approach slab reinforcement.

Notes:
 Hatched area to be poured after superstructure false work has been removed. Quantity of concrete included with Concrete Superstructure.
 Parapet area to be poured with the approach slabs. Space reinforcement in cap to miss anchor bolts. Pour steps monolithically with cap.
 For Pile details see sheet SA24.
 For details of Bar Splicers see sheet SA29.
 Concrete Sealer shall be applied to the designated areas of the backwalls and bridge seats of the abutments.

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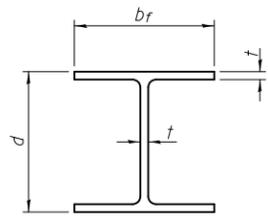
DRAWN	- M. LANGE	REVISED	-
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DATE	- 5/3/2012	REVISED	-

STATE OF ILLINOIS
DEPARTMENT OF TRANSPORTATION

ABUTMENT DETAILS
ILLINOIS ROUTE 31 OVER CRYSTAL CREEK
STRUCTURE NO. 056-0077


O.R. RTE.	SECTION	COUNTY	TOTAL SHEETS	SHEET NO.
0003	18A-2	MCHENRY	825	483
			CONTRACT NO. 60F72	
ILLINOIS FED. AID PROJECT				

SHEET NO. SA23 OF SA33 SHEETS




STEEL PILE TABLE


Designation	Depth d	Flange width br	Web and Flange thickness t	Encasement diameter A
HP 14x117	14 1/4"	14 7/8"	1 3/16"	30"
x102	14"	14 3/4"	1/16"	30"
x89	13 7/8"	14 3/4"	5/8"	30"
x73	13 5/8"	14 5/8"	1/2"	30"
HP 12x84	12 1/4"	12 1/4"	1/16"	24"
x74	12 1/8"	12 1/4"	5/8"	24"
x63	12"	12 1/8"	1/2"	24"
x53	11 3/4"	12"	7/16"	24"
HP 10x57	10"	10 1/4"	9/16"	24"
x42	9 3/4"	10 1/8"	7/16"	24"
HP 8x36	8"	8 1/8"	7/16"	18"

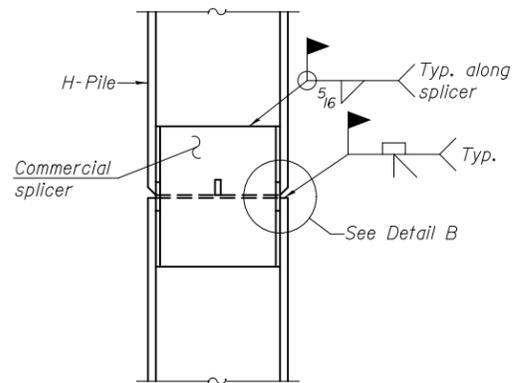

ELEVATION

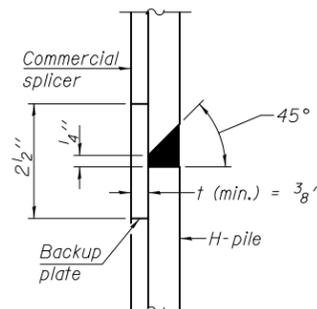


DETAIL "B"

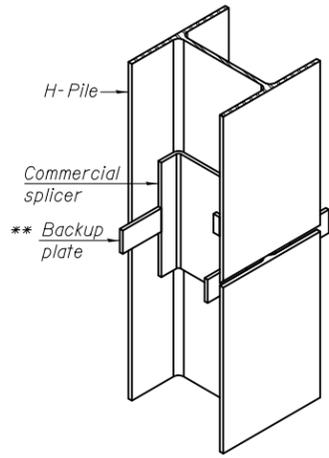


ISOMETRIC VIEW

WELDED COMMERCIAL SPLICE

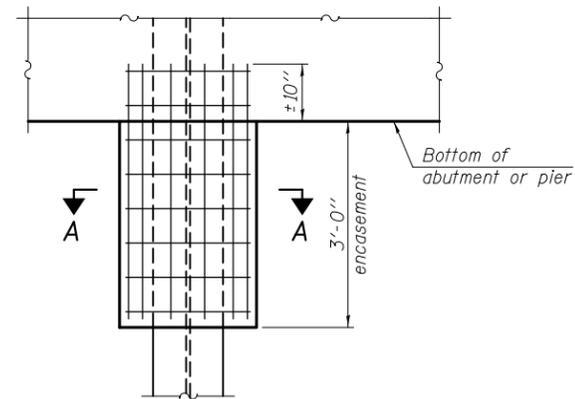


ELEVATION

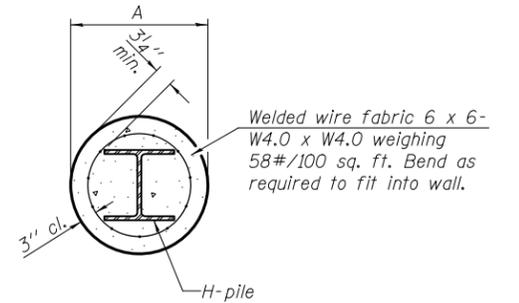


SECTION A-A


PILE ENCASEMENT

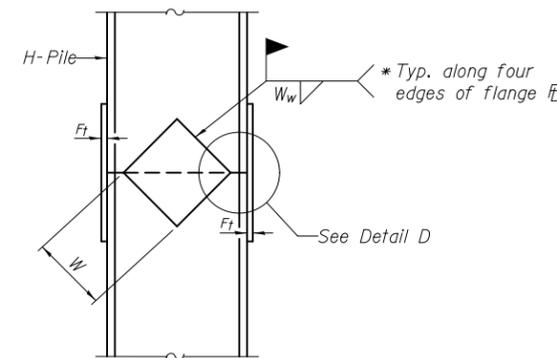

ELEVATION

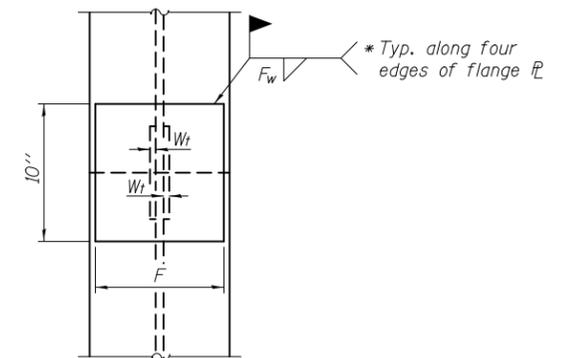


END VIEW

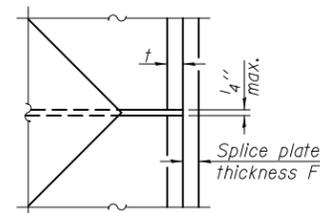


DETAIL D

WELDED PLATE FIELD SPLICE

Designation	F	F _t	F _w	W	W _t	W _w
HP 14x117	12 1/2"	1"	7/8"	7 3/4"	5/8"	1/2"
x102	12 1/2"	7/8"	3/4"	7 3/4"	5/8"	1/2"
x89	12 1/2"	3/4"	1/16"	7 3/4"	5/8"	1/2"
x73	12 1/2"	5/8"	9/16"	7 3/4"	5/8"	1/2"
HP 12x84	10"	7/8"	1/16"	6 1/2"	5/8"	1/2"
x74	10"	7/8"	1/16"	6 1/2"	5/8"	1/2"
x63	10"	5/8"	1/2"	6 1/2"	1/2"	3/8"
x53	10"	5/8"	1/2"	6 1/2"	1/2"	3/8"
HP 10x57	8"	3/4"	9/16"	5 1/4"	1/2"	3/8"
x42	8"	5/8"	9/16"	5 1/4"	1/2"	3/8"
HP 8x36	7"	5/8"	7/16"	4 1/4"	1/2"	3/8"

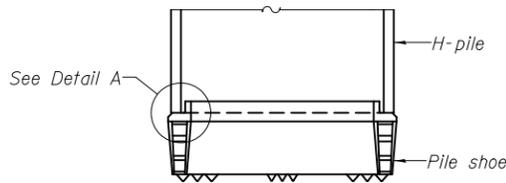


ELEVATION

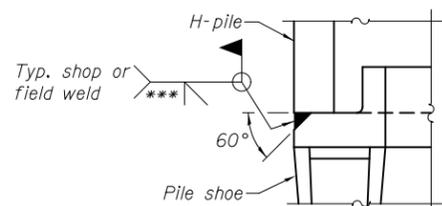

DETAIL A

H-PILE SHOE ATTACHMENT

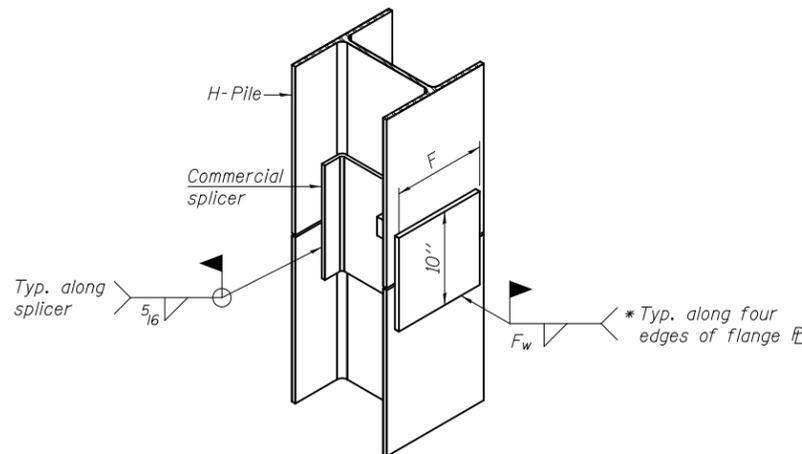

ISOMETRIC VIEW

WELDED COMMERCIAL SPLICE ALTERNATE

- * Interrupt welds 1/4" from end of web and/or each flange.
- ** Remove portions of backup plates that extend outside the flanges.
- *** Weld size per pile shoe manufacturer (5/16" min.).

Note:
The steel H-piles shall be according to AASHTO M270 Grade 50.

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F-HP 7-1-10

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CHECKED - G. HATLESTAD	REVISED -
DATE - 5/3/2012	REVISED -


**STATE OF ILLINOIS
DEPARTMENT OF TRANSPORTATION**

**PILE DETAILS
ILLINOIS ROUTE 31 OVER CRYSTAL CREEK
STRUCTURE NO. 056-0077**


SHEET NO. SA24 OF SA33 SHEETS

O.R. RTE.	SECTION	COUNTY	TOTAL SHEETS	SHEET NO.
0003	18A-2	MCHENRY	825	484
CONTRACT NO. 60F72				
ILLINOIS FED. AID PROJECT				


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NORTH ABUTMENT WALL
Unfolded Elevation

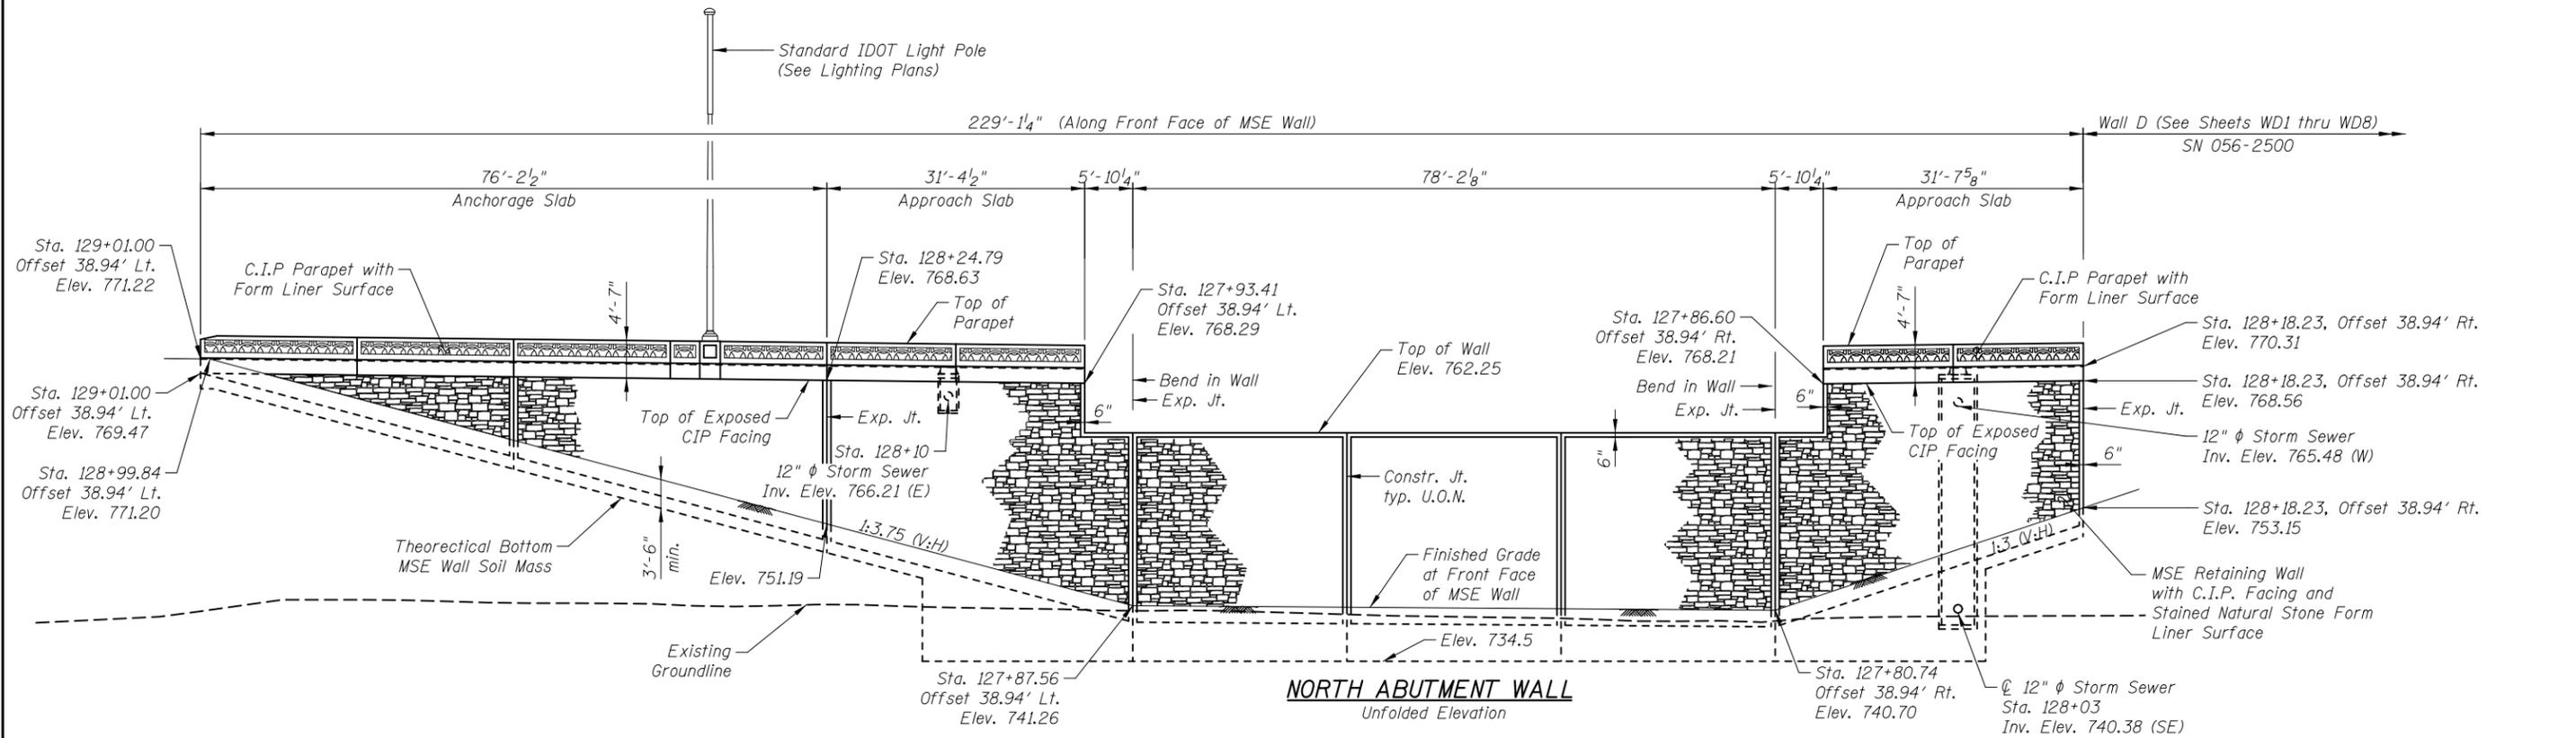

SOUTH ABUTMENT WALL
Unfolded Elevation

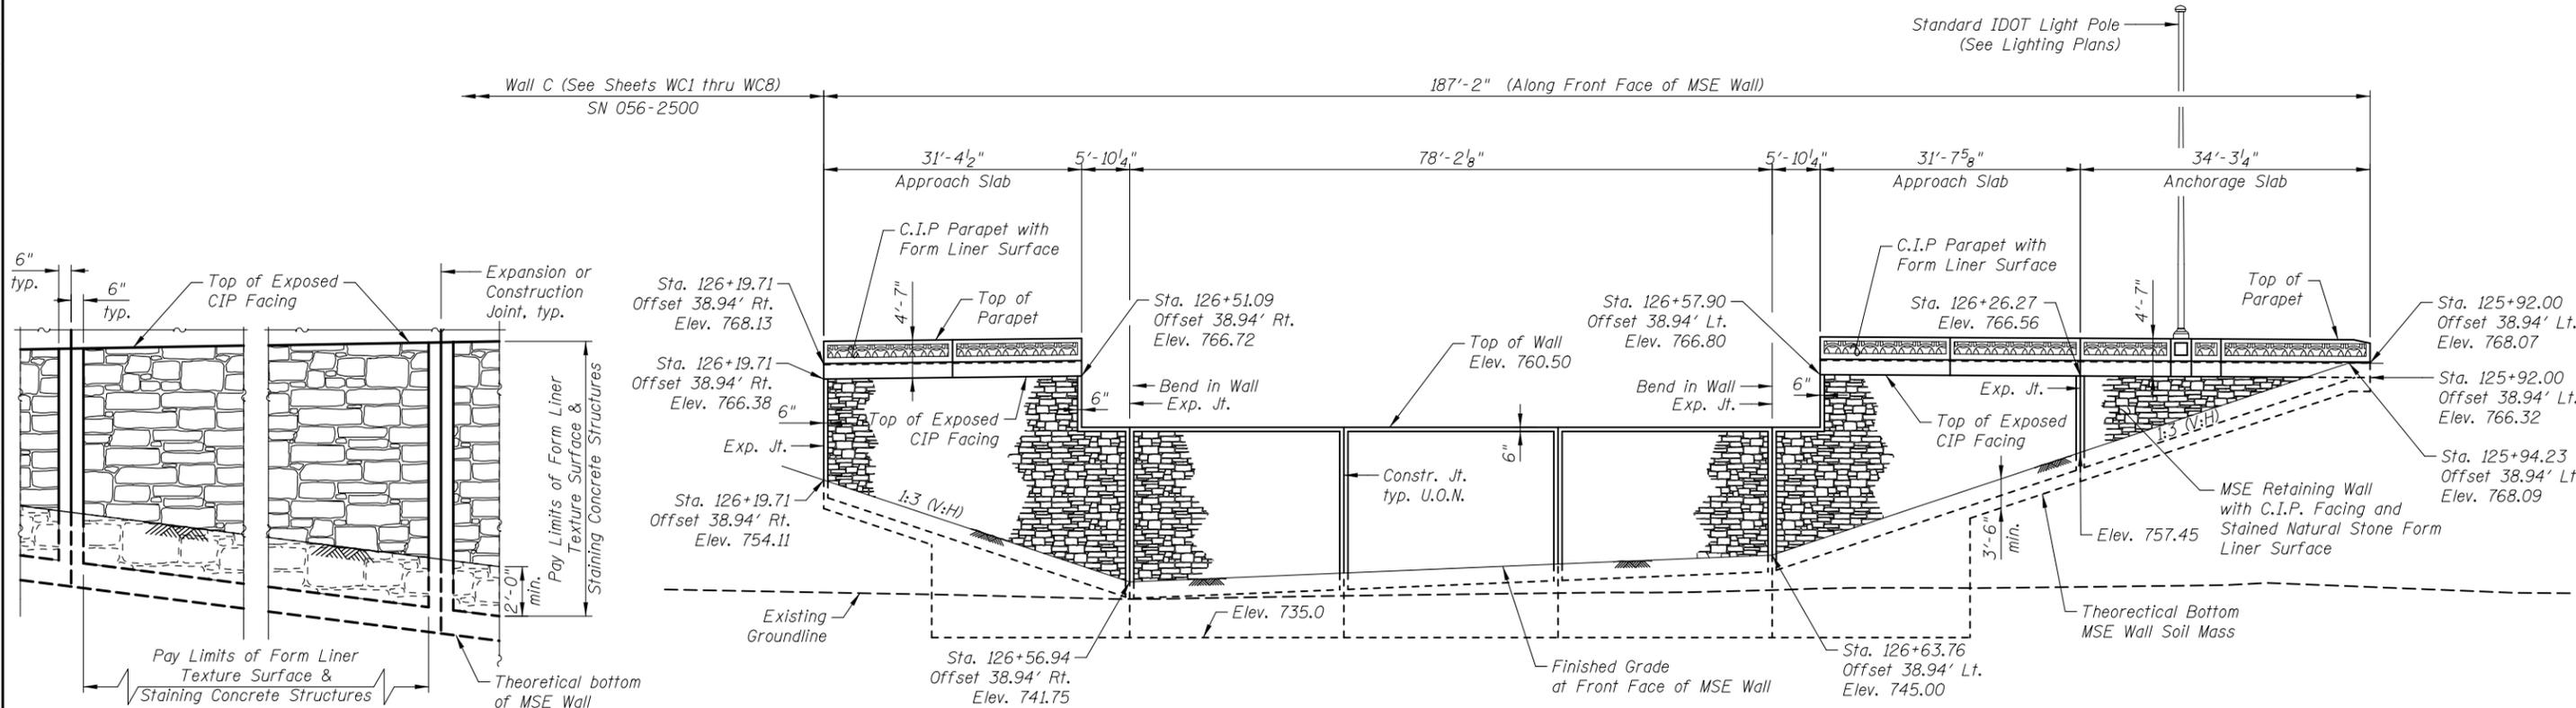

FORM LINER TEXTURE SURFACE DETAIL

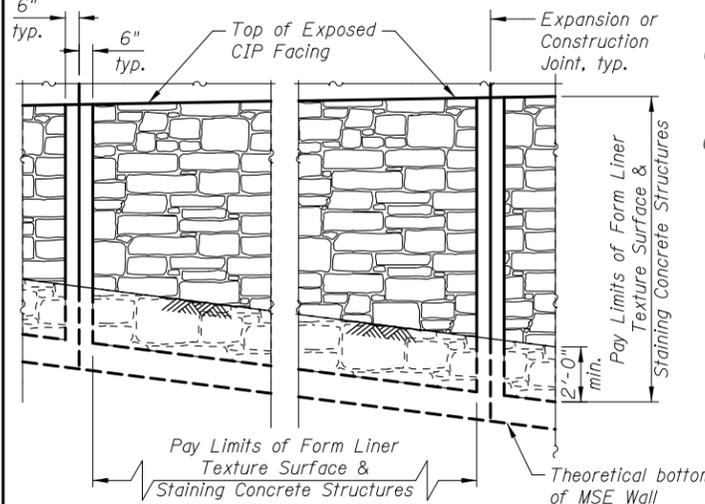Notes:
 See sheet SA1 for Plan View
 See sheet SA12 for Parapet Form Liner Details.
 Offsets are measured from \varnothing IL Rte. 31 to Front Face of MSE Wall.

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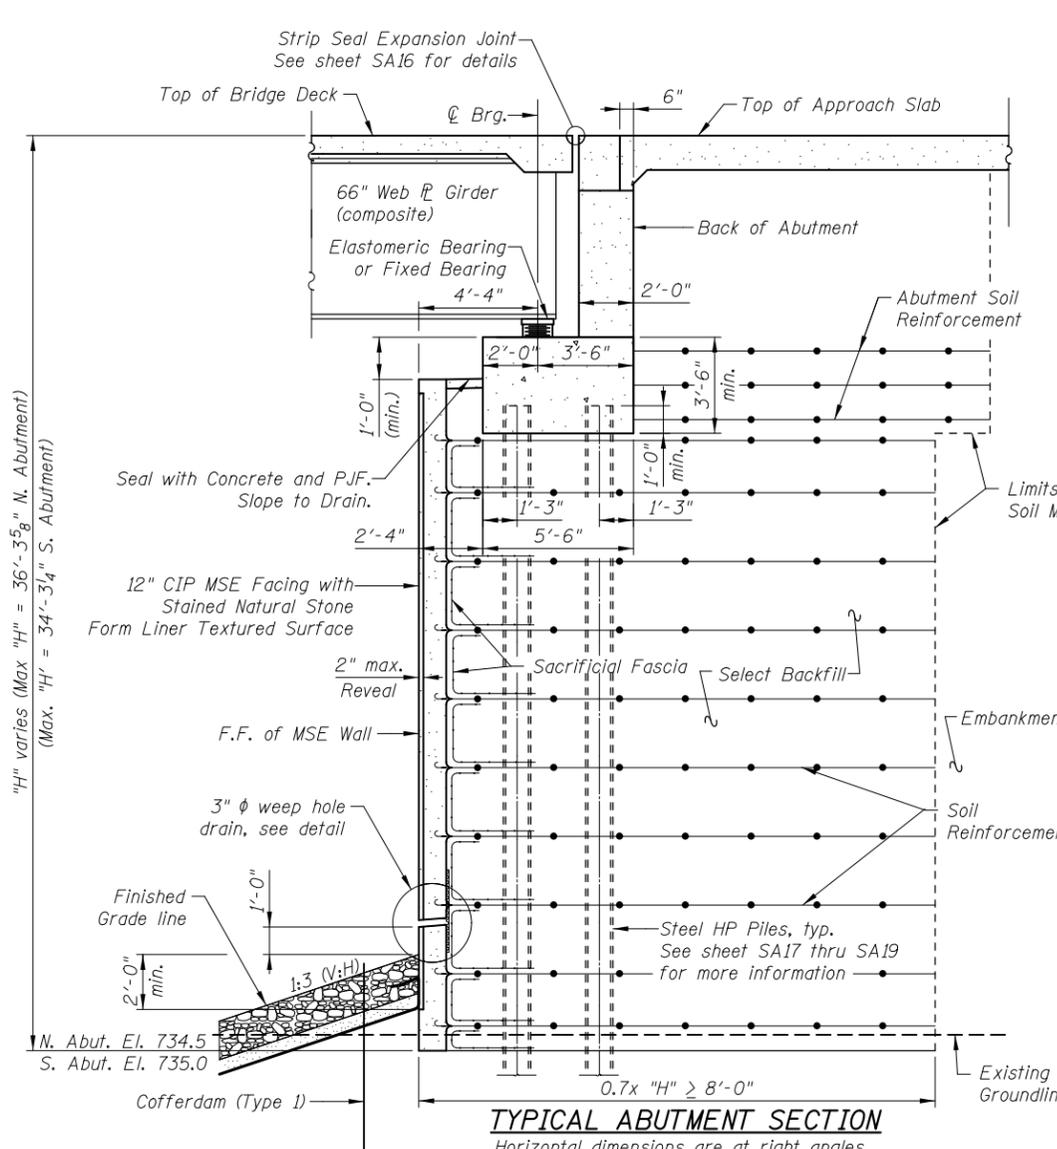
DRAWN	- M. LANGE	REVISED	-
DESIGNED	- D. ATKINS	REVISED	-
CHECKED	- G. HATLESTAD	REVISED	-
DATE	- 5/3/2012	REVISED	-

STATE OF ILLINOIS
DEPARTMENT OF TRANSPORTATION

MSE WALLS
ILLINOIS ROUTE 31 OVER CRYSTAL CREEK
STRUCTURE NO. 056-0077
 SHEET NO. SA25 OF SA33 SHEETS



O.R. RTE.	SECTION	COUNTY	TOTAL SHEETS	SHEET NO.
0003	18A-2	MCHENRY	825	485
CONTRACT NO. 60F72				

ILLINOIS FED. AID PROJECT





The MSE Wall supplier shall design the abutment soil reinforcement to resist an unfactored horizontal force of 4.7 kips/ft. of abutment.

The MSE wall supplier's internal stability design shall account for the anchorage slab's bearing pressure surcharge of 1.0 ksf and horizontal sliding force of 0.5 kips/ft. of wall.

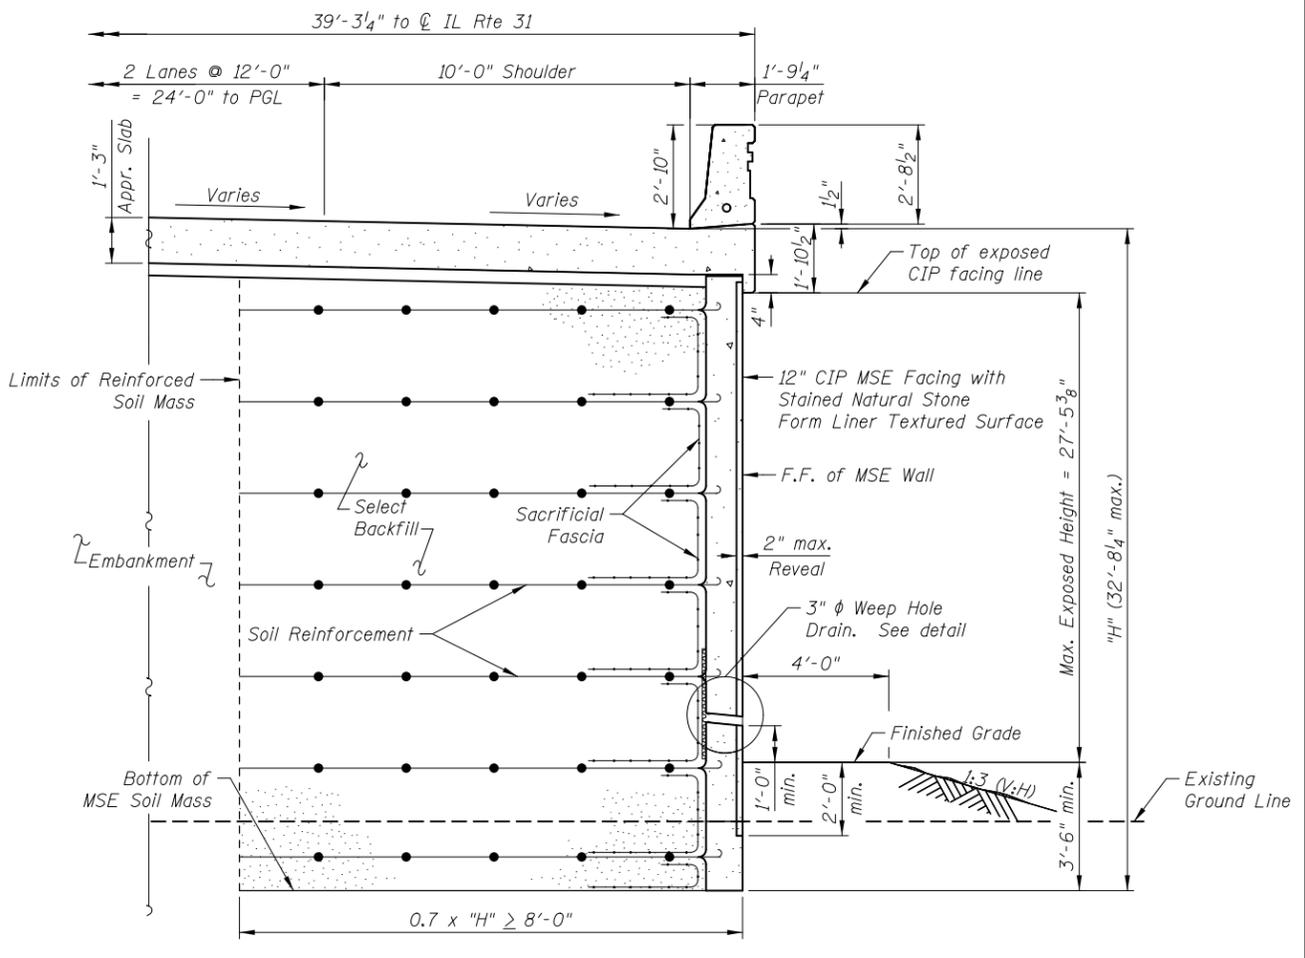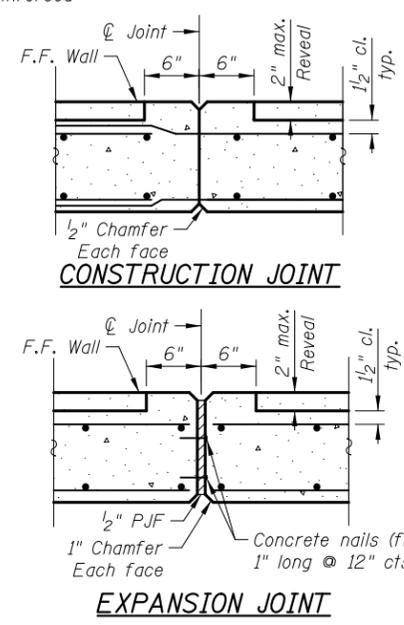


BILL OF MATERIAL


ITEM	UNIT	TOTAL
Concrete Structures	Cu Yd.	2.5
Form Liner Textured Surface	Sq. Ft.	6,979
Geocomposite Wall Drain	Sq. Yd.	54
Mechanically Stabilized Earth Retaining Wall	Sq. Ft.	9,311
Staining Concrete Structures	Sq. Yd.	775

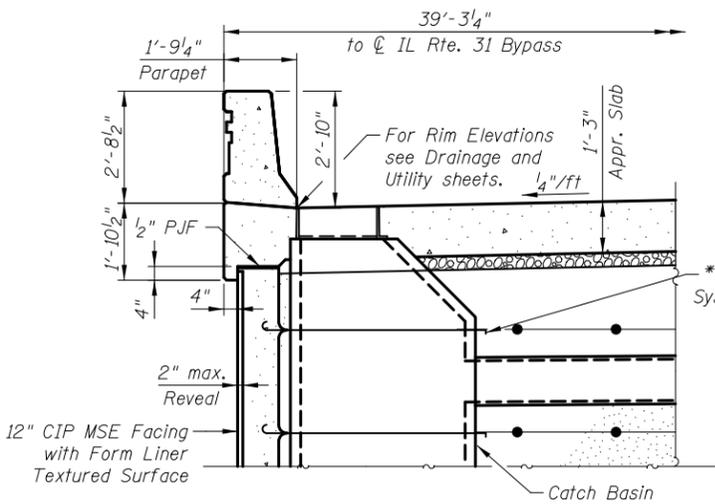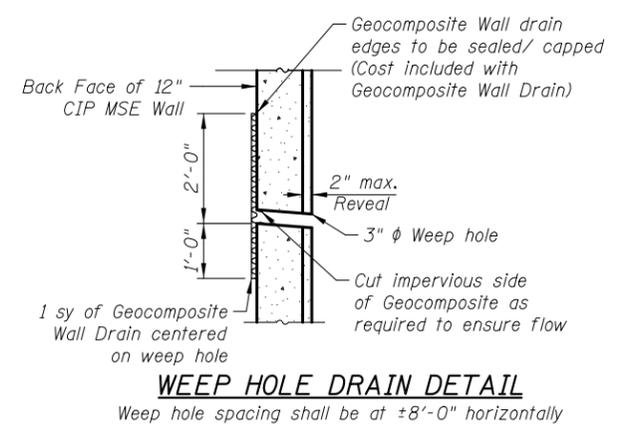

SECTION THRU DRAINAGE STRUCTURE
* M.S.E. supplier to design load transfer system to accommodate concrete pipe and catch basin

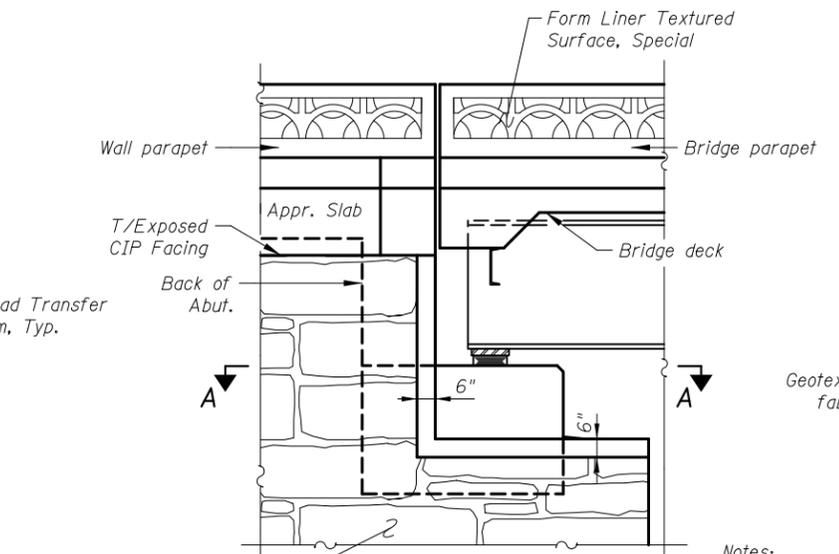

MSE Wall with CIP facing and Stained Natural Stone Textured Form Liner Surface Walls

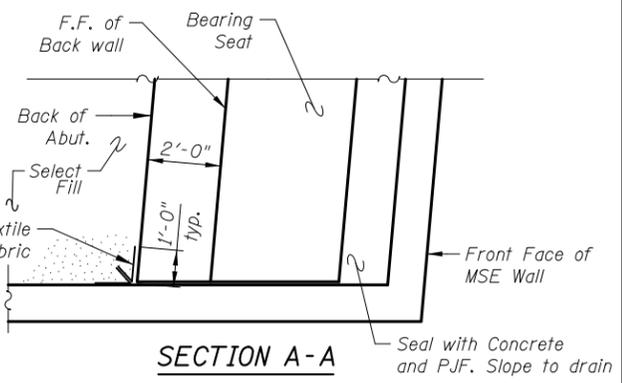

Notes:
See Sheet SA28 for anchorage slab details.
Seal with concrete and P.J.F shall be paid for as Concrete Structures.
Geotextile Fabric shall be paid for as Mechanically Stabilized Earth Retaining Wall.
For Form Liner Textured Surface details see sheet SA25.

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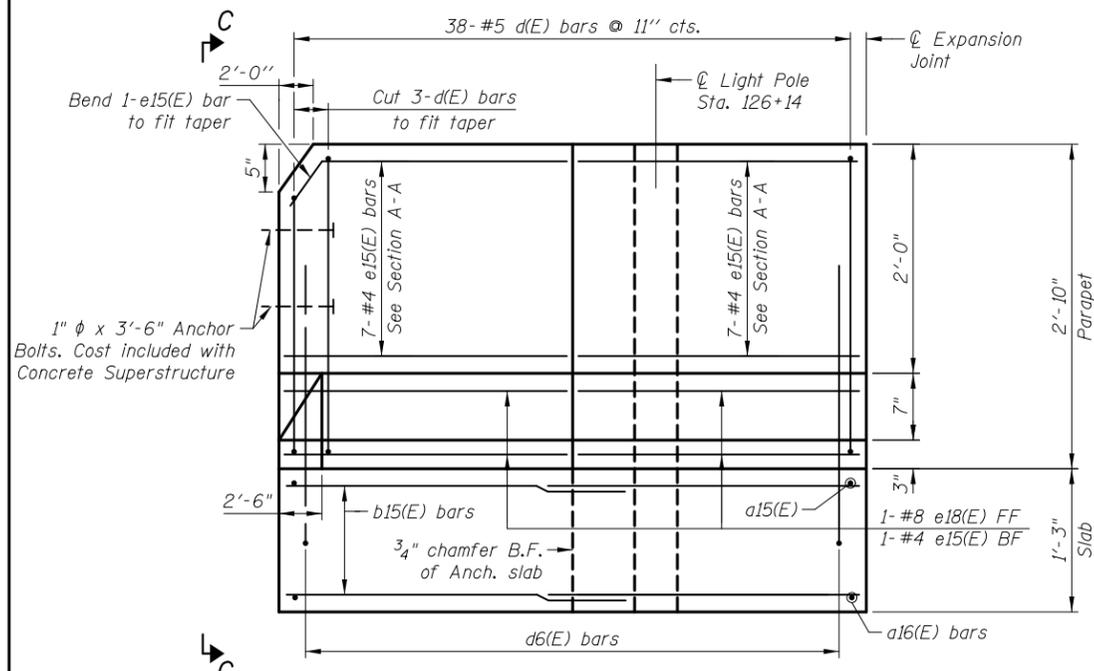
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DESIGNED	- D. ATKINS	REVISED	-
CHECKED	- G. HATLESTAD	REVISED	-
DATE	- 5/3/2012	REVISED	-


**STATE OF ILLINOIS
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**MSE WALL DETAILS
ILLINOIS ROUTE 31 OVER CRYSTAL CREEK
STRUCTURE NO. 056-0077**
SHEET NO. SA26 OF SA33 SHEETS


O.R. RTE.	SECTION	COUNTY	TOTAL SHEETS	SHEET NO.
0003	18A-2	MCHENRY	825	486
CONTRACT NO. 60F72			ILLINOIS FED. AID PROJECT	




ELEVATION SW ANCHORAGE SLAB
(Front face of parapet)

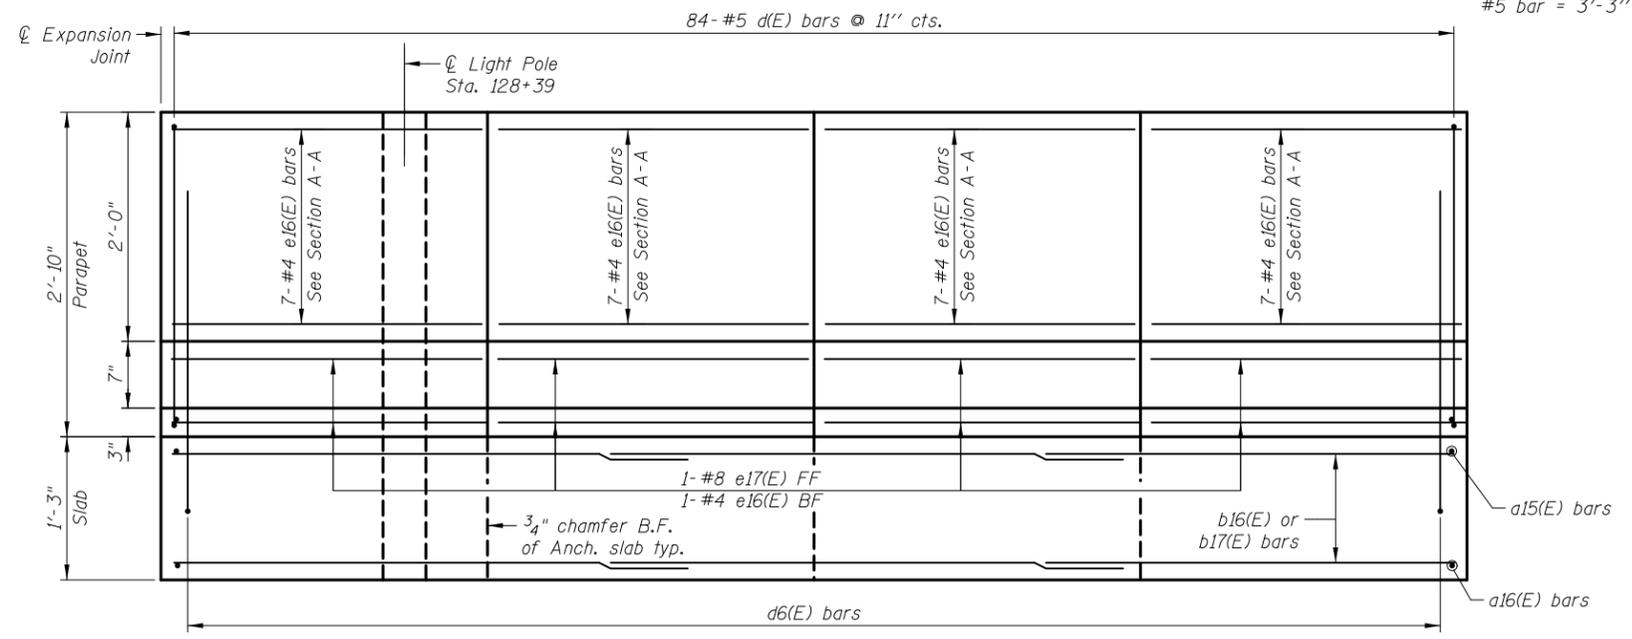

ELEVATION NW ANCHORAGE SLAB
(Front face of parapet)


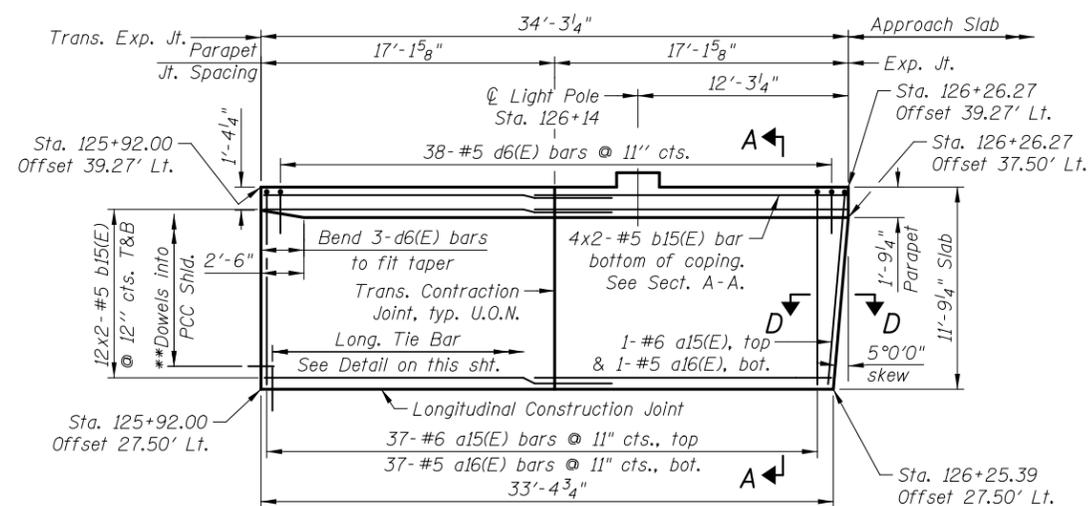


PLAN SW ANCHORAGE SLAB

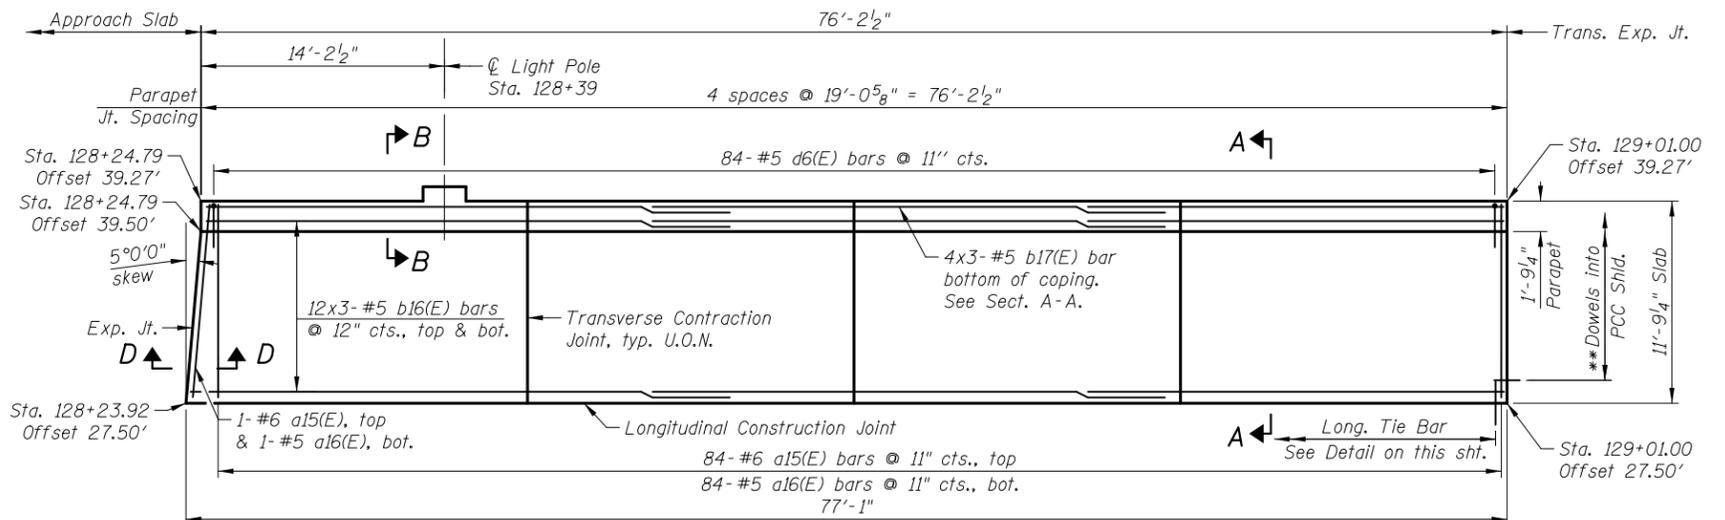


PLAN NW ANCHORAGE SLAB


Sheet Notes: See sheet SA28 for reinforcement schedule & Bill of Material.
See sheet SA28 for Sections A-A, B-B, View C-C, Section D-D and Trans. Contraction Jt. Detail
** Indicates dowels into PCC Shld. See Transverse Expansion Joint Detail.
U.O.N. denotes Unless Otherwise Noted

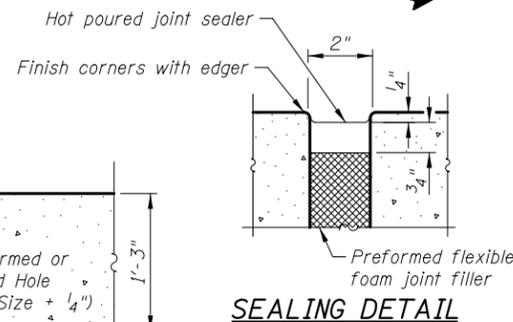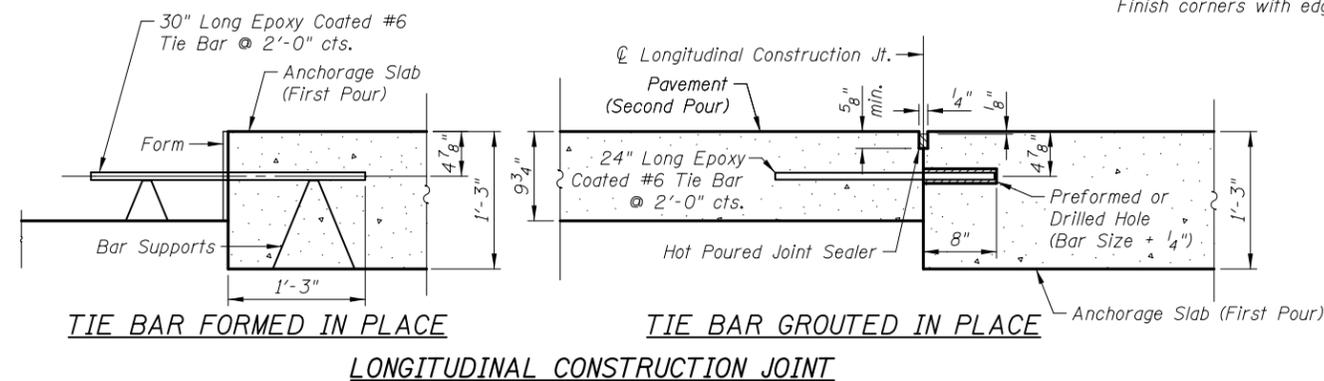

SEALING DETAIL

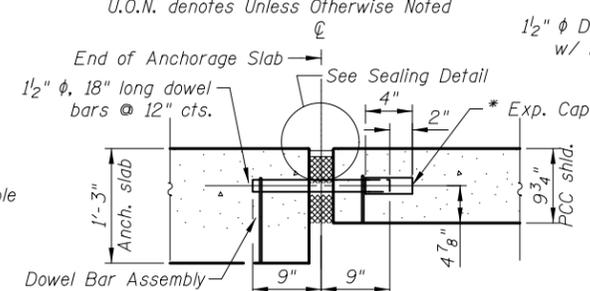

TRANSVERSE EXP. JOINT

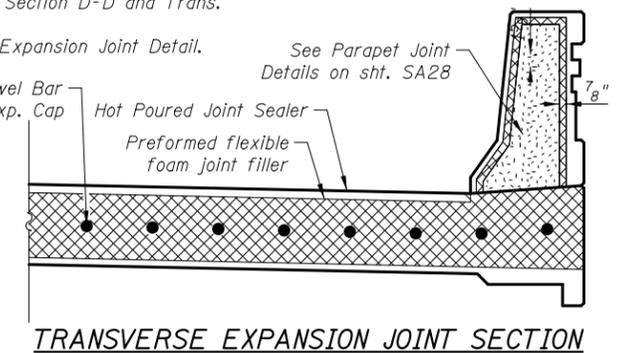


TRANSVERSE EXPANSION JOINT SECTION


* Expansion caps shall be installed on the exposed end of each dowel bar once the header has been removed and the joint filler material has been installed.
Expansion Joint and Dowel Bars included in the cost of Concrete Superstructures.

5/2/2012 4:16:48 PM I:\2154\cad\sheet\Roadway\20-Structures & Walls\01.SN 056-007\Y056007T-60F72-27-ANS.rev.dgn

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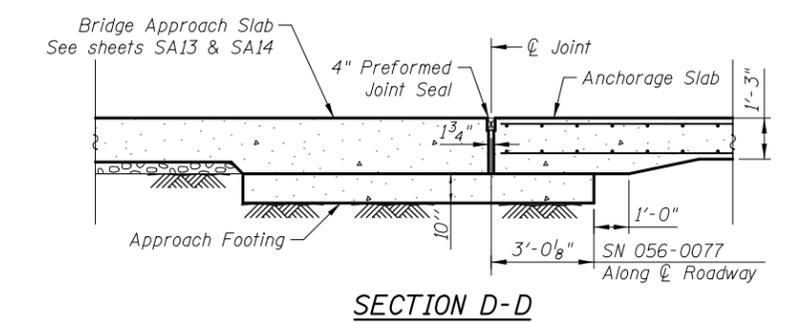


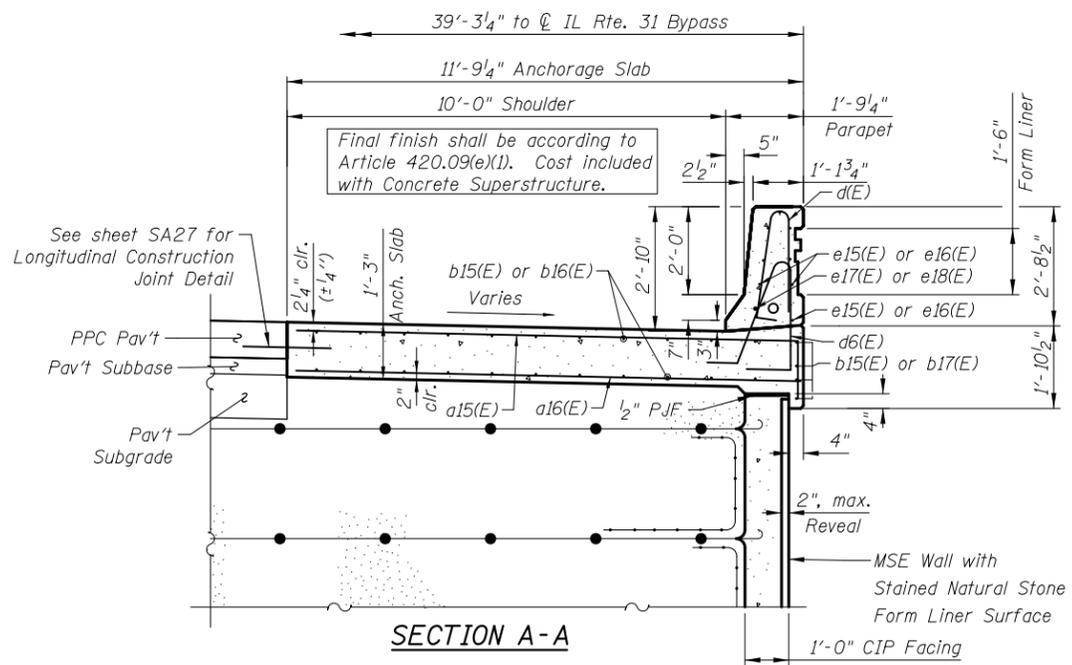SECTION A-A

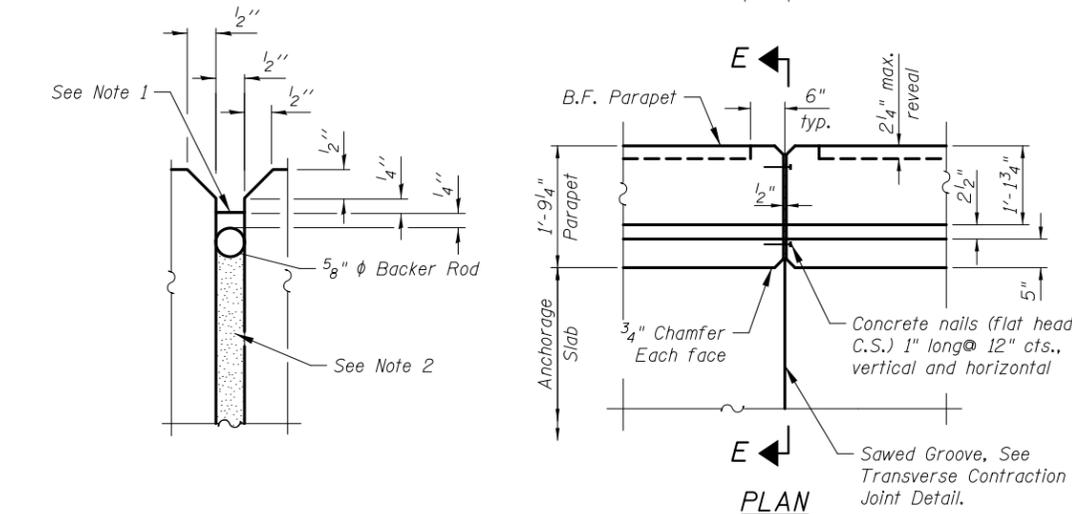


PARAPET JOINT DETAILS


- Parapet Joint Notes:**
- Non-staining gray one component non-sag elastomeric gun grade polyurethane sealant meeting the requirements of ASTM C-920, Type S, Grade NS, Class 25, use T with a 5/8" backer rod.
 - 1/2" Preformed Self-Expanding Cork Joint Filler according to Article 1051.07 of the Std. Spec. Cost included with Concrete Superstructure.




SECTION D-D

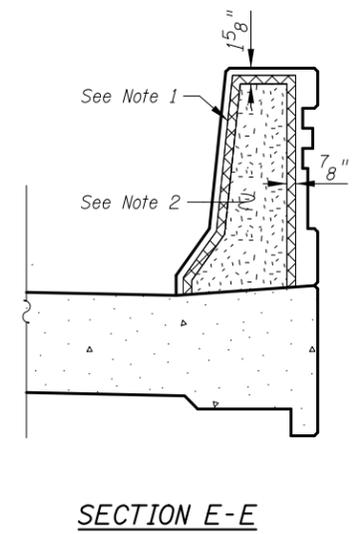


SECTION E-E

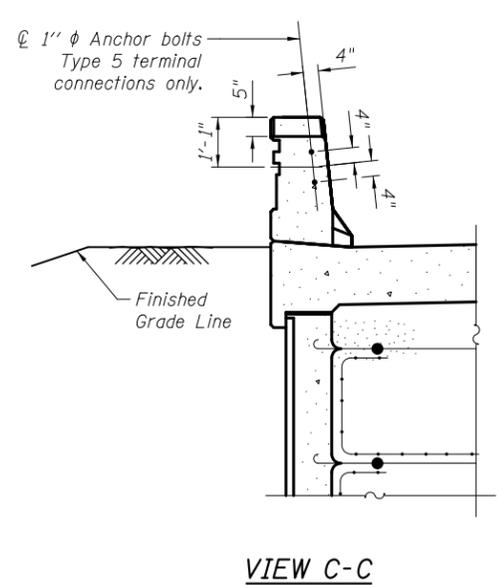


VIEW C-C

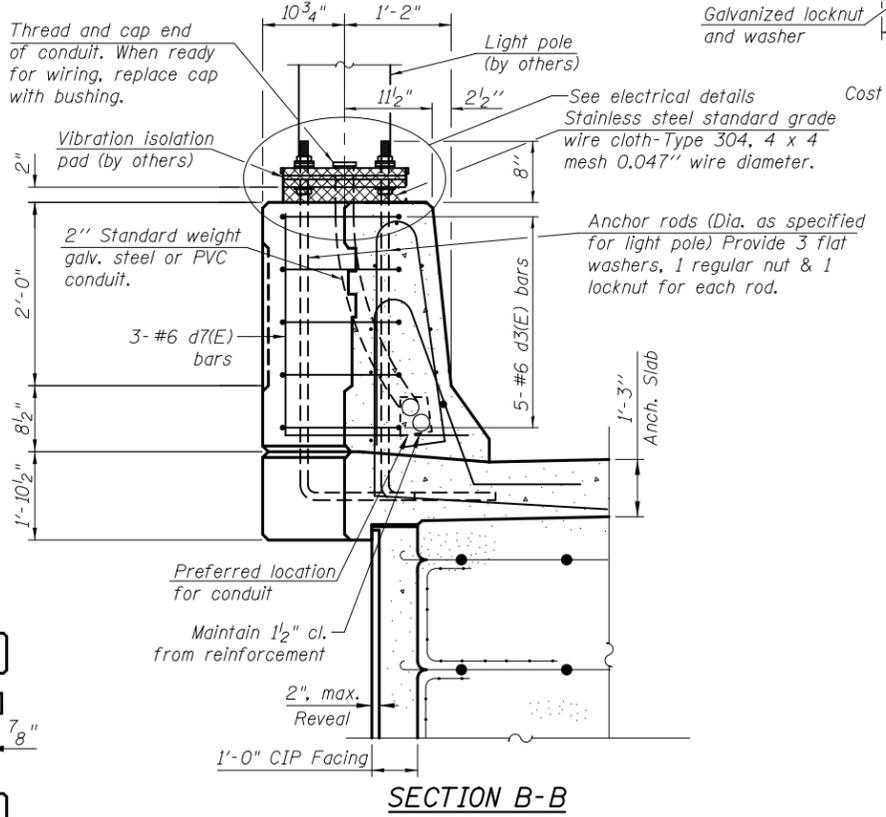

SECTION B-B

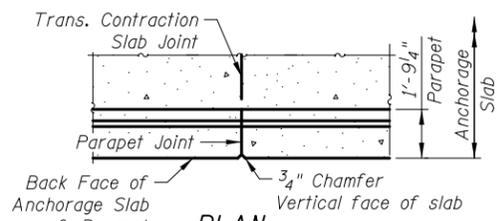


TRANSVERSE CONTRACTION JOINT
See Art. 420.05(c) of Standard Specifications

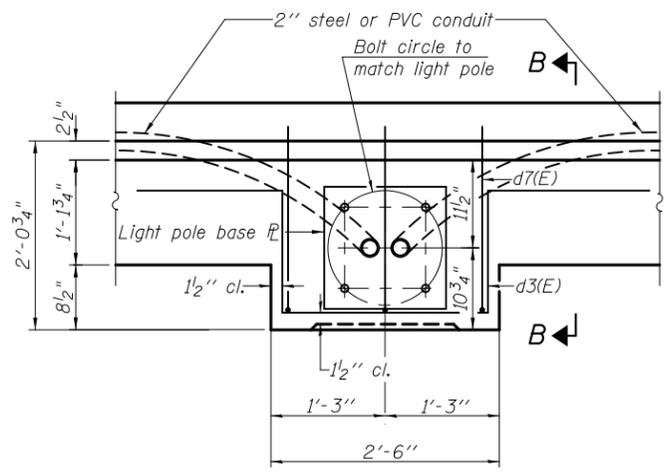


LIGHT POLE FOUNDATION PLAN

Cost of anchor bolts is included with Concrete Superstructure.

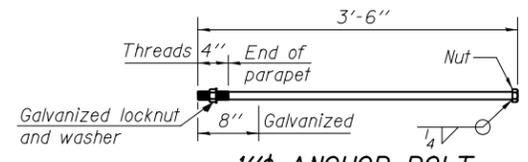

1" ANCHOR BOLT

Cost included with Concrete Superstructure

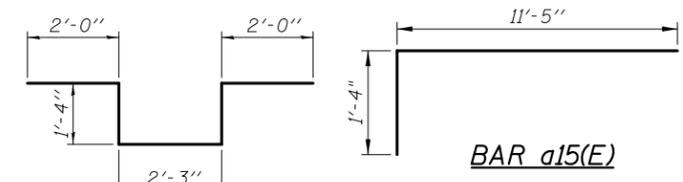


BAR a15(E)




BAR d3(E)



BAR d7(E)

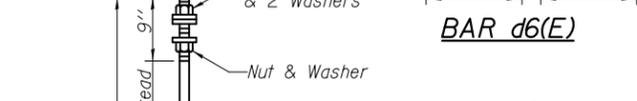

BAR d6(E)

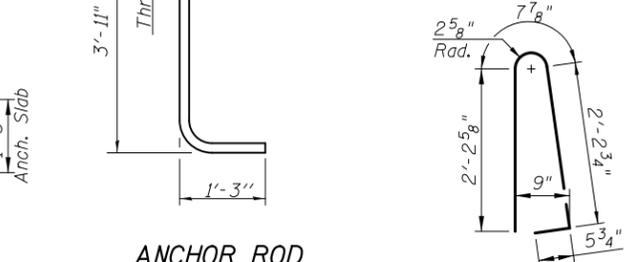

ANCHOR ROD

Diameter as specified for light poles. (ASTM F 1554 Grade 105)

**ANCHORAGE SLABS
BILL OF MATERIAL**

Bar	No.	Size	Length	Shape
a15(E)	123	#6	12'-9"	U
a16(E)	123	#5	11'-5"	U
b15(E)	56	#5	18'-8"	U
b16(E)	72	#5	27'-9"	U
b17(E)	12	#5	27'-6"	U
d(E)	122	#5	5'-7"	U
d3(E)	10	#6	8'-11"	U
d6(E)	122	#5	7'-11"	U
d7(E)	6	#6	4'-5"	U
e15(E)	16	#4	16'-10"	U
e16(E)	32	#4	18'-9"	U
e17(E)	4	#8	18'-9"	U
e18(E)	2	#8	16'-10"	U

ITEM	UNIT	QUANTITY
Concrete Superstructure	Cu. Yds.	78.3
Protective Coat	Sq. Yd.	174
Reinforcement Bars, Epoxy Coated	Pound	10,110
Form Liner Textured Surface, Special	Sq. Ft.	146

Bars indicated thus 8x2 - #5 etc. indicates 8 lines of bars with 2 length per line

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DRAWN - M. LANGE	REVISED -
DESIGNED - D. ATKINS	REVISED -
CHECKED - G. HATLESTAD	REVISED -
DATE - 5/3/2012	REVISED -


**STATE OF ILLINOIS
DEPARTMENT OF TRANSPORTATION**

**ANCHORAGE SLAB DETAILS
ILLINOIS ROUTE 31 OVER CRYSTAL CREEK
STRUCTURE NO. 056-0077**

SHEET NO. SA28 OF SA33 SHEETS

O.R. RTE. 0003	SECTION 18A-2	COUNTY MCHENRY	TOTAL SHEETS 825	SHEET NO. 488
			CONTRACT NO. 60F72	

ILLINOIS FED. AID PROJECT

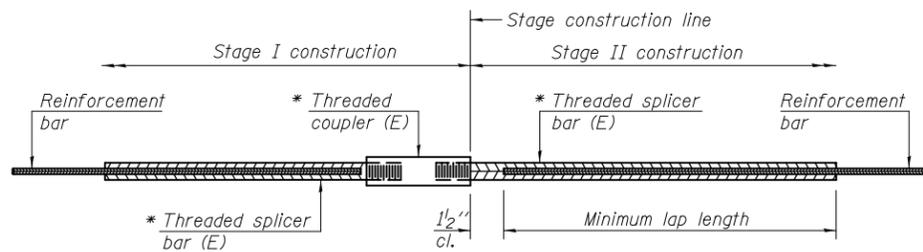

STANDARD BAR SPLICER ASSEMBLY


Minimum Lap Lengths					
Bar size to be spliced	Table 1	Table 2	Table 3	Table 4	Table 5
3, 4	1'-5"	1'-11"	2'-1"	2'-4"	2'-3"
5	1'-9"	2'-5"	2'-7"	2'-11"	2'-10"
6	2'-1"	2'-11"	3'-1"	3'-6"	3'-4"
7	2'-9"	3'-10"	4'-2"	4'-8"	4'-6"
8	3'-8"	5'-1"	5'-5"	6'-2"	5'-10"
9	4'-7"	6'-5"	6'-10"	7'-9"	7'-5"

- Table 1: Black bar, 0.8 Class C
- Table 2: Black bar, Top bar lap, 0.8 Class C
- Table 3: Epoxy bar, 0.8 Class C
- Table 4: Epoxy bar, Top bar lap, 0.8 Class C
- Table 5: Epoxy bar, Top bar lap, Class B

Threaded splicer bar length = min. lap length + 1/2" + thread length


* Epoxy not required on Bar Splicer Assembly components used in conjunction with black bars.

Location	Bar size	No. assemblies required	Table for minimum lap length

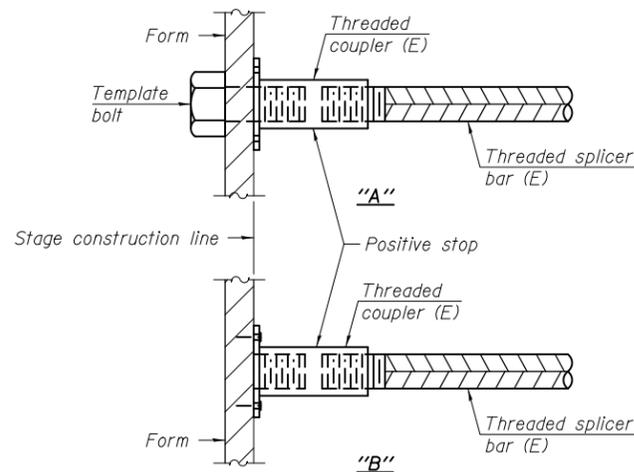


INSTALLATION AND SETTING METHODS

"A" : Set bar splicer assembly by means of a template bolt.
 "B" : Set bar splicer assembly by nailing to wood forms or cementing to steel forms.
 (E) : Indicates epoxy coating.

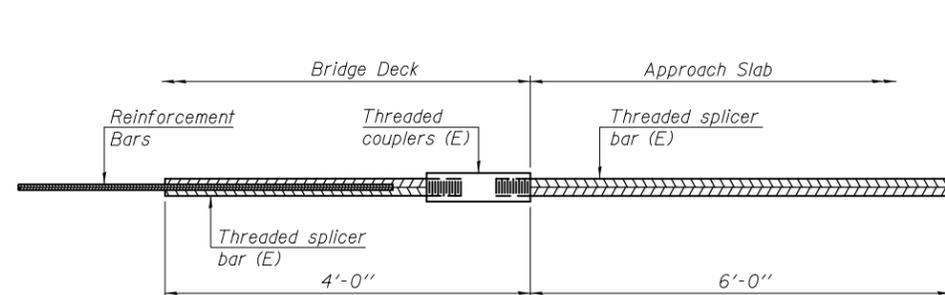

BAR SPLICER ASSEMBLY FOR #5 BAR ON INTEGRAL OR SEMI-INTEGRAL ABUTMENTS

No. required =

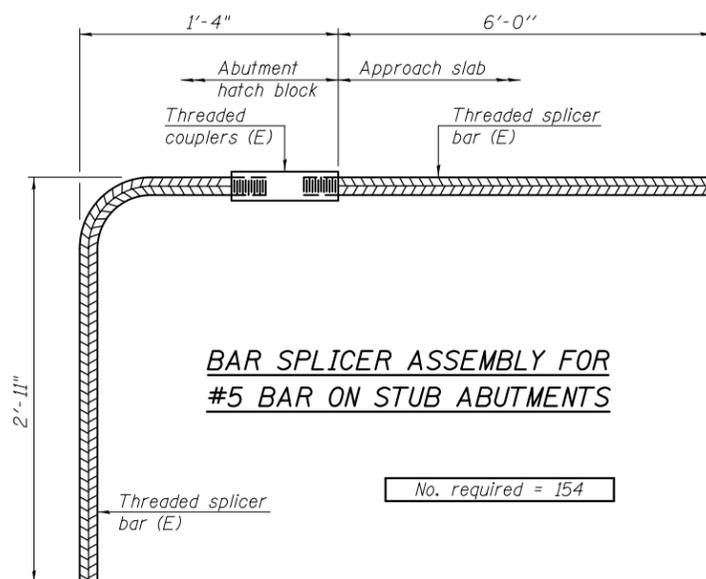

BAR SPLICER ASSEMBLY FOR #5 BAR ON STUB ABUTMENTS


No. required = 154

NOTES

Splicer bars shall be deformed with threaded ends and have a minimum 60 ksi yield strength.
 All reinforcement shall be lapped and tied to the splicer bars.
 Bar splicer assemblies shall be epoxy coated according to the requirements for reinforcement bars. See Section 508 of the Standard Specifications.
 See approved list of bar splicer assemblies and mechanical splicers for alternatives.


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Benchmark: Control Point CP10, Iron Rod in gravel lot, IL Rte 31 Station 127+66.44, offset 99.87 feet Right; Elev. 737.99.

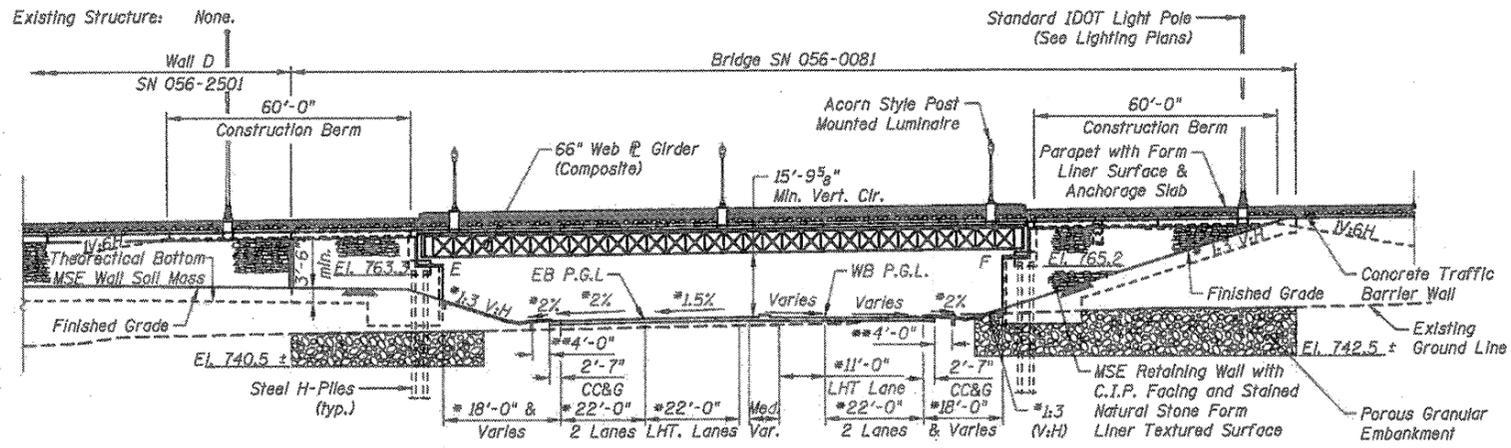


ELEVATION

(Looking West)
 * at Rt. Angles to \odot Algonquin Road
 ** at Rt. Angles to Back of Curb

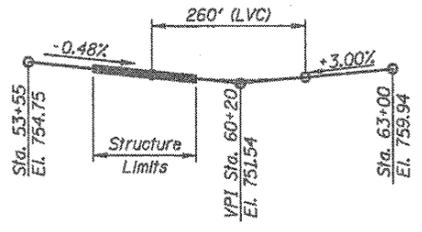


PROPOSED PROFILE WESTBOUND ALGONQUIN ROAD

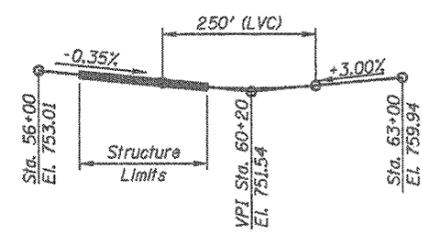

PROPOSED PROFILE EASTBOUND ALGONQUIN ROAD

STATION 132+37.67
 BUILT 2011 BY
 STATE OF ILLINOIS
 O.R. 0003
 SEC 18A-2
 LOADING HL-93
 STRUCTURE NO. 056-0081
NAME PLATE
 See Std. 515001

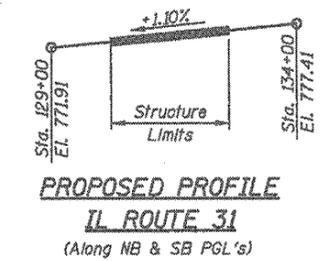

PROPOSED PROFILE IL ROUTE 31
 (Along NB & SB PGL's)

CIVILTECH ENGINEERING, INC.
 GREGORY J. HATLESTAD, S.E.



GREGORY J. HATLESTAD, S.E.
 # 081-005562
 EXP 11/30/12
 DATE 3/15/12

SEISMIC DATA

Seismic Performance Zone (SPZ) = 1
 Design Spectral Acceleration at 1.0 sec. (S_{D1}) = 0.081
 Design Spectral Acceleration at 0.2 sec. (S_{D5}) = 0.142
 Soil Site Class = D

DESIGN SPECIFICATIONS

2010 AASHTO LRFD Bridge Design Specifications

DESIGN STRESSES

FIELD UNITS

f'_c = 3,500 psi
 f_y = 60,000 psi (Reinforcement)
 f_y = 50,000 psi (AASHTO M270 Gr. 50- Main Girders)
 f_y = 36,000 psi (AASHTO M270 Gr. 36- Secondary Members)

LOADING HL-93


Allow 50#/sq. ft. for future wearing surface.

CURVE DATA

Algonquin Road
 Δ = 19° 57' 21.30" (RT)
 D = 7° 17' 37.78"
 T = 138.20'
 L = 273.60'
 E = 12.06'
 R = 785.54'
 $S.E.$ = 2.0%
 $P.C.$ = Sta. 55+55.95
 $P.T.$ = Sta. 58+29.55
 $P.I.$ = Sta. 56+94.15
 SE Runoff = 45' (WB), Sta. 58+15 to 58+60
 $Tangent$ Runout = 45' (WB), Sta. 58+60 to 59+05

APPROVED
 For Structural Adequacy Only


G. Carl Remy
 Engineer of Bridges & Structures

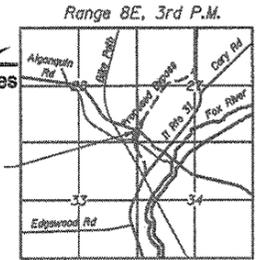

LOCATION SKETCH

**GENERAL PLAN AND ELEVATION
 IL ROUTE 31 OVER ALGONQUIN ROAD
 O.R. 0003 SECTION 18A-2
 McHENRY COUNTY**

STATION 132+37.67, STRUCTURE NO. 056-0081

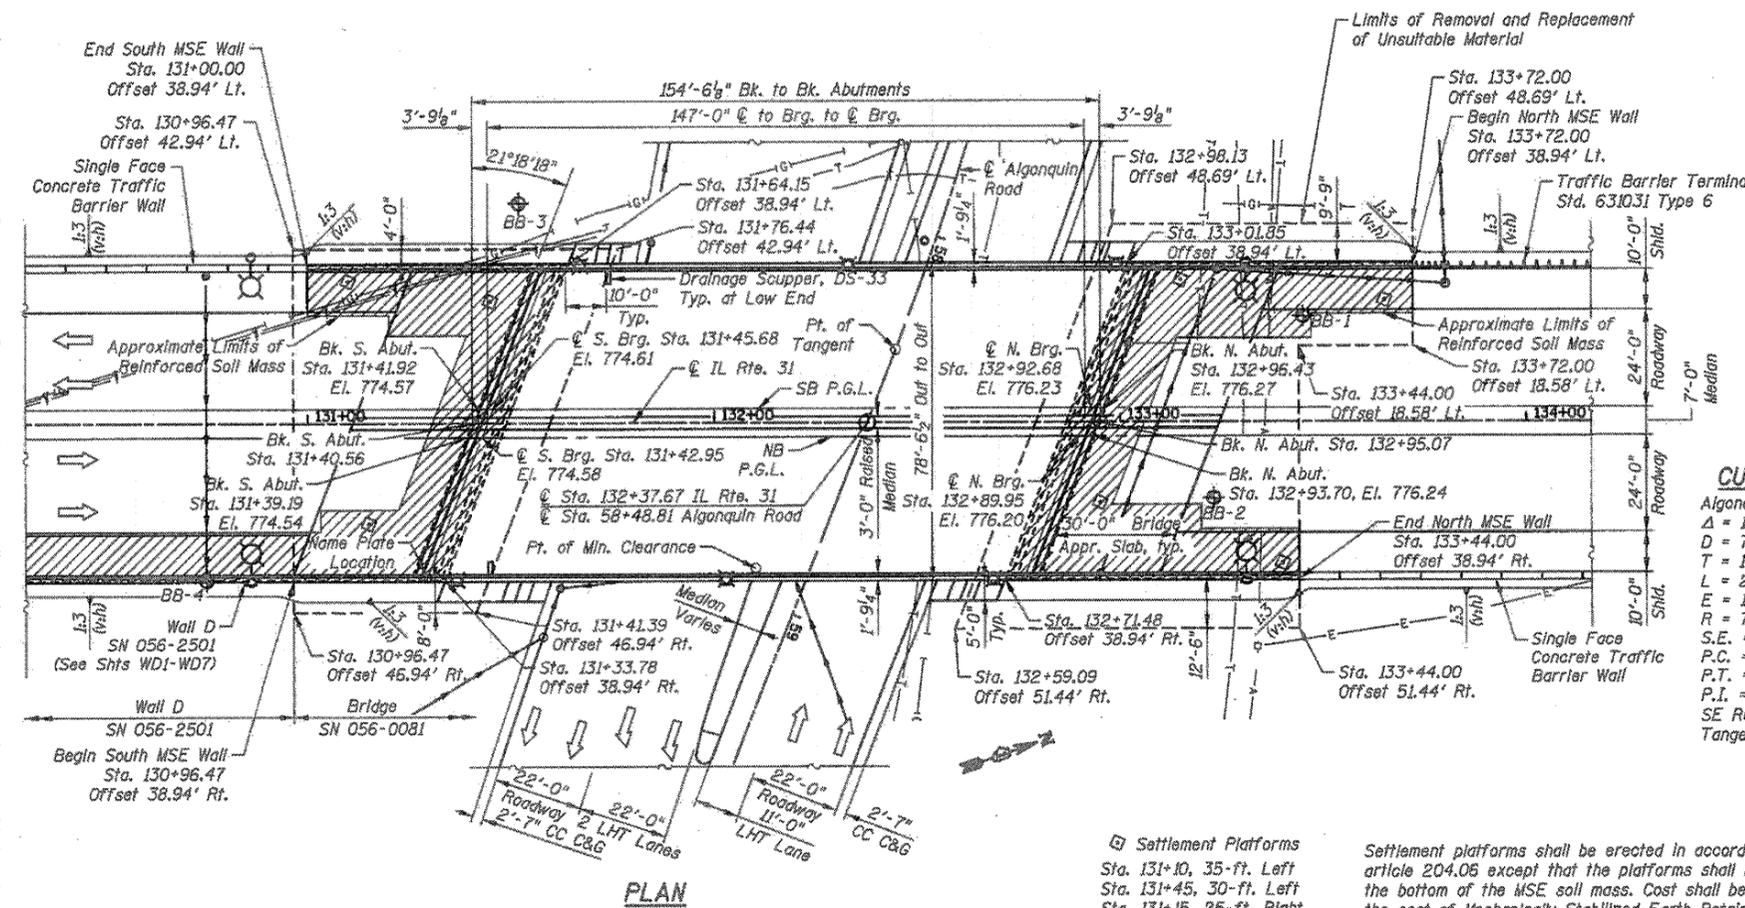

PLAN

Settlement Platforms
 Sta. 131+10, 35-ft. Left
 Sta. 131+45, 30-ft. Left
 Sta. 131+15, 25-ft. Right
 Sta. 131+65, 30-ft. Left
 Sta. 133+15, 35-ft. Left
 Sta. 133+40, 35-ft. Right
 Sta. 132+95, 20-ft. Right

Settlement platforms shall be erected in accordance with article 204.06 except that the platforms shall be placed at the bottom of the MSE soil mass. Cost shall be included in the cost of Mechanically Stabilized Earth Retaining Wall.

Note:
 MSE Wall Offsets measured from \odot IL Rte. 31 to front face of C.I.P. facing.

CIVILTECH
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 Itasca, Illinois 60143
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 www.civiltechinc.com

DRAWN - M. LANGE	REVISED -
DESIGNED - D. ATKINS	REVISED -
CHECKED - G. HATLESTAD	REVISED -
DATE - 3/23/2012	REVISED -

STATE OF ILLINOIS
 DEPARTMENT OF TRANSPORTATION

GENERAL PLAN & ELEVATION
 ILLINOIS ROUTE 31 OVER ALGONQUIN ROAD
 STRUCTURE NO. 056-0081
 SHEET NO. SBI OF SB32 SHEETS

O.R.	SECTION	COUNTY	TOTAL SHEETS	SHEET NO.
0003	18A-2	McHENRY	825	494
				CONTRACT NO. 60F72
ILLINOIS FEDERAL AID PROJECT				

GENERAL NOTES


- Fasteners shall be AASHTO M164 Type 1, mechanically galvanized bolts. Bolts $\frac{7}{8}$ in. ϕ , holes $\frac{15}{16}$ in. ϕ , unless otherwise noted.
- Calculated weight of Structural Steel = 403,690 lbs (AASHTO M270 GR. 50)
Calculated weight of Structural Steel = 29,230 lbs (AASHTO M270 GR. 36)
- No field welding is permitted except as specified in the contract documents.
- Reinforcement bars designated (E) shall be epoxy coated.
- If the Contractor elects to use cantilever forming brackets on the exterior beams or girders, the brackets shall be placed at the same locations as required for the hardwood blocks in Article 503.06(b) of the Standard Specifications. If additional cantilever forming brackets are required, hardwood blocking shall be wedged between the exterior and first interior beam at each of these additional bracket locations.
- Concrete Sealer shall be applied to the designated areas of the backwalls and bridge seats of the abutments.
- The Organic Zinc Rich Primer / Epoxy / Urethane Paint System shall be used for painting of new structural steel except where otherwise noted. The entire system shall be shop applied, with the exception that masked off connection surfaces, field installed fasteners and damaged areas shall be touched up in the field. The color of the final finish coat for all steel surfaces shall be Gray, Munsell No. 5B 7/1.
- The embankment configuration shown shall be the minimum that must be placed and compacted prior to construction of the abutments.
- Sloped wall shall be reinforced with welded wire fabric, 6" x 6" - W4.0 x W4.0, weighing 58 lbs. per 100 sq. ft.
- Neither the MSE wall cast-in-place concrete facing, anchorage slab & parapet, approach slabs, nor approach roadway pavements shall be constructed until after the roadway embankment and reinforced select fill have been in place for 7 $\frac{1}{2}$ months, after which time less than 1 inch of the total anticipated 5 $\frac{3}{4}$ inches settlement is assumed to remain, without the prior approval of the Engineer. The settlement period may be shortened at the discretion of the Engineer if the monitoring data indicates a lesser than predicted settlement.
- Slipforming of the parapets is not allowed.

TOTAL BILL OF MATERIAL

ITEM	UNIT	SUPER	SUB	TOTAL
Porous Granular Embankment	Cu. Yd.	-	4,233	4,233
Removal and Disposal of Unsuitable Materials for Structures	Cu. Yd.	-	4,378	4,378
Concrete Structures	Cu. Yd.	-	246.2	246.2
Concrete Superstructures	Cu. Yd.	706.4	-	706.4
Bridge Deck Grooving	Sq. Yd.	1,705	-	1,705
Form Liner Textured Surface	Sq. Ft.	-	4,511	4,511
Protective Coat	Sq. Yd.	2,142	-	2,142
Furnishing and Erecting Structural Steel	L. Sum	0.36	-	0.36
Stud Shear Connectors	Each	2,400	-	2,400
Reinforcement Bars, Epoxy Coated	Pound	157,850	24,360	182,210
Bar Splicers	Each	-	162	162
Slope Wall 4 Inch	Sq. Yd.	-	317	317
Furnishing Steel Piles HP 14X73	Foot	-	4,080	4,080
Driving piles	Foot	-	4,080	4,080
Test Pile Steel HP 14X73	Each	-	2	2
Pile Shoes	Each	-	50	50
Name Plates	Each	1	-	1
Preformed Joint Strip Seal	Foot	167	-	167
Elastomeric Bearing Assembly, Type I	Each	10	-	10
Anchor Bolts, 1"	Each	20	-	20
Anchor Bolts, 1 $\frac{1}{4}$ "	Each	20	-	20
Concrete Sealer	Sq. Ft.	-	1,380	1,380
Geocomposite Wall Drain	Sq. Yd.	-	53	53
Biaxial Geogrid	Sq. Yd.	-	1,445	1,455
Parapet Railing, Special	Foot	300	-	300
Drainage Scupper, DS-33	Each	2	-	2
Mechanically Stabilized Earth Retaining Wall	Sq. Ft.	-	5,773	5,773
Staining Concrete Structures	Sq. Yd.	-	501	501
Form Liner Textured Surface, Special	Sq. Ft.	688	-	688
Ornamental Aluminum Lattice	Foot	294	-	294

INDEX OF SHEETS

- SB1 General Plan & Elevation
- SB2 General Data
- SB3 Top of Slab Elevations I
- SB4 Top of Slab Elevations II
- SB5 Top of Slab Elevations III
- SB6 Top of Approach Slab Elevations
- SB7 Superstructure
- SB8 Superstructure Details I
- SB9 Superstructure Details II
- SB10 Ornamental Aluminum Lattice
- SB11 Architectural Details
- SB12 Bridge Approach Slab
- SB13 Bridge Approach Slab Details
- SB14 Parapet Railing, Special
- SB15 Preformed Joint Strip Seal
- SB16 Drainage Scuppers, DS-33
- SB17 Framing Plan
- SB18 Plate Girder Details
- SB19 Bearing Details
- SB20 South Abutment
- SB21 North Abutment
- SB22 Abutment Details
- SB23 Pile Details
- SB24 MSE Wall
- SB25 MSE Wall Details
- SB26 Anchorage Slabs
- SB27 Anchorage Slab Details
- SB28 Bar Splicer Assembly Details
- SB29 Boring Logs I
- SB30 Boring Logs II
- SB31 Boring Logs III
- SB32 Boring Logs IV

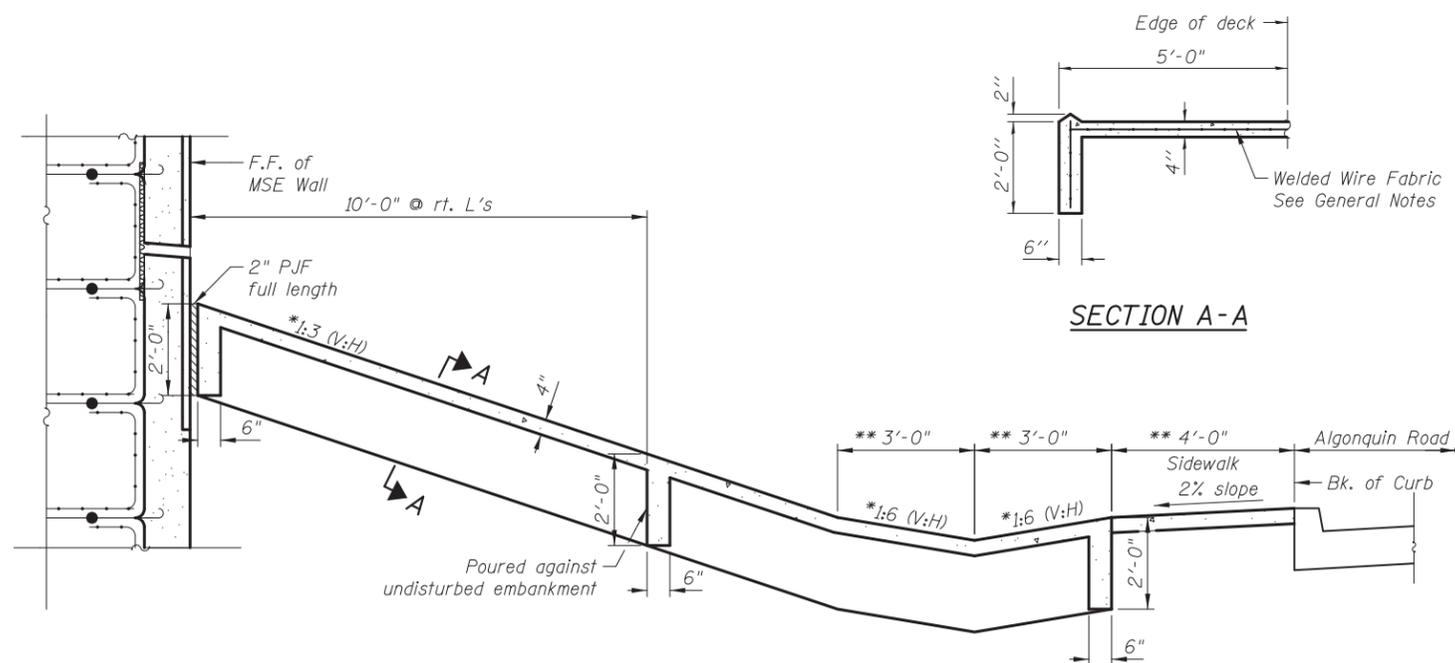

* at Rt. Angles to ϕ Algonquin Road
** at Rt. Angles to Back of Curb

SECTION THRU CONCRETE SLOPEWALL

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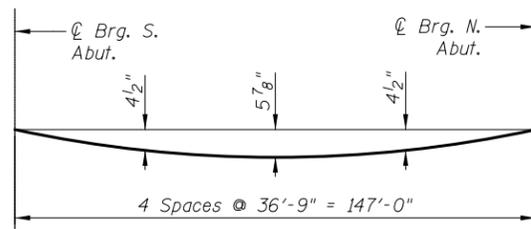
DRAWN - M. LANGE	REVISED - 5/4/12 K.L.B.
DESIGNED - D. ATKINS	REVISED -
CHECKED - G. HATLESTAD	REVISED -
DATE - 5/3/2012	REVISED -

**STATE OF ILLINOIS
DEPARTMENT OF TRANSPORTATION**

**GENERAL DATA
ILLINOIS ROUTE 31 OVER ALGONQUIN ROAD
STRUCTURE NO. 056-0081**

SHEET NO. SB2 OF SB32 SHEETS

O.R. RTE.	SECTION	COUNTY	TOTAL SHEETS	SHEET NO.
0003	18A-2	MCHENRY	825	495
CONTRACT NO. 60F72			ILLINOIS FED. AID PROJECT	




DEAD LOAD DEFLECTION DIAGRAM

(Includes weight of concrete only.)

Note:

The above deflections are not for use in the field if the Engineer is working from the Theoretical Grade Elevations Adjusted for Dead Load Deflection as shown on SB4 and SB5.

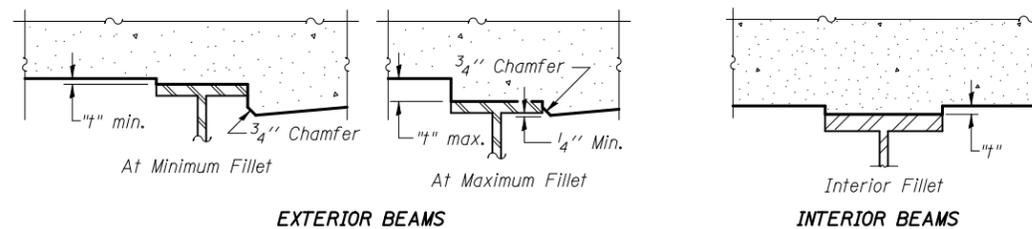


EXTERIOR BEAMS

INTERIOR BEAMS

To determine "t": After all structural steel has been erected, elevations of the top flanges of the beams shall be taken at intervals shown below. These elevations subtracted from the "Theoretical Grade Elevations Adjusted for Dead Load Deflection" shown on SB4 & SB5, minus slab thickness, equals the fillet heights "t" above top flange of beams.

FILLET HEIGHTS

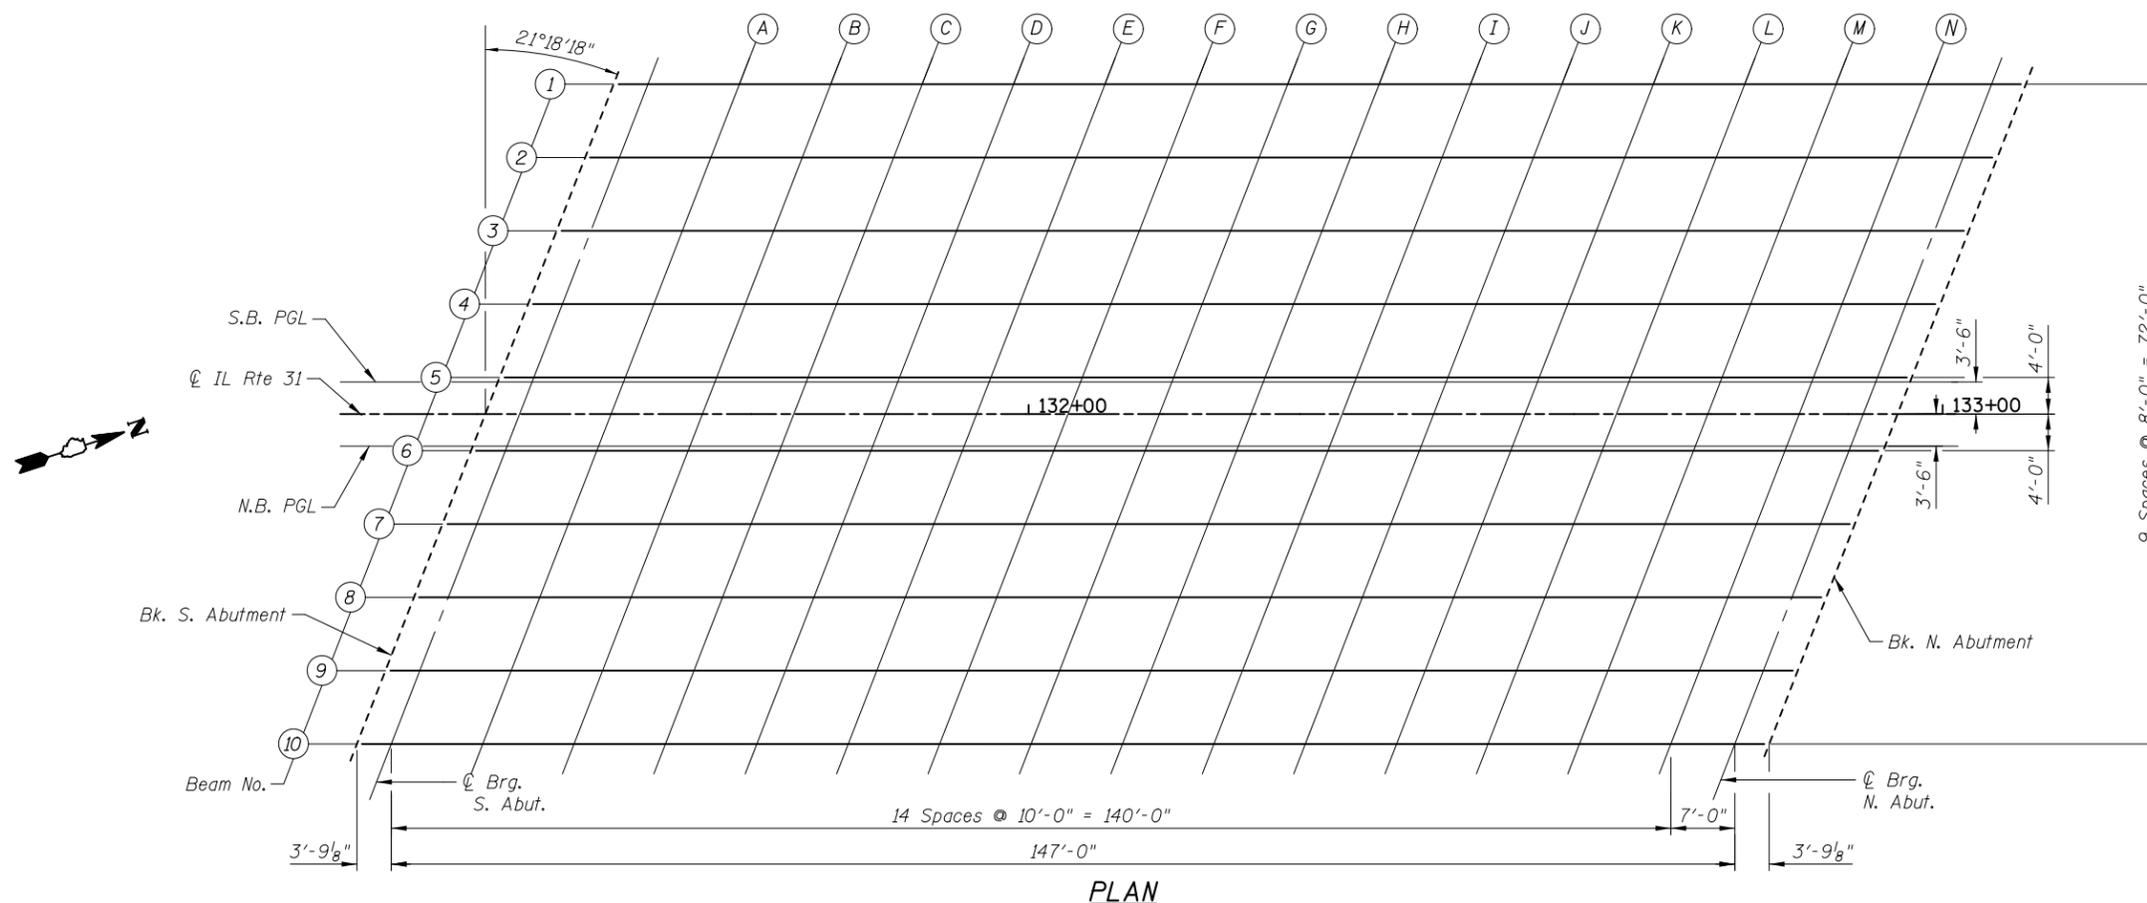

PLAN

5/2/2012 4:17:48 PM I:\2154\cad\sheet\Roadway\20-Structures & Walls\02-SN 056-008\056008-60F72-03-TSE.dgn

DRAWN	- M. LANGE	REVISED	-
DESIGNED	- D. ATKINS	REVISED	-
CHECKED	- G. HATLESTAD	REVISED	-
DATE	- 5/3/2012	REVISED	-

O.R. RTE.	SECTION	COUNTY	TOTAL SHEETS	SHEET NO.
0003	18A-2	MCHENRY	825	496
CONTRACT NO. 60F72				
ILLINOIS FED. AID PROJECT				

BEAM 1

Location	Station	Offset	Theoretical Grade Elevation	Theoretical Grade Elev Adj for Dead Load Deflection
Bk. S Abut.	131+54.59	-36.00	774.03	774.03
⊕ Brg. S Abut.	131+58.35	-36.00	774.07	774.07
A	131+68.35	-36.00	774.18	774.29
B	131+78.35	-36.00	774.29	774.50
C	131+88.35	-36.00	774.40	774.71
D	131+98.35	-36.00	774.51	774.89
E	132+08.35	-36.00	774.62	775.05
F	132+18.35	-36.00	774.73	775.21
G	132+28.35	-36.00	774.84	775.33
H	132+38.35	-36.00	774.95	775.44
I	132+48.35	-36.00	775.06	775.53
J	132+58.35	-36.00	775.17	775.59
K	132+68.35	-36.00	775.28	775.64
L	132+78.35	-36.00	775.39	775.67
M	132+88.35	-36.00	775.50	775.69
N	132+98.35	-36.00	775.61	775.69
⊕ Brg. N Abut.	133+05.35	-36.00	775.69	775.69
Bk. N Abut.	133+09.11	-36.00	775.73	775.73

BEAM 2

Location	Station	Offset	Theoretical Grade Elevation	Theoretical Grade Elev Adj for Dead Load Deflection
Bk. S Abut.	131+51.47	-28.00	774.17	774.17
⊕ Brg. S Abut.	131+55.23	-28.00	774.21	774.21
A	131+65.23	-28.00	774.32	774.43
B	131+75.23	-28.00	774.43	774.64
C	131+85.23	-28.00	774.54	774.84
D	131+95.23	-28.00	774.65	775.02
E	132+05.23	-28.00	774.76	775.19
F	132+15.23	-28.00	774.87	775.34
G	132+25.23	-28.00	774.98	775.46
H	132+35.23	-28.00	775.09	775.57
I	132+45.23	-28.00	775.20	775.66
J	132+55.23	-28.00	775.31	775.72
K	132+65.23	-28.00	775.42	775.77
L	132+75.23	-28.00	775.53	775.80
M	132+85.23	-28.00	775.64	775.82
N	132+95.23	-28.00	775.75	775.82
⊕ Brg. N Abut.	133+02.23	-28.00	775.82	775.82
Bk. N Abut.	133+05.99	-28.00	775.87	775.87

BEAM 3

Location	Station	Offset	Theoretical Grade Elevation	Theoretical Grade Elev Adj for Dead Load Deflection
Bk. S Abut.	131+48.35	-20.00	774.30	774.30
⊕ Brg. S Abut.	131+52.11	-20.00	774.34	774.34
A	131+62.11	-20.00	774.45	774.56
B	131+72.11	-20.00	774.56	774.77
C	131+82.11	-20.00	774.67	774.97
D	131+92.11	-20.00	774.78	775.15
E	132+02.11	-20.00	774.89	775.32
F	132+12.11	-20.00	775.00	775.47
G	132+22.11	-20.00	775.11	775.60
H	132+32.11	-20.00	775.22	775.70
I	132+42.11	-20.00	775.33	775.79
J	132+52.11	-20.00	775.44	775.86
K	132+62.11	-20.00	775.55	775.90
L	132+72.11	-20.00	775.66	775.94
M	132+82.11	-20.00	775.77	775.95
N	132+92.11	-20.00	775.88	775.96
⊕ Brg. N Abut.	132+99.11	-20.00	775.96	775.96
Bk. N Abut.	133+02.87	-20.00	776.00	776.00

BEAM 4

Location	Station	Offset	Theoretical Grade Elevation	Theoretical Grade Elev Adj for Dead Load Deflection
Bk. S Abut.	131+45.23	-12.00	774.43	774.43
⊕ Brg. S Abut.	131+48.99	-12.00	774.47	774.47
A	131+58.99	-12.00	774.58	774.69
B	131+68.99	-12.00	774.69	774.90
C	131+78.99	-12.00	774.80	775.10
D	131+88.99	-12.00	774.91	775.29
E	131+98.99	-12.00	775.02	775.45
F	132+08.99	-12.00	775.13	775.60
G	132+18.99	-12.00	775.24	775.73
H	132+28.99	-12.00	775.35	775.83
I	132+38.99	-12.00	775.46	775.92
J	132+48.99	-12.00	775.57	775.99
K	132+58.99	-12.00	775.68	776.03
L	132+68.99	-12.00	775.79	776.07
M	132+78.99	-12.00	775.90	776.08
N	132+88.99	-12.00	776.01	776.09
⊕ Brg. N Abut.	132+95.99	-12.00	776.09	776.09
Bk. N Abut.	132+99.75	-12.00	776.13	776.13

BEAM 5

Location	Station	Offset	Theoretical Grade Elevation	Theoretical Grade Elev Adj for Dead Load Deflection
Bk. S Abut.	131+42.11	-4.00	774.56	774.56
⊕ Brg. S Abut.	131+45.87	-4.00	774.60	774.60
A	131+55.87	-4.00	774.71	774.82
B	131+65.87	-4.00	774.82	775.03
C	131+75.87	-4.00	774.93	775.24
D	131+85.87	-4.00	775.04	775.42
E	131+95.87	-4.00	775.15	775.58
F	132+05.87	-4.00	775.26	775.74
G	132+15.87	-4.00	775.37	775.86
H	132+25.87	-4.00	775.48	775.97
I	132+35.87	-4.00	775.59	776.06
J	132+45.87	-4.00	775.70	776.12
K	132+55.87	-4.00	775.81	776.17
L	132+65.87	-4.00	775.92	776.20
M	132+75.87	-4.00	776.03	776.22
N	132+85.87	-4.00	776.14	776.22
⊕ Brg. N Abut.	132+92.87	-4.00	776.22	776.22
Bk. N Abut.	132+96.63	-4.00	776.26	776.26

SB PGL

Location	Station	Offset	Theoretical Grade Elevation	Theoretical Grade Elev Adj for Dead Load Deflection
Bk. S Abut.	131+41.92	-3.50	774.57	774.57
⊕ Brg. S Abut.	131+45.68	-3.50	774.61	774.61
A	131+55.68	-3.50	774.72	774.83
B	131+65.68	-3.50	774.83	775.04
C	131+75.68	-3.50	774.94	775.25
D	131+85.68	-3.50	775.05	775.43
E	131+95.68	-3.50	775.16	775.59
F	132+05.68	-3.50	775.27	775.74
G	132+15.68	-3.50	775.38	775.87
H	132+25.68	-3.50	775.49	775.97
I	132+35.68	-3.50	775.60	776.06
J	132+45.68	-3.50	775.71	776.13
K	132+55.68	-3.50	775.82	776.18
L	132+65.68	-3.50	775.93	776.21
M	132+75.68	-3.50	776.04	776.22
N	132+85.68	-3.50	776.15	776.23
⊕ Brg. N Abut.	132+92.68	-3.50	776.23	776.23
Bk. N Abut.	132+96.43	-3.50	776.27	776.27

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NB PGL

Location	Station	Offset	Theoretical Grade Elevation	Theoretical Grade Elev Adj for Dead Load Deflection
Bk. S Abut.	131+39.19	3.50	774.54	774.54
⊕ Brg. S Abut.	131+42.95	3.50	774.58	774.58
A	131+52.95	3.50	774.69	774.80
B	131+62.95	3.50	774.80	775.01
C	131+72.95	3.50	774.91	775.22
D	131+82.95	3.50	775.02	775.40
E	131+92.95	3.50	775.13	775.56
F	132+02.95	3.50	775.24	775.71
G	132+12.95	3.50	775.35	775.84
H	132+22.95	3.50	775.46	775.94
I	132+32.95	3.50	775.57	776.03
J	132+42.95	3.50	775.68	776.10
K	132+52.95	3.50	775.79	776.15
L	132+62.95	3.50	775.90	776.18
M	132+72.95	3.50	776.01	776.19
N	132+82.95	3.50	776.12	776.20
⊕ Brg. N Abut.	132+89.95	3.50	776.20	776.20
Bk. N Abut.	132+93.70	3.50	776.24	776.24

BEAM 6

Location	Station	Offset	Theoretical Grade Elevation	Theoretical Grade Elev Adj for Dead Load Deflection
Bk. S Abut.	131+39.00	4.00	774.53	774.53
⊕ Brg. S Abut.	131+42.75	4.00	774.57	774.57
A	131+52.75	4.00	774.68	774.79
B	131+62.75	4.00	774.79	775.00
C	131+72.75	4.00	774.90	775.20
D	131+82.75	4.00	775.01	775.38
E	131+92.75	4.00	775.12	775.55
F	132+02.75	4.00	775.23	775.70
G	132+12.75	4.00	775.34	775.83
H	132+22.75	4.00	775.45	775.93
I	132+32.75	4.00	775.56	776.02
J	132+42.75	4.00	775.67	776.09
K	132+52.75	4.00	775.78	776.13
L	132+62.75	4.00	775.89	776.17
M	132+72.75	4.00	776.00	776.18
N	132+82.75	4.00	776.11	776.19
⊕ Brg. N Abut.	132+89.75	4.00	776.19	776.19
Bk. N Abut.	132+93.51	4.00	776.23	776.23

BEAM 7

Location	Station	Offset	Theoretical Grade Elevation	Theoretical Grade Elev Adj for Dead Load Deflection
Bk. S Abut.	131+35.88	12.00	774.33	774.33
⊕ Brg. S Abut.	131+39.63	12.00	774.37	774.37
A	131+49.63	12.00	774.48	774.59
B	131+59.63	12.00	774.59	774.80
C	131+69.63	12.00	774.70	775.00
D	131+79.63	12.00	774.81	775.18
E	131+89.63	12.00	774.92	775.35
F	131+99.63	12.00	775.03	775.50
G	132+09.63	12.00	775.14	775.63
H	132+19.63	12.00	775.25	775.73
I	132+29.63	12.00	775.36	775.82
J	132+39.63	12.00	775.47	775.89
K	132+49.63	12.00	775.58	775.93
L	132+59.63	12.00	775.69	775.96
M	132+69.63	12.00	775.80	775.98
N	132+79.63	12.00	775.91	775.98
⊕ Brg. N Abut.	132+86.63	12.00	775.99	775.99
Bk. N Abut.	132+90.39	12.00	776.03	776.03

BEAM 8

Location	Station	Offset	Theoretical Grade Elevation	Theoretical Grade Elev Adj for Dead Load Deflection
Bk. S Abut.	131+32.76	20.00	774.13	774.13
⊕ Brg. S Abut.	131+36.51	20.00	774.17	774.17
A	131+46.51	20.00	774.28	774.39
B	131+56.51	20.00	774.39	774.60
C	131+66.51	20.00	774.50	774.80
D	131+76.51	20.00	774.61	774.98
E	131+86.51	20.00	774.72	775.15
F	131+96.51	20.00	774.83	775.30
G	132+06.51	20.00	774.94	775.42
H	132+16.51	20.00	775.05	775.53
I	132+26.51	20.00	775.16	775.62
J	132+36.51	20.00	775.27	775.68
K	132+46.51	20.00	775.38	775.73
L	132+56.51	20.00	775.49	775.76
M	132+66.51	20.00	775.60	775.78
N	132+76.51	20.00	775.71	775.78
⊕ Brg. N Abut.	132+83.51	20.00	775.78	775.78
Bk. N Abut.	132+87.27	20.00	775.83	775.83


BEAM 9

Location	Station	Offset	Theoretical Grade Elevation	Theoretical Grade Elev Adj for Dead Load Deflection
Bk. S Abut.	131+29.64	28.00	773.93	773.93
⊕ Brg. S Abut.	131+33.39	28.00	773.97	773.97
A	131+43.39	28.00	774.08	774.19
B	131+53.39	28.00	774.19	774.40
C	131+63.39	28.00	774.30	774.60
D	131+73.39	28.00	774.41	774.78
E	131+83.39	28.00	774.52	774.95
F	131+93.39	28.00	774.63	775.10
G	132+03.39	28.00	774.74	775.22
H	132+13.39	28.00	774.85	775.33
I	132+23.39	28.00	774.96	775.42
J	132+33.39	28.00	775.07	775.48
K	132+43.39	28.00	775.18	775.53
L	132+53.39	28.00	775.29	775.56
M	132+63.39	28.00	775.40	775.58
N	132+73.39	28.00	775.51	775.58
⊕ Brg. N Abut.	132+80.39	28.00	775.58	775.58
Bk. N Abut.	132+84.15	28.00	775.63	775.63

BEAM 10

Location	Station	Offset	Theoretical Grade Elevation	Theoretical Grade Elev Adj for Dead Load Deflection
Bk. S Abut.	131+26.52	36.00	773.72	773.72
⊕ Brg. S Abut.	131+30.27	36.00	773.77	773.77
A	131+40.27	36.00	773.88	773.98
B	131+50.27	36.00	773.99	774.20
C	131+60.27	36.00	774.10	774.40
D	131+70.27	36.00	774.21	774.58
E	131+80.27	36.00	774.32	774.75
F	131+90.27	36.00	774.43	774.90
G	132+00.27	36.00	774.54	775.02
H	132+10.27	36.00	774.65	775.13
I	132+20.27	36.00	774.76	775.22
J	132+30.27	36.00	774.87	775.28
K	132+40.27	36.00	774.98	775.33
L	132+50.27	36.00	775.09	775.36
M	132+60.27	36.00	775.20	775.38
N	132+70.27	36.00	775.31	775.38
⊕ Brg. N Abut.	132+77.27	36.00	775.38	775.38
Bk. N Abut.	132+81.03	36.00	775.42	775.42

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PLAN

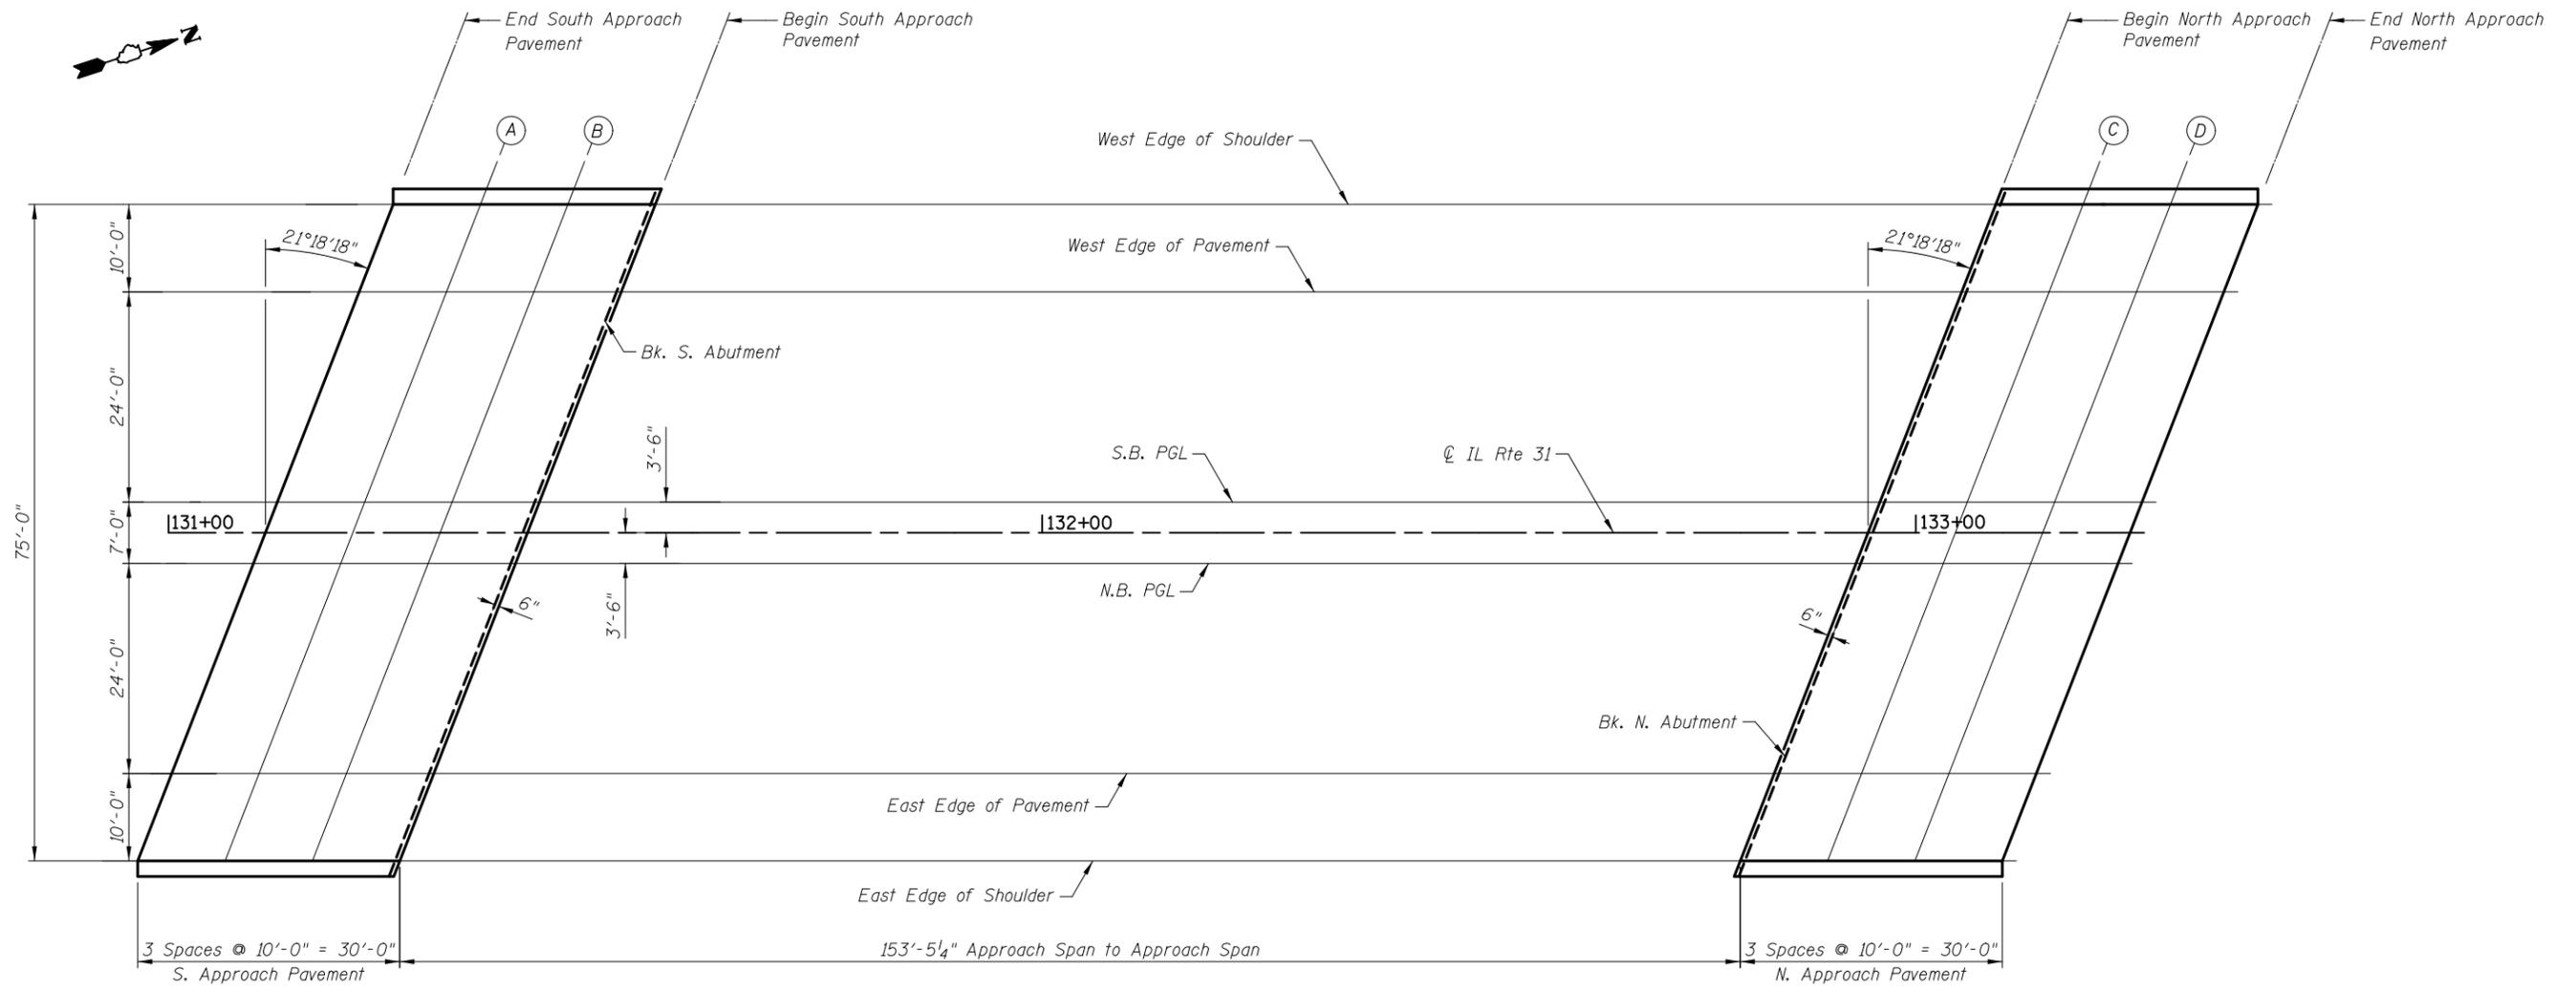WEST EDGE OF SHOULDER

Location	Station	Offset	Theoretical Grade Elevations
End S. Appr. Pav't	131+25.72	-37.50	773.68
A	131+35.72	-37.50	773.79
B	131+45.72	-37.50	773.90
Begin S. Appr. Pav't	131+55.72	-37.50	774.01
Begin N. Appr. Pav't	133+09.16	-37.50	775.70
C	133+19.16	-37.50	775.81
D	133+29.16	-37.50	775.92
End N. Appr. Pav't	133+39.16	-37.50	776.03

WEST EDGE OF PAVEMENT

Location	Station	Offset	Theoretical Grade Elevations
End S. Appr. Pav't	131+21.82	-27.50	773.85
A	131+31.82	-27.50	773.96
B	131+41.82	-27.50	774.07
Begin S. Appr. Pav't	131+51.82	-27.50	774.18
Begin N. Appr. Pav't	133+05.26	-27.50	775.87
C	133+15.26	-27.50	775.98
D	133+25.26	-27.50	776.09
End N. Appr. Pav't	133+35.26	-27.50	776.20

SOUTHBOUND PGL

Location	Station	Offset	Theoretical Grade Elevations
End S. Appr. Pav't	131+12.46	-3.50	774.25
A	131+22.46	-3.50	774.36
B	131+32.46	-3.50	774.47
Begin S. Appr. Pav't	131+42.46	-3.50	774.58
Begin N. Appr. Pav't	132+95.90	-3.50	776.26
C	133+05.90	-3.50	776.37
D	133+15.90	-3.50	776.48
End N. Appr. Pav't	133+25.90	-3.50	776.59

NORTHBOUND PGL

Location	Station	Offset	Theoretical Grade Elevations
End S. Appr. Pav't	131+09.73	3.50	774.22
A	131+19.73	3.50	774.33
B	131+29.73	3.50	774.44
Begin S. Appr. Pav't	131+39.73	3.50	774.55
Begin N. Appr. Pav't	132+93.17	3.50	776.23
C	133+03.17	3.50	776.34
D	133+13.17	3.50	776.45
End N. Appr. Pav't	133+23.17	3.50	776.56


EAST EDGE OF PAVEMENT

Location	Station	Offset	Theoretical Grade Elevations
End S. Appr. Pav't	131+00.37	27.50	773.61
A	131+10.37	27.50	773.72
B	131+20.37	27.50	773.83
Begin S. Appr. Pav't	131+30.37	27.50	773.94
Begin N. Appr. Pav't	132+83.81	27.50	775.63
C	132+93.81	27.50	775.74
D	133+03.81	27.50	775.85
End N. Appr. Pav't	133+13.81	27.50	775.96

EAST EDGE OF SHOULDER


Location	Station	Offset	Theoretical Grade Elevations
End S. Appr. Pav't	130+96.47	37.50	773.36
A	131+06.47	37.50	773.47
B	131+16.47	37.50	773.58
Begin S. Appr. Pav't	131+26.47	37.50	773.69
Begin N. Appr. Pav't	132+79.91	37.50	775.38
C	132+89.91	37.50	775.49
D	132+99.91	37.50	775.60
End N. Appr. Pav't	133+09.91	37.50	775.71

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PLAN

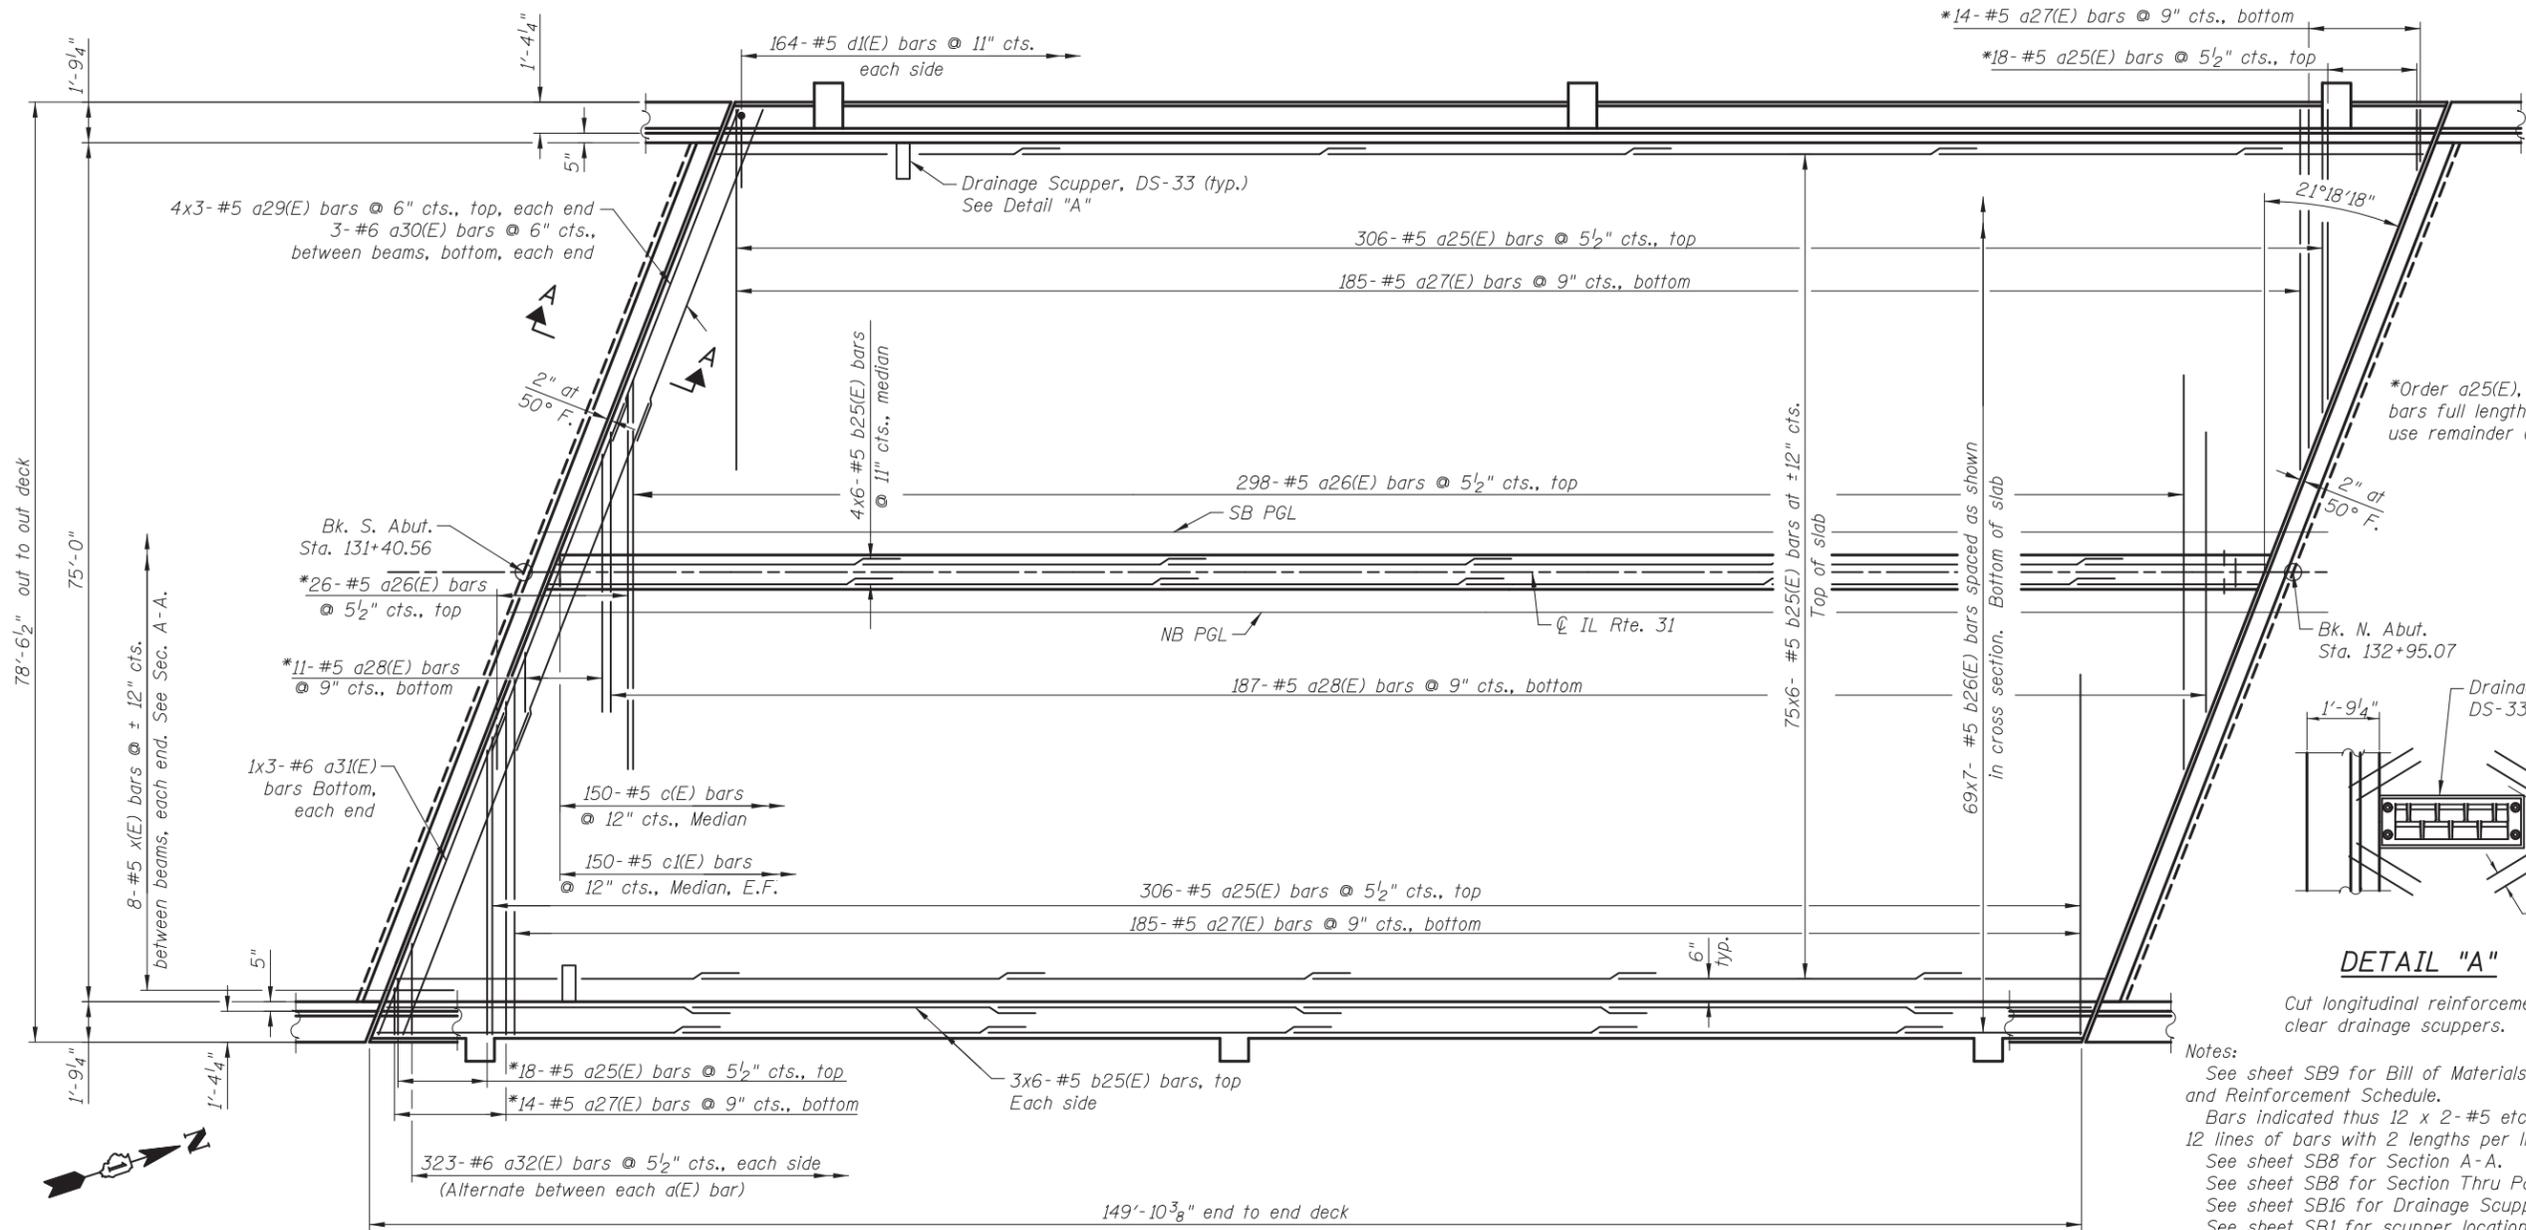*Order a25(E), a27(E), a27(E), & a28(E) bars full length. Cut to fit skew and use remainder of bars in opposite end.




DETAIL "A"

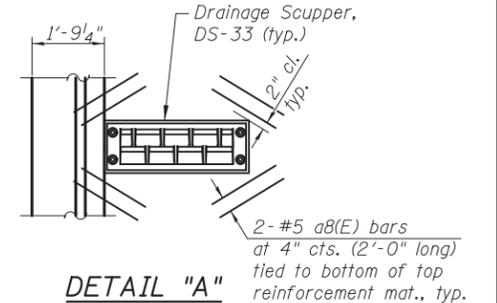Cut longitudinal reinforcement to clear drainage scuppers.

Notes:
 See sheet SB9 for Bill of Materials, Bar Diagrams and Reinforcement Schedule.
 Bars indicated thus 12 x 2-#5 etc. indicates 12 lines of bars with 2 lengths per line.
 See sheet SB8 for Section A-A.
 See sheet SB8 for Section Thru Parapet.
 See sheet SB16 for Drainage Scupper DS-33 details.
 See sheet SB1 for scupper locations.
 Dimensions are based on a Rolled Rail Strip Seal Joint. If the Contractor elects to use the Welded Rail Strip Seal Joint, deck dimensions may require adjustments to satisfy the details on sheet SB15.

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CROSS SECTION

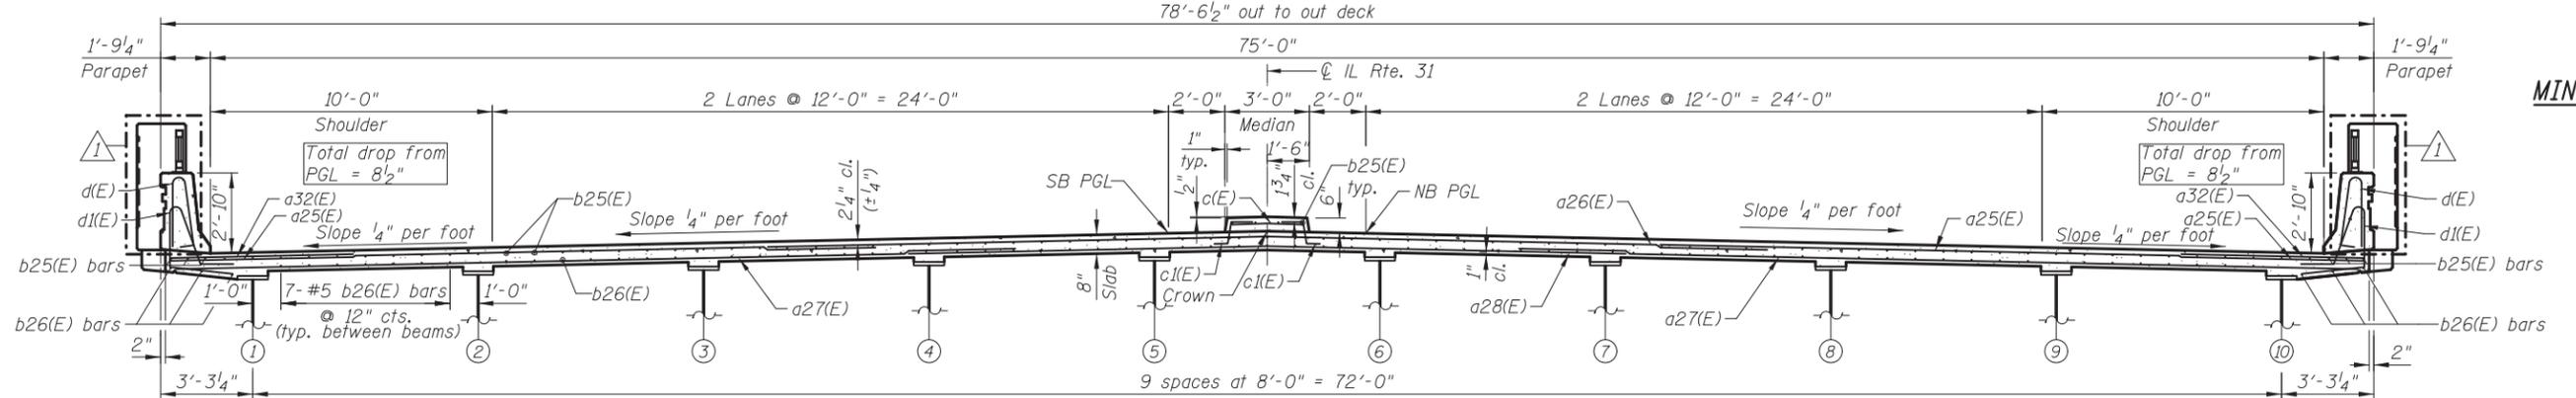(Looking North)
(Drainage Scuppers not shown)

MINIMUM BAR LAP

(Deck)
 #5 bar = 3'-3"
 #6 bar = 3'-10"

CIVILTECH
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 Itasca, Illinois 60143
 Tel: 630.773.3900 Fax: 630.773.3975
 www.civiltechinc.com

DRAWN	- M. LANGE	REVISED	- 5/4/12 K.L.B.
DESIGNED	- D. ATKINS	REVISED	-
CHECKED	- G. HATLESTAD	REVISED	-
DATE	- 5/3/2012	REVISED	-

STATE OF ILLINOIS
DEPARTMENT OF TRANSPORTATION

SUPERSTRUCTURE
ILLINOIS ROUTE 31 OVER ALGONQUIN ROAD
STRUCTURE NO. 056-0081
 SHEET NO. SB7 OF SB32 SHEETS

O.R. RTE.	SECTION	COUNTY	TOTAL SHEETS	SHEET NO.
0003	18A-2	MCHENRY	825	500
CONTRACT NO. 60F72				
ILLINOIS FED. AID PROJECT				