

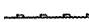
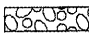

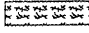
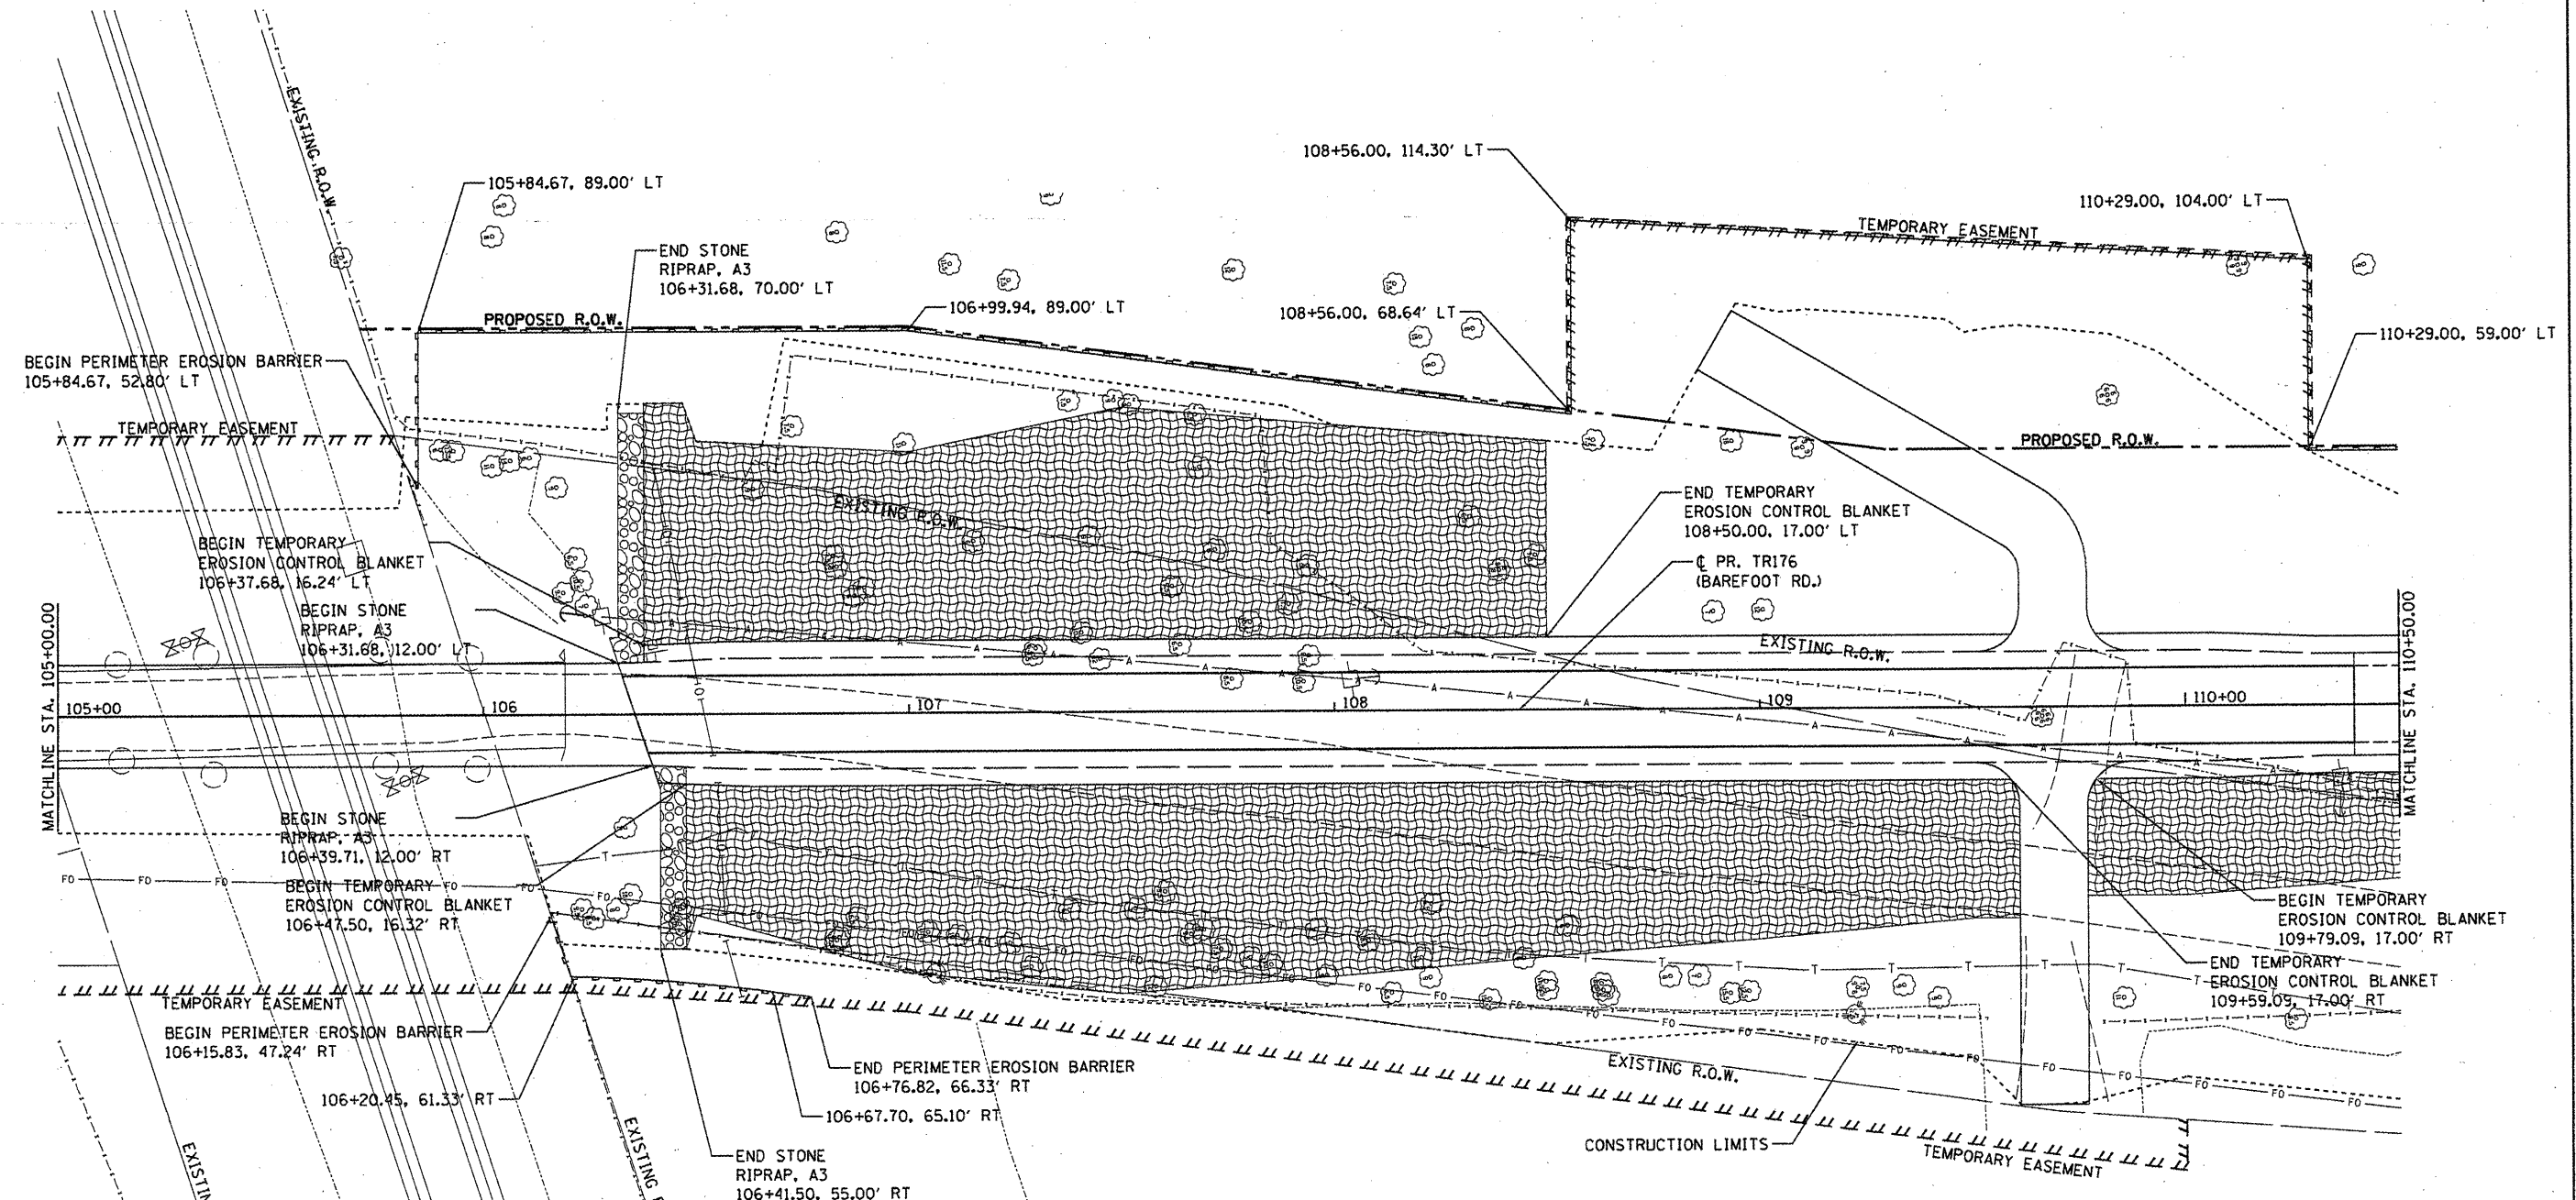


LEGEND

-  INLET AND PIPE PROTECTION
-  TEMPORARY DITCH CHECK
-  PERIMETER EROSION BARRIER
-  STONE RIPRAP
-  TEMPORARY EROSION CONTROL BLANKET
-  TURF REINFORCEMENT MAT



NOTES

1. ALL DISTURBED AREAS NOT COVERED BY RIPRAP SHALL BE SEEDED AND MULCHED. SLOPES STEEPER THAN 1:3 SHALL RECEIVE SEEDING CLASS 3A AND MULCH METHOD 2. REMAINING SLOPES SHALL RECEIVE SEEDING CLASS 2A AND MULCH METHOD 2

FILE NAME =	USER NAME = daws00076	DESIGNED MGD	REVISED -
or\pwise_work\do_not_delete\dms27369\10-22-2012		DRAWN DLC	REVISED -
PLOT SCALE = 40.0000' / in.		CHECKED CAL	REVISED -
PLOT DATE = 02/02/2012		DATE 1/12/12	REVISED -

**STATE OF ILLINOIS
DEPARTMENT OF TRANSPORTATION**

**TR 176 (BAREFOOT ROAD)
EROSION CONTROL PLAN**

SCALE: 1"=20' SHEET NO. OF SHEETS STA. TO STA.

F.A. RTE.	SECTION	COUNTY	TOTAL SHEETS	SHEET NO.
TR176	05-15103-00-BR	KNOX	97	18
	05-15106-01-BR			
CONTRACT NO. 89429				
ILLINOIS FED. AID PROJECT BROS 0095 (120)				