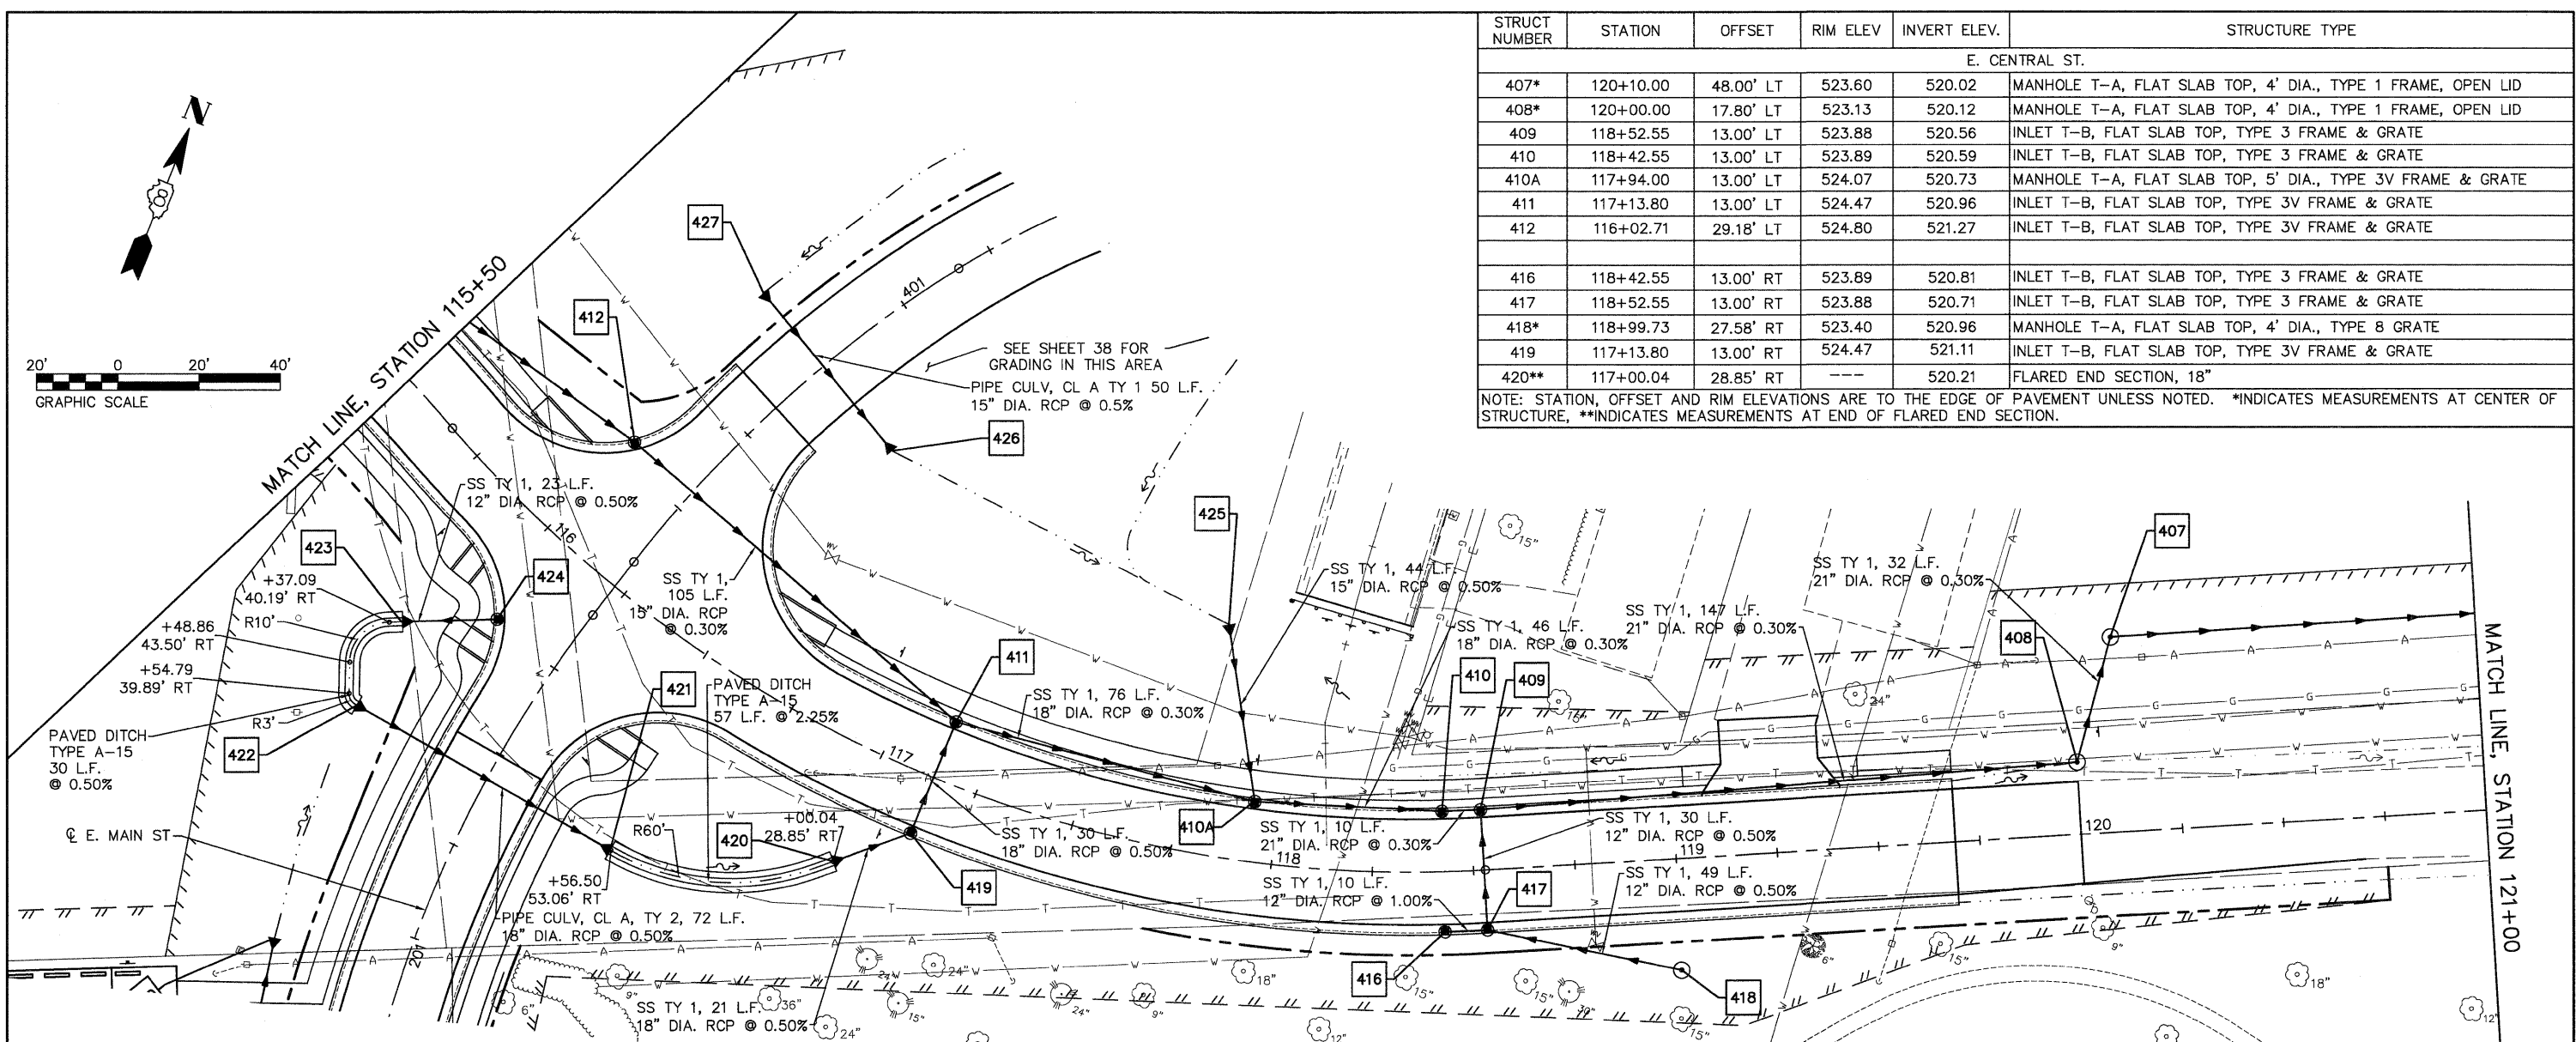


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STRUCT NUMBER	STATION	OFFSET	RIM ELEV.	INVERT ELEV.	STRUCTURE TYPE
E. CENTRAL ST.					
407*	120+10.00	48.00' LT	523.60	520.02	MANHOLE T-A, FLAT SLAB TOP, 4' DIA., TYPE 1 FRAME, OPEN LID
408*	120+00.00	17.80' LT	523.13	520.12	MANHOLE T-A, FLAT SLAB TOP, 4' DIA., TYPE 1 FRAME, OPEN LID
409	118+52.55	13.00' LT	523.88	520.56	INLET T-B, FLAT SLAB TOP, TYPE 3 FRAME & GRATE
410	118+42.55	13.00' LT	523.89	520.59	INLET T-B, FLAT SLAB TOP, TYPE 3 FRAME & GRATE
410A	117+94.00	13.00' LT	524.07	520.73	MANHOLE T-A, FLAT SLAB TOP, 5' DIA., TYPE 3V FRAME & GRATE
411	117+13.80	13.00' LT	524.47	520.96	INLET T-B, FLAT SLAB TOP, TYPE 3V FRAME & GRATE
412	116+02.71	29.18' LT	524.80	521.27	INLET T-B, FLAT SLAB TOP, TYPE 3V FRAME & GRATE
416	118+42.55	13.00' RT	523.89	520.81	INLET T-B, FLAT SLAB TOP, TYPE 3 FRAME & GRATE
417	118+52.55	13.00' RT	523.88	520.71	INLET T-B, FLAT SLAB TOP, TYPE 3 FRAME & GRATE
418*	118+99.73	27.58' RT	523.40	520.96	MANHOLE T-A, FLAT SLAB TOP, 4' DIA., TYPE 8 GRATE
419	117+13.80	13.00' RT	524.47	521.11	INLET T-B, FLAT SLAB TOP, TYPE 3V FRAME & GRATE
420**	117+00.04	28.85' RT	---	520.21	FLARED END SECTION, 18"

NOTE: STATION, OFFSET AND RIM ELEVATIONS ARE TO THE EDGE OF PAVEMENT UNLESS NOTED. *INDICATES MEASUREMENTS AT CENTER OF STRUCTURE, **INDICATES MEASUREMENTS AT END OF FLARED END SECTION.

STRUCT NUMBER	STATION	OFFSET	RIM ELEV.	INVERT ELEV.	STRUCTURE TYPE	
E. MAIN ST.						
540	421**	200+57.93	35.09' LT	---	521.48	FLARED END SECTION, 18"
540	422**	200+56.24	36.79' RT	---	521.84	FLARED END SECTION, 18"
540	423**	200+35.49	37.49' RT	---	521.99	FLARED END SECTION, 12"
535	424	200+22.28	16.87' RT	524.81	522.11	INLET T-B, FLAT SLAB TOP, TYPE 3V FRAME & GRATE
NOTE: STATION, OFFSET AND RIM ELEVATIONS ARE TO THE EDGE OF PAVEMENT UNLESS NOTED. *INDICATES MEASUREMENTS AT CENTER OF STRUCTURE, **INDICATES MEASUREMENTS AT END OF FLARED END SECTION.						
LONGFELLOW ST.						
540	425**	117+79.32	56.85' LT	---	520.95	FLARED END SECTION, 15"
540	426**	400+75.00	26.70' RT	---	521.72	FLARED END SECTION, 15"
540	427**	400+75.00	23.12' LT	---	521.97	FLARED END SECTION, 15"
NOTE: STATION, OFFSET AND RIM ELEVATIONS ARE TO THE EDGE OF PAVEMENT UNLESS NOTED. *INDICATES MEASUREMENTS AT CENTER OF STRUCTURE, **INDICATES MEASUREMENTS AT END OF FLARED END SECTION.						

08026-Sht-Drain.dwg	USER NAME = Robert Watson	DESIGNED - M.J.R.	REVISED -	STATE OF ILLINOIS DEPARTMENT OF TRANSPORTATION	DRAINAGE AND UTILITY PLAN	F.A.U. RTE. 8959	SECTION 08-00026-00-WR	COUNTY MADISON	TOTAL SHEETS 62	SHEET NO. 35		
PLOT SCALE = 1:1						CHECKED - E.R.O.	REVISED -	CONTRACT NO. 97493				
PLOT DATE = 2/4/2012						DATE - 3/21/12	REVISED -	SCALE: 1:20H, 1:5V SHEET NO. 35 OF 62 SHEETS STA. 115+50 TO STA. 121+00				
								BETHALTO ILLINOIS FED. AID PROJECT				