06-15-2018 LETTING ITEM 012

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FOR INDEX OF SHEETS & HIGHWAY STANDARDS, SEE SHEET NO. 2

IMPROVEMENT IS LOCATED IN THE CITY OF DES PLAINES

TRAFFIC DATA


2017 ADT = 1550 POSTED SPEED LIMIT = 35 MPH


STATE OF ILLINOIS DEPARTMENT OF TRANSPORTATION

PROPOSED HIGHWAY PLANS


F.A.U. ROUTE 3512 (BUSSE HWY) AT PRAIRIE CREEK (0.4 MILES SE OF US 14) SECTION 3216B-BR(16) PROJECT STP 4W1D (107) BRIDGE DECK OVERLAY COOK COUNTY

C-91-014-17

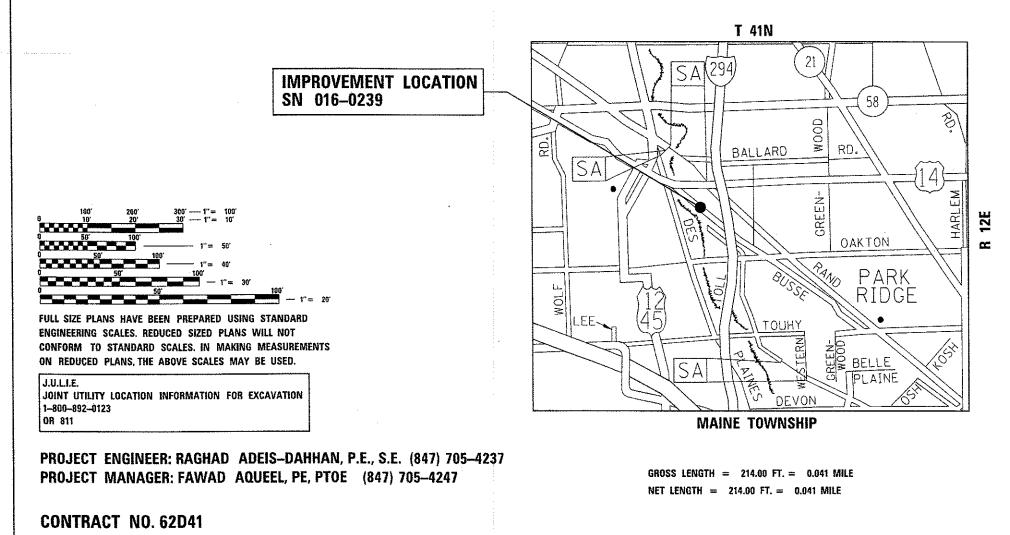

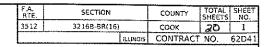



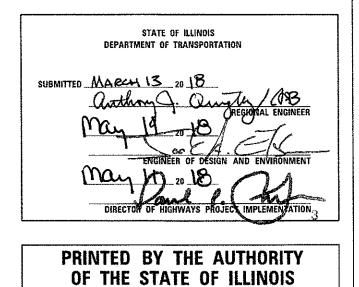

INDEX	<u>K OF SHEETS</u>	STATE	<u>STANDARDS</u>	GENERAL NOTES:
1	COVER SHEET	000001-06	STANDARD SYMBOLS, ABBREVIATIONS AND PATTERNS	1. BEFORE STARTING ANY EXCAVATION FOR FIELD LOCATIONS OF BURIED ELEC
2	GENERAL NOTES, INDEX OF SHEETS & STATE STANDARDS	701101-05	OFF-RD OPERATIONS, MULTILANE, 15' TO 24" FROM PAVEMENT EDGE	2. THE CONTRACTOR SHALL COORDIN
3 -4	SUMMARY OF QUANTITIES	701301-04	LANE CLOSURE, 2L, 2W, SHORT TIME OPERATIONS	OF DES PLAINES.
5	TYPCAL SECTIONS	701311-03	LANE CLOSURE 21, 2W MOVING OPERATIONS-DAY ONLY	3. THE CONTRACTOR WILL NOT BE A WRITTEN PERMISSION FROM THE DEPAR
6	REMOVAL PLAN	701427-05	URBAN SINGLE LANE CLOSURE, MULTILANE, 2W WITH MOUNTABLE MEDIAN	4. ANY PAVEMENT MARKINGS AND RA
7	ROADWAY AND PAVEMENT MARKING PLAN	701606-10	LANE CLOSURE, MULTILANE INTERMITTENT OR MOVING OPER., FOR SPPEDS < 40MPH	OPERATIONS ON SIDE STREETS AND EN
8	MAINTENANCE OF TRAFFIC - GENERAL NOTES AND TYPICAL SECTIONS	701611-01	URBAN HALF ROAD CLOSURE MULTILANE, 2W WITH MOUNTABLE MEDIAN	5. ALL DAMAGE TO EXISTING PAVEM REMOVAL LINE SHOWN ON THE PLANS
9	MAINTENANCE OF TRAFFIC STAGE 1	701701-10	URBAN LANE CLOSURE, MULTILANE INTERSECTION	6. BEFORE BEGINNING ANY WORK, TH
10	MAINTENANCE OF TRAFFIC STAGE 2		TRAFFIC CONTROL DEVICES	EXISTING PAVEMENT MARKING LINES (A CAN BE RE-ESTABLISHED FOR STRIPIN
11-14	STRUCTURE PLANS SN 016-0239		TEMPORARY CONCRETE BARRIER	THE ENGINEER.
	BUTT JOINT AND HMA TAPER (BD-32)	782006	GUARDRAIL AND BARRIER WALL REFLECTOR MOUNTING DETAILS	7. IT SHALL BE THE CONTRACTOR'S THE FIELD PRIOR TO CONSTRUCTION A
	TRAFFIC CONTROL AND PROTECTION FOR SIDE ROADS, INTERSECTIONS AN	•	(TC-10)	8. THE CONTRACTOR SHALL CONTACT MINIMUM OF 72 HOURS IN ADVANCE OF
÷ .	RAISED REFLECTIVE PAVEMENT MARKERS (SNOW PLOW RESISTANT) (TC-11) DISTRICT ONE TYPICAL PAVEMENT MARKINGS (TC-13))		9. THE ENGINEER SHALL CONTACT D A MINIMUM OF TWO (2) WEEKS PRIOR
	ARTERIAL ROAD INFORMATION SIGN (TC-22) DRIVEWAY ENTRANCE SIGNING (TC-26)			10. WHERE SECTION OR SUB-SECTION SUCH MONUMENTS ARE REMOVED. THE AND MONUMENTS UNTIL THE.OWNER, A
				11. THESE PLANS HAVE BEEN PREPAR INSPECTORS).
				12. THE CONTRACTOR SHALL BE RED THE CONSTRUCTION OF THIS PROJECT
				13. THE CONTRACTOR SHALL BE RESP(I.D.O.T.'S COMMUNICATIONS CENTER, S CLOSURE. THE CONTRACTOR SHALL A CLOSURE WILL BE IN PLACE.
				14. DO NOT SCALE PLANS FOR CONS
				15. DOUBLE LANE MARKERS ARE TO REFLECTIVE PAVEMENT MARKERS (SNO
	· · · · · · · · · · · · · · · · · · ·			16. PAVEMENT MARKING TAPE, TYPE I
				17. WHEN THE MILLED PAVEMENT IS O MACHINE SHALL NOT EXCEED 1 1/2 IN (25 mm) WHERE THE SPEED LIMIT IS MAXIMUM GRADE DIFFERENTIAL OF 3 1:3 (V:H) OR A NOTCHED LONGITUDINA
				18. BUTT JOINTS WILL BE INSTALLED ACCORDING TO THE "BUTT JOINT AND OTHERWISE SPECIFIED.
				19. THE CONTRACTOR SHALL TAKE A FOR WHICH THE CONTRACT DOES NOT REPAIR OR REPLACEMENT OF EXISTIN WITH THE REOUIREMENTS OF SECTION
				20. THE DEPARTMENT HAS DETERMINE THE DEPARTMENT HAS NOT OBTAINED 404 PERMIT IT IS THE CONTRACTOR'

USER NAME = KAINIP	DESIGNED -	REVISED -		GENE	RAL NOTES,	INDEX O	F SHEETS	S AND ST	TATE STANDARDS	F.A. RTE.	SECTION	COUNTY	TOTAL SHEET SHEETS NO.
	DRAWN -	REVISED -	STATE OF ILLINOIS		,		ADE AT D		· · · · · · · · · · · · · · · · · · ·	3512	3216B-BR(16)	соок	20 2
PLOT SCALE = 100.0000 ' / in.	CHECKED -	REVISED -	DEPARTMENT OF TRANSPORTATION		l	BUSSE H	WT AI P	RAIRIE CF	KEEK			CONTRAC	T NO. 62041
PLOT DATE = 4/12/2018	DATE -	REVISED -		SCALE:	SHEET	OF	SHEET	5 STA.	TO STA.		ILLINOIS FE	D. AID PROJECT	

THE CONTRACTOR SHALL CALL "J.U.L.I.E." AT (800) 892-0123 OR 811 IC, TELEPHONE AND GAS UTILITIES. 48 HOUR NOTIFICATION IS REQUIRED. CONSTRUCTION ACTIVITIES WITH UTILITY COMPANIES, AND THE CITY OF

WED TO SET UP A YARD OR FIELD OFFICE ON STATE PROPERTY WITHOUT

D REFLECTIVE PAVEMENT MARKERS OBLITERATED BY MILLING AND RESURFACING ANCES SHALL BE REPLACED AND PAID FOR IN KIND.

MARKINGS OR RAISED REFLECTIVE PAVEMENT MARKERS OUTSIDE THE LL BE REPLACED AT NO ADDITIONAL COST TO THE DEPARTMENT.

CONTRACTOR SHALL RETAIN AND RECORD FOR FUTURE REFERENCE, ALL RAISED REFLECTIVE PAVEMENT MARKERS) IN ORDER THAT THESE LOCATIONS EXACT LOCATIONS OF ALL PAVEMENT MARKINGS SHALL BE AS DIRECTED BY

SPONSIBILITY TO VERIFY ALL DIMENSIONS AND CONDITIONS EXISTING IN ORDERING OF MATERIALS.

HE DISTRICT ONE TRAFFIC CONTROL SUPERVISOR AT (847)705-4470 A EGINNING WORK.

CHIARUGI, AREA TRAFFIC FIELD ENGINEER, AT Don Chiarugi@illinois.gov THE PLACEMENT OF PERMANENT PAVEMENT MARKINGS.

NUMENTS ARE ENCOUNTERED, THE ENGINEER SHALL BE NOTIFIED BEFORE NTRACTOR SHALL PROTECT AND CAREFULLY PRESERVE ALL PROPERTY MARKERS UTHORIZED SURVEYOR OR AGENT HAS WITNESSED THEIR LOCATION.

FROM NOTES RECEIVED FROM THE BUREAU OF MAINTENANCE (BRIDGE

ED TO PROVIDE ACCESS TO ABUTTING PROPERTY AT ALL TIMES DURING

BLE FOR THE NOTIFICATION OF ALL EMERGENCY SERVICES, SCHOOL DISTRICTS, NGFIELD TRUCK PERMIT SECTION AND OTHER AGENCIES AFFECTED BY THE BE RESPONSIBLE FOR POSTING SIGNS THAT WILL INDICATE THE DATES THE

CTION DIMENSIONS.

JSED AS SHOWN ON THE DISTRICT ONE DETAIL "TYPICAL APPLICATIONS - RAISED .OW RESISTANT!" SHOWN IN THE PLANS.

HALL BE USED FOR SHORT TERM PAVEMENT MARKINGS ON ALL FINAL SURFACES.

N TO TRAFFIC THE MAXIMUM GRADE DIFFERENTIAL BETWEEN PASSES OF THE MILLING ES (40 mm) WHERE THE SPEED LIMIT IS 40 MPH (80 km/h) OR LESS AND 1 INCH ATER THAN 40 MPH (80 km/h). WITH WRITTEN APPROVAL OF THE ENGINEER, A HES (75 mm) MAY BE ALLOWED IF THE EDGE OF THE NILLING IS SLOPED A MINIMUM (EDGE IS USED.

THE ENDS OF ALL RESURFACING (WHERE RESURFACING MEETS EXISTING PAVEMENT) T-MIX ASPHALT TAPER DETAILS" SHEET INCLUDED IN THE PLANS, UNLESS

VECESSARY PRECAUTIONS FOR THE PROTECTION OF EXISTING PLANT MATERIAL DVIDE REMOVAL. THE PROTECTION OF EXISTING PLANT MATERIAL AND THE LANT MATERIAL DAMAGED BY THE CONTRACTOR SHALL BE DONE IN ACCORDANCE 1 OF THE STANDARD SPECIFICATIONS.


HAY IN STREAM WORK IS NOT REQUIRED FOR THE WORK SPECIFIED IN THIS CONTRACT. 404 PERMIT. IF THE CONTRACTOR CHOOSES TO USE ACTIVITIES REQUIRING AN USACE ESPONSIBILITY TO SECURE THE PROPER USACE PERMITS.


	SUMMARY OF QUANTITIES		<u>urban</u>		<u> </u>	NSTRUCT	ION TYPE	CODE				SUMMARY OF QUANTITIES	
CODE NO	ITEM	UNIT	TOTAL QUANTITIES	FED 80%	BRIDCE 0013 FED 80% STATE 20%						CODE NO	ITEM	UNIT
40600290	BITUMINOUS MATERIALS (TACK COAT)	POUND	353	353						_*	78008210	POLYUREA PAVEMENT MARKING TYPE I - LINE	F 001
												4"	
40600982	HOT-MIX ASPHALT SURFACE REMOVAL - BUTT	SO YD	294	294									
	JOINT									*	78100100	RAISED REFLECTIVE PAVEMENT MARKER	EACH
40603340	HOT-MIX ASPHALT SURFACE COURSE, MIX	TON	(olo	66							78100200	TEMPORARY RAISED REFLECTIVE PAVEMENT	EACH
	"D", N70											MARKER	
44000155	HOT-MIX ASPHALT SURFACE REMOVAL, 1	SO YD	489	489						*	78200006	GUARDRAIL REFLECTORS, TYPE B	EACH
	1/2"												
										*	78200011	BARRIER WALL REFLECTORS, TYPE C	EACH
52000050	PREFORMED JOINT SEAL 4"	FOOT	88		88								
											X0327638	STREAM GAUGE	EACH
67000400	ENGINEER'S FIELD OFFICE, TYPE A	CAL MO	3	3									
67100100	MOBILIZATION	L SUM	1	1							x0327980	PAVEMENT MARKING REMOVAL - WATER BLASTING	50 F
87100100			· · ·	• •									
70300904	PAVEMENT MARKING TAPE. TYPE IV 4"	FOOT	4852	4852							X0900046	PREFORMED JOINT SEAL, 1"	FOOT
70400100	TEMPORARY CONCRETE BARRIER	FOOT	180	180							x7010216	TRAFFIC CONTROL AND PROTECTION,	LSU
												(SPECIAL)	
70400200	RELOCATE TEMPORARY CONCRETE BARRIER	FOOT	180	180							Z0012102	CONCRETE BRIDGE DECK SCARIFICATION 3/B INCH	502 4
										_	Z0012193	BRIDGE DECK THIN POLYMER OVERLAY 3/8"	SO Y
70600250	IMPACT ATTENUATORS, TEMPORARY (NON-	EACH	2	2									
	REDIRECTIVE), TEST LEVEL 3										Z0012754	STRUCTURAL REPAIR OF CONCRETE (DEPTH	SQ F
70600350	IMPACT ATTENUATORS, RELOCATE (NON-	EACH	2	2						_		EQUAL 10 OR LESS THAN 5 INCHES	+
	REDIRECTIVE), TEST LEVEL 3										20015802	PLUG EXISTING DECK DRAINS	EACH
78000200	THERMOPLASTIC PAVEMENT MARKING - LINE	FOOT	2236	2236						_	Z0016001	DECK SLAB REPAIR (FULL DEPTH, TYPE 1)	SO Y
	4 ¹⁰										3	*Sauce Har Har	
FILE NAME =	USER NAME = KANIP Ullinols.gov/PWIDDT\Documents\DDf OfTcas\Dtstrldt NProjects\DD(47)CADData\Deslgn\D(0)47	DESIGNED -	<u> </u>	REVISED REVISED					STATE O	F II	· · · · ·	*Specialty Hem	
A STATUTE COLUMN EG	Utilinals.gov/PMIDDI Obcuments.dboi Utilinals.gov/PMIDDI Obcuments.gnc.kuleir PLOT SCALE = 100,0000 1 / In.	CHECKED -		REVISED			1				ANSPORTA		Y OF QUA
N /	PLOT DATE = 3/23/20/8	DATE -		REVISED	-							SCALE: SHEET NO. OF	SHEETS

	URBAN							
				CO	NSTRUCTIC	N TYPE C	ODE	
IT	TOTAL QUANTITIES	ROADWAY OCI3 FED 80% STATE 20%	0 FED	IDGE 013 80% E 20%				
٥ĩ	140	140						
CH	6	6						
CH	10	10						
Сн	16	16						
CH	15	15						
CH	1			l				
FT	743	743					-	
DT	88		88	3				
UM	1	1						
٩D	174		l	14				
YD	174		174					
FT	236		2	36	•			
СН	4			4				
YD	1.8		1	. 8				
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JANT	TIES			F.A RTE.	SECTI	ON		OTAL SHEET NO. 20 3
STA		O STA.		FED. 804	AD DIST. NO. 1 I	LEINOIS FED. AIC	CONTRACT I	10. 02041

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			URBAN		00	NSTRUCTI	ON TYPE C	ODE						1	1	CON	STRUCTIO		DE	·
	SUMMARY OF QUANTITIES										SUM	MARY OF QUANTITIES		4			31100110			
CODE NO	ITEM	UNIT	QUANTITIES	ROADWAY 0004 FED 80% STATE 20%	BRIDGE 0013 FED 80% STATE 20%					CODE	10	ITEM	UNIT	TOTAL QUANTITIES						
Z0016200	DECK SLAB REPAIR (PARTIAL)	SO YD	47		47															
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Z0030850	TEMPORARY INFORMATION SIGNING	SQ FT	68	68																Į
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	PLOT DATE = 3/23/2018 DAT	Ε		REVISED	Ŧ							SCALE: SHEET NO.	OF SHEETS ST	Α, 1	IO STA.	FED. ROA	D DIST. NO. 1 IL	LINOIS FED. AID	PROJECT	



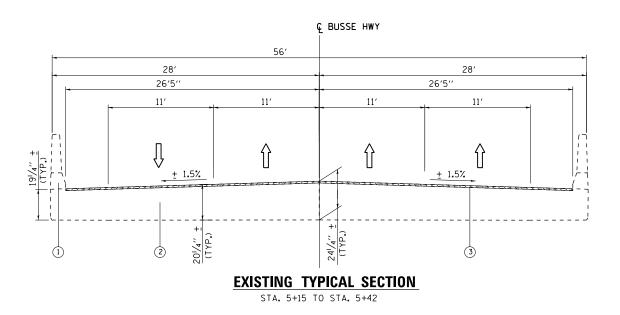

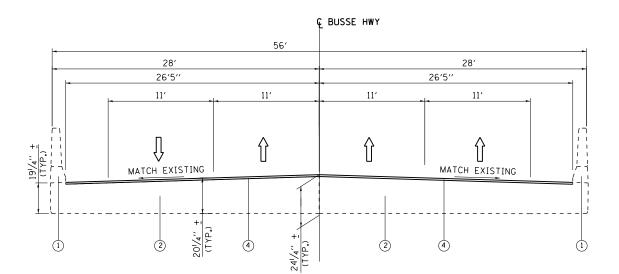PROPOSED TYPICAL SECTION

STA. 5+15 TO STA. 5+42

HOT-MIX ASPHALT MIXTURE REQUIREMENTS		QUALITY MANAGEMENT
MIXTURE TYPE	AIR VOIDS Ndes	PROGRAM (QMP)
BRIDGE APPROACH OVERLAY AND BUTT JOINT		
HOT-MIX-ASPHALT SURFACE COURSE, MIX "D", N70 (IL-9.5 MM); 1 7/8"	4% @ 70 GYR	QC / QA
QMP DESIGNATION: QUALITY CONTROL / QUALITY ASSURANCE (QC/QA)		

NOTES:

1. THE UNIT WEIGHT USED TO CALCULATE ALL HMA SURFACE MIXTURE QUANTITIES IS 112 LBS/ SQ. YD,/ IN.

2. THE "AC TYPE" FOR NON-POLYMERIZED HMA THE "AC TYPE" SHALL BE "PG 64-22" UNLESS MODIFIED BY DISTRIC ONE SPECIAL PROVISION. 3. FOR USE OF RECYCLE MATERIALS SEE DISTRICT ONE SPECIAL PROVISIONS.

USER NAME = KAINIP	DESIGNED -	REVISED -				турі	CAL SECTIONS		F.A. BTE	SECTION	COUNTY	TOTAL SHEET
	DRAWN -	REVISED -	STATE OF ILLINOIS		DU				3512	3216B-BR(16)	соок	20 5
PLOT SCALE = 100.0000 ' / in.	CHECKED -	REVISED -	DEPARTMENT OF TRANSPORTATION		BU	55E HVV1	Y AT PRAIRIE CREEK				CONTRACT	
PLOT DATE = 4/12/2018	DATE -	REVISED -		SCALE:	SHEET	OF	SHEETS STA.	TO STA.		ILLINOIS FED.	AID PROJECT	

LEGEND


EXISTING CONCRETE PARAPET

2 EXISTING CONCRETE BRIDGE DECK

(3) concrete bridge deck scarification $\frac{3}{8}$ inch

(4) PROPOSED THIN POLYMER OVERLAY 3/8 INCH

4. QUALITY MANAGEMENT PROGRAM IDENTIFIES THE PARTICULAR QUALITY CONTROL SPECIFICATION THAT APPLIES TO THE HMA MIXTURE.

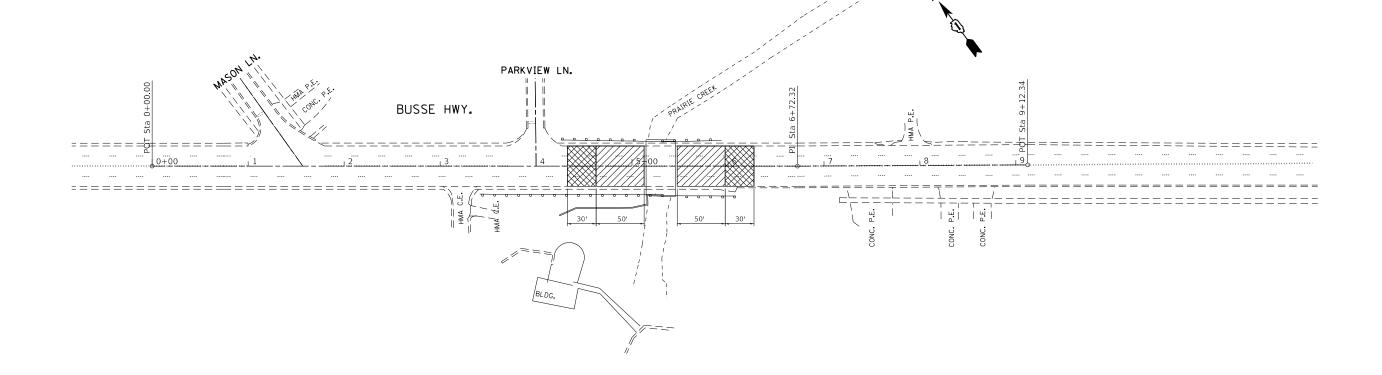


LEGEND

HMA SURFACE REMOVAL 11/2"

HMA SURFACE REMOVAL BUTT JOINT

USER NAME = KAINIP	DESIGNED -	REVISED -				RF	MOVAL PLAN		F.A.U. BTE	SECTION	COUNTY	TOTAL	SHEET
	DRAWN -	REVISED -	STATE OF ILLINOIS		ВШ				3512	3216B-BR(16)	соок	20	6
PLOT SCALE = 100.0000 ' / in.	CHECKED -	REVISED -	DEPARTMENT OF TRANSPORTATION		BU	SSE HW	Y AT PRAIRIE CREEK				CONTRACT	NO. 62	D41
PLOT DATE = 4/12/2018	DATE -	REVISED -		SCALE: 1"=50'	SHEET	OF	SHEETS STA.	TO STA.		ILLINOIS FED. A	ID PROJECT		

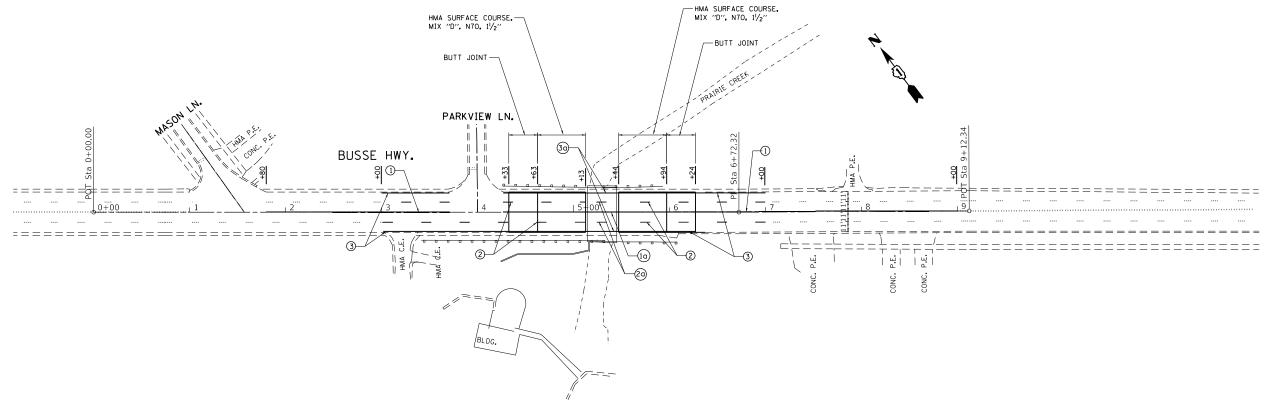

LEGEND

- () THERMOPLASTIC PAVEMENT MARKING LINE 4" (DOUBLE YELLOW) @ 11" C-C
- (2) THERMOPLASTIC PAVEMENT MARKING LINE 4" (WHITE, 10'-30' SKIP-DASH)
- THERMOPLASTIC PAVEMENT MARKING LINE 4" (SOLID WHITE)
 POLYUREA PAVEMENT MARKING LINE 4" (DOUBLE YELLOW) @ 11" C-C
 POLYUREA PAVEMENT MARKING LINE 4" (WHITE, 10'-30' SKIP-DASH)
 POLYUREA PAVEMENT MARKING LINE 4" (SOLID WHITE)

USER NAME = KAINIP	DESIGNED -	REVISED -		RC	ADWAY A	ND PAV	EMENT I	MARKING PL	AN	F.A.U. RTE	SECTION	COUNTY	TOTAL SHEET SHEETS NO.
	DRAWN -	REVISED -	STATE OF ILLINOIS		BIIG	SE HWY		IRIE CREEK		3512	3216B-BR(16)	соок	20 7
PLOT SCALE = 100.0000 / in.	CHECKED -	REVISED -	DEPARTMENT OF TRANSPORTATION		БОЗ	SE HVVI						CONTRACT	T NO. 62D41
PLOT DATE = 4/12/2018	DATE -	REVISED -		SCALE: 1"=50	SHEET	OF	SHEETS	STA.	TO STA.		ILLINOIS FEE	. AID PROJECT	

MOT GENERAL NOTES:

1. THE CONTRACTOR SHALL REMOVE AND SAFELY STORE (FREE FROM THEFT OR DAMAGE) OR COVER ALL CONFLICTING EXISTING SIGNS FOR THE DURATION OF THE CONSTRUCTION. ALL SIGNS SHALL BE RESTORED TO THEIR ORIGINAL CONDITION AT THE END OF CONSTRUCTION.

2. THE FOLLOWING APPLY TO CONSTRUCTION SIGNS:

A) THE CONTRACTOR SHALL FURNISH ALL SIGNS.

B)THE CONTRACTOR SHALL BE RESPONSIBLE FOR AND REPLACE ANY SIGNS THAT ARE SUPPLIED BY OTHERS AND DAMAGED BY THE CONTRACTOR'S WORK FORCE OR SUBCONTRACTORS DURING RELOCATION OR CONSTRUCTION OPERATIONS.

C) ALL SIGNS AND ASSEMBLIES SHALL BE CERTIFIED BY THE CONTRACTOR AS MEETING THE APPLICABLE REQUIREMENTS OF NCHRP REPORT 350. TEST LEVEL 2.

D) ALL SIGNS SHALL BE CONSIDERED INCLUDED IN THE COST OF THE TRAFFIC CONTROL AND PROTECTION (SPECIAL) PAY ITEM, EXCEPT FOR TEMPORARY INFORMATIONAL SIGNING AS NOTED ON THE PLANS.

3. ALL TEMPORARY PAVEMENT MARKINGS DURING STAGED CONSTRUCTION SHALL BE PAVEMENT MARKING TAPE, TYPE IV OF THE WIDTH AND COLOR SPECIFIED ON THE PLAN SHEETS

4. THE CONTRACTOR SHALL MAINTAIN DRAINAGE AND EROSION CONTROL DURING CONSTRUCTION FOR THE DURATION OF THE CONTRACT.

5. THE CONTRACTOR SHALL PROVIDE AND MAINTAIN ACCESS TO ALL COMMERCIAL AND RESIDENTIAL ENTRANCES FOR THE ENTIRE DURATION OF THE PROJECT UNLESS OTHERWISE NOTED ON THE PLANS.

6. SIDE ROAD, INTERSECTIONS, AND DRIVEWAY TRAFFIC CONTROL SHALL BE IN ACCORDANCE WITH THE TYPICAL ENTRANCE SIGNING DETAIL, DISTRICT DETAILS TC-10 AND TC-26, AND AS SHOWN ON THE PLANS

STAGE 1:

CONSTRUCTION:

```
- DECK SLAB AND JOINT REPAIR ON EASTBOUND SIDE.
- ABUTMENT REPAIR ON EASTBOUND SIDE.
```

TRAFFIC:

- MAINTAIN ONE LANE EACH FOR EASTBOUND AND WESTBOUND TRAFFIC AS SHOWN ON PLAN.

STAGE 2:

CONSTRUCTION:

- DECK SLAB AND JOINT REPAIR ON WESTBOUND SIDE.

- ABUTMENT REPAIR ON WESTBOUND SIDE.

TRAFFIC:

- MAINTAIN ONE LANE EACH FOR EASTBOUND AND WESTBOUND TRAFFIC AS SHOWN ON PLAN.


STAGE 3:


CONSTRUCTION:

- BUTT JOINT REMOVAL AND SURFACE COURSE REMOVAL HMA SURFACE COURSE
- PAVEMENT MARKING

TRAFFIC:

- MAINTAIN ONE LANE EACH FOR EASTBOUND AND WESTBOUND TRAFFIC.
- USE HIGHWAY STANDARDS 701101, 701301, 701311, 701427, 701606, 701611 AND 701701.

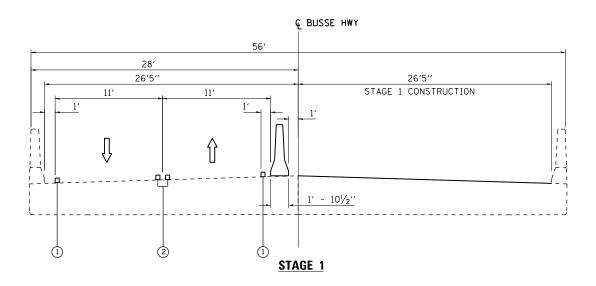

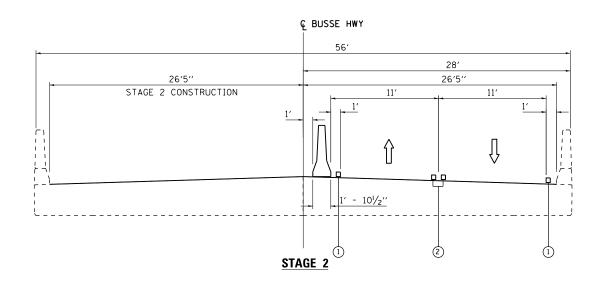


LEGEND

(1) PAVEMENT MARKING 4" SOLID WHITE EDGE LINE

(2) PAVEMENT MARKING 4" DOUBLE YELLOW @11" C-C W/

USER NAME = KAINIP	DESIGNED -	REVISED -		MAINTENANCI	E OF TRAF	FIC – GI	ENERAL	NOTES AND	TYPICAL SECTIONS	F.A. BTE	SECTION	COUNTY	TOTAL SHEET
	DRAWN -	REVISED -	STATE OF ILLINOIS	MAINTENANO	BUS			IRIE CREEK		3512	3216B-BR(16)	соок	20 8
PLOT SCALE = 100.0000 ' / in.	CHECKED -	REVISED -	DEPARTMENT OF TRANSPORTATION			SL HVVI	ALTRA			_		CONTRACT	NO. 62D41
PLOT DATE = 4/12/2018	DATE -	REVISED -		SCALE:	SHEET	OF	SHEETS	STA.	TO STA.		ILLINOIS FED.	AID PROJECT	

TEMPORARY RAISED REFLECTIVE PAVEMENT MARKERS

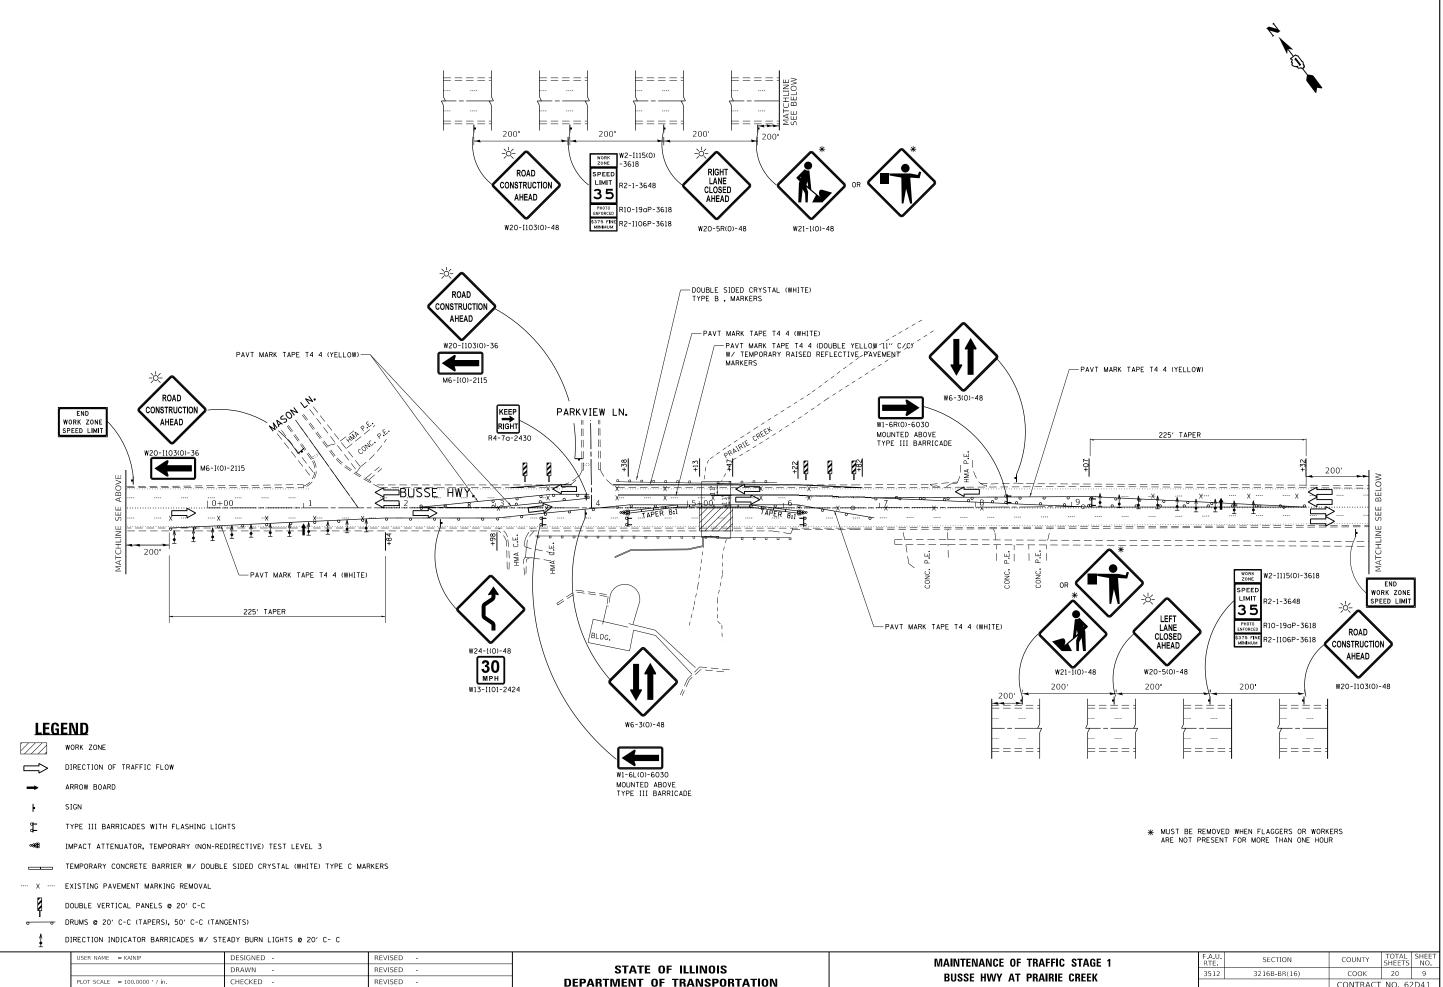


REVISED **DEPARTMENT OF TRANSPORTATION** REVISED

PLOT DATE = 4/12/2018

DATE


BUSSE HWY AT P SCALE: 1"=50' SHEET OF SHEET

PR	AIRIE CREEK		3512	3216B-	BR(16)		СООК	20		9
							CONTRACT	NO.	621	D41
TS	STA.	TO STA.			ILLINOIS	FED. AI	ID PROJECT			

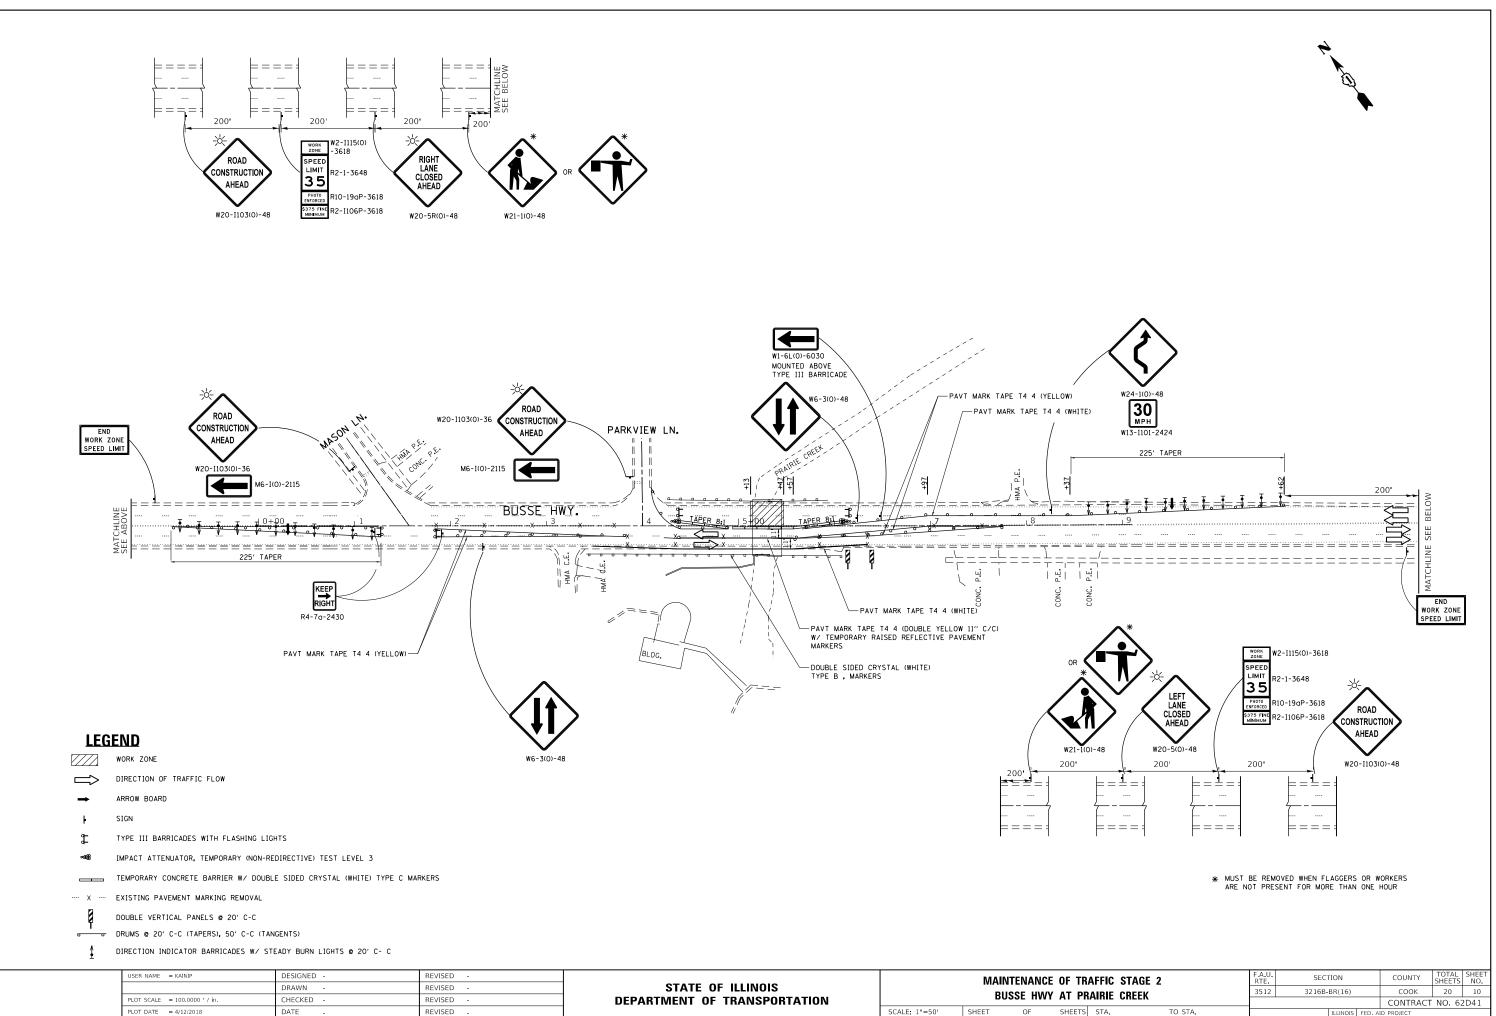


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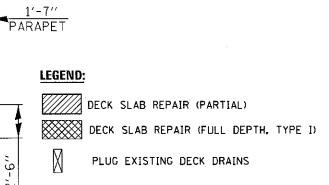
SCALE: 1"=50' SHEET OF

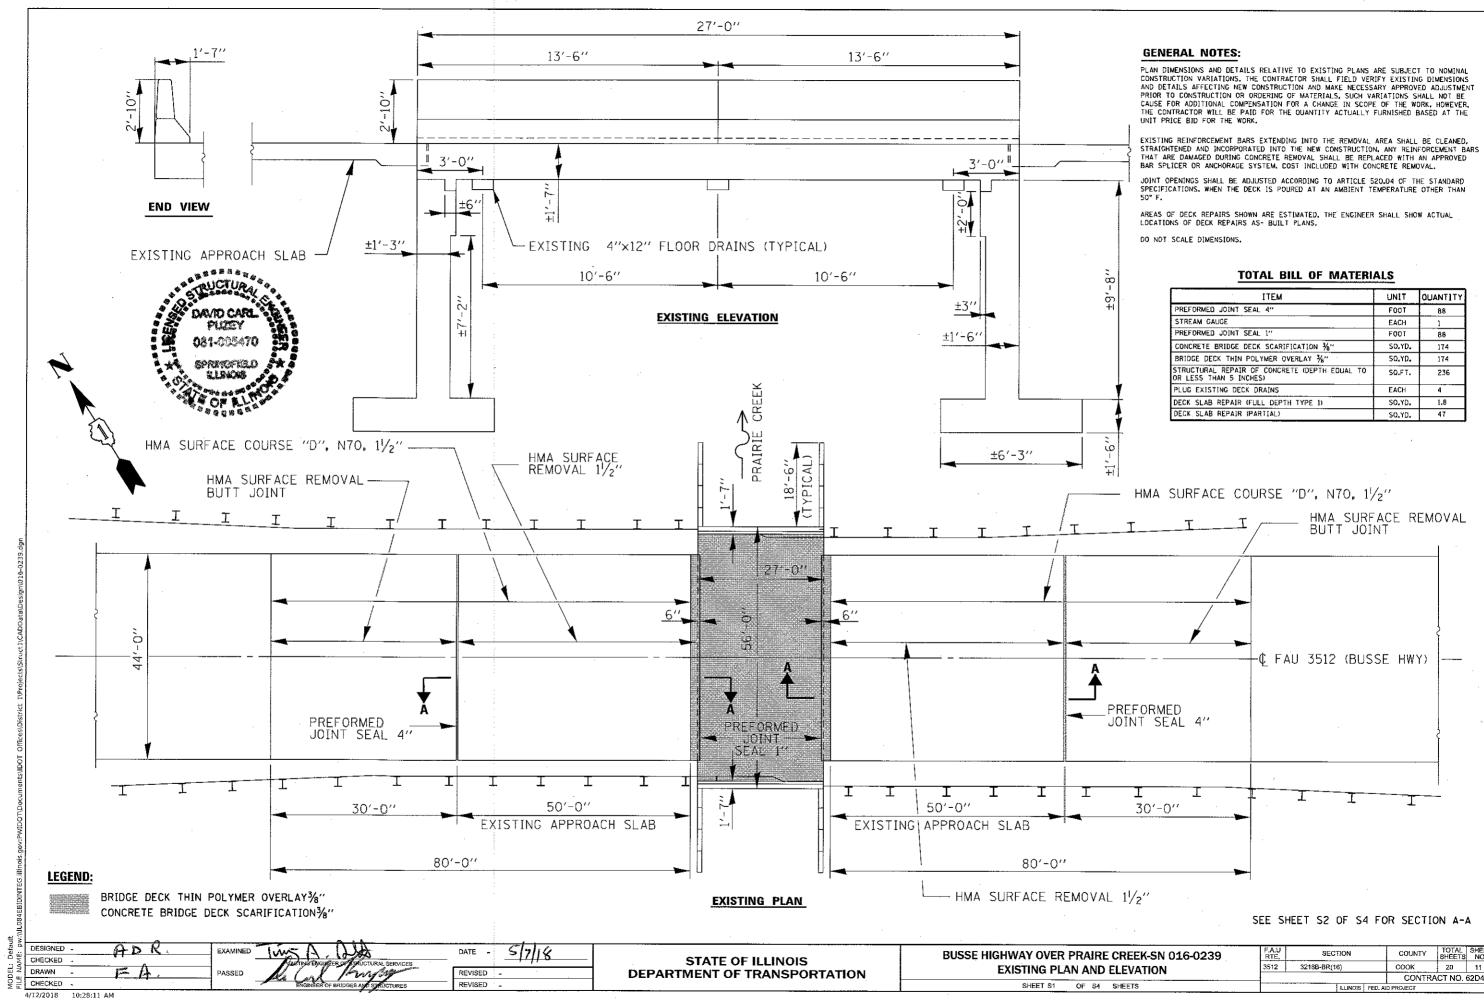


ITEM	UNIT	QUANTITY
PREFORMED JOINT SEAL 4"	FOOT	88
STREAM GAUGE	EACH	1
PREFORMED JOINT SEAL 1"	FOOT	88
CONCRETE BRIDGE DECK SCARIFICATION 3/8"	SD.YD.	174
BRIDGE DECK THIN POLYMER OVERLAY %"	SQ.YD.	174
STRUCTURAL REPAIR OF CONCRETE (DEPTH EQUAL TO OR LESS THAN 5 INCHES)	SO.FT.	236
PLUG EXISTING DECK DRAINS	EACH	4
DECK SLAB REPAIR (FULL DEPTH TYPE 1)	SQ.YD.	1.8
DECK, SLAB REPAIR (PARTIAL)	SQ.YD.	47

E CREEK-SN 016-0239 ELEVATION SHEETS		SECTION		COUNTY	TOTAL SHEETS	SHEET NO.
		3216B-BR(16)		COOK	20	11
				CONTRA	CT NO.	62D41
		(LLINO)	FED. A	D PROJECT		



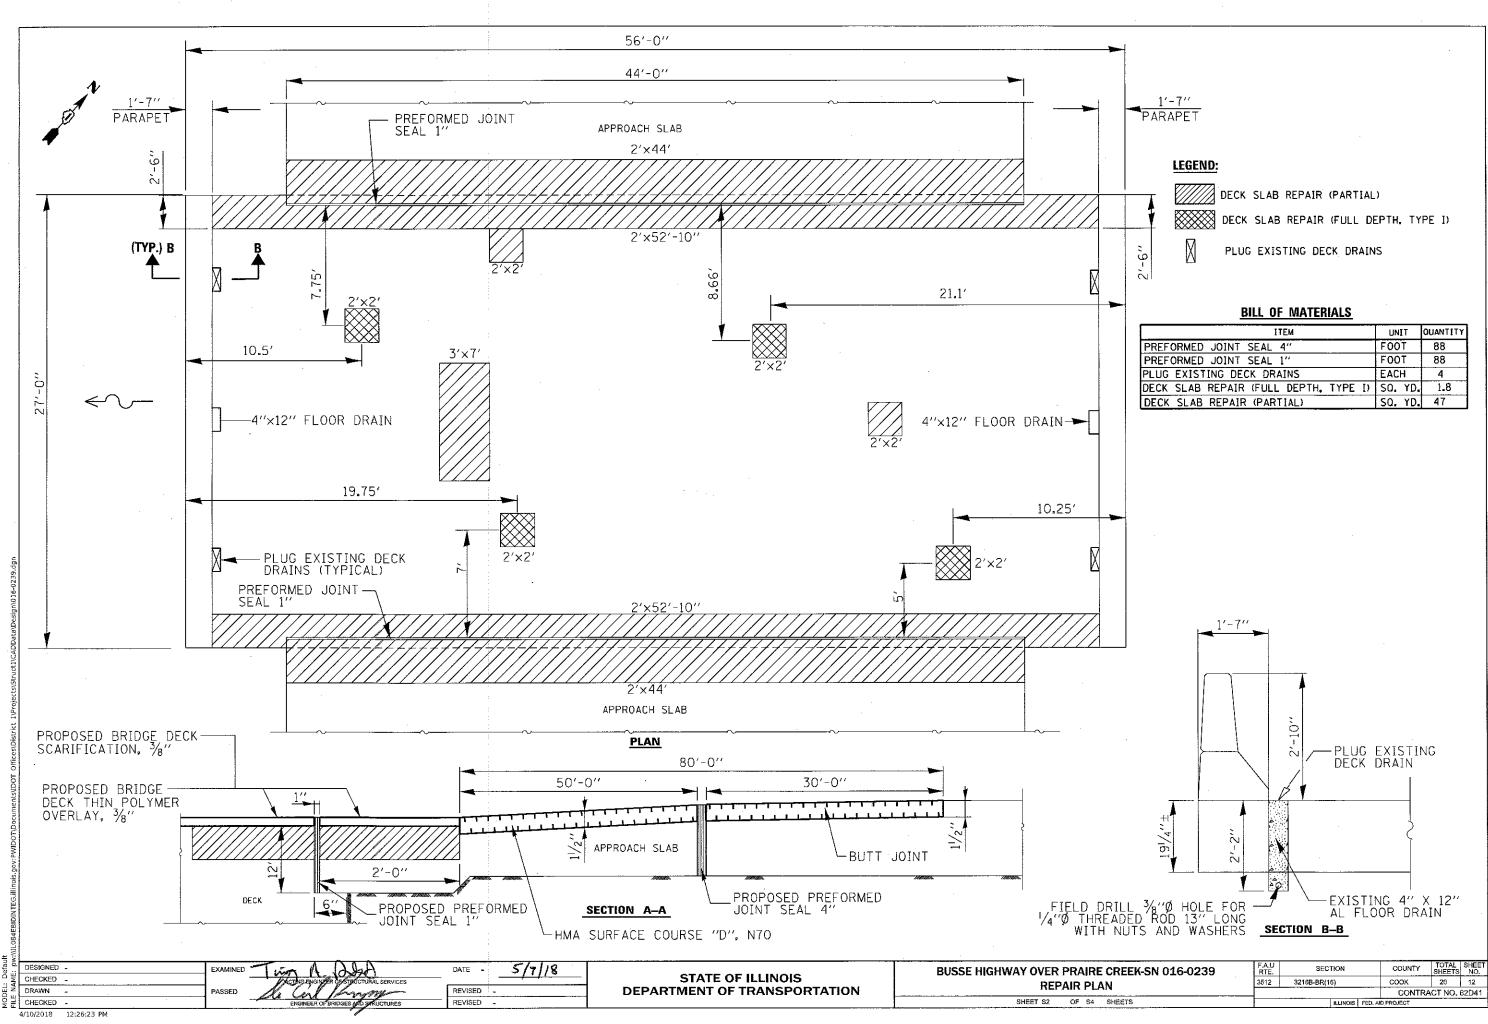


ITEM	UNIT	QUANTITY
PREFORMED JOINT SEAL 4"	FOOT	88
PREFORMED JOINT SEAL 1"	FOOT	88
PLUG EXISTING DECK DRAINS	EACH	4
DECK SLAB REPAIR (FULL DEPTH, TYPE I)	SO. YD.	1.8
DECK SLAB REPAIR (PARTIAL)	SQ. YD.	47

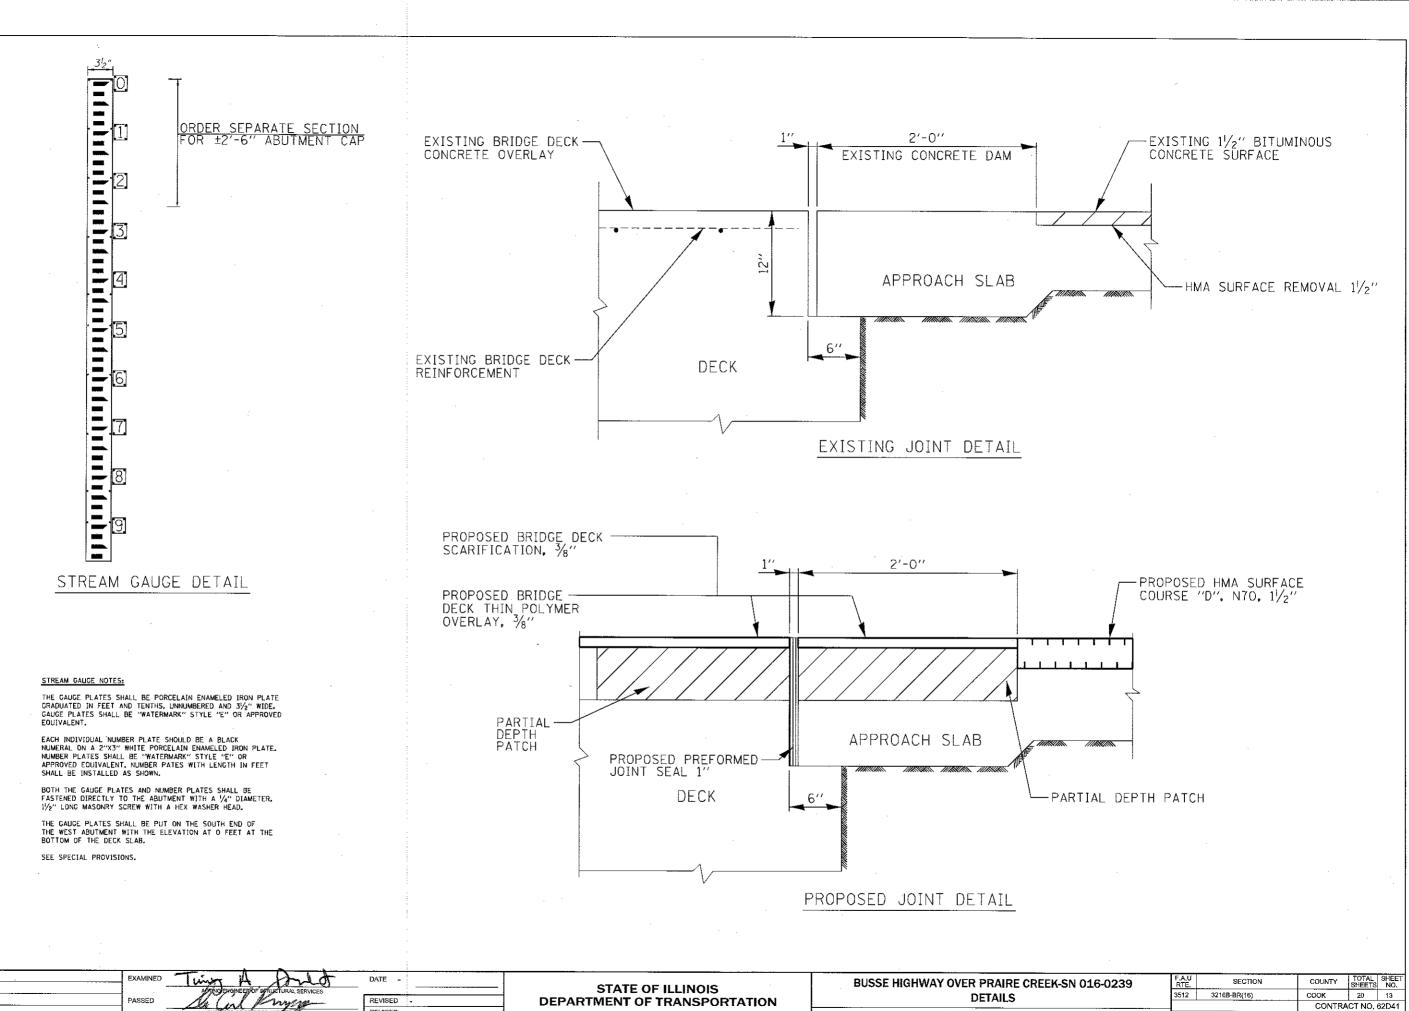

F NAME: NW	DESIGNED - CHECKED - DRAWN -	 MANDENGINEEROF SPRINCIPAL SERVICES	DATE	STATE OF ILLINOIS DEPARTMENT OF TRANSPORTATION	BUSSE HIGHWAY OVER PRAIRE CREEP DETAILS
ÉĦ	CHECKED	 ENGINEER OF BRIDGES AND STRUCTURES	REVISED .		SHEET S3 OF S4 SHEETS
	4/10/2018 12:26:51 PM	<i>a a a a</i>			


ILLINOIS FED. AID PROJECT

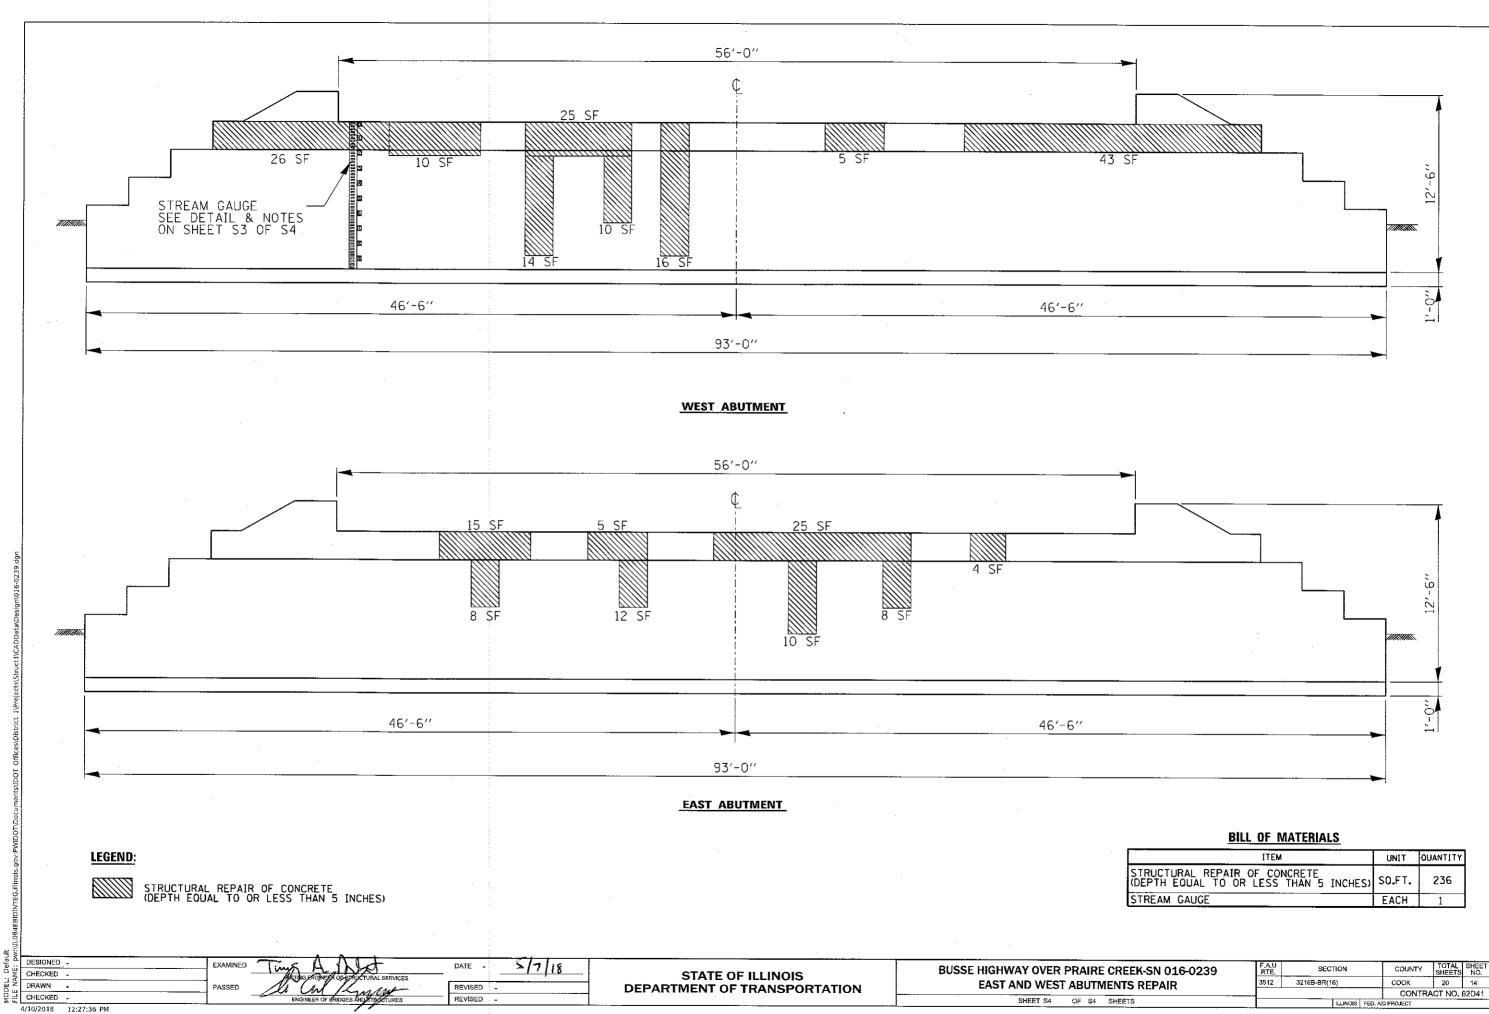




ITEM	UNIT	QUANTITY
STRUCTURAL REPAIR OF CONCRETE (DEPTH EQUAL TO OR LESS THAN 5 INCHES)	SO.FT.	236
STREAM GAUGE	EACH	1


							-	
E CREEK-SN 016-0239 MENTS REPAIR		SECT	ION	Ĩ	COUNTY	TOTAL SHEETS	SHEET NO.	
		3216B-BR(16)		COOK	20	14	
					CONTRA	CT NO.	32D41	
SHEETS			ILLINOIS	FED. AID	PROJECT			

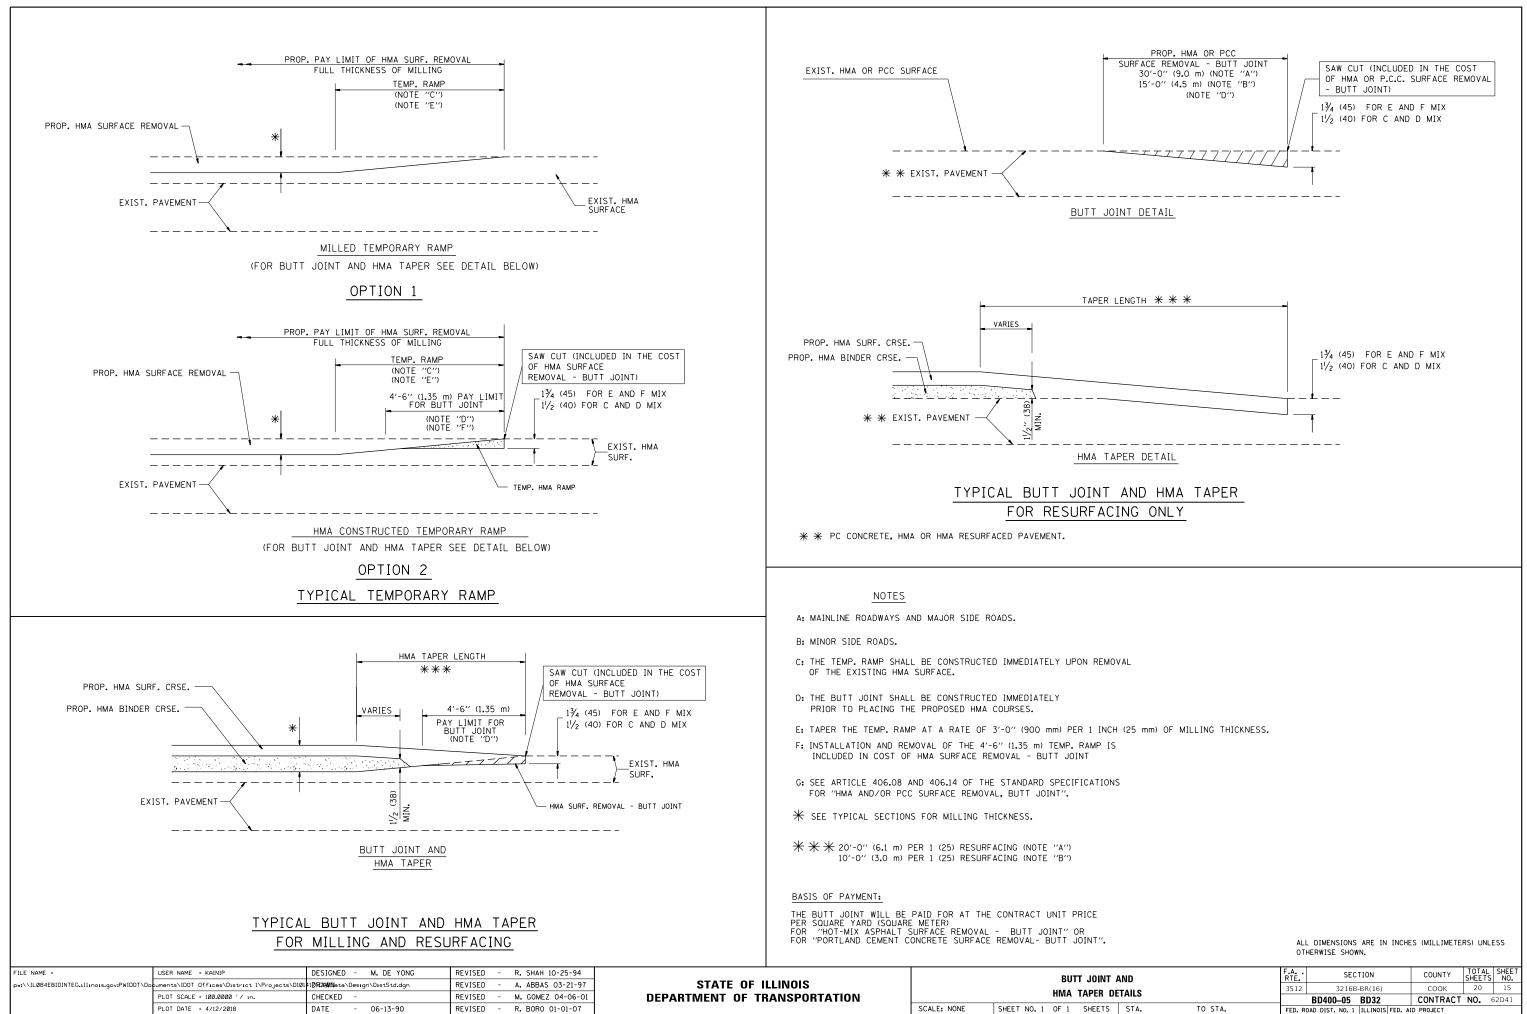

AND DETAILS		F.A RTE.	SECTION	COUNTY	TOTAL SHEETS	SHEET NO.	
		3512	3216B-BR(16)	соок	20	15	
			BD400–05 BD32	CONTRACT	NO. 6	52D41	
	STA.	TO STA.	FED. RO	DAD DIST. NO. 1 ILLINOIS FED. A	ID PROJECT		


	TYPE I OR TYPE II BARRICADES WITH ORE 10.000 2.0000 2.0000 2.000 2.000 2.
	 NOTES: 1. SIDE ROAD WITH A SPEED LIMIT OF 40 MPH 160 km/hi 07 R LESS AS SHOWN ON THE DRAWING AND AS DIRECTED BY THE ENDINES: a. ONE "ROAD CONSTRUCTION AND AS DIRECTED BY THE ENDINES AS SHOWN ON THE DRAWING AND AS DIRECTED BY THE ENDINES AS SHOWN ON THE DRAWING CONSTRUCTION AND AS 36 (900/900) WITH A FLASHER NOUNCED ON IT APPROXIMATELY 200' (60 m) IN ADVANCE OF THE MAIN ROUTE BLOCKING WITH YPE, ITYPE II OS TYPE II BARRICADES, IS OF THE CLOSED PORTION OF THE KAIN ROUTE SHALL BE PROTECTED BY BLOCKING WITH YPE, ITYPE II OS TYPE II BARRICADES, IS OF THE CROSS SECTION OF THE CLOSED PORTION. 3. SIDE ROAD WITH A SPEED LIMIT GREATER THAN 40 MPH 160 km/hi SS SHOWN ON THE DRAWING GREATER THAN 40 MPH 160 km/hi SS SHOWN ON THE DRAWING AND AS DIRECTED BY THE ENGINEER. 4. WEN "ROAD CONSTRUCTION AREAD" STON 48 x 48 (12 m x 12 m) WITH A FLASHER MONITED ON THE DRAWING REATER THAN 40 MPH 160 km/hi SD LOCKING WITH A SPEED LIMIT GREATER THAN 40 MPH 160 km/hi SS SHOWN ON THE DRAWING AND AS DIRECTED BY THE ENGINEER. 5. WIEN CONTED ON THE DRAWING STON 48 x 48 (12 m x 12 m) WITH A FLASHER MONITED ON THE DRAWING REATER THAN 40 MPH 160 km/hi SD LOCKING WITH A SPEED LIMIT GREATER THAN 40 MPH 160 km/hi SS SHOWN ON THE DRAWING AND AS DIRECTED BY THE ENGINEER. 6. WIEN THE SIDE OND THE DRAWING STON 48 x 48 (12 m x 12 m) WITH A FLASHER MONITED ON THE DRAWING STON 48 x 48 (12 m x 12 m) WITH A FLASHER BUSTITUTED FOR BARRICADES OR DRUMS AT HALF THE SPACING DURING DAY DEFRATIONS. CONES SHALL BE A MINIMUM OF 28 (710) IN THE CLOSED PORTION. 9. MEN THE SIDE ROAD LIES BETWEEN THE BEGINNING OF THE MAINLINE EUCISLING AND THE WORK ZONG, A SINCLE HEADED ARROW M6-40. AND IMMENSION DAY DEFRATIONS CONES SHALL BE AMINIMUM OF 28 (710) IN LEUGAL AN HEID HER DURING DAY DEFRATIONS. CONES SHALL BE AMINIMUM OF 28 (710) IN LEUGAL MI DIMENSION DAY DEFRATIONS CONES SHALL BE AMINIMUM OF 28 (710) MI DIMENSION DAY DEFRATIONS CONES SHALL BE AMINIMUM OF 28 (710)
FILE NAME = USER NAME = KAINIP DESIGNED - L.H.A. REVISED - A. HOUSEH 10- pwt:\L\L084EBIDINTEG.illinois.gov/PWIDDT\Decuments\DDT Offices\District 1\Projects\D101810RXWNkta\Design\DistStd.dgn REVISED - T. RAMMACHER 01- Public PLOT SCALE = 100.0000 '/ in. CHECKED - REVISED - A. SCHUETZE 07 Defoult PLOT DATE = 4/12/2018 DATE - 06-89 REVISED - A. SCHUETZE 07	Unless otherwise shown. 5-96 6-00 51-13 DEPARTMENT OF TRANSPORTATION 5-96 6-00 51-13 DEPARTMENT OF TRANSPORTATION 5-96 6-00 51-13 512 512 512 512 512 512 512 512

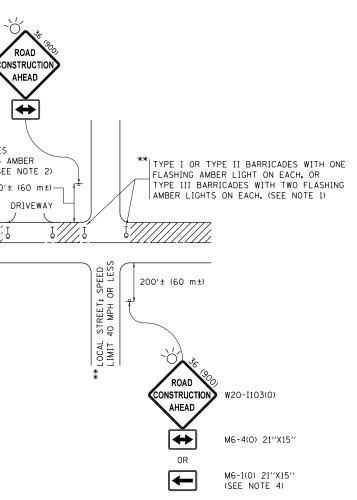


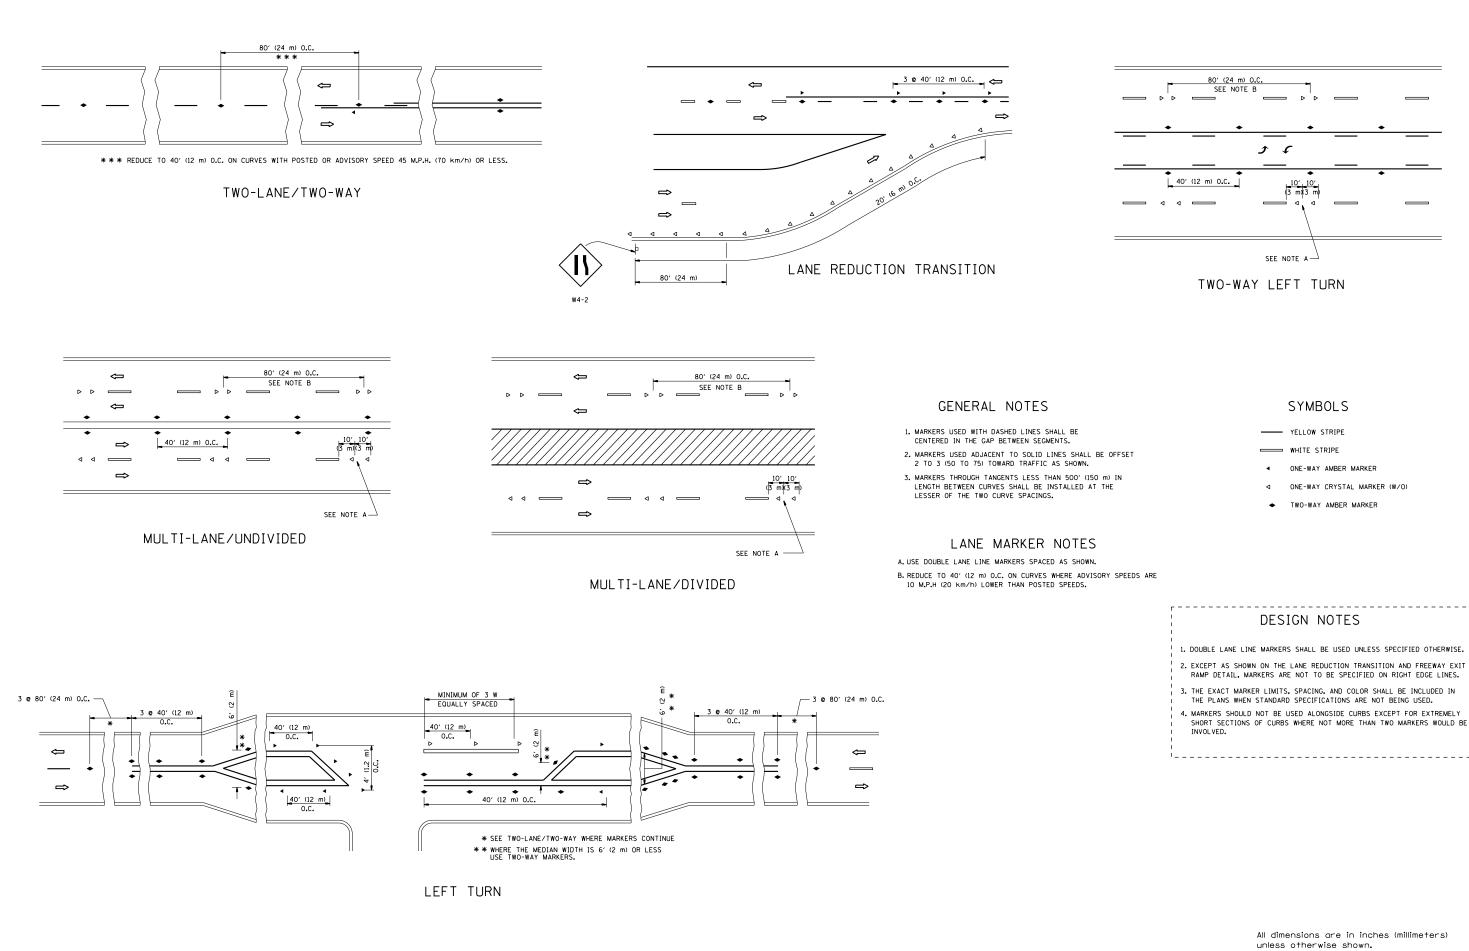

FILE NAME =		DESIGNED -	REVISED - T. RAMMACHER 09-19-94			TYPICAL APPLICATIONS	F.A RTE.	SECTION	COUNTY TOTAL SHEET SHEETS NO.
pw://IL084EBIDINTEG.1111no1s.gov:PWIDOT/Do	uments\IDOT Offices\District 1\Projects\D101	10RAWNata\Design\DistStd.dgn	REVISED - T. RAMMACHER 03-12-99	STATE OF ILLINOIS	RAISED REFLECTIVE PAVEMENT MARKERS (SNOW-PLOW RESISTANT)		3512	3216B-BR(16)	СООК 20 17
	PLOT SCALE = 100.0000 ' / in.	CHECKED -	REVISED -T. RAMMACHER 01-06-00	DEPARTMENT OF TRANSPORTATION				TC-11	CONTRACT NO. 62D41
	PLOT DATE = 4/12/2018	DATE -	REVISED - C. JUCIUS 09-09-09		SCALE: NONE	SHEET NO. 1 OF 1 SHEETS STA. TO STA.	FED. ROAD	DIST. NO. 1 ILLINOIS FED.	

4. MARKERS SHOULD NOT BE USED ALONGSIDE CURBS EXCEPT FOR EXTREMELY SHORT SECTIONS OF CURBS WHERE NOT MORE THAN TWO MARKERS WOULD BE INVOLVED.

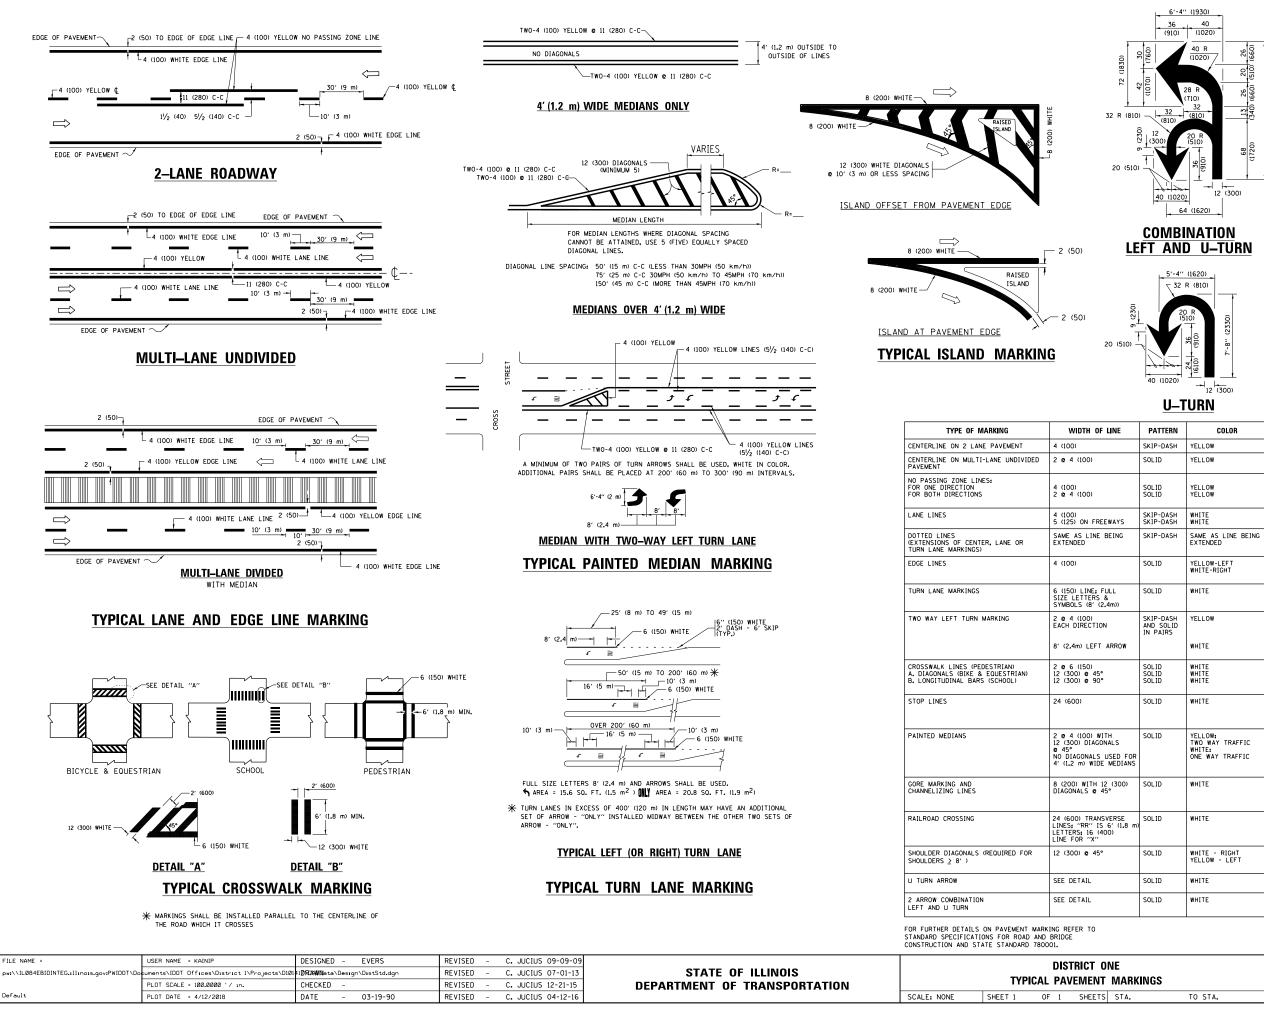

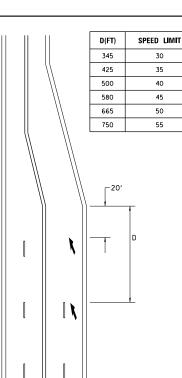


LANE REDUCTION TRANSITION

lane reduction arrows required at speeds of 45 MPH or greater or when specified in plans.

F LINE	PATTERN	COLOR	SPACING /REMARKS
	SKIP-DASH	YELLOW	10' (3 m) LINE WITH 30' (9 m) SPACE
	SOLID	YELLOW	11 (280) C-C
	SOLID SOLID	YELLOW YELLOW	5/2 (140) C-C FROM SKIP-DASH CENTERLINE 11 (280) C-C OMIT SKIP-DASH CENTERLINE BETWEEN
EEWAYS	SKIP-DASH SKIP-DASH	WHITE WHITE	10' (3 m) LINE WITH 30' (9 m) SPACE
BEING	SKIP-DASH	SAME AS LINE BEING EXTENDED	2' (600) LINE WITH 6' (1.8 m) SPACE
	SOLID	YELLOW-LEFT WHITE-RIGHT	OUTLINE MEDIANS IN YELLOW
FULL & 2.4m))	SOLID	WHITE	SEE TYPICAL TURN LANE MARKING DETAIL
ON ARROW	SKIP-DASH AND SOLID IN PAIRS	YELLOW	10' (3 m) LINE WITH 30' (9 m) SPACE FOR SKIP-DASH; 5½ (140) C-C BETWEEN SOLID LINE AND SKIP-DASH LINE SEE TYPICAL TWO-WAY LEFT TURN MARKING DETAIL
•	SOLID SOLID SOLID	WHITE WHITE WHITE	NOT LESS THAN 6' (1.8 m) APART 2' (600) APART 2' (600) APART SEE TYPICAL CROSSWALK MARKING DETAILS.
	SOLID	WHITE	PLACE 4' (1,2 m) IN ADVANCE OF AND PARALLEL TO CROSSWALK, IF PRESENT, OTHEWNISE, PLACE AT DESIRED STOPPING POINT. PARALLEL TO CROSSROAD CENTERLINE, WHERE POSSIBLE
ITH DNALS USED FOR E MEDIANS	SOLID	YELLOW: TWO WAY TRAFFIC WHITE: ONE WAY TRAFFIC	11 (280) C-C FOR THE DOUBLE LINE SEE TYPICAL PAINTED MEDIAN MARKING.
12 (300) 45°	SOLID	WHITE	DIAGONALS: 15' (4,5 m) C-C (LESS THAN 30MPH (50 km/h)) 20' (6 m) C-C 30MPH (50 km/h) TO 45MPH (70 km/h)) 30' (9 m) C-C (0VER 45MPH (70 km/h))
SVERSE 5 6' (1.8 m) 400)	SOLID	WHITE	SEE STATE STANDARD 780001 AREA OF: "R"=3.6 SO. FT. (0.33 m ²) EACH "X"=54.0 SO. FT. (5.0 m ²)
•	SOLID	WHITE - RIGHT YELLOW - LEFT	50' (15 m) C-C (LESS THAN 30MPH (50 km/h)) 75' (25 m) C-C (30 MPH (50 km/h) TO 45MPH (70 km/h)) 150' (45 m) C-C (0VER 45MPH (70 km/h))
	SOLID	WHITE	16.3 SF
	SOLID	WHITE	30.4 SF

All dimensions are in inches (millimeters) unless otherwise shown.

ONE				SECTION	COUNTY	TOTAL SHEETS	SHEET NO.				
IT MARKINGS			3512	3216B-BR(16)	соок	20	18				
	I MARKINGS			TC-13	CONTRACT	NO. 6	52D41				
TS	STA.	TO STA.		ILLINOIS FED. AID PROJECT							

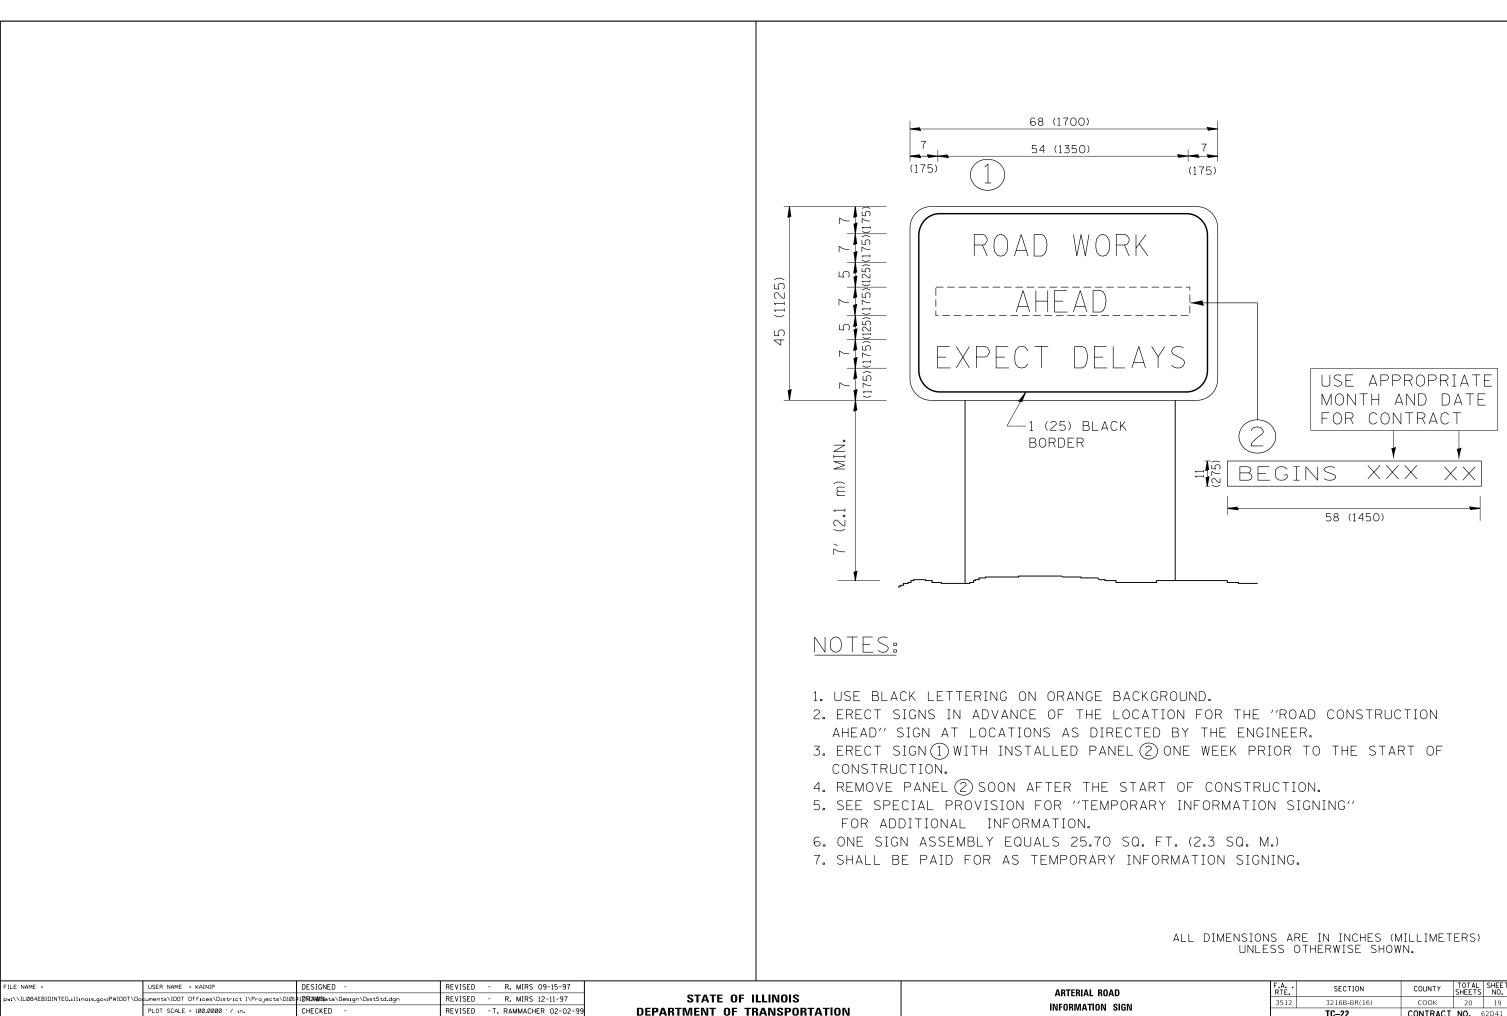


REVISED - C. JUCIUS 01-31-07

PLOT DATE = 4/12/2018

DATE

ROAD			F.A RTE.	SECTION	COUNTY	TOTAL SHEETS	SHEET NO.		
м	N SIGN			3216B-BR(16)	СООК	20	19		
IN				TC-22	CONTRACT	NO. 6	52D41		
	STA.	TO STA.	FED. ROAD DIST. NO. 1 ILLINOIS FED. AID PROJECT						

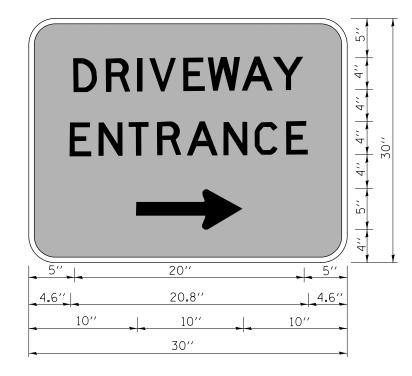

3.0" RADIUS, 0.5" BORDER, WHITE ON GREEN; REFLECTORIZED "DRIVEWAY" D; "ENTRANCE" D; STANDARD ARROW CUSTOM 12.0" × 5.0"

NOTES:

- 1. HALF OF THE SIGNS WILL REQUIRE A LEFT HAND FACING ARROW.
- 2. TWO SIGNS SHALL BE USED AT EACH COMMERCIAL ENTRANCE PLACED BACK-TO-BACK: ONE WITH A RIGHT HAND ARROW (SHOWN) SHALL BE PLACED ON THE NEAR RIGHT SIDE THE DRIVEWAY AND ONE WITH A LEFT HAND ARROW SHALL BE PLACED ON THE FAR LEFT SIDE OF THE DRIVEWAY.
- 3. SIGNS TO BE PAID FOR AS ITEM "TEMPORARY INFORMATION SIGNING".

FILE NAME = USER NAME = KAINI		USER NAME = KAINIP	DESIGNED -	REVISED - C. JUCIUS 02-15-07		DRIVEWAY ENTRANCE SIGNING			F.A RTF	SECTION	COUNTY	TOTAL SHEET
pw:\\ILØ84E	\L084EBIDINTEG.111no1s.gov:PWIDDT\Documents\IDDT_Offices\District_1\Projects\D101 <mark>110RX#Wo</mark> sta\Design\DistStd.dgn		REVISED -	STATE OF ILLINOIS	DRIVEWAT ENTRANCE SIGNING			3512	3216B-BR(16)	соок	20 20	
		PLOT SCALE = 100.0000 '/ in.	CHECKED -	REVISED -	DEPARTMENT OF TRANSPORTATION					TC-26	CONTRACT NO.	
		PLOT DATE = 4/12/2018	DATE -	REVISED -		SCALE: NONE	SHEET NO. 1 OF 1 SHEETS STA.	TO STA.	FED. ROAD D	AD DIST. NO. 1 ILLINOIS FED. AID PROJECT		