06-15-2018 LETTING ITEM 013

STATE OF ILLINOIS DEPARTMENT OF TRANSPORTATION

*741 2: 76 TOTAL SHEETS

D-91-073-17

PROPOSED HIGHWAY PLANS

FAP ROUTE 347 (ROOSEVELT RD.)

US 12/20/45 (MANNHEIM RD.) TO DES PLAINES AVE.

SECTION: 2016–084RS

PROJECT: NHPP-TCS3(711)

RESURFACING (3P), PEDESTRIAN RAMPS

COOK COUNTY

R 12 E

R 13 E

SUBMITTED MAI

LOCATION OF SECTION INDICATED THUS: -

DIRECTOR OF HIGHWAYS PROJECT MAPLEMENT

STATE OF ILLINOIS
DEPARTMENT OF TRANSPORTATION

PRINTED BY THE AUTHORITY OF THE STATE OF ILLINOIS

FOR INDEX OF SHEETS, SEE SHEET NO. 2

PROJECT IS LOCATED IN THE VILLAGES OF HILLSIDE, WESTCHESTER, BROADVIEW, MAYWOOD AND FOREST PARK

TRAFFIC DATA:
2015 ADT: 28,700
POSTED SPEED LIMIT: 30 MPH

0

0

0

<u>DESIGN DESIGNATION:</u> FAP 347 (ROOSEVELT ROAD): OTHER ARTERIAL

FULL SIZE PLANS HAVE BEEN PREPARED USING STANDARD ENGINEERING SCALES. IN MAKING MEASUREMENTS ON REDUCED PLANS, THE ABOVE SCALES MAY BE USED.

JULLIE.

JOINT UTILITY LOCATION INFORMATION FOR EXCAVATION 1-800-892-0123

-800-892-0123 R 811

PROJECT ENGINEER: DANIEL WILGREEN (847)–705–4240 PROJECT MANAGER: FAWAD AQUEEL (847)–705–4247

CONTRACT NO. 62D64

GROSS LENGTH = 17506.5 FT. = 3.32 MILE NET LENGTH = 15380.5 FT. = 2.91 MILE

INDEX OF	SHEETS	<u>s</u>	TATE STANDARDS (CONTINUED)		GENERAI	NOTES (CONTINUED)		
SHEET NO.	DESCRIPTION	STANDAR	D NO. DESCRIPTION		NOTE NO.	DESCRIPTION		
1	COVER SHEET	701606-10	URBAN SINGLE LANE CLOSURE, MULTILANE. 2W WITH MOUNTABLE MEDIAN		12	PAVEMENT MARKING TAPE, TYPE III SHALL BE USED FOR SHORT TERM PAVEMENT MARKINGS ON ALL FINAL		:
. 2	INDEX OF SHEETS, LIST OF STATE STANDARDS AND GENERAL NOTES	701611-01	URBAN HALF ROAD CLOSURE, MULTILANE, 2W WITH MOUNTABLE MEDIAN		. 13	SRUFACES.		
3-5 6-7	SUMMARY OF QUANTITIES TYPICAL SECTIONS	701701-10	URBAN LANE CLOSURE, MULTILANE INTERSECTION			THE CONTRACTOR SHALL CONTACT THE TRAFFIC CONTROL SUPERVISOR AT (847) 705-4470 A MINIMUM OF 72 HOURS PRIOR TO BEGINNING WORK		
8-13	PLAN AND PROFILE SHEETS	701801-06 701901-06	SIDEWALK, CORNER OR CROSSWALK CLOSURE TRAFFIC CONTROL DEVICES		14	THE RESIDENT ENGINEER SHALL CONTACT THE AREA TRAFFIC FIELD ENGINEER, PATRICE HARRIS AT PATRICE.HARRIS@ILLINDIS.GOV AT LEAST TWO (2) WEEKS PRIOR TO THE PLACEMENT OF PERMANENT PAVEMENT MARKINGS.		
14-52B	SIDEWALK & RAMP DETAILS	720001-01	SIGN PANEL MOUNTING DETAILS		15			
53-58 59	DETECTOR LOOP REPLACEMENT PLAN DRIVEWAY DETAILS - DISTANCE BETWEEN R.O.W. AND FACE OF CURB <15' (BD-02)	720006-04 728001-01	SIGN PANEL ERECTION DETAILS TELESCOPING STEEL SIGN SUPPORT		10	LOCATIONS OF PAVEMENT PATCHING AND CURB AND GUTTER REMOVAL AND REPLACEMENT WILL BE AS DETERMINED BY THTE ENGINEER.		
60	DETAILS FOR FRAMES AND LIDS ADJUSTMENT WITH	814001-03	HANDHOLES .		16	BUTT JOINTS WILL BE INSTALLED AT THE END OF ALL RESURFACING, (WHERE RESURFACING MEETS EXISTING PAVEMENT), IN ACCORDANCE THE "BUTT JOINT AND HMA TAPER DETAILS" INCLUDED IN THE PLANS, UNLESS OTHERWISE SPECIFIED		
61	PAVEMENT PATCHING FOR HMA SURFACED PAVEMENT					HMA TAPER DETAILS" INCLUDED IN THE PLANS, UNLESS OTHERWISE SPECIFIED		
62	(BD-22) CURB OR CURB AND GUTTER REMOVAL AND REPLACEMENT (BD-24)	GENERA	L NOTES		17	MATCH EXISTING PAVEMENT AT THE PROJECT LIMITS.		
63	REPLACEMENT (BD-24) BUTT JOINT AND HMA TAPER DETAILS (BD-32)	NOTE NO	2550000000			ALL DAMAMGE TO EXISTING PAVEMENT MARKINGS OUTSIDE THE REMOVAL LINE SHOWN ON THE PLANS SHALL BE REPLACED AT THE CONTRACOTORS EXPENSE.		
		NOTE NO.			. 19 .	THE CONTRACTOR SHALL BE RESPONSIBLE FOR CONTACTING OWNERS OF ALL UTILITITES PRIOR TO CONSTRUCTION TO DETERMINE THE LOCATION OF ALL UTILITY EQUIPMENT. THE CONTRACTOR SHALL COOPGERATE WITH ALL UTILITY OWNERS IN ACCORDANCE WITH THE STANDARD SPECIFICATIONS IF UTILITY RELOCATION, ADJUSTMENT, OR PROTECTION IS NECISSARY	·	
64	TRAFFIC CONTROL AND PROTECTION FOR SIDE ROADS. INTERSECTIONS, AND DRIVEWAYS (TC-10)	1	BEFORE STARTING ANY EXCAVATION, THE CONTRACTOR SHALL CALL "JULIE" (JOINT UTILITY LOCATION INFORMATION FOR EXCAVATION AT 8-1-1 OR (800) 892-0123 FOR FIELD LOCATION OF BURIED ELECTRIC, TELEPHONE, AND GAS FACILITIES (48 HOUR NOTIFICATION IS REQUIRED).	•		UTILITY EQUIPMENT. THE CONTRACTOR SHALL COOPGERATE WITH ALL UTILITY OWNERS IN ACCORDANCE WITH THE STANDARD SPECIFICATIONS		
65	TYPICAL APPLICATIONS RAISED REFLECTIVE PAVEMENT MARKERS (SNOW-PLOW RESISTANT) (TC-11)		(800) 892-0123 FOR FIELD LOCATION OF BURIED. ELECTRIC, TELEPHONE, AND GAS FACILITIES (48 HOUR NOTIFICATION IS REQUIRED).			IF UTILITY RELOCATION, ADJUSTMENT, OR PROTECTION IS NECISSARY		
66 67	DISTRICT ONE TYPICAL PAVEMENT MARKINGS (TC-13) TRAFFIC CONTROL AND PROTECTION AT TURN BAYS	2	10 FEET TRANSITIONS SHALL BE USED TO MATCH PROPOSED CURB AND GUTTER ITEMS OF WORK TO		, 20	THE LOCATION OF EXISTING DRAINAGE STRUCTURES, STORM SEWERS, WATER MAINS, SANITARY SEWERS, AND ANY OTHER PUBLIC OR PRIVATE UTILITIES AS SHOWN ON THE PLANS IS APPROXIMATE AND THEIR EXACT LOCATION IS TO BE DETERMINED IN THE FIELD BY THE CONTRACTOR.		
	(TO REMAIN OPEN TO TRAFFIC) (TC-14)		10 FEET TRANSITIONS SHALL BE USED TO MATCH PROPOSED CURB AND GUTTER ITEMS OF WORK TO EXISTING CURBS AND GUTTERS AND CONDITIONS IN THE FIELD UNLESS OTHERWISE SHOWN. THE TRANSITIONS SHALL BE PAID FOR AT THE CONTRACT UNIT PRICE FOR THE PROPOSED ITEMS OF WORK SPECIFIED.			SHOWN ON THE PLANS IS APPROXIMATE AND THEIR EXACT LOCATION IS TO BE DETERMINED IN THE FIELD BY THE CONTRACTOR.		
68	SHORT TERM PAVEMENT MARKING LETTERS AND SYBOLS FOR TRAFFIC STAGING (TC-16)		UNIT PRICE FOR THE PROPOSED ITEMS OF WORK SPECIFIED.		21			
69 · 70	ARTERIAL ROAD INFORMATION SIGN (TC-22) TYPICAL SUPPLEMENTAL SIGNING AND PAVEMENT MARKING TREATMENT FOR RAILROAD CROSSINS	3	THE CONTRACTOR SHALL COORDINATE CONSTRUCTION ACTIVITIES WITH UTILITY COMPANIES ALL MUNICIPALITIES WITHIN THE PROJECT LIMITS			THE CONTRACTOR SHALL BE RESPONSIBLE FOR THE PROTECTION OF ALL UNDERGROUND AND SURFACE UTILITIES EVEN THOUGH THEY MIGHT NOT BE SHOWN ON THE PLANS IS APPROXIMATE AND THEIR EXACT LOCATION IS TO BE DETERMINED IN THE FIELD BY THE CONTRACTOR.		
	(1C-23)	4			22	CONTRACTOR,		
71 72-73	DRIVEWAY ENTRANCE SIGNING (TC-26) DISTRICT 1 - STANDARD TRAFFIC SIGNAL DESIGN	4 . :	IN VARIOUS LOCATIONS THROUGHT THE PROJECT, EXISTING ASPHALT OVERLAYS THE EXISTING CONCRETE GUTTER FLAG. REMOVAL OF ASPHALT ON THE GUTTER FLAG SHALL BE INCLUDED IN THE UNIT COST OF HOT-MIX ASPHALT SURFACE REMOVAL, 21/2 INCH.			ANY LOOSE MATERIAL DEPOSITED IN THE FLOW LINE OF DRAINAGE STRUCTURES, WHICH OBSTRUCTS THE NATURAL FLOW OF WATER SHALL BE REMOVED AT THE CLOSE OF EACH WORKING DAY, PRIOR TO ACCEPTANCE OF THE IMPROVEMENT. ALL DRAINAGE STRUCTURES SHALL BE FREE OF DIRT AND DEBRIS. THIS WILL NOT BE PAID FOR SEPERATELY, BUT SHALL BE CONSIDERED AS INCLUDED IN THE UNIT BID PRICES OF THE CONTRACT.		
74	DETAILS (SHEET 1-2 OF 7) (TS-05) DETECTOR LOOP INSTALLATION DETAILS FOR		COST OF HOT-MIX ASPHALT SURFACE REMOVAL, 21/2 INCH.			OF THE IMPROVEMENT. ALL DRAINAGE STRUCTURES SHALL BE FREE OF DIRT AND DEBRIS. THIS WILL NOT BE PAID FOR SEPERATELY, BUT SHALL BE CONSIDERED		
	ROADWAY RESURFACING (TS-07)	5	THE CONTRACTOR WILL NOT BE ALLOWED TO SET UP A YARD OR FIELD OFFICE ON STATE PROPERTY WITHOUT WRITTEN PERMISSION FROM THE DEPARTMENT.					
		. 6			23	EXISTING BROKEN FRAMES AND LIDS SHALL BE REMOVED AND DISPOSED OF BY THE CONTRACTOR AND SHALL BE REPLACED AS DIRECTED BY THE		
			SAW CUTTING OF PAVEMENTS, SIDEWALK, CURB & GUTTER, ETC. SHALL BE TO FULL DEPTH AND SHALL RESULT IN A CLEAN STRAIGHT EDGE ON THE PORTION REMAINING. ALL SAW CUTTING SHALL BE CONSIDERED INCLUDED IN THE COST OF THE ITEM REMOVED			AND SHALL BE REPLACED AS DIRECTED BY THE ENGINEER. REPOLACEMENT FRAMES AND LIDS WILL BE PAID FOR ACCORDING TO ARTICLE 109,04 OF THE STANDARD SPECIFICATIONS UNLESS A SEPERATE PAY ITEM HAS BEEN PROVIDED.		÷.
STATE	STANDARDS	7	DO NOT SCALE PLANS FOR CONSTRUCTION DIMENSIONS		24			
STANDARD NO	DESCRIPTION	8	THE CONTRACTOR SHALL LISE CARE IN DEMOVING OR			FOR WORK OUTSIDE THE LIMITS OF THE BRIDGE APPROACH PAVEMENT, ALL REFERENCES IN THE HIGHWAY STANDARDS AND STANDARD SPECIFICATIONS FOR REINFORCEMENT, DOWEL BARS AND TIE BARS IN PAVEMENT, SHOULDERS, CURB, GUTTER, COMBINATION CURB AND GUTTER ANDMEDIAN, AND CHAIR SLPPORTS FOR CRC PAVEMENT, SHALL BE EPOXY COATED		
000001-06	STANDARD SYMBOLS, ABBREVIATIONS AND PATTERNS		EXCAVATING NEAR ALL EXISTING ITEMS WHICH WILL REMAIN. ANY DAMAGE DONE TO EXISTING ITEMS BY THE CONTRACTOR SHALL BE REPAIRED AT THE CONTRACTOR'S EXPENSE.			PAVEMENT, SHOULDERS, CURE, GUTTER, COMBINATION CURB AND GUTTER ANDMEDIAN, AND CHAIR SUPPORTS FOR CRC PAVEMENT,SHALL BE EPOXY COATED		
424001-09 424011-03	PERPENDICULAR CURB RAMPS CORNER PARALLEL CURB RAMPS FOR SIDEWALKS	9	BUIER MILLED DAVENEUT 10 ABOUT 10 TRACETA THE					
424021-03	DEPRESSED CORNER FOR SIDEWALKS		WHEN MILLED PAVEMENT IS OPEN TO EXAFTL, THE MAXIMUM GRADE DIFFERENTIAL, BETWEEN PASSES OF THE MILLING MACHING SHALL NOT EXCEED 1.5 INCHES WHERE THE SPEED LIMIT IS 40 MPH OR LESS, WITH WRITTEN APPROVAL FROM THE ENGINEER, A MAXIMUM GRAD DIFFERENTIAL OF 3 INCHES MAY BE ALLOWED IF THE EDGE OF MILLING IS SLOPED A MINUMUM OF			(x,y) = (x,y)		
442201-03 604001-04	CLASS C AND D PATCHES FRAME AND LIDS TYPE 1		GRAD DIFFERENTIAL OF 3 INCHES MAY BE ALLOWED IF THE EDGE OF MILLING IS SLOPED A MINUMUM OF 1:3 (V:H)					
604086-03	FRAME AND GRATE TYPE 23	10 •	UNLESS OTHER CONDITIONS WARRANT EXTENDED LANE CLOSURES AS DETERMINED AND APPROVED IN					
606001-06	CONCRETE CURB TYPE B AND COMBINATION CONCRETE CURB AND GUTTER		WRITING BY THE ENGINEER OR AS PROVIDED FOR IN WRITING BY THE ENGINEER OR AS PROVIDED FOR IN THE CONTRACT SPECIFICATIONS, OVERNIGHT					
606301-04	PC CONCRETE ISLANDS AND MEDIANS	•	UNLESS OTHER CONDITIONS WARRANT EXTENDED LANE CLOSURES AS DETERMINED AND APPROVED IN WRITING BY THE ENGINEER OR AS PROVIDED FOR IN WRITING BY THE ENGINEER OR AS PROVIDED FOR IN THE CONTRACT SPECIFICATIONS, OVERNIGHT CLOSURES WHALL NOT BE ALLOWED FOR REHABILITATION PROJECTS INVOLVING DAYTIME MILLING AND RESURFACING OPERATIONS AND CLASS D PATCHING.					
606306-04 701101-05	CORRUGATED PC CONCRETE MEDIANS OFF-RD OPERATIONS, MULTILANE, 15' (4.5 m) TO 24"	. 11	U PATCHING. BEFORE BEGINNING ANY WORK. THE CONTRACTOR					
701427-05	(600 mm) FROM PAVEMENT EDGE	: .	BEFORE BEGINNING ANY WORK. THE CONTRACTOR SHALL RETAIN AND RECORD FOR FUTURE REFERENCE ALL EXISTING PAVEMENT MARKING LINES AND RAISED REFLECTIVE PAVEMENT MARKERS IN ORDER THAT THESE LOCATIONS CAN BE RE-ESTABLISHED FOR STRIPING. EXACT LOCATIONS OF ALL PAVEMENT MARKING SHALL BE AS DIRECTED BY THE ENGINEER.					
701602-08	LANE CLOSURE, MULTILANE, DAY OPERATIONS ONLY, FOR SPEEDS <= 40 MPH URBAN LANE CLOSURE, MULTILANE, 2W WITH		THESE LOCATIONS CAN BE RE-ESTABLISHED FOR STRIPING. EXACT LOCATIONS OF ALL PAVEMENT MARKING SHALL BE AS DIRECTED BY THE ENGINEER.					
	BIDIRECTIONAL LEFT TURN LANE			<u> </u>	· · · · · · · · · · · · · · · · · · ·			
ILE NAME = n::\\IL 98 4EBIDINTEG.1111no1s.gov		- : :	STATE OF ILLINOIS	1	•) MANNHEIM RD. TO DES PLANES STANDARDS & GENERAL NOTES F.A.P. SECTION 347 2016-084RS	COUNTY TOTAL SHEET NO.	
Default .	PLOT SCALE : 100.00000 '/ in. CHECKED - REVISED PLOT DATE : 4/27/2018 DATE - REVISED		DEPARTMENT OF TRANSPORTATION	SCALE:	SHEET OF	SHEETS STA. TO STA. ILLINOIS FED.	CONTRACT NO. 62064	ьI
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MRBAN urban CONSTRUCTION TYPE CODE CONSTRUCTION TYPE CODE SUMMARY OF QUANTITIES SUMMARY OF QUANTITIES 80% FED 80% FED TOTAL TOTAL QUANTITIES 20% STATE QUANTITIES 20% STATE ITEM UNIT CODE NO ITEM UNIT CODE NO 0005 0005 HOT-MIX ASPHALT REPLACEMENT OVER TON 327 TREE REMOVAL (6 TO 15 UNITS DIAMETER) UNIT 40 40601005 327 20100110 PATCHES 20100210 TREE REMOVAL (OVER 15 UNITS DIAMETER) UNIT 40 40 40603335 HOT-MIX ASPHALT SURFACE COURSE, MIX 11 11 199 199 20200100 EARTH EXCAVATION CU YD "D", N50 20800150 TRENCH BACKFILL CU YD 10 40603565 POLYMERIZED HOT-MIX ASPHALT SURFACE 10345 10345 21101625 TOPSOIL FURNISH AND PLACE, 6" SQ YD 713 713 COURSE, MIX "E", N70 25000400 NITROGEN FERTILIZER NUTRIENT POUND 14 42001300 PROTECTIVE COAT SQ YD 3323 3323 PHOSPHORUS FERTILIZER NUTRIENT POUND 14 25000500 14 PORTLAND CEMENT CONCRETE SIDEWALK 5 SQ FT 24411 24411 POTASSIUM FERTILIZER NUTRIENT INCH 25000600 POUND 14 14 25200110 SODDING, SALT TOLERANT SO YD 713 713 42400800 DETECTABLE WARNINGS SO FT 1450 1450 SUPPLEMENTAL WATERING 44000159 HOT-MIX ASPHALT SURFACE REMOVAL, 2 SQ YD 105561 105561 25200200 33 33 1/2" AGGREGATE SUBGRADE IMPROVEMENT 3030*0*001 CU 4D 35501316 HOT-MIX ASPHALT BASE COURSE. 8" 92 92 44000200 DRIVEWAY PAVEMENT REMOVAL SQ YD 92 92 40600290 BITUMINOUS MATERIALS (TACK COAT) 71254 71254 44000600 SIDEWALK REMOVAL SQ FT 24826 24826 40600400 MIXTURE FOR CRACKS, JOINTS, AND 157 157 FLANGEWAYS 44002216 HOT-MIX ASPHALT REMOVAL OVER PATCHES, SQ YD 1460 1460 4" 40600827 POLYMERIZED LEVELING BINDER (MACHINE TON 4433 4433 METHOD), IL-4.75, N50 44201761 CLASS D PATCHES, TYPE I, 10 INCH SQ YD 17 17 44201765 CLASS D PATCHES, TYPE II. 10 INCH 40600982 HOT-MIX ASPHALT SURFACE REMOVAL - BUTT SO YD 281 281 SQ YD 769 769 JOINT * = SPECIALTY ITEMS 44201769 | CLASS D PATCHES, TYPE III. 10 INCH SQ YD 148 148 FILE NAME = DESIGNED -REVISED USER NAME = curryow SECTION COUNTY STATE OF ILLINOIS Offices\District NProjects\Di073f7\CADData\Design\Di073**7-设积外面i**lign -REVISED CDOK 74 3 347 2016-084RS **SUMMARY OF QUANTITIES** CHECKED -REVISED **DEPARTMENT OF TRANSPORTATION** PLOT SCALE = 100,0000 1/ In. CONTRACT NO. 62064 DATE -REVISED -SHEET NO. OF SHEETS STA. TO STA. PLOT DATE = 3/22/2018 FED. ROAD DIST. NO. 1 ILLINOIS FED. AID PROJECT

			urban											urban						
	SUMMARY OF QUANTITIES				CC	NSTRUCTIO	ON TYPE C	CODE			SUMMAF	RY OF QUANTITIES				CC	NSTRUCTIO	N TYPE CO	DE	[
CODE NO	ITEM	UNIT	TOTAL CUANTITIES	80% FED 20% STATE 0005						CODE NO		ITEM	UNIT	TOTAL QUANTITIES	80% FED 20% STATE 0005			į		
44201771	CLASS D PATCHES, TYPE IV, 10 INCH	SQ YD	343	343						70102632	TRAFFIC CONT	ROL AND PROTECTION,	L SUM	1	1					
550 A 0050	STORM SEWERS CLASS A, TYPE I, 12"	PT	83	83							STANDARD 701	602								
60253000	CATCH BASINS TO BE RECONSTRUCTED WITH	EACH	1	1																
	NEW TYPE 1 FRAME, OPEN LID			***						70102634	TRAFFIC CONT	ROL AND PROTECTION.	L SUM	1	1					
											STANDARD 701	611								
60255800	MANHOLES TO BE ADJUSTED WITH NEW TYPE 1	EACH	2	2	· .								******							
	FRAME, CLOSED LID				:		ļ	ļ		70102635	TRAFFIC CONT	ROL AND PROTECTION,	LSUM	- 1	1					
											STANDARD 701	701								
60258100	MANHOLES TO BE RECONSTRUCTED WITH NEW	EACH	1	1																
	TYPE 1 FRAME, OPEN LID									70102640	TRAFFIC CONT	ROL AND PROTECTION,	LSUM	1	1			-		
6026154D	INLETS TO BE ADJUSTED WINEW TYPE 24 F & G	EACH	2	2							STANDARD 701	801								
60262700	INLETS TO BE RECONSTRUCTED	EACH	2	2	:															
					·					70300100	SHORT TERM P	AVEMENT MARKING	FOOT	11786	11786					
60266600	VALVE BOXES TO BE ADJUSTED	EACH	9	9	:					-										
					:		-			70300150	SHORT TERM P	AVEMENT MARKING REMOVAL	SO FT	3929	3929					
60300105	FRAMES AND GRATES TO BE ADJUSTED	EACH	3	3														. =		
					-					70300210		VEMENT MARKING LETTERS AND	SO FT	871	871					
60300305	FRAMES AND LIDS TO BE ADJUSTED	EACH	27	27			<u>.</u>				SYMBOLS					<u> </u>				
1																				
* 66900200	NON-SPECIAL WASTE DISPOSAL	CU YD	all	all						70300220	TEMPORARY PA	VEMENT MARKING - LINE 4"	FOOT	62708	62708					
					:					70700740	TEMPORARY DA	VENEZIT MADVING CANE CV		10580	10500	-				
* 66900450	SPECIAL WASTE PLANS AND REPORTS	L SUM	1	1						70300240	IEMPURART PA	VEMENT MARKING - LINE 6"	FOOT	10589	10589					
¥ 66666	COLL DISPOSAL LIVER SEE	F.60	1.5	15						70300260	TEMPODARY RA	VEMENT MARKING - LINE 12"	FOOT	908	908					
* 66900530		EACH	15	15		-				70300280	IZWEQNANT PA	EINE IZ			300					
	ENGINEER'S FIELD OFFICE, TYPE A	CAL MO	12	12	:			1		70300280	TEMPORARY PA	VEMENT MARKING - LINE 24"	FOOT	674	674					
67100100	MOBILIZATION	Laum	1	1	:					.0300200	Table Wisels I P	market ma	1.001			}				
70102625	TRAFFIC CONTROL AND PROTECTION.	L SUM	1	1	:		+			70300520	PAVEMENT MAR	RKING TAPE, TYPE III 4"	FOOT	5893	5893					
.5102023	STANDARD 701606	2	•					****		-						1				-
										★ 72400200	REMOVE SIGN	PANEL ASSEMBLY - TYPE B	EACH	4	4					
\ ^^{					:					(3)								* =	SPECIALT	TITEMS
FILE NAME =	USER NAME = outryow DE	SIGNED -		REVISED	<u></u>					1 1 '						F.A.P RTE.	SECTI	ON	COUNTY	TOTAL SHEET
1		RAMMAGN - HECKED -		REVISED REVISED	-				TATE OF	ILLINOIS Fransport <i>i</i>	TION .	SUMMAF	RY OF QUANT	ITIES		347	2016-0	34RS	COOK CONTRACT	TOTAL SHEET SHEETS NO. 74 4
		ATE -		REVISED	÷			AN (IY)				SCALE: SHEET NO. OF			TO STA.	FED. R	OAD DIST. NO. 1			NO. 62064

urban URBAN CONSTRUCTION TYPE CODE CONSTRUCTION TYPE CODE SUMMARY OF QUANTITIES SUMMARY OF QUANTITIES 80% FED 80% FED TOTAL TOTAL QUANTITIES 20% STATE 0005 QUANTITIES 20% STATE ITEM UNIT CODE NO ITEM UNIT CODE NO 0005 RELOCATE EXISTING PEDESTRIAN SQ FT 81 81 89500400 EACH 27 72400310 REMOVE SIGN PANEL - TYPE 1 27 PUSH-BUTTON RELOCATE SIGN PANEL ASSEMBLY - TYPE B EACH 4 4 72400600 89502376 REBUILD EXISTING HANDHOLE EACH 25 25 72400710 RELOCATE SIGN PANEL - TYPE 1 SO FT 81 81 X0320050 CONSTRUCTION LAYOUT (SPECIAL) LSUM 1 78000100 THERMOPLASTIC PAVEMENT MARKING -SQ FT 871 871 REMOVE AND REINSTALL BRICK PAVER SQ FT LETTERS AND SYMBOLS X0327611 51 51 78000200 THERMOPLASTIC PAVEMENT MARKING - LINE FOOT 62708 62708 X5537800 STORM SEWERS TO BE CLEANED 12" FOOT 272 272 X6030310 FRAMES AND LIDS TO BE ADJUSTED EACH 178 178 THERMOPLASTIC PAVEMENT MARKING - LINE (SPECIAL) 78000400 F00T 10589 10589 X7030005 TEMPORARY PAVEMENT MARKING REMOVAL SQ FT 28653 28653 78000600 THERMOPLASTIC PAVEMENT MARKING - LINE F00T 908 908 12" REBUILD EXISTING HANDHOLE, SPECIAL EACH 78000650 THERMOPLASTIC PAVEMENT MARKING - LINE 674 674 Z0004562 COMBINATION CONCRETE CURB AND GUTTER FOOT 4726 4726 REMOVAL AND REPLACEMENT DRAINAGE STRUCTURES TO BE CLEANED 20018500 50 EACH 78100100 RAISED REFLECTIVE PAVEMENT MARKER EACH 1573 1573 Z0030850 TEMPORARY INFORMATION SIGNING SQ FT 52 52 78300200 RAISED REFLECTIVE PAVEMENT MARKER EACH 1573 1573 RAILROAD PROTECTIVE LIABILITY INSURANCE LSUM REMOVAL Z0064800 SELECTIVE CLEARING UNIT 2 2 8 8 85000200 MAINTENANCE OF EXISTING TRAFFIC SIGNAL EACH INSTALLATION 60208240 CATCH BASINS, TYPE C, TYPE 24 FRAME AND GRATE 88600600 DETECTOR LOOP REPLACEMENT FOOT 2253 2253 \$ 20076600 TRAINEES HOUR 500 500 Ø= 0042 * = SPECIALTY ITEMS DE ZOOTGGOY TRAINEES TRAINING PROGRAM GRADUATE 500 HOUR 100% STATE □ = TOTAL SHEET SHEETS NO. FILE NAME = USER NAME = curryow DESIGNED -REVISED -COUNTY SECTION STATE OF ILLINOIS Offices-District NProjects/Di073I7\CADOctol:Design\Di073**7-@R\$006i**gn -REVISED COOK 347 2016-084RS 74 5 **SUMMARY OF QUANTITIES** PLOT SCALE = 100.0071" / In. CHECKED -REVISED -**DEPARTMENT OF TRANSPORTATION** CONTRACT NO. 62D64 PLOT DATE = 3/22/2018 DATE -REVISED -SHEET NO. OF SHEETS STA. TO STA. FED. ROAD DIST. NO. 1 ILLINOIS FED. AID PROJECT

REV

HOT-MIX ASPHALT MIXTURE REQUIREMENTS

MIXTURE TYPE	AIR VOIDS (%) @ Ndes	OMP
-PAVEMENT RESURFACING-		
POLYMERIZED HOT-MIX ASPHALT SURFACE COURSE, MIX"E", N70 IL-9.5MM	4.0% @ 70 GYR.	PFP
POLYMERIZED LEVELING BINDER (MACHINE METHOD), IL-4.75 N50	3.5% @ 50 GYR.	QCP
-DRIVEWAYS-		
HMA SURFACE COURSE, MIX D, N50 (IL 9.5 mm); 2"	4% @ 50 GYR.	QC/QA
HMA BASE COURSE (HMA BINDER IL-19 mm); PE - 6", CE - 8"	4% @ 50 GYR.	QC/QA
-PATCHING-		
CLASS D PATCH (HMA BINDER IL-19 mm)	4% @ 70 GYR.	QC/QA
HMA REPLACEMENT OVER PATCHES (HMA BINDER IL-19 mm)	4% @ 70 GYR.	QC/QA

OMP DESIGNATION: QUALITY CONTROL/QUALITY ASSURANCE (QC/QA); QUALITY CONTROL FOR PERFORMANCE (QCP)

NOTES

QUALITY MANAGEMENT PROGRAM (QMP) ITDENTIFIES THE PARTICULAR QUALITY CONTROL SPECIFICATION THAT APPLIES TO THE HMA MIXTURE

THE UNIT WEIGHT USED TO CALCULATE ALL HOT-MIX ASPHALT SURFACE MIXTURE QUANTITIES IS 112 LBS/SQYD/IN

THE "AC TYPE" FOR POLYMERIZED HMA MIXTURES SHALL BE "SBS/SBR PG 76-22"
AND FOR NON-POLYMERIZED HMA THE "AC TYPE" SHALL BE "PG 64-22" UNLESS MODIFIED BY DISTRICT ONE SPECIAL PROVISIONS.

FOR USE OF RECYCLED MATERIALS SEE DISTRICT ONE SPECIAL PROVISIONS


PATCHING SHALL BE DONE PRIOR TO MILLING

LEGEND (EXISTING)


- (A) EXIST. P.C. CONCRETE PAVEMENT, ± 10"
- (B) EXIST. HOT-MIX ASPHALT (BEFORE MILLING), ± 4"
- (C) EXIST. CONCRETE CURB AND GUTTER TYP B-6. 12
- (D) EXISTING PC CONCRETE MEDIAN

LEGEND (PROPOSED)

- (1) PROP. HOT-MIX ASPHALT SURFACE REMOVAL 2 1/2"
- (2) PROP. POLYMERIZED HOT-MIX ASPHALT SURFACE COURSE, MIX "E", N70, 1 3/4"
- (3) PROP. POLYMERIZED LEVELING BINDER (MM), IL-4.75, N50, 3/4"

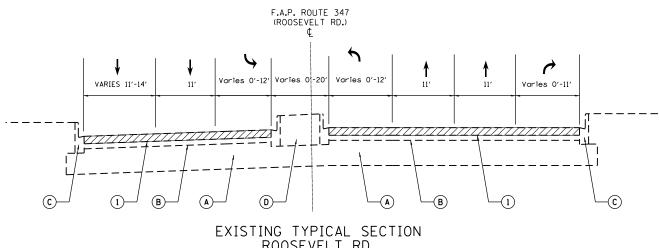

ROOSEVELT RD.
STATIONS:
1+75 TO 22+68

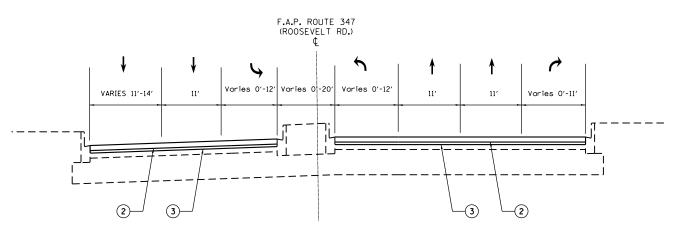

PROPOSED TYPICAL SECTION ROOSEVELT RD. STATIONS: 1+75 TO 22+68

- 1	FILE NAME =	USER NAME = curryaw	DESIGNED -	REVISED -
- 1	pw:\\IL084EBIDINTEG.illinois.gov:PWIDOT\Documen	s\IDOT Offices\District 1\Projects\D107317\CADData\De	ig D.B.A.W.N. 7-sht-typical.dgn	REVISED -
- 1		PLOT SCALE = 100.0000 ' / in.	CHECKED -	REVISED -
L	Default	PLOT DATE = 3/16/2018	DATE -	REVISED -

STATE OF ILLINOIS DEPARTMENT OF TRANSPORTATION	FAP
DEI ARTIVIERI OF TRANSFORTATION	
	SCALE:


P 347 RO	347 ROOSEVELT ROAD - MANNHEIM ROAD TO DESPLAINES ROAD						SECTION			COUNTY	TOTAL SHEETS	SHEET NO.	
	TYPICAL SECTIONS							2016-084RS			74	6	
	TIFICAL SECTIONS										NO.	62D64	
	SHEET	OF	SHEETS	STA.	TO STA.	ILLINOIS FED. A		FED. AI	D PROJECT				

LEGEND (EXISTING)


- (A) EXIST. P.C. CONCRETE PAVEMENT, ± 10"
- (B) EXIST. HOT-MIX ASPHALT (BEFORE MILLING), ± 4"
- (C) EXIST. CONCRETE CURB AND GUTTER TYP B-6. 12
- (D) EXISTING PC CONCRETE MEDIAN

LEGEND (PROPOSED)

- (1) PROP. HOT-MIX ASPHALT SURFACE REMOVAL 2 1/2"
- (2) PROP. POLYMERIZED HOT-MIX ASPHALT SURFACE COURSE, MIX "E", N70, 1 3/4"
- (3) PROP. POLYMERIZED LEVELING BINDER (MM), IL-4.75, N50, 3/4"

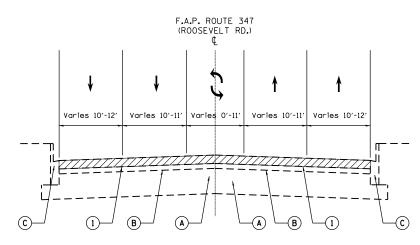

EXISTING TYPICAL SECTION ROOSEVELT RD. STATIONS: 22+68 TO 41+74 51+08 TO 131+00 140+71 TO 152+21 154+42 TO 176+82

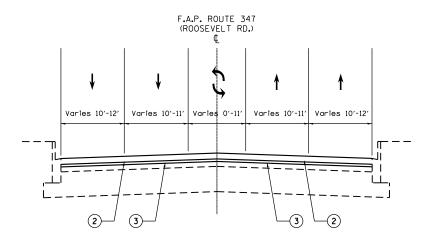



EXISTING TYPICAL SECTION ROOSEVELT RD. STATIONS: 22+68 TO 41+74 51+08 TO 131+00 140+71 TO 152+21 154+42 TO 176+82


FILE NAME =	USER NAME = curryaw	DESIGNED -	REVISED -		
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Default	PLOT DATE = 3/16/2018	DATE -	REVISED -		


FAP 347 RO	0SEVELT		ANNHEIN AL SECTI		O TO DESPLAINES ROAD
SCALE:	SHEET	OF	SHEETS	STA.	TO STA.


F.A. RTE	SECT	ION		COUNTY	TOTAL SHEETS	SHEET NO.
347	2016-0)84RS		COOK	74	7
				CONTRACT	NO.	52D64
		ILLINOIS	FED. A	ID PROJECT		

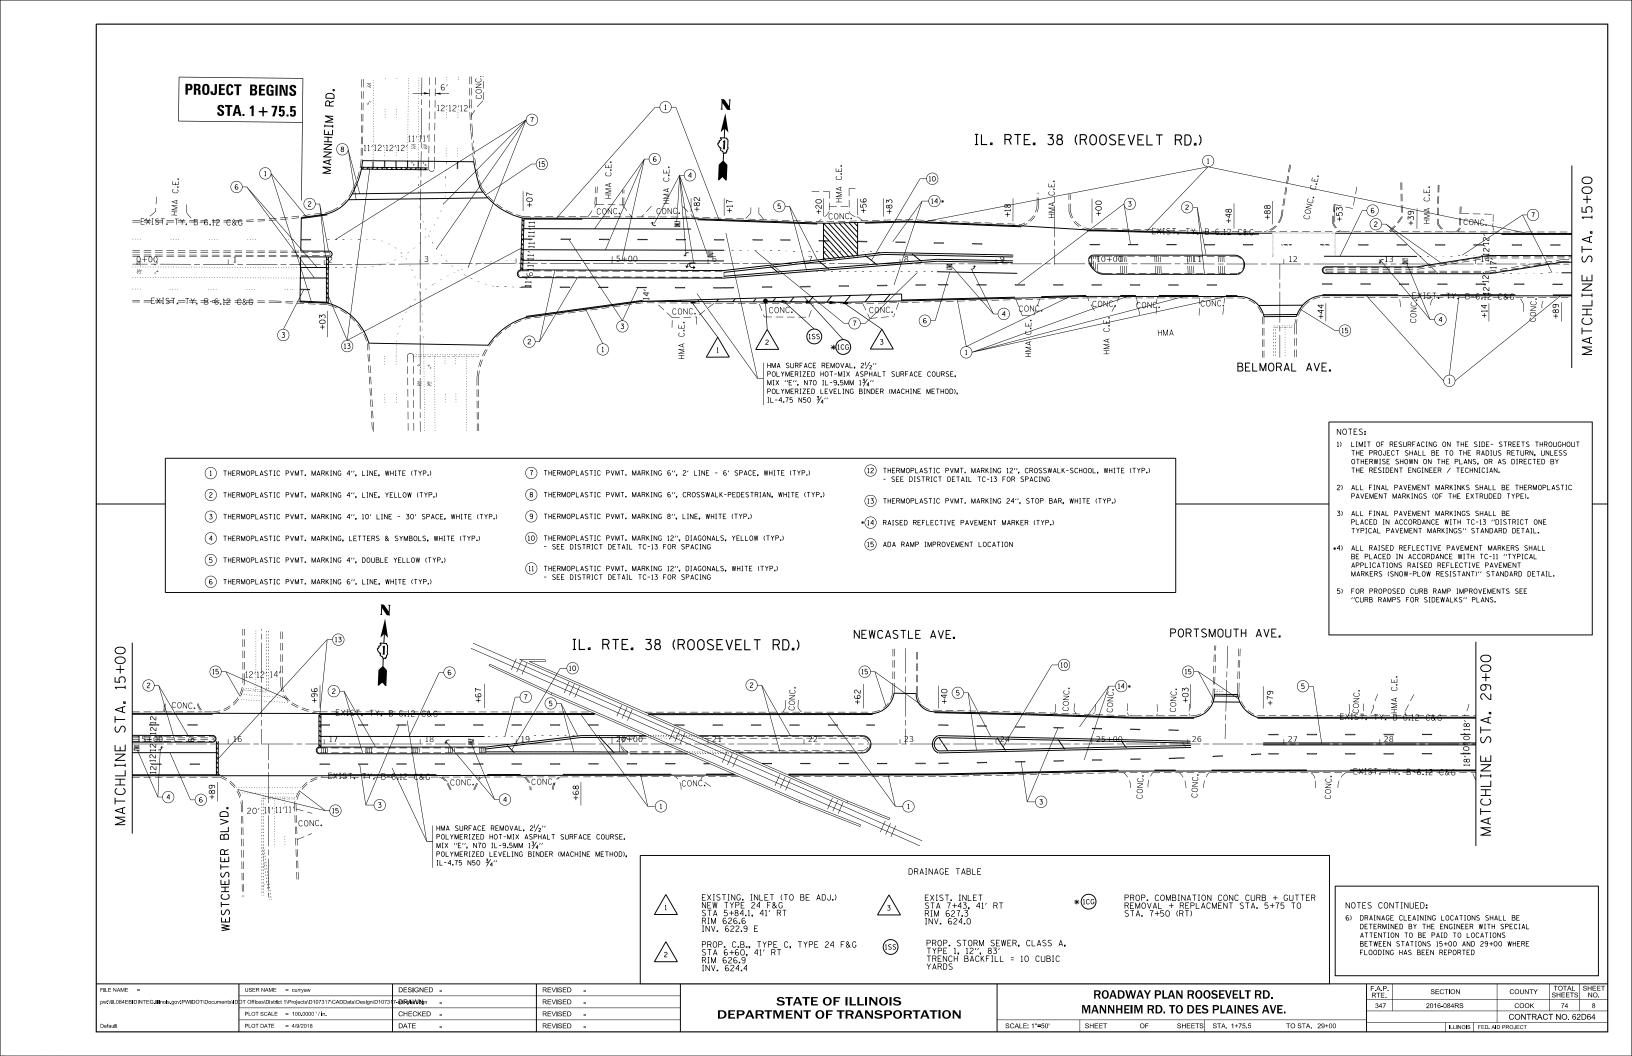


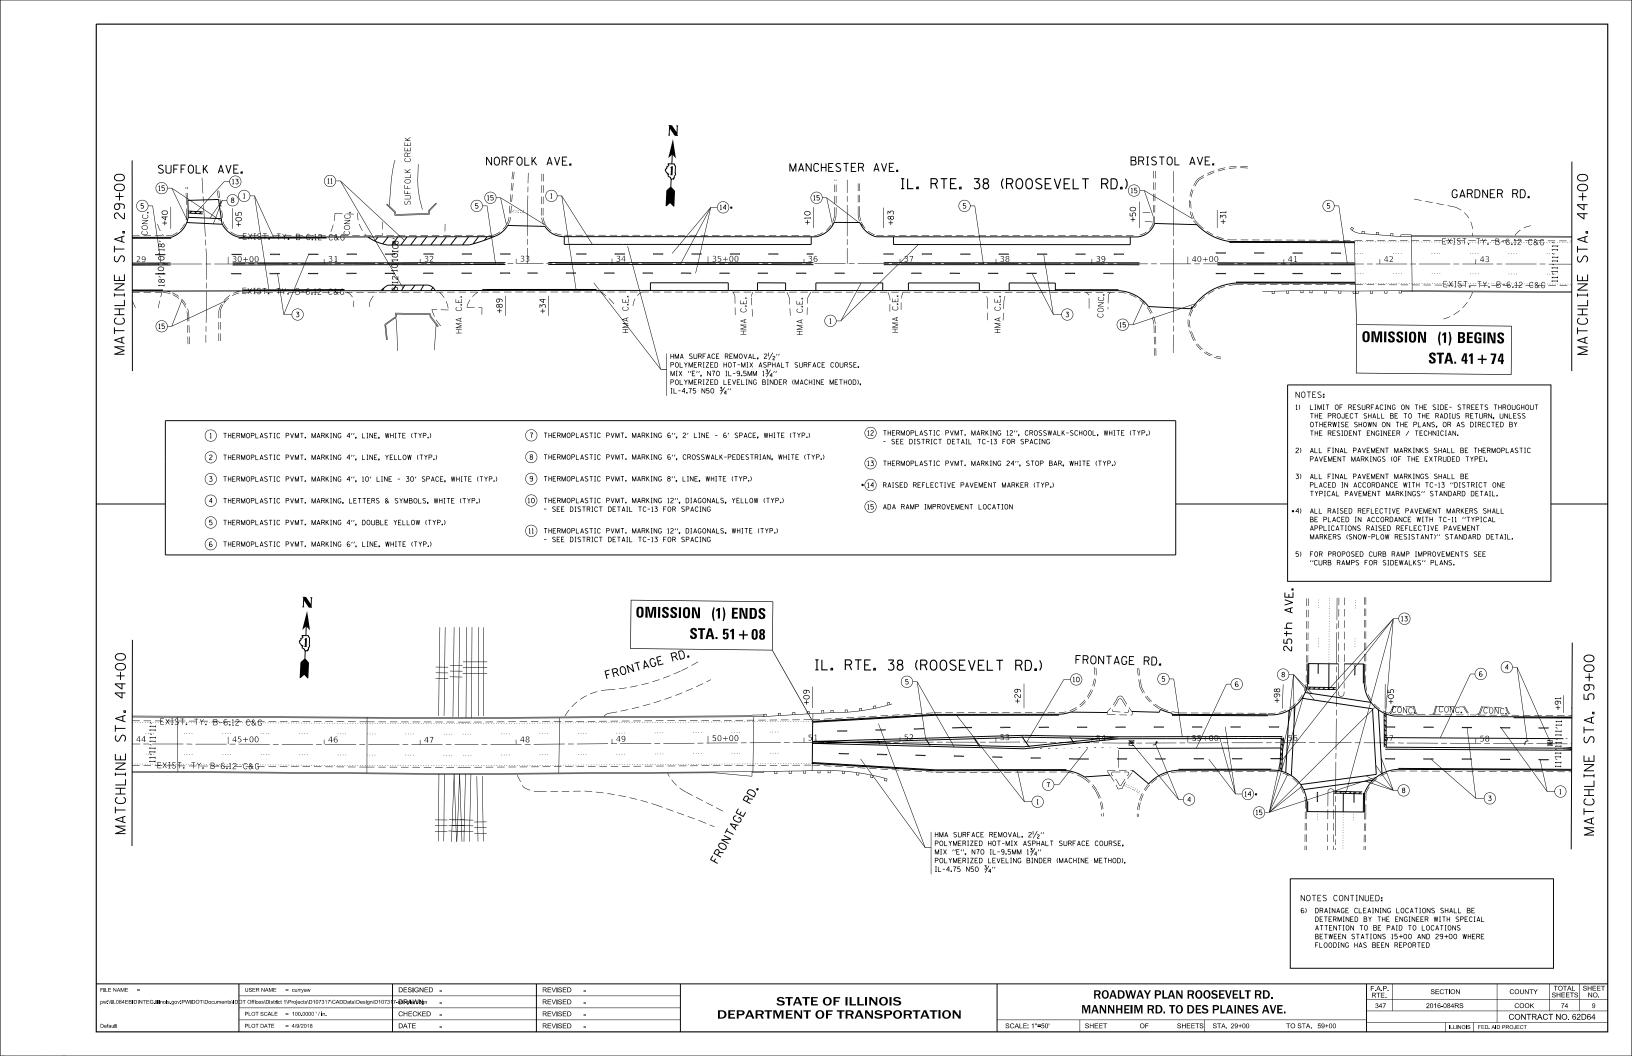


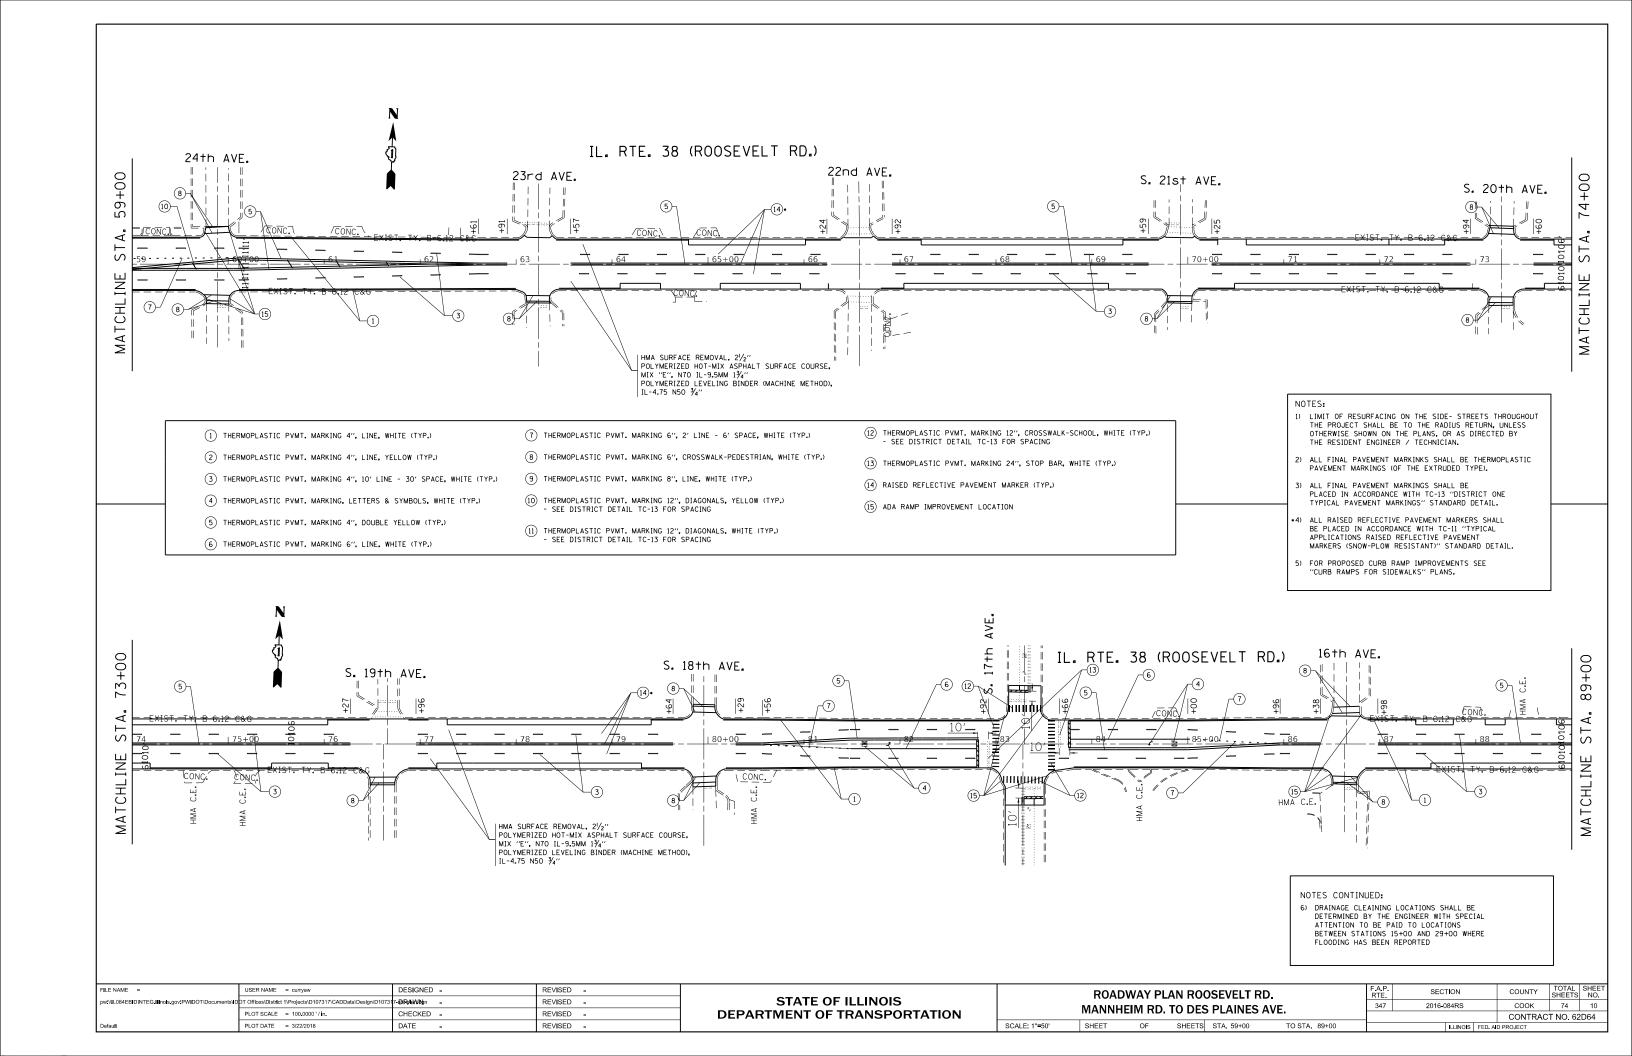


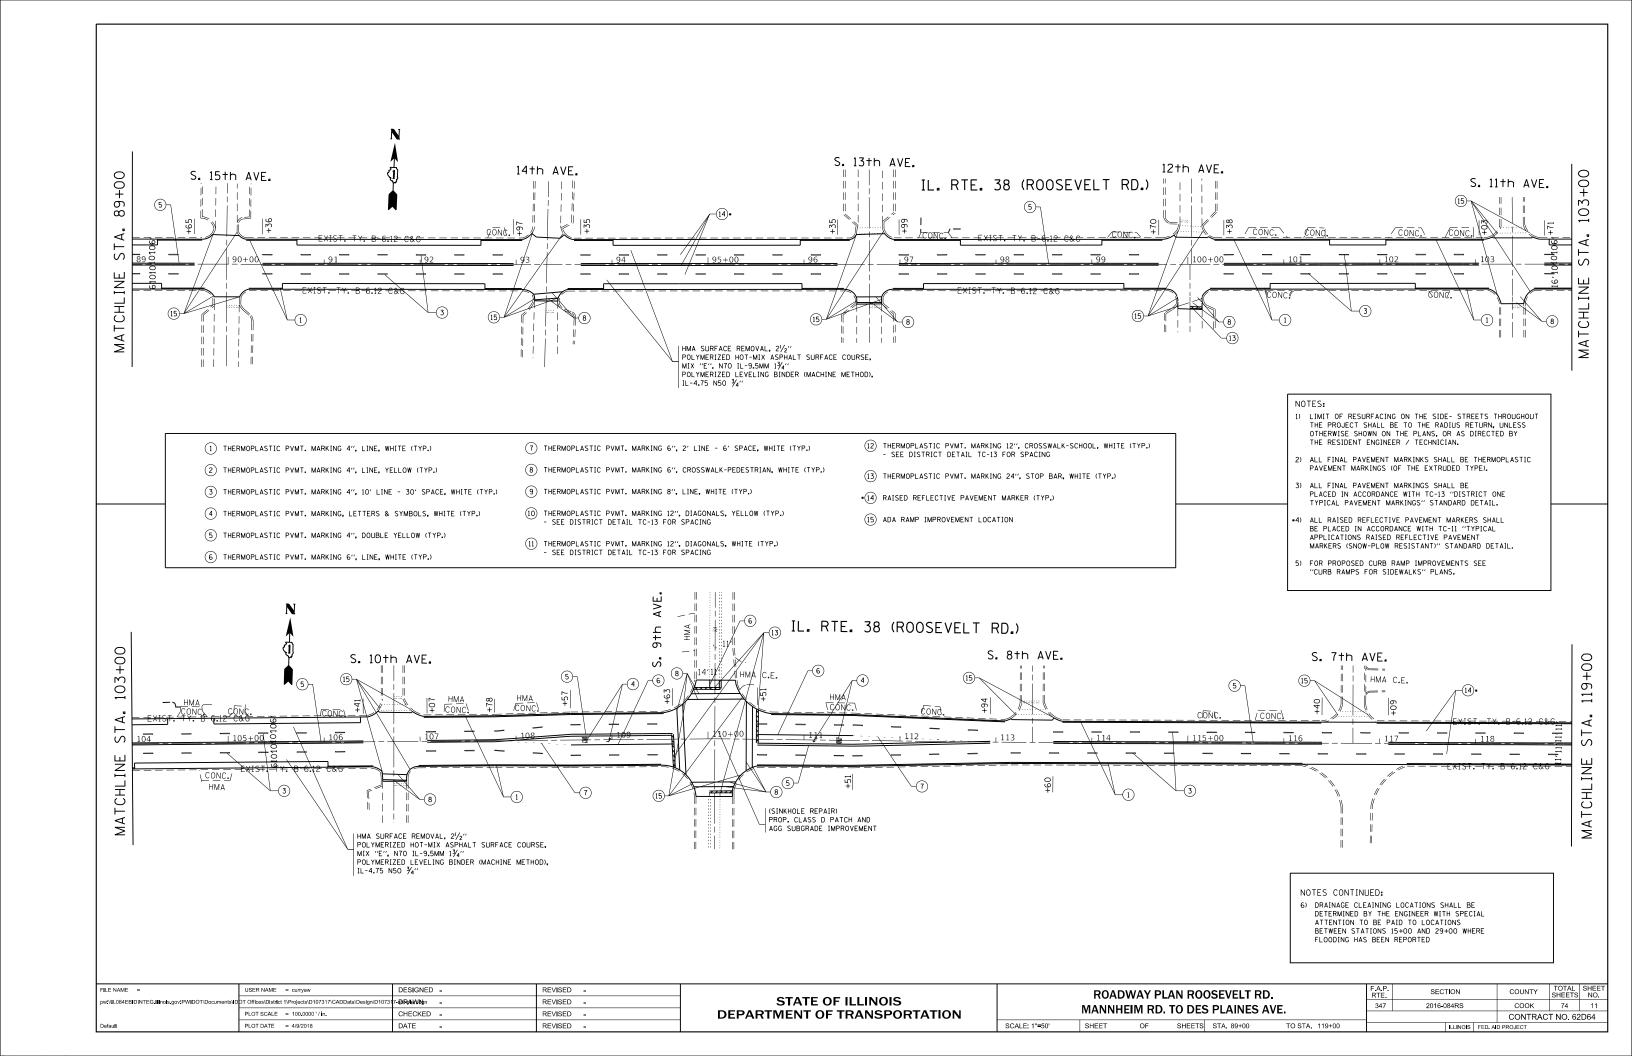

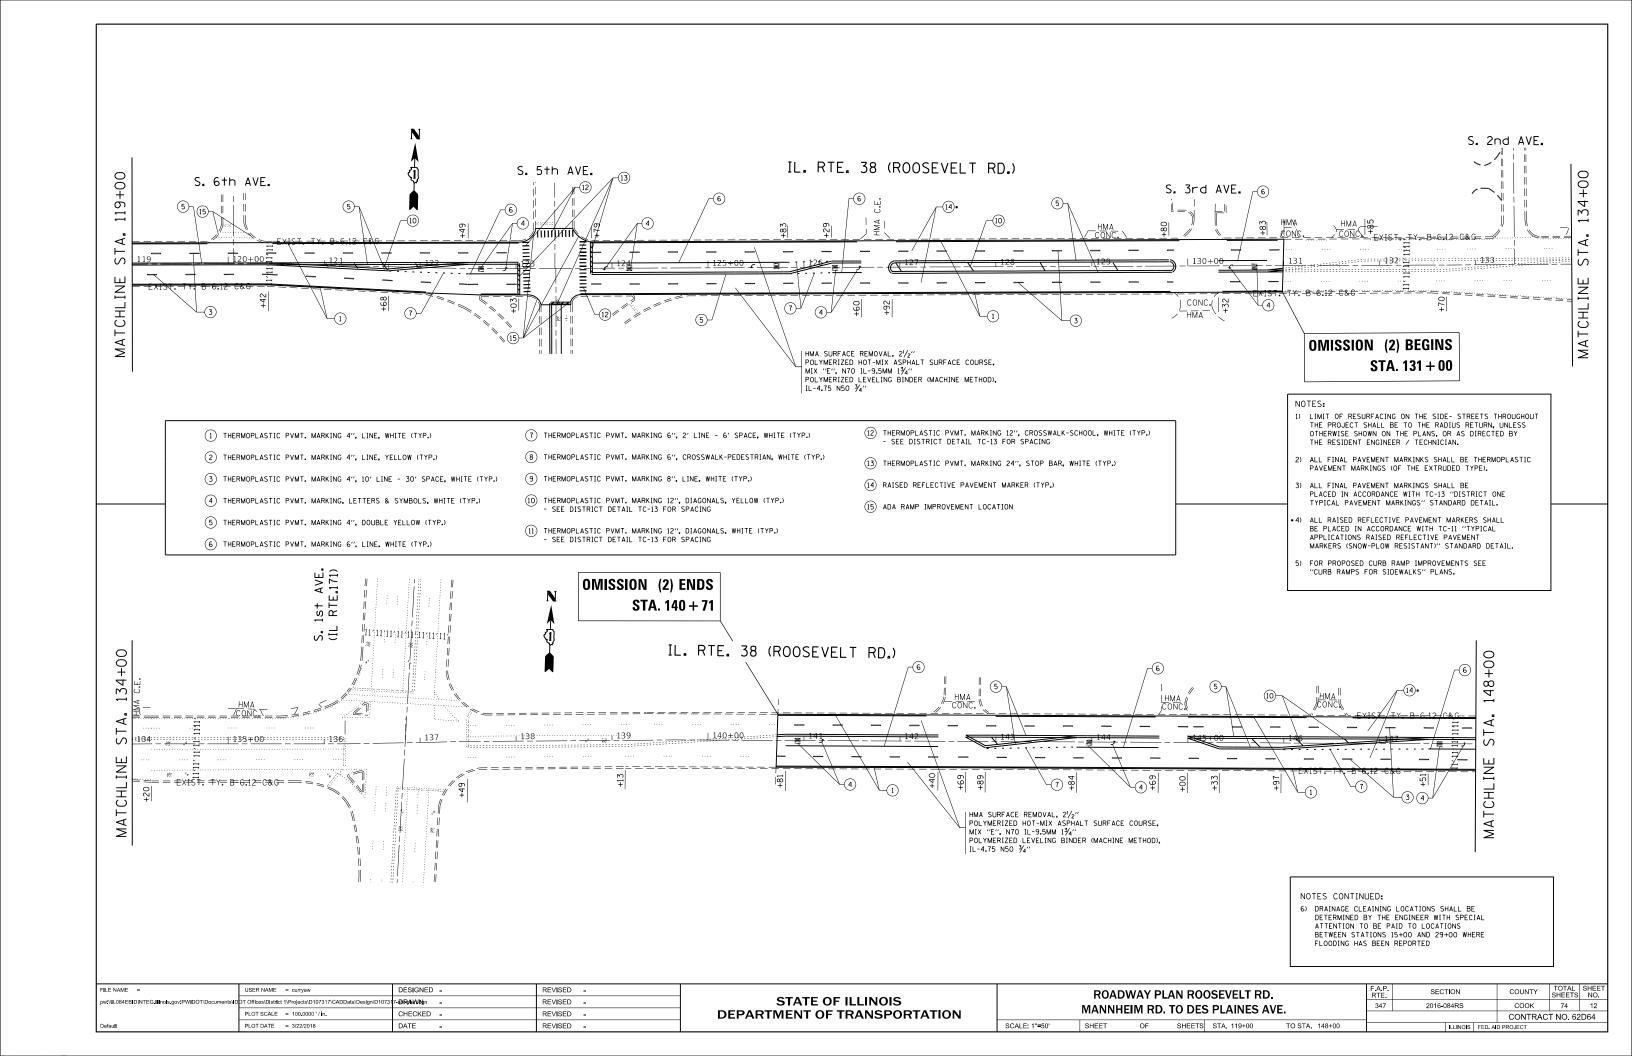

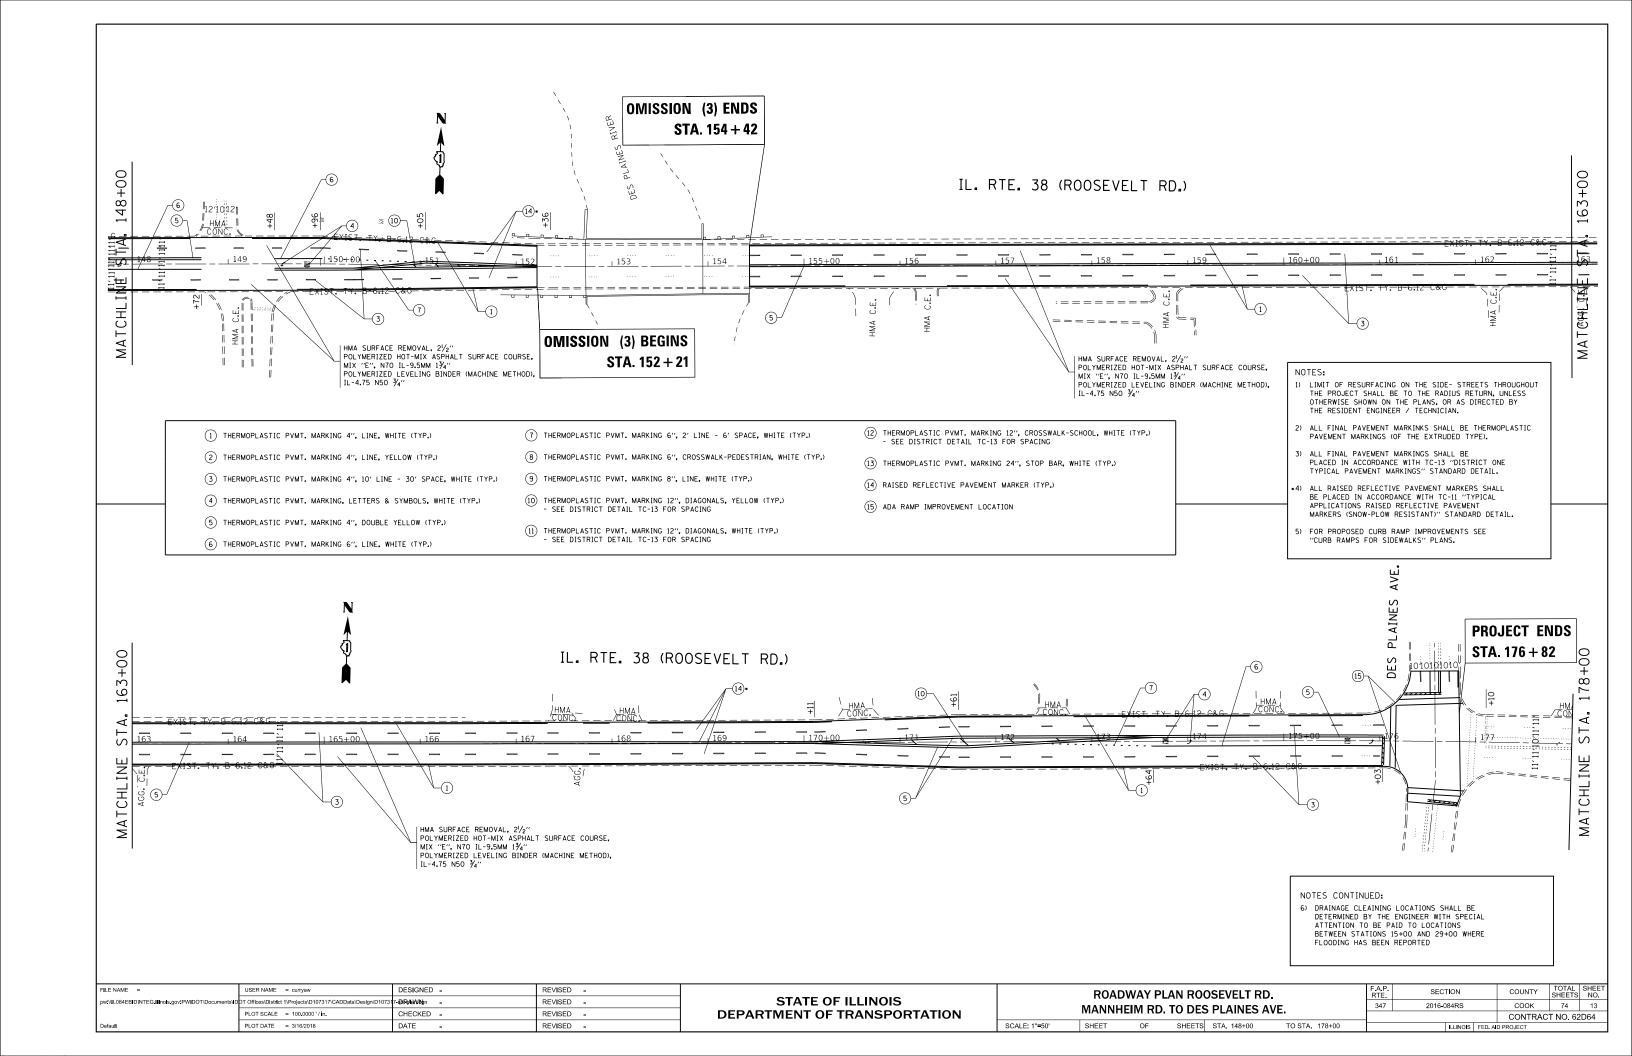

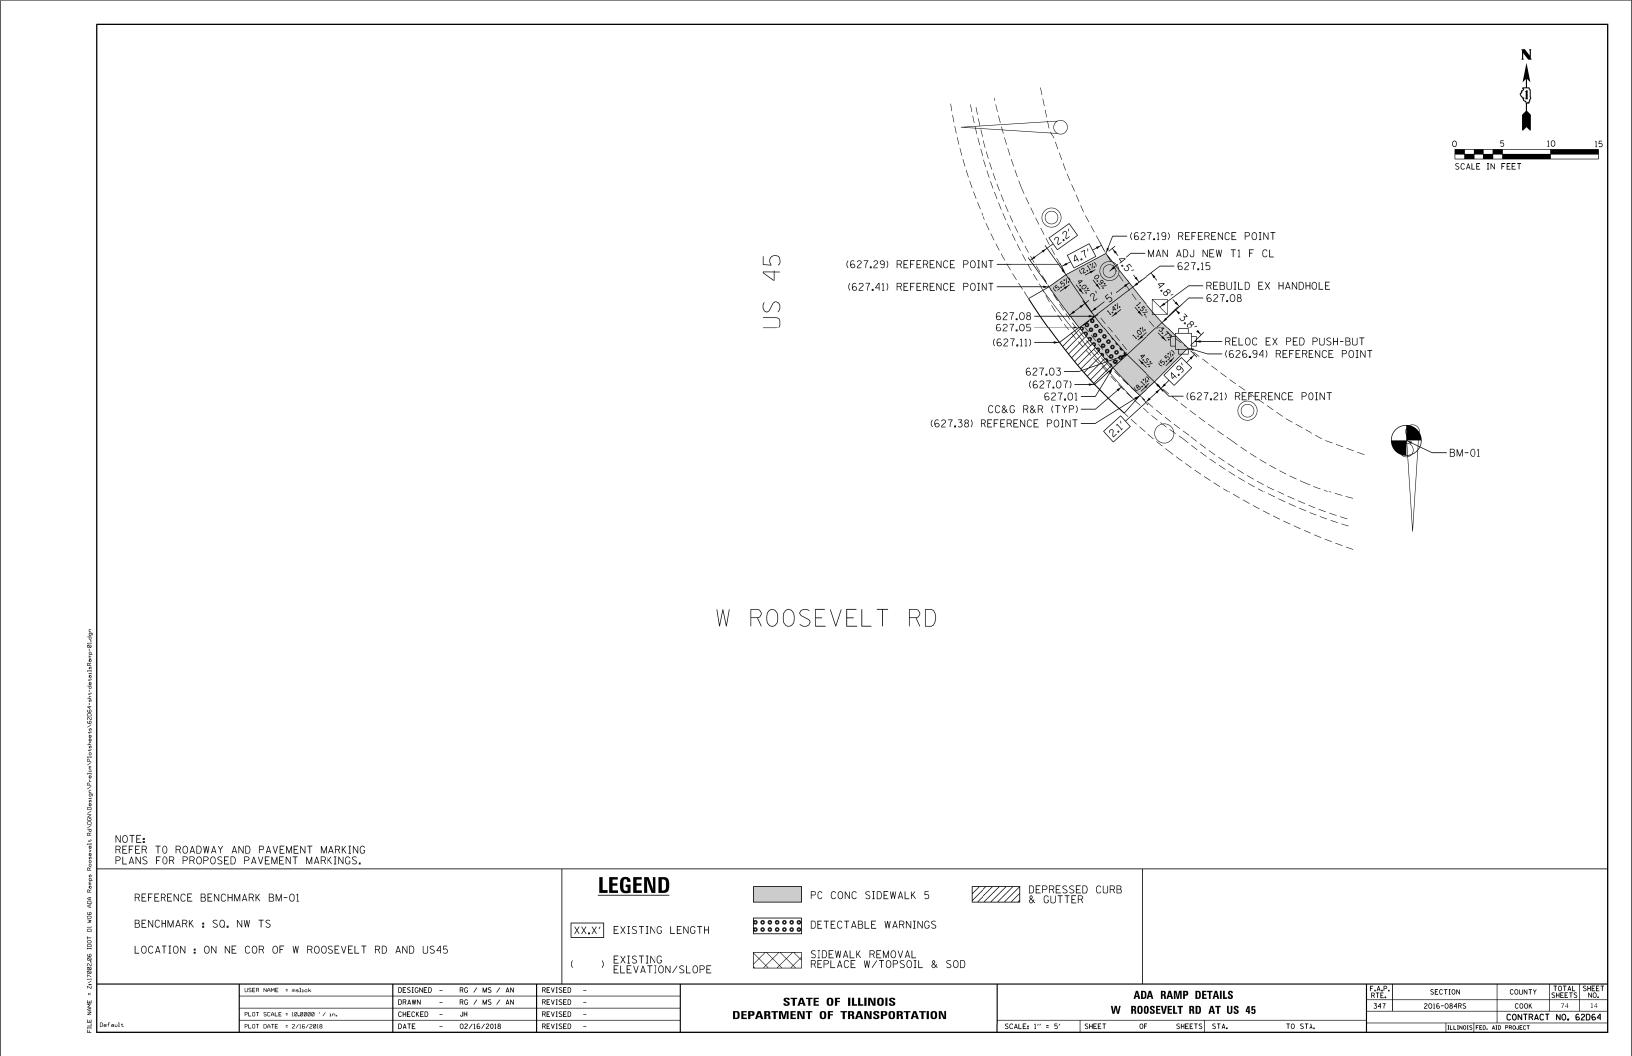

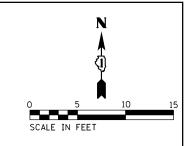

632.17 -631.47 -631.38 -FR & LIDS ADJUST--(632.18) REFERENCE POINT 631.40 -630.95- $A \vee E$ 7.0% (631.01) -BALMORAL 7.0% (631.03) -(632.43) REFERENCE POINT — 631**.**54 630.97 630.99 SIDE CURB (TYP) CC&G R&R (TYP)--(632.07) REFERENCE POINT 631.45 --(631.99) REFERENCE POINT

BM-02

NOTE: REFER TO ROADWAY AND PAVEMENT MARKING PLANS FOR PROPOSED PAVEMENT MARKINGS.

LEGEND

XX.X' EXISTING LENGTH

PC CONC SIDEWALK 5

DEPRESSED CL & GUTTER

REFERENCE BENCHMARK BM-02

BENCHMARK : SE BOLT FH

LOCATION: ON SW COR OF W ROOSEVELT RD AND BALMORAL AVE


() EXISTING ELEVATION/SLOPE SIDEWALK REMOVAL REPLACE W/TOPSOIL & SOD


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	DRAWN	-	RG / MS / AN	REVIS	ED -
PLOT SCALE = 10.00000 '/ in.	CHECKED	-	JH	REVIS	ED -
PLOT DATE = 2/16/2018	DATE	_	02/16/2018	REVIS	FD -


STATE OF ILLINOIS	
DEPARTMENT OF TRANSPORTATION	

DETECTABLE WARNINGS


		ADA R	F.A.P. RTE.	SECT	COUNTY							
W ROOSEVELT RD AT BALMORAL AVE								347 2016-084RS				
	VV NO	OSEVELI	IID AI L	ALIVIUNA	LAVL			-		CONTRA		
5'	SHEET	OF	SHEETS	STA.	TC	O STA.		l ₁	LI INDIS EED	AID PROJECT		

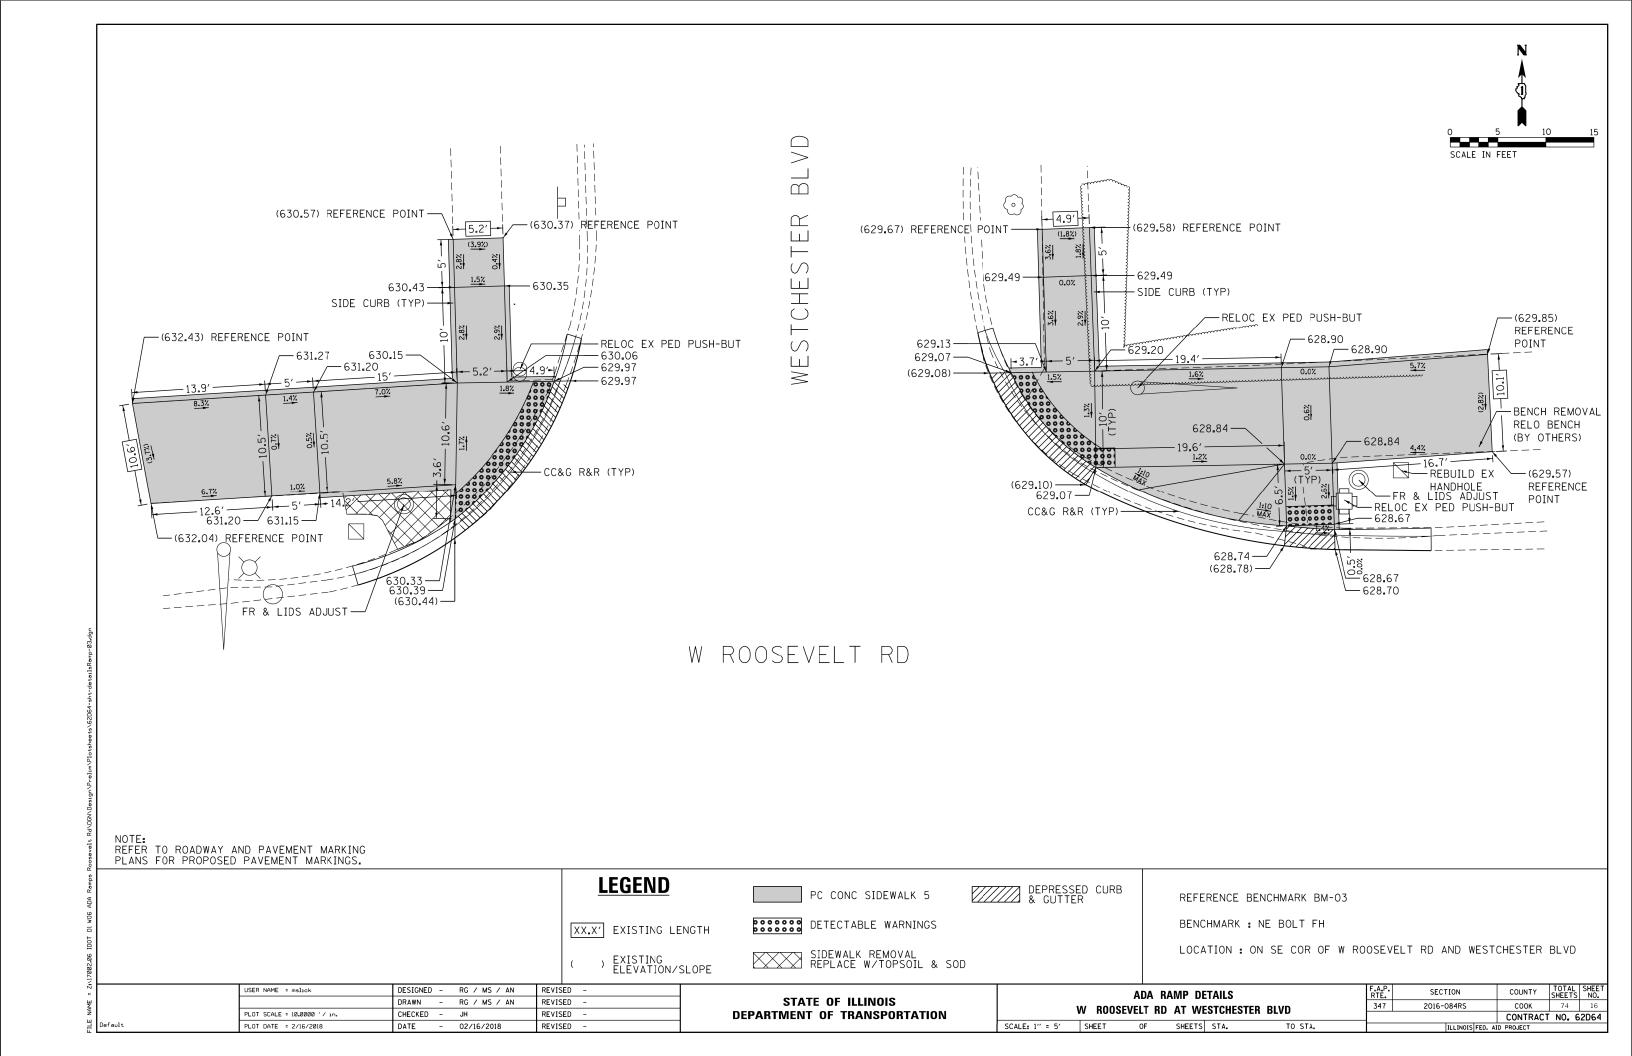

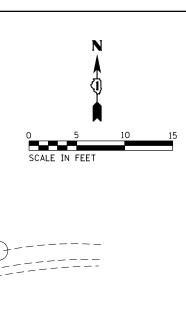

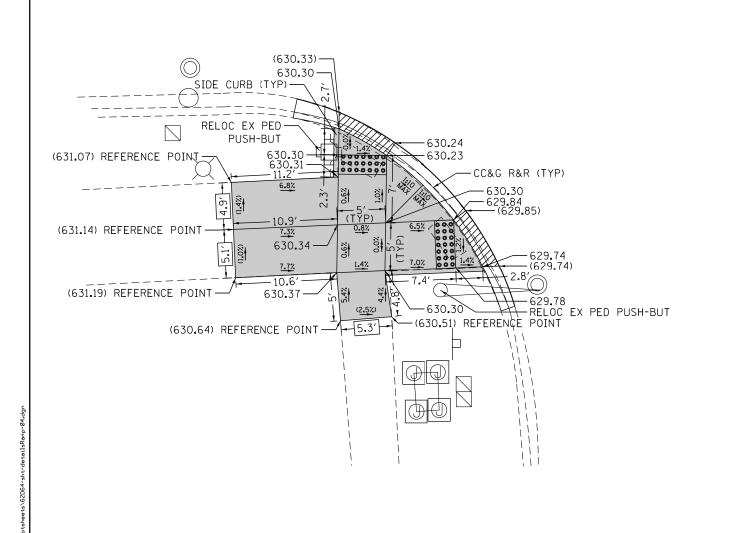

WESTCHESTER BLVD

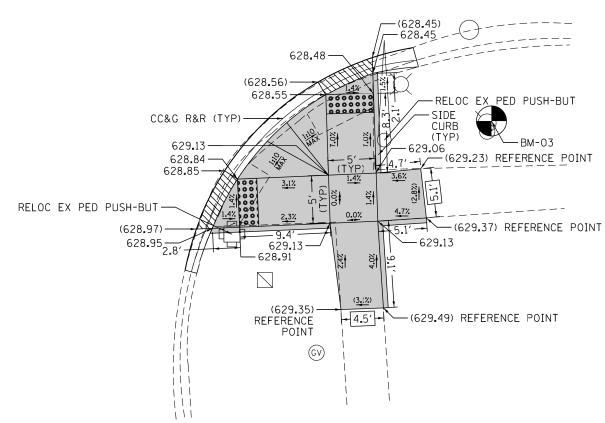

NOTE: REFER TO ROADWAY AND PAVEMENT MARKING PLANS FOR PROPOSED PAVEMENT MARKINGS.

LEGEND

XX.X' EXISTING LENGTH

) EXISTING ELEVATION/SLOPE PC CONC SIDEWALK 5

DEPRESSED CURE & GUTTER

REFERENCE BENCHMARK BM-03

BENCHMARK : NE BOLT FH

LOCATION : ON SE CORNER OF W ROOSEVELT RD AND WESTCHESTER BLVD

USER NAME = mslick	DESIGNED	-	RG / MS / AN	REVISE	ID -
	DRAWN	-	RG / MS / AN	REVISE	ID -
PLOT SCALE = 10.0000 ' / in.	CHECKED	-	JH	REVISE	ID -
PLOT DATE = 2/16/2018	DATE	_	02/16/2018	REVISE	n -


STATE OF ILLINOIS
DEPARTMENT OF TRANSPORTATION


DETECTABLE WARNINGS


SIDEWALK REMOVAL REPLACE W/TOPSOIL & SOD


		ADA F	RAMP DE	TAILS		F.A.P RTE.		
	W ROOS	EVELT RE) AT WE	STCHEST	TER RIVD	347		
W ROOSEVELT RD AT WESTCHESTER BLVD								
" = 5"	SHEET	ΩF	SHEETS	STA	TO STA			


	THE THOUGHT FED	AID DOO FOT		
		CONTRACT	NO. 6	2D64
347	2016-084RS	COOK	74	17
F.A.P. RTE.	SECTION	COUNTY	SHEETS	SHEET NO.

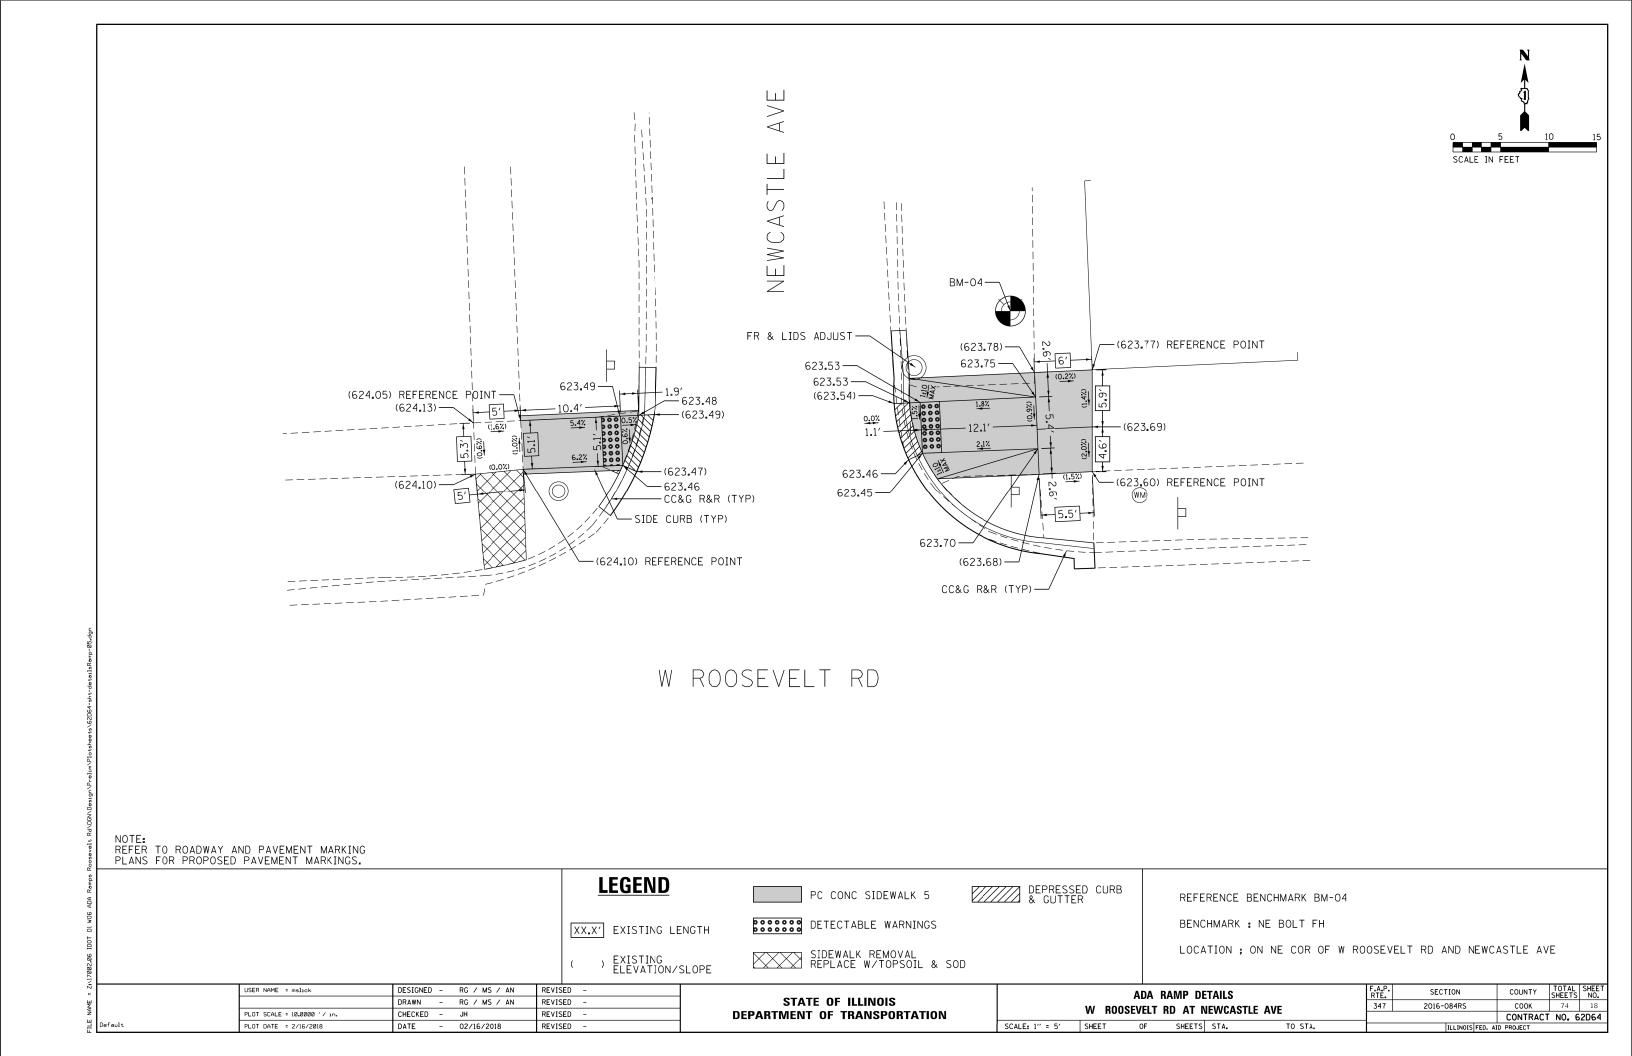


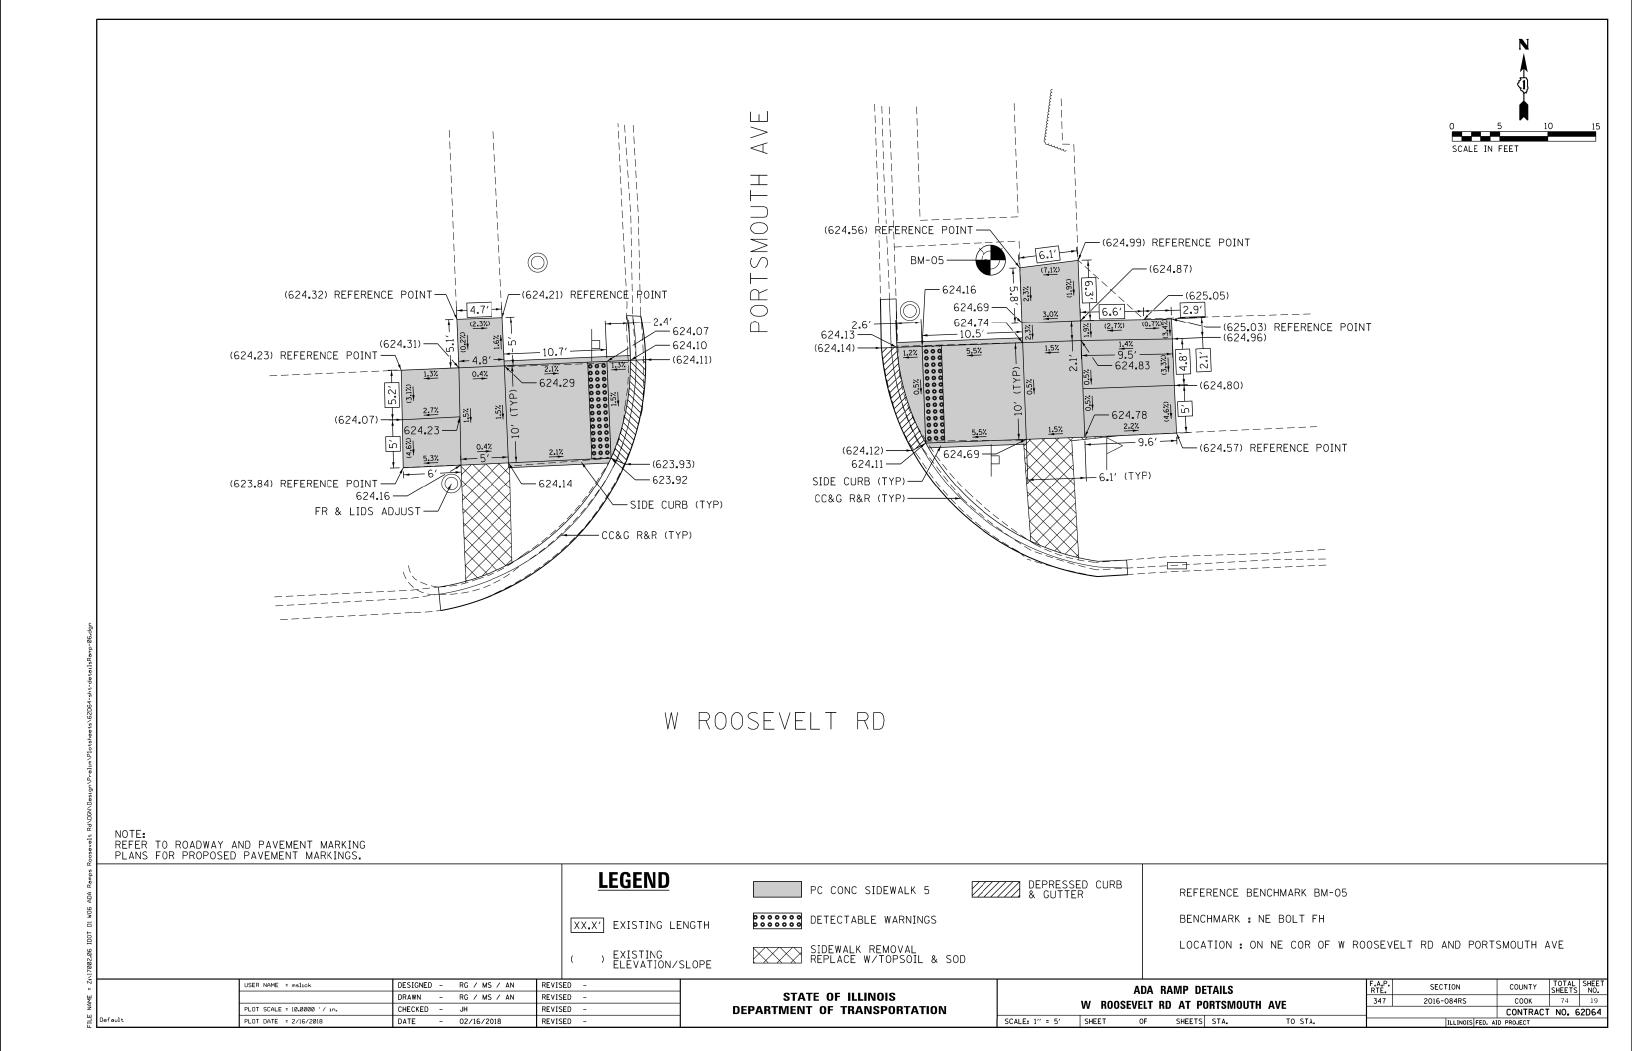


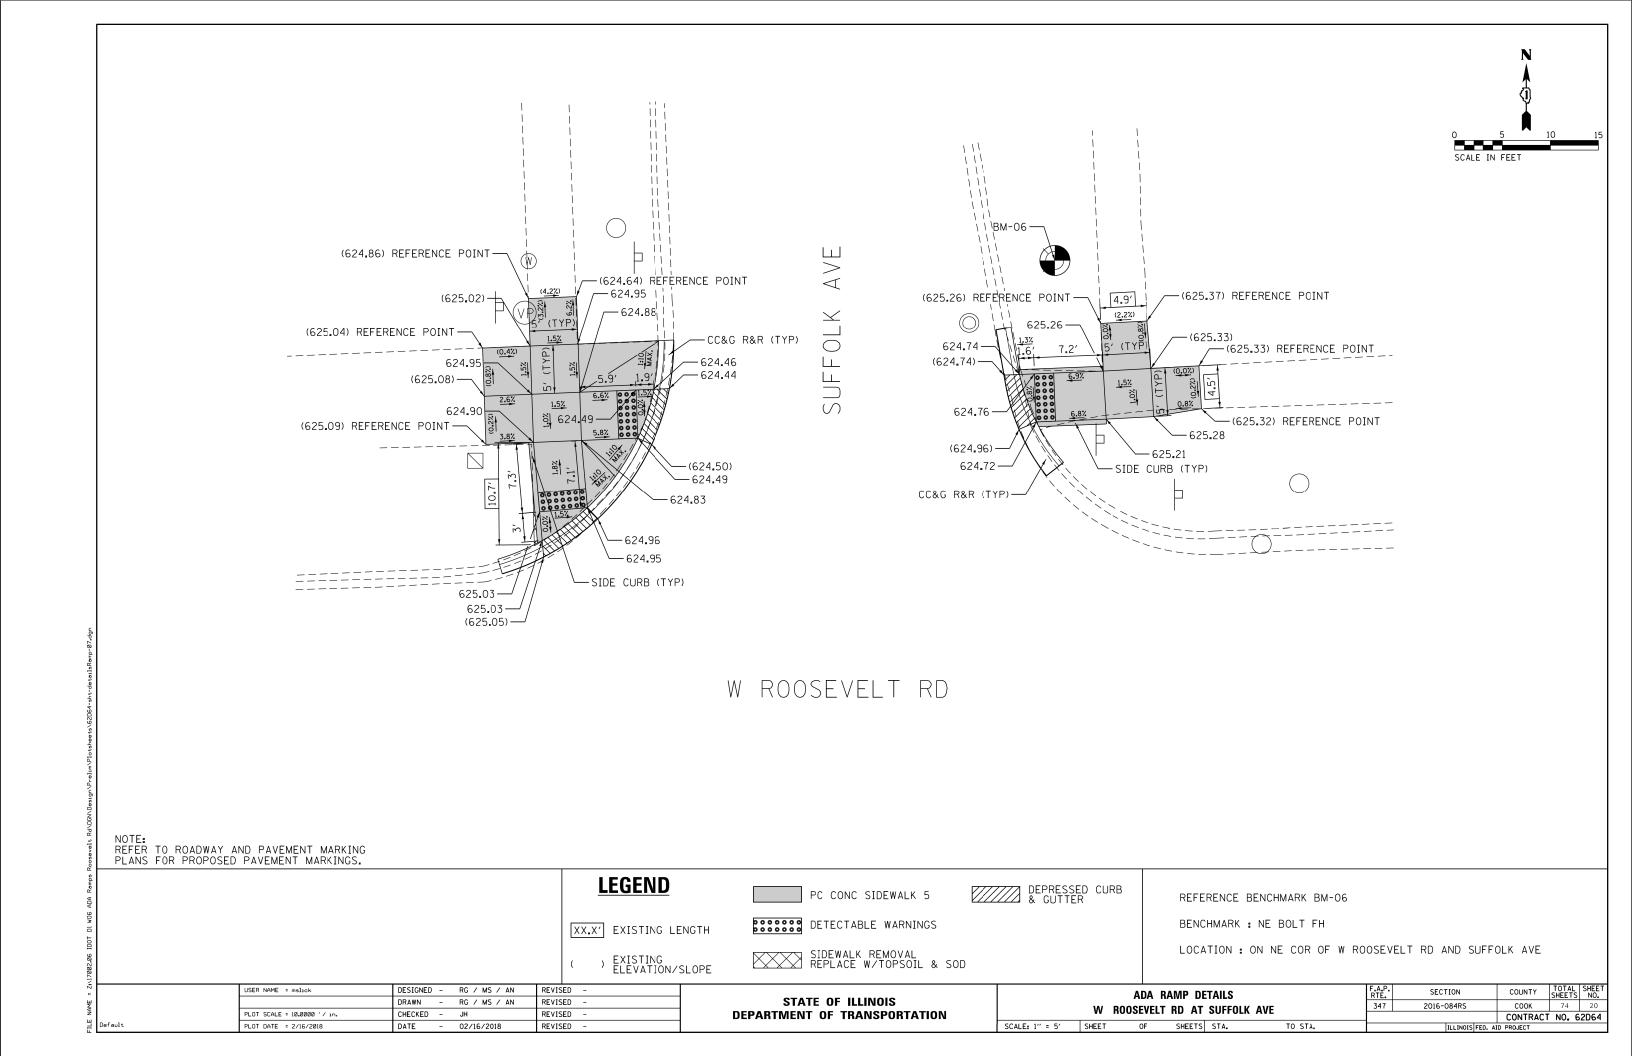


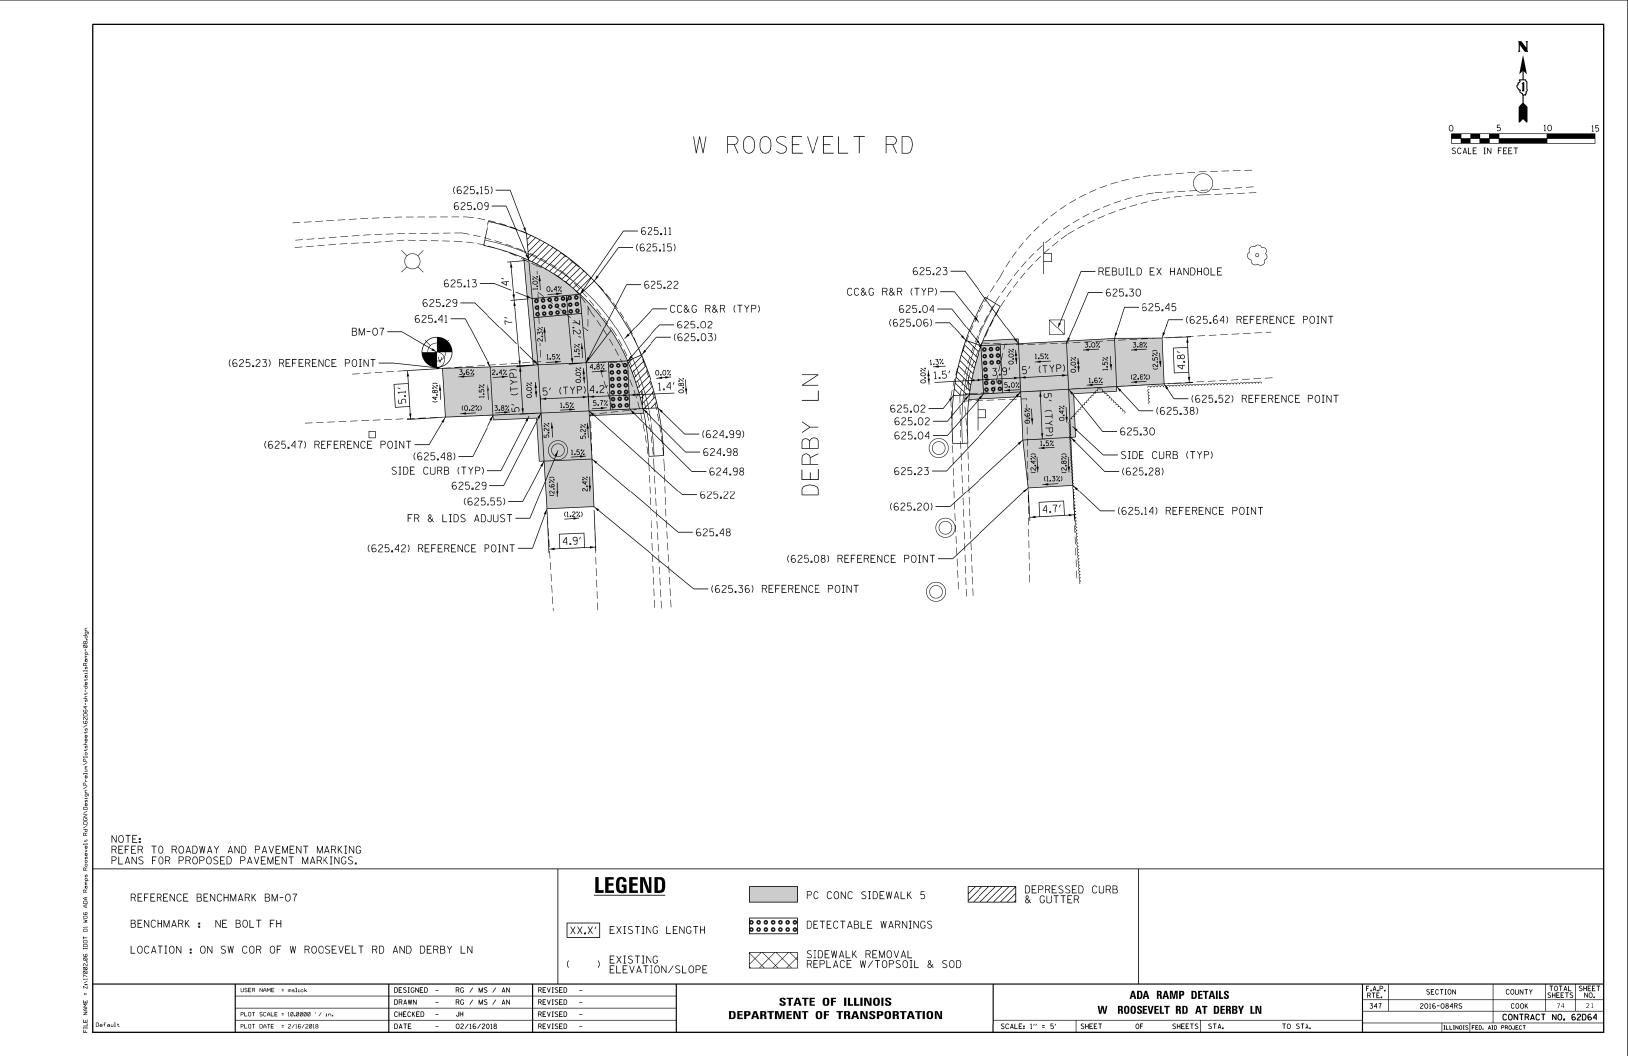


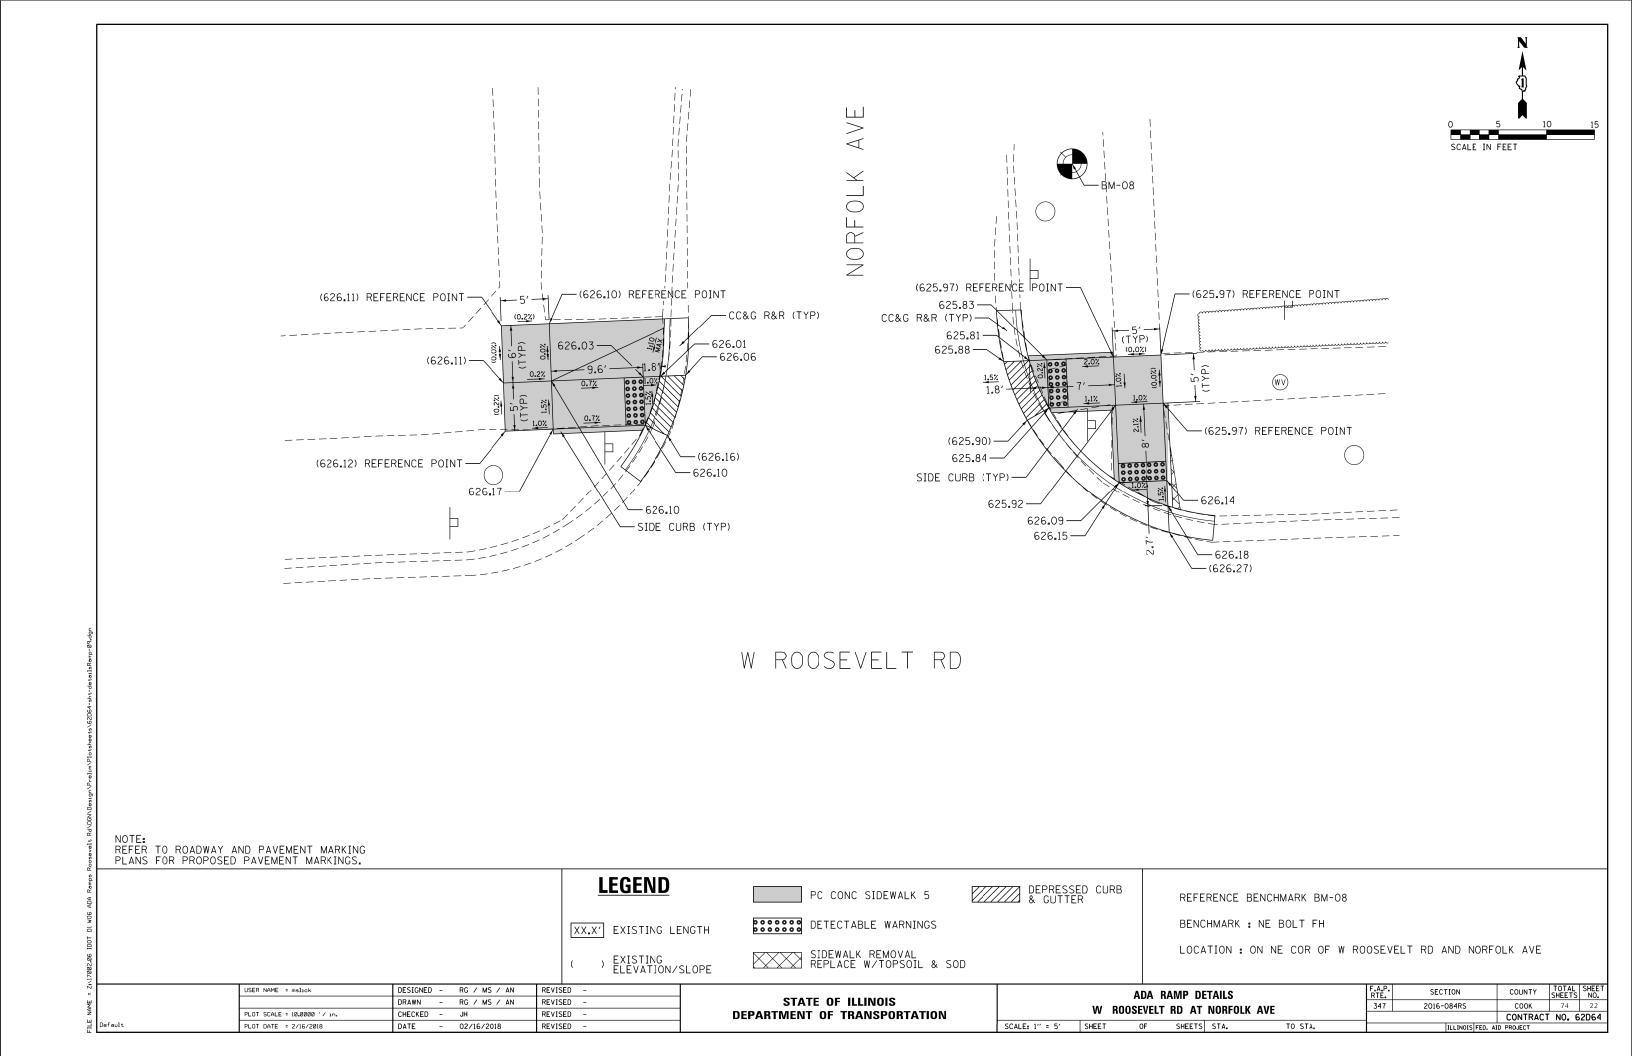


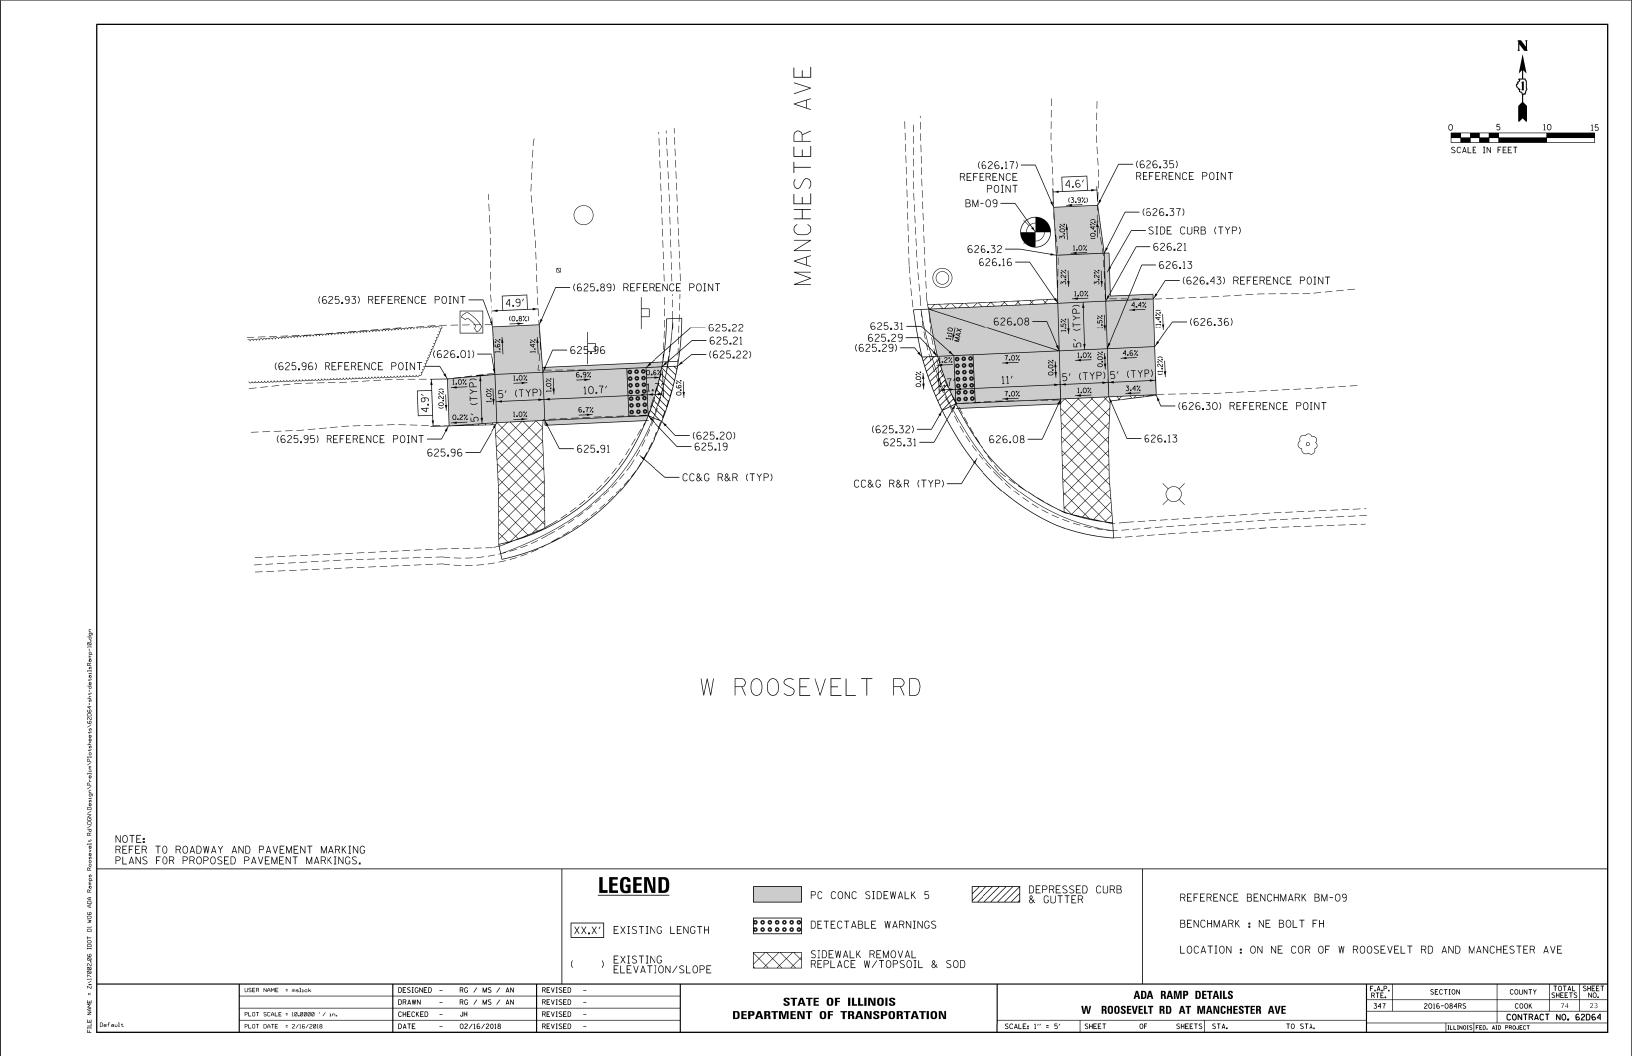

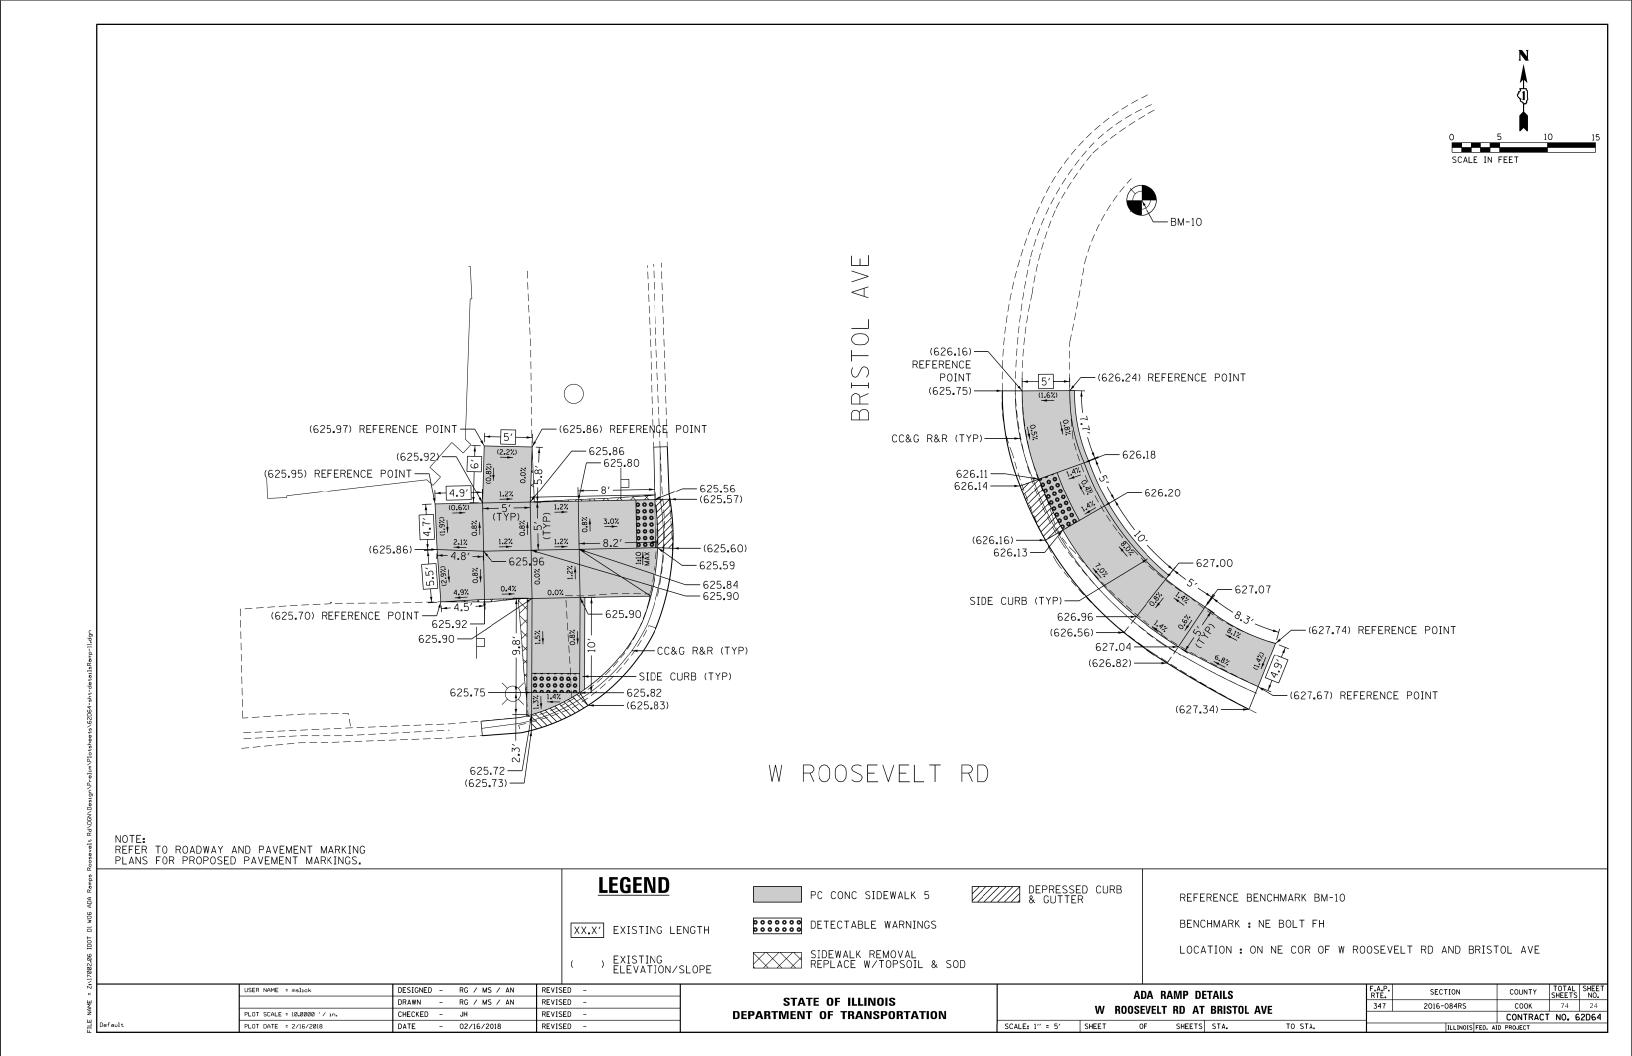

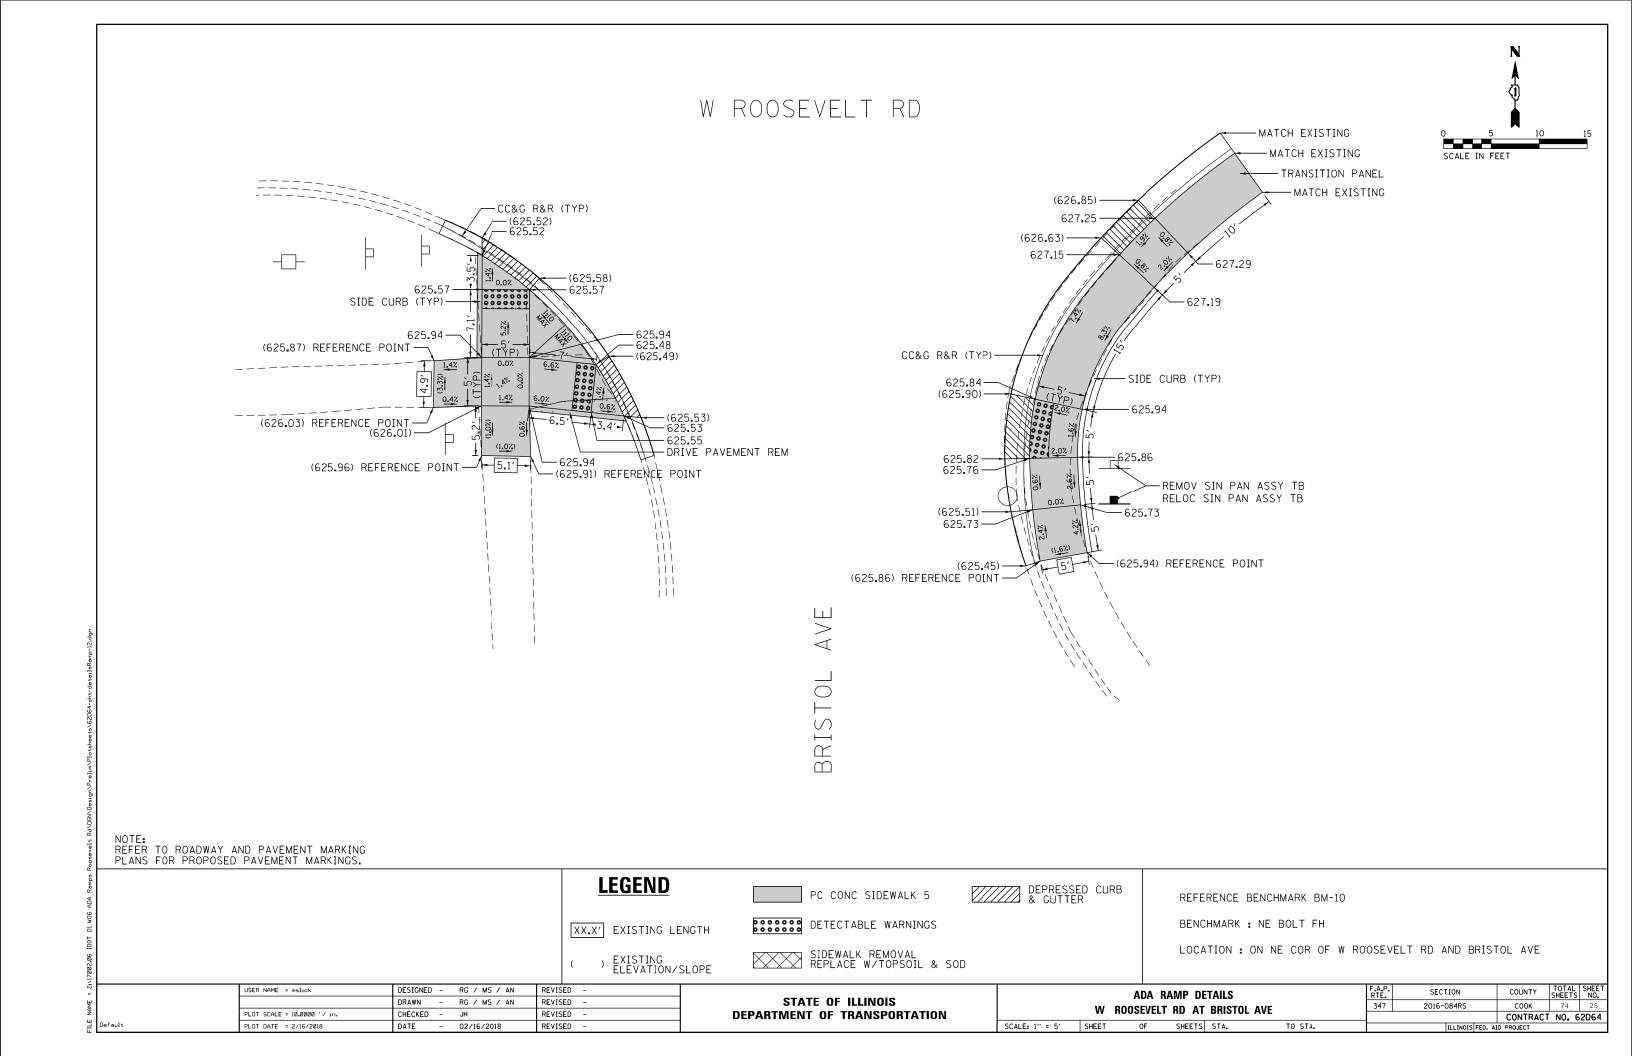

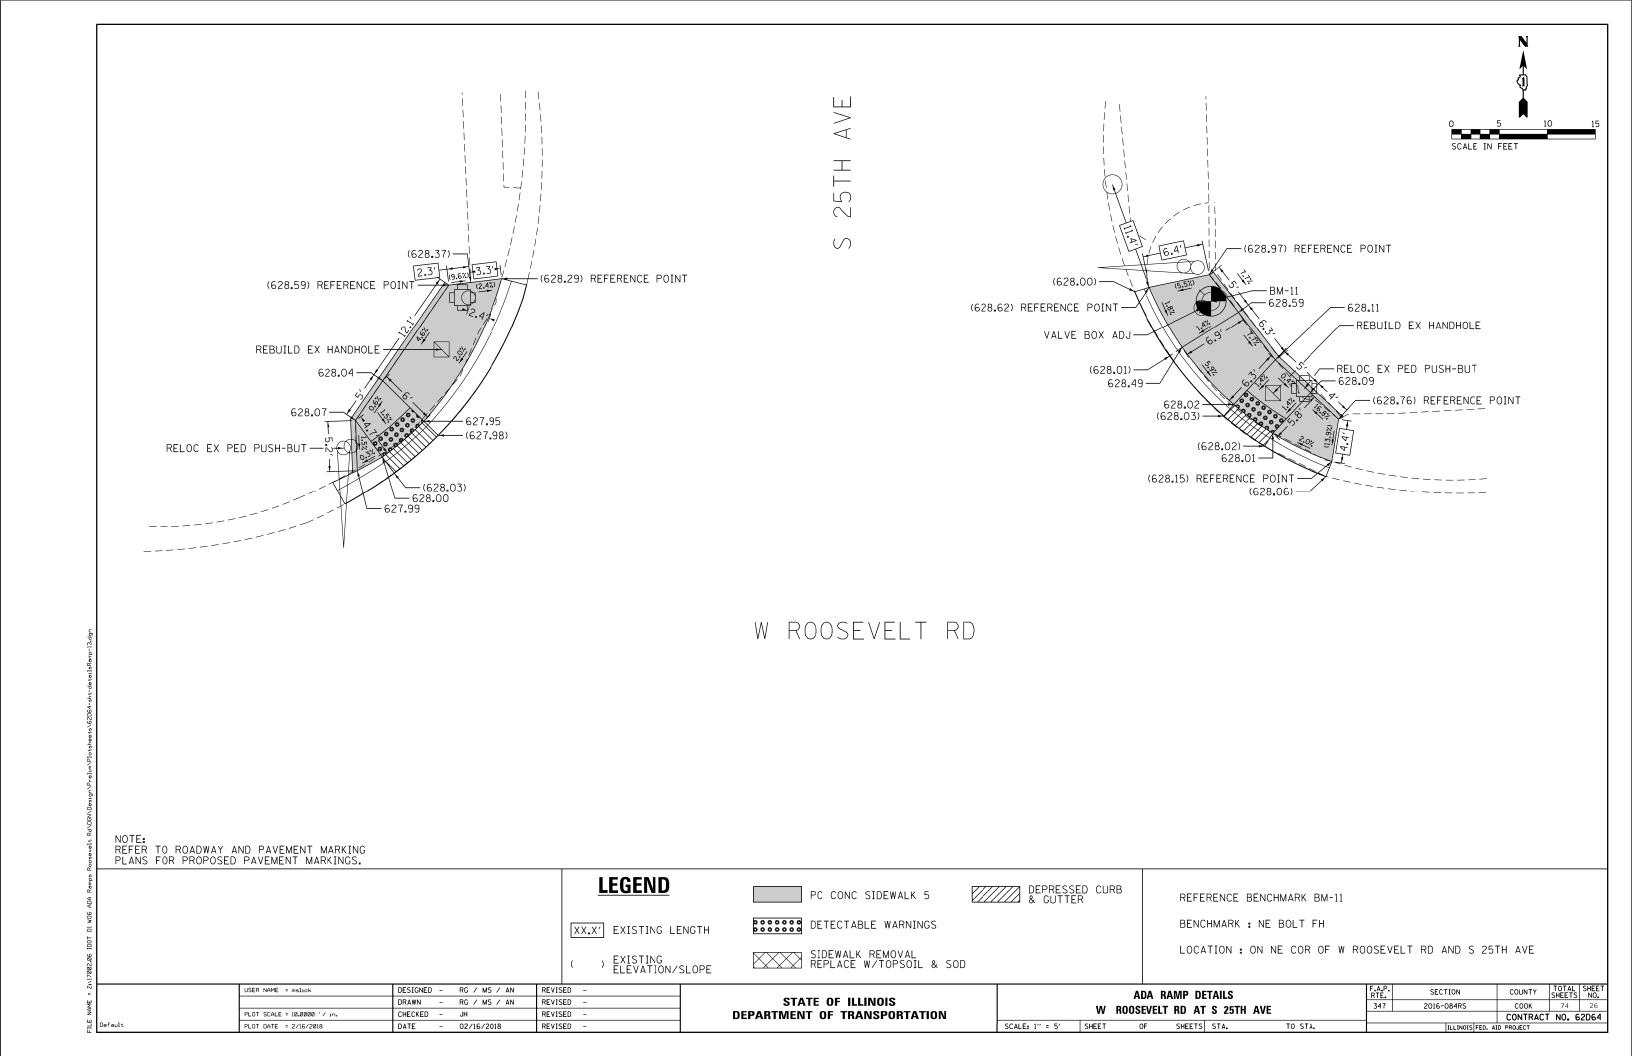

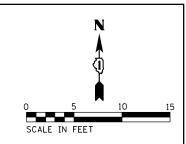

- (628.56) REFERENCE POINT -(628.79) REFERENCE POINT -628**.**44 / 628**.**05 FR & LIDS ADJUST 628.54 — 628 RELOC EX PED PUSH-BUT 628.16 -628.50 REBUILD EX HANDHOLE (628.05) REFERENCE POINT

. \(\) \bigcirc

(628.16) REFERENCE POINT -628.09-RELOC EX PED PUSH-BUT-628.03-627.97 (627.87)-- 627**.**90 - 628**.**02 -628.14 — (628.29) REFERENCE POINT — - (628.27) REFERENCE POINT (628.23) REFERENCE POINT

NOTE: REFER TO ROADWAY AND PAVEMENT MARKING PLANS FOR PROPOSED PAVEMENT MARKINGS.

LEGEND

PC CONC SIDEWALK 5

SCALE: 1" = 5'

REFERENCE BENCHMARK BM-11

BENCHMARK : NE BOLT FH

LOCATION : ON NE COR OF W ROOSEVELT RD AND S 25TH AVE


XX.X' EXISTING LENGTH) EXISTING ELEVATION/SLOPE DETECTABLE WARNINGS


SIDEWALK REMOVAL REPLACE W/TOPSOIL & SOD

	USER NAME = mslick	DESIGNED -	-	RG / MS / AN	REVISED	-	
		DRAWN -	-	RG / MS / AN	REVISED	-	
	PLOT SCALE = 10.0000 '/ 10.	CHECKED -	-	JH	REVISED	-	DEPARTN
Default	PLOT DATE = 2/16/2018	DATE -	_	02/16/2018	REVISED	-	

STATE OF ILLINOIS
DEPARTMENT OF TRANSPORTATION

ADA RAMP DETAILS			F.A.P. RTE.	SECTION	COUNTY	TOTAL SHEETS	SHEE NO.		
W ROOSEVELT RD AT S 25TH AVE		347	2016-084RS	COOK	74	27			
W NOUSEVELLI NO AL S ZOIN AVE					CONTRACT	NO. 6	52D64		
SHEET	OF	SHEETS	STA.	TO STA.		ILLINOIS FED. A	D PROJECT		

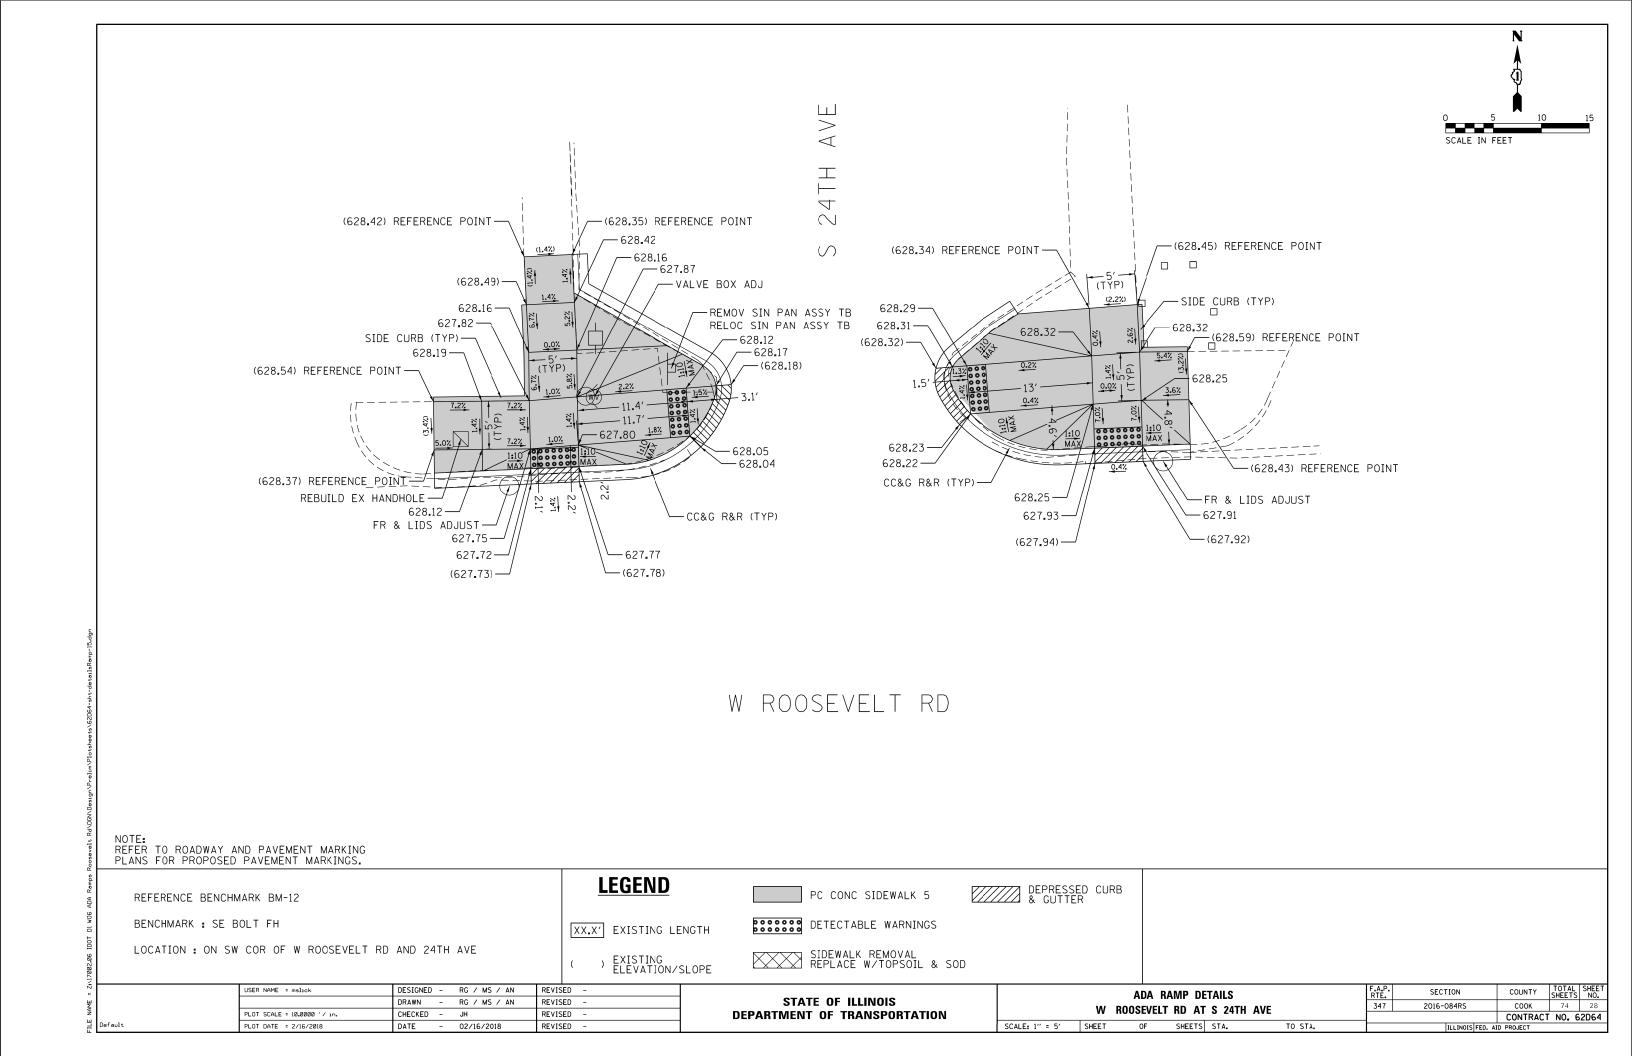

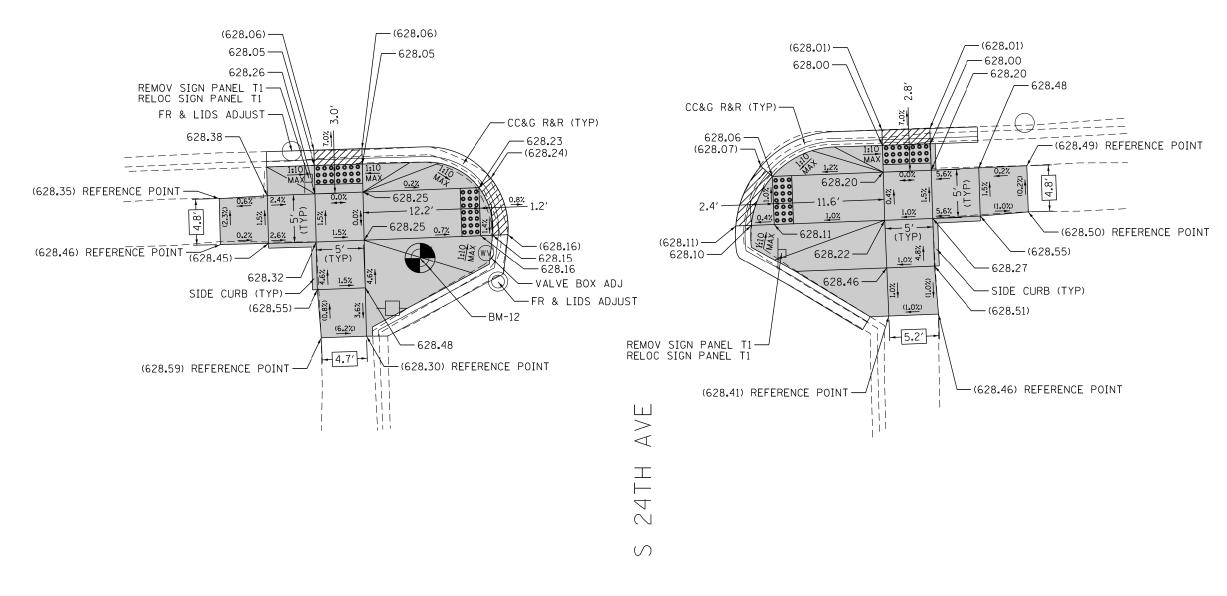

NOTE: REFER TO ROADWAY AND PAVEMENT MARKING PLANS FOR PROPOSED PAVEMENT MARKINGS.

REFERENCE BENCHMARK BM-12

LEGEND

PC CONC SIDEWALK 5

XX.X' EXISTING LENGTH

DETECTABLE WARNINGS

SIDEWALK REMOVAL REPLACE W/TOPSOIL & SOD

USER NAME = mslick	DESIGNED	-	RG / MS / AN	REVISE	ID -
	DRAWN	-	RG / MS / AN	REVISE	ID -
PLOT SCALE = 10.0000 '/ 10.	CHECKED	-	JH	REVISE	ID -
PLOT DATE = 2/16/2018	DATE		02/16/2018	REVISE	'D -

STATE OF	ILLINOIS
DEPARTMENT OF	TRANSPORTATION

ADA RAMP DETAILS							
	W	ROOSEVELT	AVE AT	S 24TH AV	E		
ALE: 1" = 5"	SHEET	OF	SHEETS	STA.	TO STA.		


	ILLINOIS FED. A	ID PROJECT		
		CONTRACT	NO. 6	2D64
347	2016-084RS	COOK	74	29
RTE.	SECTION	COUNTY	SHEETS	NO.


BENCHMARK : SE BOLT FH

LOCATION: ON SW COR OF W ROOSEVELT RD AND 24TH AVE

) EXISTING ELEVATION/SLOPE

SCAL

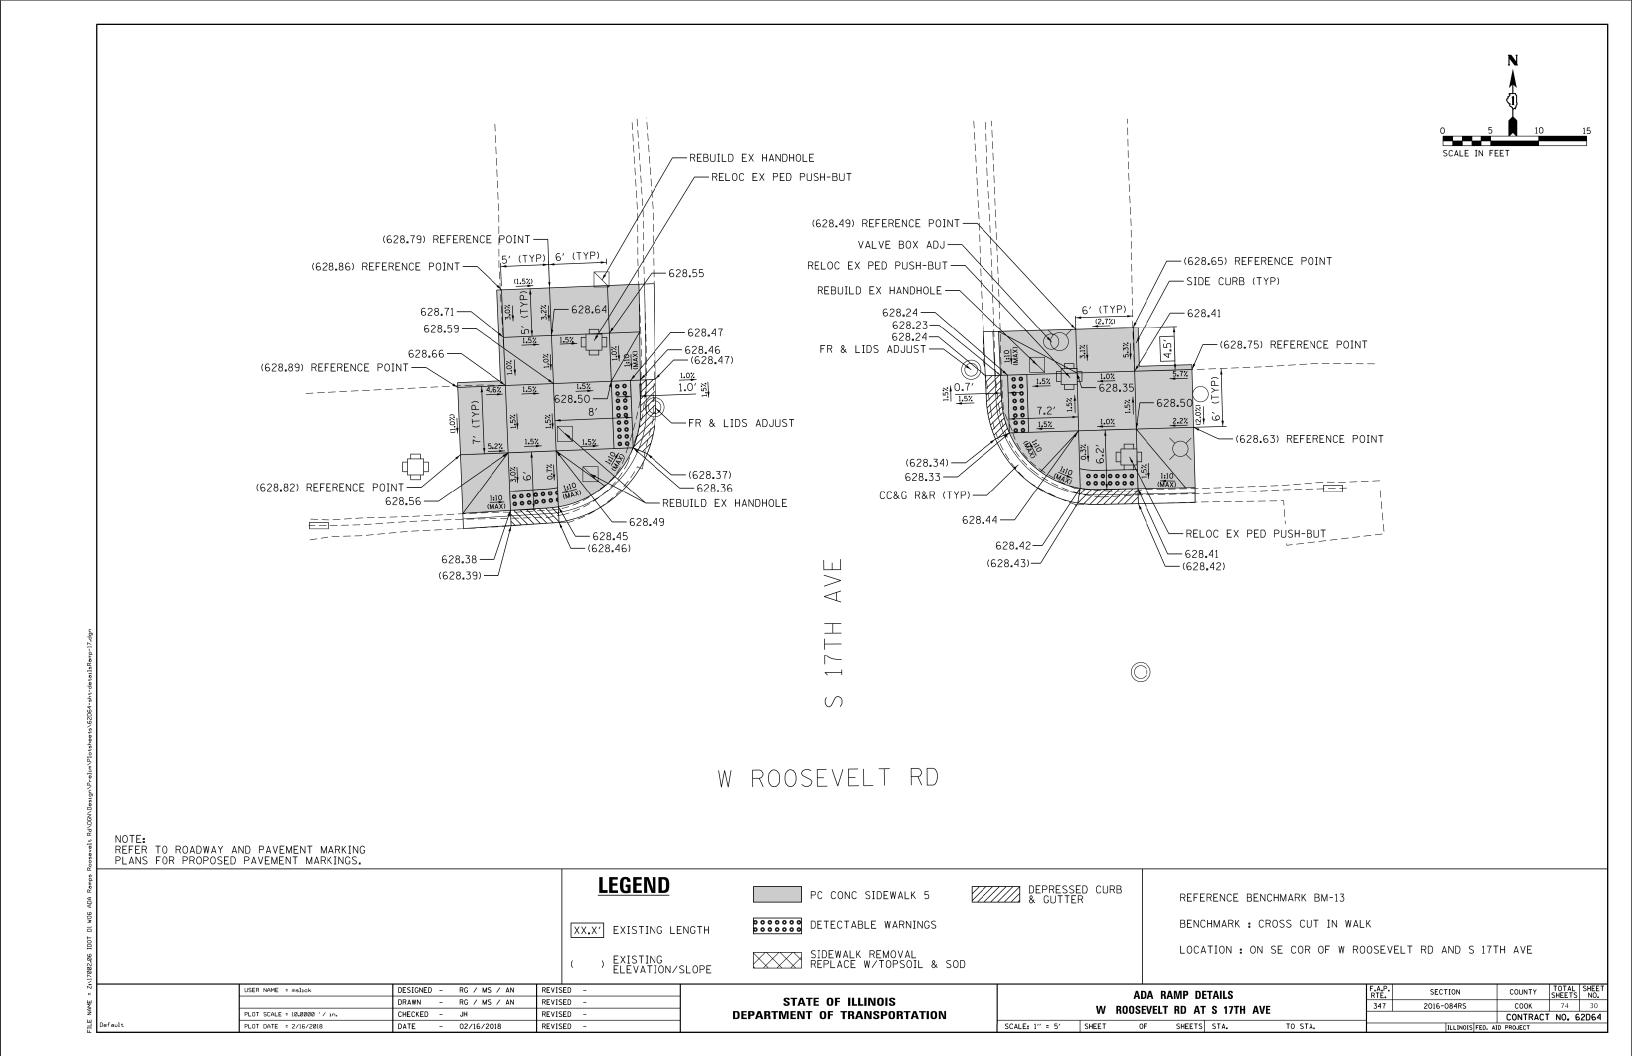

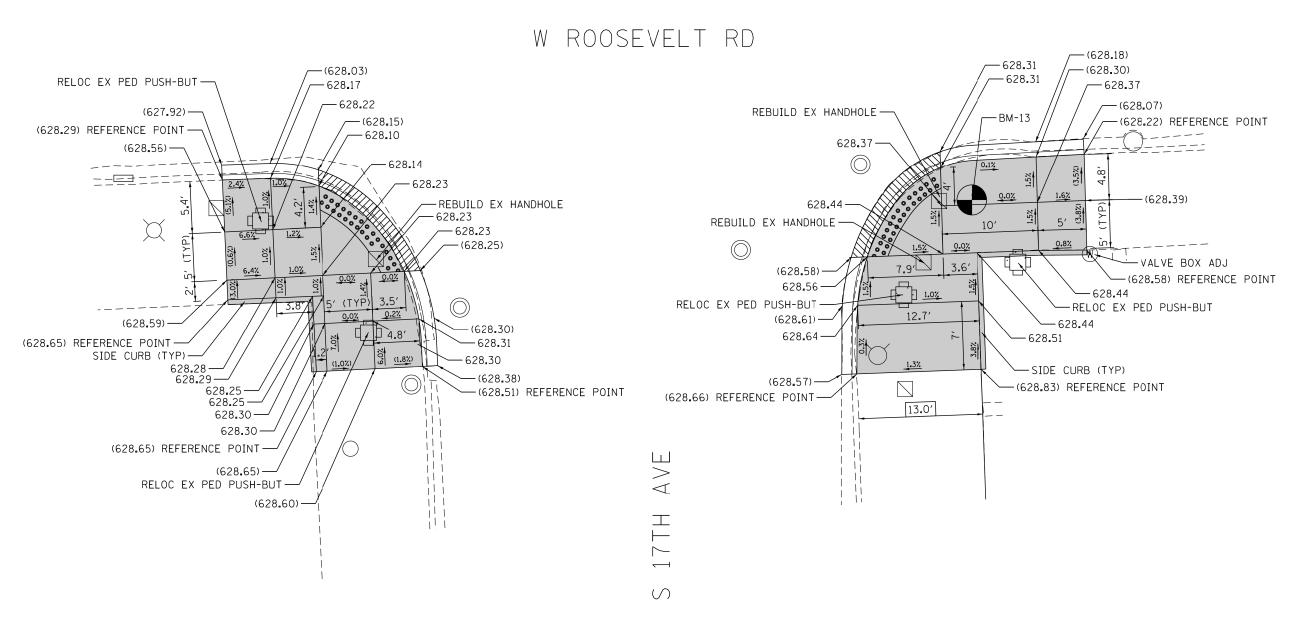

NOTE: REFER TO ROADWAY AND PAVEMENT MARKING PLANS FOR PROPOSED PAVEMENT MARKINGS.

PC CONC SIDEWALK 5 DETECTABLE WARNINGS XX.X' EXISTING LENGTH SIDEWALK REMOVAL REPLACE W/TOPSOIL & SOD) EXISTING ELEVATION/SLOPE

LEGEND

REFERENCE BENCHMARK BM-13

BENCHMARK : CROSS CUT IN WALK

LOCATION: ON SE COR OF W ROOSEVELT RD AND S 17TH AVE


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PLOT SCALE = 10.0000 ' / in.	CHECKED	-	JH	REVISED	-
PLOT DATE = 2/16/2018	DATE	-	02/16/2018	REVISED	=


STATE OF	ILLINOIS
DEPARTMENT OF 1	RANSPORTATION


		ADA RA	AMP D	ETA	ILS		
	W	ROOSEVELT	RD A	ΓS	17TH	AVE	
5′	SHEET	OF	SHEETS	ST	ΓΑ.		TO STA.

	ILLINOIS FED. A	ID PROJECT		
		CONTRACT	NO. 6	2D64
347	2016-084RS	COOK	74	31
RTE.	SECTION	COUNTY	SHEETS	NO.

SCALE: 1" = 5

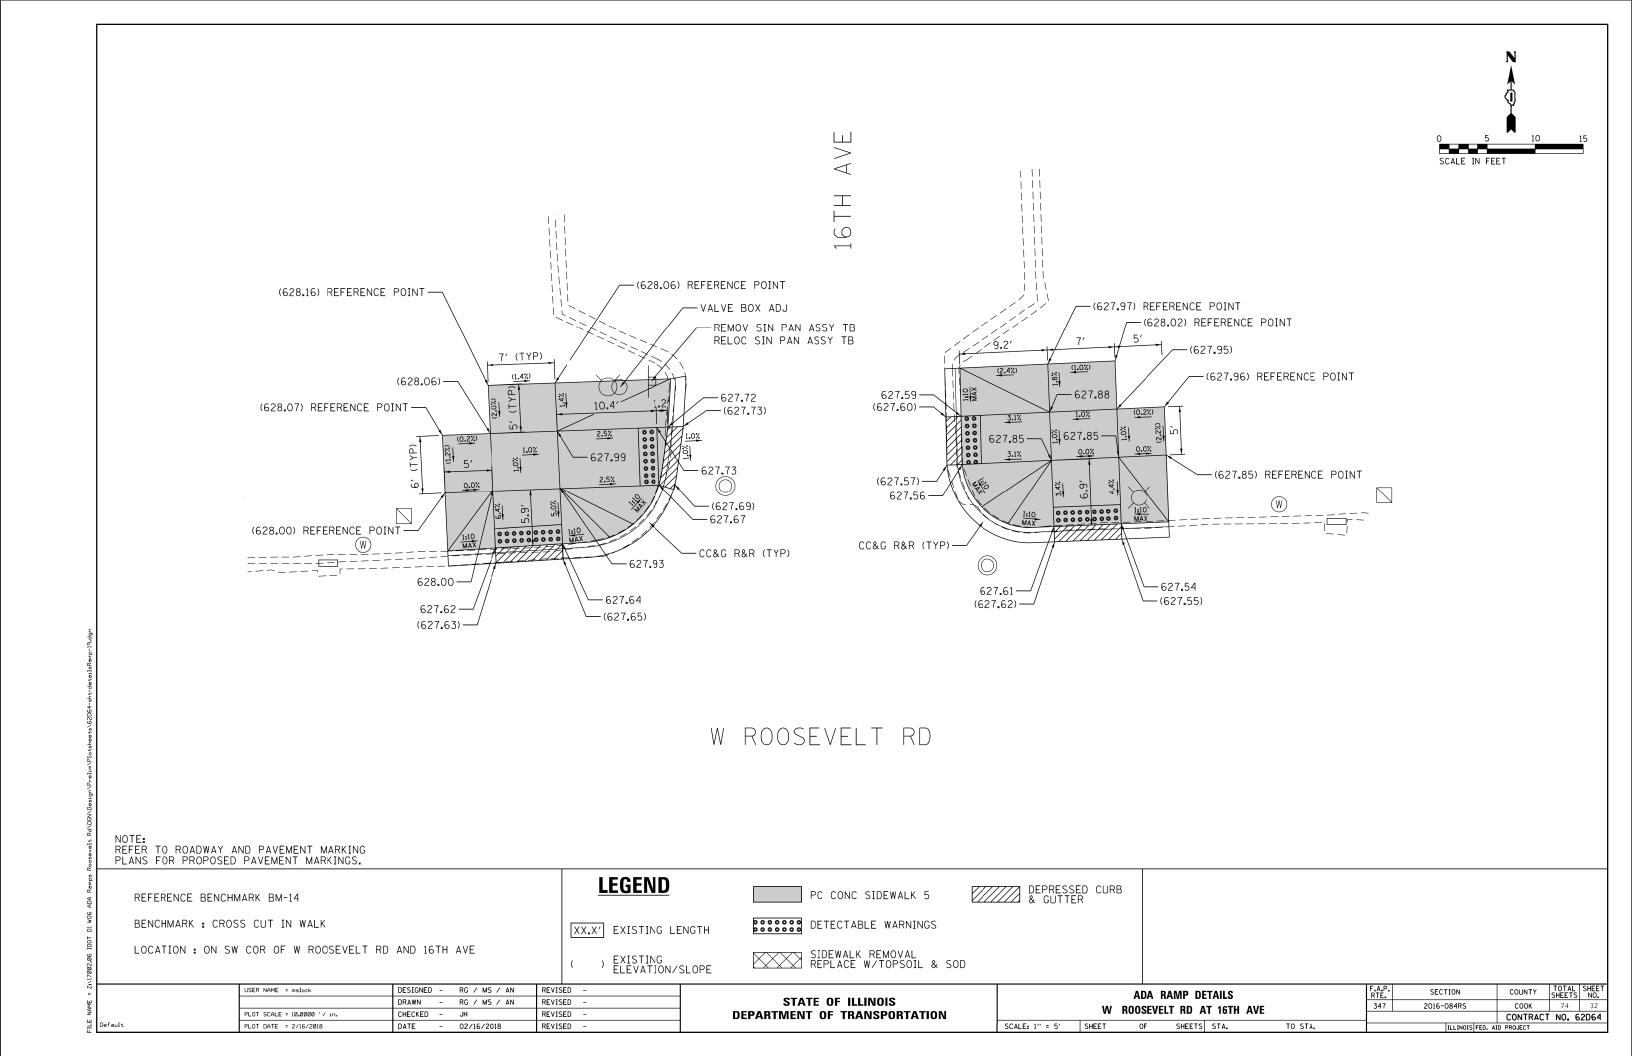

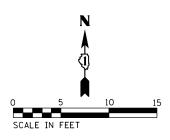

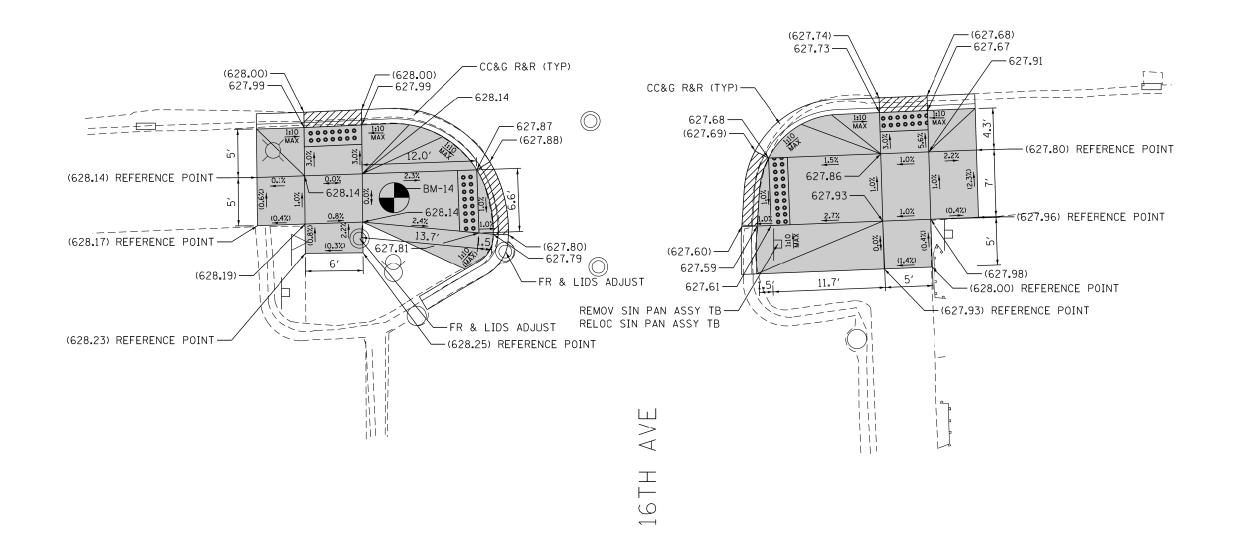

NOTE: REFER TO ROADWAY AND PAVEMENT MARKING PLANS FOR PROPOSED PAVEMENT MARKINGS.

REFERENCE BENCHMARK BM-14

BENCHMARK : CROSS CUT IN WALK

LOCATION: ON SW COR OF W ROOSEVELT RD AND 16TH AVE

LEGEND

PC CONC SIDEWALK 5



XX.X' EXISTING LENGTH

) EXISTING ELEVATION/SLOPE DETECTABLE WARNINGS


SIDEWALK REMOVAL REPLACE W/TOPSOIL & SOD

USER NAME = mslick	DESIGNED	-	RG / MS / AN	REVISED	-
	DRAWN	-	RG / MS / AN	REVISED	-
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PLOT DATE = 2/16/2018	DATE	-	02/16/2018	REVISED	=


STATE OF ILLINOIS								
DEPARTMENT OF	TRANSPORTATION							

	ADA RAMP DETAILS W ROOSEVELT RD AT 16TH AVE							SECTION	COUNTY	SHEETS	SHEE NO.	
								2016-084RS	соок	74	33	
	VV NOUSEVELI ND AI IUIN AVE								CONTRACT	. NO. 6	62D64	
	SCALE: 1" = 5"	SHEET	OF	SHEETS	STA.	TO STA.	ILLINOIS FED. AID PROJECT					

16 ADA Ramps Roosevelt Rd\DGN\Design\Prelim\Plotsheets\

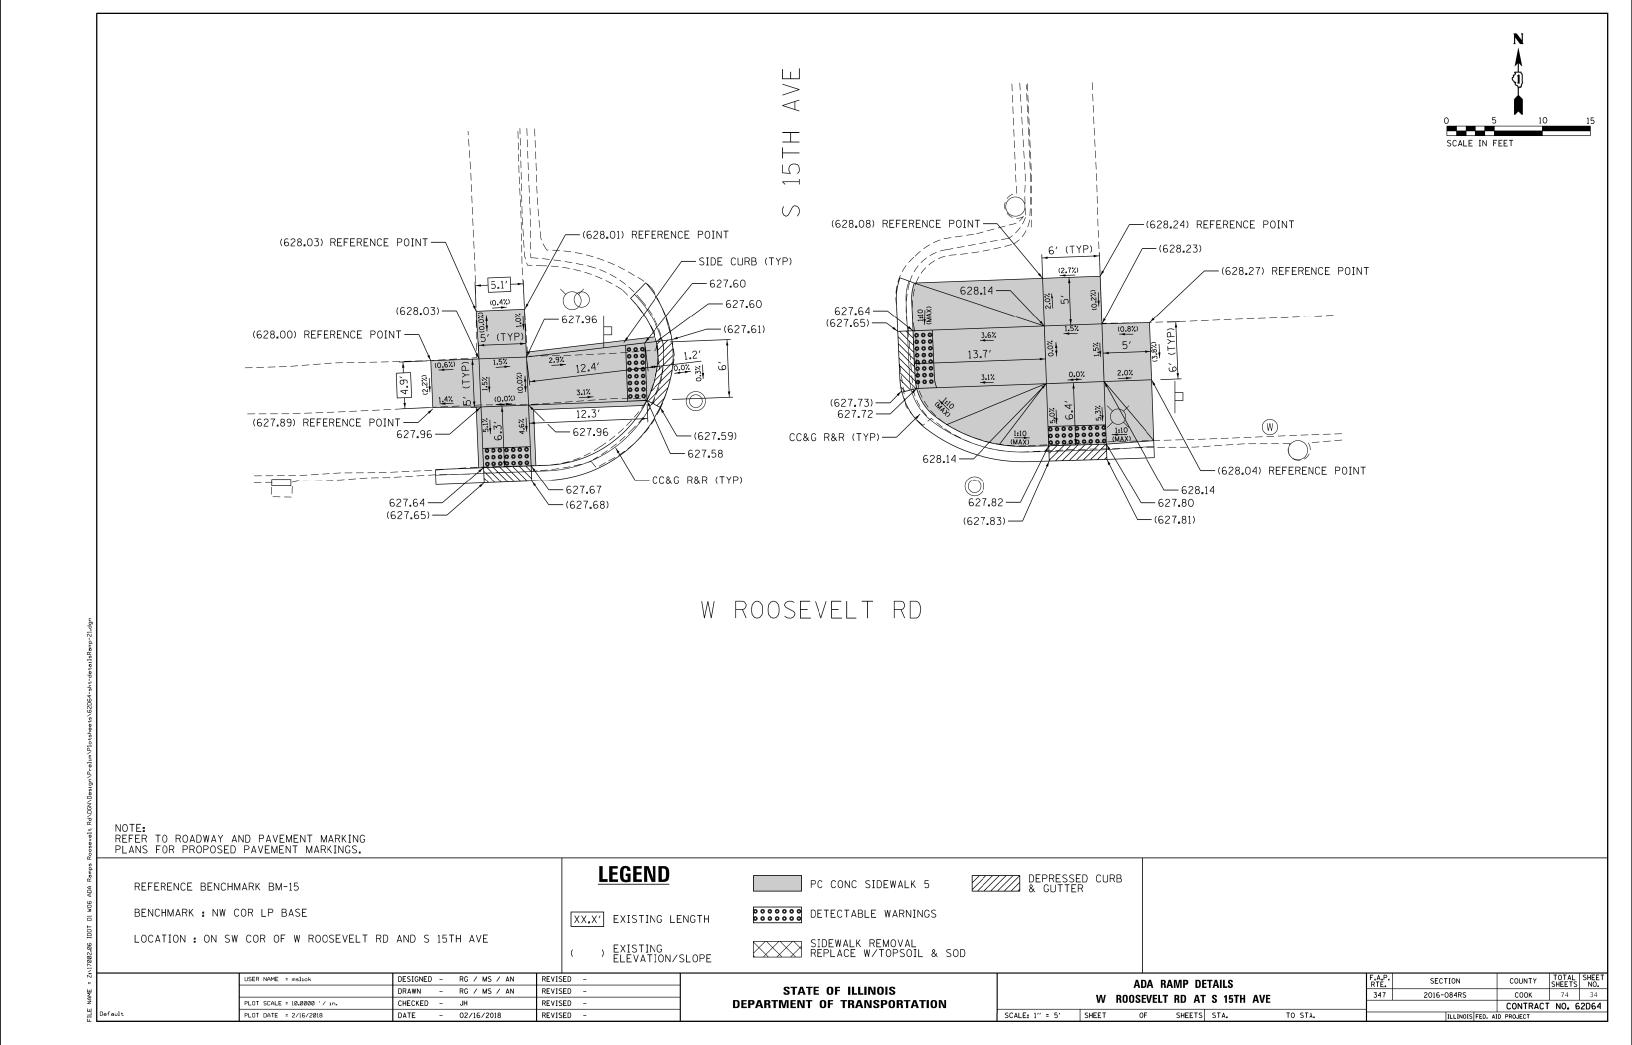

W ROOSEVELT RD SCALE IN FEET — (627**.**74) — 627**.**73 (627.80) — - (627**.**86) -- 627**.**85 (627.84) -627.79-627.83-- CC&G R&R (TYP) 627.98-627.79 REBUILD EX HANDHOLE CC&G R&R (TYP) 000000000 1:10 000000000 MAX -627.79 627.64-- 627.65 --- (627.66) - (627.85) REFERENCE POINT (627.65)-10.6 -627**.**98 11**.**5′ -(627.99) REFERENCE POINT (627.60)----FR & LIDS ADJUST -(627**.**60) 627.57 **─** 627**.**88 — 627**.**59 (628.07)-627.57-**─** 627**.**59 6' (TYP) -SIDE CURB (TYP) -FR & LIDS ADJUST (<u>3.6%)</u> 5′ (TYP) (628.05) REMOV SIGN PANEL T1-RELOC SIGN PANEL T1 -(628.07) REFERENCE POINT (628.12) (627.79) REFERENCE POINT ш \bigcirc NOTE: REFER TO ROADWAY AND PAVEMENT MARKING PLANS FOR PROPOSED PAVEMENT MARKINGS. **LEGEND** PC CONC SIDEWALK 5 REFERENCE BENCHMARK BM-15 DETECTABLE WARNINGS BENCHMARK : NW COR LP BASE XX.X' EXISTING LENGTH LOCATION: ON SW COR OF W ROOSEVELT RD AND S 15TH AVE SIDEWALK REMOVAL REPLACE W/TOPSOIL & SOD) EXISTING ELEVATION/SLOPE SHEETS NO. DESIGNED - RG / MS / AN USER NAME = mslick REVISED -SECTION ADA RAMP DETAILS STATE OF ILLINOIS DRAWN - RG / MS / AN REVISED соок 2016-084RS W ROOSEVELT RD AT S 15TH AVE PLOT SCALE = 10.0000 '/ 10. CHECKED -REVISED -**DEPARTMENT OF TRANSPORTATION** CONTRACT NO. 62D64 OF SHEETS STA. TO STA. REVISED SCALE: 1" = 5' SHEET PLOT DATE = 2/16/2018 DATE - 02/16/2018

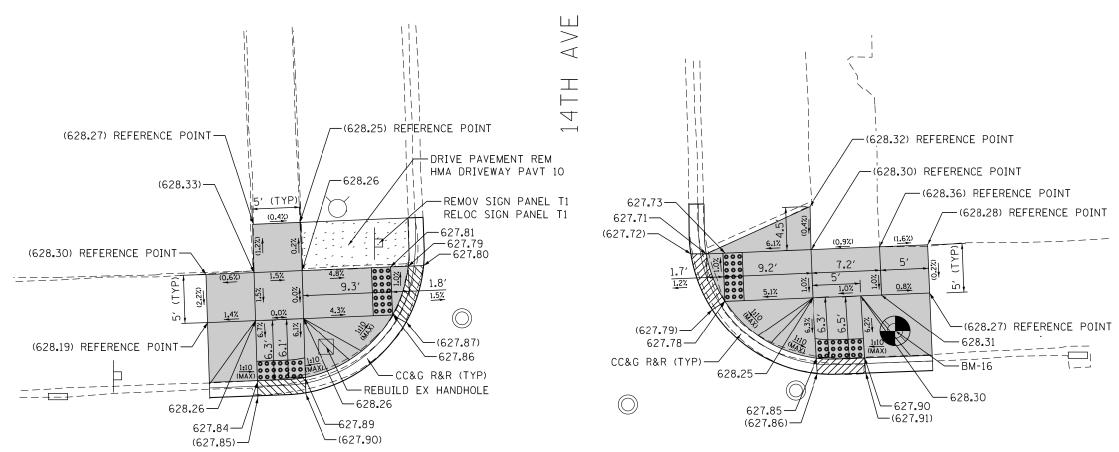

NOTE: REFER TO ROADWAY AND PAVEMENT MARKING PLANS FOR PROPOSED PAVEMENT MARKINGS.

PC CONC SIDEWALK 5

[XX.X'] EXISTING LENGTH

CONC SIDEWALK 5

[XX.X'] EXISTING LENGTH

[XX.X'] E

REFERENCE BENCHMARK BM-16

BENCHMARK : CORNER CONC LP BASE


LOCATION : ON NE COR OF W ROOSEVELT RD AND 14TH AVE

SECTION 2016-084RS

CONTRACT NO. 62D64

USER NAME = mslick	DESIGNED -	RG / MS / AN	REVISED -		ADA RAMP DETAILS					
	DRAWN -	RG / MS / AN	REVISED -	STATE OF ILLINOIS	W ROOSEVELT RD AT 14TH AVE					
PLOT SCALE = 10.0000 '/ in.	CHECKED -	JH	REVISED -	DEPARTMENT OF TRANSPORTATION						
PLOT DATE = 2/16/2018	DATE -	02/16/2018	REVISED -		SCALE: 1" = 5'	SHEET	OF SHEE	TS STA.	TO STA.	

: NAME = ZiNI7002.06 IDOT DI WO6 ADA Romps Roosevelt Rd\DGN\Design\Prelim\Plotsheets\62D6

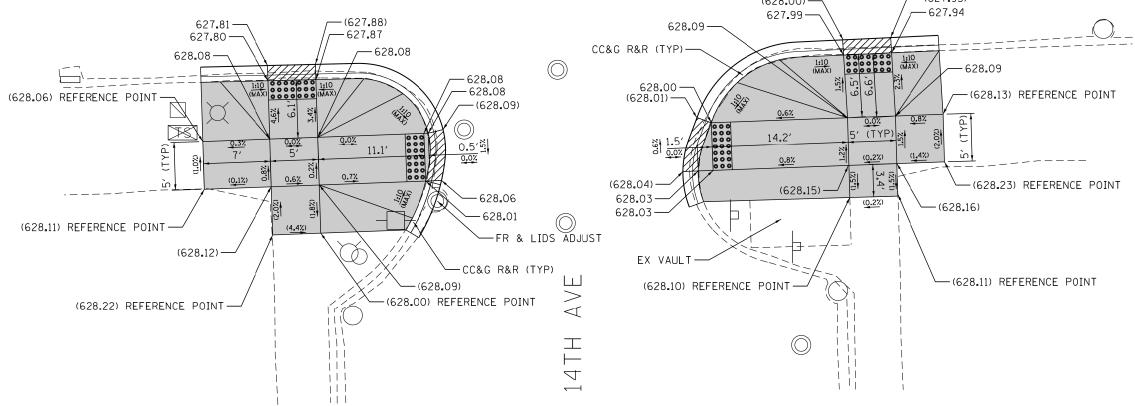

NOTE: REFER TO ROADWAY AND PAVEMENT MARKING PLANS FOR PROPOSED PAVEMENT MARKINGS.

LEGEND

XX.X' EXISTING LENGTH

) EXISTING ELEVATION/SLOPE PC CONC SIDEWALK 5



REFERENCE BENCHMARK BM-16

BENCHMARK : CORNER CONC LP BASE

LOCATION : ON NE COR OF W ROOSEVELT RD AND 14TH AVE

USER NAME = mslick	DESIGNED	-	RG / MS / AN	REVIS	ED -
	DRAWN	-	RG / MS / AN	REVIS	ED -
PLOT SCALE = 10.0000 ' / in.	CHECKED	-	JH	REVIS	ED -
PLOT DATE = 2/16/2018	DATE	_	02/16/2018	REVIS	ED -


STATE OF ILLINOIS DEPARTMENT OF TRANSPORTATION

DETECTABLE WARNINGS

SIDEWALK REMOVAL REPLACE W/TOPSOIL & SOD


	w	ADA I Rooseve	RAMP DE LT RD A		AVE
ALE: 1" = 5"	SHEET	OF	SHEETS	STA.	TO STA.

	n n a a mma			
		CONTRACT	NO. 6	2D64
347	2016-084RS	соок	74	37
F.A.P. RTE.	SECTION	COUNTY	SHEETS	NO.

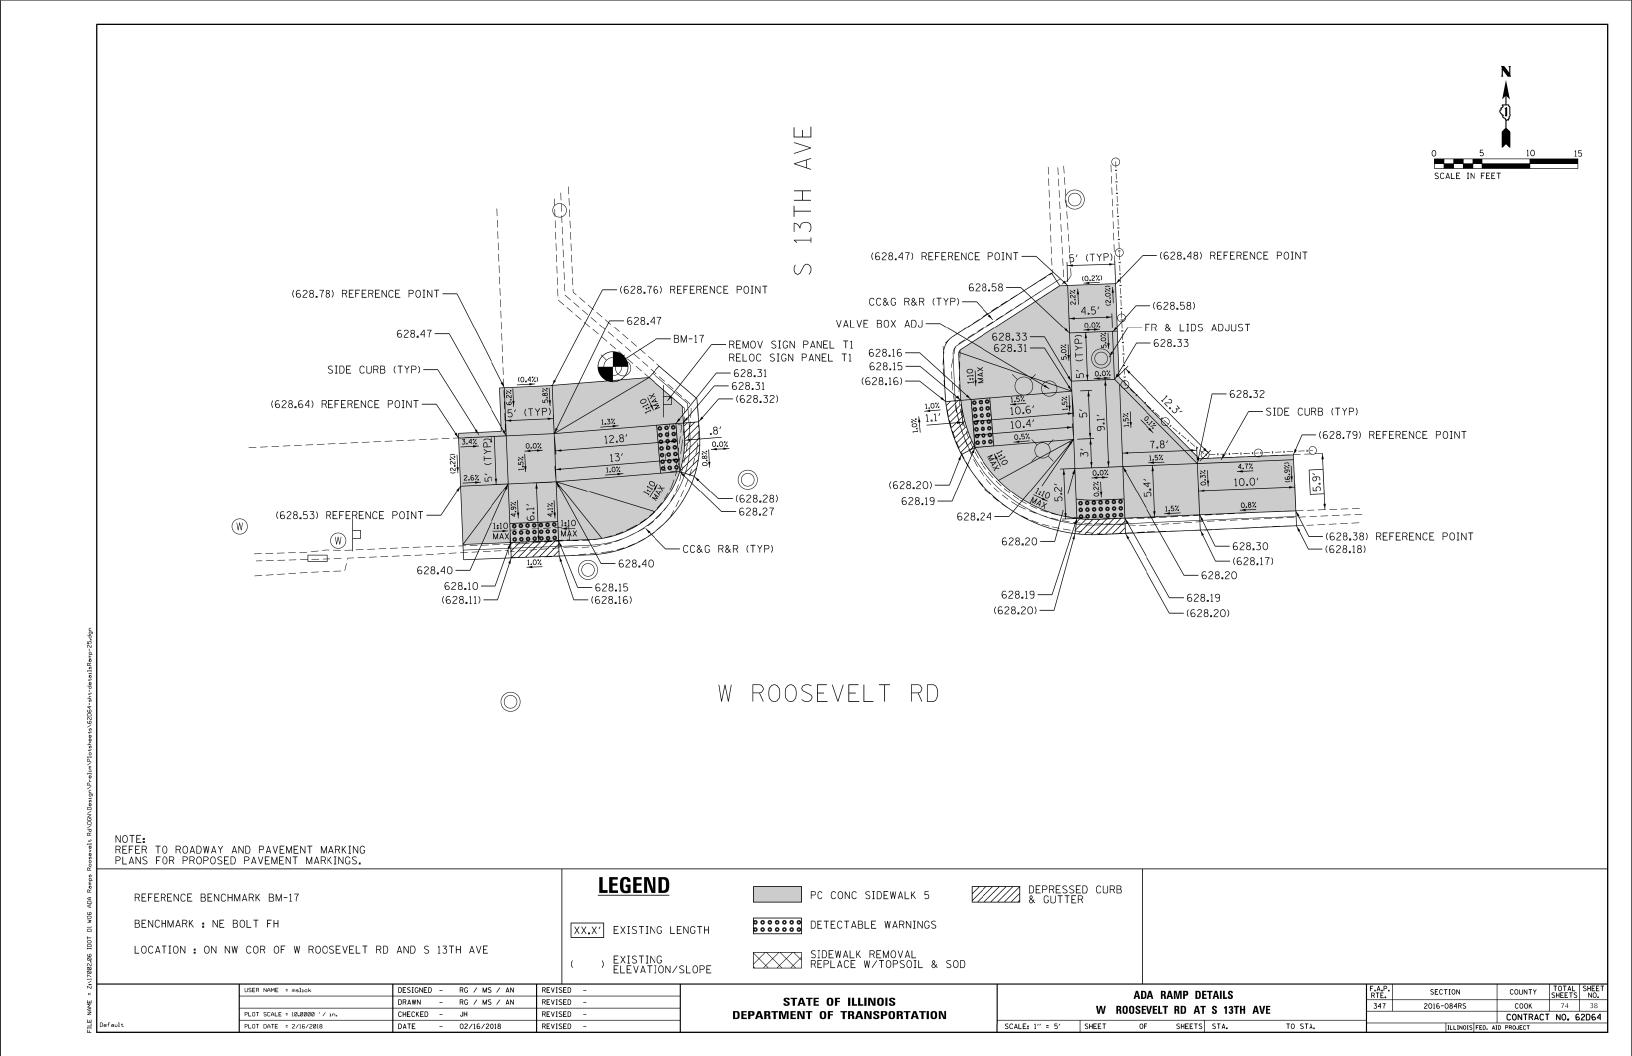

SCALE IN FEET

W ROOSEVELT RD

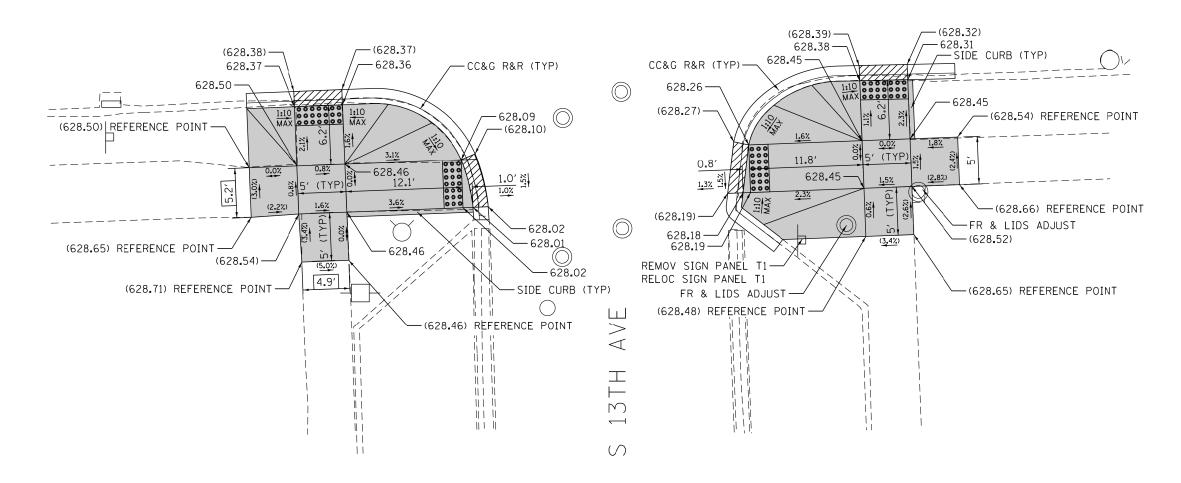

NOTE: REFER TO ROADWAY AND PAVEMENT MARKING PLANS FOR PROPOSED PAVEMENT MARKINGS.

REFERENCE BENCHMARK BM-17

BENCHMARK : NE BOLT FH

LOCATION: ON NW COR OF W ROOSEVELT RD AND S 13TH AVE

LEGEND

PC CONC SIDEWALK 5

SCALE: 1" = 5'

XX.X' EXISTING LENGTH

DETECTABLE WARNINGS

) EXISTING ELEVATION/SLOPE


SIDEWALK REMOVAL REPLACE W/TOPSOIL & SOD

USER NAME = mslick	DESIGNED	-	RG / MS / AN	REVISED	-
	DRAWN	-	RG / MS / AN	REVISED	-
PLOT SCALE = 10.0000 ' / 10.	CHECKED	-	JH	REVISED	-
PLOT DATE = 2/16/2018	DATE	-	02/16/2018	REVISED	-


STATE OF ILLINOIS	
DEPARTMENT OF TRANSPORTATION	

ADA RAMP DETAILS					F.A.P. RTE.	SECTION		
w	ROOSEVELT	RD AT	S 13TH AVE		347	2016-084RS		
. **	HOUSEVEEL	וא טוו	3 IJIII AVL				ĺ	
SHEET	OF	SHEETS	STA.	TO STA.		ILLINOIS FED. AI	i	


TOTAL SHEE NO. COUNTY соок CONTRACT NO. 62D64

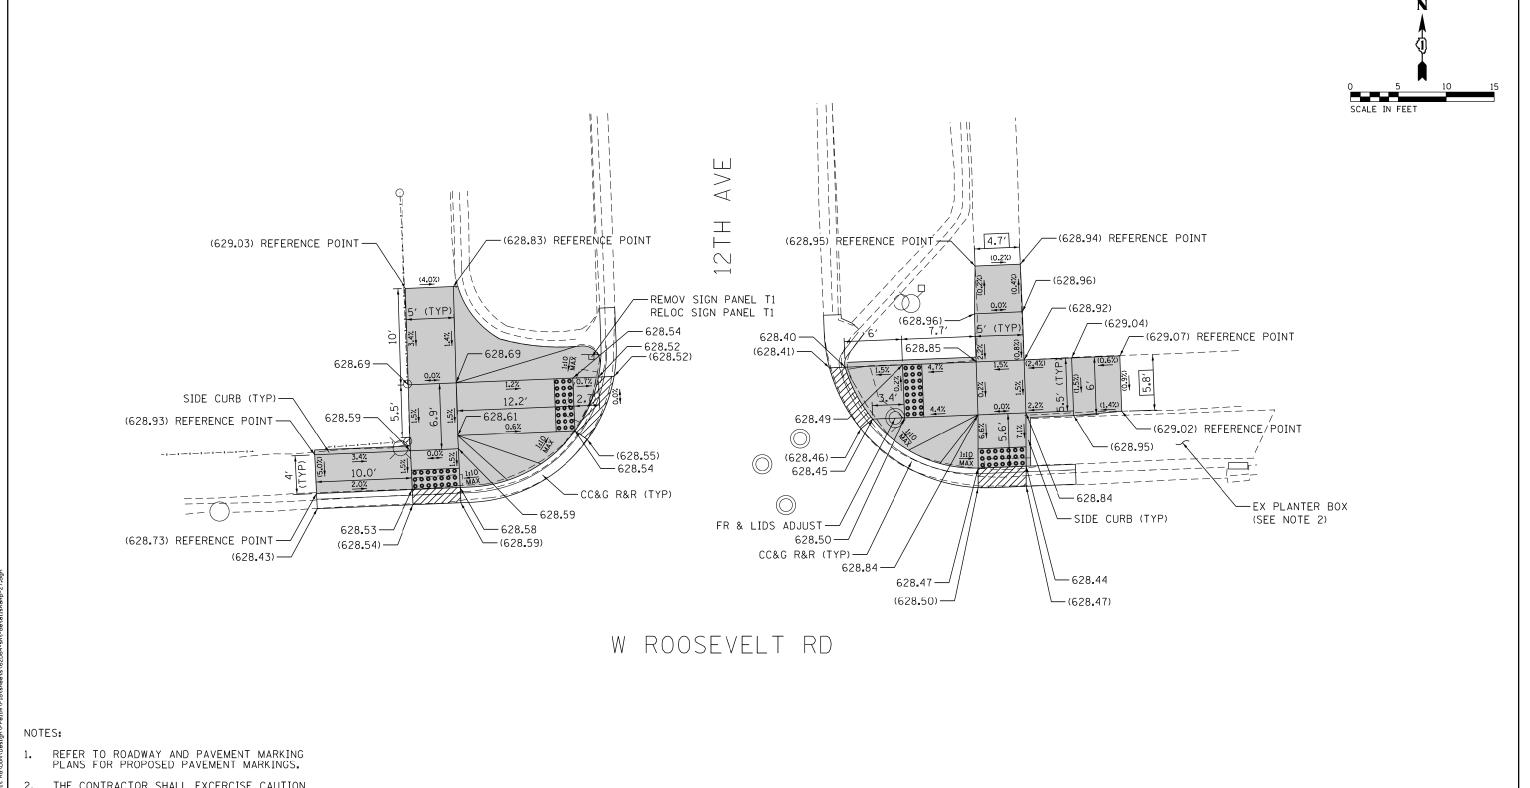


2. THE CONTRACTOR SHALL EXCERCISE CAUTION NOT TO DAMAGE THE EXISITNG PLANTER.

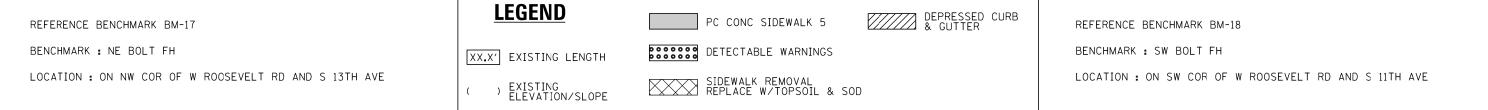

DESIGNED - RG / MS / AN TOTAL SHEE NO. 74 40 REVISED -USER NAME = mslick SECTION ADA RAMP DETAILS STATE OF ILLINOIS DRAWN - RG / MS / AN REVISED 2016-084RS COOK W ROOSEVELT RD AT 12TH AVE PLOT SCALE = 10.0000 ' / 10. CHECKED -REVISED **DEPARTMENT OF TRANSPORTATION** CONTRACT NO. 62D64 OF SHEETS STA. SCALE: 1" = 5' SHEET TO STA. PLOT DATE = 2/16/2018 DATE - 02/16/2018 REVISED

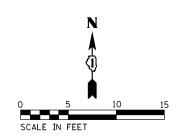

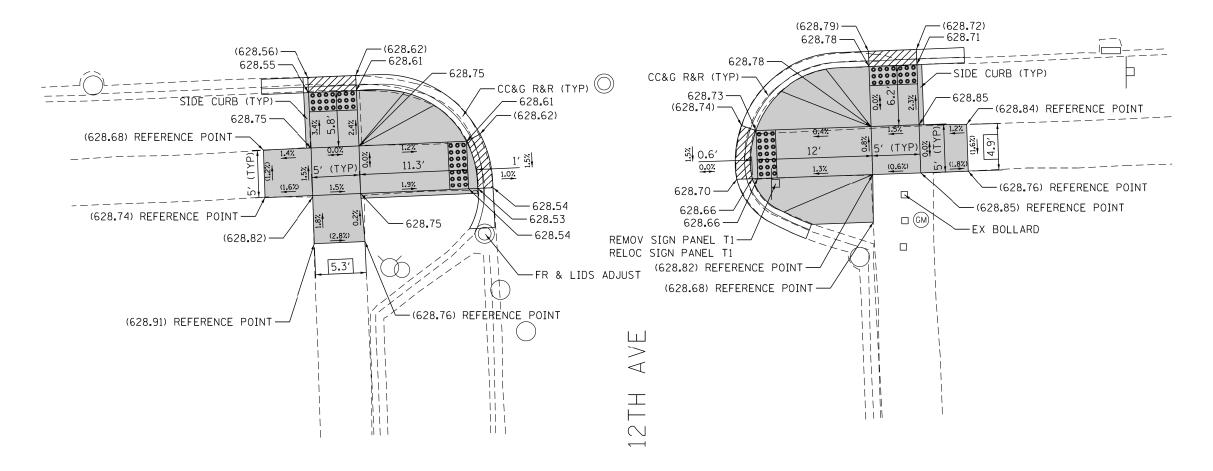

NOTE: REFER TO ROADWAY AND PAVEMENT MARKING PLANS FOR PROPOSED PAVEMENT MARKINGS.

REFERENCE BENCHMARK BM-17

BENCHMARK : NE BOLT FH

LOCATION: ON NW COR OF W ROOSEVELT RD AND S 13TH AVE

LEGEND

PC CONC SIDEWALK 5



REFERENCE BENCHMARK BM-18

BENCHMARK : SW BOLT FH

LOCATION: ON SW COR OF W ROOSEVELT RD AND S 11TH AVE

) EXISTING ELEVATION/SLOPE

XX.X' EXISTING LENGTH

SIDEWALK REMOVAL REPLACE W/TOPSOIL & SOD

DETECTABLE WARNINGS


ΔΓ	NA RAMP DETAILS


ADA R	AMP DE	TAILS		RTE.	SECTION	COUNTY	SHEETS	NO.
ROOSEVELT RD AT 12TH AVE			347	2016-084RS	COOK	74	41	
HOUSEVEE	י א שוו וי	1 12111 /	AVL			CONTRACT	NO. 6	2D64
OF	SHEETS	STA.	TO STA.		ILLINOIS FED. AI	D PROJECT		


USER NAME = mslick DESIGNED - RG / MS / AN REVISED -DRAWN - RG / MS / AN REVISED -PLOT SCALE = 10.0000 '/ 10. CHECKED -REVISED -PLOT DATE = 2/16/2018 REVISED DATE - 02/16/2018

STATE OF ILLINOIS **DEPARTMENT OF TRANSPORTATION**

SCALE: 1" = 5' SHEET

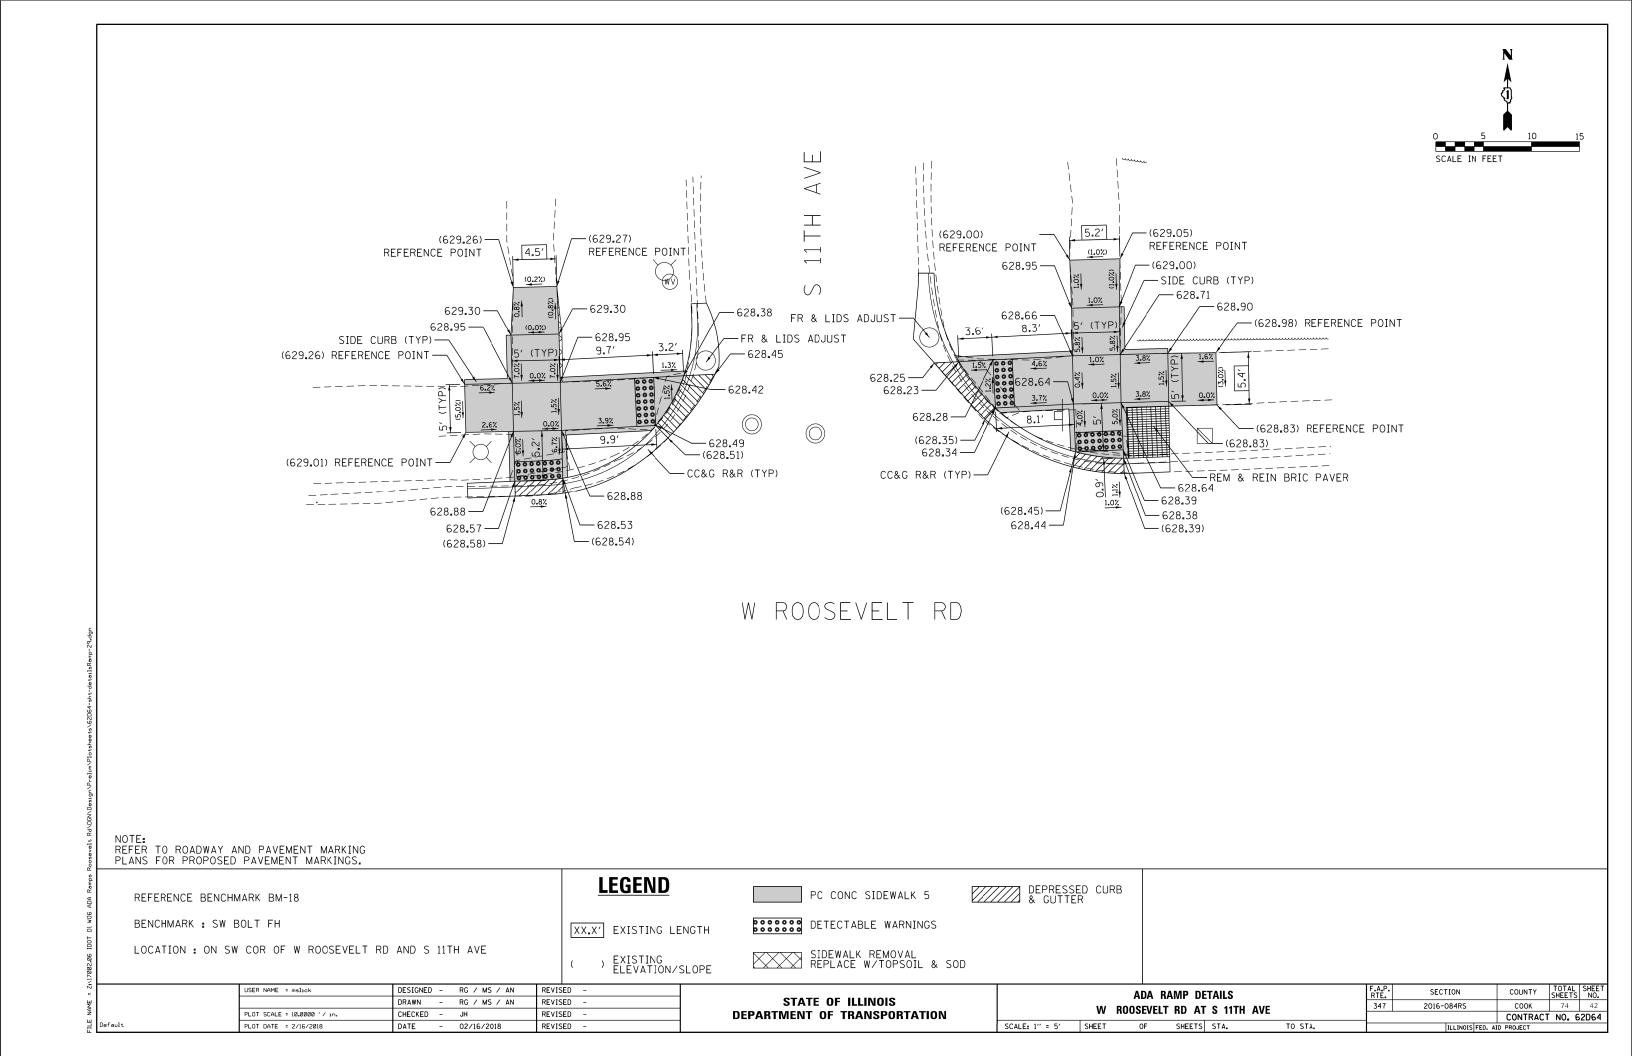

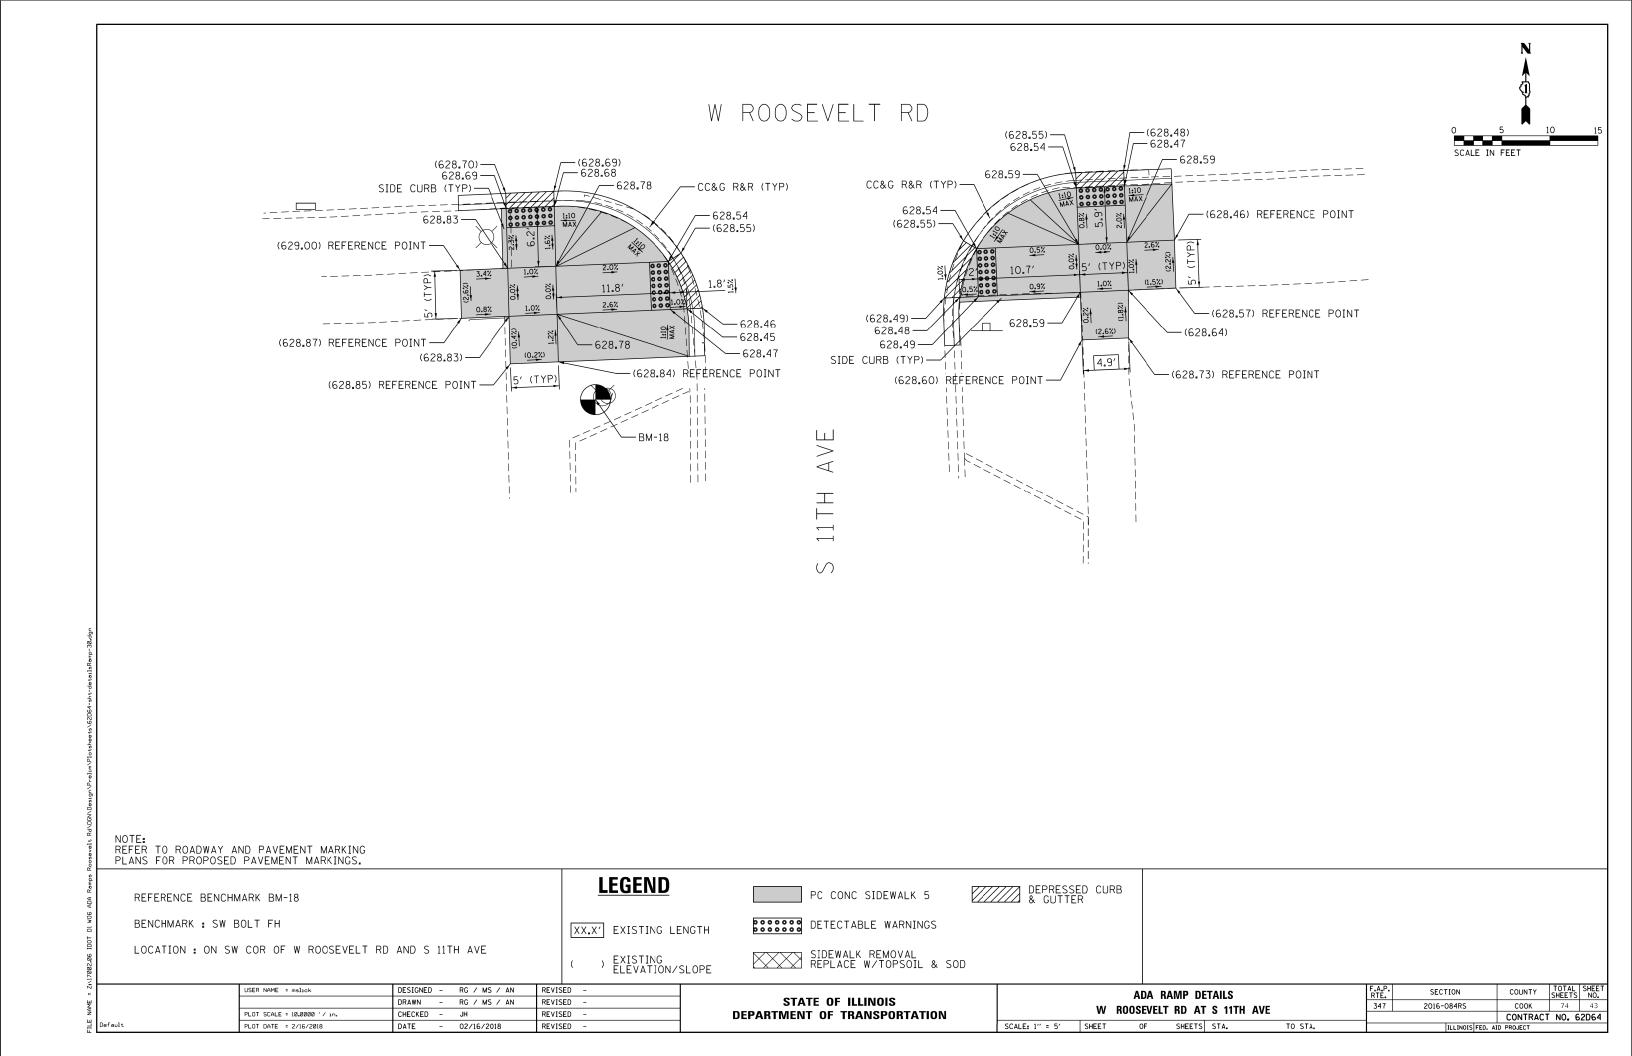

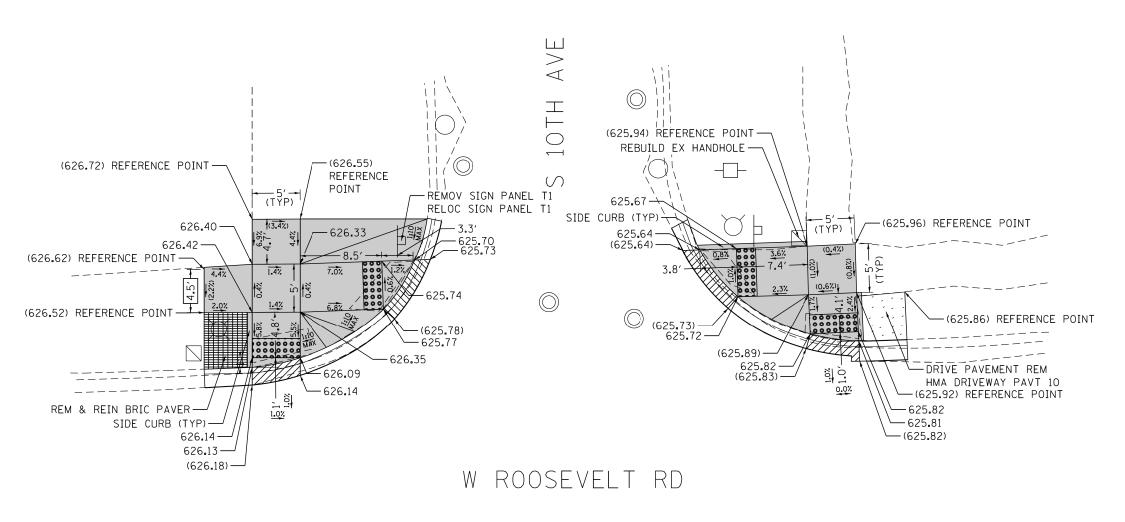

NOTE: REFER TO ROADWAY AND PAVEMENT MARKING PLANS FOR PROPOSED PAVEMENT MARKINGS.

REFERENCE BENCHMARK BM-19

BENCHMARK : NW BOLT FH

LOCATION : ON SW COR OF W ROOSEVELT RD AND S 10TH AVE

USER NAME = mslick

LEGEND

XX.X' EXISTING LENGTH

REVISED -

PC CONC SIDEWALK 5

DETECTABLE WARNINGS

) EXISTING ELEVATION/SLOPE

SIDEWALK REMOVAL REPLACE W/TOPSOIL & SOD

STATE (OF ILLINOIS

	w	ADA RA ROOSEVELT		TAILS S 10TH AVE	
SCALE: 1" = 5"	SHEET	OF	SHEETS	STA.	TO STA.


TOTAL SHEE NO.

74 44 SECTION COOK 2016-084RS CONTRACT NO. 62D64

DRAWN - RG / MS / AN REVISED -PLOT SCALE = 10.0000 '/ 10. CHECKED - JH REVISED -PLOT DATE = 2/16/2018 DATE - 02/16/2018 REVISED -

DESIGNED - RG / MS / AN

DEPARTMENT OF TRANSPORTATION

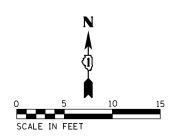


TOTAL SHEE NO. 74 45

CONTRACT NO. 62D64

СООК

W ROOSEVELT RD

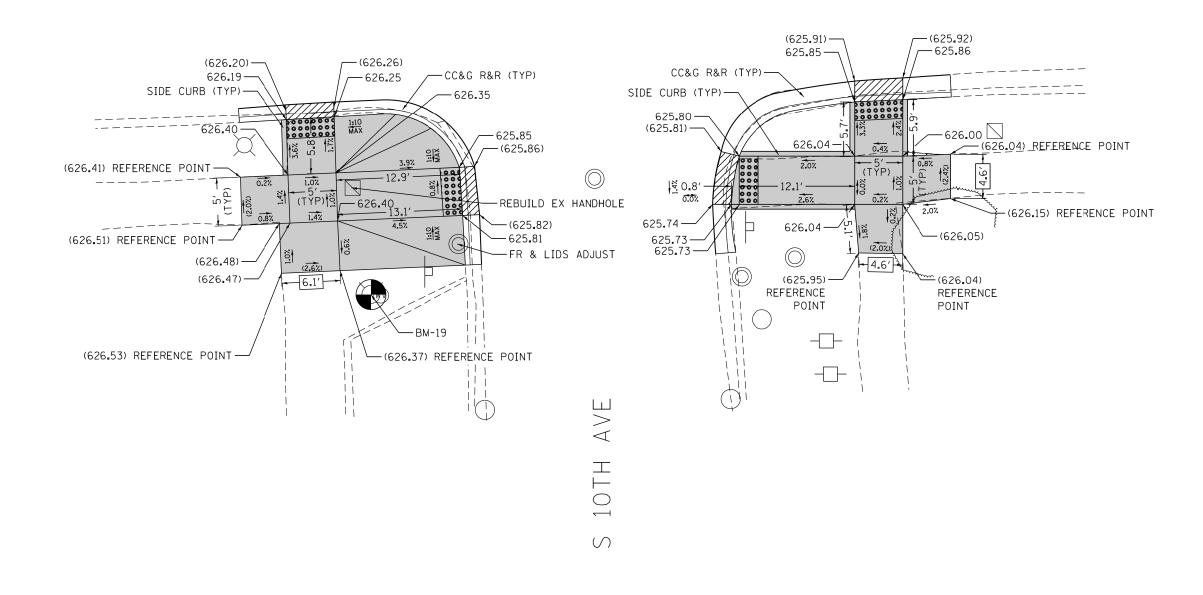

NOTE: REFER TO ROADWAY AND PAVEMENT MARKING PLANS FOR PROPOSED PAVEMENT MARKINGS.

REFERENCE BENCHMARK BM-19 BENCHMARK : NW BOLT FH

LOCATION: ON SW COR OF W ROOSEVELT RD AND S 10TH AVE

LEGEND

PC CONC SIDEWALK 5



XX.X' EXISTING LENGTH

DETECTABLE WARNINGS





SIDEWALK REMOVAL REPLACE W/TOPSOIL & SOD

				l l
USER NAME = mslick	DESIGNED	-	RG / MS / AN	REVISED -
	DRAWN	-	RG / MS / AN	REVISED -
PLOT SCALE = 10.0000 ' / in.	CHECKED	-	JH	REVISED -
PLOT DATE = 2/16/2018	DATE	-	02/16/2018	REVISED -

STATE OF ILLINOIS				
DEPARTMENT OF	TRANSPORTATION			

		ADA R	AMP DE	TAILS		RTE.	SECTION	
	w	ROOSEVELT	RD AT	S 10TH	ΔVF	347	2016-084RS	
		HOOOLVEEL	IID AI		AVE			
SCALE: 1" = 5'	SHEET	OF	SHEETS	STA.	TO STA.		ILLINOIS FED. A	D

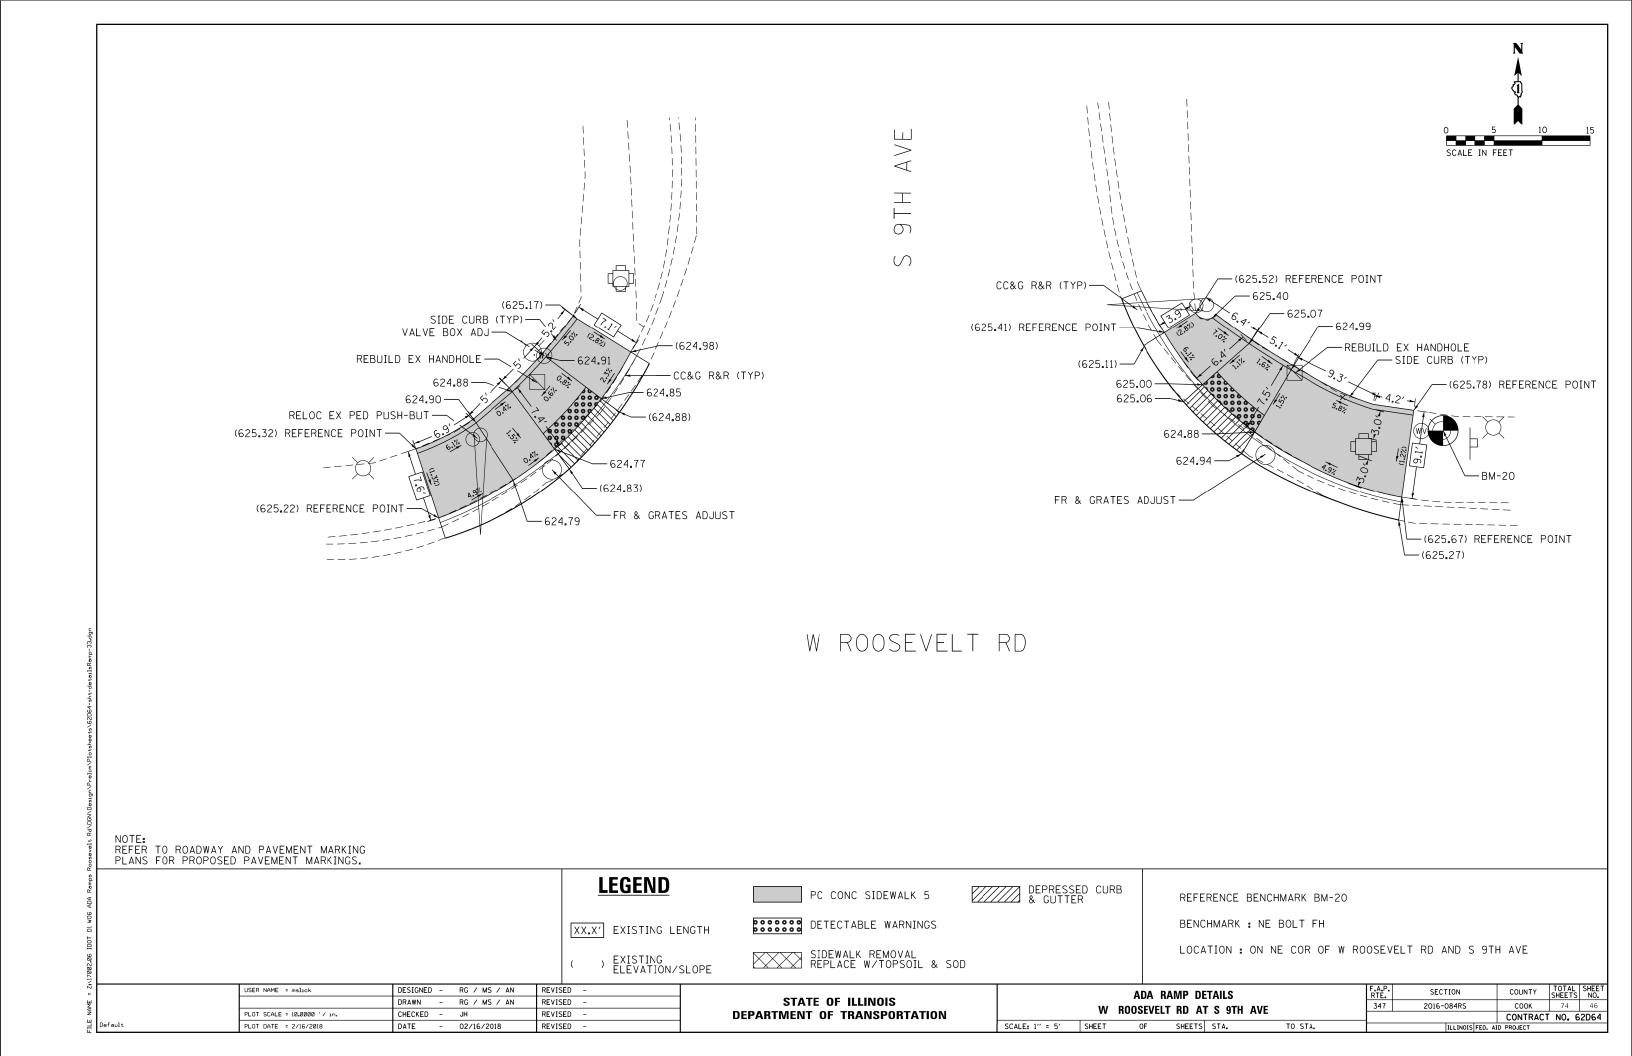

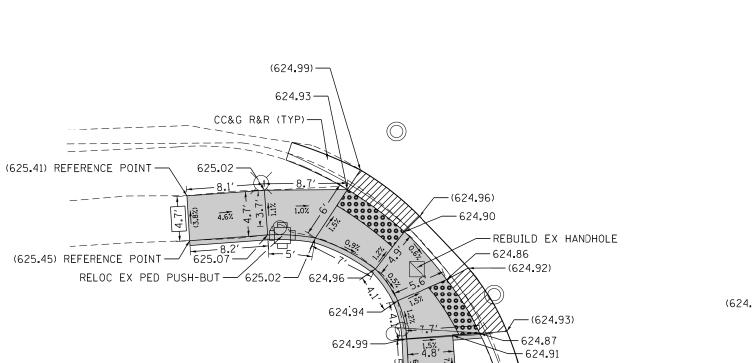

SIDE CURB (TYP)-

(625.48) REFERENCE POINT —

(625.32) REFERENCE POINT--CC&G R&R (TYP) (625.20) 625.21 FR & LIDS ADJUST -SIDE CURB (TYP) 624.70--REBUILD EX HANDHOLE (624.76) REFERENCE POINT \bigcirc

NOTE: REFER TO ROADWAY AND PAVEMENT MARKING PLANS FOR PROPOSED PAVEMENT MARKINGS.

LEGEND

XX.X' EXISTING LENGTH

PC CONC SIDEWALK 5

(625.37) REFERENCE POINT

REFERENCE BENCHMARK BM-20

BENCHMARK : NE BOLT FH

LOCATION : ON NE COR OF W ROOSEVELT RD AND S 9TH AVE

) EXISTING ELEVATION/SLOPE

SIDEWALK REMOVAL REPLACE W/TOPSOIL & SOD


DETECTABLE WARNINGS


USER NAME = mslick	DESIGNED	-	RG / MS / AN	REVISED	-
	DRAWN	-	RG / MS / AN	REVISED	-
PLOT SCALE = 10.00000 '/ in.	CHECKED	-	JH	REVISED	-
DLOT DATE - 2/16/2010	DATE		02/16/2019	DEVISED	_

STATE OF	ILLINOIS
DEPARTMENT OF	TRANSPORTATION

		ADA R	AMP DE	TAILS		F.A.P. RTE.	SECTION	
	w	ROOSEVEL	T RN A1	S 9TH AVE		347	2016-084RS	
		HOUGEVEE	. IID A	O JIII AVE				C
5'	SHEET	ΩF	SHEETS	STA	TO STA.		TILITHOIS EED AT	n D

CONTRACT NO. 62D64

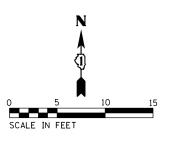

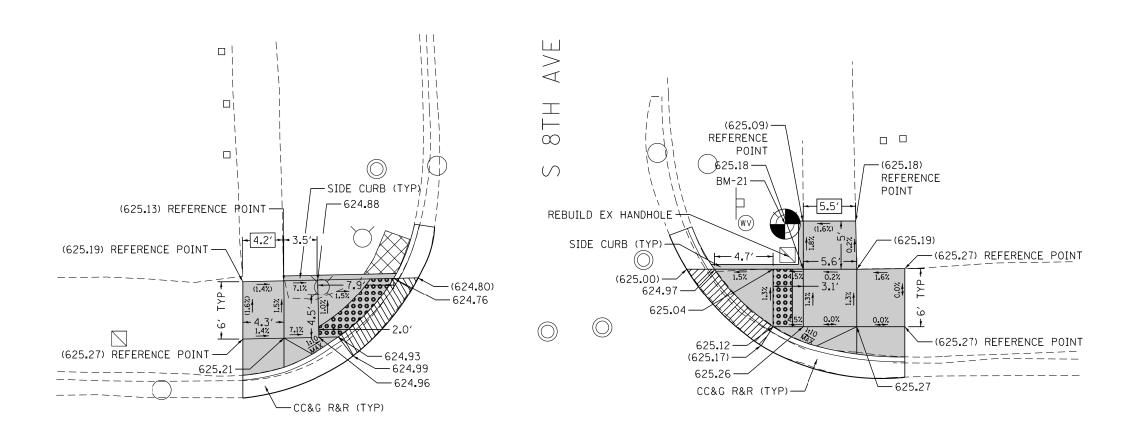

NOTE: REFER TO ROADWAY AND PAVEMENT MARKING PLANS FOR PROPOSED PAVEMENT MARKINGS.

LEGEND

PC CONC SIDEWALK 5


DEPRESSED CURB
& GUTTER


REFERENCE BENCHMARK BM-21

BENCHMARK: NE BOLT FH

LOCATION: ON NE COR OF W ROOSEVELT RD AND S 8TH AVE

DESIGNED - RG / MS / AN USER NAME = mslick REVISED -ADA RAMP DETAILS STATE OF ILLINOIS DRAWN - RG / MS / AN REVISED -2016-084RS W ROOSEVELT RD AT S 8TH AVE CHECKED - JH PLOT SCALE = 10.0000 ' / 10. REVISED -**DEPARTMENT OF TRANSPORTATION** CONTRACT NO. 62D64 DATE - 02/16/2018 SCALE: 1" = 5' SHEET OF SHEETS STA. REVISED -PLOT DATE = 2/16/2018

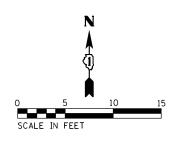

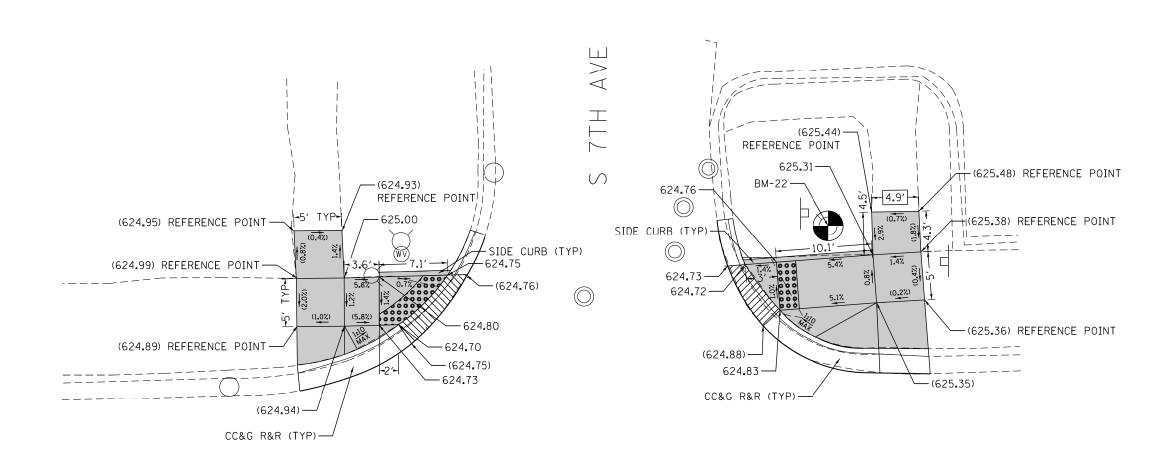


NOTE: REFER TO ROADWAY AND PAVEMENT MARKING PLANS FOR PROPOSED PAVEMENT MARKINGS.

REFERENCE BENCHMARK BM-22


BENCHMARK : NE BOLT FH

LOCATION : ON NE COR OF W ROOSEVELT RD AND S 7TH AVE

USER NAME = mslick	DESIGNED - RG / MS / A	N REVISED -				ΔΠΔ	RAMP DETAILS		F.A.P.	SECTION	COUNTY	TOTAL SHEET
	DRAWN - RG / MS / A	N REVISED -	STATE OF ILLINOIS	W ROOSFVELT RD AT S 7TH AVF 347 2016-084RS 0		соок	74 49					
PLOT SCALE = 10.0000 '/ 10.	CHECKED - JH	REVISED -	DEPARTMENT OF TRANSPORTATION					T NO. 62D64				
PLOT DATE = 2/16/2018	DATE - 02/16/2018	REVISED -		SCALE: 1" = 5'	SHEET	OF	SHEETS STA.	TO STA.		ILLINOIS FED.	AID PROJECT	

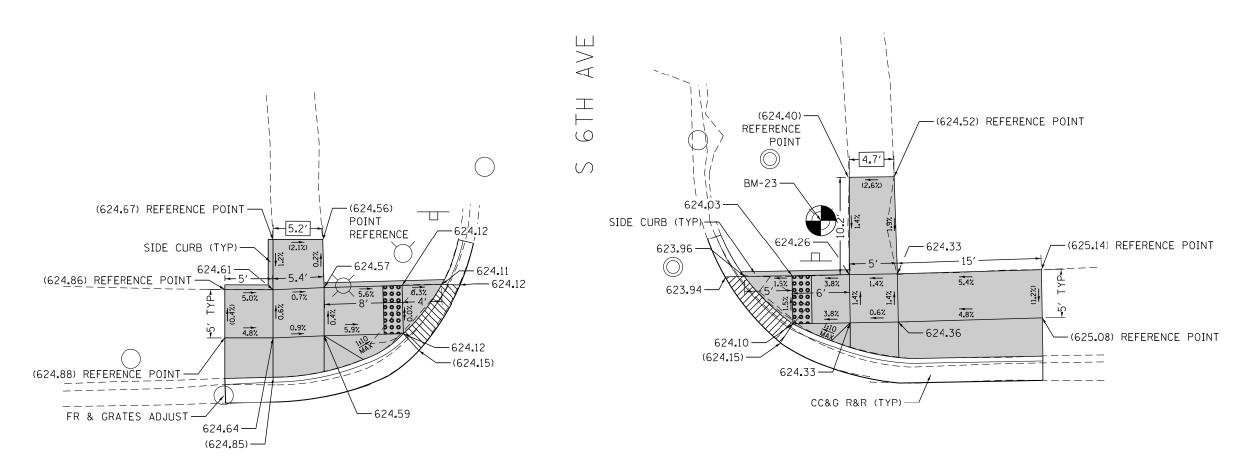

NOTE: REFER TO ROADWAY AND PAVEMENT MARKING PLANS FOR PROPOSED PAVEMENT MARKINGS.

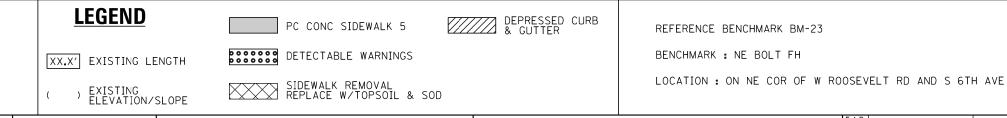


FILE NAME = Ziv17002.06 IDOT DI WO6 ADA Ramps Roosevelt


STATE OF ILLINOIS
DEPARTMENT OF TRANSPORTATION

 ADA RAMP DETAILS

 W
 ROOSEVELT RD AT S 6TH AVE


 SCALE: 1" = 5"
 SHEET
 OF SHEETS STA. TO STA.

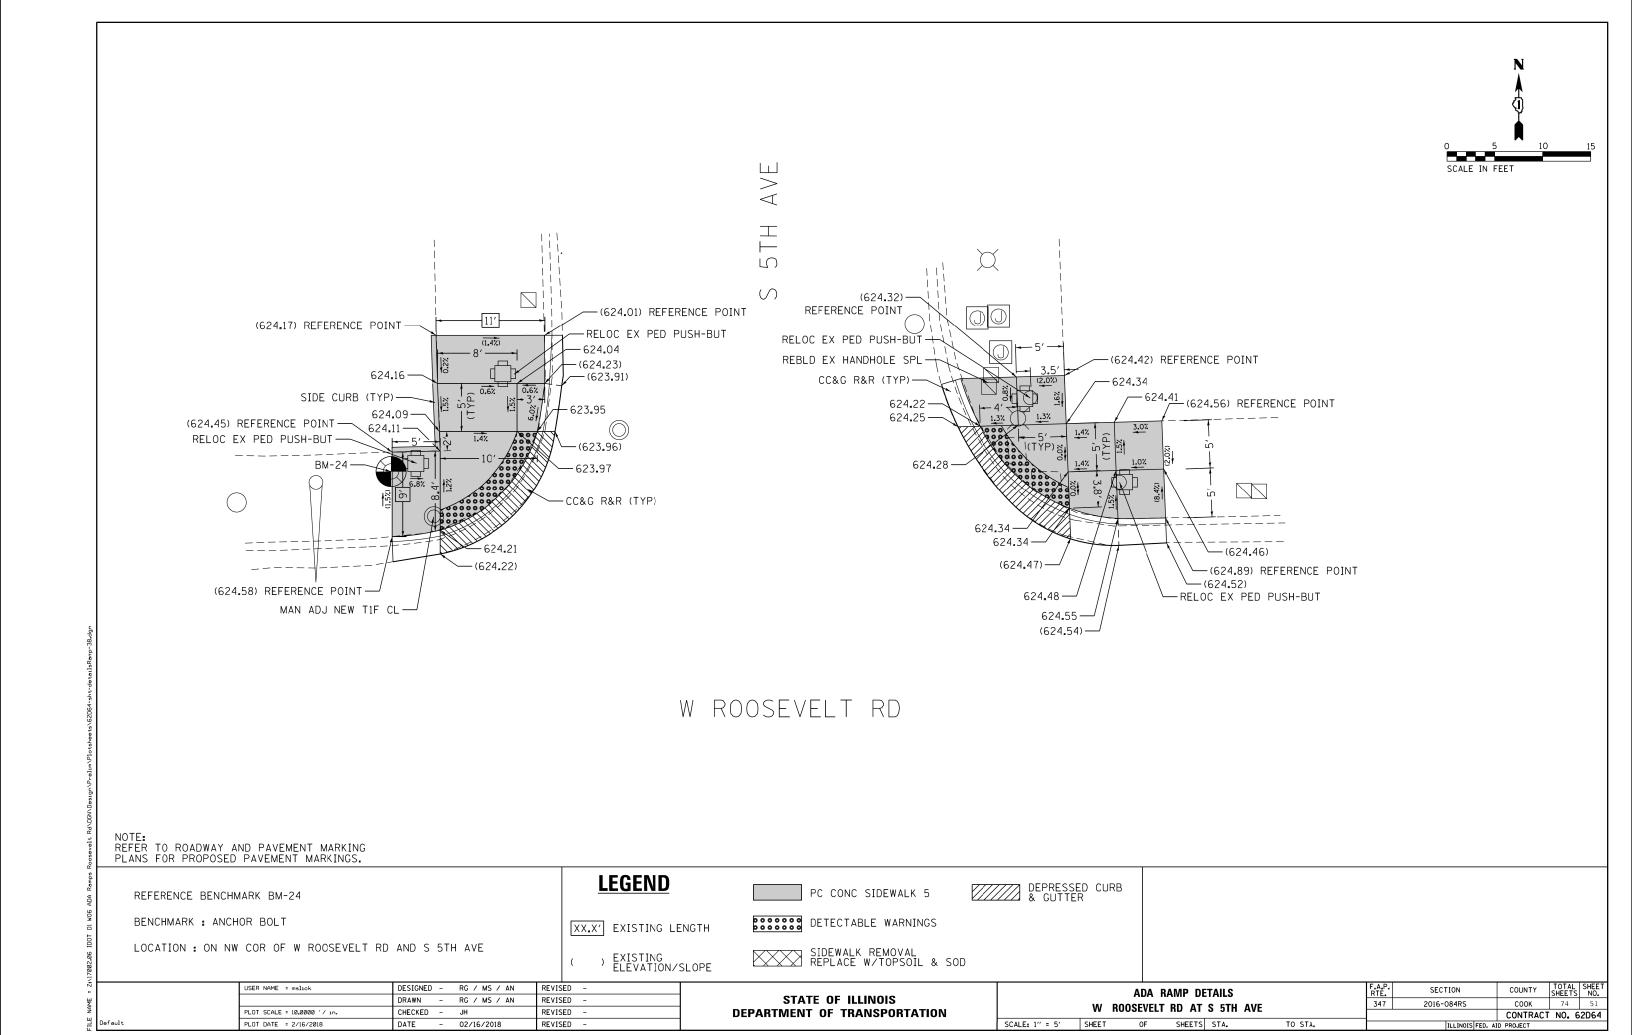

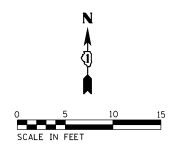


COUNTY TOTAL SHEETS NO.

COOK 74 52

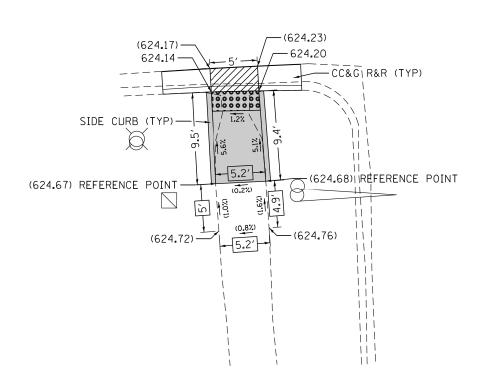

 \bigcirc

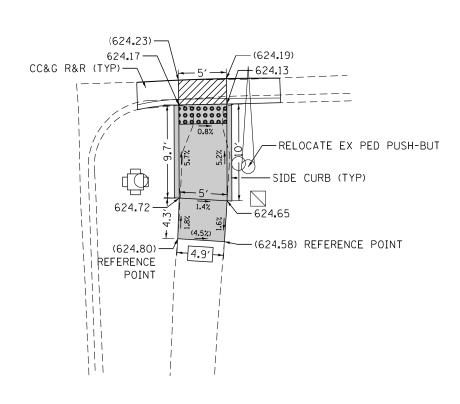

NOTE: REFER TO ROADWAY AND PAVEMENT MARKING PLANS FOR PROPOSED PAVEMENT MARKINGS.

REFERENCE BENCHMARK BM-24

BENCHMARK : ANCHOR BOLT

LOCATION : ON NW COR OF W ROOSEVELT RD AND S 5TH AVE

LEGEND

PC CONC SIDEWALK 5



SCALE: 1" = 5'

XX.X' EXISTING LENGTH

DETECTABLE WARNINGS


) EXISTING ELEVATION/SLOPE


SIDEWALK REMOVAL REPLACE W/TOPSOIL & SOD

USER NAME = mslick	DESIGNED	-	RG / MS / AN	REVISED	-
	DRAWN	-	RG / MS / AN	REVISED	-
PLOT SCALE = 10.0000 '/ in.	CHECKED	-	JH	REVISED	-
PLOT DATE = 2/16/2018	DATE	-	02/16/2018	REVISED	-

STATE OF ILLINOIS	
DEPARTMENT OF TRANSPORTATION	

	ADA RAMP DETAILS					F.A.P. RTE.	SECTION	COUNTY	TOTAL SHEETS	SHEET NO.
W ROOSEVELT RD AT S 5TH AVE				AVE	347	2016-084RS	COOK	74	52	
		HOUSEVEEL	ND AI	3 3111 /	TVL			CONTRACT	NO. 6	2D64
	SHEET	OF	SHEETS	STA.	TO STA.		ILLINOIS FED. AI	D PROJECT		

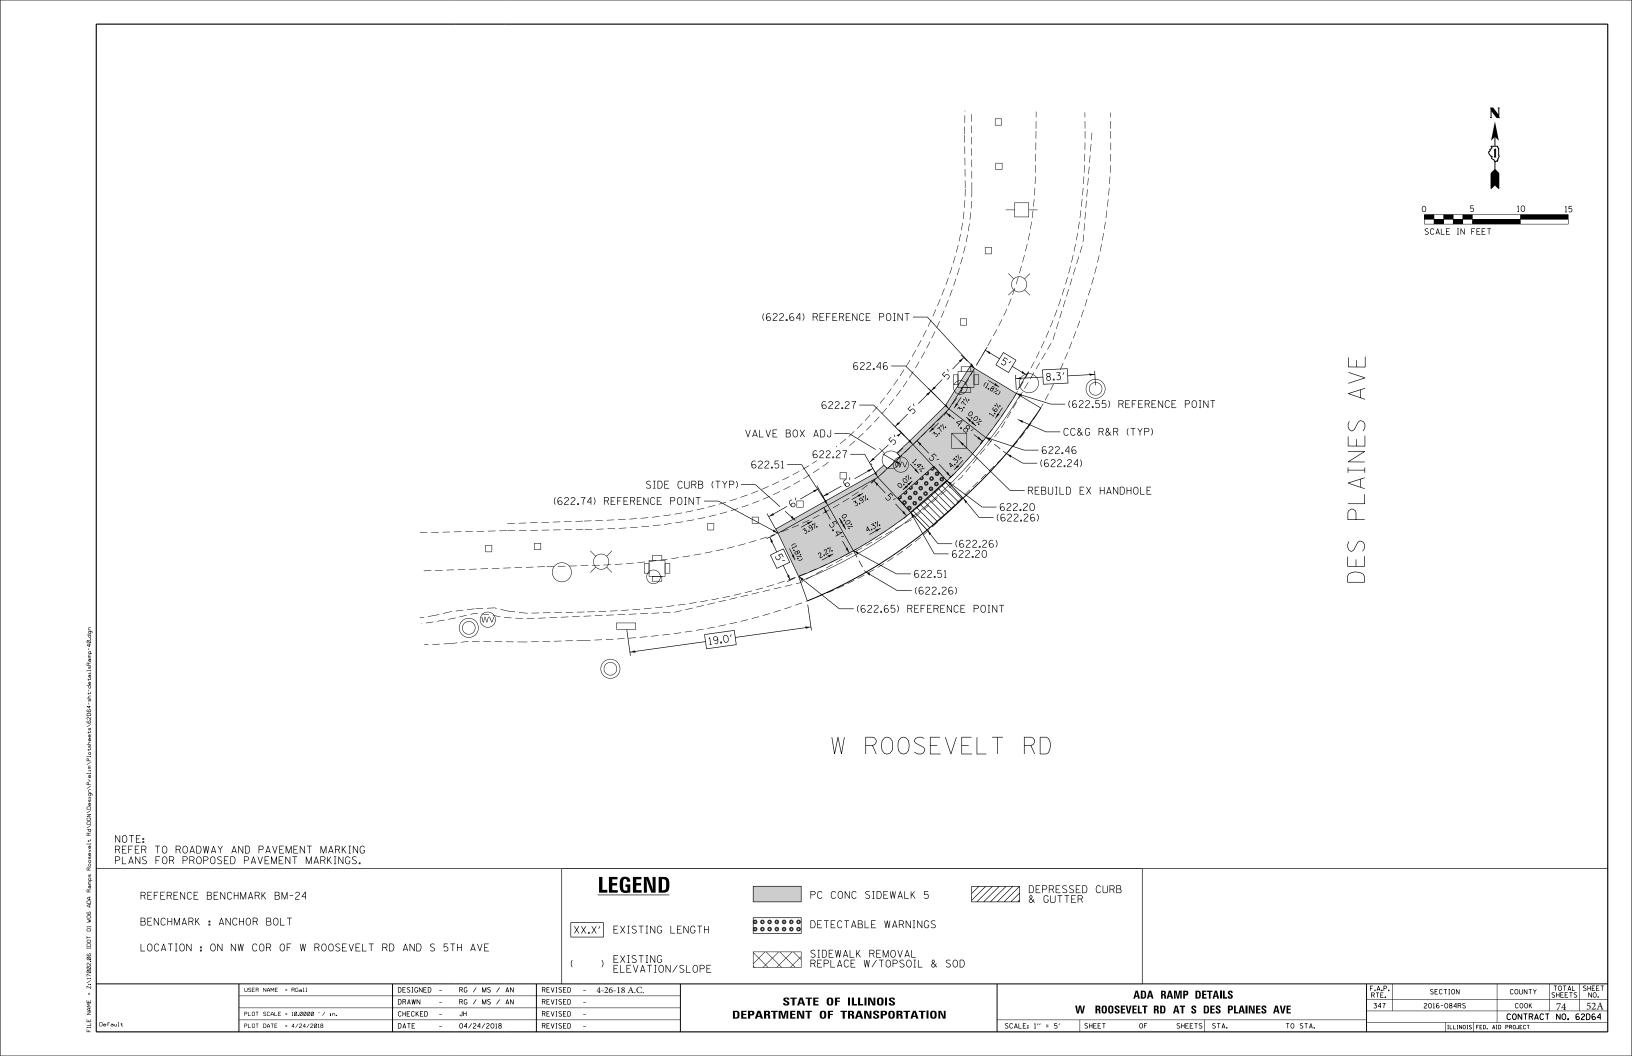

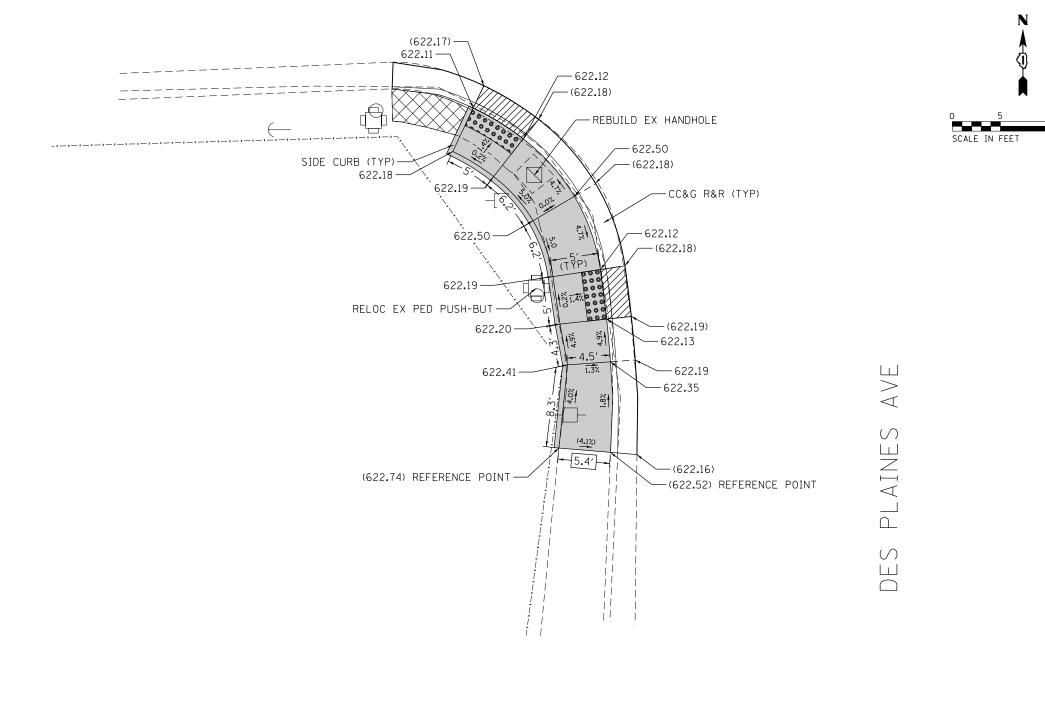

NOTE: REFER TO ROADWAY AND PAVEMENT MARKING PLANS FOR PROPOSED PAVEMENT MARKINGS.

REFERENCE BENCHMARK BM-24

BENCHMARK : ANCHOR BOLT

LOCATION : ON NW COR OF W ROOSEVELT RD AND S 5TH AVE

USER NAME = RGall

LEGEND

REVISED - 4-26-18 A.C.

PC CONC SIDEWALK 5



SCALE: 1" = 5'

XX.X' EXISTING LENGTH



DETECTABLE WARNINGS



SIDEWALK REPLACE	REMOVAL W/TOPSOIL	&	SOD


	Ī
STATE OF ILLINOIS	
STATE OF RECITORS	
DEPARTMENT OF TRANSPORTATION	

ADA RAMP DETAILS	F.A.P. RTE.	SECTION	COUNTY	TOTAL SHEETS	SHEET NO.
W ROOSEVELT RD AT S DES PLAINES AVE	347	2016-084RS	COOK	74	52B
VV HOUSEVEET HD AT 3 DESTEAMVES AVE			CONTRACT	NO. 6	2D64
SHEET OF SHEETS STA. TO STA.		TILLINOIS EED AT	n ppn iect		

DRAWN - RG / MS / AN REVISED PLOT SCALE = 10.0000 '/ in. CHECKED - JH REVISED PLOT DATE = 4/24/2018 DATE - 04/24/2018 REVISED

DESIGNED - RG / MS / AN

DEPARTMENT OF TRANSPORTATION

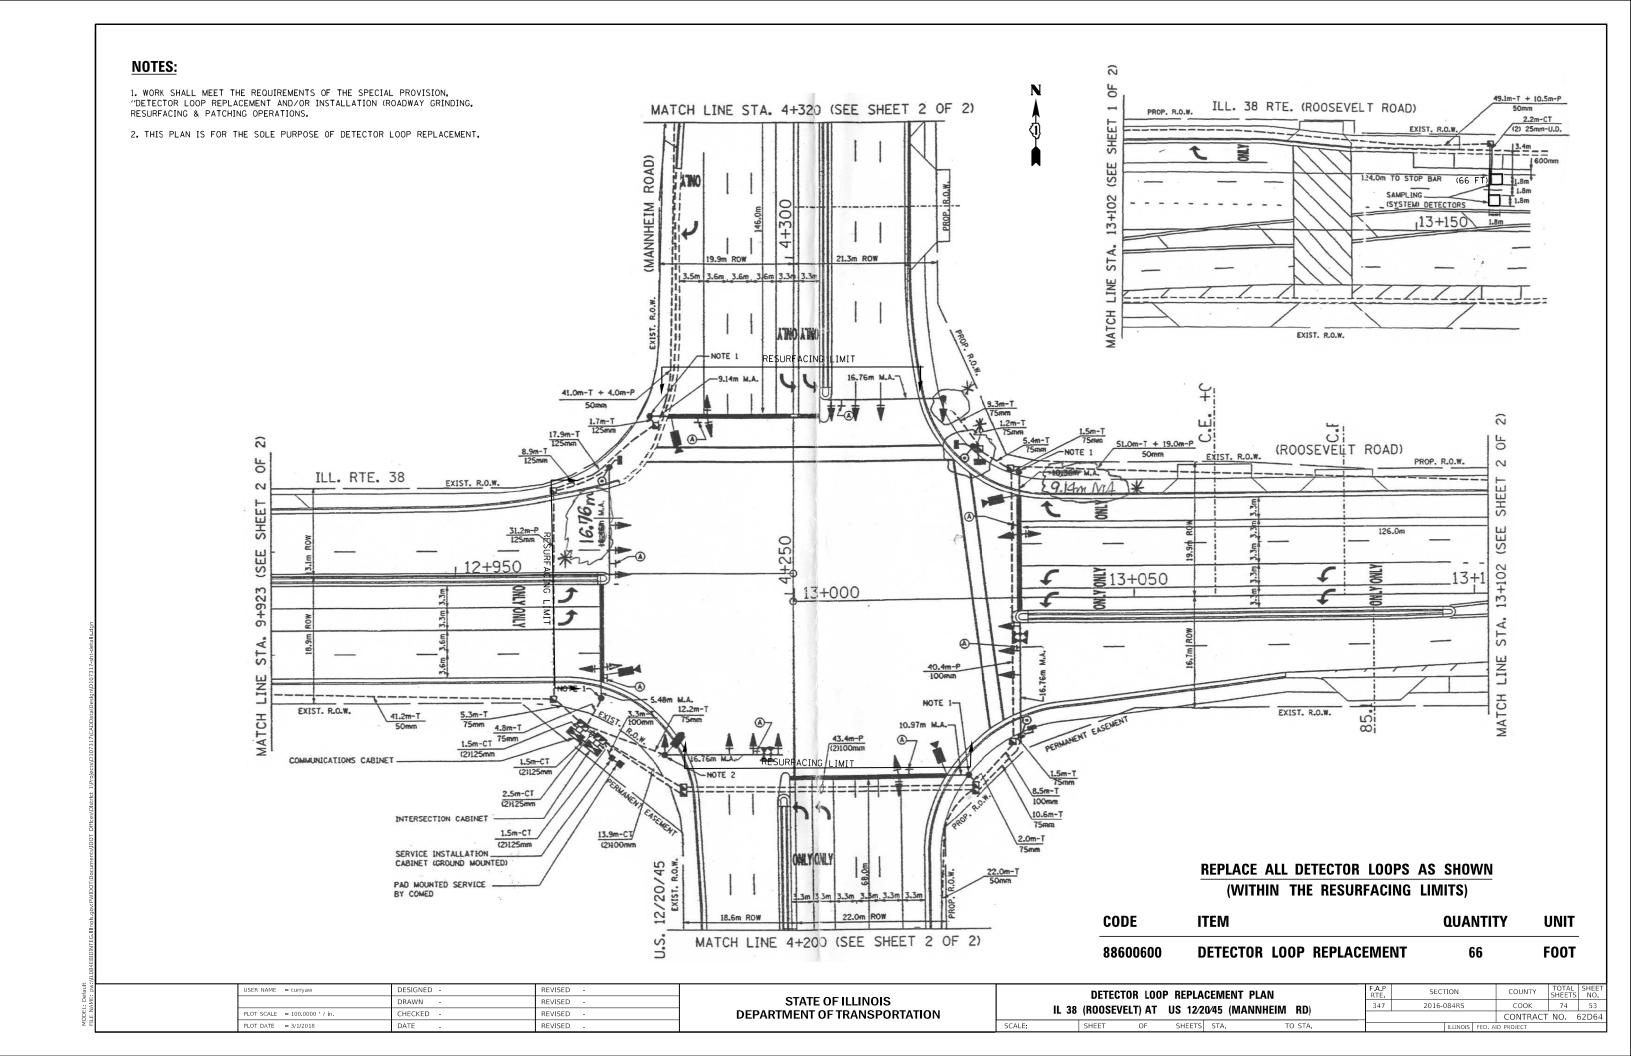

- 1. WORK SHALL MEET THE REQUIREMENTS OF THE SPECIAL PROVISION, "DETECTOR LOOP REPLACEMENT AND/OR INSTALLATION (ROADWAY GRINDING, RESURFACING & PATCHING OPERATIONS,
- 2. THIS PLAN IS FOR THE SOLE PURPOSE OF DETECTOR LOOP REPLACEMENT.

DESIGNED -

CHECKED

DRAWN


LOT SCALE = 100.0000 ' / in.

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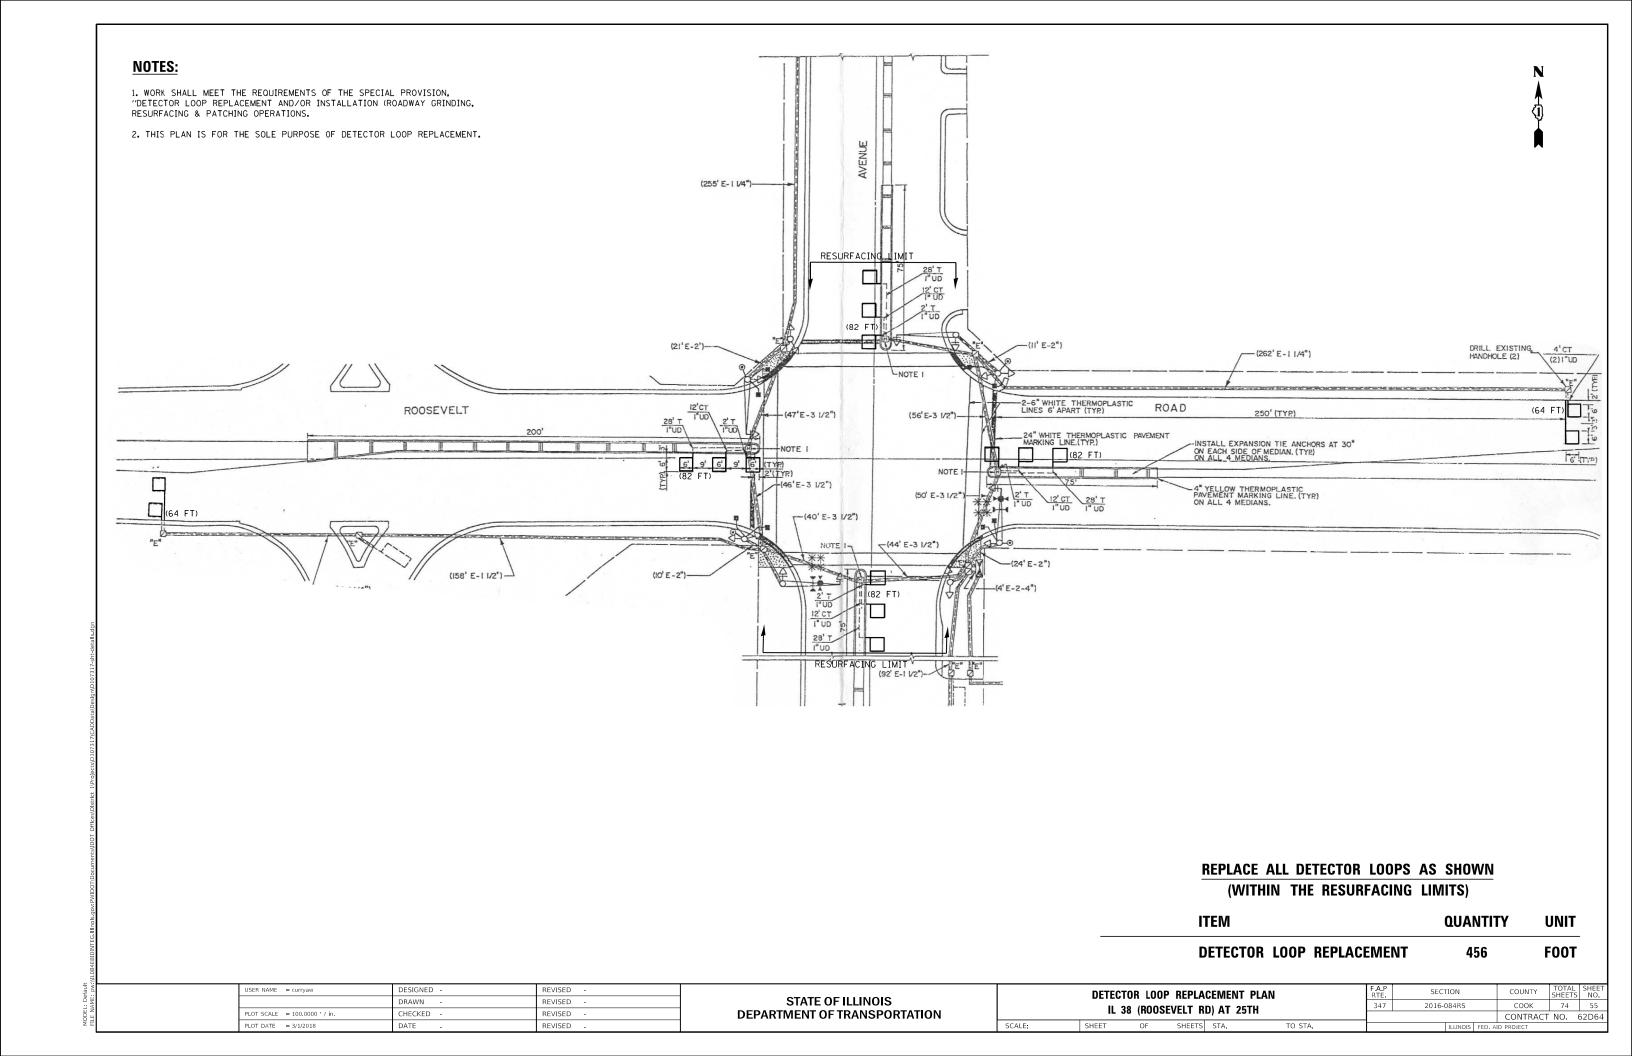
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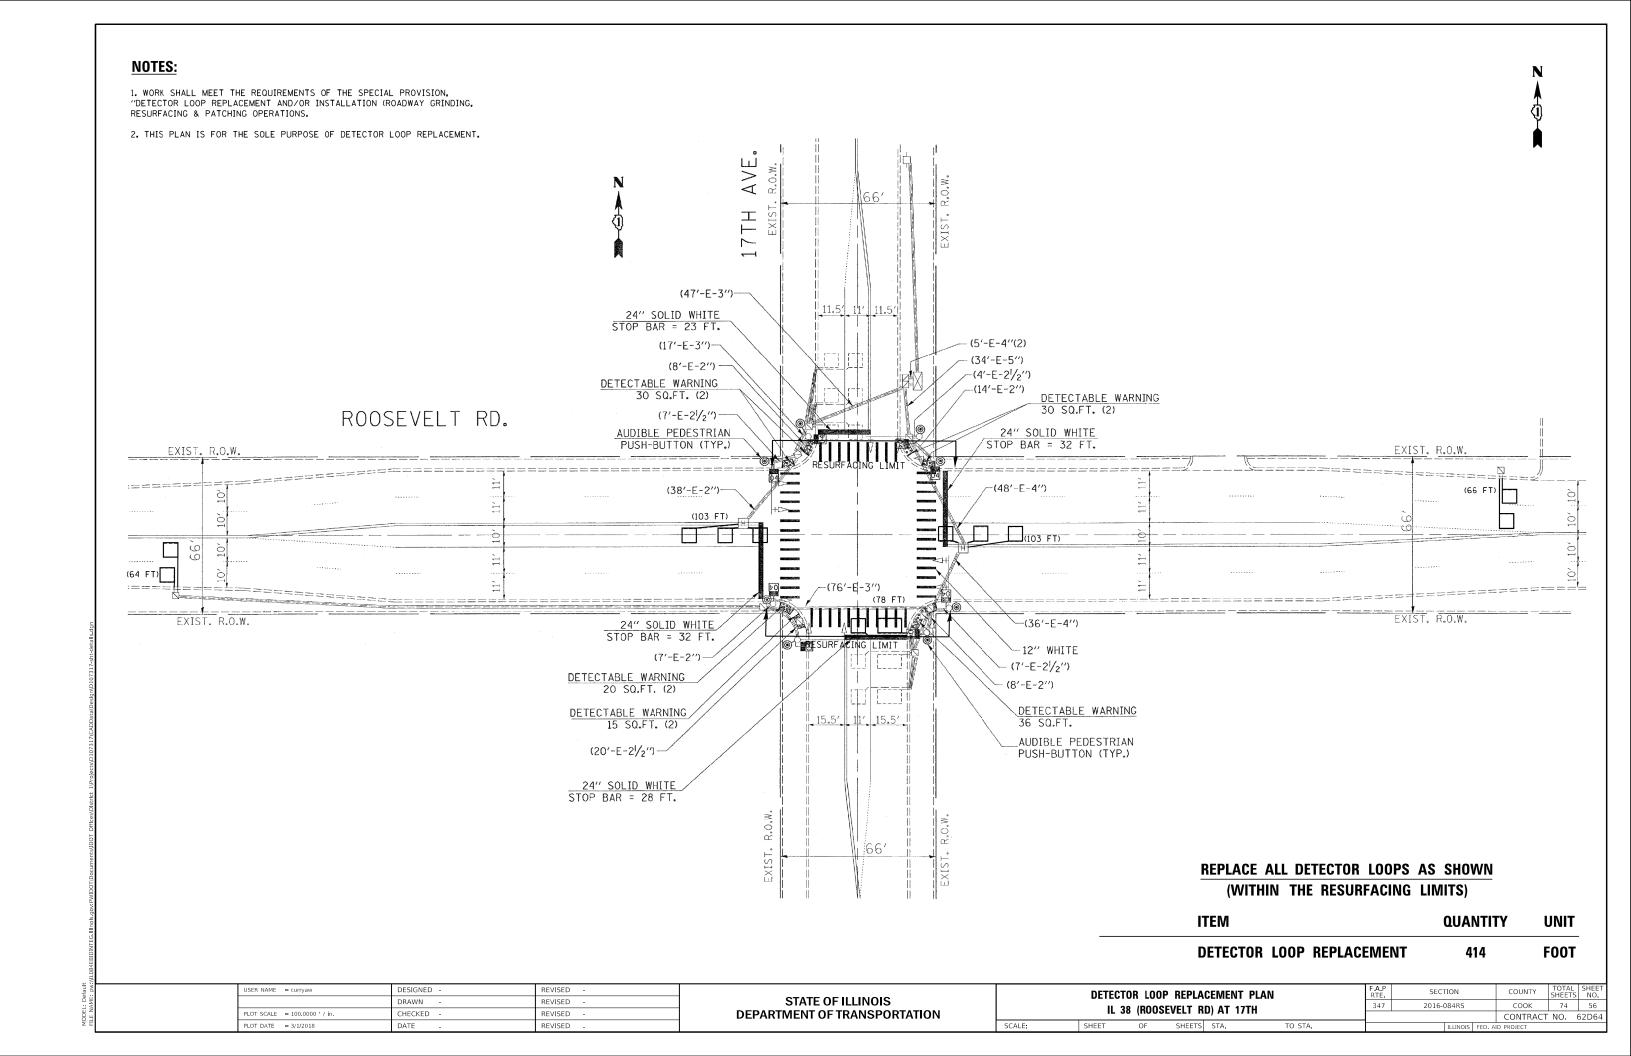
STATE OF ILLINOIS DEPARTMENT OF TRANSPORTATION DETECTOR LOOP REPLACEMENT PLAN
IL 38 (ROOSEVELT RD) AT WESTCHESTER BLVD


DETECTOR LOOP REPLACEMENT


338


FOOT

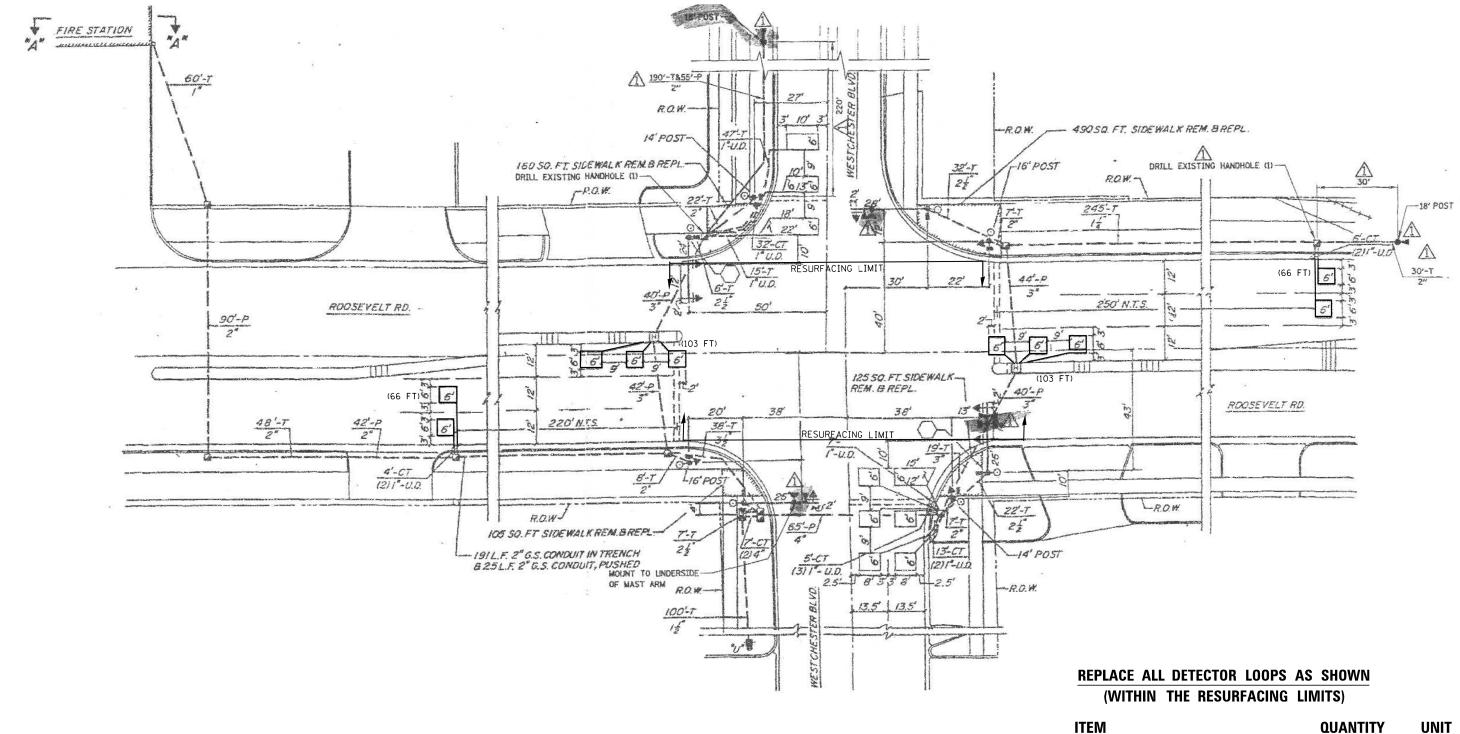





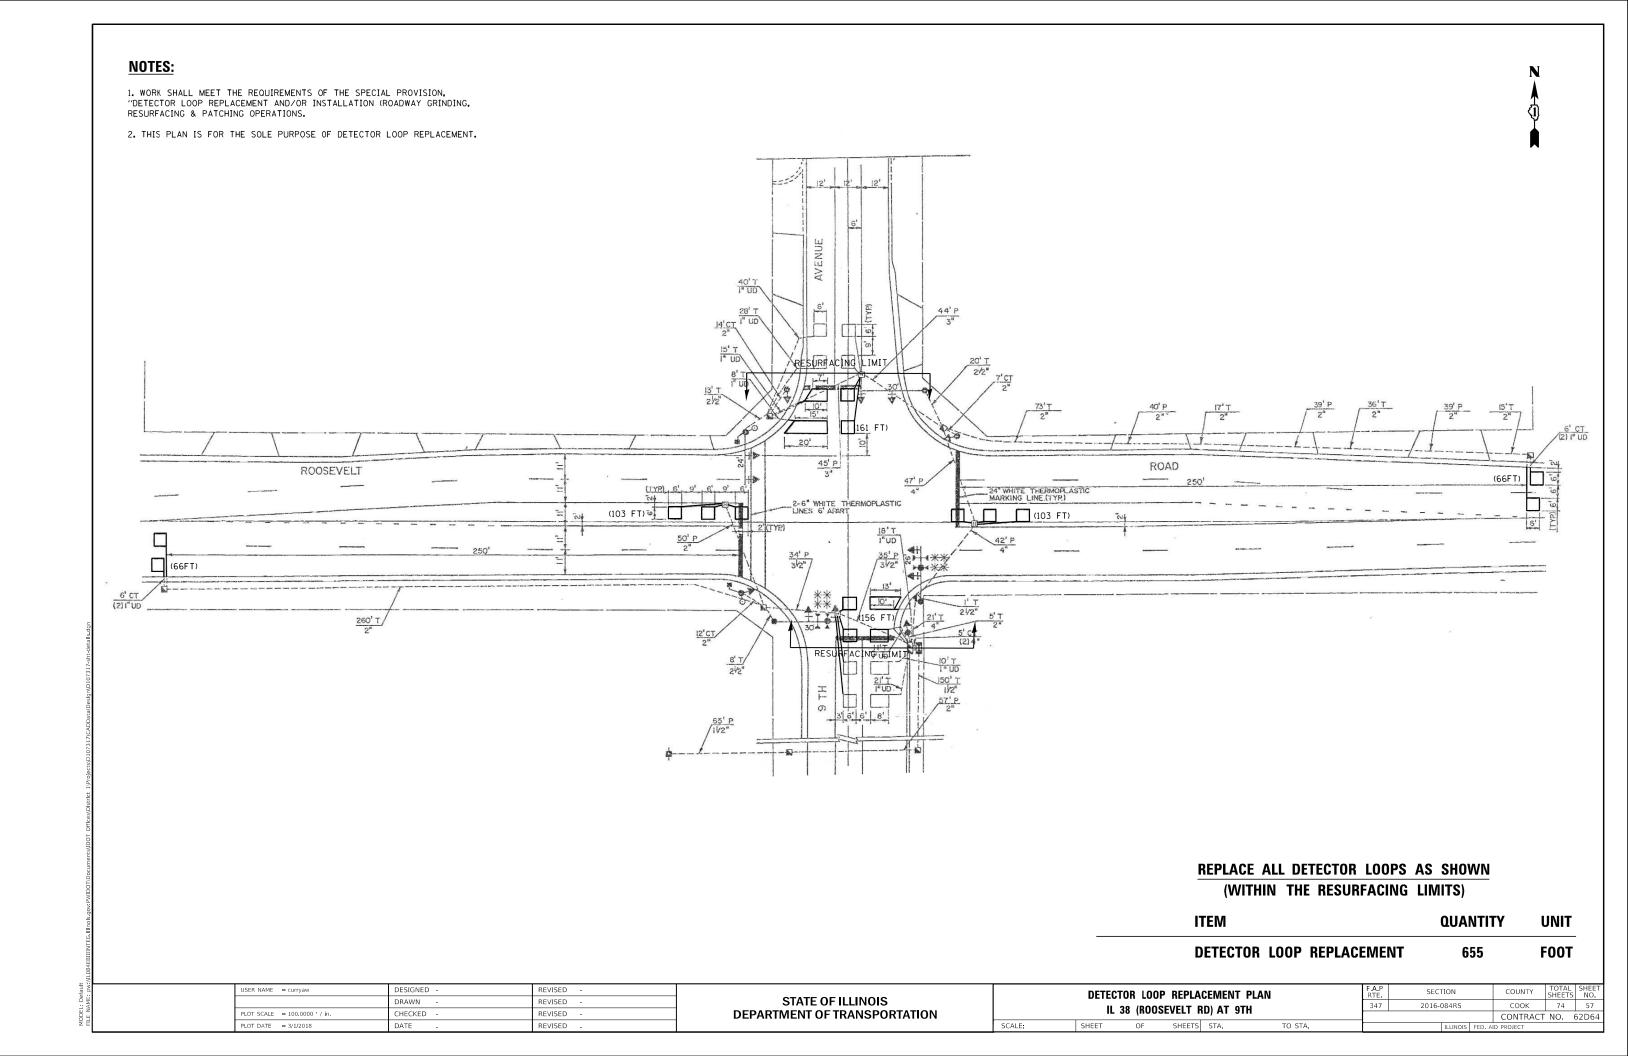

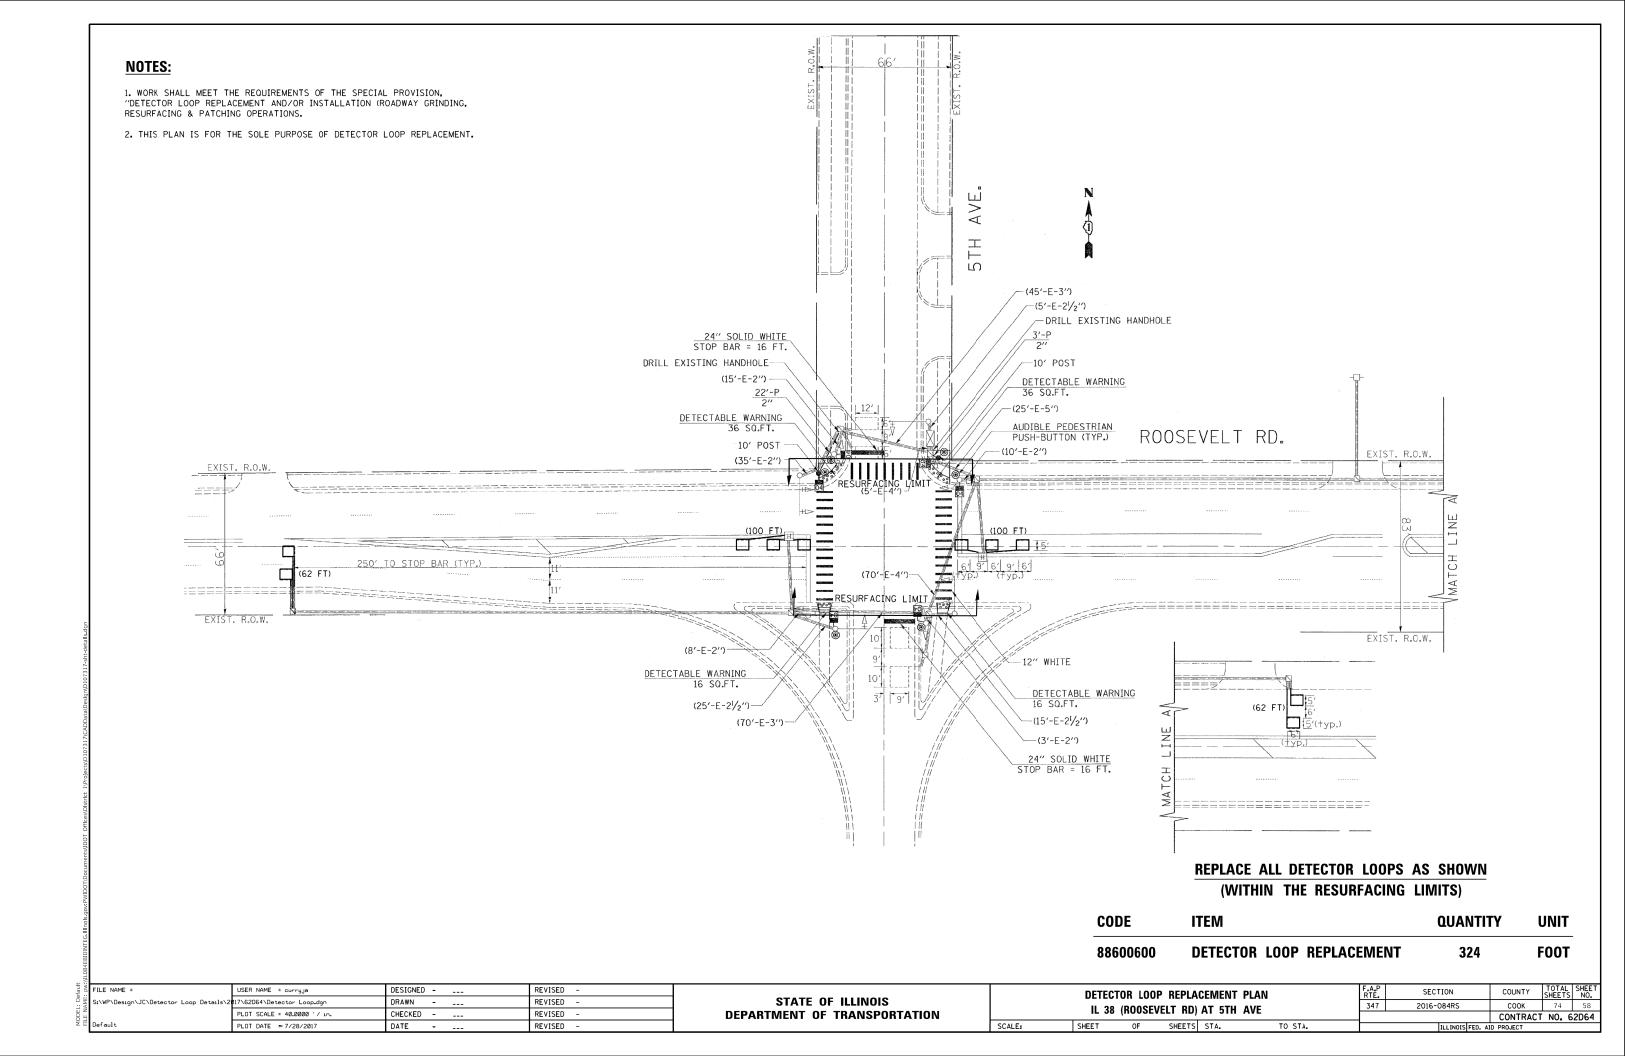

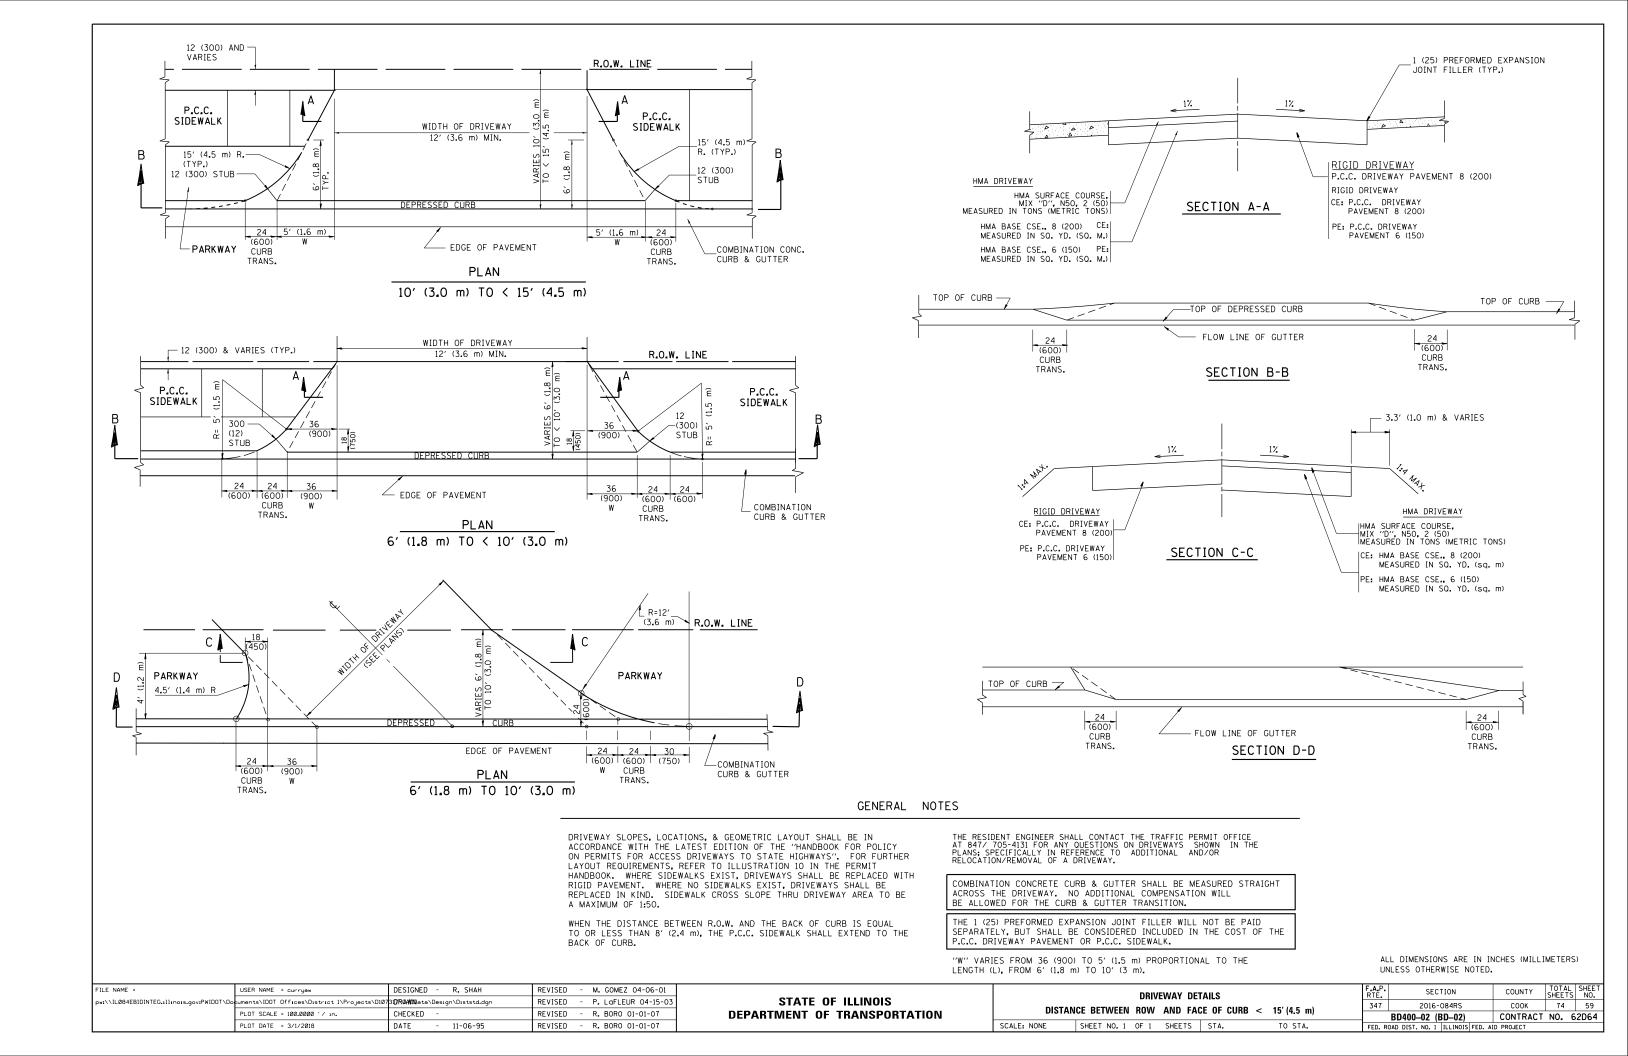

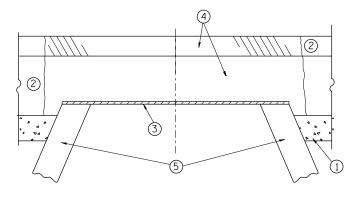

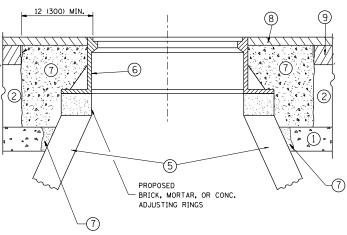

EXISTING BROKEN FRAMES AND LIDS SHALL BE REMOVED AND DISPOSED OF BY THE CONTRACTOR AND SHALL BE REPLACED AS DIRECTED BY THE ENGINEER. REPLACEMENT FRAMES AND LIDS WILL BE PAID FOR IN ACCORDANCE WITH ARTICLE 109,04 OF THE STANDARD SPECIFICATIONS UNLESS A SEPARATE PAY ITEM HAS BEEN PROVIDED.

IF THE EXISTING LIDS ARE OPEN, THE FRAME WILL BE ADJUSTED TO THE ELEVATION OF THE MILLED PAVEMENT SURFACE PRIOR TO THE MILLING OPERATION. THE FRAME WILL NOT BE REMOVED AND COVERED BY THE METAL PLATE.

CITY OF CHICAGO CASTINGS ARE THE PROPERTY OF THE CITY AND THE CONTRACTOR SHALL NOTIFY THE CITY FOR REMOVAL AND DISPOSITION OF THE CASTINGS.

THE METAL PLATE USED TO COVER THE STRUCTURE SHALL REMAIN THE PROPERTY OF THE CONTRACTOR.

WHEN STRUCTURES ARE TO BE ADJUSTED OR RECONSTRUCTED. THE LOWERING AND RAISING OF THE FRAMES AND LIDS WILL NOT BE PAID FOR SEPARATELY BUT WILL BE INCLUDED IN THE COST OF THE CORRESPONDING PAY ITEM.

CONSTRUCTION PROCEDURES

STAGE 1 (BEFORE PAVEMENT MILLING)

- A) REMOVE A MINIMUM OF 12 (300) OF THE PAVEMENT FROM AROUND THE STRUCTURE.
- B) REMOVE THE EXISTING FRAME AND LID FROM THE STRUCTURE.
- C) COVER THE STRUCTURE OPENING WITH A 36 (900) DIAMETER METAL PLATE.

 D) BACKFILL WITH CRUSHED STONE AND A MINIMUM 11/2 (40)
- D) BACKFILL WITH CRUSHED STONE AND A MINIMUM 11/2 (40) THICK HMA SURFACE MIX APPROVED BY THE ENGINEER.

STAGE 2 (AFTER PAVEMENT MILLING)

- A) REMOVE THE HMA SURFACE MIX AND CRUSHED STONE.
- B) INSTALL THE FRAME AND LID; ADJUST THE FRAME TO ITS FINAL SURFACE ELEVATION.
- C) THE SURROUNDING SPACE SHALL BE FILLED WITH CLASS PP-1*
 CONCRETE TO THE ELEVATION OF THE SURFACE OF THE EXISTING
 BASE COURSE OR THE BINDER COURSE.
- * UNLESS OTHERWISE SPECIFIED IN THE PLANS.

THE PROCEDURE EXPLAINED ABOVE SHALL CONFORM TO THE APPLICABLE PORTIONS OF SECTIONS 353, 406, 602, AND 603 OF THE STANDARD SPECIFICATIONS EXCEPT THAT "THE CONTRACTOR SHALL ADJUST THE STRUCTURES TO THE FINISHED PAVEMENT ELEVATION NO MORE THAN 5 CALENDAR DAYS PRIOR TO PLACEMENT OF THE FINAL LIFT OF SURFACE UNLESS APPROVED BY THE ENGINEER."

LEGEND

- 1 SUB-BASE GRANULAR MATERIAL
- (6) FRAME AND LID (SEE NOTES)
- 2 EXISTING PAVEMENT

(5) EXISTING STRUCTURE

- (7) CLASS PP-1* CONCRETE
- 3 36 (900) DIAMETER METAL PLATE
- (8) PROPOSED HMA SURFACE COURSE
- PROPOSED CRUSHED STONE AND HMA SURFACE MIX
- (9) PROPOSED HMA BINDER COURSE

LOCATION OF STRUCTURES:

THE CONTRACTOR WILL BE REQUIRED TO KEEP A RECORD OF THE LOCATIONS OF THE BURIED STRUCTURES ACCORDING TO THE STATION AND DISTANCE LEFT OR RIGHT OF THE CENTERLINE OF PAYEMENT. UPON COMPLETION OF THE WORK, THE CONTRACTOR WILL DELIVER THE RECORD TO THE ENGINEER.

BASIS OF PAYMENT:

REMOVING FRAMES AND LIDS ON DRAINAGE AND UTILITY STRUCTURES IN THE PAVEMENT PRIOR TO MILLING, AND ADJUSTING TO FINAL GRADE PRIOR TO PLACING THE SURFACE COURSE, WILL BE PAID FOR AT THE CONTRACT UNIT PRICE EACH FOR "FRAMES AND LIDS TO BE ADJUSTED (SPECIAL),"

THIS WORK WILL NOT BE PAID FOR WHEN DRAINAGE AND UTILITY STRUCTURES ARE SPECIFIED FOR PAYMENT AS STRUCTURE RECONSTRUCTION.

NEW FRAMES AND LIDS, WHEN SPECIFIED, WILL BE PAID FOR SEPARATELY.


DETAILS FOR FRAMES AND LIDS ADJUSTMENT WITH MILLING

ALL DIMENSIONS ARE IN INCHES (MILLIMETERS) UNLESS OTHERWISE SHOWN

FILE NAME =	USER NAME = curryaw	DESIGNED - R. SHAH	REVISED - R. WIEDEMAN 05-14-04
pw:\\ILØ84EBIDINTEG.:ll:no:s.gov:PWIDOT\Do	cuments\IDOT Offices\District 1\Projects\D107	3 DROMDN ata\Design\Diststd.dgn	REVISED - R. BORO 01-01-07
	PLOT SCALE = 100.0000 '/ in.	CHECKED -	REVISED - R. BORO 03-09-11
	PLOT DATE = 3/1/2018	DATE - 10-25-94	REVISED - R. BORO 12-06-11

STATE OF ILLINOIS
DEPARTMENT OF TRANSPORTATION

DETAILS FOR	F.A.P. RTE.	SECTION	COUNTY	TOTAL SHEETS	SHEET NO.
FRAMES AND LIDS ADJUSTMENT WITH MILLING	347	2016-084RS	соок	74	60
		BD600-03 (BD-8)	CONTRACT	NO.	62D64
SCALE: NONE SHEET NO. 1 OF 1 SHEETS STA. TO STA.	FED. R	OAD DIST, NO. 1 ILLINOIS FED. AL	D PROJECT		

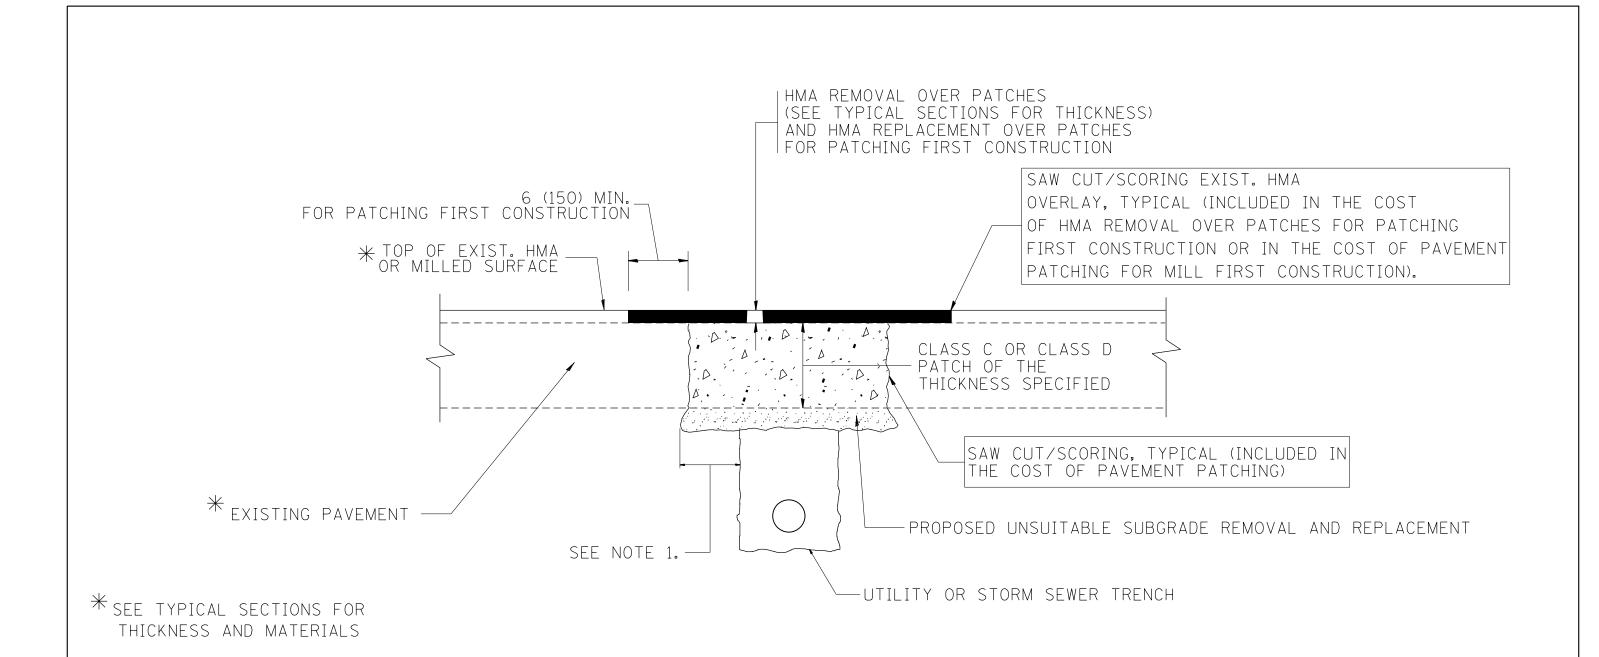

- 1. THE WIDTH OF THE FULL DEPTH PATCH OVER A TRENCH SHALL BE 12 (300) WIDER ON EACH SIDE OF THE TRENCH.
- 2. FOR METHOD OF MEASUREMENT AND BASIS OF PAYMENT, SEE RECURRING SPECIAL PROVISION "PATCHING WITH HOT-MIX ASPHALT OVERLAY REMOVAL".

SEQUENCE OF CONSTRUCTION (PATCHING FIRST)


- 1. REMOVE THE EXISTING HMA MATERIAL OVER THE AREA TO BE PATCHED.
- 2. REMOVE AND REPLACE WITH CLASS C OR D PATCH.
- 3. REPLACE HMA MATERIAL OVER THE AREA TO BE PATCHED.

SEQUENCE OF CONSTRUCTION (MILLING FIRST)

- 1. MILL HMA FIRST IF THERE IS AT LEAST 41/2 INCHES OR MORE OF HMA MATERIAL ON TOP OF THE EXISTING PAVEMENT OR IF THE PAVEMENT IS FULL DEPTH HMA. A MINIMUM OF 2 INCHES OF HMA MATERIAL SHALL BE IN PLACE AFTER MILLING.
- 2. REMOVE AND REPLACE WITH FULL DEPTH CLASS D PATCHES TO TOP OF MILLED SURFACE.

ALL DIMENSIONS ARE IN INCHES (MILLIMETERS) UNLESS OTHERWISE SHOWN.

	FILE NAME =	USER NAME = curryaw	DESIGNED - R. SHAH	REVISED -	A. ABBAS 04-27-98			PAVEMENT PATCHING FOR		F.A.P.	SECTION	COUNTY	TOTAL SI SHEETS	IEET NO.
- 1	pw:\\IL084EBIDINTEG.:ll:nois.gov:PWIDOT\Do	cuments\IDOT Offices\District 1\Projects\D107	31 DR(AWIN) ata\Design\Diststd.dgn	REVISED -	R. BORO 01-01-07	STATE OF ILLINOIS				347	2016-084RS	соок	74	61
		PLOT SCALE = 100.0000 '/ in.	CHECKED -	REVISED -	R. BORO 09-04-07	DEPARTMENT OF TRANSPORTATION		HMA SURFACED PAVEMENT		BD	400-04 (BD-22)	CONTRACT	NO. 62')64
- 1		PLOT DATE = 3/1/2018	DATE - 10-25-94	REVISED -	K. ENG 10-27-08		SCALE: NONE	SHEET NO. 1 OF 1 SHEETS STA.	TO STA.	FED. ROAD I	DIST. NO. 1 ILLINOIS FED. AL	D PROJECT		-

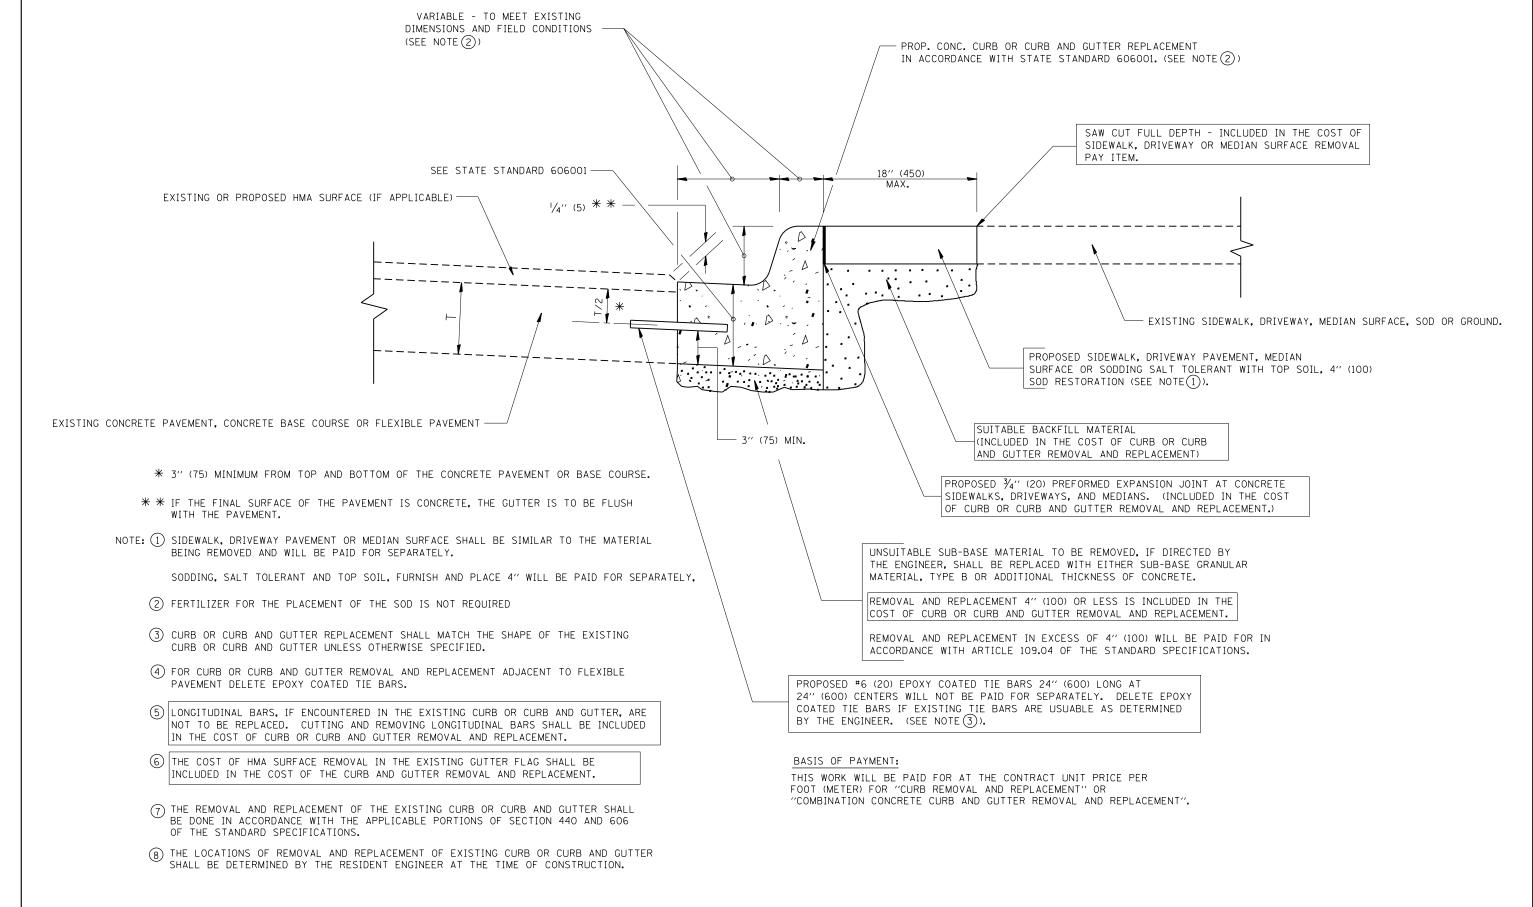

CURB OR CURB AND GUTTER REMOVAL AND REPLACEMENT


ALL DIMENSIONS ARE IN INCHES (MILLIMETERS) UNLESS OTHERWISE SHOWN.

COUNTY


74 62

CONTRACT NO. 62D64


FILE NAME =	USER NAME = curryaw	DESIGNED - A. HOUSEH	REVISED - R. SHAH 10-03-96			CURB OR CURB AND	CUTTER	RTF.	SECTION	
pw:\\ILØ84EBIDINTEG.:111:nois.gov:PWIDOT\Doci	ments\IDOT Offices\District 1\Projects\D107	3 DRØMUN ata\Design\Diststd.dgn	REVISED - A. ABBAS 03-21-97	STATE OF ILLINOIS				347	2016-084RS	-
	PLOT SCALE = 100.0000 '/ in.	CHECKED -	REVISED - M. GOMEZ 01-22-01	DEPARTMENT OF TRANSPORTATION		REMOVAL AND REPLA	CEMENI	BI	D600-06 (BD-24)	\top
	PLOT DATE = 3/1/2018	DATE - 03-11-94	REVISED - R. BORO 12-15-09		SCALE: NONE	SHEET NO. 1 OF 1 SHEETS	STA. TO STA.	FED. ROAD	DIST. NO. 1 ILLINOIS F	ED. AID

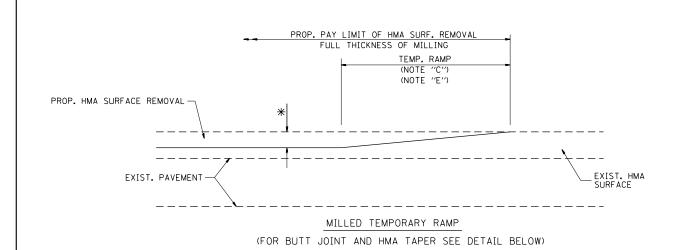

OPTION 1

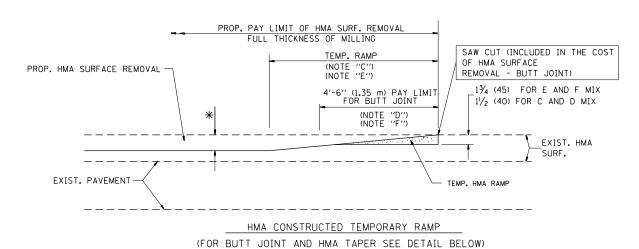

OPTION 2 TYPICAL TEMPORARY RAMP

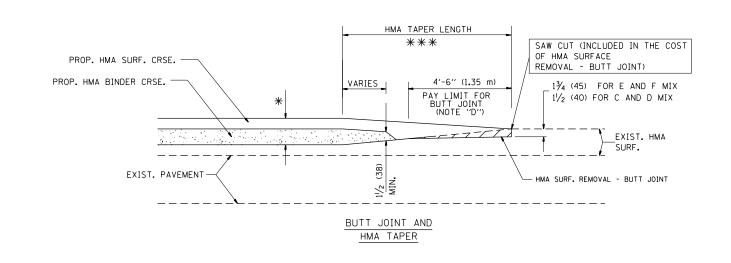

TYPICAL BUTT JOINT AND HMA TAPER FOR MILLING AND RESURFACING

FILE NAME = USER NAME = curryaw DESIGNED - M. DE YONG REVISED - R. SHAH 10-25-94

pwi\\[L084EBIDINTEG.illinois.gov:PWIDOT\Documents\[DOT\] Offices\[District\] 1\Projects\[District\] 3\DRAWDBata\[Design\] District.ddgn REVISED - A. ABBAS 03-21-97


PLOT SCALE = 100.0000 '/ in. CHECKED - REVISED - M. GOMEZ 04-06-01


PLOT DATE = 3/1/2018 DATE - 06-13-90 REVISED - R. BORO 01-01-07

STATE OF ILLINOIS
DEPARTMENT OF TRANSPORTATION

ALL DIMENSIONS ARE IN INCHES (MILLIMETERS) UNLESS

OTHERWISE SHOWN.

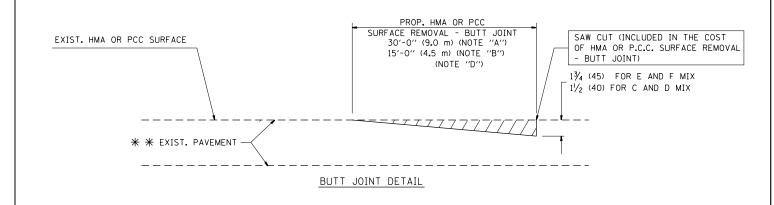

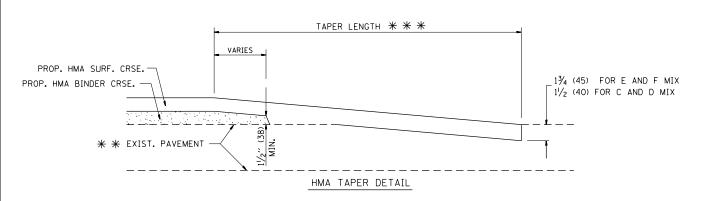

TYPICAL BUTT JOINT AND HMA TAPER FOR RESURFACING ONLY


* * PC CONCRETE, HMA OR HMA RESURFACED PAVEMENT.

NOTES

- A: MAINLINE ROADWAYS AND MAJOR SIDE ROADS.
- MINOR SIDE ROADS.
- C: THE TEMP. RAMP SHALL BE CONSTRUCTED IMMEDIATELY UPON REMOVAL OF THE EXISTING HMA SURFACE.
- D: THE BUTT JOINT SHALL BE CONSTRUCTED IMMEDIATELY PRIOR TO PLACING THE PROPOSED HMA COURSES.
- E: TAPER THE TEMP. RAMP AT A RATE OF 3'-0" (900 mm) PER 1 INCH (25 mm) OF MILLING THICKNESS.
- F: INSTALLATION AND REMOVAL OF THE 4'-6" (1.35 m) TEMP. RAMP IS INCLUDED IN COST OF HMA SURFACE REMOVAL BUTT JOINT
- G: SEE ARTICLE 406.08 AND 406.14 OF THE STANDARD SPECIFICATIONS FOR "HMA AND/OR PCC SURFACE REMOVAL, BUTT JOINT".
- * SEE TYPICAL SECTIONS FOR MILLING THICKNESS.
- ** * 20'-0" (6.1 m) PER 1 (25) RESURFACING (NOTE "A") 10'-0" (3.0 m) PER 1 (25) RESURFACING (NOTE "B")

BASIS OF PAYMENT:

THE BUTT JOINT WILL BE PAID FOR AT THE CONTRACT UNIT PRICE PER SQUARE YARD (SQUARE METER) FOR "HOT-MIX ASPHALT SURFACE REMOVAL - BUTT JOINT" OR FOR "PORTLAND CEMENT CONCRETE SURFACE REMOVAL- BUTT JOINT".

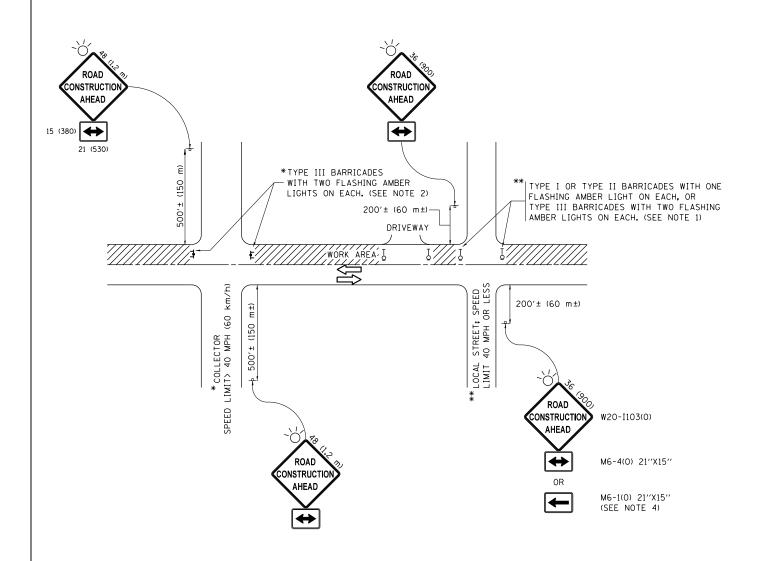

- SIDE ROAD WITH A SPEED LIMIT OF 40 MPH (60 km/h) OR LESS AS SHOWN ON THE DRAWING AND AS DIRECTED BY THE ENGINEER:
 - a) ONE "ROAD CONSTRUCTION AHEAD" SIGN 36 x 36 (900x900) WITH A FLASHER MOUNTED ON IT APPROXIMATELY 200" (60 m) IN ADVANCE OF THE MAIN ROUTE.
 - b) THE CLOSED PORTION OF THE MAIN ROUTE SHALL BE PROTECTED BY BLOCKING WITH TYPE I, TYPE II OR TYPE III BARRICADES, 1/3 OF THE CROSS SECTION OF THE CLOSED PORTION.
- 2. SIDE ROAD WITH A SPEED LIMIT GREATER THAN 40 MPH (60 km/h) AS SHOWN ON THE DRAWING AND AS DIRECTED BY THE ENGINEER:
 - a) ONE "ROAD CONSTRUCTION AHEAD" SIGN 48 \times 48 (1.2 m \times 1.2 m) WITH A FLASHER MOUNTED ON IT APPROXIMATELY 500" (150 m) IN ADVANCE OF THE MAIN ROUTE.
 - b) THE CLOSED PORTION OF THE MAIN ROUTE SHALL BE PROTECTED BY BLOCKING WITH TYPE III BARRICADES, 1/2 OF THE CROSS SECTION OF THE CLOSED PORTION.
- 3. CONES MAY BE SUBSTITUTED FOR BARRICADES OR DRUMS AT HALF THE SPACING DURING DAY OPERATIONS. CONES SHALL BE A MINIMUM OF 28 (710)
 IN HEIGHT
- 4. WHEN THE SIDE ROAD LIES BETWEEN THE BEGINNING OF THE MAINLINE SIGNING AND THE WORK ZONE, A SINGLE HEADED ARROW (M6-1) SHALL BE USED IN LIEU OF THE DOUBLE HEADED ARROW (M6-4).

SCALE: NONE


- 5. WHEN WORK IS BEING PERFORMED ON A SIDE ROAD OR DRIVEWAY, FOLLOW THE APPLICABLE STANDARD(S). THE DIRECTIONAL ARROW (M6-1 OR M6-4) SHALL BE COVERED OR REMOVED WHEN NO LONGER CONSISTENT WITH THE TRAFFIC CONTROL SET-UP.
- 6. ADVANCE WARNING SIGNS ARE TO BE OMITTED ON DRIVEWAYS UNLESS OTHERWISE SPECIFIED IN THE PLANS OR BY THE ENGINFER.
- 7. THE TRAFFIC CONTROL AND PROTECTION FOR SIDE ROADS, INTERSECTIONS, AND DRIVEWAYS SHALL BE INCLUDED IN THE COST OF SPECIFIED TRAFFIC CONTROL STANDARDS OR ITEMS.

All dimensions are in inches (millimeters) unless otherwise shown.

FILE NAME =	USER NAME = curryaw	DESIGNED - L.H.A.	REVISED	- A. HOUSEH 10-15-96
pw:\\ILØ84EBIDINTEG.:ll:no:s.gov:PWIDOT\Do	cuments\IDOT Offices\District 1\Projects\D107	31 DROMON ata\Design\Diststd.dgn	REVISED	-T. RAMMACHER 01-06-00
	PLOT SCALE = 100.0000 '/ in.	CHECKED -	REVISED	- A. SCHUETZE 07-01-13
Default	PLOT DATE = 3/1/2018	DATE - 06-89	REVISED	- A. SCHUETZE 09-15-16


STATE OF ILLINOIS	
DEPARTMENT OF TRANSPORTATION	


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СI	SIDE ROADS, INTERSECTIONS, AND DRIVEWAYS					347	2016-08
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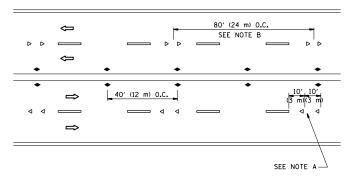
*** REDUCE TO 40' (12 m) O.C. ON CURVES WITH POSTED OR ADVISORY SPEED 45 M.P.H. (70 km/h) OR LESS.

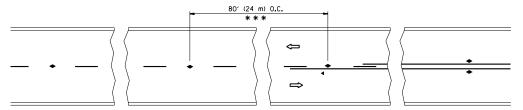TWO-LANE/TWO-WAY




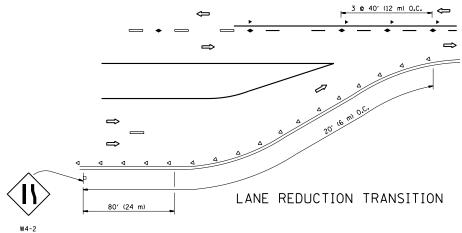

TWO-WAY LEFT TURN

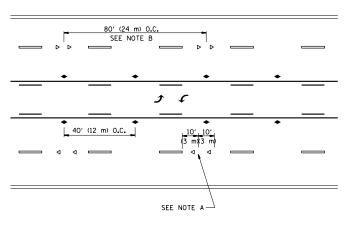

MULTI-LANE/UNDIVIDED

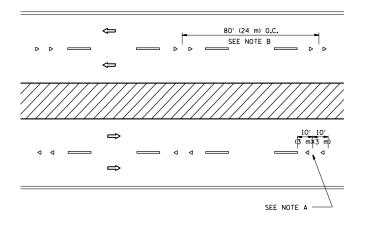

MULTI-LANE/DIVIDED

GENERAL NOTES

- MARKERS USED WITH DASHED LINES SHALL BE CENTERED IN THE GAP BETWEEN SEGMENTS.
- 2. MARKERS USED ADJACENT TO SOLID LINES SHALL BE OFFSET 2 TO 3 (50 TO 75) TOWARD TRAFFIC AS SHOWN.
- 3. MARKERS THROUGH TANGENTS LESS THAN 500' (150 m) IN LENGTH BETWEEN CURVES SHALL BE INSTALLED AT THE LESSER OF THE TWO CURVE SPACINGS.

LANE MARKER NOTES

A. USE DOUBLE LANE LINE MARKERS SPACED AS SHOWN.

B. REDUCE TO 40' (12 m) O.C. ON CURVES WHERE ADVISORY SPEEDS ARE 10 M.P.H (20 km/h) LOWER THAN POSTED SPEEDS.

SYMBOLS

---- YELLOW STRIPE

WHITE STRIPE

- ONE-WAY AMBER MARKER
- ONE-WAY CRYSTAL MARKER (₩/O)
- ◆ TWO-WAY AMBER MARKER


DESIGN NOTES

- 1. DOUBLE LANE LINE MARKERS SHALL BE USED UNLESS SPECIFIED OTHERWISE.
- 2. EXCEPT AS SHOWN ON THE LANE REDUCTION TRANSITION AND FREEWAY EXIT RAMP DETAIL, MARKERS ARE NOT TO BE SPECIFIED ON RIGHT EDGE LINES.
- 3. THE EXACT MARKER LIMITS, SPACING, AND COLOR SHALL BE INCLUDED IN THE PLANS WHEN STANDARD SPECIFICATIONS ARE NOT BEING USED.
- 4. MARKERS SHOULD NOT BE USED ALONGSIDE CURBS EXCEPT FOR EXTREMELY SHORT SECTIONS OF CURBS WHERE NOT MORE THAN TWO MARKERS WOULD BE INVOLVED.


LEFT TURN

All dimensions are in inches (millimeters) unless otherwise shown.

FILE NAME =	USER NAME = curryaw	DESIGNED -	REVISED - T. RAMMACHER 09-19-94		TYPICAL APPLICATIONS	F.A.P. RTE.	SECTION	COUNTY	TOTAL SHEET SHEETS NO.
pw:\\ILØ84EBIDINTEG.:llinois.gov:PWIDOT\Do	cuments\IDOT Offices\District 1\Projects\D107		REVISED -T. RAMMACHER 03-12-99	STATE OF ILLINOIS	RAISED REFLECTIVE PAVEMENT MARKERS (SNOW-PLOW RESISTANT)		2016-084RS	соок	74 65
	PLOT SCALE = 100.0000 '/ in.	CHECKED -	REVISED -T. RAMMACHER 01-06-00	DEPARTMENT OF TRANSPORTATION			TC-11	CONTRACT	T NO. 62D64
	PLOT DATE = 3/1/2018	DATE -	REVISED - C. JUCIUS 09-09-09		SCALE: NONE SHEET NO. 1 OF 1 SHEETS STA. TO STA.	FED. ROAD D	IST. NO. 1 ILLINOIS F	ED. AID PROJECT	

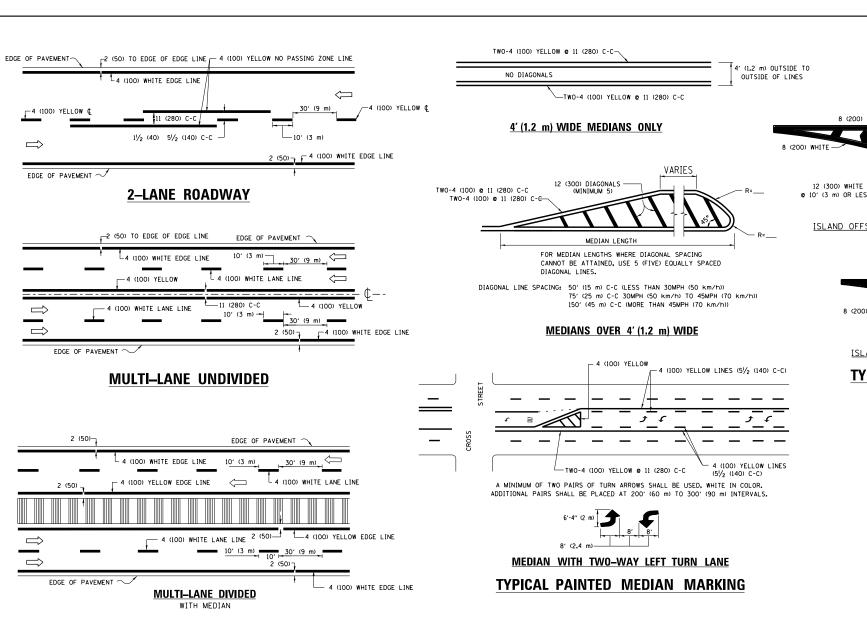

TYPICAL LANE AND EDGE LINE MARKING

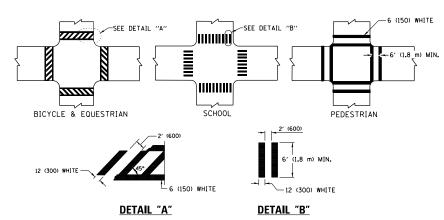

TYPICAL CROSSWALK MARKING


* MARKINGS SHALL BE INSTALLED PARALLEL TO THE CENTERLINE OF THE ROAD WHICH IT CROSSES

FULL SIZE LETTERS 8' (2.4 m) AND ARROWS SHALL BE USED. \P AREA = 15.6 SO. FT. (1.5 m²))


* TURN LANES IN EXCESS OF 400' (120 m) IN LENGTH MAY HAVE AN ADDITIONAL SET OF ARROW - "ONLY" INSTALLED MIDWAY BETWEEN THE OTHER TWO SETS OF ARROW - "ONLY".

TYPICAL LEFT (OR RIGHT) TURN LANE


TYPICAL TURN LANE MARKING

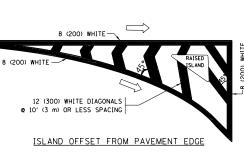




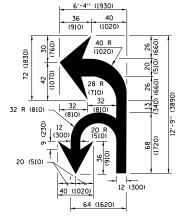

COMBINATION LEFT AND U-TURN

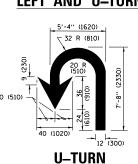

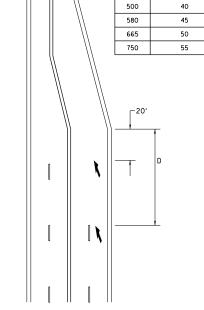

D(FT)

345

425

SPEED LIMIT

LANE REDUCTION TRANSITION

* LANE REDUCTION ARROWS REQUIRED AT SPEEDS OF 45 MPH OR GREATER OR WHEN SPECIFIED IN PLANS.

TYPE OF MARVING	WIDTH OF LINE	PATTERN	COLOR	CDACING /DEMADI/C
TYPE OF MARKING				SPACING /REMARKS
CENTERLINE ON 2 LANE PAVEMENT	4 (100)	SKIP-DASH	YELLOW	10' (3 m) LINE WITH 30' (9 m) SPACE
CENTERLINE ON MULTI-LANE UNDIVIDED PAVEMENT	2 @ 4 (100)	SOLID	YELLOW	11 (280) C-C
NO PASSING ZONE LINES: FOR ONE DIRECTION FOR BOTH DIRECTIONS	4 (100) 2 @ 4 (100)	SOLID SOLID	YELLOW YELLOW	5½ (140) C-C FROM SKIP-DASH CENTERLINE 11 (280) C-C OMIT SKIP-DASH CENTERLINE BETWEEN
LANE LINES	4 (100) 5 (125) ON FREEWAYS	SKIP-DASH SKIP-DASH	WHITE WHITE	10' (3 m) LINE WITH 30' (9 m) SPACE
DOTTED LINES (EXTENSIONS OF CENTER, LANE OR TURN LANE MARKINGS)	SAME AS LINE BEING EXTENDED	SKIP-DASH	SAME AS LINE BEING EXTENDED	2' (600) LINE WITH 6' (1.8 m) SPACE
EDGE LINES	4 (100)	SOLID	YELLOW-LEFT WHITE-RIGHT	OUTLINE MEDIANS IN YELLOW
TURN LANE MARKINGS	6 (150) LINE; FULL SIZE LETTERS & SYMBOLS (8' (2.4m))	SOLID	WHITE	SEE TYPICAL TURN LANE MARKING DETAIL
TWO WAY LEFT TURN MARKING	2 @ 4 (100) EACH DIRECTION 8' (2.4m) LEFT ARROW	SKIP-DASH AND SOLID IN PAIRS	WHITE	10' (3 m) LINE WITH 30' (9 m) SPACE FOR SKIP-DASH; 5½ (140) C-C BETWEEN SOLID LINE AND SKIP-DASH LINE SEE TYPICAL TWO-WAY LEFT TURN MARKING DETAIL
CROSSWALK LINES (PEDESTRIAN) A. DIAGONALS (BIKE & EOUESTRIAN) B. LONGITUDINAL BARS (SCHOOL)	2 @ 6 (150) 12 (300) @ 45° 12 (300) @ 90°	SOLID SOLID SOLID	WHITE WHITE WHITE	NOT LESS THAN 6' (1.8 m) APART 2' (600) APART 2' (600) APART 5EE TYPICAL CROSSWALK MARKING DETAILS.
STOP LINES	24 (600)	SOLID	WHITE	PLACE 4' (1.2 m) IN ADVANCE OF AND PARALLEL TO CROSSWALK, IF PRESENT. OTHERWISE, PLACE AT DESIRED STOPPING POINT. PARALLEL TO CROSSROAD CENTERLINE, WHERE POSSIBLE
PAINTED MEDIANS	2 @ 4 (100) WITH 12 (300) DIAGONALS @ 45° NO DIAGONALS USED FOR 4' (1.2 m) WIDE MEDIANS	SOLID	YELLOW: TWO WAY TRAFFIC WHITE: ONE WAY TRAFFIC	11 (280) C-C FOR THE DOUBLE LINE SEE TYPICAL PAINTED MEDIAN MARKING.
GORE MARKING AND CHANNELIZING LINES	8 (200) WITH 12 (300) DIAGONALS @ 45°	SOLID	WHITE	DIAGONALS: 15' (4.5 m) C-C (LESS THAN 30MPH (50 km/h)) 20' (6 m) C-C 30MPH (50 km/h) T0 45MPH (70 km/h)) 30' (9 m) C-C (OVER 45MPH (70 km/h))
RAILROAD CROSSING	24 (600) TRANSVERSE LINES; "RR" IS 6' (1.8 m) LETTERS; 16 (400) LINE FOR "X"	SOLID	WHITE	SEE STATE STANDARD 780001 AREA OF: "R"=3.6 SO. FT. (0.33 m²) EACH "X"=54.0 SO. FT. (5.0 m²)
SHOULDER DIAGONALS (REOUIRED FOR SHOULDERS > 8')	12 (300) © 45°	SOLID	WHITE - RIGHT YELLOW - LEFT	50' (15 m) C-C (LESS THAN 30MPH (50 km/h)) 75' (25 m) C-C (30 MPH (50 km/h) TO 45MPH (70 km/h 150' (45 m) C-C (0VER 45MPH (70 km/h))
U TURN ARROW	SEE DETAIL	SOLID	WHITE	16.3 SF
2 ARROW COMBINATION LEFT AND U TURN	SEE DETAIL	SOLID	WHITE	30.4 SF

FOR FURTHER DETAILS ON PAVEMENT MARKING REFER TO STANDARD SPECIFICATIONS FOR ROAD AND BRIDGE CONSTRUCTION AND STATE STANDARD 780001.

All dimensions are in inches (millimeters) unless otherwise shown.

FILE NAME = DESIGNED - EVERS REVISED - C. JUCIUS 09-09-09 USER NAME = curryaw ow:\\ILØ84EBIDINTEG.:ll:no: ments\IDOT Offices\District 1\Projects\D107317RANDNata\Design\Diststd.dor REVISED -C. JUCIUS 07-01-13 CHECKED REVISED -C. JUCIUS 12-21-15 PLOT DATE = 3/1/2018 DATE 03-19-90 REVISED -C. JUCIUS 04-12-16

STATE OF ILLINOIS
DEPARTMENT OF TRANSPORTATION

	DISTRICT ONE	F.A.P. RTE.	SECTION	COUNTY	TOTAL SHEETS	SHEET NO.
ı	TYPICAL PAVEMENT MARKINGS	347	2016-084RS	соок	74	66
ı			TC-13	CONTRACT	NO.	62D64
	SCALE: NONE SHEET 1 OF 1 SHEETS STA. TO STA.		ILLINOIS FED. AI	ID PROJECT		

TURN BAY ENTRANCE AT START OF LANE CLOSURE TAPER

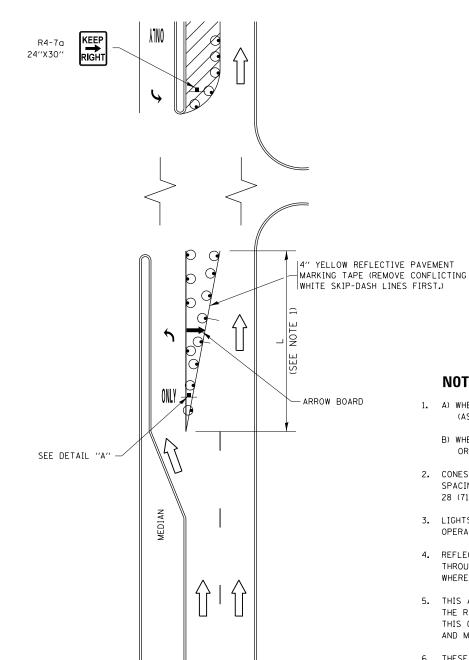



FIGURE 1

LEGEND WORK AREA LANE OPEN TO TRAFFIC ARROW BOARD TYPE I OR II BARRICADE OR DRUM WITH STEADY BURN LIGHT DRUM WITH STEADY BURN LIGHT SIGN ASSEMBLY TYPE I OR II CHECK BARRICADE WITH FLASHING LIGHT

NOTES:

- 1. A) WHEN "L" IS < THE STORAGE LENGTH OF THE TURN LANE (AS SHOWN IN FIG. 1), USE FIGURE 1.
 - B) WHEN "L" IS > THE STORAGE LENGTH OF THE TURN LANE OR THE TURN LANE IS WITHIN THE LANE CLOSURE, USE FIGURE 2.
- 2. CONES MAY BE SUBSTITUTED FOR BARRICADES OR DRUMS AT HALF THE SPACING DURING DAY OPERATIONS. CONES SHALL BE A MINIMUM OF 28 (710) IN HEIGHT.
- 3. LIGHTS WILL NOT BE REQUIRED ON BARRICADES OR DRUMS FOR DAY OPERATIONS. ALL LIGHTS SHALL BE MONODIRECTIONAL.
- 4. REFLECTIVE TEMPORARY PAVEMENT MARKINGS SHALL BE PLACED THROUGHOUT THE BARRICADED AREAS OF EACH TURN BAY AS SHOWN WHERE THE CLOSURE TIME IS GREATER THAN FOURTEEN (14) DAYS.
- 5. THIS APPLICATION ALSO APPLIES WHEN WORK IS BEING PERFORMED IN THE RIGHT LANE(S) AND THE RIGHT TURN BAY IS TO REMAIN OPEN. UNDER THIS CONDITION, "RIGHT TURN LANE" R3-I100R 24 x 24 (600 x 600) AND M6-2R 21 x 15 (530 x 380) SHALL BE USED.
- 6. THESE CONTROLS SHALL SUPPLEMENT MAINLINE TRAFFIC CONTROL FOR LANE CLOSURES.
- 7. THE SIGNS SHALL BE MOUNTED ABOVE THE BARRICADES/DRUMS ON SEPARATE SIGN SUPPORTS THAT MEET NCHRP 350 OR MASH PREQUIREMENTS.
- 8. TRAFFIC CONTROL AND PROTECTION AT TURN BAYS (TO REMAIN OPEN TO TRAFFIC) SHALL BE INCLUDED IN THE COST OF SPECIFIED TRAFFIC CONTROL STANDARDS OR ITEMS.

TURN BAY ENTRANCE WITHIN A LANE CLOSURE

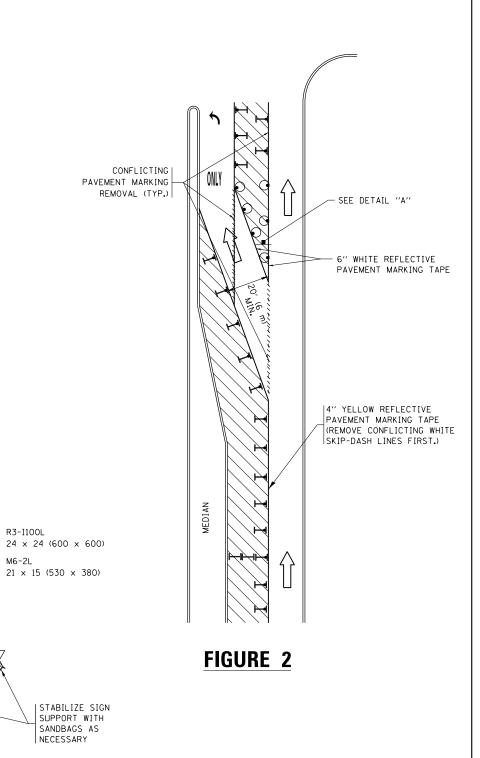

DETAIL A

TURN

All dimensions are in inches (millimeters) unless otherwise shown.

COUNTY


COOK 74 67 CONTRACT NO. 62D64

FILE NAME -	USER NAME - CUrryaw	REVISED - 1. RAMMACHER 09-08-94	KEVISED - K. BUKU US-14-US		TD
pw:\\ILØ84EBIDINTEG.:ll:nois.gov:PWIDOT\Do	cuments\IDOT Offices\District 1\Projects\D107	3 REV48E 0:a\Design\ Q ;s HOUSGH 11-07-95	REVISED - A. SCHUETZE 07-01-13	STATE OF ILLINOIS	""
	PLOT SCALE = 100.0000 '/ in.	REVISED - A. HOUSEH 10-12-96	REVISED - A. SCHUETZE 09-15-16	DEPARTMENT OF TRANSPORTATION	
Default	PLOT DATE = 3/1/2018	REVISED -T. RAMMACHER 01-06-00	REVISED -		SCALE: NONE

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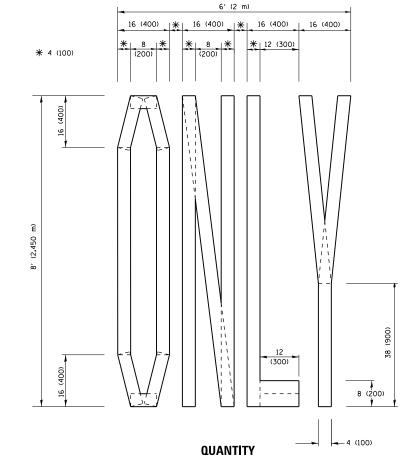
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TRAFF	IC CONTI	ROL AND	PROTEC	TION AT	TURN BAYS	F.A.P. RTE.	SECT	TION		COUNTY
	(TO REMAIN OPEN TO TRAFFIC)						2016-0	084RS		COOK
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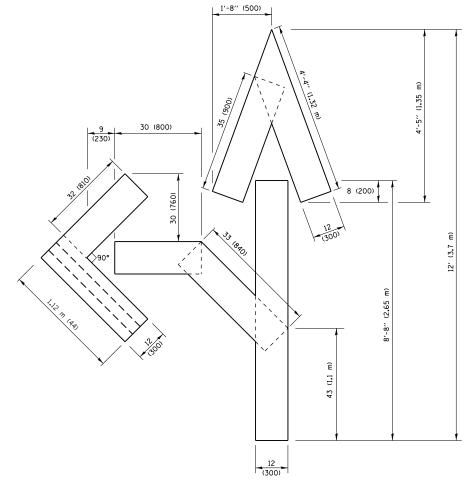


QUANTITY

4 (100) LINE = 45.5 ft. (13.9 m) 15.2 sq. ft. (1.41 sq. m)

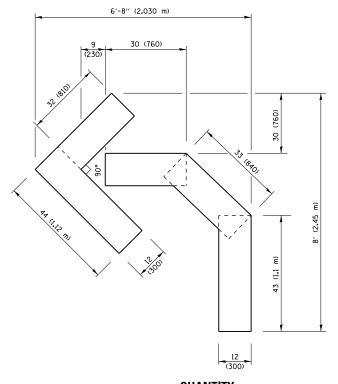

4 (100) LINE = 64.1 ft. (19.5 m) 21.4 sq. ft. (1.99 sq. m)




QUANTITY

4 (100) LINE = 82.5 ft. (25.1 m) 27.5 sq. ft. (2.53 sq. m)

NOTE:

ALL QUANTITIES OF PLACEMENT ARE REPRESENTED IN LINEAR FEET OF 4" LINES TO MATCH THE 4" TEMPORARY TAPE PAY ITEM AND REPRESENTS THE TOTAL QUANTITY OF 4" TAPE REQUIRED.

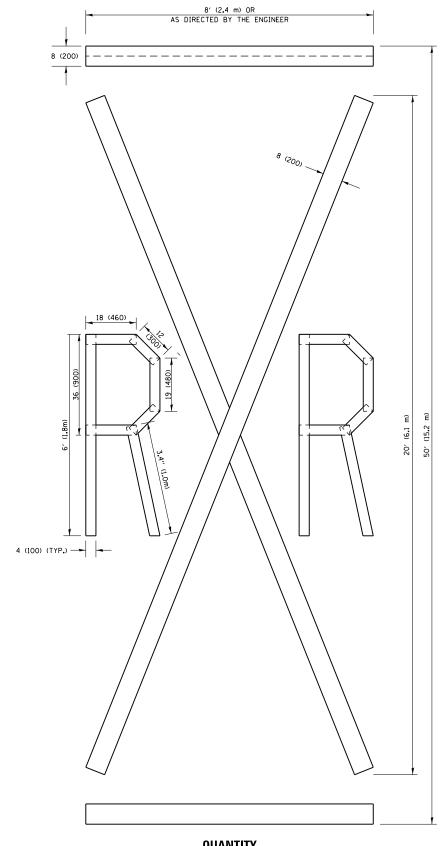


QUANTITY

4 (100) LINE = 225.9 ft. (68.9 m) 75.3 sq. ft. (6.99 sq. m)

> All dimensions are in inches (millimeters) unless otherwise shown.


FILE NAME =	USER NAME = curryaw	DESIGNED -	REVISED -T. RAMMACHER 03-02-9			F.A.P.	SECTION	COUNTY	TOTAL SHEET
pw:\\IL084EBIDINTEG.:111:no:s.gov:PWIDOT\Do	cuments\IDOT Offices\District 1\Projects\D10		REVISED -E. GOMEZ 08-28-00	STATE OF ILLINOIS	SHORT TERM PAVEMENT MARKING LETTERS AND SYMBOLS	347	2016-084RS	соок	74 68
	PLOT SCALE = 100.0010 '/ in.	CHECKED -	REVISED - E. GOMEZ 08-28-00	DEPARTMENT OF TRANSPORTATION			TC-16	CONTRACT	NO. 62D64
	PLOT DATE = 3/1/2018	DATE - 09-18-94	REVISED - A. SCHUETZE 09-15-16		SCALE: NONE SHEET NO. 1 OF 1 SHEETS STA. TO STA.	FED. ROA	AD DIST. NO. 1 ILLINOIS FED. A		

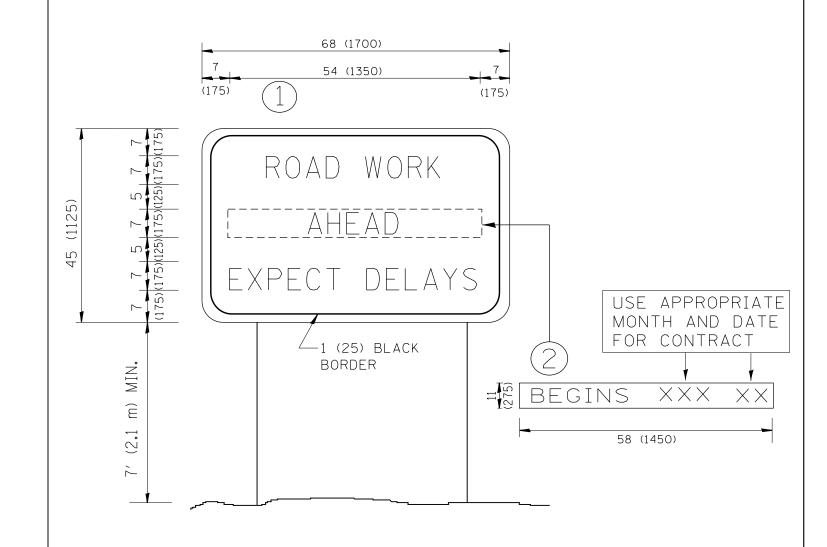


- 1. USE BLACK LETTERING ON ORANGE BACKGROUND.
- 2. ERECT SIGNS IN ADVANCE OF THE LOCATION FOR THE "ROAD CONSTRUCTION AHEAD" SIGN AT LOCATIONS AS DIRECTED BY THE ENGINEER.
- 3. ERECT SIGN (1) WITH INSTALLED PANEL (2) ONE WEEK PRIOR TO THE START OF CONSTRUCTION.
- 4. REMOVE PANEL (2) SOON AFTER THE START OF CONSTRUCTION.
- 5. SEE SPECIAL PROVISION FOR "TEMPORARY INFORMATION SIGNING" FOR ADDITIONAL INFORMATION.
- 6. ONE SIGN ASSEMBLY EQUALS 25.70 SQ. FT. (2.3 SQ. M.)
- 7. SHALL BE PAID FOR AS TEMPORARY INFORMATION SIGNING.

ALL DIMENSIONS ARE IN INCHES (MILLIMETERS) UNLESS OTHERWISE SHOWN.

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I'	PLOT SCALE = 100.0000 '/ 10.	CHECKED -	REVISED -	-T. RAMMACHER 02-02-99	DEPARTMENT OF TRANSPORTATION		INFORMATION SIGN		347	7016-084RS TC-22	CONTRACT	NO. 6	03
	PLOT DATE = 3/1/2018	DATE -	REVISED -	- C. JUCIUS 01-31-07		SCALE: NONE	SHEET NO. 1 OF 1 SHEETS STA.	TO STA.	FED. ROAD	D DIST. NO. 1 ILLINOIS FED. A			

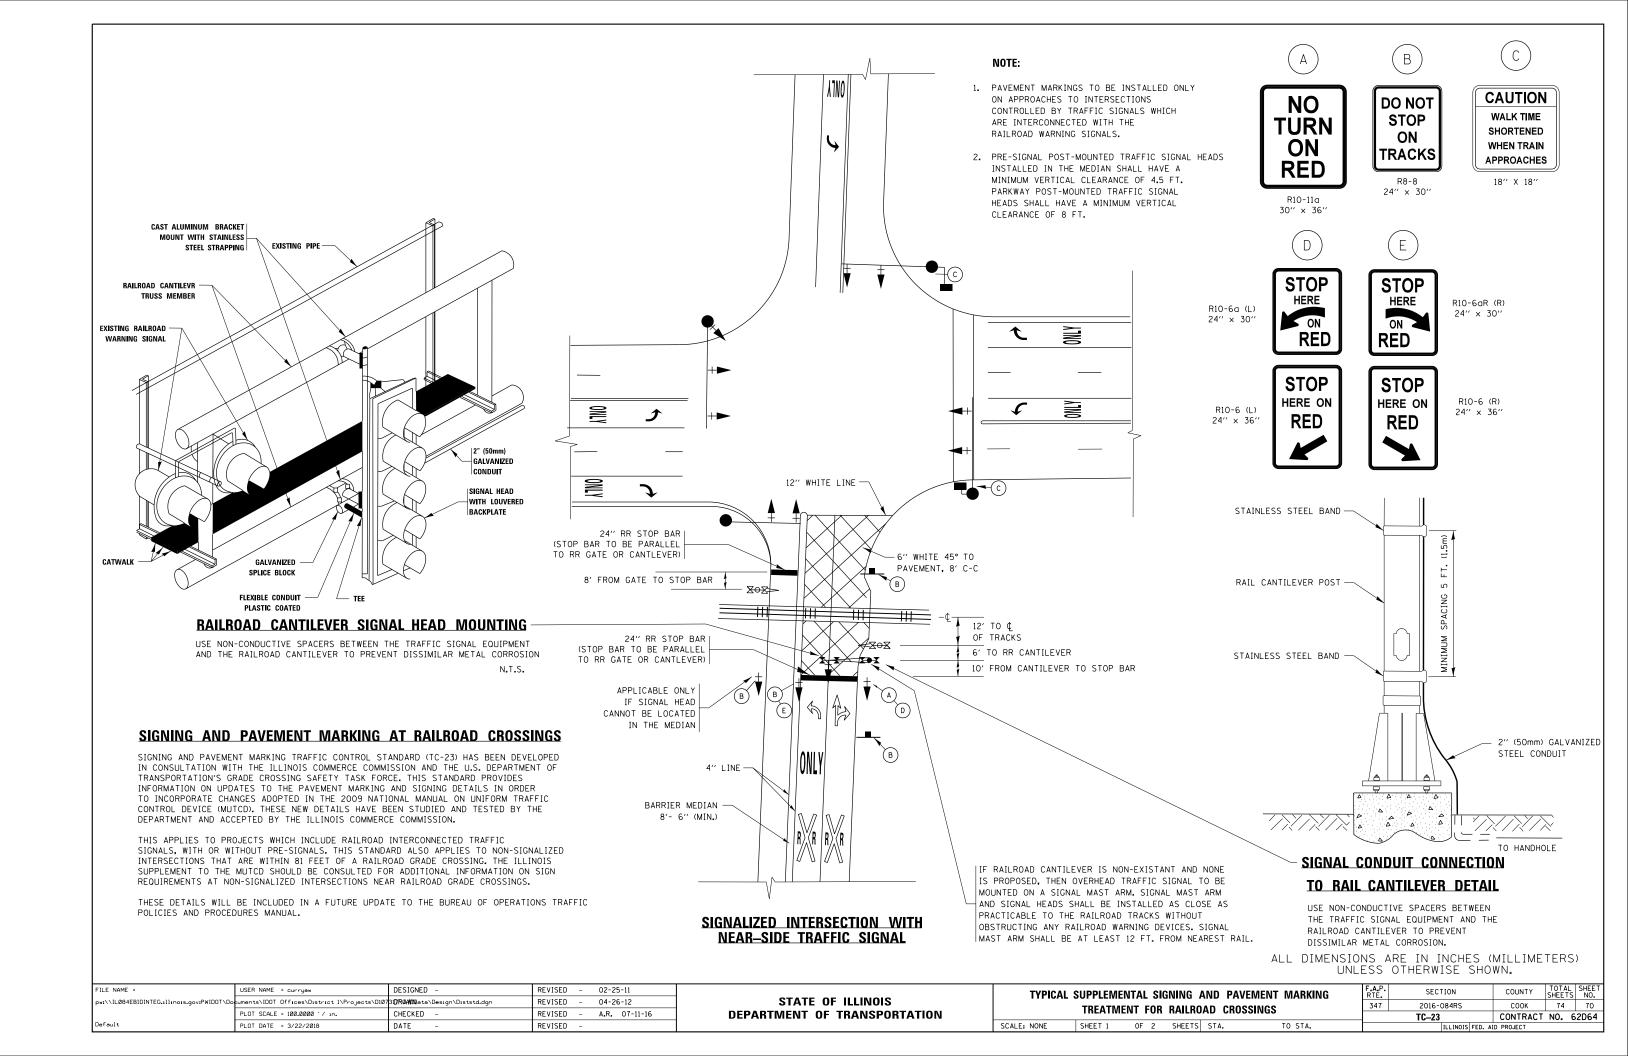

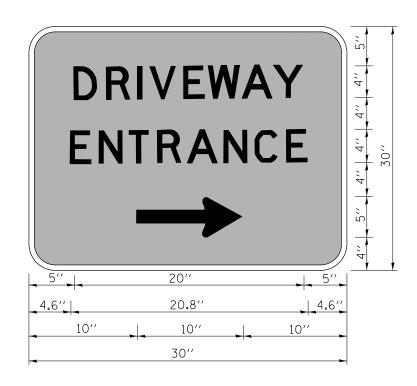

3.0" RADIUS, 0.5" BORDER, WHITE ON GREEN; REFLECTORIZED "ORIVEWAY" D; "ENTRANCE" D; STANDARD ARROW CUSTOM 12.0" x 5.0"

NOTES:

- 1. HALF OF THE SIGNS WILL REQUIRE A LEFT HAND FACING ARROW.
- 2. TWO SIGNS SHALL BE USED AT EACH COMMERCIAL ENTRANCE PLACED BACK-TO-BACK: ONE WITH A RIGHT HAND ARROW (SHOWN) SHALL BE PLACED ON THE NEAR RIGHT SIDE THE DRIVEWAY AND ONE WITH A LEFT HAND ARROW SHALL BE PLACED ON THE FAR LEFT SIDE OF THE DRIVEWAY.
- 3. SIGNS TO BE PAID FOR AS ITEM "TEMPORARY INFORMATION SIGNING".

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	PLOT DATE = 3/1/2018	DATE -	REVISED	-	

STATE	OF	ILLINOIS	
DEPARTMENT (OF 1	TRANSPORTATION	

DRIVEWAY ENTRANCE SIGNING					SECTION	COUNTY	TOTAL SHEETS	
		347	2016-084RS	COOK	74	71		
					TC-26	CONTRACT	NO.	62D64
SCALE: NONE	SHEET NO. 1 OF 1 SHEETS	STA.	TO STA.	FED. R	DAD DIST. NO. 1 ILLINOIS FED. AI	D PROJECT		

TRAFFIC SIGNAL LEGEND


(NOT TO SCALE)

CONTROLLER CABINET COMMUNICATION CABINET MASTER CONTROLLER MASTER MASTER CONTROLLER UNINTERRUPTABLE POWER SUPPLY SERVICE INSTALLATION -(P) POLE MOUNTED SERVICE INSTALLATION -(G) GROUND MOUNTED -(GM) GROUND MOUNTED TELEPHONE CONNECTION STEEL MAST ARM ASSEMBLY AND POLE ALUMINUM MAST ARM ASSEMBLY AND POLE STEEL COMBINATION MAST ARM	EXISTING ECC EMC EMC F C C C C C C C C C C C C	PROPOSED CCC MC MMC F P CM G G G G G M T B B B B B B B B B B B B	HANDHOLE -SOUARE -ROUND HEAVY DUTY HANDHOLE -SOUARE -ROUND DOUBLE HANDHOLE JUNCTION BOX RAILROAD CANTILEVER MAST ARM RAILROAD FLASHING SIGNAL RAILROAD CROSSING GATE RAILROAD CROSSBUCK RAILROAD CONTROLLER CABINET UNDERGROUND CONDUIT (UC), GALVANIZED STEEL TEMPORARY SPAN WIRE, TETHER WIRE, AND CABLE	EXISTING S S S S S S S S S S S S S S S S S S	PROPOSED H G V V V V V V V V V V V V V	SIGNAL HEAD -(P) PROGRAMMABLE SIGNAL HEAD SIGNAL HEAD WITH BACKPLATE -(P) PROGRAMMABLE SIGNAL HEAD -(RB) RETROREFLECTIVE BACKPLATE PEDESTRIAN SIGNAL HEAD AT RAILROAD INTERSECTIONS PEDESTRIAN SIGNAL HEAD WITH COUNTDOWN TIMER	EXISTING RESCOPE P RESCOPE RESCOPE	PROPOSED R Y G 4Y 4G P R Y G 4Y 4G P R R Y G Y G Y G Y G Y G Y G F D
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ALUMINUM MAST ARM ASSEMBLY AND POLE STEEL COMBINATION MAST ARM ASSEMBLY AND POLE WITH LUMINAIRE SIGNAL POST (BM) BARREL MOUNTED - TEMPORARY WOOD POLE SUY WIRE	0X 0X		UNDERGROUND CONDUIT (UC), GALVANIZED STEEL TEMPORARY SPAN WIRE,				C C	₩ C
STEEL COMBINATION MAST ARM SSEMBLY AND POLE WITH LUMINAIRE SIGNAL POST (BM) BARREL MOUNTED - TEMPORARY VOOD POLE SUY WIRE	o ` ¤—		TEMPORARY SPAN WIRE,	====		1	MA	★ □
ASSEMBLY AND POLE WITH LUMINAIRE SIGNAL POST (BM) BARREL MOUNTED - TEMPORARY VOOD POLE SUY WIRE	0					ILLUMINATED SIGN		
(BM) BARREL MOUNTED - TEMPORARY VOOD POLE SUY WIRE		● ● BM				"NO LEFT TURN"/"NO RIGHT TURN"		G V
GUY WIRE	⊗		SYSTEM ITEM	S	SP	NUMBER OF CONDUCTORS, ELECTRIC CABLE NO. 14, UNLESS NOTED OTHERWISE. ALL DETECTOR LOOP CABLE TO BE SHIELDED		
	· ·	•	INTERSECTION ITEM REMOVE ITEM	I	IP R	GROUND CABLE IN CONDUIT,		
STONAL HEAD	>-	>-	RELOCATE ITEM		RL	NO. 6 SOLID COPPER (GREEN)	(1#6)	(1*6)
ITGINAL HEAD	→ >	-	ABANDON ITEM		А	ELECTRIC CABLE IN CONDUIT, TRACER NO. 14 1/C		
IGNAL HEAD WITH BACKPLATE	+1>	+-	CONTROLLER CABINET AND FOUNDATION TO BE REMOVED		RCF	COAXIAL CABLE	<u> </u>	<u> </u>
	P P	→ + > P	MAST ARM POLE AND		RMF	VENDOR CABLE		
FLASHER INSTALLATION OF SOLAR POWERED		F FS	FOUNDATION TO BE REMOVED		TAIVII	COPPER INTERCONNECT CABLE,		
D-C		FF FS FS	SIGNAL POST AND FOUNDATION TO BE REMOVED		RPF	NO. 18, 3 PAIR TWISTED, SHIELDED FIBER OPTIC CABLE		_
PEDESTRIAN SIGNAL HEAD	-0	-1	DETECTOR LOOP, TYPE I			-NO. 62.5/125, MM12F -NO. 62.5/125, MM12F SM12F	— <u>(12</u> F)—	<u> 12F</u>
PEDESTRIAN PUSH BUTTON (APS) ACCESSIBLE PEDESTRIAN PUSH BUTTON	® APS	<pre></pre>	PREFORMED DETECTOR LOOP	[P] (P)	P P	-NO. 62.5/125, MM12F SM24F	— (24F)—	—(24F)—
RADAR DETECTION SENSOR	RJ	R■	SAMPLING (SYSTEM) DETECTOR	$\begin{bmatrix} \overline{s} \end{bmatrix}$ (\overline{s})	s s			—(36F)—
/IDEO DETECTION CAMERA	V	V	INTERSECTION AND SAMPLING (SYSTEM) DETECTOR		IS (IS)	GROUND ROD	C M D S	C M D S
RADAR/VIDEO DETECTION ZONE			QUEUE AND SAMPLING (SYSTEM) DETECTOR	[<u>0</u> s] (<u>0</u> s)	os (os)	-(C) CONTROLLER -(M) MAST ARM	±C ±M ±P ±S	† † † † †
PAN, TILT, ZOOM (PTZ) CAMERA	PTZ	PTZ◀	WIRELESS DETECTOR SENSOR	®	®	-(P) POST -(S) SERVICE		
MERGENCY VEHICLE LIGHT DETECTOR	\bowtie	◄	WIRELESS ACCESS POINT					
CONFIMATION BEACON	o-()	⊷						
WIRELESS INTERCONNECT	<u>○+</u>	•-1 						
	ERR	RR				1		


LOOP DETECTOR NOTES

- 1. EACH PAIR OF LOOP WIRES SHALL BE PLACED IN A SEPARATE EMPTY COILABLE NONMETALLIC CONDUIT FROM THE EDGE OF PAVEMENT TO THE HANDHOLE. SPACING BETWEEN THE HOLES DRILLED IN THE PAVEMENT SHALL NOT BE LESS THAN 6" (150 mm). EMPTY COILABLE NONMETALLIC CONDUIT SHALL BE INCLUDED IN THE COST OF THE LOOP WIRE.
- 2. THE NUMBER OF LOOP TURNS SHALL BE AS RECOMMENDED BY THE AMPLIFIER MANUFACTURER. ALL ADJACENT SIDES OF THE LOOPS SHALL BE INSTALLED IN SUCH A WAY THAT THE CURRENT FLOW IS IN THE SAME DIRECTION TO REINFORCE ITS MAGNETIC FIELDS FOR SMALL VEHICLE DETECTION.
- 3. EACH LOOP LEAD-IN SHALL BE IDENTIFIED AND PERMANENTLY TAGGED IN THE HANDHOLE. EACH LEAD-IN CABLE TAG SHALL INDICATE THE LOCATION OF THE LOOP, LOOP ROTATION (CLOCKWISE/COUNTERCLOCKWISE), LOOP LEAD-IN DIRECTION (IN OR OUT), LOOP CABLE NUMBER AND LOCATION IN CABINET. AND NUMBER OF TURNS IN THE DETECTOR LOOPS IN WATER PROOF INK AS INDICATED ON THE DISTRICT 1 STANDARD TRAFFIC SIGNAL DESIGN DETAIL. THE CONTRACTOR SHALL MARK LOOP LOCATIONS ON RECORD DRAWINGS AND PRESENT TO THE ENGINEER AFTER FINAL INSPECTION. LOOPS SHALL BE MARKED BY LANE AND LOOP NUMBER. SEE DETAIL BELOW.
- 4. ALL LOOP CABLE SHALL BE FASTENED WITH PLASTIC TIE WRAP TO THE HANDHOLE HOOKS.
- 5. IN ASPHALT PAVEMENT, LOOPS SHOULD BE PLACED IN THE BINDER AND DIVEHOLES MARKED AT THE CURB WITH A SAW-CUT. THE SAW-CUT SHALL BE CUT IN ACCORDANCE WITH LOCAL AND E.P.A. DUST CONTROL REQUIREMENTS. DETECTOR LOOP(S) SHALL NOT BE INSTALLED IN WET CONDITIONS AND THE SAW-CUTS MUST BE FREE OF DEBRIS AND RESIDUE SUCH AS DUST AND WATER WHICH IS TO BE ACHIEVED BY THE USE OF COMPRESSED AIR, WIRE BRUSHING AND HEAT DRYING ACCORDING TO SEALANT MANUFACTURER REQUIREMENTS. THE DETECTOR WIRE SHALL BE HELD IN PLACE BY THE USE OF FORM WEDGES. WEDGES SHALL BE SPACED NO MORE THAN 18" (450 mm) APART.
- 6. LOOP SPLICES SHALL BE SOLDERED USING A SOLDERING IRON. BLOW TORCHES OR OTHER DEVICES WHICH OXIDIZE COPPER CABLE SHALL NOT BE ALLOWED FOR SOLDERING OPERATIONS. SEE DETAIL BELOW RIGHT.
- 7. PREFORMED DETECTOR LOOPS SHALL BE USED, AS SHOWN ON THE PLANS, WHERE NEW CONCRETE PAVEMENT IS PROPOSED. THE INSTALLATION OF PREFORMED LOOPS SHALL BE IN ACCORDANCE WITH THE DISTRICT 1 SPECIFICATIONS OR AS DIRECTED BY THE ENGINEER.

LOOP LEAD-IN CABLE TAG

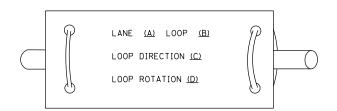



- A. LANE 1 IS THE LANE CLOSEST TO THE CENTERLINE OF THE ROADWAY
- B. LOOP *1 IS THE LOOP IN THE LANE CLOSEST TO THE INTERSECTION.
- C. LABEL LOOP CABLE "IN" OR LOOP CABLE "OUT".
- D. LABEL LOOP CABLE CLOCKWISE OR LOOP CABLE COUNTERCLOCKWISE.

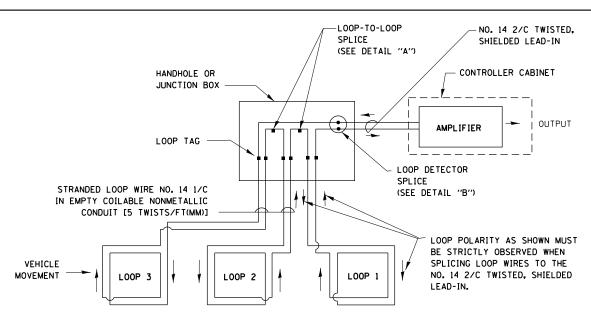

DETECTOR LOOP WIRING SCHEMATIC


- LOOPS SHALL BE SPLICED IN SERIES.
- SAW-CUTS SHALL BE A MINIMUM WIDTH OF 5/16" (8 mm).
- SAW-CUT DEPTHS SHALL BE 3" (75 mm). IF IN CONCRETE. THE SAW-CUT DEPTH SHALL BE TO THE TOP OF THE REINFORCEMENT.
- LOOP CORNERS SHALL BE DRILLED WITH A 2" (50 mm) DIAMETER CORE.

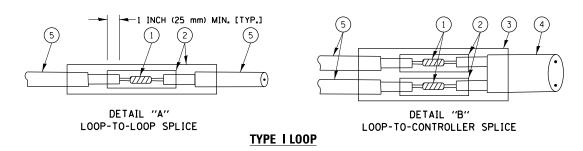

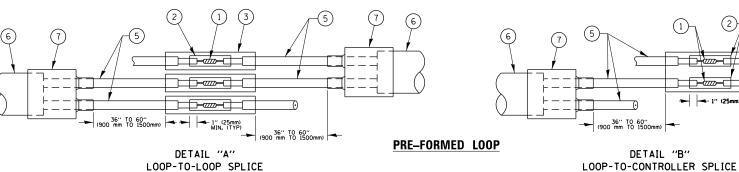

LOOP DETECTOR SPLICE

- (1) WESTERN UNION SPLICE SOLDERED WITH ROSIN CORE FLUX. ALL EXPOSED SURFACES OF THE SOLDER SHALL BE SMOOTH. THE WESTERN UNION SPLICES SHALL BE STAGGERED.
- (2) WCSMW 30/100 HEAT SHRINK TUBE, MINIMUM LENGTH 3" (75 mm), UNDERWATER GRADE.
- (3) WCS 200/750 HEAT SHRINK TUBE, MINIMUM LENGHT 6" (150 mm), UNDERWATER GRADE.
- (4) NO. 14 2/C TWISTED, SHIELDED CABLE.

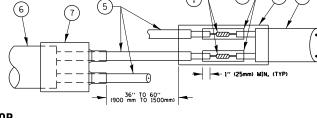

- 5 LOOP CONDUCTOR WITH FLEXIBLE PLASTIC TUBE.
- 6 PRE-FORMED LOOP
- XL POLYOLEFIN 2 CONDUCTOR 7 BREAKOUT SEALS. TYCO CBR-2 OR APPROVED EQUAL

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Default	PLOT DATE = 3/1/2018	DATE -	REVISED -		SCALE: NONE	SHEET 2	OF 7	SHEETS	STA.

DISTRICT ONE	F.A.P. RTE.	SECTION	COUNTY TOTAL SHEETS		SHEET NO.
STANDARD TRAFFIC SIGNAL DESIGN DETAILS	347	2016-084RS	COOK	74	73
STANDARD TRAFFIC SIGNAL DESIGN DETAILS		TS-05	CONTRACT NO.		2D64
SHEET 2 OF 7 SHEETS STA. TO STA.	T 2 OF 7 SHEETS STA. TO STA. ILLINOIS FED. AID PROJECT				

PROVIDE A PAVEMENT REPLACEMENT NOTE WHICH SHOULD EQUAL 3' (900 mm) X WIDTH OF PAVED SHOULDER. PAVED OR NON-PAVED SHOULDER PAVED OR NON-PAVED SHOULDER * = (600 mm) * * UNIT DUCT IS TO BE SHOWN ON PLAN SHEETS BUT SHALL NOT BE INCLUDED IN THE PAY ITEMS.

LEFT TURN LANES WITH MEDIANS VOLUME DENSITY ("FAR OUT" DETECTION) ON SAME APPROACH

(PROTECTED / PERMITTED LEFT TURN PHASING)

HANDHOLE LOCATION MAY
VARY DEPENDING ON GEOMETRICS
AND DESIGN OF TRAFFIC SIGNALS.
HEAVY-DUTY HANDHOLES TO BE
USED WHEN THE MEDIAN IS
MOUNTABLE. REFER TO STANDARD
REFER TO STANDARD

BI4001 TO ENSURE THAT HANDHOLE
FITS IN MEDIAN.

TRENCHED 1" (25 mm)

UNIT DUCT (3) **

* = (600 mm)

STRAIGHT SAW CUTS
PERPENDICULAR TO
MEDIAN (TYP.)

12'

(3.6 m)

12'

(6 w)

(1.8 m)

** UNIT DUCT IS TO BE SHOWN ON PLAN SHEETS


BUT SHALL NOT BE INCLUDED IN THE PAY ITEMS.

PLAN SHEET FOR DETECTOR LOOP REPLACEMENT

NOTE: DUAL LEFT TURNS NOT SHOWN REFER TO

LEFT TURN LANES WITHOUT MEDIANS VOLUME DENSITY ("FAR OUT" DETECTION) ON SAME APPROACH

(PROTECTED / PERMITTED LEFT TURN PHASING)

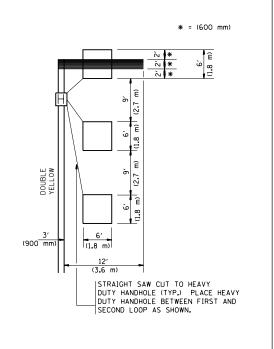



NOTE: DUAL LEFT TURNS NOT SHOWN REFER TO PLAN SHEET FOR DETECTOR LOOP REPLACEMENT

SCALE: NONE

ARTERIAL-VOLUME DENSITY ("FAR OUT" DETECTION)
CROSS STREET-VOLUME DENSITY ("FAR OUT" DETECTION)

ARTERIAL-VOLUME DENSITY ("FAR OUT" DETECTION)
CROSS STREET-NON VOLUME DENSITY ("UPTIGHT" PRESENCE DETECTION)

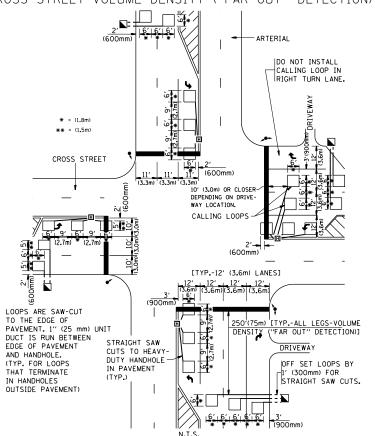

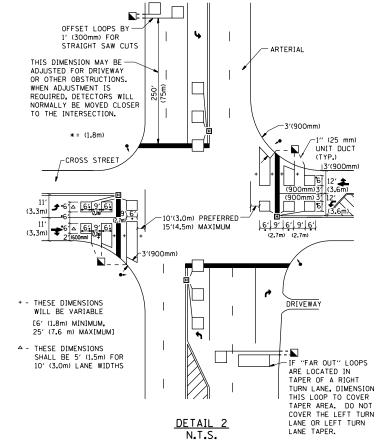

NOTES:

VEHICLES LOOP DETECTORS

- * ALL LEAD IN CABLE SHALL BE TWO CONDUCTOR NO. 14 TWISTED, SHIFLDED.
- * EACH DETECTOR LOOP SHALL HAVE ITS OWN SAW CUT FROM THE LOOP TO THE EDGE OF PAVEMENT OR TO A HANDHOLE IN THE PAVEMENT.
- * EACH DETECTOR LOOP SHALL HAVE ITS OWN ONE INCH (25 mm) UNIT DUCT BETWEEN THE EDGE OF PAVEMENT AND THE FIRST HANDHOLE OR JUNCTION BOX, EACH UNIT DUCT RUN SHALL BE SHOWN ON THE PLANS BY THE DESIGNER, BUT SHALL NOT BE PAID FOR SEPARATLY. THIS ITEM IS INCIDENTAL TO THE PAY ITEM FOR DETECTOR LOOPS.
- * ONE DIMENSION OF <u>ALL</u> DETECTOR LOOPS SHALL BE SIX FEET (1.8 m)
- * EACH LANE OF NON-LOCKING, PRESENCE DETECTION AND EACH LANE OF A DOUBLE LEFT TURN LANE REQUIRES A SEPARATE INDUCTIVE LOOP DETECTOR AND LEAD IN CABLE.
- * WHEN NON-LOCKING, PRESENCE DETECTION IS USED, MORE
 THAN ONE LOOP PER LANE IS REQUIRED BEHIND THE STOP BAR
 (i.e. 1-1/2, 1-3/4, 2).
- * WHEN SYSTEM LOOPS ARE REQUIRED ON AN APPROACH OF AN INTERSECTION, THE LOOPS USED FOR VOLUME DENSITY AND INTERSECTION TIMING SHALL ALSO BE USED AS SYSTEM DETECTORS. EACH ONE OF THESE TYPE OF LOOPS REQUIRES A SEPARATE TWO CONDUCTOR NO. 14 TWISTED SHIELDED CABLE AND A SEPARATE INDUCTIVE LOOP DETECTOR WHEN NEW CONTROLLERS ARE UTILIZED. THE DESIGNER SHALL LABEL THESE TYPES OF LOOPS AS "INTERSECTION AND SAMPLING (SYSTEM) DETECTORS" ON THE SIGNAL LAYOUT, THE INTERCONNECT PLAN AND THE SYSTEM CABLE PLAN. WHEN AN EXISTING CONTROLLER IS UTILIZED FOR THIS TYPE OF DETECTION, THE PAY ITEM "INDUCTIVE LOOP DETECTOR WITH SYSTEM OUTPUT" SHOULD BE USED.

PLACEMENT OF DETECTORS

THE FOLLOWING FIGURES REPRESENT THE MOST COMMON DETECTOR LOOP LOCATIONS AND SIZES. ADJUSTMENTS WILL BE NECESSARY FOR SPECIFIC GEOMETRIC CONSIDERATIONS.

LOCATIONS AND DEMENSIONS OF DETECTOR LOOPS ARE REQUIRED ON ALL SIGNAL LAYOUT PLAN SHEETS.

"FAR OUT" DETECTION REFERS TO LOCKING, PRESENCE TYPE DETECTION LOCATED IN THRU LANES, RIGHT TURN LANES, AND RIGHT TURN LANE TAPER AREAS (IF APPLICABLE), USUALLY 250' (75 m) IN ADVANCE OF STOP BARS. "UPTIGHT" DETECTION REFERS TO NON-LOCKING PRESENCE TYPE DETECTION LOCATED IN ALL LANES AND 10'-15' (3.0 m-4.5 m) BEHIND THE CROSSING STREET'S EDGE OF PAVEMENT EXTENDED.

JOTE.

ALL DETAILS AND NOTES SHOWN ARE FROM THE I.D.O.T. DISTRICT 1 TRAFFIC SIGNAL DESIGN GUIDELINES DATED JANUARY 1995

THIS DRAWING HAS BEEN PREPARED TO ASSIST THE RESIDENT ENGINEER FOR ALL ROADWAY RESURFACING OR S.M.A.R.T. PROJECTS WHERE THE DIMENSIONS ARE NOT SHOWN ON THE PLANS AND THE FINAL LOCATIONS FOR CROSSWALKS OR STOP BARS ARE NOT DETERMINED.

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DETAIL

N.T.S.

STATE OF ILLINOIS
DEPARTMENT OF TRANSPORTATION

DISTRICT 1 - E	ETECTOR L	OOP INSTALLATI	ON	F.A.P. RTE.	SECT	rion	COUNTY	TOTAL SHEETS	SHEET NO.
DETAILS FOR ROADWAY RESURFACING					2016-0	D84RS	соок	74	74
DETAILS	UN NUADVV	AT DESURE ACTIV	.	TS-07			CONTRACT	NO. 6	2D64
SHEET NO. 1 OF 1	SHEETS	STA.	TO STA.	FED. R	OAD DIST. NO. 1	ILLINOIS FED. A	ID PROJECT		