06-15-2018 LETTING ITEM 019

STATE OF ILLINOIS DEPARTMENT OF TRANSPORTATION


*30+1 = 31 TOTAL SHEETS

(55-1414R)RS-1

COOK 4 30

ILLINOIS CONTRACT NO. 62F81

D-91-210-18

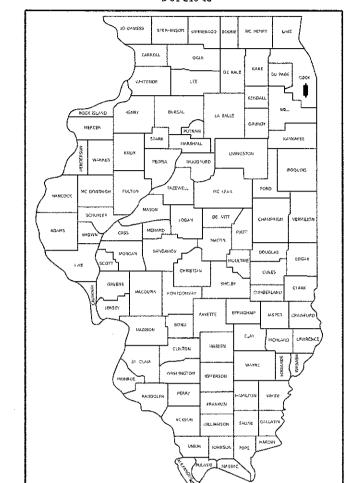

LOCATION OF SECTION INDICATED THUS: - -

FOR INDEX OF SHEETS, SEE SHEET NO. 2

IMPROVEMENT LOCATED IN THE CITY OF BLUE ISLAND

TRAFFIC DATA

0

2014 ADT GREGORY STREET = 5100 ADT


POSTED SPEED LIMIT

GREGORY STREET = 25 MPH

PROPOSED HIGHWAY PLANS

FAU ROUTE 2846: GREGORY ST. FROM 127TH STREET TO WESTERN AVENUE. **SECTION: (55–1414R)RS–1** RESURFACING (3P)/PEDESTRIAN RAMPS PROJECT: STP-E71C(599) **COOK COUNTY**

C-91-059-18

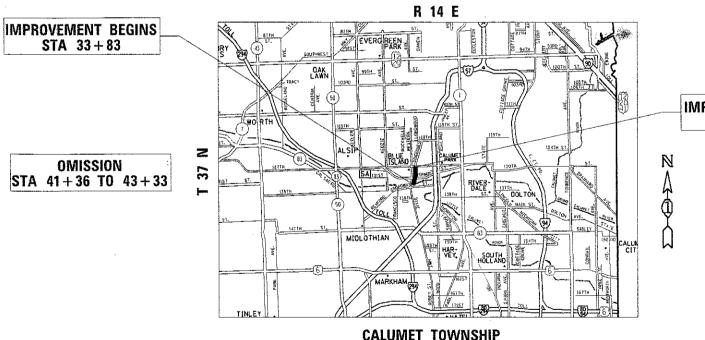

IMPROVEMENT ENDS STA 67+31

JOINT UTILITY LOCATION INFORMATION FOR EXCAVATION 1-800-892-0123

ENGINEERING SCALES, REDUCED SIZED PLANS WILL NOT CONFORM TO STANDARD SCALES. IN MAKING MEASUREMENTS ON REDUCED PLANS, THE ABOVE SCALES MAY BE USED.

PROJECT ENGINEER: ALAIN MIDY (847)221-3056 PROJECT MANAGER: FAWAD AQUEEL (847)705-4247

GROSS LENGTH = 3,368 FT. = 0.638 MILE

NET LENGTH = 3,171 FT. = 0.600 MILE

DEPARTMENT OF TRANSPORTATION SUBMITTED MARCH 13 20 18

STATE OF ILLINOIS

PRINTED BY THE AUTHORITY OF THE STATE OF ILLINOIS

CONTRACT NO. 62F81

STATE STANDARDS

INDEX OF SHEETS

- 1 COVER SHEET
- 2 INDEX OF SHEETS, STATE STANDARDS & GENERAL NOTES
- 3 4A SUMMARY OF QUANTITIES
 - 5 EXISTING AND PROPOSED TYPICAL SECTIONS
- 6 & 7 ROADWAY PLAN
 - B DETECTOR LOOP REPLACEMENT PLANS
- 9-19 ADA RAMPS
- 20 DETAILS FOR FRAMES AND LIDS ADJUSTMENT WITH MILLING (BD-08)
- 21 PAVEMENT PATCHING FOR HMA SURFACED PAVEMENT (BD-22)
- 22 CURB OR CURB AND GUTTER REMOVAL AND REPLACEMENT (BD-24)
- 23 BUTT JOINT AND HMA TAPER DETAILS (80-32)
- 24 TRAFFIC CONTROL AND PROTECTION FOR SIDE ROADS, INTERSECTIONS, AND DRIVEWAYS (TC-10)
- 25 TYPICAL APPLICATIONS RAISED REFLECTIVE PAVEMENT MARKERS (SNOW PLOW RESISTANT) (TC-11)
- 26 DISTRICT ONE TYPICAL PAVEMENT MARKINGS (TC-13)
- 27 TRAFFIC CONTROL AND PROTECTION AT TURN BAYS (TO REMAIN OPEN TO TRAFFIC) (TC-14)
- 28 PAVEMENT MARKING LETTERS AND SYMBOLS FOR TRAFFIC STAGING (TC-16)
- 29 ARTERIAL ROAD INFORMATION SIGN (TC-22)
- 30 DISTRICT 1 DETECTOR LOOP INSTALLATION DETAILS FOR ROADWAY RESURFACING (TS-07)

STANDARD NO.

DESCRIPTION

000001-66	STANDARD SYMBOLS, ABBREVIATIONS AND PATTERNS
424001-10	PREPENDICULAR CURB RAMPS FOR SIDEWALKS
424006-03	DIAGONAL CURB RAMPS FOR SIDEWALKS
424011-03	CORNER PARALLEL CURB RAMPS FOR SIDEWALKS
424016-0 4	MID-BLOCK CURB RAMPS FOR SIDEWALKS
424021-04	DEPRESSED CORNER FOR SIDEWALKS
442201-03	CLASS C AND D PATCHES
604001-04	FRAME AND LIDS, TYPE 1
606001- 67	COMBINATION CONCRETE CURB AND GUTTER
606201-0 4	TYPE B GUTTER (INLET, OUTLET & ENTRANCE)
701101-05	OFF-ROAD OPERATIONS, MULTILANE, 15' (4.5 M) TO 24" (600 MM) FROM PAVEMENT EDGE
701427-05	LANE CLOSURE, MULTILANE, INTERMITTEN OR MOVING OPERATION, FOR SPEEDS $\leq 40~\mathrm{MPH}$
701601-09	URBAN LANE CLOSURE, MULTILANE, 1W OR 2W. WITH NONTRAVERSABLE MEDIAN
701701-10	URBAN LANE CLOSURE, MULTILANE INTERSECTION
701801-06	SIDEWALK, CORNER OR CROSSWALK CLOSURE
701901-07	TRAFFIC CONTROL DEVICES

GENERAL NOTES

THE CONTRACTOR SHALL COORDINATE CONSTRUCTION ACTIVITIES WITH UTILITY COMPANIES, AND THE CITY OF BLUE ISLAND.

BEFORE STARTING ANY EXCAVATION, THE CONTRACTOR SHALL CALL "JULIE" AT 800-892-0123 OR 811 FOR FIELD LOCATIONS OF BURIED ELECTRIC, TELEPHONE AND GAS FACILITIES.

(48 HOURS NOTIFICATION IS REQUIRED)

THE CONTRACTOR WILL NOT BE ABLE TO SET UP A YARD OR FIELD OFFICE ON STATE PROPERTY WITHOUT THE WRITTEN PERMISSION OF THE DEPARTMENT.

ALL DAMAGE TO EXISTING PAVEMENT MARKINGS OR RAISED REFLECTIVE PAVEMENT MARKERS
OUTSIDE THE REMOVAL LINE SHOWN ON THE PLANS SHALL BE REPLACED AT THE CONTRACTOR'S EXPENSE.

BEFORE BEGINNING ANY WORK, THE CONTRACTOR SHALL RETAIN AND RECORD FOR FUTURE REFERENCE, ALL EXISTING PAVEMENT MARKING LINES (AND RAISED REFLECTIVE PAVEMENT MARKERS) IN ORDER THAT THESE LOCATIONS CAN BE RE-ESTABLISHED FOR STRIPING. EXACT LOCATIONS OF ALL PAVEMENT MARKINGS SHALL BE AS DIRECTED BY THE ENGINEER.

IT SHALL BE THE CONTRACTOR'S RESPONSIBILITY TO VERIFY ALL DIMENSIONS AND CONDITIONS EXISTING IN THE FIELD PRIOR TO CONSTRUCTION AND ORDERING OF MATERIALS.

FRAMES AND GRATES ADJUSTMENT OF PRIVATE UTILITIES WITHIN THE LIMITS OF THE IMPROVEMENTS SHALL BE DONE BY THEIR RESPECTIVE OWNERS AND ARE NOT PART OF THIS CONTRACT.

THE CONTRACTOR SHALL CONTACT THE IDOT ARTERIAL DISTRICT ONE TRAFFIC CONTROL SUPERVISOR AT (847) 705-4470 A MINIMUM OF 72 HOURS IN ADVANCE OF BEGINNING WORK.

THE RESIDENT ENGINEER SHALL CONTACT PATRICE HARRIS, AREA TRAFFIC FIELD ENGINEER, AT PATRICE HARRIS@ILLINOIS.GOV A MINIMUM OF TWO (2) WEEKS PRIOR TO THE PLACEMENT OF PERMANENT PAVEMENT MARKINGS.

DO NOT SCALE PLANS FOR CONSTRUCTION DIMENSIONS.

WHEN THE MILLED PAVEMENT IS OPEN TO TRAFFIC THE MAXIMUM GRADE DIFFERENTIAL BETWEEN PASSES OF THE MILLING MACHINE SHALL NOT EXCEED $1\frac{1}{2}$ INCHES WHERE THE SPEED LIMIT IS 40 MPH. OR LESS AND 1 INCH WHERE THE SPEED LIMIT IS GREATER THAN 40 MPH. WITTEN APPROVAL OF THE ENGINEER, A MAXIMUM GRADE DIFFERENTIAL OF 3 INCHES MAY BE

ALLOWED IF THE EDGE OF THE MILLING IS SLOPED A MINIMUM 1:3 (V:H) OR A NOTCHED LONGITUDINAL WEDGE IS USED.

ALL PAVEMENT PATCHING LOCATIONS WILL DETERMINED IN THE FIELD BY THE ENGINEER.

BUTT JOINTS WILL BE INSTALLED AT THE ENDS OF ALL RESURFACING (WHERE RESURFACING MEETS EXISTING PAYEMENT) ACCORDING TO THE "BUTT JOINT AND HOT-MIX ASPHALT TAPER DETAILS" SHEET INCLUDED IN THE PLANS, UNLESS OTHERWISE SPECIFIED.

OVERNIGHT LANE CLOSURES SHALL NOT BE ALLOWED FOR REHABILITATION PROJECTS INVOLVING DAYTIME MILLING AND RESURFACING OPERATIONS AND CLASS D PATCHING UNLESS OTHER CONDITIONS WARRANT EXTENDED LANE CLOSURES AS DETERMINED AND APPROVED IN WRITING BY THE ENGINEER OR AS PROVIDED FOR IN THE CONTRACT SPECIFICATIONS.

THE CONTRACTOR SHALL BE REQUIRED TO PROVIDE ACCESS TO ABUTTING PROPERTY AT ALL TIMES DURING THE CONSTRUCTION OF THIS PROJECT.

EXISTING BROKEN FRAMES AND LIDS SHALL BE REMOVED AND DISPOSED OF BY THE CONTRACTOR AND SHALL BE REPLACED AS DIRECTED BY THE ENGINEER. REPLACEMENT FRAMES AND LIDS WILL BE PAID FOR ACCORDING TO ARTICLE 109.04 OF THE STANDARD SPECIFICATIONS UNLESS A SEPARATE PAY ITEM HAS BEEN PROVIDED.

THE COST OF SURFACE REMOVAL IN THE GUTTER FLAG SHALL BE INCLUDED IN THE COST OF OF "HOT-MIX ASPHALT SURFACE REMOVAL 2 1/4" PAY ITEM.

ALL COMBINATION CONCRETE CURB AND GUTTER REMOVAL AND REPLACEMENT LOCATIONS WILL BE DETERMINED IN THE FIELD BY THE ENGINEER.

PAVEMENT MARKING TAPE, TYPE III SHALL BE USED FOR SHORT TERM PAVEMENT MARKINGS ON ALL FINAL SURFACES.

CONTACT THE IDOT ROADSIDE DEVELOPMENT UNIT AT 847-705-4171 AT LEAST 2 WEEKS PRIOR TO BEGINNING FORESTRY WORK FOR LAYOUT.

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PLOT DATE = 3/23/2018	DATE -	REVISED -

SCALE:

CODE NO 20100110 TF	ITEM	UNIT	URBAN TOTAL	80% FED 20% STATE			Ì]	 			URBAN					i	
20100110 TI			QUANTITIES	0005						CODE NO	ITEM	UNIT	TOTAL OUANTITIES	80% FED 20% STATE 0005	West-9444				
	TREE REMOVAL (6 TO 15 UNITS DIAMETER)	UNIT	114	114		ļ													
								-		40603340	HOT-MIX ASPHALT SURFACE COURSE, MIX	TON	1480	1480		<u> </u>			-
20100210 TR	TREE REMOVAL (OVER 15 UNITS DIAMETER)	UNIT	30	30	-						"D", N70		1-100	19100				_	
										42001300	PROTECTIVE COAT	SO YD	800	800		<u> </u>			
20101350 TR	TREE PRUNING (OVER 10 INCH DIAMETER)																		
20101330	TREE PROBLEM (OVER 10 INCH DIAMETER)	EACH	4	4						42700400	DODY AND OFFICE OR AND OFFICE OF THE OWNER OW								
,										42300400	PORTLAND CEMENT CONCRETE DRIVEWAY PAVEMENT, 8 INCH	SO YD	25	25					
20101400 NI	NITROGEN FERTILIZER NUTRIENT	POUND	1	1															
										42400200	PORTLAND CEMENT CONCRETE SIDEWALK 5 INCH	SO FT	5100	5100					
20101600 PO	POTASSIUM FERTILIZER NUTRIENT	POUND	1	1	the state of the s														-
										42400800	DETECTABLE WARNINGS	SO FT	443	443	<u>. </u>				
20200100 EA	EARTH EXCAVATION	CU YD	48	48														_	
				 	-	-				44000158	HOT-MIX ASPHALT SURFACE REMOVAL. 2	SO YD	17500	17500					
21101615 TO	OPSOIL FURNISH AND PLACE, 4"	SO YD	175	175							HOT-MIX ASPHALT SURFACE REMOVAL, 2	30 15	17300	11300				<u> </u>	
21101613	OFSOIL FURNISH AND FLACE, 4	50 10	135	135		İ	THE PARTY OF THE P			-									
									-	44000200	DRIVEWAY PAVEMENT REMOVAL	SO YD	25	25		<u></u>			
25000312 SE	SEEDING, CLASS 4A	ACRE	0.1	0. 1	ļļ.								<u> </u>						
			:							44000600	SIDEWALK REMOVAL	SQ FT	5100	SIDD					
25200110 S0	SODDING, SALT TOLERANT	SO YD	122	122			- Average and a second a second and a second a second and			The same of the sa				·					
	•									44002209	HOT-MIX ASPHALT REMOVAL OVER PATCHES, 2	SO YD	2730	2730					
25200200 SU	SUPPLEMENTAL WATERING	UNIT	1	1											0.4.40				-
										44201765	CLASS D PATCHES, TYPE II, 10 INCH	SO YD	700	700					
28001100 TE	EMPORARY EROSION CONTROL BLANKET	SO YD	400	400						11201703	CLASS B FAICHES, TIFE II, 10 INCH	טו זט	700	700					
25551755	LIN STATE ENGSTON CONTINUE BEARALT	30 10	400	400												<u> </u>			
										44201769	CLASS D PATCHES, TYPE III, 10 INCH	SQ YD	665	665	•				
40600290 BI	SITUMINOUS MATERIALS (TACK COAT)	POUND	11810	11810															
	TUTURE FOR COLOUR 12 112									44201771	CLASS D PATCHES, TYPE IV, 10 INCH	SO YD	950	950					
	IXTURE FOR CRACKS, JOINTS, AND ANGEWAYS	TON	27	27	1		-												
444		1		mm prografika e virtu						56109210	WATER VALVES TO BE ADJUSTED	EACH	3	3				.,,,	
40600827 MFT	LYMERIZED LEVELING BINDER (MACHINE THOD), IL-4.75, N50	TON	732	732															
	11.134 11.134									60250200	CATCH BASINS TO BE ADJUSTED	FACIL							
	T-MIX ASPHALT SURFACE REMOVAL - BUTT	SQ YD	216	216				•			AND POSTED TO BE MEGGIED	EACH	6	6					
10I	INT		11.00							-		-							
										60252800	CATCH BASINS TO BE RECONSTRUCTED	EACH	2	2					
	OT-MIX ASPHALT REPLACEMENT OVER ATCHES	TON	460	460						15									
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I		HECKED - ATE -		REVISED REVISED	-		DEP			ANSPORTA	SCALE: SHEET NO. OF	Y OF QUANTI			2846	(55-1414F	ORS-1	CONTRACT	30 3

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ſ		SUMM	ARY OF QUANTITIES		URBAN		CONSTRUC	TION TYPE CODE	***		SUMMARY OF QUANTITIES	:	URBAN		CONSTRUCTION TYPE	CODE
	CODE NO		ITEM	UNIT	TOTAL QUANTITIES	80% FED 20% STATE 0005				CODE NO	ITEM	UNIT	TOTAL QUANTITIES	80% FED 20% STATE 0005		
	60255410	CATCH BASINS	TO BE CLEANED	EACH	55	55				1.				 		
										70300220	TEMPORARY PAVEMENT MARKING - LINE 4"	FOOT	3832	3832		
	60260100	INLETS TO BE	ADJUSTED	EACH	7	7										
										70300240	TEMPORARY PAVEMENT MARKING - LINE 6"	F00T	1086	1086		
	60265700	VALVE VAULTS	TO BE ADJUSTED	EACH	1	1										
-										70300250	TEMPORARY PAVEMENT MARKING - LINE 8"	FOOT	395	395		
-	60404940	FRAMES AND G	RATES, TYPE 23	EACH	2	2										
										70300260	TEMPORARY PAVEMENT MARKING - LINE 12"	FOOT	776	776		
-	60406100	FRAMES AND L	IDS, TYPE 1, CLOSED LID	EACH	3	3				70300280	TEMPORARY PAVEMENT MARKING - LINE 24"	FOOT	207	207		
3 Ł						40			1	10300290	ILMI ONANI I ATEMENI MANKINO - LINE 24	7001	201	201		
*	66900200	NON-SPECIAL	WASTE DISPOSAL	CU YD	48	48		1	- Andrews	70300520	PAVEMENT MARKING TAPE, TYPE III 4"	F00T	2216	2216		
*	66900450	SPECIAL WAST	E PLANS AND REPORTS	L SUM	1	1				72/20/22	The A	- nai)	1	1		
7		JI COIRE WAS	E I CARO ARD NEI ON I S	L 3541						78000100	RELOCATE SIGN PANEL ASSEMBLY - TYPE A THERMOPLASTIC PAVEMENT MARKING - LETTERS AND SYMBOLS	E ACH SO FT	220	220		
*	66900530	SOIL DISPOSA	L ANALYSIS	EACH	1	1	de en				LETTERS ARD SIMBULS					
-										78000200	THERMOPLASTIC PAVEMENT MARKING - LINE 4"	FOOT	3832	3832		
•	67000400	ENGINEER'S F	IELD OFFICE, TYPE A	CAL MO	6	6	April									
							A the second sec			780004,00	THERMOPLASTIC PAVEMENT MARKING - LINE 6"	F00T	1086	1086		
	67100100	MOBILIZATION		L SUM	1	1										
										** 78000500	THERMOPLASTIC PAVEMENT MARKING - LINE 8"	FOOT	395	395		
	70102630	TRAFFIC CONT STANDARD 701	ROL AND PROTECTION, 601	L SUM	1	1										
-										78000600	THERMOPLASTIC PAVEMENT MARKING - LINE 12"	F001	776	776		
}	70102635	TRAFFIC CONTE	ROL AND PROTECTION, 701	L SUM	1	1										
Ī						44				78000650	THERMOPLASTIC PAVEMENT MARKING - LINE 24"	F00T	207	207	100	
	70102640	TRAFFIC CONTI	ROL AND PROTECTION, 301	L SUM	1	1				78100100	RAISED REFLECTIVE PAVEMENT MARKER	EACH	172	172		
					SSELE FOR STATE OF THE STATE OF					78100100	NAISED REFLECTIVE PAVEMENT MARKEN	EACH	112	112		
	70300100	SHORT TERM P	AVEMENT MARKING	FOOT	8865	8865				78300200	RAISED REFLECTIVE PAVEMENT MARKER	EACH	145	145		
	70300150	SHORT TERM P	AVEMENT MARKING REMOVAL	SQ FT	740	740					REMOVAL					
						1.0				* 85000200	MAINTENANCE OF EXISTING TRAFFIC SIGNAL INSTALLATION	EACH	1	1		
Ŋ	70300210		VEMENT MARKING LETTERS AND	SO FT	220	220				1				-	100	
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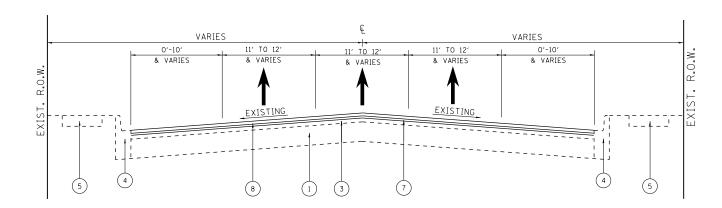
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		SUMMARY OF QUANTITIES		URBAN		CONSTRUC	TION TYPE (CODE			SUMMARY OF QUANTITIES			C	NSTRUCTION	N TYPE CODE	$\overline{-}$
CO	DE NO	ITEM	UNIT	TOTAL QUANTITIES	80% FED 20% STATE 0005					CODE NO	ITEM	UNIT	TOTAL QUANTITIES				
< 88	e00e00	DETECTOR LOOP REPLACEMENT	FOOT	155	155												
89!	5023,76	REBUILD EXISTING HANDHOLE	EACH	7	7												
xo:	320050	CONSTRUCTION LAYOUT (SPECIAL)	L SUM	1	1							William and the second of the					
									_			6.5 	The second secon				
X20	010400	STUMP REMOVAL ONLY	UNIT	47	47												
X5:	537800	STORM SEWERS TO BE CLEANED 12"	FOOT	300	300												
X60	030310	FRAMES AND LIDS TO BE ADJUSTED (SPECIAL)	EACH	40	40									1			+
		(SPECIAL)															<u></u>
x703	300Q5	TEMPORARY PAVEMENT MARKING REMOVAL	SQ FT	3970	3970												
Z00	18500	DRAINAGE STRUCTURES TO BE CLEANED	EACH	30	30												
Z00	045,62	COMBINATION CONCRETE CURB AND GUTTER REMOVAL AND REPLACEMENT	FOOT	880	889												
70	030850	TEMPORARY INFORMATION SIGNING	60.51	100											-		
	030630	TEMPORARY INFORMATION STORING	SQ FT	102	102												+
. 20	064800	SELECTIVE CLEARING	UNIT	4	4												
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		PLOT DATE = 3/23/2018	DATE -		REVISED	_				^		OF SHEETS STA	. TO STA.	FED. RO	AD DIST. NO. 1 ILL	INDIS FED. AID PROJECT	

GREGORY STREET

EXISTING TYPICAL SECTION

STA. 33+63 TO STA. 41+36 STA. 43+33 TO STA. 67+31



GREGORY STREET PROPOSED TYPICAL SECTION

STA. 33+63 TO STA. 41+36 STA. 43+33 TO STA. 67+31

MIXTURE REQUIREMENTS		QUALITY MANAGEMENT
MIXTURE USES	VOIDS ◎ Ndes	PROGRAM (QMP)
PAVEMENT RESURFACING		
HOT-MIX ASPHALT SURFACE COURSE, MIX "D", N70 (IL 9.5 mm)	4% AT 70 GYR.	QCP
POLYMERIZED LEVELING BINDER (MACHINE METHOD), IL-4.75, N50	3.5% AT 50 GYR.	QC/QA
PATCHING		
CLASS D PATCHES (HMA BINDER, IL-19.0 mm)	4% AT 70 GYR.	QC/QA
HOT-MIX ASPHALT REPLACEMENT OVER PATCHES (HMA BINDER IL 19MM)	4% AT 70 GYR.	QC/QA
QMP Designation: Quality Control/Quality Assurance (QC/QA); Quality Co	ntrol for Performance (Q	CP)

LEGEND

1 EXIST. P.C.C. PAVEMENT 10"

(5) EXIST. P.C.C SIDEWALK

2 EXIST. HOT-MIX ASPHALT PAVEMENT ± 3"

(3) EXIST. HOT-MIX ASPHALT PAVEMENT AFTER MILLING $\pm \frac{3}{4}$ "

(8) PROP. HOT-MIX ASPHALT SURFACE COURSE, MIX "D", N70, 11/2"

(7) PROP. POLYMERIZED LEVELING BINDER (MACHINE METHOD), IL-4.75, N50, 3/4"

(4) EXIST. COMBINATION CONCRETE CURB AND GUTTER

(6) PROP. HOT-MIX ASPHALT SURFACE REMOVAL, 21/4"

1. THE UNIT WEIGHT USED TO CALCULATE ALL HMA SURFACE MIXTURE QUANTITIES IS 112 LBS/SQYD/IN

SCALE:

2. THE "AC TYPE" FOR POLYMERIZED HMA MIXES SHALL BE "SBS/SBR PG 76-22" AND FOR NON-POLYMERIZED HMA THE "AC TYPE" SHALL BE "PG 64-22" UNLESS MODIFIED BY DISTRICT ONE SPECIAL PROVISIONS. FOR USE OF RECYCLED MATERIALS SEE SPECIAL PROVISIONS.


QUALITY MANAGEMENT PROGRAM (QMP) IDENTIFIES THE PARTICULAR QUALITY CONTROL SPECIFICATION THAT APPLIES TO THE HMA MIXTURE


THE CONTRACTOR SHALL PATCH FIRST BEFORE MILLING.

USER NAME = hassann	DESIGNED -	REVISED -	
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PLOT DATE = 3/23/2018	DATE -	REVISED -	


STATE OF ILLINOIS	
DEPARTMENT OF TRANSPORTATION	

		TYP	ICAL SECT	10N		F.A.U. RTE	SECTION		COUNTY	TOTAL SHEETS	SHEET NO.
GRE	GORY ST. FF	MOS	127TH CT	TO WES	TERN AVE.	2846	(55-1414R)RS-1		COOK	30	5
Unit	doni 31.11	TOIVI	12/111 31	. IO VVLS	ILIIIV AVL.				CONTRACT	NO. 62	2F81
	SHEET	OF	SHEETS	STA.	TO STA.		ILLINOIS	FED. AI	D PROJECT		

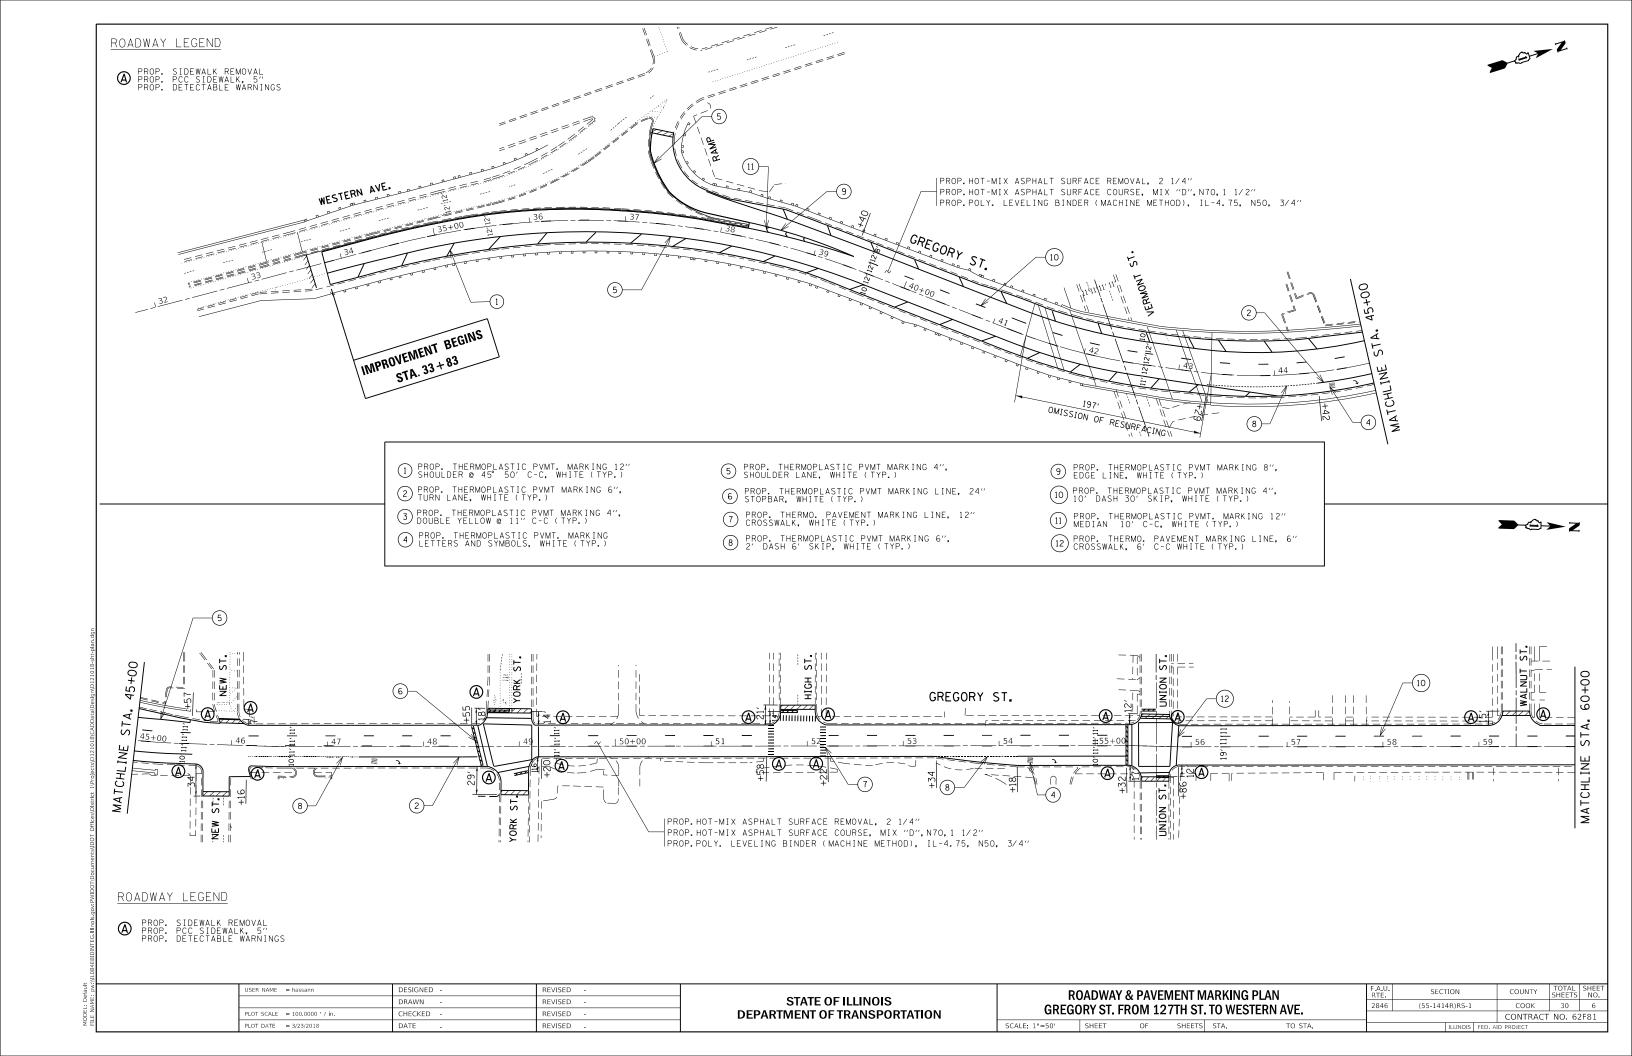

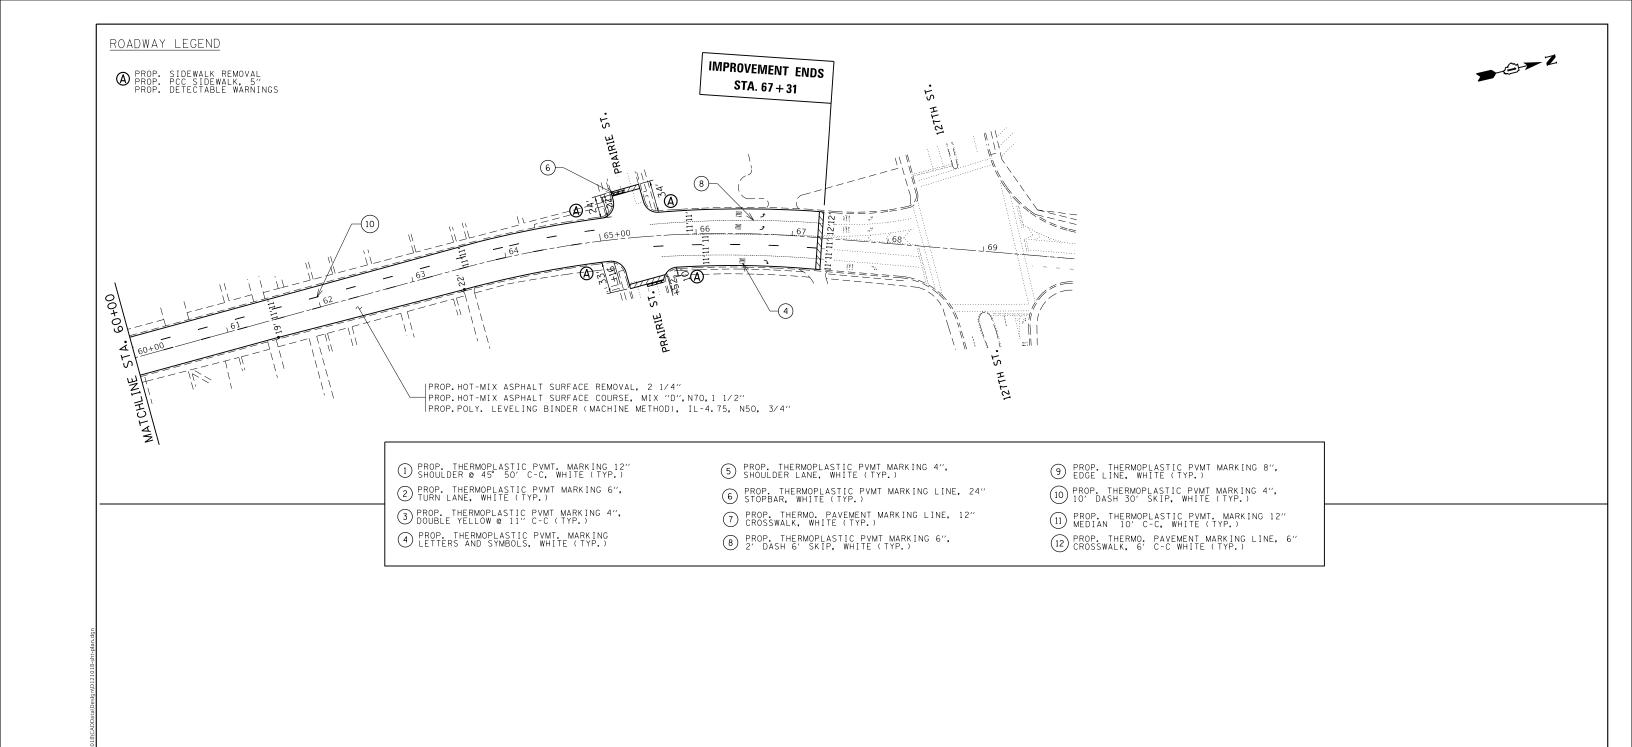


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PLOT DATE = 3/23/2018	DATE -	REVISED -	

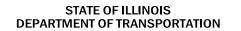


1		/ & PAVEI From 12			G PLAN STERN AVE.
SCALE: 1"=50'	SHEET	OF	SHEETS	STA.	TO STA.

F.A.U. RTE	SECTION		COUNTY	TOTAL SHEETS	SHEET NO.
2846	(55-1414R)RS-1	соок	30	7	
		CONTRACT	NO. 62	2F81	
	TLUNOIS	ID PROJECT			

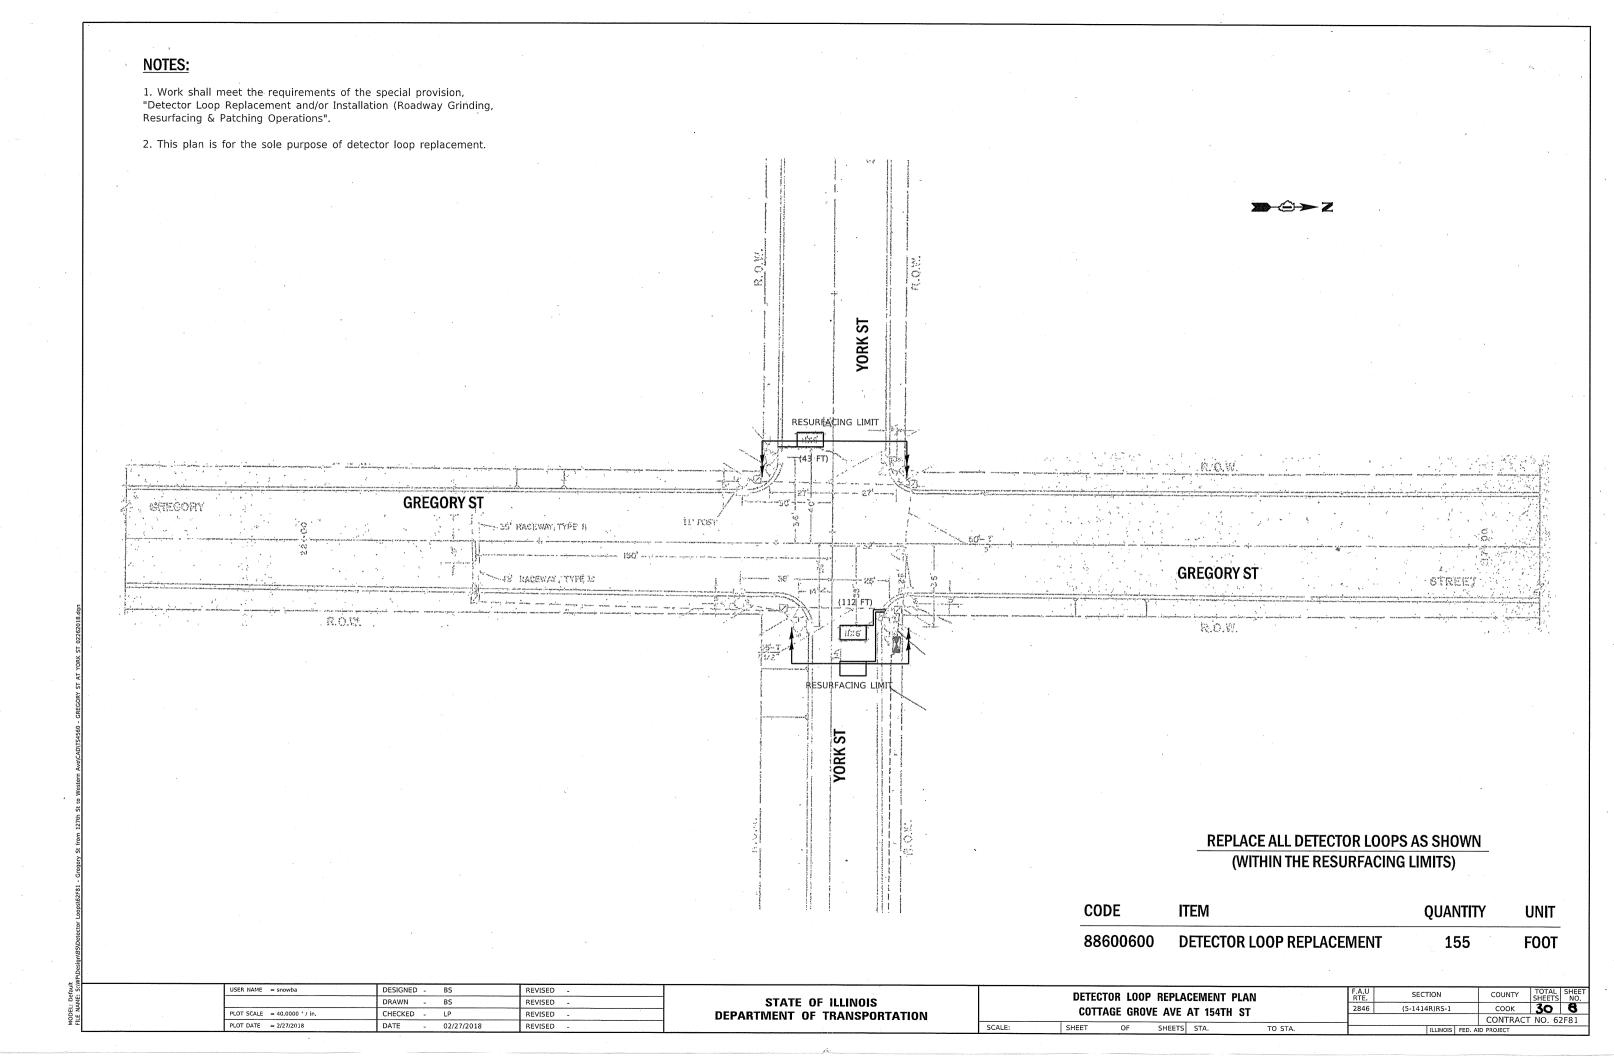



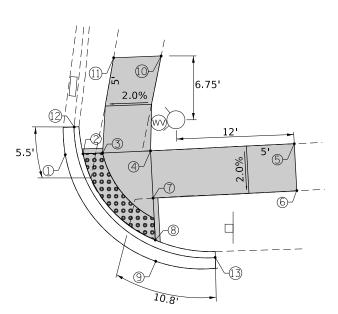


PRAIRIE ST.

ADA RAMP NORTHEAST CORNER GREGORY ST. & PRAIRIE ST.

POINT NO.:	EX. ELEVATION	PR. ELEVATION
<u>1</u>	634.15	Meet Existing
<u>2</u>	NA	634.15
<u>3</u>	NA	634.15
<u>4</u>	NA	634.15
<u>5</u>	635.14	Meet Existing
<u>6</u>	634.98	Meet Existing
<u>7</u>	NA	634.22
<u>8</u>	634.31	634.22
9	634.31	634.22
<u>10</u>	634.94	Meet Existing
<u>11</u>	634.77	Meet Existing
<u>12</u>	634.15	Meet Existing
<u>13</u>	634.24	Meet Existing

POINT NO.	DISTANCE (FEET)	<u>GRADES</u>
1-2	1.90	0.0%
2-3	2.00	0.0%
3-4	5.00	0.0%
4-5	15.00	6.6%
5-6	4.90	3.3%
6-7	15.00	5.1%
7-8	4.40	2.0%
8-9	1.90	0.0%
4-7	4.90	1.4%
4-10	10.00	7.9%
10-11	4.80	3.3%
11-3	10.00	6.2%
2-8	12.20	1.3%
1-9	15.30	1.0%

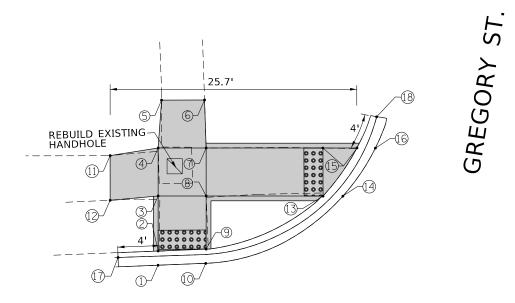

PRAIRIE ST.

ADA RAMP NORTHWEST CORNER GREGORY ST. & PRAIRIE ST.

POINT NO.:	EX. ELEVATION	PR. ELEVATION
<u>1</u>	634.50	Meet Existing
<u>2</u>	NA	634.5
<u>3</u>	NA	634.9
<u>4</u>	NA	634.9
<u>5</u>	635.23	Meet Existing
<u>6</u>	635.01	Meet Existing
<u>7</u>	NA	634.9
<u>8</u>	NA	634.9
9	NA	634.48
<u>10</u>	634.48	Meet Existing
<u>11</u>	635.31	Meet Existing
<u>12</u>	634.97	Meet Existing
<u>13</u>	NA	634.53
<u>14</u>	634.53	Meet Existing
<u>15</u>	NA	634.51
<u>16</u>	634.51	Meet Existing
<u>17</u>	634.48	Meet Existing
<u>18</u>	634.47	Meet Existing

1-2	1.5	0.0%
2-3	5.7	7.0%
3-4	5.0	0.0%
4-5	5.0	6.6%
5-6	4.5	4.9%
6-7	5.0	2.2%
7-8	5.0	0.0%
8-9	5.5	7.6%
9-10	1.5	0.0%
11-12	4.7	7.2%
12-3	5.0	1.4%
11-4	5.1	8.0%
4-7	5.0	0.0%
13-14	1.5	0.0%
8-13	12.2	3.0%
3-8	5.0	0.0%
7-15	15.7	2.5%
15-16	1.5	0.0%
1-10	5.0	0.4%
14-16	6.0	0.3%
2-9	5.0	0.4%
13-15	6.1	0.3%

POINT NO. DISTANCE (FEET) GRADES

REFERENCE BENCHMARK ELEV 636.135

BENCHMARK : EASTERLY BOLT OF FIRE HYDRANT.

LOCATION: NORTH EAST CORNER OF GREGORY ST. & PRAIRE ST.

LEGEND

EXISTING LENGTH

PROPOSED SIDE CURB

EXISTING ELEVATION/SLOPE

PROPOSED SIDEWALK

DETECTABLE WARNINGS

SIDEWALK REMOVAL REPLACE W/TOPSOIL & SOD REFERENCE BENCHMARK ELEV 636.135

BENCHMARK : EASTERLY BOLT OF FIRE HYDRANT.

LOCATION: NORTH EAST CORNER OF GREGORY ST. & PRAIRE ST.


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STATE OF ILLINOIS **DEPARTMENT OF TRANSPORTATION**

SIDEWALK DETAIL PLAN GREGORY STREET FROM 127TH ST. TO WESTERN AVENUE SCALE: SHEETS STA.

SECTION СООК 2846 (55-1414R)RS-1 CONTRACT NO. 62F81

PRAIRIE ST.




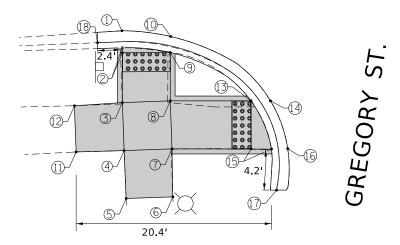

POINT NO.:	EX. ELEVATION	PR. ELEVATION
<u>1</u>	634.47	Meet Existing
<u>2</u>	NA	634.47
3	NA	634.75
<u>4</u>	NA	634.75
<u>5</u>	635.06	Meet Existing
<u>6</u>	634.89	Meet Existing
<u>7</u>	NA	634.75
<u>8</u>	NA	634.75
9	NA	634.39
<u>10</u>	634.39	Meet Existing
<u>11</u>	635.10	Meet Existing
<u>12</u>	634.93	Meet Existing
<u>13</u>	NA	634.22
<u>14</u>	634.22	Meet Existing
<u>15</u>	NA	634.21
<u>16</u>	634.21	Meet Existing
<u>17</u>	634.17	Meet Existing
<u>18</u>	634.44	Meet Existing

POINT NO.	DISTANCE (FEET)	<u>GRADES</u>
1-2	1.8	0.0%
2-3	5.7	4.9%
3-4	5.0	0.0%
4-5	5.0	6.2%
5-6	4.9	3.5%
6-7	5.0	2.8%
7-8	5.0	0.0%
8-9	5.0	7.2%
9-10	1.7	0.0%
11-12	4.8	3.5%
12-3	5.0	3.6%
11-4	5.0	7.0%
4-7	5.0	0.0%
13-14	2.0	0.0%
8-13	8.4	6.3%
3-8	5.0	0.0%
7-15	10.4	5.2%
15-16	1.7	0.0%
1-10	5.0	1.6%
14-16	5.3	0.2%
2-9	5.0	1.6%
13-15	5.0	0.2%

PRAIRIE ST.

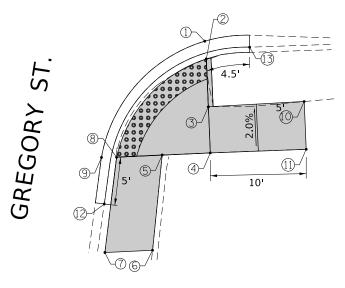

ADA RAMP SOUTHEAST CORNER GREGORY ST. & PRAIRIE ST.

POINT NO.:	EX. ELEVATION	PR. ELEVATION
<u>1</u>	634.13	Meet Existing
<u>2</u>	NA	634.13
<u>3</u>	NA	634.13
<u>4</u>	NA	634.13
<u>5</u>	NA	634.13
<u>6</u>	634.53	Meet Existing
<u>7</u>	634.63	Meet Existing
<u>8</u>	NA	634.13
9	634.14	Meet Existing
<u>10</u>	634.67	Meet Existing
<u>11</u>	634.81	Meet Existing
<u>12</u>	634.15	Meet Existing
<u>13</u>	634.13	Meet Existing

<u>POINT NO.</u>	DISTANCE (FEET)	<u>GRADES</u>
1-2	1.86	0.0%
2-3	5.00	0.0%
3-4	4.80	0.0%
4-5	5.00	0.0%
5-6	10.00	4.0%
6-7	4.90	2.0%
7-8	10.00	5.0%
8-9	1.60	0.6%
10-11	4.70	3.0%
11-4	10.00	6.8%
10-3	10.00	5.4%
8-5	4.80	0.0%
2-8	14.50	0.0%

COOK 30 10

CONTRACT NO. 62F81

REFERENCE BENCHMARK ELEV 636.135

BENCHMARK : EASTERLY BOLT OF FIRE HYDRANT.

LOCATION: NORTH EAST CORNER OF GREGORY ST. & PRAIRE ST.

LEGEND

EXISTING LENGTH

PROPOSED SIDE CURB

EXISTING ELEVATION/SLOPE

PROPOSED SIDEWALK

TABLE WARNINGS

DETECTABLE WARNINGS

SIDEWALK REMOVAL REPLACE W/TOPSOIL & SOD

SCALE:


REFERENCE BENCHMARK ELEV 636.135

BENCHMARK : EASTERLY BOLT OF FIRE HYDRANT.

LOCATION: NORTH EAST CORNER OF GREGORY ST. & PRAIRE ST.

STATE OF ILLINOIS
DEPARTMENT OF TRANSPORTATION

		SIDEWA	LK DETA	IL PLA	N	F.A.U. RTE.	SECTION
GREGORY	STREET	FROM	127TH S	т то	WESTERN AVENUE	2846	(55-1414R)RS-1
UNLUUM	JIIILLI	IIIOIVI	12/111 3	1. 10	WESTERN AVENUE		
	CHEET	0.5	CHEETC	CT.	TO CTA		

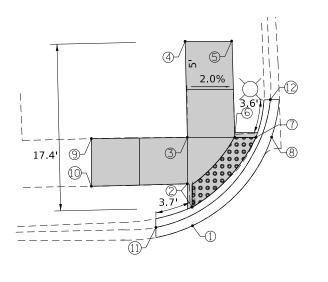

GREGORY


WALNUT ST.

ADA RAMP NORTHWEST CORNER GREGORY ST. & WALNUT ST.

POINT NO.:	EX. ELEVATION	PR. ELEVATION
<u>1</u>	634.17	Meet Existing
<u>2</u>	NA	634.17
<u>3</u>	NA	634.1
<u>4</u>	634.66	Meet Existing
<u>5</u>	634.33	Meet Existing
<u>6</u>	NA	634.1
<u>7</u>	NA	634.1
<u>8</u>	634.10	Meet Existing
9	634.86	Meet Existing
<u>10</u>	634.77	Meet Existing
<u>11</u>	634.19	Meet Existing
<u>12</u>	633.93	Meet Existing

POINT NO.	DISTANCE (FEET)	<u>GRADES</u>
1-2	1.90	0.0%
2-3	7.50	0.9%
3-4	10.00	5.6%
4-5	4.80	6.9%
5-6	10.00	2.3%
6-7	2.20	0.0%
7-8	1.60	0.0%
9-10	5.00	1.8%
9-3	10.00	7.6%
10-2	10.00	6.0%
6-3	4.90	0.0%
7-2	10.00	0.7%
1-8	12.70	0.6%

WALNUT ST.

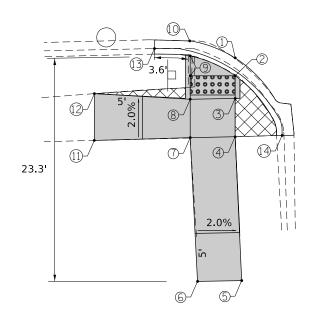

ST. GREGORY

ADA RAMP SOUTHWEST CORNER GREGORY ST. & WALNUT ST.

POINT NO.:	EX. ELEVATION	PR. ELEVATION
<u>1</u>	634.75	634.65
<u>2</u>	NA	634.65
<u>3</u>	NA	634.80
<u>4</u>	NA	634.80
<u>5</u>	635.65	Meet Existing
<u>6</u>	635.75	Meet Existing
<u>7</u>	NA	634.80
<u>8</u>	NA	634.80
9	NA	634.60
<u>10</u>	634.60	Meet Existing
<u>11</u>	635.55	Meet Existing
<u>12</u>	635.40	Meet Existing
<u>13</u>	634.44	Meet Existing
<u>14</u>	635.03	Meet Existing

POINT NO.	DISTANCE (FEET)	<u>GRADES</u>
1-2	1.90	0.0%
2-3	2.40	6.2%
3-4	4.00	0.0%
4-5	15.00	5.7%
5-6	4.60	2.2%
6-7	15.00	6.3%
7-8	4.00	0.0%
9-10	1.60	0.0%
11-12	5.10	2.9%
9-2	4.60	1.1%
12-8	10.00	6.0%
11-7	10.00	7.5%
7-4	4.70	0.0%
8-3	4.70	0.0%
10-1	5.30	0.9%
•		

REFERENCE BENCHMARK ELEV 635.84

BENCHMARK : SOUTH EASTERLY BOLT OF FIRE HYDRANT.

LOCATION: NORTH EAST CORNER OF GREGORY ST. & WALNUT ST.

LEGEND

EXISTING LENGTH

PROPOSED SIDE CURB

EXISTING ELEVATION/SLOPE



PROPOSED SIDEWALK

DETECTABLE WARNINGS

SIDEWALK REMOVAL REPLACE W/TOPSOIL & SOD REFERENCE BENCHMARK ELEV 635.84

BENCHMARK : SOUTH EASTERLY BOLT OF FIRE HYDRANT.


LOCATION: NORTH EAST CORNER OF GREGORY ST. & WALNUT ST.

FILE NAME = DESIGNED -REVISED ow:\\ILØ84EBIDINTEG.:111:no: ments\IDOT Offices\District 1\Projects\Di21**81BRXWW**ota\Design\Di21018-sht-details.dg REVISED CHECKED -REVISED PLOT DATE = 3/23/2018

STATE OF ILLINOIS **DEPARTMENT OF TRANSPORTATION**

SIDEWALK DETAIL PLAN								
	GREGORY STREET FROM 127TH ST. TO WESTERN AVENUE							
SCALE:		SHEET	OF	SHEETS	STA.		TO STA.	

(55-1414R)RS-1 СООК CONTRACT NO. 62F81

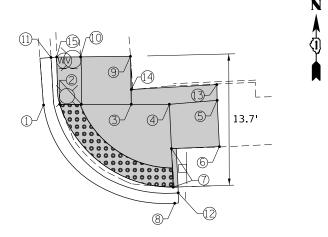

UNION ST.

REBUILD EXISTING HANDHOLE 17.1' 8 5' 8 6 6 7 7 4.8'

UNION ST.

ADA RAMP NORTHEAST CORNER GREGORY ST. & UNION ST.

POINT NO.:	EX. ELEVATION	PR. ELEVATION	
<u>1</u>	638.74	Meet Existing	
<u>2</u>	NA	638.74	
<u>3</u>	NA	638.7	
<u>4</u>	NA	638.7	
<u>5</u>	638.82	Meet Existing	
<u>6</u>	638.59	Meet Existing	
<u>7</u>	NA	638.57	
<u>8</u>	638.57	Meet Existing	
9	639.03	Meet Existing	
<u>10</u>	638.96	Meet Existing	
<u>11</u>	638.68	Meet Existing	
<u>12</u>	638.46	Meet Existing	
<u>13</u>	638.91	Meet Existing	
<u>14</u>	NA	638.97	
<u>15</u>	639.15	Meet Existing	

POINT NO.	DISTANCE (FEET)	<u>GRADES</u>
1-2	1.70	0.0%
2-3	7.50	0.5%
3-4	4.00	0.0%
4-5	5.00	2.4%
5-6	4.80	4.8%
6-7	5.00	0.4%
7-8	1.70	0.0%
9-10	5.20	1.3%
9-14	3.50	1.7%
10-2	5.00	4.4%
4-7	8.60	1.5%
7-2	15.70	1.1%
1-8	18.80	0.9%

ADA RAMP NORTHWEST CORNER GREGORY ST. & UNION ST.

POINT NO.:	EX. ELEVATION	PR. ELEVATION
<u>1</u>	638.52	Meet Existing
<u>2</u>	NA	638.52
<u>3</u>	NA	638.52
<u>4</u>	639.04	Meet Existing
<u>5</u>	639.10	Meet Existing
<u>6</u>	NA	638.60
<u>7</u>	638.70	638.60
<u>8</u>	639.09	Meet Existing
9	638.94	Meet Existing
<u>10</u>	638.38	Meet Existing
<u>11</u>	638.65	Meet Existing

<u>POINT NO.</u>	DISTANCE (FEET)	<u>GRADES</u>
1-2	1.90	0.0%
2-3	7.10	0.0%
3-4	10.00	5.2%
4-5	4.90	1.2%
5-6	10.00	5.0%
6-7	2.10	0.0%
8-9	5.00	3.0%
9-2	10.00	4.2%
8-3	10.00	5.7%
2-6	10.20	0.8%
1-7	13.20	0.6%
3-6	6.60	1.2%

REFERENCE BENCHMARK ELEV 641.44

BENCHMARK : TOP SPINDLE OF FIRE HYDRANT.

LOCATION: NORTH EAST CORNER OF GREGORY ST. & UNION ST.

LEGEND

EXISTING LENGTH

PROPOSED SIDE CURB

EXISTING ELEVATION/SLOPE

PROPOSED SIDEWALK

DETECTABLE WARNINGS

SIDEWALK REMOVAL
REPLACE W/TOPSOIL & SOD

SCALE:


REFERENCE BENCHMARK ELEV 641.44

BENCHMARK: TOP SPINDLE OF FIRE HYDRANT.


LOCATION: NORTH EAST CORNER OF GREGORY ST. & UNION ST.

STATE OF ILLINOIS
DEPARTMENT OF TRANSPORTATION



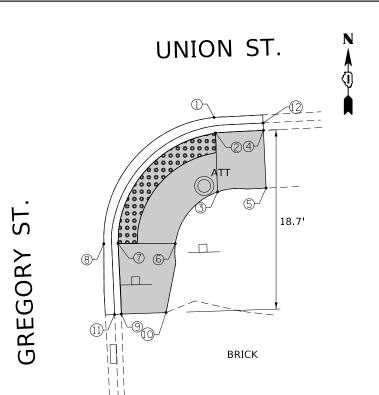

UNION ST.

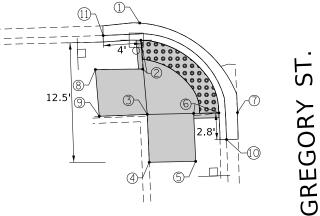

ADA RAMP SOUTHEAST CORNER GREGORY ST. & UNION ST.

POINT NO.:	EX. ELEVATION	PR. ELEVATION
<u>1</u>	638.73	Meet Existing
<u>2</u>	NA	638.73
<u>3</u>	NA	638.73
<u>4</u>	639.08	Meet Existing
<u>5</u>	639.23	Meet Existing
<u>6</u>	NA	638.83
<u>7</u>	NA	638.83
<u>8</u>	638.83	Meet Existing
9]	639.28	Meet Existing
<u>10</u>	639.41	Meet Existing
<u>11</u>	638.86	Meet Existing
<u>12</u>	638.64	Meet Existing

POINT NO.	DISTANCE (FEET)	<u>GRADES</u>
1-2	1.60	0.0%
2-3	6.15	0.0%
2-4	5.00	7.0%
4-5	6.00	2.5%
3-5	5.10	7.8%
6-7	6.00	0.0%
7-8	1.50	0.0%
9-10	5.20	2.5%
9-7	7.40	6.1%
10-6	7.40	7.8%
6-3	7.30	1.4%
7-2	16.75	0.6%
1-8	19.20	0.5%

ADA RAMP SOUTHWEST CORNER GREGORY ST. & UNION ST.

POINT NO.:	EX. ELEVATION	PR. ELEVATION
<u>1</u>	638.65	Meet Existing
<u>2</u>	NA	638.65
<u>3</u>	NA	638.75
<u>4</u>	639.03	Meet Existing
<u>5</u>	638.89	Meet Existing
<u>6</u>	NA	638.75
<u>7</u>	638.89	638.75
<u>8</u>	638.82	Meet Existing
9	638.97	Meet Existing
<u>10</u>	638.80	Meet Existing
<u>11</u>	638.51	Meet Existing

<u>POINT NO.</u>	DISTANCE (FEET)	<u>GRADES</u>
1-2	1.80	0.0%
2-3	7.75	1.3%
3-4	5.00	5.6%
4-5	4.80	2.9%
5-6	5.00	2.8%
6-7	1.90	0.0%
8-9	4.90	3.1%
9-3	5.00	4.4%
8-2	5.00	3.4%
2-6	12.20	0.8%
1-7	15.10	0.7%
3-6	4.80	0.0%

 COUNTY
 TOTAL SHEETS NO.

 COOK
 30
 13

 CONTRACT
 NO.
 62F81

REFERENCE BENCHMARK ELEV 641.44

BENCHMARK : TOP SPINDLE OF FIRE HYDRANT.

LOCATION: NORTH EAST CORNER OF GREGORY ST. & UNION ST.

LEGEND

EXISTING LENGTH

PROPOSED SIDE CURB

EXISTING ELEVATION/SLOPE



PROPOSED SIDEWALK

DETECTABLE WARNINGS

SIDEWALK REMOVAL REPLACE W/TOPSOIL & SOD REFERENCE BENCHMARK ELEV 641.44


BENCHMARK : TOP SPINDLE OF FIRE HYDRANT.

LOCATION: NORTH EAST CORNER OF GREGORY ST. & UNION ST.

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		PLOT SCALE = 10.0000 '/ in.	CHECKED -	REVISED -	
	Default	PLOT DATE = 3/23/2018	DATE -	REVISED -	

STATE	OF ILLINOIS	
DEPARTMENT	OF TRANSPORTATION	V

SIDEWALK DETAIL PLAN						SECTION
	GREGORY STREET	FROM	127TH ST. TO W	ESTERN AVENUE	2846	(55-1414R)RS-1
	GILLOUIT GITTLE		127111 01110 111			
SCALE:	SHEET	OF	SHEETS STA.	TO STA.		ILLINOIS F

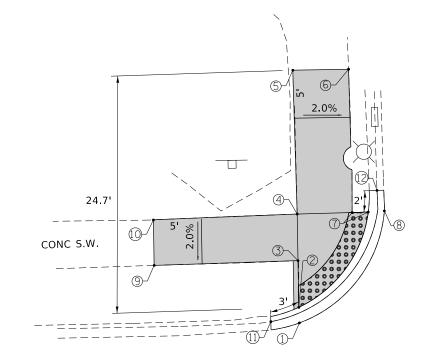

GREGORY

HIGH ST.

ADA RAMP NORTHEAST CORNER GREGORY ST. & HIGH ST.

HIGH ST.

POINT NO.:	EX. ELEVATION	PR. ELEVATION
<u>1</u>	641.39	Meet Existing
<u>2</u>	NA	641.39
<u>3</u>	NA	641.39
<u>4</u>	NA	641.42
<u>5</u>	NA	641.42
<u>6</u>	641.42	Meet Existing
<u>7</u>	641.90	Meet Existing
<u>8</u>	642.02	Meet Existing
9	641.94	Meet Existing
<u>10</u>	642.02	Meet Existing
<u>11</u>	641.36	Meet Existing
<u>12</u>	641.39	Meet Existing

POINT NO.	DISTANCE (FEET)	<u>GRADES</u>
1-2	1.60	0.0%
2-3	9.60	0.0%
3-4	5.00	0.6%
4-5	8.90	0.0%
5-6	1.60	0.0%
7-8	8.00	-1.5%
9-10	7.00	1.1%
9-2	10.00	5.5%
10-3	10.00	6.3%
5-7	10.00	4.8%
4-8	10.00	6.0%
1-6	5.00	0.6%
2-5	5.00	0.6%

ADA RAMP NORTHWEST CORNER GREGORY ST. & HIGH ST.

POINT NO.:	EX. ELEVATION	PR. ELEVATION
<u>1</u>	641.10	Meet Existing
<u>2</u>	NA	641.1
<u>3</u>	NA	641.1
<u>4</u>	NA	641.1
<u>5</u>	642.04	Meet Existing
<u>6</u>	641.73	Meet Existing
<u>7</u>	NA	641.17
<u>8</u>	641.17	Meet Existing
9	641.99	Meet Existing
<u>10</u>	642.22	Meet Existing
<u>11</u>	641.10	Meet Existing
<u>12</u>	641.10	Meet Existing

POINT NO.	DISTANCE (FEET)	<u>GRADES</u>
1-2	1.60	0.0%
2-3	4.90	0.0%
3-4	4.85	0.0%
4-5	15.00	6.3%
5-6	5.20	6.0%
6-7	15.00	3.7%
7-8	1.70	0.0%
9-10	4.90	4.7%
9-3	15.00	5.9%
10-4	15.00	7.5%
4-7	5.70	1.2%
7-2	12.80	0.5%
1-8	15.50	0.5%

REFERENCE BENCHMARK ELEV 642.253

BENCHMARK : "
" SOUTH CONCRETE BASE OF LIGHT POLE.

LOCATION: NORTH SIDE OF HIGH ST. ±50' WEST OF GREGORY ST.

LEGEND

EXISTING LENGTH

PROPOSED SIDE CURB

EXISTING ELEVATION/SLOPE

DETECTABLE WARNINGS

PROPOSED SIDEWALK

SIDEWALK REMOVAL REPLACE W/TOPSOIL & SOD

REFERENCE BENCHMARK ELEV 642.253

BENCHMARK : "

" SOUTH CONCRETE BASE OF LIGHT POLE.


LOCATION: NORTH SIDE OF HIGH ST. ±50' WEST OF GREGORY ST.

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STATE OF ILLINOIS **DEPARTMENT OF TRANSPORTATION**

SIDEWALK DETAIL PLAN GREGORY STREET FROM 127TH ST. TO WESTERN AVENUE SHEETS STA.

SECTION COOK (55-1414R)RS-1 CONTRACT NO. 62F81

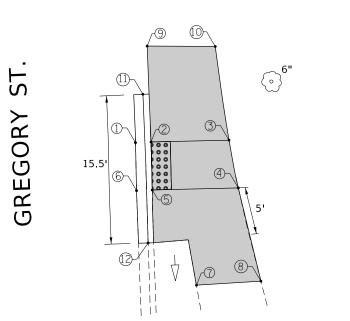


ADA RAMP SOUTHEAST CORNER GREGORY ST. & HIGH ST.

POINT NO.:	EX. ELEVATION	PR. ELEVATION
<u>1</u>	641.47	Meet Existing
<u>2</u>	NA	641.47
<u>3</u>	NA	641.47
<u>4</u>	NA	641.47
<u>5</u>	NA	641.47
<u>6</u>	641.46	Meet Existing
<u>7</u>	641.86	Meet Existing
<u>8</u>	641.93	Meet Existing
9	641.93	Meet Existing
<u>10</u>	642.00	Meet Existing
<u>11</u>	641.44	Meet Existing
<u>12</u>	641.38	Meet Existing

POINT NO.	DISTANCE (FEET)	<u>GRADES</u>
1-2	1.60	0.0%
2-3	8.10	0.0%
3-4	5.00	0.0%
4-5	9.00	0.0%
5-6	1.60	0.6%
7-8	10.00	0.7%
9-10	7.60	0.9%
9-2	10.00	4.6%
10-3	10.00	5.3%
5-7	10.00	3.9%
4-8	10.00	4.6%
1-6	5.00	0.2%
2-5	5.00	0.0%

HIGH ST.

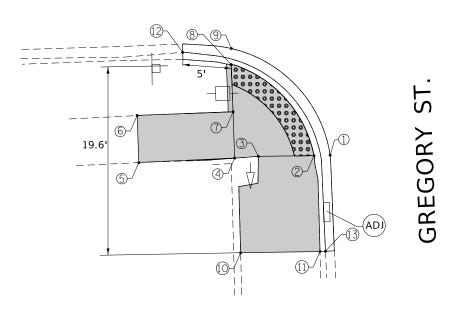

ADA RAMP SOUTHWEST CORNER GREGORY ST. & HIGH ST.

POINT NO.:	EX. ELEVATION	PR. ELEVATION
1	641.20	Meet Existing
<u>2</u>	NA	641.2
<u>3</u>	NA	641.2
<u>4</u>	NA	641.2
<u>5</u>	641.69	Meet Existing
<u>6</u>	641.67	Meet Existing
<u>7</u>	NA	641.25
<u>8</u>	NA	641.25
9	641.32	641.25
<u>10</u>	641.77	Meet Existing
<u>11</u>	641.56	Meet Existing
<u>12</u>	641.37	Meet Existing
<u>13</u>	641.15	Meet Existing

POINT NO.	DISTANCE (FEET)	GRADES
1-2	1.70	0.0%
2-3	5.80	0.0%
3-4	2.50	0.0%
4-5	10.00	4.9%
5-6	5.00	0.4%
6-7	10.00	4.2%
7-8	4.90	0.0%
8-9	1.70	0.0%
10-11	8.30	1.4%
2-11	10.00	5.7%
10-3	10.00	5.7%
4-7	4.80	1.0%
8-2	13.50	0.4%
1-9	16.10	0.3%

REFERENCE BENCHMARK ELEV 642.253

BENCHMARK : "

" SOUTH CONCRETE BASE OF LIGHT POLE.

LOCATION: NORTH SIDE OF HIGH ST. ±50' WEST OF GREGORY ST.

LEGEND

EXISTING LENGTH

PROPOSED SIDE CURB



PROPOSED SIDEWALK

DETECTABLE WARNINGS

SIDEWALK REMOVAL REPLACE W/TOPSOIL & SOD REFERENCE BENCHMARK ELEV 642.253

BENCHMARK : "
" SOUTH CONCRETE BASE OF LIGHT POLE.


LOCATION: NORTH SIDE OF HIGH ST. ±50' WEST OF GREGORY ST.

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STATE OF ILLINOIS **DEPARTMENT OF TRANSPORTATION**

			SIDEWA	LK DETAI	IL PL/	AN		F.A RT
	CRECORV	CTRFFT	FROM	127TH C	т то	WESTERN	AVENUE	28
	diledoili	JIIILLI	THOW			VVLSTEIIIV	AVENUE	
SCALE:	S	HEET	OF	SHEETS	STA.		TO STA.	

		ILLINOIS	FED. A	ID	PROJECT			
					CONTRACT	Γ NO. 6	S2F81	
2846	(55-1414R)RS-1				COOK	30	15	
RTE.					COUNTY	SHEETS	NO.	

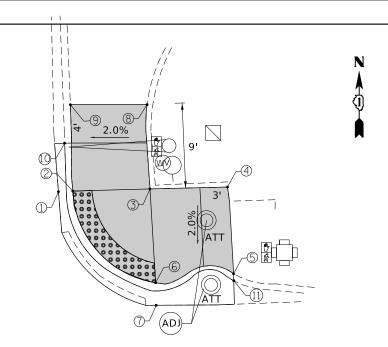


YORK ST.

ADA RAMP NORTHEAST CORNER GREGORY ST. & YORK ST.

GREGORY

POINT NO.:	EX. ELEVATION	PR. ELEVATION
<u>1</u>	638.01	Meet Existing
<u>2</u>	NA	638.01
<u>3</u>	NA	638.01
4	638.09	Meet Existing
<u>5</u>	637.83 Meet Existing	
6	NA 637.85	
<u>7</u>	637.77 637.85	
<u>8</u>	638.69	Meet Existing
9	638.56 Meet Existing	
<u>10</u>	638.09 Meet Existin	
<u>11</u>	637.35	Meet Existing

POINT NO.	DISTANCE (FEET)	<u>GRADES</u>
1-2	1.60	0.0%
2-3	8.00	0.0%
3-4	8.00	1.0%
4-5	9.00	2.9%
5-6	8.20	0.2%
6-7	2.30	0.0%
8-9	5.00	2.6%
9-2	9.00	6.1%
8-3	9.00	7.6%
2-6	13.90	1.2%
1-7	17.30	0.9%
3-6	9.80	1.6%

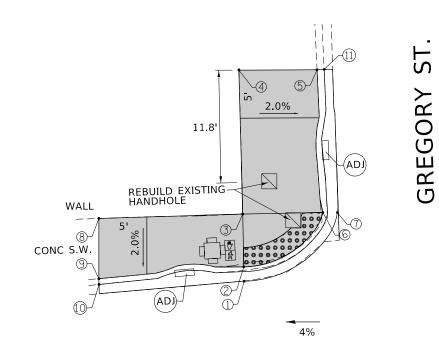

YORK ST.

ADA RAMP NORTHWEST CORNER GREGORY ST. & YORK ST.

POINT NO.:	EX. ELEVATION	PR. ELEVATION
<u>1</u>	637.36	Meet Existing
<u>2</u>	NA	637.36
<u>3</u>	NA	637.36
<u>4</u>	638.60	Meet Existing
<u>5</u>	638.30	Meet Existing
<u>6</u>	NA	637.45
<u>7</u>	637.73 637.45	
<u>8</u>	638.16 Meet Existin	
<u>9</u>	637.79 Meet Existing	
<u>10</u>	637.14	Meet Existing
<u>11</u>	637.70	Meet Existing

POINT NO.	DISTANCE (FEET)	<u>GRADES</u>
1-2	1.60	0.0%
2-3	5.50	0.0%
3-4	15.00	8.3%
4-5	7.90	3.8%
5-6	15.00	5.7%
6-7	1.60	0.0%
8-9	5.00	7.4%
9-2	15.00	2.9%
8-3	15.00	5.3%
2-6	10.60	0.8%
1-7	13.00	0.7%
3-6	8.30	1.1%

REFERENCE BENCHMARK ELEV 637.67

BENCHMARK: "
"IN THE NORTH EAST CORNER OF CONCRETE BASE OF T.C.B.

LOCATION: NORTH EAST CORNER OF GREGORY ST AND YORK ST.

LEGEND

EXISTING LENGTH

PROPOSED SIDE CURB

EXISTING ELEVATION/SLOPE

PROPOSED SIDEWALK

DETECTABLE WARNINGS

SIDEWALK REMOVAL REPLACE W/TOPSOIL & SOD

SCALE:

REFERENCE BENCHMARK ELEV 637.67

BENCHMARK: " " IN THE NORTH EAST CORNER OF CONCRETE BASE OF T.C.B.


LOCATION: NORTH EAST CORNER OF GREGORY ST AND YORK ST.

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	PLOT SCALE = 10.0000 '/ in.	CHECKED -	REVISED -	
Default	PLOT DATE = 3/23/2018	DATE -	REVISED -	

STATE OF ILLINOIS DEPARTMENT OF TRANSPORTATION

SIDEWALK DETAIL PLAN						
GREGORY	Y STREET	FROM	127TH S	T. T0	WESTERN	AVENUE
	SHEET	OF	SHEETS	STA.		TO STA.

F.A.U. RTE.	SECTION	COUNTY	TOTAL SHEETS	SHEET NO.
2846	(55-1414R)RS-1	COOK	30	16
		CONTRAC	NO. 6	52F81
	ILLINOIS FED. A	ID PROJECT		

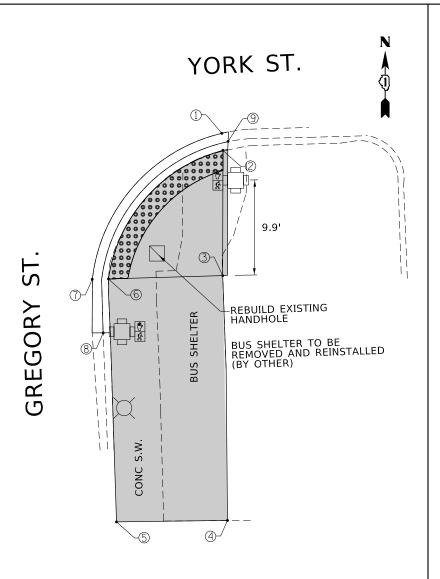


ADA RAMP SOUTHEAST CORNER GREGORY ST. & YORK ST.

POINT NO.:	EX. ELEVATION	PR. ELEVATION
<u>1</u>	637.49	Meet Existing
<u>2</u>	NA	637.49
<u>3</u>	NA	637.49
<u>4</u>	638.00	Meet Existing
<u>5</u>	637.83	Meet Existing
<u>6</u>	NA 637.54	
<u>7</u>	637.54 Meet Existing	
<u>8</u>	637.50	Meet Existing
9	637.33	Meet Existing

POINT NO.	DISTANCE (FEET)	<u>GRADES</u>
1-2	1.60	0.0%
2-3	13.00	0.0%
3-4	25.50	2.0%
4-5	11.60	1.5%
5-6	25.30	1.1%
6-7	1.60	0.0%
3-6	11.90	0.4%
1-7	21.60	0.2%
2-6	19.00	0.3%

YORK ST.

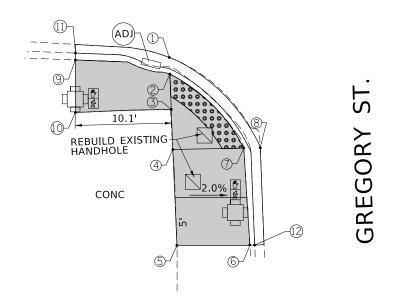

ADA RAMP SOUTHWEST CORNER GREGORY ST. & YORK ST.

POINT NO.:	EX. ELEVATION	PR. ELEVATION
<u>1</u>	637.48	Meet Existing
<u>2</u>	NA	637.48
<u>3</u>	NA	637.48
<u>4</u>	NA	637.53
<u>5</u>	638.19	Meet Existing
<u>6</u>	637.87	Meet Existing
<u>7</u>	NA	637.53
<u>8</u>	637.53	Meet Existing
<u>9</u>	637.97	Meet Existing
<u>10</u>	638.20 Meet Existin	
<u>11</u>	637.47 Meet E	
<u>12</u>	637.49 Meet Existin	

POINT NO.	DISTANCE (FEET)	<u>GRADES</u>
1-2	1.60	0.0%
2-3	3.70	0.0%
3-4	4.20	1.2%
4-5	10.00	6.6%
5-6	7.50	4.3%
6-7	10.00	3.4%
7-8	1.60	0.0%
9-10	5.10	4.5%
9-2	10.00	4.9%
10-3	10.00	7.2%
4-7	7.40	0.0%
2-7	11.10	0.5%
1-8	14.10	0.4%

СООК

CONTRACT NO. 62F81

REFERENCE BENCHMARK ELEV 637.67

BENCHMARK: " " IN THE NORTH EAST CORNER OF CONCRETE BASE OF T.C.B.

LOCATION: NORTH EAST CORNER OF GREGORY ST AND YORK ST.

LEGEND

EXISTING LENGTH

= PROPOSED SIDE CURB



DETECTABLE WARNINGS

PROPOSED SIDEWALK

SIDEWALK REMOVAL
REPLACE W/TOPSOIL & SOD

SCALE:

REFERENCE BENCHMARK ELEV 637.67


BENCHMARK: " " IN THE NORTH EAST CORNER OF CONCRETE BASE OF T.C.B.

LOCATION: NORTH EAST CORNER OF GREGORY ST AND YORK ST.

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Default	PLOT DATE = 3/23/2018	DATE -	REVISED -	L

STATE OF	ILLINOIS
DEPARTMENT OF	TRANSPORTATION

	•	SIDEWA	LK DETAI	L PL	AN	F.A.U. RTE.	SECTION
GREGORY	STREET	FROM	127TH S	т то	WESTERN AVENUE	2846	(55-1414R)RS-1
diledoii	OTHELL	THOW	127111 0	1. 10	WESTERN AVENUE		
	SHEET	OF	SHEETS	STA.	TO STA.		ILLINOIS FED.

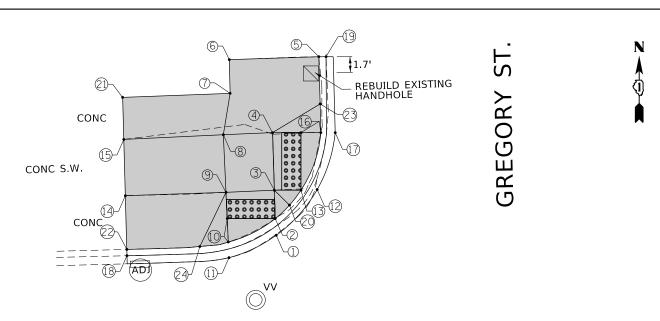


NEW ST.

ADA RAMP NORTHWEST CORNER GREGORY ST. & NEW ST.

POINT NO.:	EX. ELEVATION	PR. ELEVATION
1	636.67	Meet Existing
<u>2</u>	NA	636.67
3	NA	636.85
	NA	636.90
<u>4</u> <u>5</u> 6	636.98	Meet Existing
<u>6</u>	637.18	Meet Existing
<u>7</u>	NA	637.05
<u>8</u>	NA	636.90
<u>9</u>	NA	636.85
<u>10</u>	NA	636.66
<u>11</u>	636.66	Meet Existing
<u>12</u>	636.71	Meet Existing
<u>13</u>	NA	636.71
<u>14</u>	637.07	Meet Existing
<u>15</u>	637.14	Meet Existing
<u>16</u>	NA	636.76
<u>17</u>	636.76	Meet Existing
<u>18</u>	636.49	Meet Existing
<u>19</u>	636.76	Meet Existing
<u>20</u>	NA	636.90
<u>21</u>	637.18	Meet Existing
<u>22</u>	636.88	Meet Existing
<u>23</u>	636.98	Meet Existing
<u>24</u>	636.88	Meet Existing

POINT NO.	DISTANCE (FEET)	<u>GRADES</u>
1-2	1.7	0.0%
2-3	3.0	6.0%
3-4	6.0	0.8%
4-5	7.8	1.0%
5-6	9.3	2.2%
6-7	3.5	3.7%
7-8	4.4	3.4%
8-9	6.0	0.8%
9-10	2.7	7.0%
10-11	1.6	0.0%
12-13	1.7	0.0%
13-3	2.8	5.0%
16-17	1.7	0.0%
4-16	3.0	4.7%
13-16	6.0	0.8%
12-17	6.3	0.8%
10-2	5.5	0.2%
9-3	5.0	0.0%
1-11	5.5	0.2%
14-9	10.5	2.1%
15-8	10.4	2.3%
4-8	5.0	0.0%
14-15	5.9	1.2%

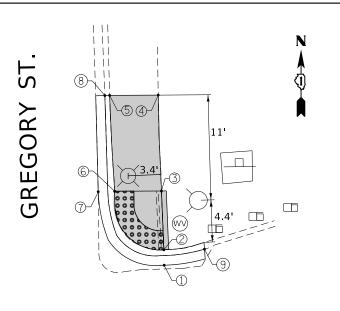

NEW ST.

ADA RAMP NORTHEAST CORNER GREGORY ST. & NEW ST.

POINT NO.:	EX. ELEVATION	PR. ELEVATION
<u>1</u>	636.67	Meet Existing
<u>2</u>	NA	636.67
<u>3</u>	NA	636.67
<u>4</u>	637.18	Meet Existing
<u>5</u>	637.04	Meet Existing
<u>6</u>	NA	636.66
<u>7</u>	636.66	Meet Existing
<u>8</u>	636.63	Meet Existing
<u>9</u>	636.42	Meet Existing

POINT NO.	DISTANCE (FEET)	<u>GRADES</u>
1-2	1.60	0.0%
2-3	6.10	0.0%
3-4	10.00	5.1%
4-5	5.00	2.8%
5-6	10.00	3.8%
6-7	1.60	0.0%
2-6	9.20	0.1%
1-7	12.00	0.1%
6-3	4.90	0.2%

REFERENCE BENCHMARK ELEV 638.51

BENCHMARK : EASTERLY BOLT OF FIRE HYDRANT.

LOCATION: EAST CORNER OF GREGORY ST. & NEW ST.

LEGEND

EXISTING LENGTH

PROPOSED SIDE CURB

EXISTING ELEVATION/SLOPE

PROPOSED SIDEWALK

DETECTABLE WARNINGS

SIDEWALK REMOVAL REPLACE W/TOPSOIL & SOD

SCALE:

REFERENCE BENCHMARK ELEV 638.51

BENCHMARK : EASTERLY BOLT OF FIRE HYDRANT.


LOCATION: EAST CORNER OF GREGORY ST. & NEW ST.


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STATE OF ILLINOIS	
DEPARTMENT OF TRANSPORTATION	

		SIDEWA	LK DETA	L PL/	١N		F.A.U. RTE.	SECTION	COUNTY	TOTAL SHEETS	SHEET NO.
GREGORY	STREET	FROM	127TH C	т то	WESTERN	AVENUE	2846	(55-1414R)RS-1	COOK	30	18
diredoni	JIIILLI	I IIOIVI	12/111 3	1. 10	VVLSTEIIIV	AVENUE			CONTRAC	T NO. 6	52F81
	CHEET	OΕ	SHEETS	CTA		TO STA		V. 10076 FED. 41	DD0 /F07		

NEW ST.



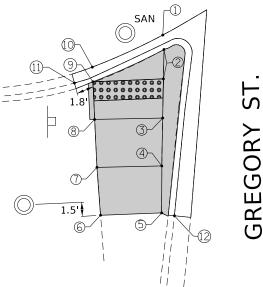


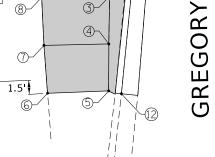ADA RAMP SOUTHWEST CORNER GREGORY ST. & NEW ST.

POINT NO.:	EX. ELEVATION	PR. ELEVATION
<u>1</u>	637.30	Meet Existing
<u>2</u>	NA	637.3
<u>3</u>	NA	637.6
<u>4</u>	NA	637.65
<u>5</u>	637.99	Meet Existing
<u>6</u>	637.90	Meet Existing
<u>7</u>	NA	637.60
<u>8</u>	NA	637.52
9	NA	637.21
<u>10</u>	637.21	Meet Existing
<u>11</u>	637.16	Meet Existing
<u>12</u>	637.50	Meet Existing

POINT NO.	DISTANCE (FEET)	<u>GRADES</u>
1-2	1.50	0.0%
2-3	4.00	7.5%
3-4	5.10	1.0%
4-5	5.00	6.8%
5-6	6.40	1.4%
6-7	5.00	6.0%
7-8	5.00	1.6%
8-9	3.90	7.9%
9-10	1.50	0.0%
10-1	8.00	1.1%
2-9	8.00	1.1%
3-8	7.00	1.1%
4-7	6.80	0.7%

ST GREGORY

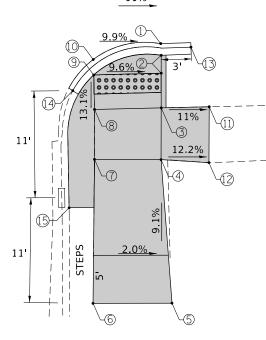

NEW ST.

ADA RAMP SOUTHEAST CORNER GREGORY ST. & NEW ST.

POINT NO.:	EX. ELEVATION	PR. ELEVATION
<u>1</u>	637.14	Meet Existing
<u>2</u>	NA	637.14
<u>3</u>	NA	637.4
<u>4</u>	NA	637.4
<u>5</u>	638.77	Meet Existing
<u>6</u>	638.49	Meet Existing
<u>7</u>	NA	637.40
<u>8</u>	NA	637.40
<u>9</u>	NA	637.87
<u>10</u>	637.87	Meet Existing
<u>11</u>	637.95	Meet Existing
<u>12</u>	638.01	Meet Existing
<u>13</u>	636.75	Meet Existing
<u>14</u>	638.18	Meet Existing
<u>15</u>	639.13	Meet Existing

POINT NO.	<u>DISTANCE (FEET)</u>	<u>GRADES</u>
1-2	1.60	0.0%
2-3	3.60	7.2%
3-4	5.40	0.0%
4-5	15.00	9.1%
5-6	7.80	3.6%
6-7	15.00	7.3%
7-8	5.20	0.0%
8-9	3.60	13.1%
9-10	1.60	0.0%
11-12	5.80	1.0%
10-1	7.40	9.9%
9-2	7.60	9.6%
8-3	7.00	0.0%
7-4	7.00	0.0%
4-12	5.00	12.2%
3-11	5.00	11.0%

REFERENCE BENCHMARK ELEV 638.51

BENCHMARK : EASTERLY BOLT OF FIRE HYDRANT.

LOCATION: EAST CORNER OF GREGORY ST. & NEW ST.

LEGEND

EXISTING LENGTH

PROPOSED SIDE CURB

EXISTING ELEVATION/SLOPE

PROPOSED SIDEWALK

SIDEWALK REMOVAL

DETECTABLE WARNINGS

REPLACE W/TOPSOIL & SOD

REFERENCE BENCHMARK ELEV 638.51

BENCHMARK : EASTERLY BOLT OF FIRE HYDRANT.


LOCATION: EAST CORNER OF GREGORY ST. & NEW ST.


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STATE OF ILLINOIS **DEPARTMENT OF TRANSPORTATION**



SECTION COOK 30 19 (55-1414R)RS-1 2846 CONTRACT NO. 62F81



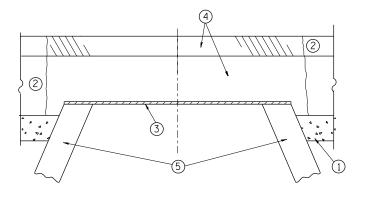

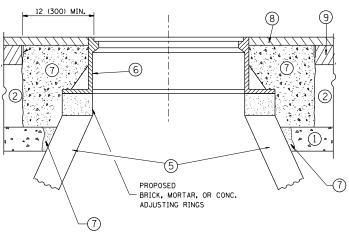NOTES:

EXISTING BROKEN FRAMES AND LIDS SHALL BE REMOVED AND DISPOSED OF BY THE CONTRACTOR AND SHALL BE REPLACED AS DIRECTED BY THE ENGINEER. REPLACEMENT FRAMES AND LIDS WILL BE PAID FOR IN ACCORDANCE WITH ARTICLE 109,04 OF THE STANDARD SPECIFICATIONS UNLESS A SEPARATE PAY ITEM HAS BEEN PROVIDED.

IF THE EXISTING LIDS ARE OPEN, THE FRAME WILL BE ADJUSTED TO THE ELEVATION OF THE MILLED PAVEMENT SURFACE PRIOR TO THE MILLING OPERATION. THE FRAME WILL NOT BE REMOVED AND COVERED BY THE METAL PLATE.

CITY OF CHICAGO CASTINGS ARE THE PROPERTY OF THE CITY AND THE CONTRACTOR SHALL NOTIFY THE CITY FOR REMOVAL AND DISPOSITION OF THE CASTINGS.

THE METAL PLATE USED TO COVER THE STRUCTURE SHALL REMAIN THE PROPERTY OF THE CONTRACTOR.

WHEN STRUCTURES ARE TO BE ADJUSTED OR RECONSTRUCTED. THE LOWERING AND RAISING OF THE FRAMES AND LIDS WILL NOT BE PAID FOR SEPARATELY BUT WILL BE INCLUDED IN THE COST OF THE CORRESPONDING PAY ITEM.

CONSTRUCTION PROCEDURES

STAGE 1 (BEFORE PAVEMENT MILLING)

- A) REMOVE A MINIMUM OF 12 (300) OF THE PAVEMENT FROM AROUND THE STRUCTURE.
- B) REMOVE THE EXISTING FRAME AND LID FROM THE STRUCTURE.
- C) COVER THE STRUCTURE OPENING WITH A 36 (900) DIAMETER METAL PLATE.

 D) BACKFILL WITH CRUSHED STONE AND A MINIMUM 11/2 (40)
- D) BACKFILL WITH CRUSHED STONE AND A MINIMUM 11/2 (40) THICK HMA SURFACE MIX APPROVED BY THE ENGINEER.

STAGE 2 (AFTER PAVEMENT MILLING)

- A) REMOVE THE HMA SURFACE MIX AND CRUSHED STONE.
- B) INSTALL THE FRAME AND LID; ADJUST THE FRAME TO ITS FINAL SURFACE ELEVATION.
- C) THE SURROUNDING SPACE SHALL BE FILLED WITH CLASS PP-1*
 CONCRETE TO THE ELEVATION OF THE SURFACE OF THE EXISTING
 BASE COURSE OR THE BINDER COURSE.
- * UNLESS OTHERWISE SPECIFIED IN THE PLANS.

THE PROCEDURE EXPLAINED ABOVE SHALL CONFORM TO THE APPLICABLE PORTIONS OF SECTIONS 353, 406, 602, AND 603 OF THE STANDARD SPECIFICATIONS EXCEPT THAT "THE CONTRACTOR SHALL ADJUST THE STRUCTURES TO THE FINISHED PAVEMENT ELEVATION NO MORE THAN 5 CALENDAR DAYS PRIOR TO PLACEMENT OF THE FINAL LIFT OF SURFACE UNLESS APPROVED BY THE FINGINEFR."

LEGEND

- 1 SUB-BASE GRANULAR MATERIAL
- (6) FRAME AND LID (SEE NOTES)
- 2 EXISTING PAVEMENT

(5) EXISTING STRUCTURE

- (7) CLASS PP-1* CONCRETE
- 3 36 (900) DIAMETER METAL PLATE
- (8) PROPOSED HMA SURFACE COURSE
- PROPOSED CRUSHED STONE AND HMA SURFACE MIX
- (9) PROPOSED HMA BINDER COURSE

LOCATION OF STRUCTURES:

THE CONTRACTOR WILL BE REQUIRED TO KEEP A RECORD OF THE LOCATIONS OF THE BURIED STRUCTURES ACCORDING TO THE STATION AND DISTANCE LEFT OR RIGHT OF THE CENTERLINE OF PAYEMENT. UPON COMPLETION OF THE WORK, THE CONTRACTOR WILL DELIVER THE RECORD TO THE ENGINEER.

BASIS OF PAYMENT:

REMOVING FRAMES AND LIDS ON DRAINAGE AND UTILITY STRUCTURES IN THE PAVEMENT PRIOR TO MILLING, AND ADJUSTING TO FINAL GRADE PRIOR TO PLACING THE SURFACE COURSE, WILL BE PAID FOR AT THE CONTRACT UNIT PRICE EACH FOR "FRAMES AND LIDS TO BE ADJUSTED (SPECIAL)."

THIS WORK WILL NOT BE PAID FOR WHEN DRAINAGE AND UTILITY STRUCTURES ARE SPECIFIED FOR PAYMENT AS STRUCTURE RECONSTRUCTION.

NEW FRAMES AND LIDS, WHEN SPECIFIED, WILL BE PAID FOR SEPARATELY.


DETAILS FOR FRAMES AND LIDS ADJUSTMENT WITH MILLING

ALL DIMENSIONS ARE IN INCHES (MILLIMETERS) UNLESS OTHERWISE SHOWN

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	PLOT DATE = 3/23/2018	DATE - 10-25-94	REVISED - R. BORO 12-06-11

STATE OF ILLINOIS
DEPARTMENT OF TRANSPORTATION

	D	ETAILS FO	R		F.A.U. RTE.	
	FRAMES AND LIDS	AD HISTM	IENT WITH	MILLING	2846	(!
	THANKS AND LIDS	ADJUGIT	LIVI VVIIII			BD600
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| FED. ROAD DIST. NO. 1 | ILLINOIS | FED. AID PROJECT | NO. 62F81 | FED. ROAD DIST. NO. 1 | ILLINOIS | FED. AID PROJECT | NO. 62F81 | FED. ROAD DIST. NO. 1 | ILLINOIS | FED. AID PROJECT | NO. 62F81

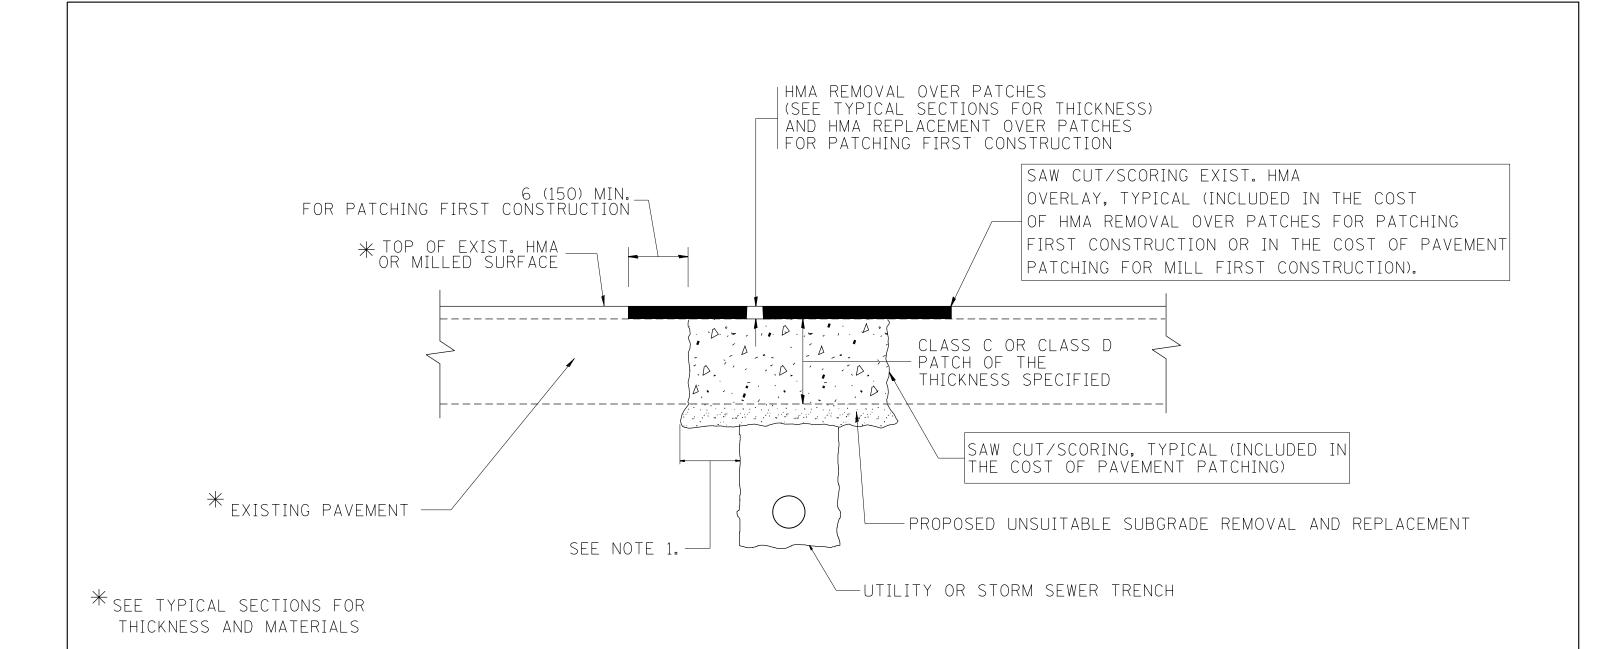
NOTES:

- 1. THE WIDTH OF THE FULL DEPTH PATCH OVER A TRENCH SHALL BE 12 (300) WIDER ON EACH SIDE OF THE TRENCH.
- 2. FOR METHOD OF MEASUREMENT AND BASIS OF PAYMENT, SEE RECURRING SPECIAL PROVISION "PATCHING WITH HOT-MIX ASPHALT OVERLAY REMOVAL".

SEQUENCE OF CONSTRUCTION (PATCHING FIRST)


- 1. REMOVE THE EXISTING HMA MATERIAL OVER THE AREA TO BE PATCHED.
- 2. REMOVE AND REPLACE WITH CLASS C OR D PATCH.
- 3. REPLACE HMA MATERIAL OVER THE AREA TO BE PATCHED.

SEQUENCE OF CONSTRUCTION (MILLING FIRST)

- 1. MILL HMA FIRST IF THERE IS AT LEAST 41/2 INCHES OR MORE OF HMA MATERIAL ON TOP OF THE EXISTING PAVEMENT OR IF THE PAVEMENT IS FULL DEPTH HMA. A MINIMUM OF 2 INCHES OF HMA MATERIAL SHALL BE IN PLACE AFTER MILLING.
- 2. REMOVE AND REPLACE WITH FULL DEPTH CLASS D PATCHES TO TOP OF MILLED SURFACE.

ALL DIMENSIONS ARE IN INCHES (MILLIMETERS) UNLESS OTHERWISE SHOWN.

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CURB OR CURB AND GUTTER REMOVAL AND REPLACEMENT

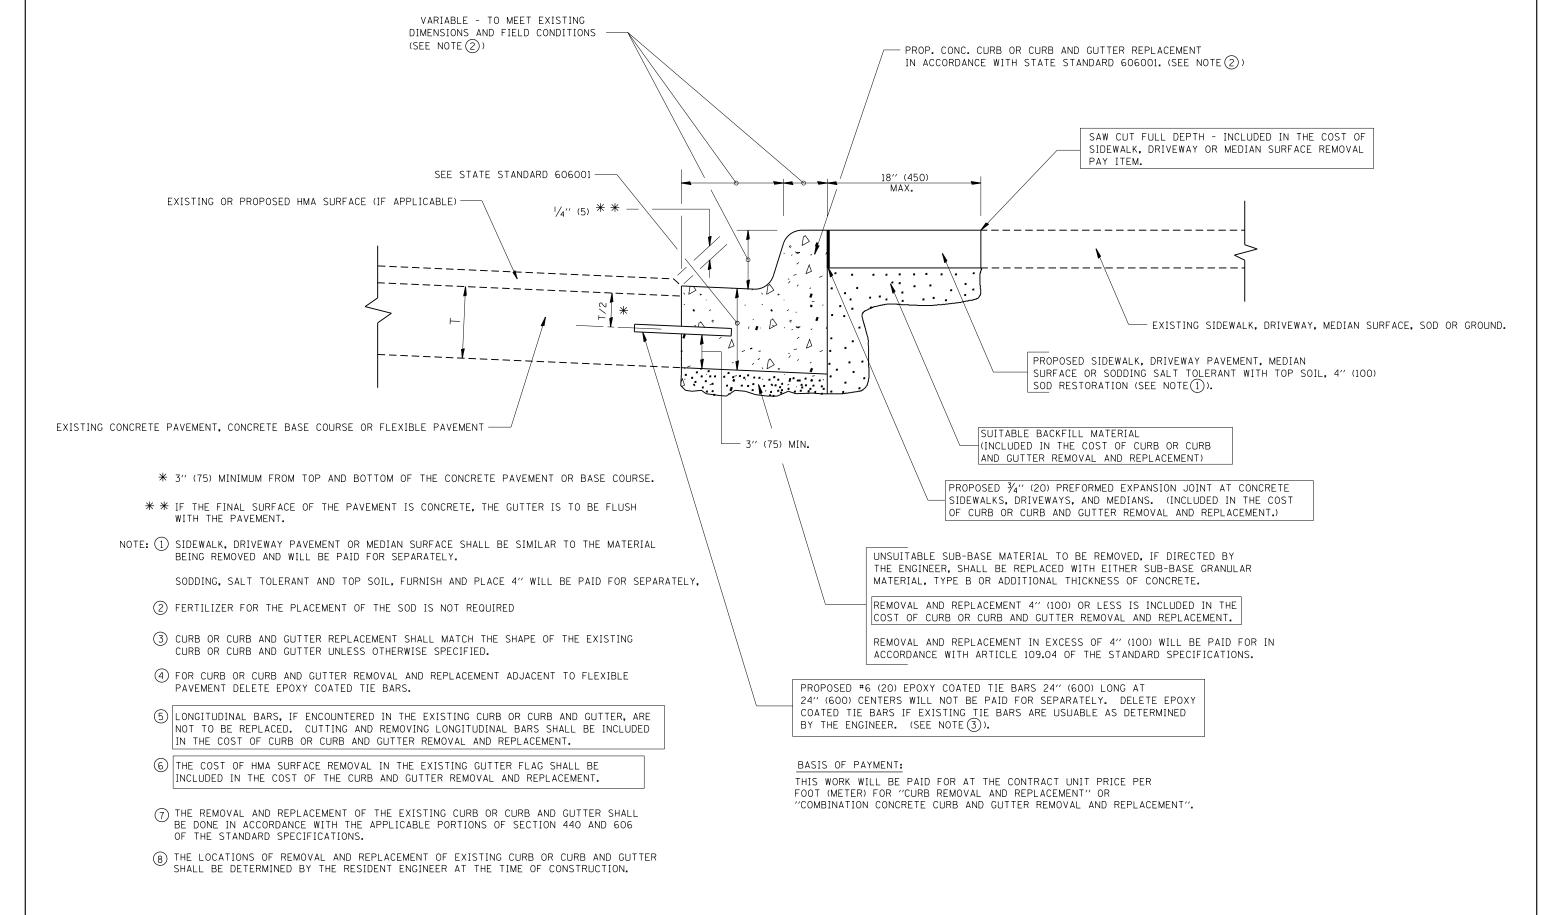
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ALL DIMENSIONS ARE IN INCHES (MILLIMETERS) UNLESS OTHERWISE SHOWN.


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	PLOT DATE = 3/23/2018	DATE - 03-11-94	REVISED - R. BORO 12-15-09	

ILLINOIS **TRANSPORTATION**

CURB OR CURB AND	GUTTER	F.A.U. RTE.	SECTION	COUNTY	TOTAL SHEETS	SHEET NO.
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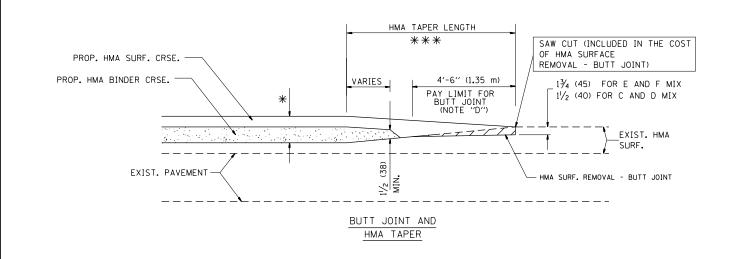


OPTION 1

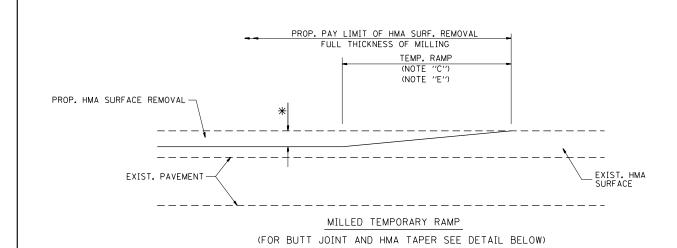

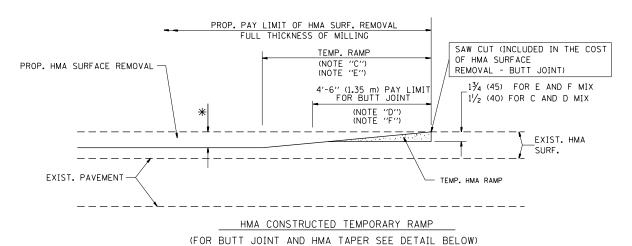
OPTION 2


TYPICAL TEMPORARY RAMP



TYPICAL BUTT JOINT AND HMA TAPER FOR MILLING AND RESURFACING

STATE OF ILLINOIS
DEPARTMENT OF TRANSPORTATION

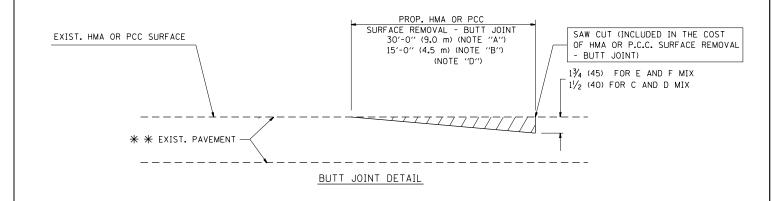

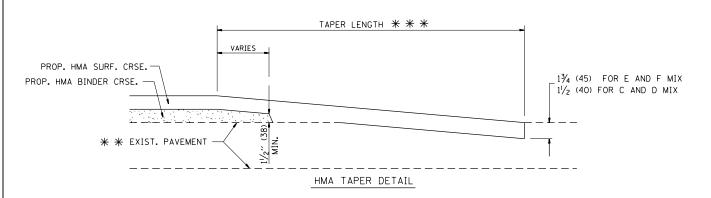

TYPICAL BUTT JOINT AND HMA TAPER FOR RESURFACING ONLY

* * PC CONCRETE, HMA OR HMA RESURFACED PAVEMENT.


NOTES

- A: MAINLINE ROADWAYS AND MAJOR SIDE ROADS.
- : MINOR SIDE ROADS.
- C: THE TEMP. RAMP SHALL BE CONSTRUCTED IMMEDIATELY UPON REMOVAL OF THE EXISTING HMA SURFACE.
- D: THE BUTT JOINT SHALL BE CONSTRUCTED IMMEDIATELY PRIOR TO PLACING THE PROPOSED HMA COURSES.
- E: TAPER THE TEMP. RAMP AT A RATE OF 3'-0" (900 mm) PER 1 INCH (25 mm) OF MILLING THICKNESS.
- F: INSTALLATION AND REMOVAL OF THE 4'-6" (1.35 m) TEMP. RAMP IS INCLUDED IN COST OF HMA SURFACE REMOVAL BUTT JOINT
- G: SEE ARTICLE 406.08 AND 406.14 OF THE STANDARD SPECIFICATIONS FOR "HMA AND/OR PCC SURFACE REMOVAL, BUTT JOINT".
- * SEE TYPICAL SECTIONS FOR MILLING THICKNESS.
- ** * 20'-0" (6.1 m) PER 1 (25) RESURFACING (NOTE "A") 10'-0" (3.0 m) PER 1 (25) RESURFACING (NOTE "B")

BASIS OF PAYMENT:

THE BUTT JOINT WILL BE PAID FOR AT THE CONTRACT UNIT PRICE PER SQUARE YARD (SQUARE METER) FOR "HOT-MIX ASPHALT SURFACE REMOVAL - BUTT JOINT" OR FOR "PORTLAND CEMENT CONCRETE SURFACE REMOVAL- BUTT JOINT".

ALL DIMENSIONS ARE IN INCHES (MILLIMETERS) UNLESS OTHERWISE SHOWN.

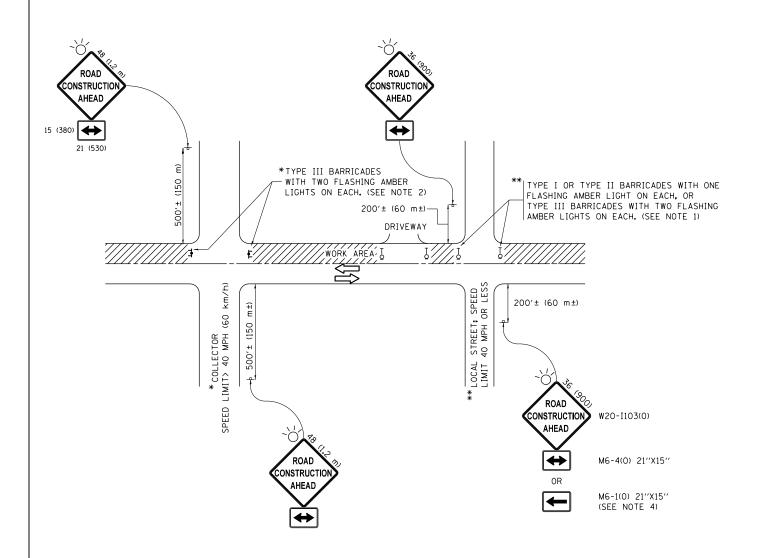

NOTES:

- SIDE ROAD WITH A SPEED LIMIT OF 40 MPH (60 km/h) OR LESS AS SHOWN ON THE DRAWING AND AS DIRECTED BY THE ENGINEER:
 - a) ONE "ROAD CONSTRUCTION AHEAD" SIGN 36 x 36 (900x900) WITH A FLASHER MOUNTED ON IT APPROXIMATELY 200" (60 m) IN ADVANCE OF THE MAIN ROUTE.
 - b) THE CLOSED PORTION OF THE MAIN ROUTE SHALL BE PROTECTED BY BLOCKING WITH TYPE I, TYPE II OR TYPE III BARRICADES, 1/3 OF THE CROSS SECTION OF THE CLOSED PORTION.
- 2. SIDE ROAD WITH A SPEED LIMIT GREATER THAN 40 MPH (60 km/h) AS SHOWN ON THE DRAWING AND AS DIRECTED BY THE ENGINEER:
 - a) ONE "ROAD CONSTRUCTION AHEAD" SIGN 48 x 48 (1.2 m x 1.2 m) WITH A FLASHER MOUNTED ON IT APPROXIMATELY 500" (150 m) IN ADVANCE OF THE MAIN ROUTE.
 - b) THE CLOSED PORTION OF THE MAIN ROUTE SHALL BE PROTECTED BY BLOCKING WITH TYPE III BARRICADES, 1/2 OF THE CROSS SECTION OF THE CLOSED PORTION.
- 3. CONES MAY BE SUBSTITUTED FOR BARRICADES OR DRUMS AT HALF THE SPACING DURING DAY OPERATIONS. CONES SHALL BE A MINIMUM OF 28 (710) IN HEICHT
- 4. WHEN THE SIDE ROAD LIES BETWEEN THE BEGINNING OF THE MAINLINE SIGNING AND THE WORK ZONE, A SINGLE HEADED ARROW (M6-1) SHALL BE USED IN LIEU OF THE DOUBLE HEADED ARROW (M6-4).

SCALE: NONE

- 5. WHEN WORK IS BEING PERFORMED ON A SIDE ROAD OR DRIVEWAY, FOLLOW THE APPLICABLE STANDARD(S). THE DIRECTIONAL ARROW (M6-1 OR M6-4) SHALL BE COVERED OR REMOVED WHEN NO LONGER CONSISTENT WITH THE TRAFFIC CONTROL SET-UP.
- 6. ADVANCE WARNING SIGNS ARE TO BE OMITTED ON DRIVEWAYS UNLESS OTHERWISE SPECIFIED IN THE PLANS OR BY THE ENGINFER.
- 7. THE TRAFFIC CONTROL AND PROTECTION FOR SIDE ROADS, INTERSECTIONS, AND DRIVEWAYS SHALL BE INCLUDED IN THE COST OF SPECIFIED TRAFFIC CONTROL STANDARDS OR ITEMS.


All dimensions are in inches (millimeters) unless otherwise shown.

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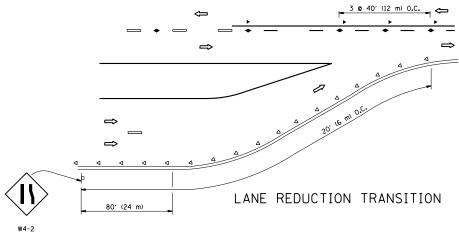
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ÇI	DE BUVDS	INT	FR	FCTIONS	: AND	DRIVEWAYS	2846	
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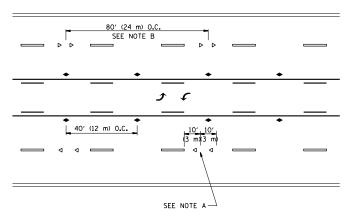
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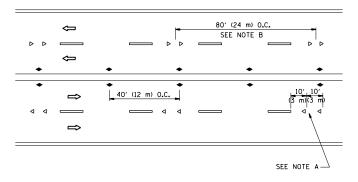
*** REDUCE TO 40' (12 m) O.C. ON CURVES WITH POSTED OR ADVISORY SPEED 45 M.P.H. (70 km/h) OR LESS.

TWO-LANE/TWO-WAY




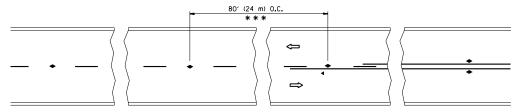

TWO-WAY LEFT TURN



MULTI-LANE/UNDIVIDED

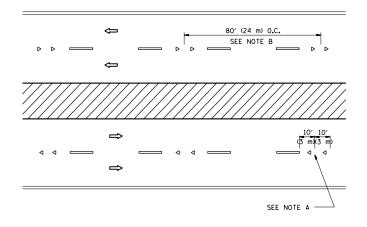

MULTI-LANE/DIVIDED

GENERAL NOTES

- MARKERS USED WITH DASHED LINES SHALL BE CENTERED IN THE GAP BETWEEN SEGMENTS.
- 2. MARKERS USED ADJACENT TO SOLID LINES SHALL BE OFFSET 2 TO 3 (50 TO 75) TOWARD TRAFFIC AS SHOWN.
- 3. MARKERS THROUGH TANGENTS LESS THAN 500' (150 m) IN LENGTH BETWEEN CURVES SHALL BE INSTALLED AT THE LESSER OF THE TWO CURVE SPACINGS.

LANE MARKER NOTES

A. USE DOUBLE LANE LINE MARKERS SPACED AS SHOWN.

B. REDUCE TO 40' (12 m) O.C. ON CURVES WHERE ADVISORY SPEEDS ARE 10 M.P.H (20 km/h) LOWER THAN POSTED SPEEDS.

SYMBOLS

---- YELLOW STRIPE

WHITE STRIPE

- ONE-WAY AMBER MARKER
- ONE-WAY CRYSTAL MARKER (₩/O)
- ◆ TWO-WAY AMBER MARKER


DESIGN NOTES

- 1. DOUBLE LANE LINE MARKERS SHALL BE USED UNLESS SPECIFIED OTHERWISE.
- 2. EXCEPT AS SHOWN ON THE LANE REDUCTION TRANSITION AND FREEWAY EXIT RAMP DETAIL, MARKERS ARE NOT TO BE SPECIFIED ON RIGHT EDGE LINES.
- 3. THE EXACT MARKER LIMITS, SPACING, AND COLOR SHALL BE INCLUDED IN THE PLANS WHEN STANDARD SPECIFICATIONS ARE NOT BEING USED.
- 4. MARKERS SHOULD NOT BE USED ALONGSIDE CURBS EXCEPT FOR EXTREMELY SHORT SECTIONS OF CURBS WHERE NOT MORE THAN TWO MARKERS WOULD BE INVOLVED.


LEFT TURN

All dimensions are in inches (millimeters) unless otherwise shown.

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TYPICAL LANE AND EDGE LINE MARKING

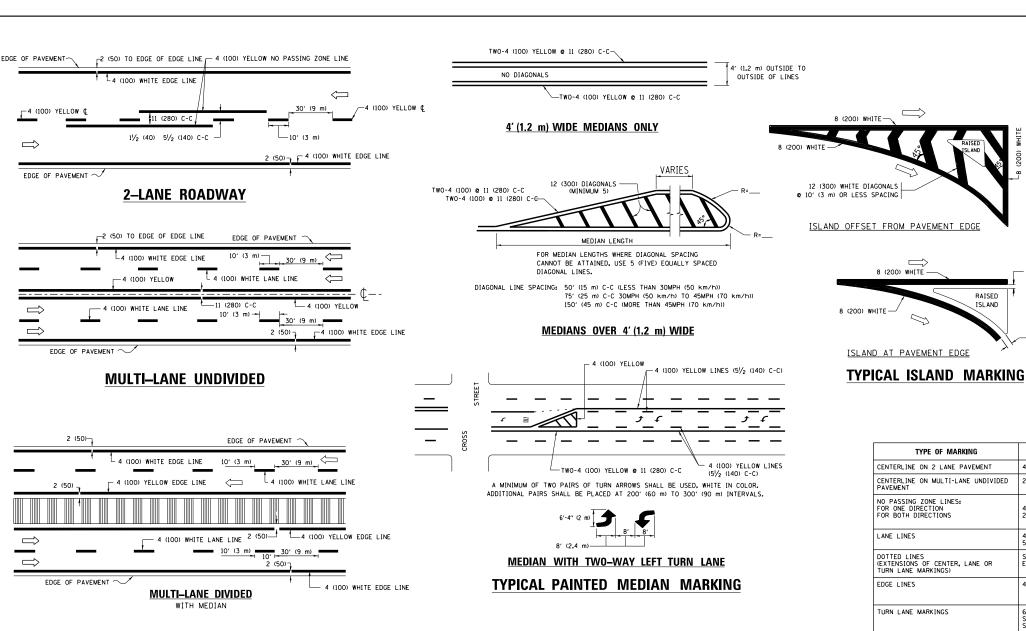

TYPICAL CROSSWALK MARKING

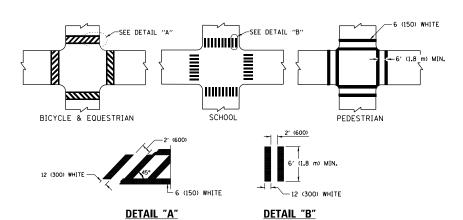CHECKED

DATE

* MARKINGS SHALL BE INSTALLED PARALLEL TO THE CENTERLINE OF THE ROAD WHICH IT CROSSES

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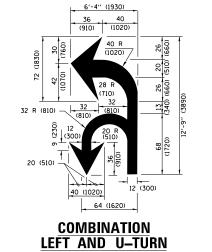
−50′ (15 m) TO 200′ (60 m) ** OVER 200' (60 m) ____ 6 (150) WHITE


FULL SIZE LETTERS 8' (2.4 m) AND ARROWS SHALL BE USED. AREA = 15.6 SO. FT. (1.5 m²) ONLY AREA = 20.8 SO. FT. (1.9 m²)

* TURN LANES IN EXCESS OF 400' (120 m) IN LENGTH MAY HAVE AN ADDITIONAL SET OF ARROW - "ONLY" INSTALLED MIDWAY BETWEEN THE OTHER TWO SETS OF ARROW - "ONLY".

TYPICAL LEFT (OR RIGHT) TURN LANE

TYPICAL TURN LANE MARKING



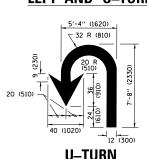

— 2 (50)

2 (50)

RAISED

ISLAND

8 (200) WHITE -

665 50 750 55 **−20**′

D(FT)

345

425

500

580

SPEED LIMIT

30

35

45

LANE REDUCTION TRANSITION

* LANE REDUCTION ARROWS REQUIRED AT SPEEDS OF 45 MPH OR GREATER OR WHEN SPECIFIED IN PLANS.

TYPE OF MARKING	WIDTH OF LINE	PATTERN	COLOR	SPACING /REMARKS
CENTERLINE ON 2 LANE PAVEMENT	4 (100)	SKIP-DASH	YELLOW	10' (3 m) LINE WITH 30' (9 m) SPACE
CENTERLINE ON MULTI-LANE UNDIVIDED PAVEMENT	2 @ 4 (100)	SOLID	YELLOW	11 (280) C-C
NO PASSING ZONE LINES: FOR ONE DIRECTION FOR BOTH DIRECTIONS	4 (100) 2 @ 4 (100)	SOLID SOLID	YELLOW YELLOW	5½ (140) C-C FROM SKIP-DASH CENTERLINE 11 (280) C-C OMIT SKIP-DASH CENTERLINE BETWEEN
LANE LINES	4 (100) 5 (125) ON FREEWAYS	SKIP-DASH SKIP-DASH	WHITE WHITE	10' (3 m) LINE WITH 30' (9 m) SPACE
DOTTED LINES (EXTENSIONS OF CENTER, LANE OR TURN LANE MARKINGS)	SAME AS LINE BEING EXTENDED	SKIP-DASH	SAME AS LINE BEING EXTENDED	2' (600) LINE WITH 6' (1.8 m) SPACE
EDGE LINES	4 (100)	SOLID	YELLOW-LEFT WHITE-RIGHT	OUTLINE MEDIANS IN YELLOW
TURN LANE MARKINGS	6 (150) LINE; FULL SIZE LETTERS & SYMBOLS (8' (2.4m))	SOLID	WHITE	SEE TYPICAL TURN LANE MARKING DETAIL
TWO WAY LEFT TURN MARKING	2 @ 4 (100) EACH DIRECTION 8' (2.4m) LEFT ARROW	SKIP-DASH AND SOLID IN PAIRS	YELLOW WHITE	10' (3 m) LINE WITH 30' (9 m) SPACE FOR SKIP-DASH, 5½ (140) C-C BETWEEN SOLID LINE AND SKIP-DASH LINE SEE TYPICAL TWO-WAY LEFT TURN MARKING DETAIL
CROSSWALK LINES (PEDESTRIAN) A. DIAGONALS (BIKE & EOUESTRIAN) B. LONGITUDINAL BARS (SCHOOL)	2 @ 6 (150) 12 (300) @ 45° 12 (300) @ 90°	SOLID SOLID SOLID	WHITE WHITE WHITE	NOT LESS THAN 6' (1,8 m) APART 2' (600) APART 2' (600) APART 5EE TYPICAL CROSSWALK MARKING DETAILS.
STOP LINES	24 (600)	SOLID	WHITE	PLACE 4' (1.2 m) IN ADVANCE OF AND PARALLEL TO CROSSMALK, IF PRESENT. OTHERWISE, PLACE AT DESIRED STOPPING POINT. PARALLEL TO CROSSROAD CENTERLINE, WHERE POSSIBLE
PAINTED MEDIANS	2 @ 4 (100) WITH 12 (300) DIAGONALS @ 45° NO DIAGONALS USED FOR 4' (1.2 m) WIDE MEDIANS	SOLID	YELLOW: TWO WAY TRAFFIC WHITE: ONE WAY TRAFFIC	11 (280) C-C FOR THE DOUBLE LINE SEE TYPICAL PAINTED MEDIAN MARKING.
GORE MARKING AND CHANNELIZING LINES	8 (200) WITH 12 (300) DIAGONALS @ 45°	SOLID	WHITE	DIAGONALS: 15' (4,5 m) C-C (LESS THAN 30MPH (50 km/h)) 20' (6 m) C-C 30MPH (50 km/h) TO 45MPH (70 km/h)) 30' (9 m) C-C (OVER 45MPH (70 km/h))
RAILROAD CROSSING	24 (600) TRANSVERSE LINES; "RR" IS 6' (1.8 m) LETTERS; 16 (400) LINE FOR "X"	SOLID	WHITE	SEE STATE STANDARD 780001 AREA OF: "R"=3.6 SO. FT. (0.33 m²) EACH "X"=54.0 SO. FT. (5.0 m²)
SHOULDER DIAGONALS (REQUIRED FOR SHOULDERS > 8')	12 (300) © 45°	SOLID	WHITE - RIGHT YELLOW - LEFT	50' (15 m) C-C (LESS THAN 30MPH (50 km/h)) 75' (25 m) C-C (30 MPH (50 km/h) TO 45MPH (70 km/h 150' (45 m) C-C (OVER 45MPH (70 km/h))
U TURN ARROW	SEE DETAIL	SOLID	WHITE	16.3 SF
2 ARROW COMBINATION LEFT AND U TURN	SEE DETAIL	SOLID	WHITE	30.4 SF

FOR FURTHER DETAILS ON PAVEMENT MARKING REFER TO STANDARD SPECIFICATIONS FOR ROAD AND BRIDGE CONSTRUCTION AND STATE STANDARD 780001.

All dimensions are in inches (millimeters) unless otherwise shown.

DESIGNED - EVERS REVISED - C. JUCIUS 09-09-09 uments\IDOT_Offices\District_1\Projects\D121**01BROAWIN**ata\Design\DistStd.dgn REVISED -C. JUCIUS 07-01-13 REVISED C. JUCIUS 12-21-15 REVISED - C. JUCIUS 04-12-16 03-19-90

STA DEPARTMEN[®]

	DISTRICT ONE						SECTION	COUNTY	TOTAL SHEETS	SHEET NO.
	TVDI	CAI DA	VEMENT	MARKING	:e	2846	(55-1414R)RS-1	соок	30	26
		UAL IA				TC-13	CONTRACT NO. 62F81			
JE.	SHEET 1	OF 1	SHEETS	STA	TO STA		THE THOSE FED. A	ID DDO IECT		-

TATE OF HAMOIO	DISTRICT ONE							SECTION	COUNTY	TOTAL SHEETS	SHEE NO.
	TYPICAL PAVEMENT MARKINGS					2846	(55-1414R)RS-1	COOK	30	26	
ATE OF ILLINOIS NT OF TRANSPORTATION			/AL I AV					TC-13	CONTRACT	NO. 6	2F81
	SCALE: NONE	SHEET 1	OF 1	SHEETS	STA.	TO STA.		ILLINOIS FED. AI	D PROJECT		

TURN BAY ENTRANCE AT START OF LANE CLOSURE TAPER


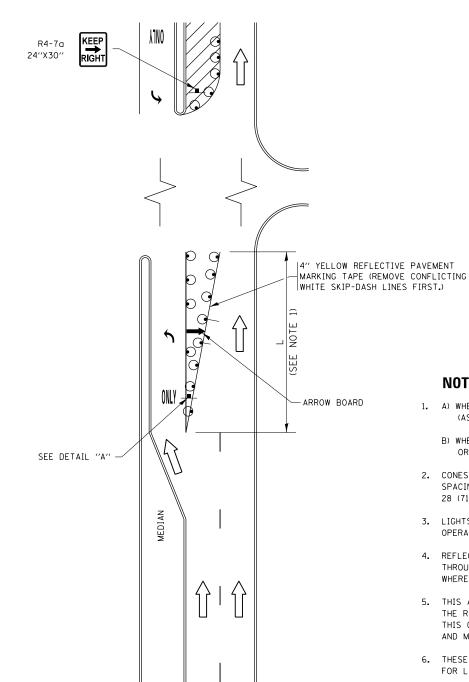


FIGURE 1


CONFLICTING |

PAVEMENT MARKING REMOVAL (TYP.)

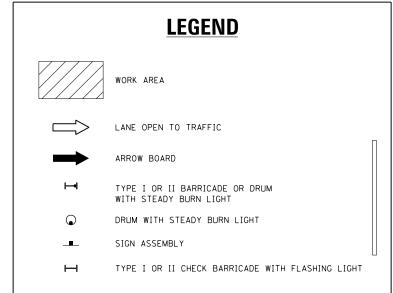


NOTES:

- 1. A) WHEN "L" IS < THE STORAGE LENGTH OF THE TURN LANE (AS SHOWN IN FIG. 1), USE FIGURE 1.
 - B) WHEN "L" IS > THE STORAGE LENGTH OF THE TURN LANE OR THE TURN LANE IS WITHIN THE LANE CLOSURE, USE FIGURE 2.
- 2. CONES MAY BE SUBSTITUTED FOR BARRICADES OR DRUMS AT HALF THE SPACING DURING DAY OPERATIONS. CONES SHALL BE A MINIMUM OF 28 (710) IN HEIGHT.
- 3. LIGHTS WILL NOT BE REQUIRED ON BARRICADES OR DRUMS FOR DAY OPERATIONS. ALL LIGHTS SHALL BE MONODIRECTIONAL.
- 4. REFLECTIVE TEMPORARY PAVEMENT MARKINGS SHALL BE PLACED THROUGHOUT THE BARRICADED AREAS OF EACH TURN BAY AS SHOWN WHERE THE CLOSURE TIME IS GREATER THAN FOURTEEN (14) DAYS.
- 5. THIS APPLICATION ALSO APPLIES WHEN WORK IS BEING PERFORMED IN THE RIGHT LANE(S) AND THE RIGHT TURN BAY IS TO REMAIN OPEN. UNDER THIS CONDITION, "RIGHT TURN LANE" R3-I100R 24 x 24 (600 x 600) AND M6-2R 21 \times 15 (530 \times 380) SHALL BE USED.
- 6. THESE CONTROLS SHALL SUPPLEMENT MAINLINE TRAFFIC CONTROL FOR LANE CLOSURES.
- 7. THE SIGNS SHALL BE MOUNTED ABOVE THE BARRICADES/DRUMS ON SEPARATE SIGN SUPPORTS THAT MEET NCHRP 350 OR MASH PREQUIREMENTS.
- 8. TRAFFIC CONTROL AND PROTECTION AT TURN BAYS (TO REMAIN OPEN TO TRAFFIC) SHALL BE INCLUDED IN THE COST OF SPECIFIED TRAFFIC CONTROL STANDARDS OR ITEMS.

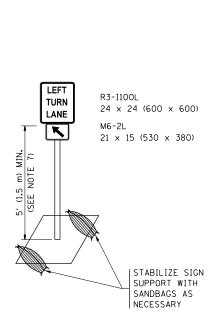

TURN BAY ENTRANCE WITHIN A LANE CLOSURE

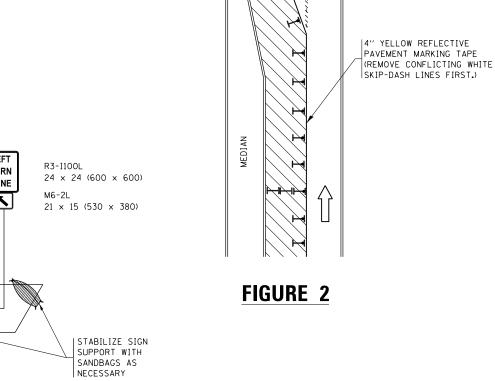

DETAIL A

All dimensions are in inches (millimeters) unless otherwise shown.

COUNTY TOTAL SHEETS NO. COOK 30 27

CONTRACT NO. 62F81

SEE DETAIL "A"


6" WHITE REFLECTIVE

PAVEMENT MARKING TAPE

ı	- AND GOVERNMENT OF THE PROPERTY DE	cuments\IDOT Offices\District 1\Projects\D121		_	RAMMACHER					
	DM: / /IERO4EBIDIM / EG:IIIInois: dov: LMIDO / / / /	puments\ibu Uffices\District i\rrojects\Dizi	DID ECHIDADO	\Desig	au / Mrs sanonadu	11-07-35	KE A12ED	- A.	SCHUE I ZE	01-01-13
ı		PLOT SCALE = 100.0000 ' / in.	REVISED	-	A. HOUSEH	10-12-96	REVISED	- A.	SCHUETZE	09-15-16
	Default	PLOT DATE = 3/23/2018	REVISED	- T.	RAMMACHER	01-06-00	REVISED	-		


STATE OF ILLINOIS **DEPARTMENT OF TRANSPORTATION**

TRAFI	FIC CONT	ROL AND	PROTEC	CTION A	AT TURN BAYS	F.A.U. RTE.	SECTION	
	(TO REMAIN OPEN TO TRAFFIC)							
	TC-14							
SCALE: NONE	SHEET 1	OF 1	SHEETS	STA.	TO STA.		ILLINOIS FED.	

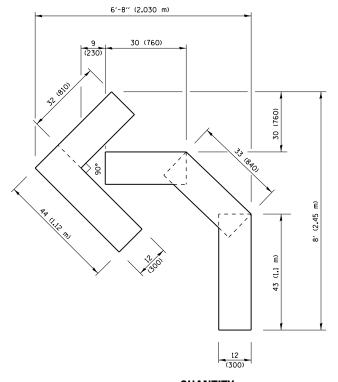


QUANTITY

4 (100) LINE = 45.5 ft. (13.9 m) 15.2 sq. ft. (1.41 sq. m)

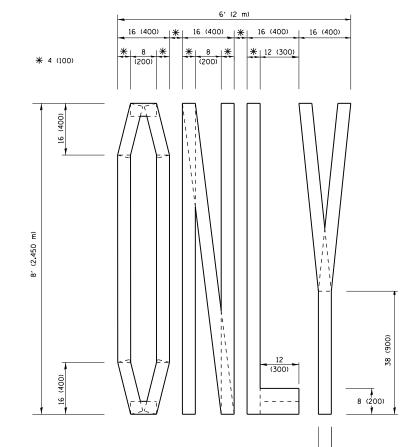

4 (100) LINE = 64.1 ft. (19.5 m) 21.4 sq. ft. (1.99 sq. m)

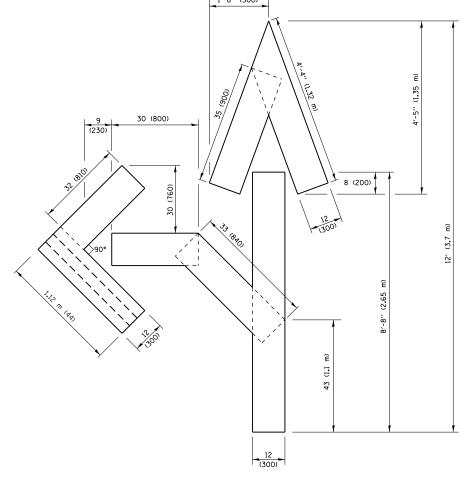


QUANTITY

4 (100) LINE = 82.5 ft. (25.1 m) 27.5 sq. ft. (2.53 sq. m)

NOTE:

ALL QUANTITIES OF PLACEMENT ARE REPRESENTED IN LINEAR FEET OF 4" LINES TO MATCH THE 4" TEMPORARY TAPE PAY ITEM AND REPRESENTS THE TOTAL QUANTITY OF 4" TAPE REQUIRED.

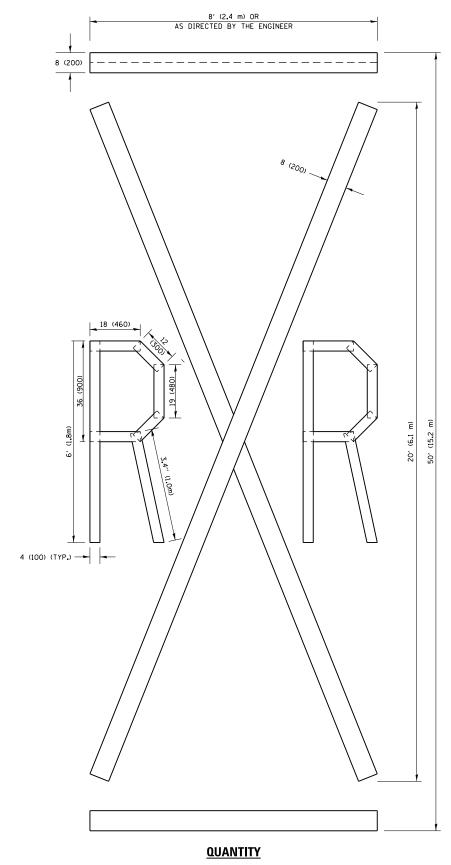

4 (100) LINE = 225.9 ft. (68.9 m) 75.3 sq. ft. (6.99 sq. m)


All dimensions are in inches (millimeters) unless otherwise shown.

FILE NAME =	USER NAME = hassann	DESIGNED -	REVISED	-T. RAMMACHER 03-02-98
pw:\\IL084EBIDINTEG.:1ll:no:s.gov:PWIDOT\Do	cuments\IDOT Offices\District 1\Projects\D121	01 97 CAWNata\Design\DistStd.dgn	REVISED	-E. GOMEZ 08-28-00
	PLOT SCALE = 100.0000 ' / in.	CHECKED -	REVISED	-E. GOMEZ 08-28-00
	PLOT DATE = 3/23/2018	DATE - 09-18-94	REVISED	- A. SCHUETZE 09-15-16

QUANTITY

STATE OF ILLINOIS
DEPARTMENT OF TRANSPORTATION

CHORT TERM DANGMENT MADRING LETTERS AND SYMPOLO				F.A.U. RTE.	SECTION	COUNTY	TOTAL SHEETS	SHEET NO.	
SHORT TERM PAVEMENT MARKING LETTERS AND SYMBOLS						(55-1414R)RS-1	COOK	30	28
		TC-16 CONTRACT NO.				2F81			
SCALE: NONE SHEET NO. 1 OF 1 SHEETS STA. TO STA. FED. 1					FFD. R	OAD DIST, NO. 1 ILLINOIS FED. AL	D PROJECT		

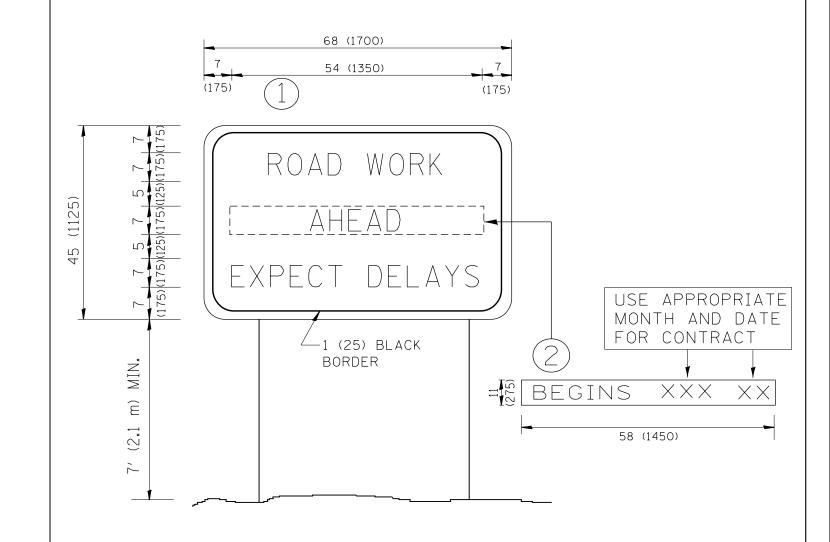

NOTES:

- 1. USE BLACK LETTERING ON ORANGE BACKGROUND.
- 2. ERECT SIGNS IN ADVANCE OF THE LOCATION FOR THE "ROAD CONSTRUCTION AHEAD" SIGN AT LOCATIONS AS DIRECTED BY THE ENGINEER.
- 3. ERECT SIGN (1) WITH INSTALLED PANEL (2) ONE WEEK PRIOR TO THE START OF CONSTRUCTION.
- 4. REMOVE PANEL (2) SOON AFTER THE START OF CONSTRUCTION.
- 5. SEE SPECIAL PROVISION FOR "TEMPORARY INFORMATION SIGNING" FOR ADDITIONAL INFORMATION.
- 6. ONE SIGN ASSEMBLY EQUALS 25.70 SQ. FT. (2.3 SQ. M.)
- 7. SHALL BE PAID FOR AS TEMPORARY INFORMATION SIGNING.

ALL DIMENSIONS ARE IN INCHES (MILLIMETERS) UNLESS OTHERWISE SHOWN.

-	FILE NAME =	USER NAME = hassann	DESIGNED -	REVISED - R. MIRS 09-15-97			ARTERIAL ROA	۸n		F.A.U.	SECTION	COUNTY	CHEETS	SHEET
- -	pw:\\IL084EBIDINTEG.illinois.gov:PWIDOT\Documents\IDOT Offices\District 1\Projects\D12101BRXWNoto\Design\DistStd.dgn		REVISED - R. MIRS 12-11-97	STATE OF ILLINOIS	INFORMATION SIGN			2846	(55-1414R)RS-1	соок	30	29		
		PLOT SCALE = 100.0000 '/ in.	CHECKED -	REVISED -T. RAMMACHER 02-02-9	DEPARTMENT OF TRANSPORTATION	INFORMATION SIGN					TC-22	CONTRACT	NO. 6	2F81
		PLOT DATE = 3/23/2018	DATE -	REVISED - C. JUCIUS 01-31-07		SCALE: NONE	SHEET NO. 1 OF 1 SHEETS	STA. TO	STA.	FED. ROAD	DIST. NO. 1 ILLINOIS FED.	AID PROJECT		

LOOPS NEXT TO SHOULDERS PROVIDE A PAVEMENT REPLACEMENT NOTE WHICH SHOULD EQUAL 3' (900 mm) X WIDTH OF PAVED SHOULDER. PAVED OR NON-PAVED SHOULDER Ê (1.5 m) (1.8 m) (1.5 m) 1" (25 mm) UNI DUCT-TRENCHED TO E/P •• (3.0 m) (3.0 m) * = (600 mm)* * UNIT DUCT IS TO BE SHOWN ON PLAN SHEETS BUT SHALL NOT BE INCLUDED IN THE PAY ITEMS.

LEFT TURN LANES WITH MEDIANS VOLUME DENSITY ("FAR OUT" DETECTION) ON SAME APPROACH (PROTECTED / PERMITTED LEFT TURN PHASING) HANDHOLE LOCATION MAY HANDHOLE LOCATION MAY VARY DEPENDING ON GEOMETRICS AND DESIGN OF TRAFFIC SIGNALS. HEAVY-DUTY HANDHOLES TO BE USED WHEN THE MEDIAN IS MOUNTABLE. REFER TO STANDARD BLADOL TO ENESURE THAT WARRING! 814001 TO ENSURE THAT HANDHOLE TRENCHED 1" (25 mm) UNIT DUCT (3) * * * = (600 mm) STRAIGHT SAW CUTS PERPENDICULAR TO MEDIAN (TYP.) (3.6 m)

** UNIT DUCT IS TO BE SHOWN ON PLAN SHEETS

NOTE: DUAL LEFT TURNS NOT SHOWN REFER TO


BUT SHALL NOT BE INCLUDED IN THE PAY ITEMS.


PLAN SHEET FOR DETECTOR LOOP REPLACEMENT

(900 mm)

LEFT TURN LANES WITHOUT MEDIANS VOLUME DENSITY ("FAR OUT" DETECTION) ON SAME APPROACH (PROTECTED / PERMITTED LEFT TURN PHASING) * = (600 mm) (900 m (1.8 m) (3.6 m |STRAIGHT SAW CUT TO HEAVY DUTY HANDHOLE (TYP.) PLACE HEAVY DUTY HANDHOLE BETWEEN FIRST AND SECOND LOOP AS SHOWN. NOTE: DUAL LEFT TURNS NOT SHOWN REFER TO PLAN SHEET FOR DETECTOR LOOP REPLACEMENT

ARTERIAL-VOLUME DENSITY ("FAR OUT" DETECTION) CROSS STREET-NON VOLUME DENSITY ("UPTIGHT" PRESENCE DETECTION)

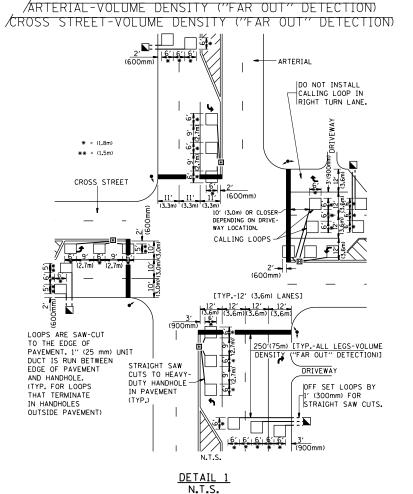

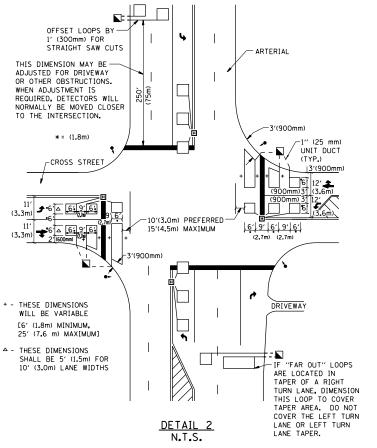

SCALE: NONE

NOTES:

VEHICLES LOOP DETECTORS

- * ALL LEAD IN CABLE SHALL BE TWO CONDUCTOR NO. 14 TWISTED,
- * EACH DETECTOR LOOP SHALL HAVE ITS OWN SAW CUT FROM THE LOOP TO THE EDGE OF PAVEMENT OR TO A HANDHOLE IN THE
- * EACH DETECTOR LOOP SHALL HAVE ITS OWN ONE INCH (25 mm) UNIT DUCT BETWEEN THE EDGE OF PAVEMENT AND THE FIRST HANDHOLE OR JUNCTION BOX. EACH UNIT DUCT RUN SHALL BE SHOWN ON THE PLANS BY THE DESIGNER, BUT SHALL NOT BE PAID FOR SEPARATLY. THIS ITEM IS INCIDENTAL TO THE PAY ITEM FOR DETECTOR LOOPS.
- * ONE DIMENSION OF ALL DETECTOR LOOPS SHALL BE SIX FEET (1.8 m)
- * EACH LANE OF NON-LOCKING, PRESENCE DETECTION AND EACH LANE OF A DOUBLE LEFT TURN LANE REQUIRES A SEPARATE INDUCTIVE LOOP DETECTOR AND LEAD IN CABLE.
- * WHEN NON-LOCKING, PRESENCE DETECTION IS USED, MORE THAN ONE LOOP PER LANE IS REQUIRED BEHIND THE STOP BAR (i.e. 1-1/2, 1-3/4, 2).
- * WHEN SYSTEM LOOPS ARE REQUIRED ON AN APPROACH OF AN INTERSECTION, THE LOOPS USED FOR VOLUME DENSITY AND INTERSECTION TIMING SHALL ALSO BE USED AS SYSTEM DETECTORS. EACH ONE OF THESE TYPE OF LOOPS REQUIRES A SEPARATE TWO CONDUCTOR NO. 14 TWISTED SHIELDED CABLE AND A SEPARATE INDUCTIVE LOOP DETECTOR WHEN NEW CONTROLLERS ARE UTILIZED. THE DESIGNER SHALL LABEL THESE TYPES OF LOOPS AS "INTERSECTION AND SAMPLING (SYSTEM) DETECTORS" ON THE SIGNAL LAYOUT, THE INTERCONNECT PLAN AND THE SYSTEM CABLE PLAN. WHEN AN EXISTING CONTROLLER IS UTILIZED FOR THIS TYPE OF DETECTION, THE PAY ITEM "INDUCTIVE LOOP DETECTOR WITH SYSTEM OUTPUT" SHOULD BE USED.

PLACEMENT OF DETECTORS

THE FOLLOWING FIGURES REPRESENT THE MOST COMMON DETECTOR LOOP LOCATIONS AND SIZES. ADJUSTMENTS WILL BE NECESSARY FOR SPECIFIC GEOMETRIC CONSIDERATIONS.

LOCATIONS AND DEMENSIONS OF DETECTOR LOOPS ARE REQUIRED ON ALL SIGNAL LAYOUT PLAN SHEETS.

"FAR OUT" DETECTION REFERS TO LOCKING, PRESENCE TYPE DETECTION LOCATED IN THRU LANES, RIGHT TURN LANES, AND RIGHT TURN LANE TAPER AREAS (IF APPLICABLE), USUALLY 250' (75 m) IN ADVANCE OF STOP BARS. "UPTIGHT" DETECTION REFERS TO NON-LOCKING PRESENCE TYPE DETECTION LOCATED IN ALL LANES AND 10'-15' (3.0 m-4.5 m) BEHIND THE CROSSING STREET'S EDGE OF PAVEMENT EXTENDED.

ALL DETAILS AND NOTES SHOWN ARE FROM THE I.D.O.T. DISTRICT 1 TRAFFIC SIGNAL DESIGN GUIDELINES DATED JANUARY 1995

THIS DRAWING HAS BEEN PREPARED TO ASSIST THE RESIDENT ENGINEER FOR ALL ROADWAY RESURFACING OR S.M.A.R.T. PROJECTS WHERE THE DIMENSIONS ARE NOT SHOWN ON THE PLANS AND THE FINAL LOCATIONS FOR CROSSWALKS OR STOP BARS ARE NOT DETERMINED.

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	PLOT DATE = 3/23/2018	DATE -	REVISED -

STATE OF ILLINOIS **DEPARTMENT OF TRANSPORTATION**

DISTRICT 1	– DE	TECTOR L	OOP INSTA	LLATION	F.A.U. RTE.	SECTION	COUNTY TOTAL SHEETS		SHEET NO.		
DETAIL	ENE	DOADWA	AY RESURF	A C INIC	2846	(55-1414R)RS-1	соок	30	30		
DETAIL	· rur	1 NUMBER	AI NESUNI	ACIIVO		TS-07	CONTRACT NO. 62F81				
SHEET NO. 1 O	F 1	SHEETS	STA.	TO STA.	FED. RO	FED. ROAD DIST. NO. 1 ILLINOIS FED. AID PROJECT					