06-16-2017 LETTING ITEM 086

FOR INDEX OF SHEETS, SEE SHEET NO. 2

THIS PROJECT IS LOCATED IN

9,500

THE CITY OF CHICAGO

POSTED SPEED: 30 MPH

2014 ADT:

STATE OF ILLINOIS


DEPARTMENT OF TRANSPORTATION

X 20+9 = 29 TOTAL PAGES

PROPOSED HIGHWAY PLANS F.A.U. ROUTE 1541 (76th STREET) ST. LAWRENCE AVE. TO DREXEL AVE.

SECTION 2016-079RS
PROJECT STP-1541(002)
RESURFACING (3P), PEDESTRIAN RAMPS (ADA)
COOK COUNTY

C-91-070-17

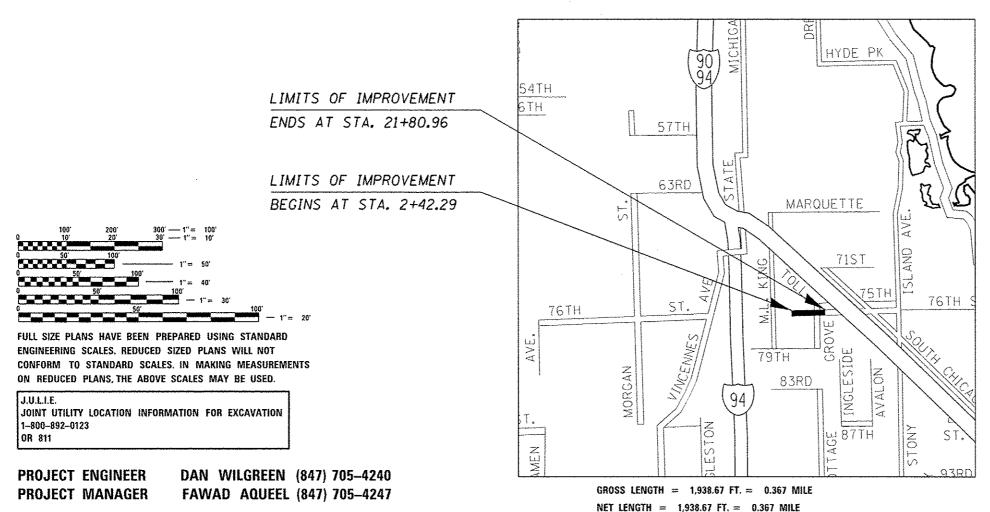

CARROLL

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PRINTED BY THE AUTHORITY OF THE STATE OF ILLINOIS

CONTRACT NO. 62D61

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INDEX OF SHEETS

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HIGHWAY STANDARDS

<u>Standards</u>

000001-06	STANDARD SYBMOLS, ABBREVIATIONS, AND PATTERNS
280001-07	TEMPORARY EROSION CONTROL SYSTEMS
424001-09	PERPENDICULAR CURB RAMPS FOR SIDEWALKS
424016-03	MID-BLOCK CURB RAMPS FOR SIDEWALKS
424021-03	DEPRESSED CORNER FOR SIDWALKS
424026-01	ENTERANCE / ALLEY PEDESTRIAN CROSSINGS
442201-03	CLASS C AND D PATCHES
604001-04	FRAME AND LIDS TYPE 1
606001-06	CONCRETE CURB TYPE B AND COMBINATION CONCRETE CURB AND GUTTER
701001-02	OFF-RD OPERATIONS, 2L, 2W, MORE THAN 15' AWAY
701006-05	OFF-RD OPERATIONS, 2L, 2W, 15' TO 24" FROM PAVEMENT EDGE
701101-05	OFF-RD OPERATIONS, MULTILANE, 15' TO 24" FROM PAVEMENT EDGE
701301-04	LANE CLOSURE, 2L. 2W. SHORT TIME OPERATIONS
701311-03	LANE CLOSURE 2L. 2W MOVING OPERATIONS- DAY ONLY
701501-06	URBAN LANE CLOSURE, 2L. 2W. UNDIVIDED
701801-06	SIDEWALK, CORNER, OR CROSSWALK CLOSURE
701901-06	TRAFFIC CONTROL DEVICES

CITY OF CHICAGO NOTES

- BEFORE STARTING ANY EXCAVATION, THE CONTRACTOR SHALL CALL "C.U.A.N." (CHICAGO UTILITY ALERT NETWORK) AT (312) 744-7000 FOR FIELD LOCATIONS OF BURIED ELECTRIC. TELEPHONE AND GAS UTILITIES. (48 HOUR NOTIFICATION REQUIRED).
- THE CONTRACTOR SHALL COORDINATE CONSTRUCTION ACTIVITIES WITH UTILITY COMPANIES AND THE CITY OF CHICAGO.
- (3) ALL CATCH BASINS IN THE CITY OF CHICAGO MUST MEET THE DEPARTMENT OF SEWERS' STANDARDS.
- (4) PERFORATED LIDS SHALL BE PLACED ON ALL MANHOLES AND CATCH BASINS.
- BENCH MONUMENT LOCATIONS WITHIN THE LIMITS OF THE IMPROVEMENT CAN BE OBTAINED IN SUITE 410 333 SOUTH STATE STREET, CHICAGO, IL 60604. THE CONTRACTOR IS RESPONSIBLE FOR THE COST OF REPLACEMENT OF ANY BENCH MONUMENT IF DAMAGED OR DESTROYED DURING CONSTRUCTION.
- (6) ALL BROKEN, CRACKED, WORN OR OTHERWISE DAMAGED OR BICYCLE UNSAFE FRAMES AND LIDS ON SEWER STRUCTURES, SHALL BE REPLACED WITH NEW DEPARTMENT OF SEWERS' STANDARD FRAMES AND LIDS.
- OPEN LID DRAINAGE STRUCTURES SHALL NOT BE CLOSED, COVERED OR OTHERWISE OBSTRUCTED DURING CONSTRUCTION OF THIS ROADWAY WITHOUT THE WRITTEN PERMISSION FROM THE CITY OF CHICAGO.
- (B) CITY OF CHICAGO CASTINGS ARE THE PROPERTY OF THE CITY OF CHICAGO AND THE CONTRACTOR SHALL NOTIFY THE CITY FOR REMOVAL AND DISPOSITION OF THE CASTINGS.
- PERMITS FROM THE DEPARTMENT OF SEWERS ARE REQUIRED FOR ALL UNDERGROUND STORM, SANITARY OR COMBINED SEWER SYSTEM CONSTRUCTION, AND FOR RESURFACING WORK INVOLVING ADJUSTMENT OF SEWER STRUCTURES. THE DEPARTMENT OF SEWERS' PERMIT MUST BE OBTAINED BY A LICENSED SEWER DRAIN LAYER PRIOR TO START OF CONSTRUCTION.
- THE CONTRACTOR SHALL TAKE EXTRA CARE AND PRECAUTION WHEN REPARING THE CONCRETE CURB AND GUTTER AT LOCATIONS WHERE EXISTING TREES ARE PRESENT.

GENERAL NOTES

- BEFORE STARTING ANY EXCAVATION, THE CONTRACTOR SHALL CALL DIGGER AT 312-744-7000 FOR FIELD LOCATIONS OF BURIED ELECTRIC, TELEPHONE, AND GAS UTILITIES. 48 HOUR NOTIFICATION IS REQUIRED.
- 2) THE CONTRACTOR SHALL BE RESPONSIBLE FOR PROTECTING UTILITY PROPERTY FROM CONSTRUCTION OPERATIONS AS OUTLINED IN ARTICLE 107.31 OF THE STANDARD SPECIFICATIONS. ANY DAMAGE TO THE UNDERGROUND FACILITIES CAUSED BY THE CONTRACTOR SHALL BE REPAIRED TO THE SATISFACTION OF THE DEPARTMENT AT THE CONTRACTOR'S EXPENSE, INCLUDING TEMPORARY REPAIRS WHICH MAY BE REQUIRED TO KEEP THE FACILITY OPERATIONAL WHILE MATERIAL IS BEING OBTAINED TO MAKE PERMANENT REPAIRS.
- (3) THE CONTRACTOR SHALL COORDINATE CONSTRUCTION ACTIVITIES WITH UTILITY COMPANIES, AND THE CITY OF CHICAGO.
- THE CONTRACTOR SHALL CONTACT THE DISTRICT ONE TRAFFIC CONTROL SUPERVISOR AT (847) 705-4470 A MINIMUM OF 72 HOURS IN ADVANCE OF REGINNING WORK.
- 5) THE CONTRACTOR WILL NOT BE ALLOWED TO SET UP A YARD OR FIELD OFFICE ON STATE PROPERTY WITHOUT WRITTEN PERMISSION FROM THE DEPARTMENT.
- 6 THE CONTRACTOR SHALL BE REQUIRED TO PROVIDE ACCESS TO ABUTTING PROPERTY AT ALL TIMES DURING THE CONSTRUCTION OF THIS PROJECT.
- (7) THE CONTRACTOR SHALL MAINTAIN PEDESTRIAN ACCESS AT ALL TIMES DURING CONSTRUCTION.
- BEFORE BEGINNING ANY WORK, THE CONTRACTOR SHALL RETAIN AND RECORD FOR FUTURE REFERENCE, ALL EXISTING PAVEMENT MARKING LINES (AND RAISED REFLECTIVE PAVEMENT MARKERS) IN ORDER THAT THE LOCATIONS CAN BE RE-ESTABLISED FOR STRIPING. EXACT LOCATIONS OF ALL PAVEMENT MARKINGS SHALL BE AS DIRECTED BY THE ENGINEER.
- IN ADDITION TO FIELD AND AERIAL SURVEYS, PLAN DIMENSIONS AND DETAILS RELATIVE TO THE EXISTING FACILITIES HAVE BEEN TAKEN FROM EXISTING PLANS AND ARE SUBJECT TO CONSTRUCTION VARIATIONS. IT SHALL BE THE CONTRACTOR'S RESPONSIBILITY TO VERIFY SUCH DIMENSIONS AND EXISTING CONDITIONS IN THE FIELD PRIOR TO CONSTRUCTION AND ORDERING MATERIALS. SUCH VARIATIONS SHALL NOT BE A CAUSE FOR ADDITIONAL COMPENSATION DUE TO A CHANGE IN THE SCOPE OF WORK. HOWEVER, THE CONTRACTOR WILL BE PAID FOR THE QUANTITY ACTUALLY FURNISHED AT THE UNIT PRICE BID FOR THE WORK.
- THE LOCATIONS OF THOSE BURIED AND ABOVE GROUND UTILITIES SHOWN ARE APPROXIMATE, ARE SHOWN FOR CONTRACTOR INFORMATIONAL USE ONLY, AND ARE NOT TO BE REFERENCED FOR CONSTRUCTION PURPOSES. THE IMPLIED PRESENCE OR ABSENCE OF UTILITIES IS NOT TO BE CONSTRUCD BY THE OWNER, ENGINEER, CONTRACTOR, OR SUBCONTRACTORS TO BE AN ACCURATE AND COMPLETE REPRESENTATION OF UTILITIES THAT MAY OR MAY NOT EXIST ON THE CONSTRUCTION SITE. BURIED AND ABOVE GROUND UTILITY LOCATIONS, IDENTIFICATION, AND MARKING ARE THE SOLE RESPONSIBILITY OF THE CONTRACTOR. REROUTING, DISCONNECTION, PROTECTION, ETC. OF ANY UTILITIES MUST BE COORDINATED BETWEEN CONTRACTOR, UTILITY COMPANY, AND OWNER. SITE SAFETY, INCLUDING THE AVOIDANCE OF HAZARDS ASSOCIATED WITH BURIED AND ABOVE GROUND UTILITIES REMAIN THE SOLE RESPONSIBILITY OF THE CONTRACTOR.
- 11) DO NOT SCALE PLANS FOR CONSTRUCTION DIMENSIONS.
- THE CONTRACTOR SHALL TAKE ALL NECESSARY PRECAUTIONS FOR THE PROTECTION OF EXISTING PLANT MATERIAL FOR WHICH THE CONTRACT DOES NOT PROVIDE REMOVAL. THE PROTECTION OF EXISTING PLANT MATERIAL AND THE REPAIR OR REPLACEMENT OF EXISTING PLANT MATERIAL DAMAGED BY THE CONTRACTOR SHALL BE DONE IN ACCORDANCE WITH THE REDUIREMENTS OF SECTION 201 OF THE STANDARD SPECIFICATIONS.
- OVERNIGHT LANE CLOSURES SHALL NOT BE ALLOWED FOR REHABILITATION PROJECTS INVOLVING DAYTIME MILLING AND RESURFACING OPERATIONS AND CLASS D PATCHING UNLESS OTHER CONDITIONS WARRANT EXTENDED LANE CLOSURES AS DETERMINED AND APPROVED IN WRITING BY THE ENGINEER OR AS PROVIDED IN THE CONTRACT SPECIFICATIONS.
- WHERE SECTION OR SUB-SECTION MONUMENTS ARE ENCOUNTERED. THE ENGINEER SHALL BE NOTIFIED BEFORE SUCH MONUMENTS ARE REMOVED. THE CONTRACTOR SHALL PROTECT AND CAREFULLY PRESERVE ALL PROPERTY MARKERS AND MONUMENTS UNTIL THE OWNER, AN AUTHORIZED SURVEYOR, OR AGENT HAS WITNESSED THEIR LOCATION.
- (5) THE EXACT LOCATIONS AND SIZES OF PAVEMENT PATCHES SHALL BE DETERMINED BY THE ENGINEER IN THE FIELD.
- WHEN THE MILLED PAVEMENT IS OPEN TO TRAFFIC THE MAXIMUM GRADE DIFFERENTIAL BETWEEN PASSES OF THE MILLING MACHINE SHALL NOT EXCEED

 1 1/2 INCHES WHERE THE SPEED LIMIT IS 40 MPH OR LESS AND 1 INCH WHERE THE SPEED LIMIT IS GREATER THAN 40 MPH. WITH WRITTEN APPROVAL OF
 THE ENGINEER, A MAXIMUM GRADE DIFFERENTIAL OF 3 INCHES MAY BE ALLOWED IF THE EDGE OF THE MILLING IS SLOPED A MINIMUM 1:3 (V:H) OR A
 NOTCHED LONGITUDINAL WEDGE IS USED.
- ANY PAVEMENT MARKINGS AND RAISED REFLECTIVE PAVEMENT MARKERS OBLITERATED BY MILLING AND RESURFACEING OPERATIONS ON SIDE STREETS AND ENTRANCES SHALL BE REPLACED AND PAID FOR IN KIND.
- (B) LOCATION OF COMBINATION CONCRETE CURB AND GUTTER REMOVAL AND REPLANCEMENT, WILL BE DETERMINED IN THE FIELD BY THE ENGINEER.
- (3) DRAINAGE ADJUSTMENT OR RECONSTRUCTION LOCATIONS WILL BE DETERMINED IN THE FIELD BY THE ENGINEER.
- EXISTING BROKEN FRAMES AND LIDS SHALL BE REMOVED AND DISPOSED OF BY THE CONTRACTOR AND SHALL BE REPLACED AS DIRECTED BY THE ENGINEER. REPLACEMENT FRAMES AND LIDS WILL BE PAID FOR ACCORDING TO ARTICLE 109.04 OF THE STANDARD SPECIFICATIONS UNLESS A SEPARATE PAY ITEM HAS BEEN PROVIDED
- (21) FOR FRAMES AND LIDS ADJUSTMENT WITHOUT MILLING, REUSE EXISTING FRAME AND LID UNLESS OTHERWISE SPECIFIED IN THE PLANS.
- FRAMES AND GRATES ADJUSTMENT OF PRIVATE UTILITIES WITHIN THE LIMITS OF THE IMPROVEMENTS SHALL BE DONE BY THEIR RESPECTIVE OWNERS AND ARE NOT PART OF THIS CONTRACT.
- THE NOMINAL THICKNESS FOR HMA BASE AND SURFACE COURSES ARE SHOWN ON THE TYPICAL SECTIONS, STANDARDS, SCHEDULES, OR SPECIAL DETAILS.
 DEVIATIONS FROM THE NOMINAL THICKNESS WILL BE PERMITTED WHEN SUCH DEVIATIONS OCCUR DUE TO IRREGULARITIES IN THE EXISTING SURFACE OR
 BASE ON WHICH THE HMA MIXUTRE IS PLACED.
- (24) PAVEMENT MARKING TAPE, TYPE III SHALL BE USED FOR SHORT TERM PAVEMENT MARKINGS ON ALL FINAL SURFACES.

SCALE:

COMMITMENTS

NO COMMITMENTS


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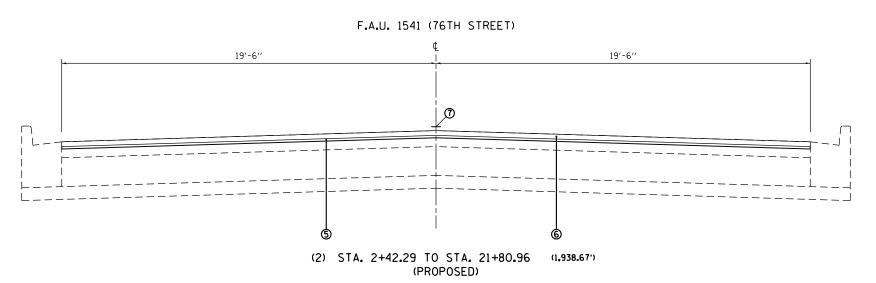
76TH STREET FROM ST. LAWRENCE AVENUE TO DREXEL AVENUE	F.A.U. RTE.	SECTION	COUNTY	TOTAL SHEETS	SHEET NO.
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urban urban CONSTRUCTION TYPE CODE CONSTRUCTION TYPE CODE SUMMARY OF QUANTITIES SUMMARY OF QUANTITIES 0005 0005 TOTAL ROADWAY TOTAL ROADWAY QUANTITIES BOX FEDERAL CODE NO ITEM UNIT CODE NO ITEM UNIT QUANTITIES 80% FEDERAL 20% STATE 20% STATE 20200100 CU YD EARTH EXCAVATION 36 36 42400200 PORTLAND CEMENT CONCRETE SIDEWALK 5 INCH SO FT 4275 4275 375 21101615 TOPSOIL FURNISH AND PLACE, 4" SO Y0 500 500 42400800 DETECTABLE WARNINGS SQ FT 375 25000400 NITROGEN FERTILIZER NUTRIENT POUND 7 44000158 HOT-MIX ASPHALT SURFACE REMOVAL. 2 1/4" SO YD 8864 8864 7 4611 25000500 PHOSPHORUS FERTILIZER NUTRIENT POUND 7 44000600 SIDEWALK REMOVAL SQ FT 4611 25000600 POTASSIUM FERTILIZER NUTRIENT 44201789 CLASS D PATCHES, TYPE II, 12 INCH SO YO 317 317 25200110 SODDING, SALT TOLERANT SQ YD 500 500 44201794 CLASS D PATCHES, TYPE 111, 12 INCH SO YD 75 75 25200200 SUPPLEMENTAL WATERING UNIT 7.5 7.5 44201796 CLASS D PATCHES, TYPE IV. 12 INCH SO YD 250 250 PERIMETER EROSION BARRIER FOOT 300 60252800 CATCH BASINS TO BE RECONSTRUCTED EACH 28000400 300 1 INLET FILTERS EACH 34 MANHOLES TO BE RECONSTRUCTED WITH NEW 28000510 34 60258100 EACH 3 TYPE 1 FRAME, OPEN LID 40600290 BITUMINOUS MATERIALS (TACK COAT) POUND 6124 6124 60300305 FRAMES AND LIDS TO BE ADJUSTED EACH 10 10 MIXTURE FOR CRACKS, JOINTS, AND FLANGEWAYS 40600400 14 14 66900200 NON-SPECIAL WASTE DISPOSAL CU YD 36 36 TON 383 383 40600827 POLYMERIZED LEVELING BINDER (MACHINE 66900450 METHOD), IL-4.75, N50 SPECIAL WASTE PLANS AND REPORTS LSUM 1 66900530 SOIL DISPOSAL ANALYSIS 40600982 HOT-MIX ASPHALT SURFACE REMOVAL - BUTT SO YD 209 209 EACH BUTT JOINT 67000400 ENGINEER'S FIELD OFFICE, TYPE A 6 40603340 HOT-MIX ASPHALT SURFACE COURSE, 765 MIX "D", N70 67100100 MOBILIZATION LSUM 1 . SPECIALTY ITEMS COUNTY TOTAL SHEE SHEETS NO. FILE NAME : DESIGNED - RWB REVISED -F.A.U. SECTION 76TH STREET FROM ST. LAWRENCE AVENUE TO DREXEL AVENUE STATE OF ILLINOIS RWB REVISED w/\VLOB4EBIOINTEGJIIInds.gov:PHIDOT\Do OF OFFicus/Quarrier NP rejects/DigPOFNCADData/Dastgn/DigPOF - BPGOBBon -2016-079RS COOK 20 3 1541 SUMMARY OF QUANTITIES **DEPARTMENT OF TRANSPORTATION** PLOT SCALE . 10000000 1/ In. CHECKED -REVISED CONTRACT NO. 62061 PLOT DATE . 3/23/2017 SHEET NO. 1 OF 2 SHEETS STA. FED, ROAD DIST. NO. 1 | ILLINOIS FED. AID PROJECT

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	STANDARD 701801					Andrew Andrew								***************************************				***************************************		
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70300100	SHORT TERM PAVEMENT MARKING	FOOT	1644	1644							The state of the s									
70300220	TEMPORARY PAVEMENT MARKING - LINE 4"	FOOT	383	383				The state of the s			The second secon									
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70300280	TEMPORARY PAVEMENT MARKING - LINE 24"	FOOT	920	920				The state of the s												
70300520	PAVEMENT MARKING TAPE, TYPE 111 4"	FOOT	000	822	station throw and an article state of the st	formation of the state of the s			-		The manufacture and the second			en principal de la constante d						
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X0327980	PAVEMENT MARKING REMOVAL - WATER BLASTING	SO FT	123	123																
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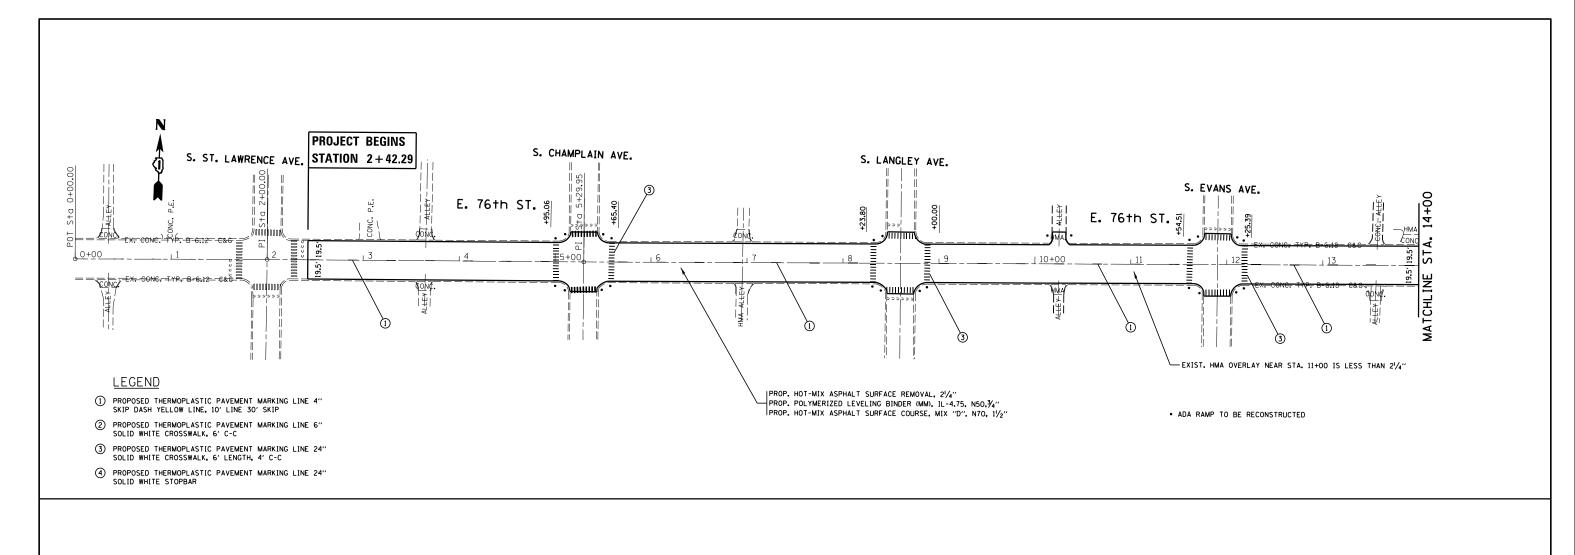
- 1 EXIST. SUBBASE GRANULAR MATERIAL, TYPE A 4"
- 2 EXIST. PCC BASE COURSE 9"
- 3 EXIST. 2¾" HMA OVERLAY
- 4 EXIST. COMBINATION CURB AND GUTTER TYPE B-6.18
- 5 PROP. POLYMERIZED LEVELING BINDER (MACHINE METHOD), IL-4.75, N50, 3/4"
- 6 PROP. HOT-MIX ASPHALT SURFACE COURSE, MIX "D", N70, 11/2"
- 7 PROP. THERMOPLASTIC PAVEMENT MARKING LINE, 4"




HOT-MIX ASPHALT MIXTURE REQUIREMENT	ΓS	QUALITY MANAGEMENT
MIXTURE TYPE	PROGRAM (QMP)	
RESURFACING		
HOT-MIX ASPHALT SURFACE COURSE, MIX "D", N70 (IL-9.5mm)	4% @ 70 GYR.	QC/QA
POLYMERIZED LEVELING BINDER (MACHINE METHOD), IL-4.75, N50	3.5% @ 50 GYR.	QC/QA
PATCHING		
CLASS D PATCHING (HMA BINDER, IL-19.0)	4% @ 70 GYR.	QC/QA
QMP DESIGNATION: QUALITY CONTROL/ QUALITY ASSURAN	CE (QC/QA)	

- THE UNIT WEIGHT USED TO CALCULATE ALL HMA SURFACE MIXTURE QUANTITIES IS 112 LBS/SQ YD/IN
- THE "AC TYPE" FOR POLYMERIZED HMA MIXES SHALL BE "SBS/SBR PG 76-22" AND FOR NON-POLYMERIZED HMA THE "AC TYPE" SHALL BE "PG 64-22" UNLESS MODIFIED BY DISTRICT ONE SPECIAL PROVISIONS.
- FOR USE OF RECYCLED MATERIALS SEE SPECIAL PROVISIONS
- QUALITY MANAGEMENT PROGRAM (QMP) IDENTIFIES THE PARTICULAR QUALITY CONTROL SPECIFICATION THAT APPLIES TO THE HMA MIXTURE
- THE SEQUENCE OF CONSTRUCTION SHALL BE PATCHING FIRST THEN MILLING

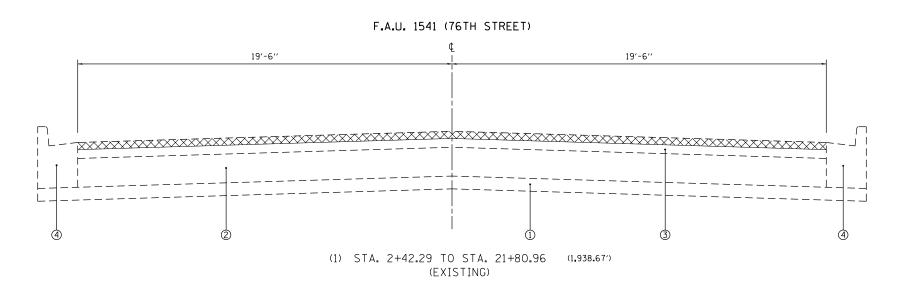ĺ	FILE NAME =	USER NAME = bartonrw	DESIGNED - RWB	REVISED -	27.77 27 11.11.22	76TH STREET FROM ST. LAWRENCE AVENUE TO DREXEL AVENUE	F.A.U. RTE.	SECTION	COUNTY	TOTAL SHEET SHEETS NO.
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	Default	PLOT DATE = 3/23/2017	DATE - 3/22/2017	REVISED -		SCALE: NTS SHEET 1 OF 1 SHEETS STA. TO STA.		ILLINOIS FED. AI	D PROJECT	



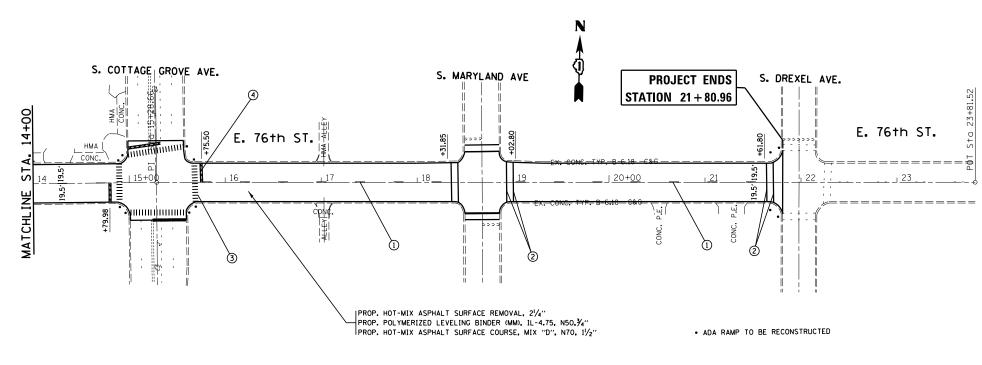

FILE NAME =	USER NAME = bartonrw	DESIGNED - RWB	REVISED -		76TH STREET FROM ST. LAWRENCE AVENUE TO DREXEL AVENUE				F.A.U.	SECTION	COUNTY	SHEETS	SHEET				
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DEPARTMENT OF TRANSPORTATION

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CONTRACT NO. 62D61


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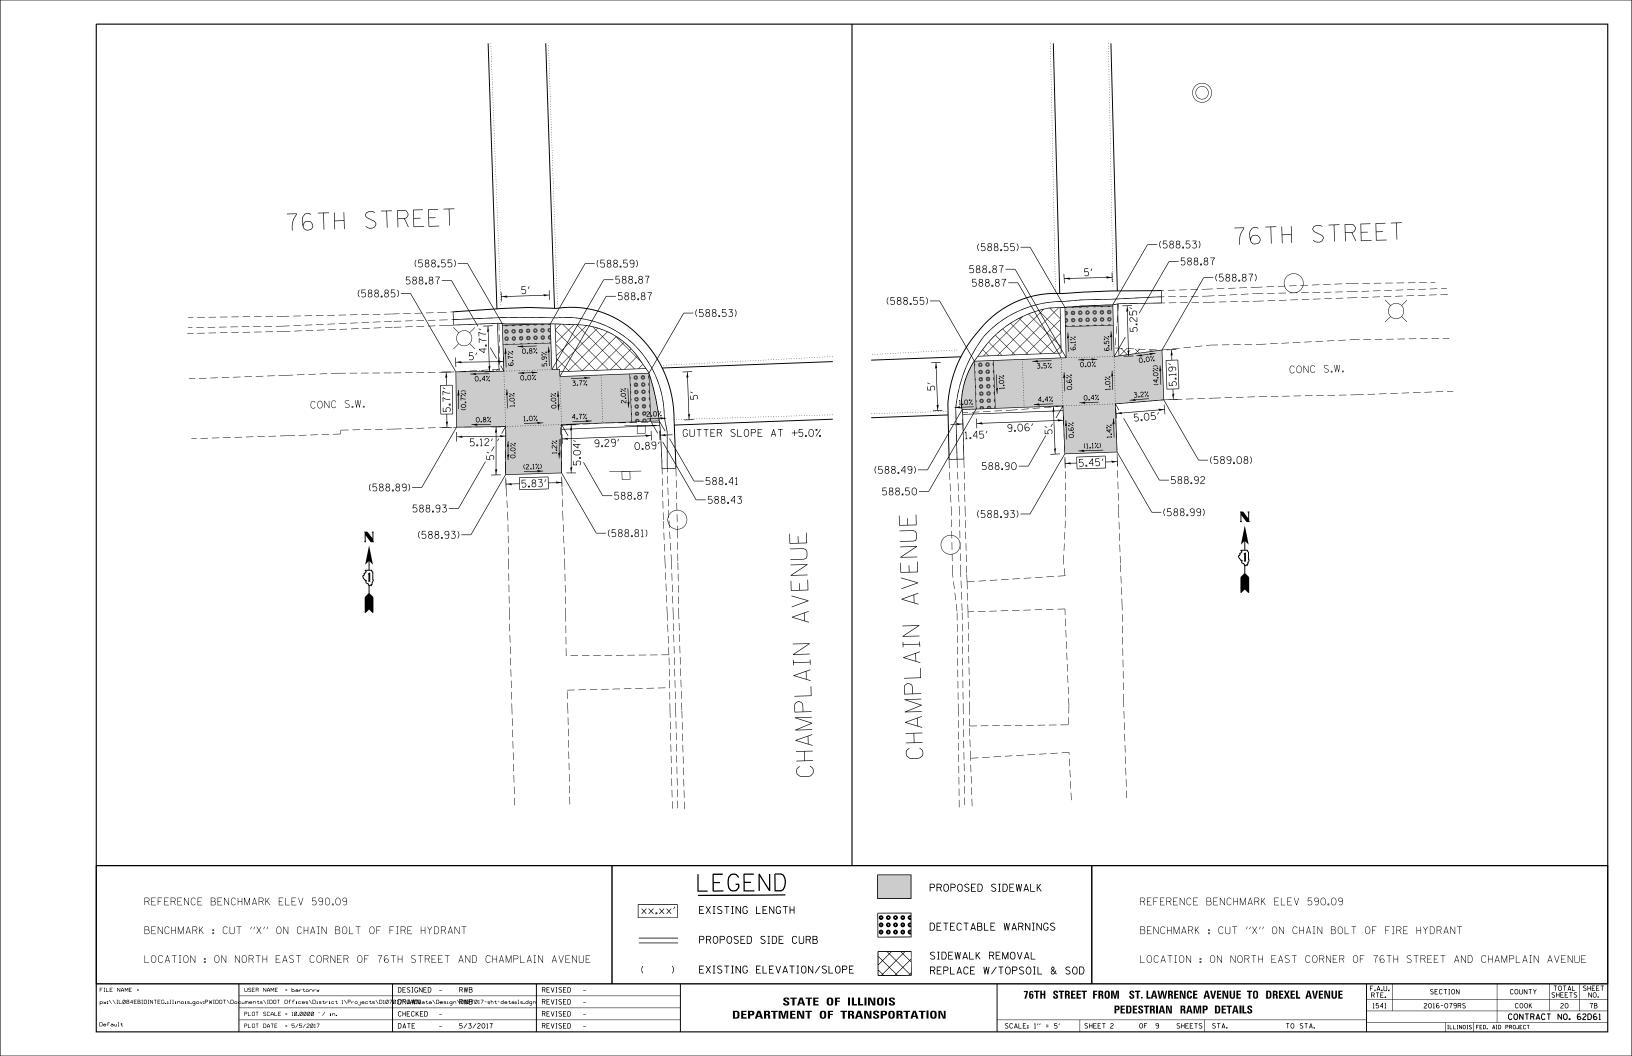
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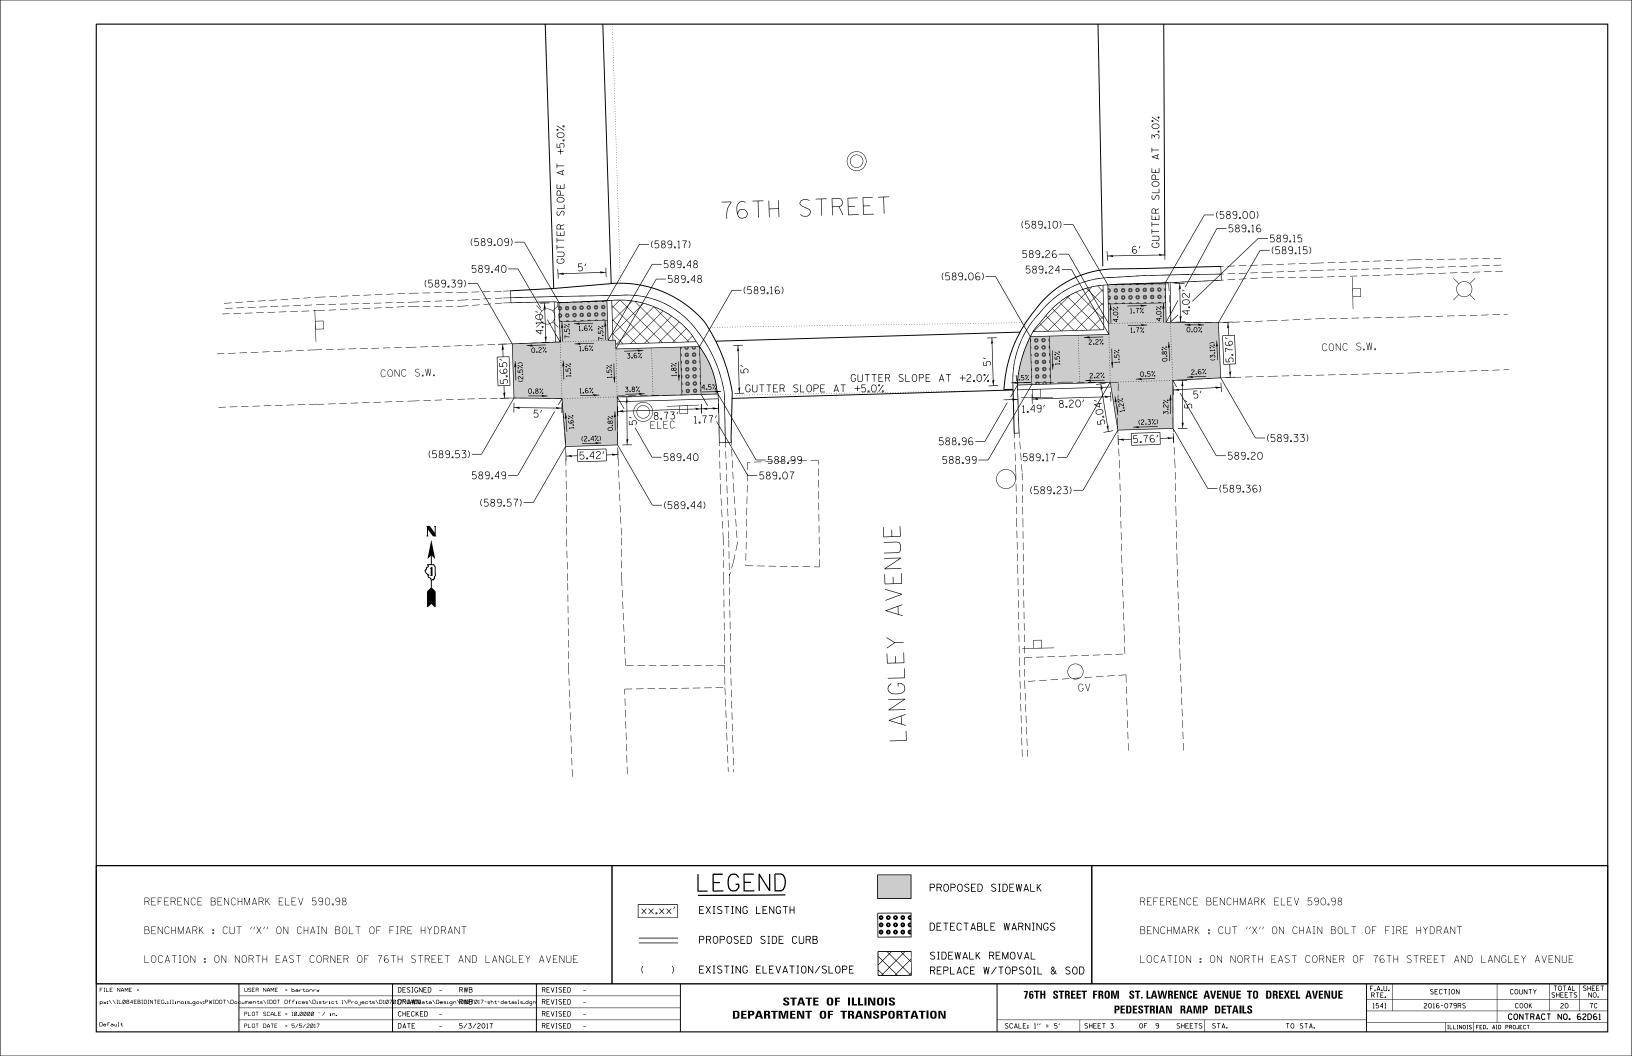
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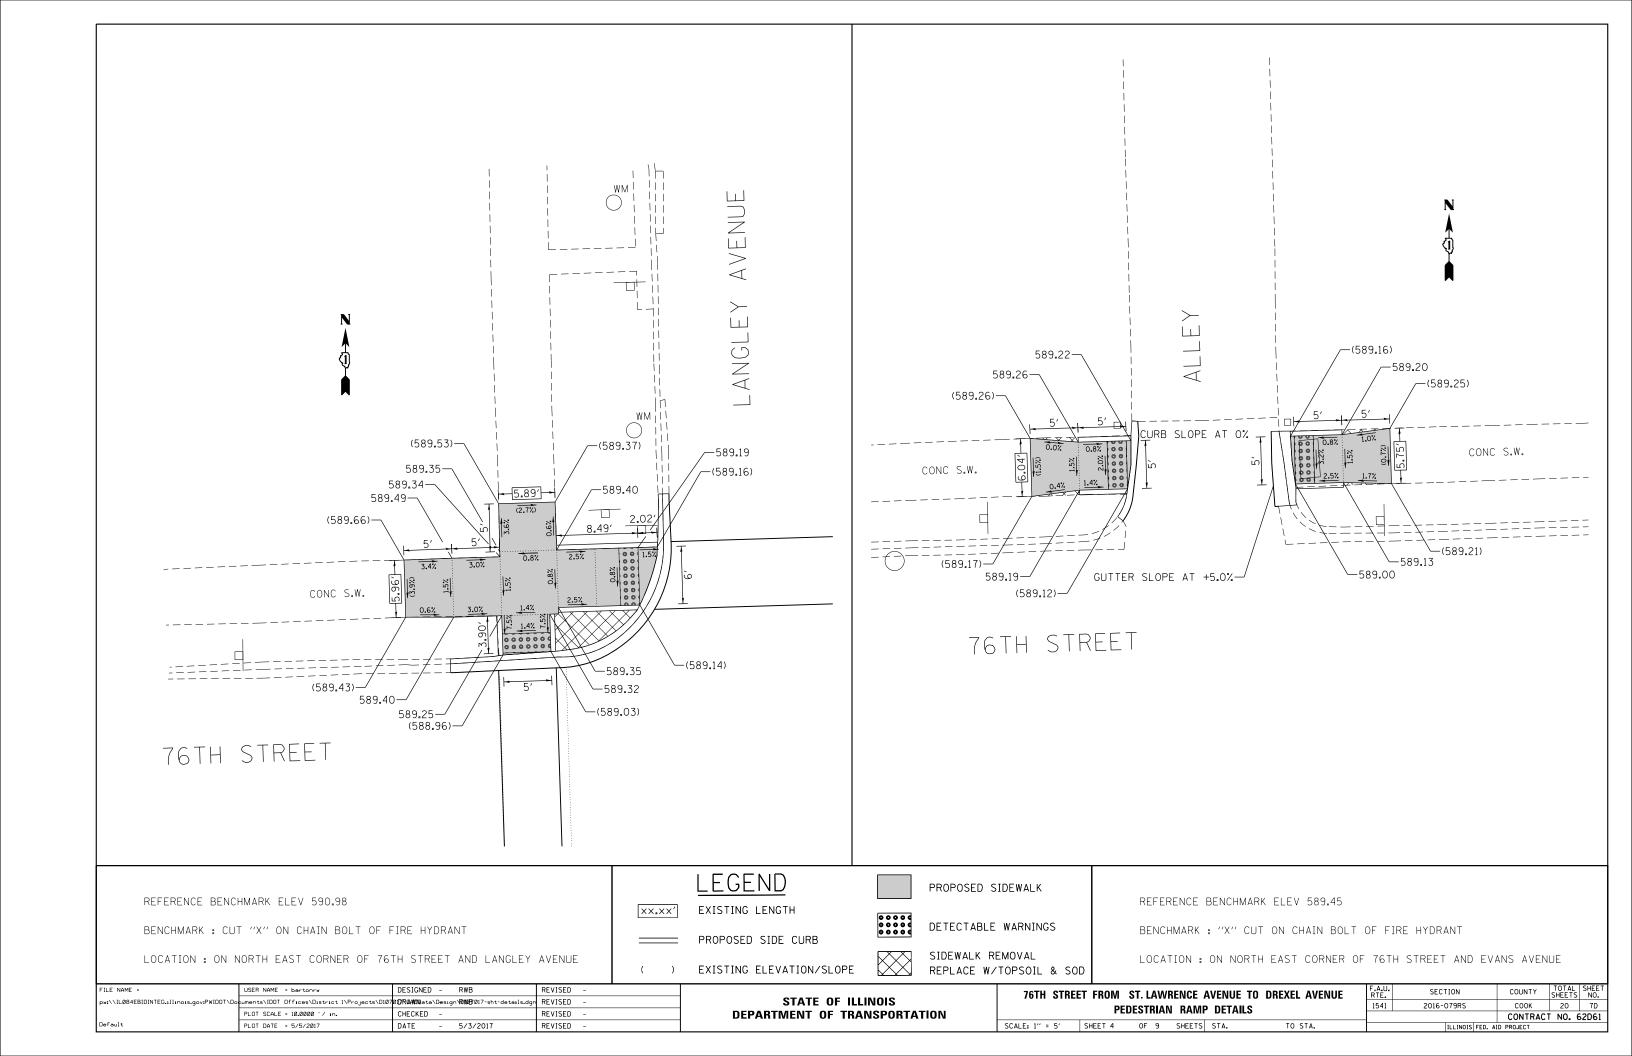
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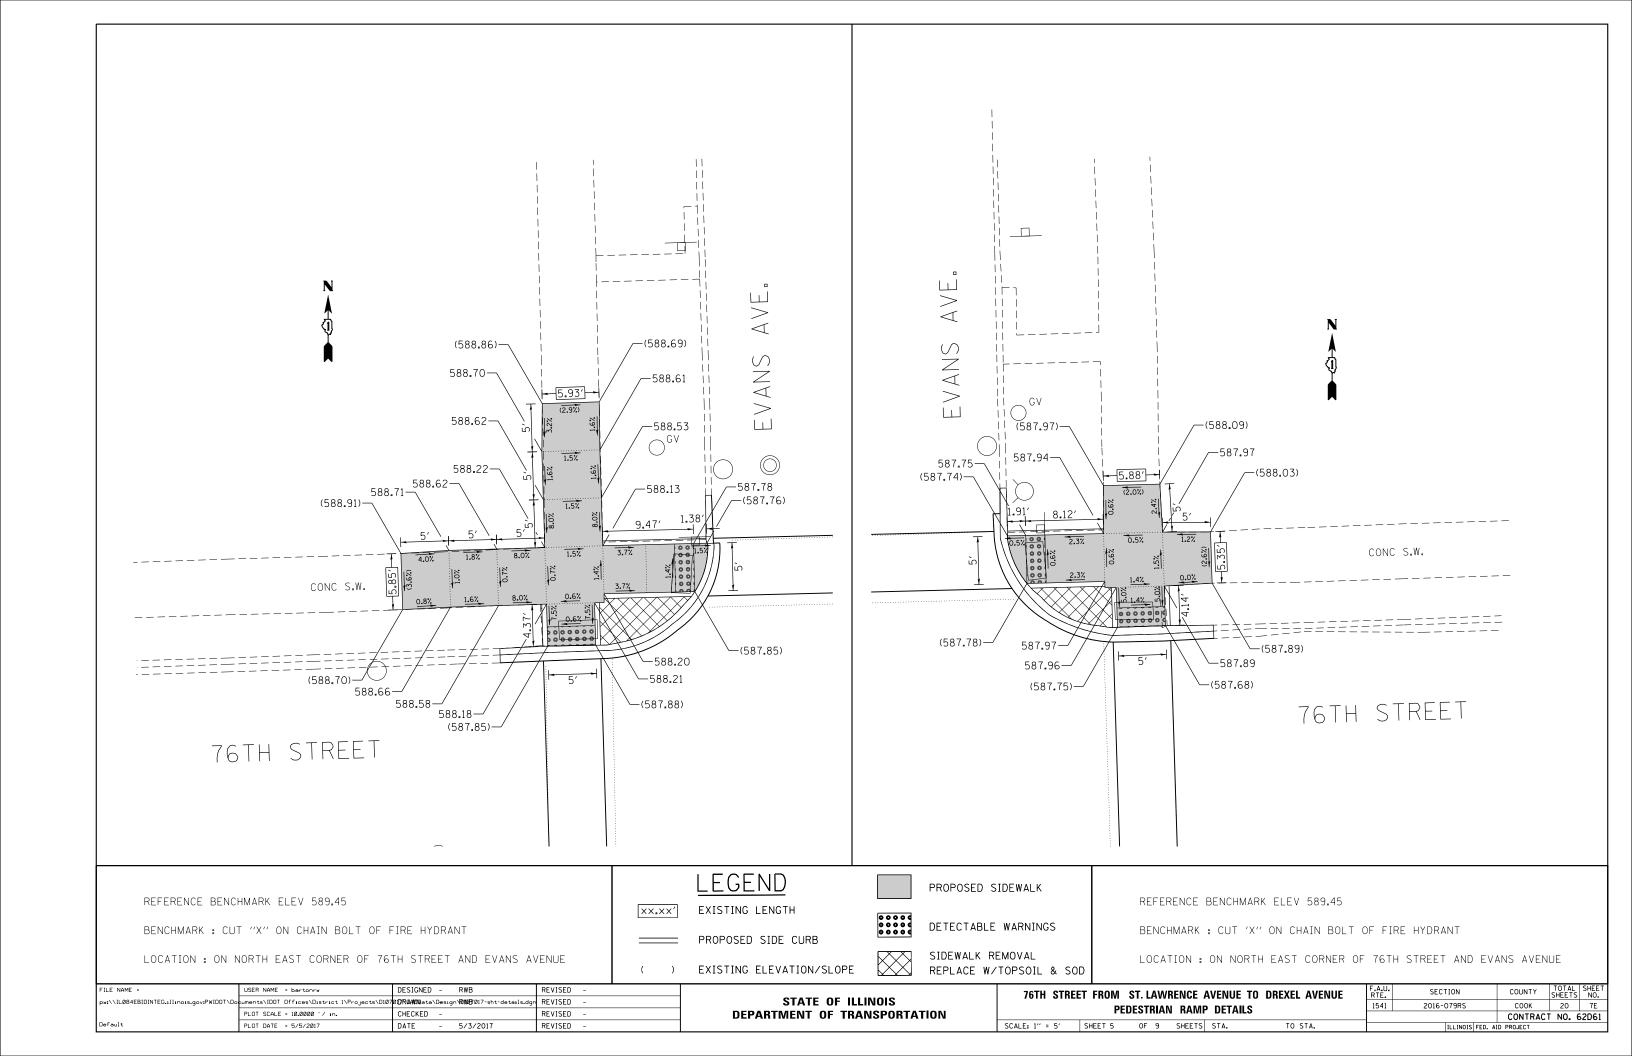
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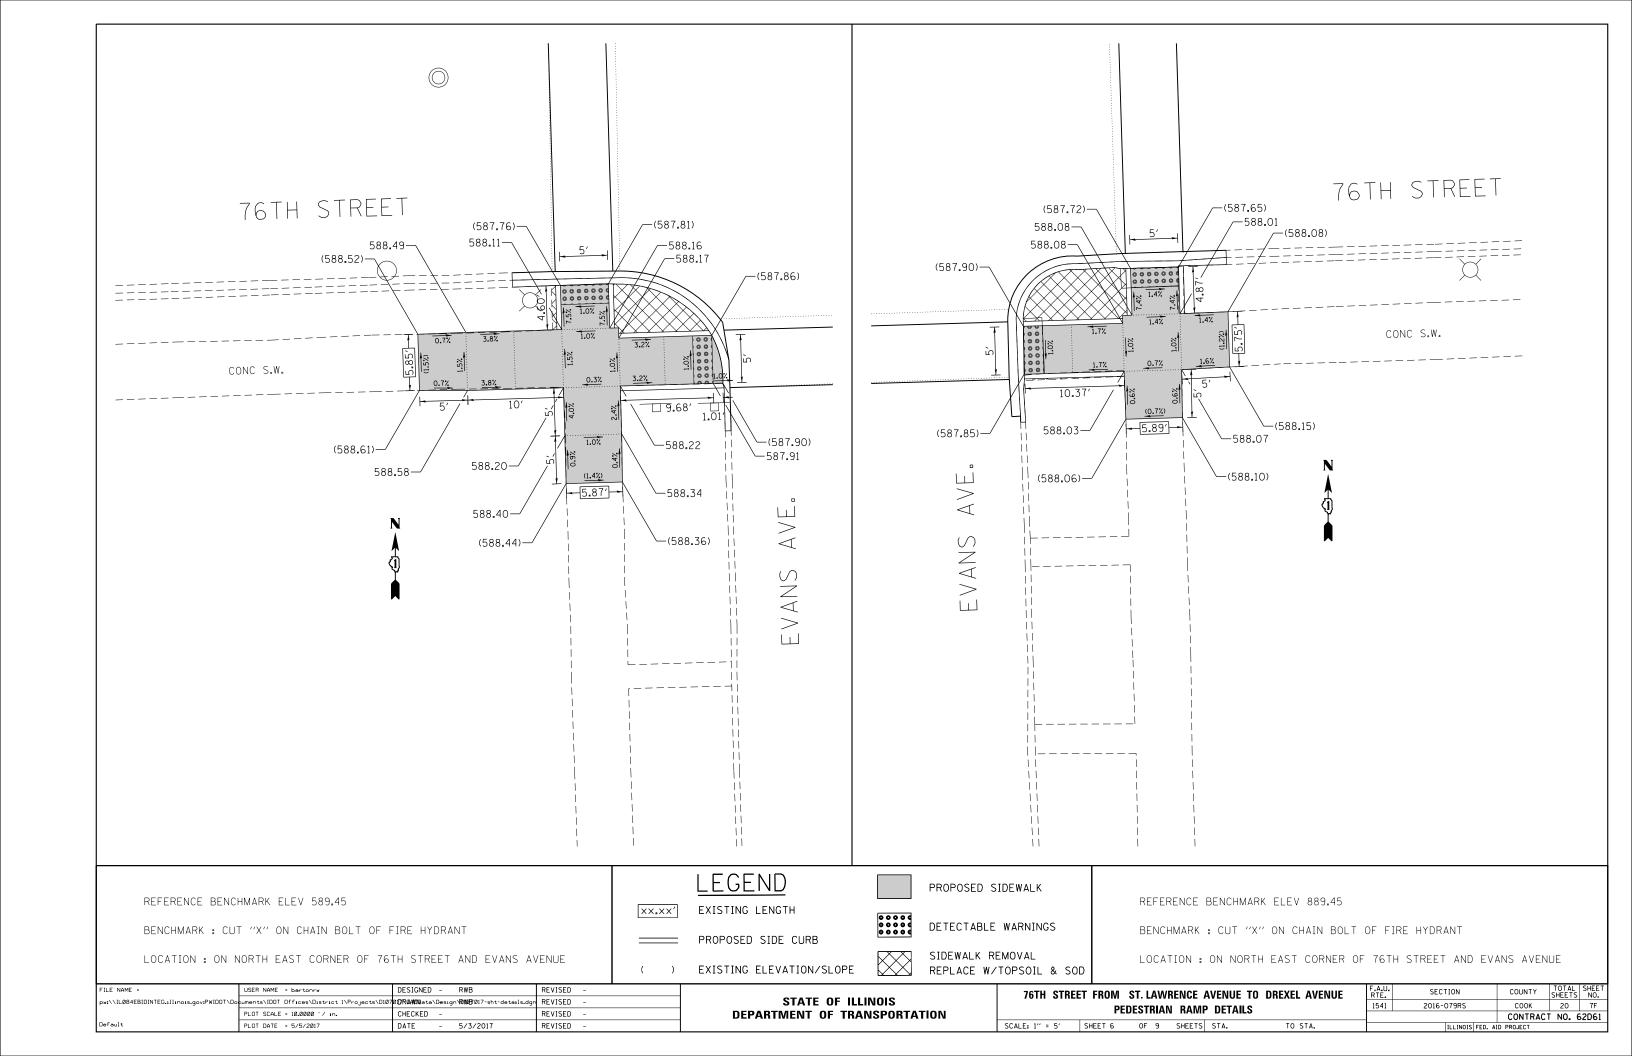














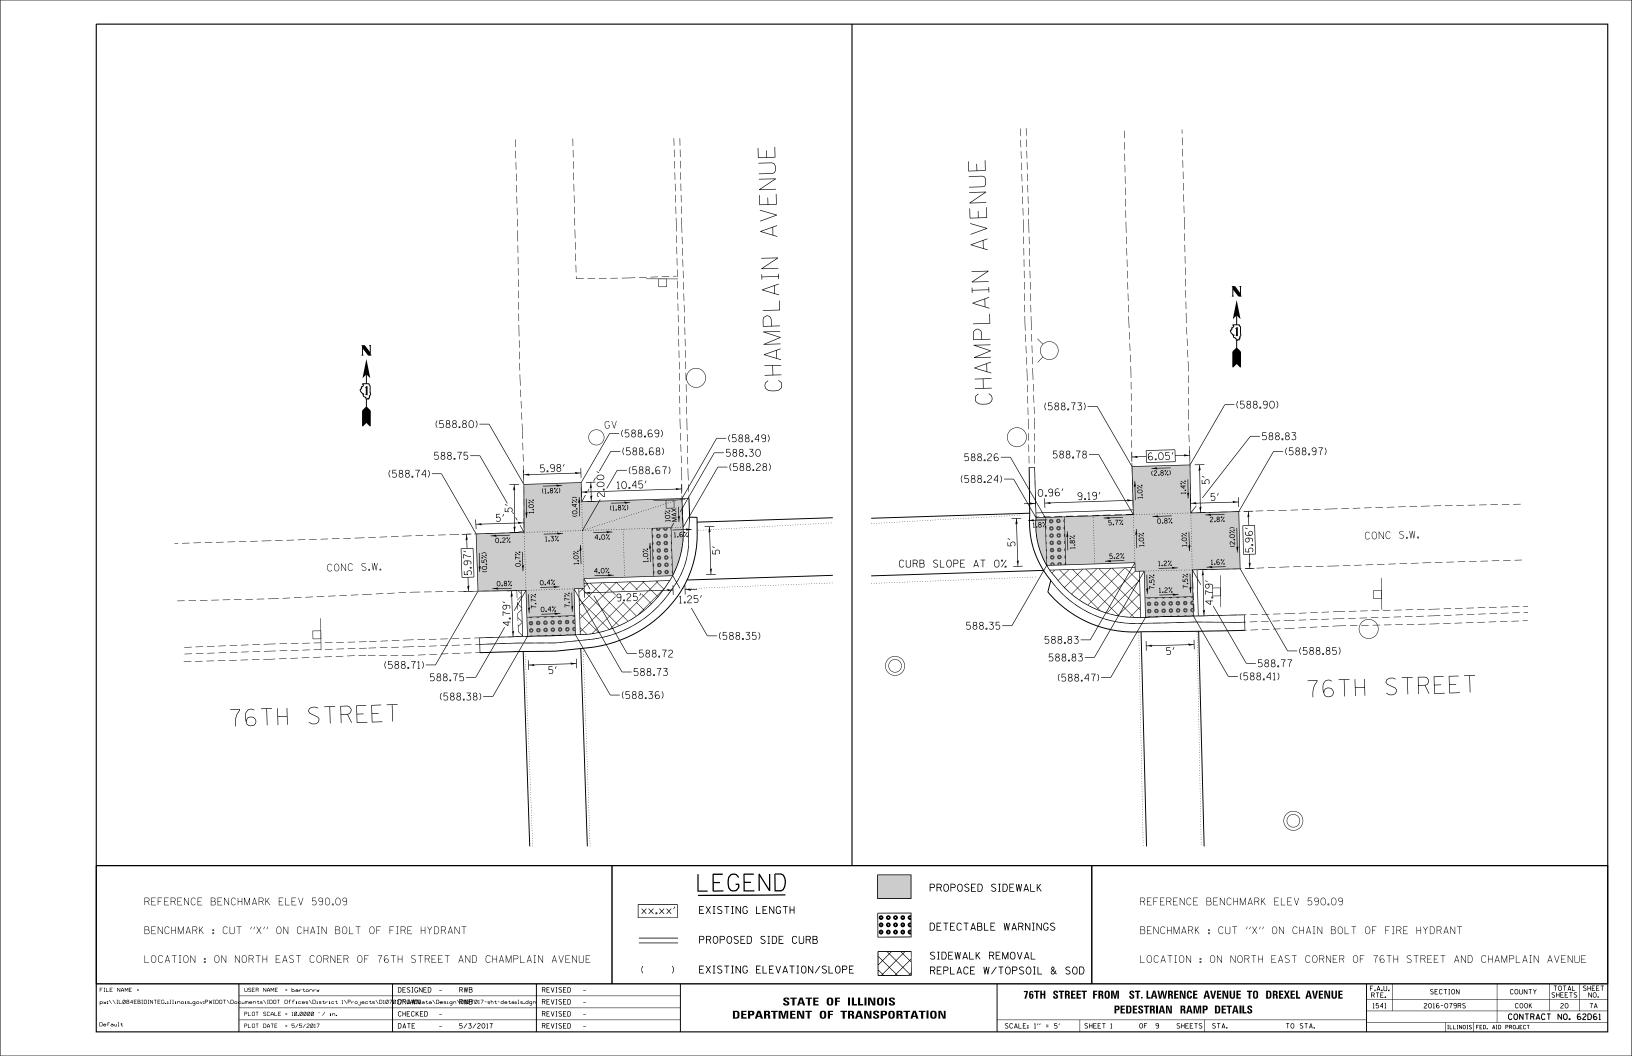


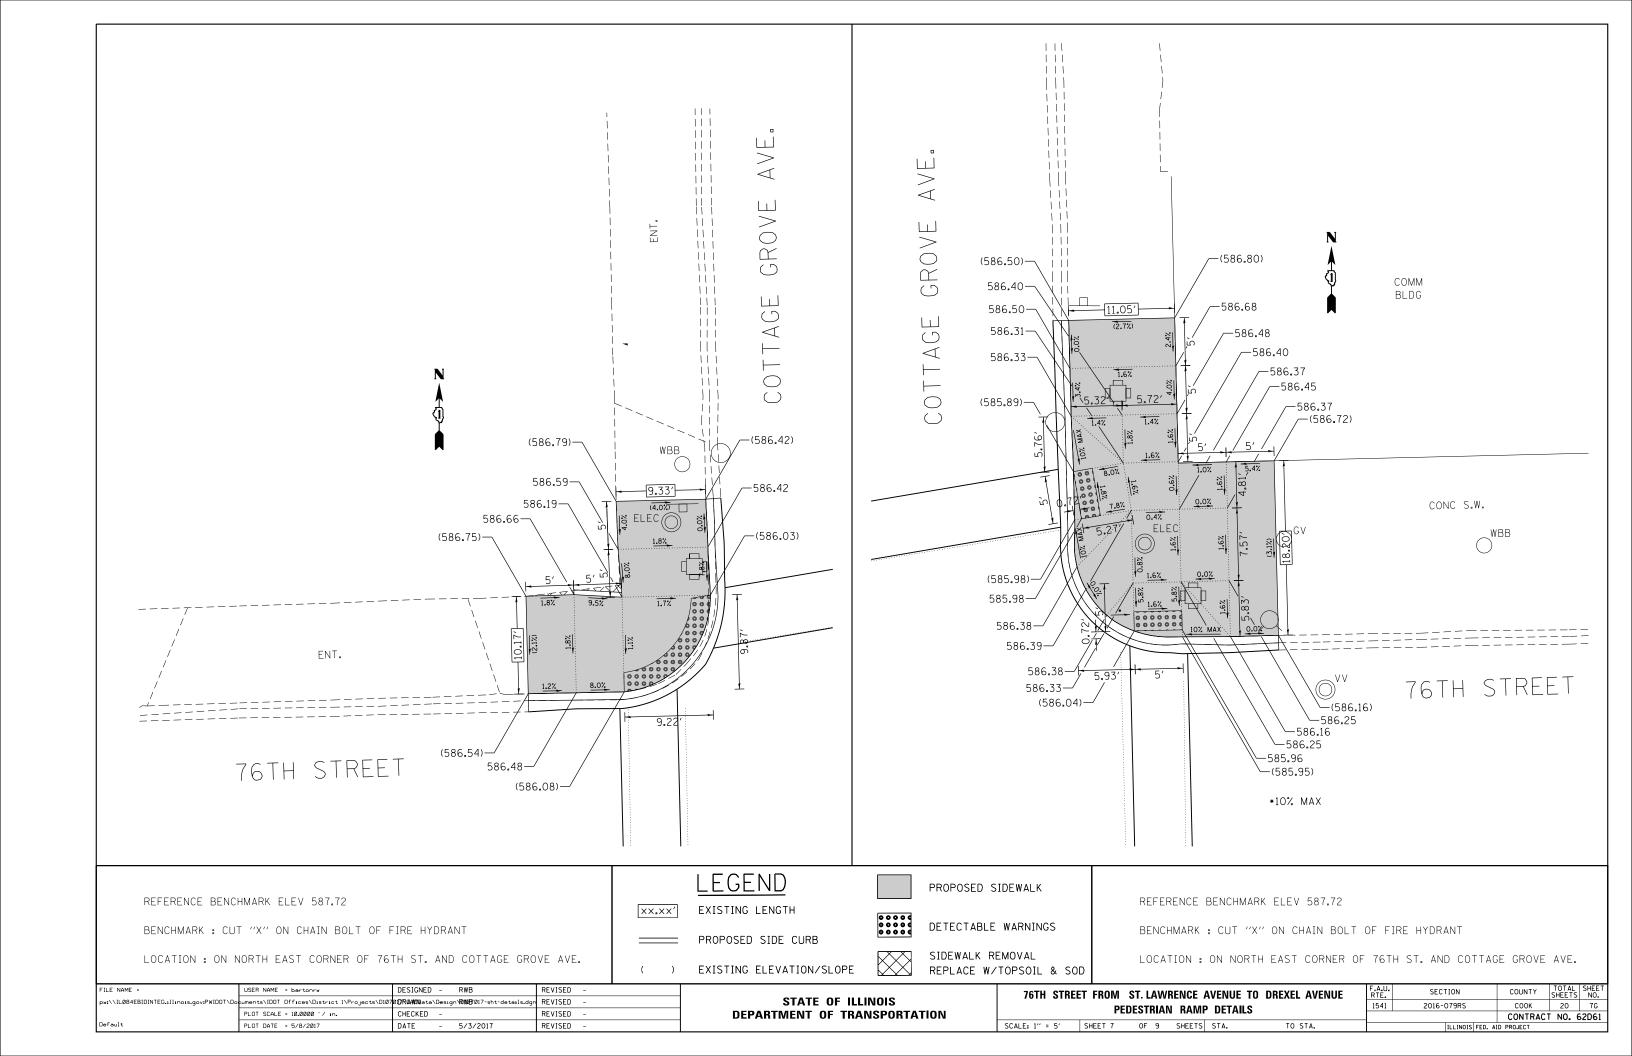

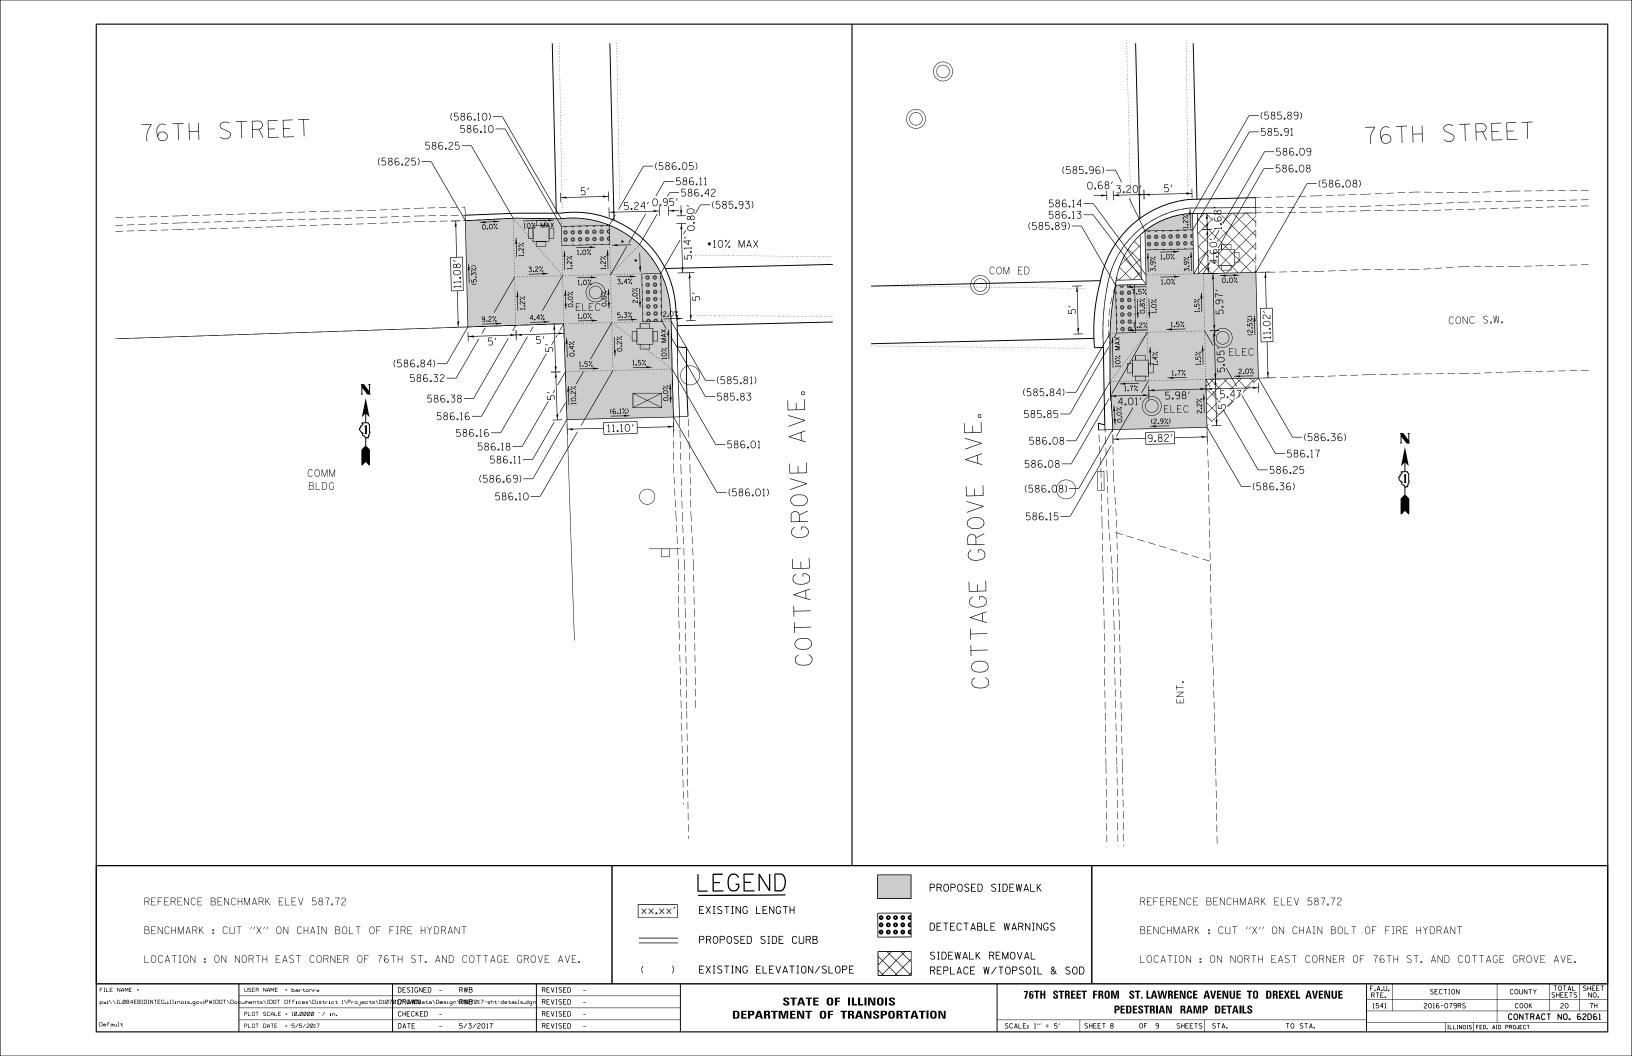

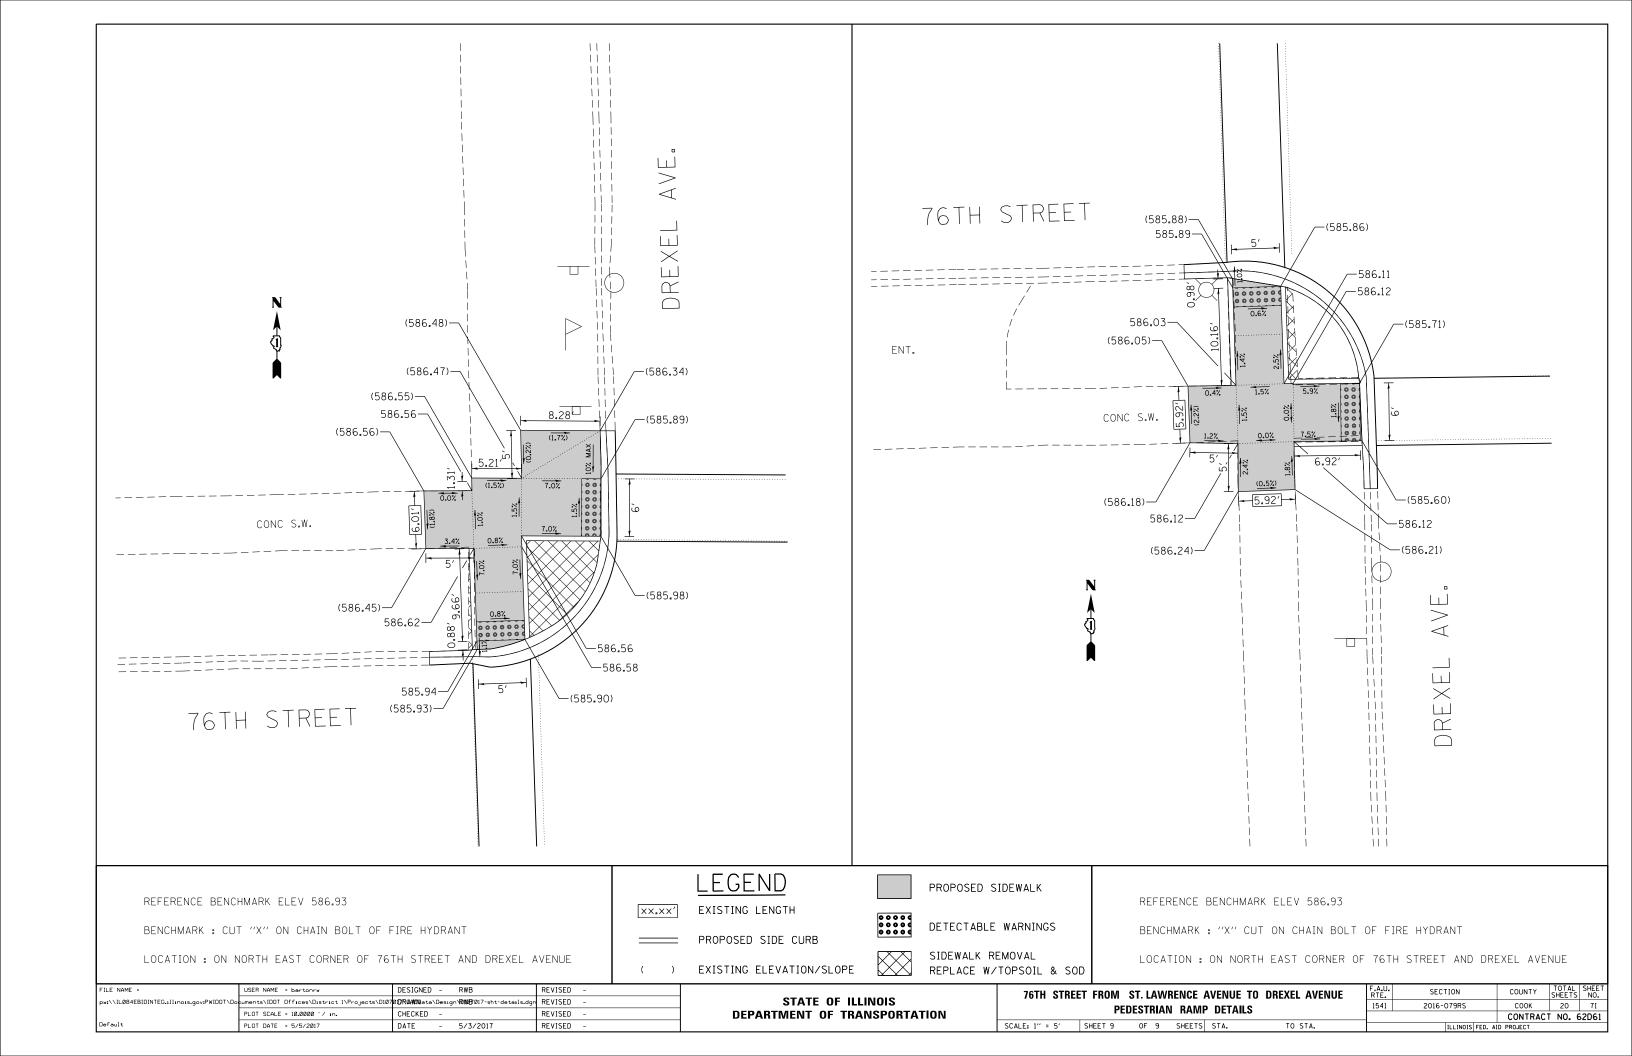

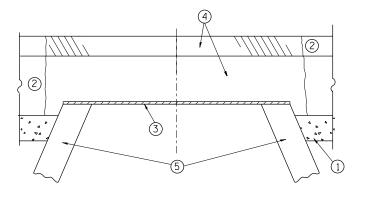

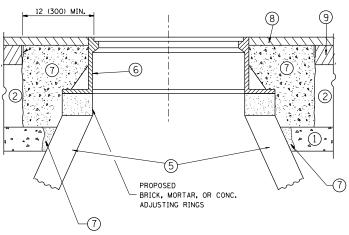

EXISTING BROKEN FRAMES AND LIDS SHALL BE REMOVED AND DISPOSED OF BY THE CONTRACTOR AND SHALL BE REPLACED AS DIRECTED BY THE ENGINEER. REPLACEMENT FRAMES AND LIDS WILL BE PAID FOR IN ACCORDANCE WITH ARTICLE 109.04 OF THE STANDARD SPECIFICATIONS UNLESS A SEPARATE PAY ITEM HAS BEEN PROVIDED.

IF THE EXISTING LIDS ARE OPEN, THE FRAME WILL BE ADJUSTED TO THE ELEVATION OF THE MILLED PAVEMENT SURFACE PRIOR TO THE MILLING OPERATION. THE FRAME WILL NOT BE REMOVED AND COVERED BY THE METAL PLATE.

CITY OF CHICAGO CASTINGS ARE THE PROPERTY OF THE CITY AND THE CONTRACTOR SHALL NOTIFY THE CITY FOR REMOVAL AND DISPOSITION OF THE CASTINGS.

THE METAL PLATE USED TO COVER THE STRUCTURE SHALL REMAIN THE PROPERTY OF THE CONTRACTOR.

WHEN STRUCTURES ARE TO BE ADJUSTED OR RECONSTRUCTED, THE LOWERING AND RAISING OF THE FRAMES AND LIDS WILL NOT BE PAID FOR SEPARATELY BUT WILL BE INCLUDED IN THE COST OF THE CORRESPONDING PAY ITEM.

CONSTRUCTION PROCEDURES

STAGE 1 (BEFORE PAVEMENT MILLING)

- A) REMOVE A MINIMUM OF 12 (300) OF THE PAVEMENT FROM
- AROUND THE STRUCTURE.

 B) REMOVE THE EXISTING FRAME AND LID FROM THE STRUCTURE.
- C) COVER THE STRUCTURE OPENING WITH A 36 (900) DIAMETER METAL PLATE. D) BACKFILL WITH CRUSHED STONE AND A MINIMUM $1\frac{1}{2}$ (40)
- THICK HMA SURFACE MIX APPROVED BY THE ENGINEER.

STAGE 2 (AFTER PAVEMENT MILLING)

- A) REMOVE THE HMA SURFACE MIX AND CRUSHED STONE.
- B) INSTALL THE FRAME AND LID; ADJUST THE FRAME TO ITS FINAL SURFACE ELEVATION.
- C) THE SURROUNDING SPACE SHALL BE FILLED WITH CLASS PP-1* CONCRETE TO THE ELEVATION OF THE SURFACE OF THE EXISTING BASE COURSE OR THE BINDER COURSE.
- * UNLESS OTHERWISE SPECIFIED IN THE PLANS.

THE PROCEDURE EXPLAINED ABOVE SHALL CONFORM TO THE APPLICABLE PORTIONS OF SECTIONS 353, 406, 602, AND 603 OF THE STANDARD SPECIFICATIONS EXCEPT THAT "THE CONTRACTOR SHALL ADJUST THE STRUCTURES TO THE FINISHED PAVEMENT ELEVATION NO MORE THAN 5 CALENDAR DAYS PRIOR TO PLACEMENT OF THE FINAL LIFT OF SURFACE UNLESS APPROVED BY THE

LEGEND

- 1 SUB-BASE GRANULAR MATERIAL
- (6) FRAME AND LID (SEE NOTES)
- 2 EXISTING PAVEMENT

(5) EXISTING STRUCTURE

- (7) CLASS PP-1* CONCRETE
- 3 36 (900) DIAMETER METAL PLATE
- (8) PROPOSED HMA SURFACE COURSE
- PROPOSED CRUSHED STONE AND HMA SURFACE MIX
- (9) PROPOSED HMA BINDER COURSE

LOCATION OF STRUCTURES:

THE CONTRACTOR WILL BE REQUIRED TO KEEP A RECORD OF THE LOCATIONS OF THE BURIED STRUCTURES ACCORDING TO THE STATION AND DISTANCE LEFT OR RIGHT OF THE CENTERLINE OF PAVEMENT. UPON COMPLETION OF THE WORK. THE CONTRACTOR WILL DELIVER THE RECORD TO THE ENGINEER.

BASIS OF PAYMENT:

REMOVING FRAMES AND LIDS ON DRAINAGE AND UTILITY STRUCTURES IN THE PAVEMENT PRIOR TO MILLING, AND ADJUSTING TO FINAL GRADE PRIOR TO PLACING THE SURFACE COURSE, WILL BE PAID FOR AT THE CONTRACT UNIT PRICE EACH FOR "FRAMES AND LIDS TO BE ADJUSTED

THIS WORK WILL NOT BE PAID FOR WHEN DRAINAGE AND UTILITY STRUCTURES ARE SPECIFIED FOR PAYMENT AS STRUCTURE RECONSTRUCTION.

NEW FRAMES AND LIDS, WHEN SPECIFIED, WILL BE PAID FOR SEPARATELY.

DETAILS FOR FRAMES AND LIDS ADJUSTMENT WITH MILLING

ALL DIMENSIONS ARE IN INCHES (MILLIMETERS) UNLESS OTHERWISE SHOWN


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CONTRACT NO. 62D61


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	PLOT DATE = 3/23/2017	DATE - 10-25-94	REVISED - R. BORO 12-06-11


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FRAM	ES AND LIDS	1541	2016-079RS	соок			
	LO AND LIDO	MILLING		BD600-03 (BD-8)	CONTRA		
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NOTEC

- EXPANSION JOINTS SHALL BE CONSTRUCTED AS SHOWN ON THE DETAILS FOR P.C.C. SIDEWALK.
- 2. THE CURB BETWEEN ADJACENT DRIVEWAYS SHALL BE FULL HEIGHT FOR A DISTANCE OF AT LEAST FOUR 4 FEET (1.2 METERS)
- P.C. CONCRETE DRIVEWAYS SHALL BE CONSTRUCTED AT LOCATIONS SHOWN ON THE PLANS OR AS DIRECTED BY THE ENGINEER.
- ¾4" (20) PREFORMED EXPANSION JOINTS WILL NOT BE PAID FOR SEPARATELY BUT SHALL BE CONSIDERED INCIDENTAL TO P.C.C. DRIVEWAY PAVEMENT 8" (200).
 COMBINATION CONC. CURB AND GUTTER SHALL BE
- COMBINATION CONC. CURB AND GUTTER SHALL BE MEASURED STRAIGHT ACROSS THE DRIVEWAY. NO ADDITIONAL COMPENSATION WILL BE ALLOWED FOR THE TRANSITION CURB AND GUTTER.



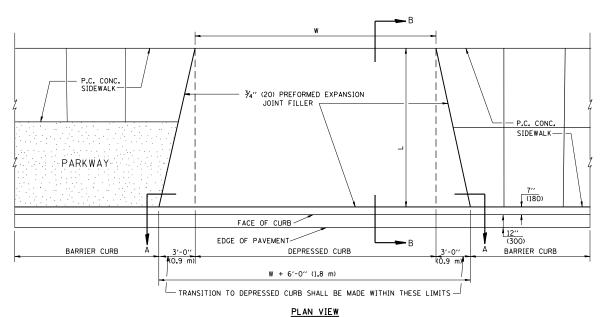

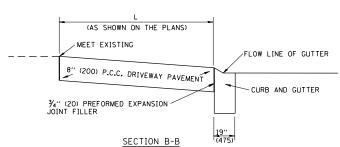P.C.C. DRIVEWAY PAVEMENT DETAIL

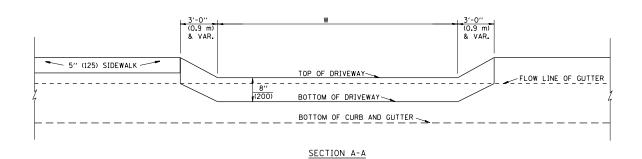WALL OR OTHER STRUCTURE SIDEWALK -R.O.W. KEYSTONE -DRIVEWAY SOD--SIDEWALK APRON RAMP SIDEWALK TO MEET CURB CURB AND GUTTER -DEPRESSED CURB FIRE HYDRANT PLATFORM TRAFFIC SIGNAL, TROLLEY POWER THE PROPOSED CARRIAGE WALK SHALL DEPRESSED CURB POLE, LIGHT STANDARD OR COLUMN FOR OVERHEAD STRUCTURE. TO BE 3'-0" (0.9 m) SQUARE OR AS DIRECTED BY THE ENGINEER. BE CONSTRUCTED THE SAME WIDTH AND LENGTH AS THE EXISTING CARRIAGE WALK AND PAID FOR AS PORTLAND CEMENT CONCRETE SIDEWALK, 5-INCHES (125). PAVEMENT PAVEMENT -

SIDEWALK 1" (25) PREFORMED EXPANSION JOINT FILLER


SLOPE FOR SIDEWALK 1" (25) IN 3'-0" (0.9 m) IN CHICAGO


NOTES:

- ONE-HALF INCH THICK EXPANSION JOINTS SHALL BE PLACED BETWEEN THE SIDEWALK AND ALL STRUCTURES SUCH AS LIGHT STANDARDS, TRAFFIC LIGHT STANDARDS, MANHOLES, WHICH EXTEND THROUGH THE SIDEWALK.
- 2. ¾4" (20) THICK EXPANSION JOINTS SHALL BE PLACED AT INTERVALS OF NOT MORE THAN 100 FEET (30 METERS) IN THE SIDEWALK, WHERE THE SIDEWALK IS CONSTRUCTED ADJACENT-TO PAVEMENT OR CURB HAVING EXPANSION JOINTS, THE EXPANSION JOINTS IN THE SIDEWALK SHALL BE PLACED OPPOSITE THE EXISTING EXPANSION JOINTS AS NEARLY AS PRACTICABLE. EXPANSION JOINTS SHALL ALSO BE PLACED WHERE THE SIDEWALK ABUTS EXISTING SIDEWALKS, BETWEEN DRIVEWAY PAVEMENT AND SIDEWALK, AND BETWEEN SIDEWALK AND CURBS WHERE THE-SIDEWALK ABUTS A CURB.

PORTLAND CEMENT CONCRETE SIDEWALK DETAILS

NOTES: NO EXTRA COMPENSATION SHALL BE ALLOWED FOR THE GUTTER FLARE

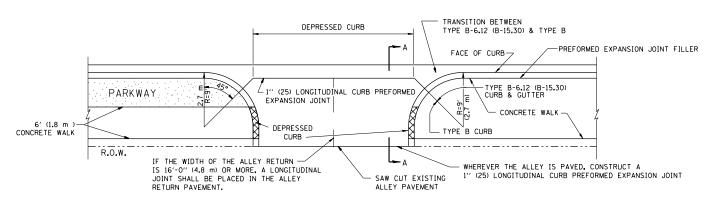

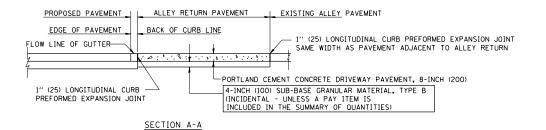


ALLEY RETURN DETAIL

ALL DIMENSIONS ARE IN INCHES (MILLIMETERS) UNLESS OTHERWISE SHOWN

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	PLOT DATE = 3/23/2017	DATE - 06-13-90	REVISED -

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DETAILS FOR P.C. CONCRETE DRIVEWAY, ALLEY RETURN AND SIDEWALK						2016-079RS	соок	20	9
DETAILS TO	n F.G. GUINGHEIE D	INIVEVVAI,	BI	0400-03 (BD-17)	CONTRACT	NO. 6	2D61		
SCALE: NONE	SHEET NO. 1 OF 1	SHEETS	STA.	TO STA.	FED. RO	DAD DIST, NO. 1 ILLINOIS FED. A	ID PROJECT		

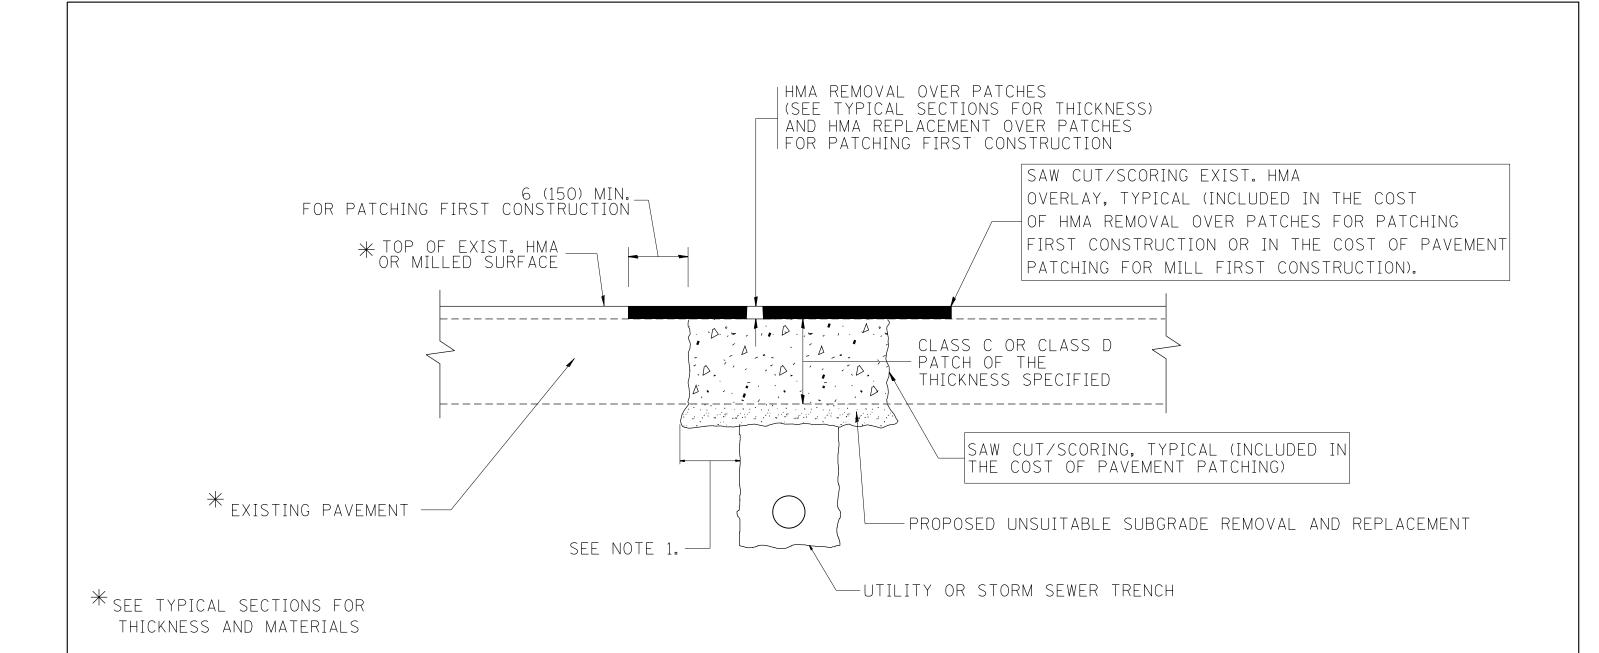

NOTES:

- 1. THE WIDTH OF THE FULL DEPTH PATCH OVER A TRENCH SHALL BE 12 (300) WIDER ON EACH SIDE OF THE TRENCH.
- 2. FOR METHOD OF MEASUREMENT AND BASIS OF PAYMENT, SEE RECURRING SPECIAL PROVISION "PATCHING WITH HOT-MIX ASPHALT OVERLAY REMOVAL".

SEQUENCE OF CONSTRUCTION (PATCHING FIRST)


- 1. REMOVE THE EXISTING HMA MATERIAL OVER THE AREA TO BE PATCHED.
- 2. REMOVE AND REPLACE WITH CLASS C OR D PATCH.
- 3. REPLACE HMA MATERIAL OVER THE AREA TO BE PATCHED.

SEQUENCE OF CONSTRUCTION (MILLING FIRST)

- 1. MILL HMA FIRST IF THERE IS AT LEAST 41/2 INCHES OR MORE OF HMA MATERIAL ON TOP OF THE EXISTING PAVEMENT OR IF THE PAVEMENT IS FULL DEPTH HMA. A MINIMUM OF 2 INCHES OF HMA MATERIAL SHALL BE IN PLACE AFTER MILLING.
- 2. REMOVE AND REPLACE WITH FULL DEPTH CLASS D PATCHES TO TOP OF MILLED SURFACE.

ALL DIMENSIONS ARE IN INCHES (MILLIMETERS) UNLESS OTHERWISE SHOWN.

- [FILE NAME =	USER NAME = bartonrw	DESIGNED - R. SHAH	REVISED -	A. ABBAS 04-27-98			PAVEMENT PATCHING FOR		F.A.U. RTF	SECTION	COUNTY	TOTAL :	SHEET
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		PLOT SCALE = 100.0000 '/ in.	CHECKED -	REVISED -	R. BORO 09-04-07	DEPARTMENT OF TRANSPORTATION		HMA SURFACED PAVEMENT		BD	1400-04 (BD-22)	CONTRACT	NO. 62	:D61
		PLOT DATE = 3/23/2017	DATE - 10-25-94	REVISED -	K. ENG 10-27-08		SCALE: NONE	SHEET NO. 1 OF 1 SHEETS STA.	TO STA.	FED. ROAD	DICT NO 1 THE INDICE OF ALL			

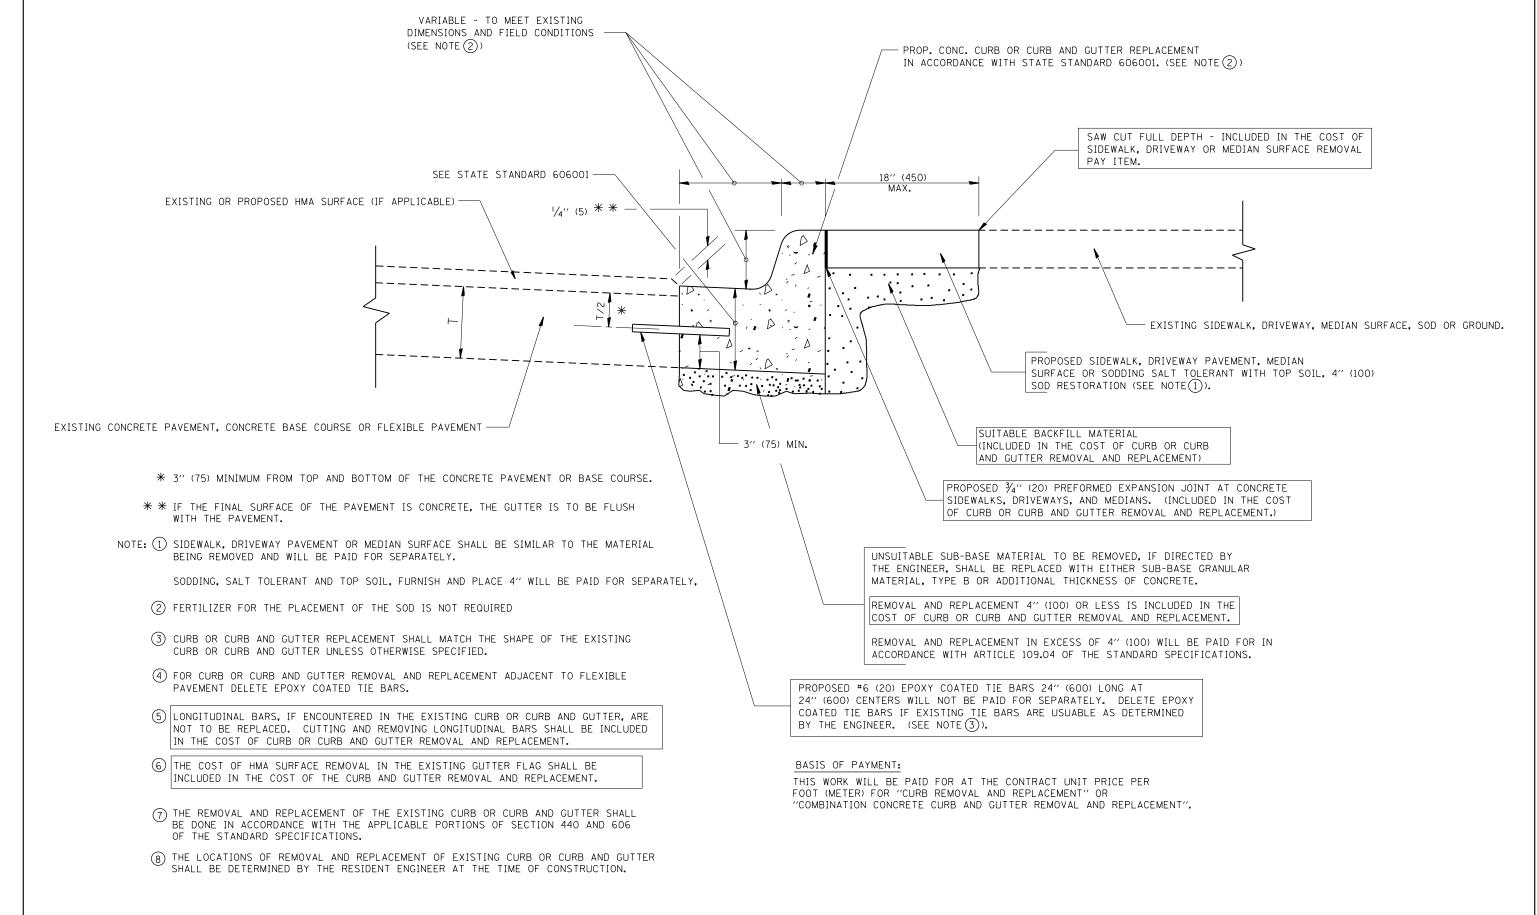


CURB OR CURB AND GUTTER REMOVAL AND REPLACEMENT


ALL DIMENSIONS ARE IN INCHES (MILLIMETERS) UNLESS OTHERWISE SHOWN.

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	PLOT DATE = 3/23/2017	DATE - 03-11-94	REVISED -	R. BORO 12-15-09

	CURB OR CURB AN	D GUTTER		F.A.U. RTE.	SECTION	COUNTY	TOTAL SHEETS	SHEET NO.
	REMOVAL AND REP	ACEMENT		1541	2016-079RS	COOK	20	11
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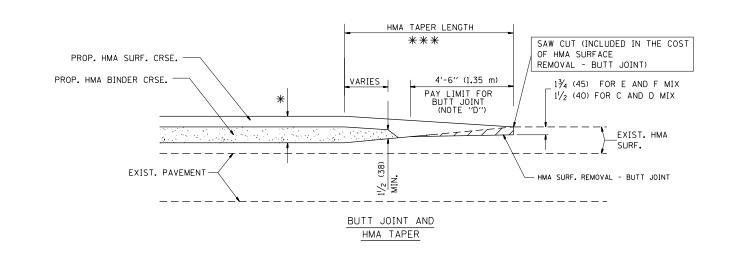
OPTION 1

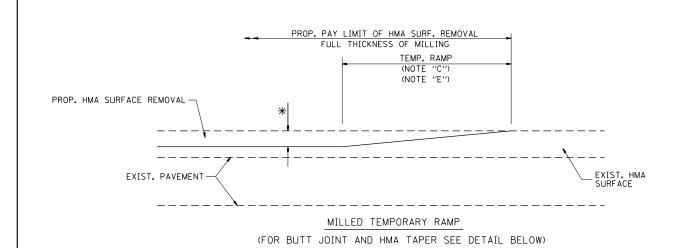

(FOR BUTT JOINT AND HMA TAPER SEE DETAIL BELOW)

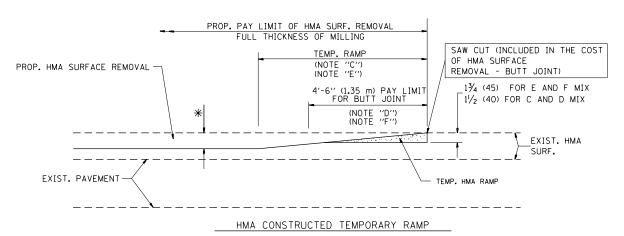OPTION 2

TYPICAL TEMPORARY RAMP



TYPICAL BUTT JOINT AND HMA TAPER FOR MILLING AND RESURFACING


STATE OF ILLINOIS
DEPARTMENT OF TRANSPORTATION


BUTT JOINT AND HMA TAPER DETAILS

SCALE: NONE SHEET NO. 1 OF 1 SHEETS STA. TO STA. FED. ROAD DIST, NO. 1 ILLINOISIFED, AID PROJECT

ALL DIMENSIONS ARE IN INCHES (MILLIMETERS) UNLESS

OTHERWISE SHOWN.

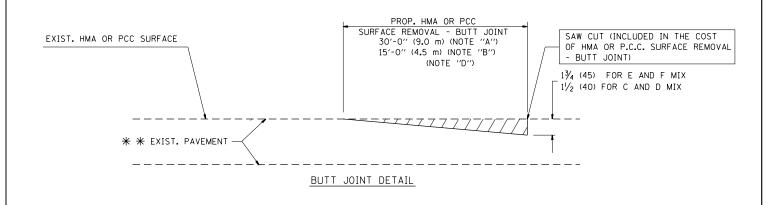

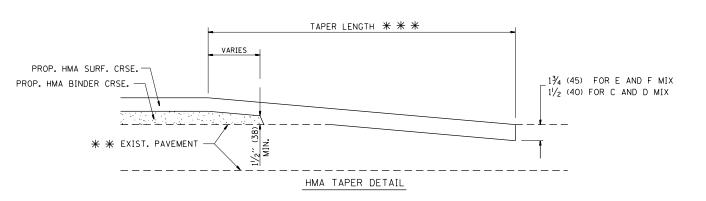

TYPICAL BUTT JOINT AND HMA TAPER FOR RESURFACING ONLY


* * PC CONCRETE, HMA OR HMA RESURFACED PAVEMENT.


NOTES

- A: MAINLINE ROADWAYS AND MAJOR SIDE ROADS.
- MINOR SIDE ROADS.
- C: THE TEMP. RAMP SHALL BE CONSTRUCTED IMMEDIATELY UPON REMOVAL OF THE EXISTING HMA SURFACE.
- D: THE BUTT JOINT SHALL BE CONSTRUCTED IMMEDIATELY PRIOR TO PLACING THE PROPOSED HMA COURSES.
- E: TAPER THE TEMP. RAMP AT A RATE OF 3'-0" (900 mm) PER 1 INCH (25 mm) OF MILLING THICKNESS.
- F: INSTALLATION AND REMOVAL OF THE 4'-6" (1.35 m) TEMP. RAMP IS INCLUDED IN COST OF HMA SURFACE REMOVAL BUTT JOINT
- G: SEE ARTICLE 406.08 AND 406.14 OF THE STANDARD SPECIFICATIONS FOR "HMA AND/OR PCC SURFACE REMOVAL, BUTT JOINT".
- * SEE TYPICAL SECTIONS FOR MILLING THICKNESS.

BASIS OF PAYMENT:

THE BUTT JOINT WILL BE PAID FOR AT THE CONTRACT UNIT PRICE PER SQUARE YARD (SQUARE METER) FOR "HOTT-MIX ASPHALT SURFACE REMOVAL - BUTT JOINT" OR FOR "PORTLAND CEMENT CONCRETE SURFACE REMOVAL- BUTT JOINT".

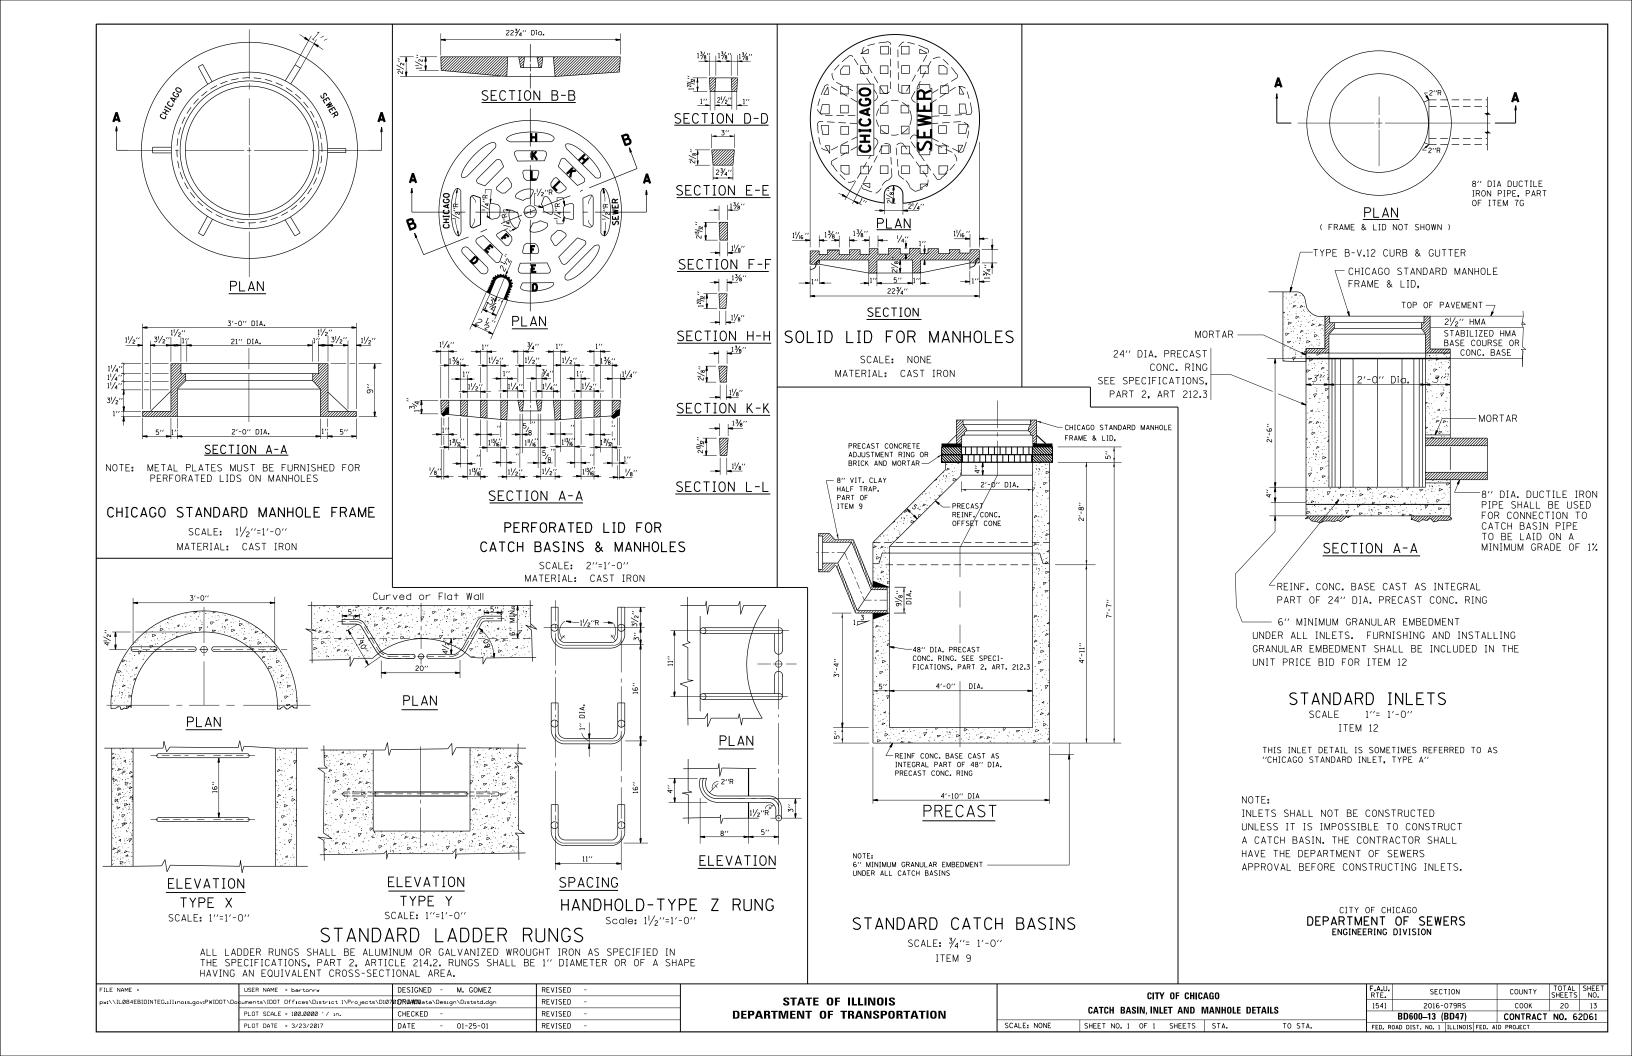

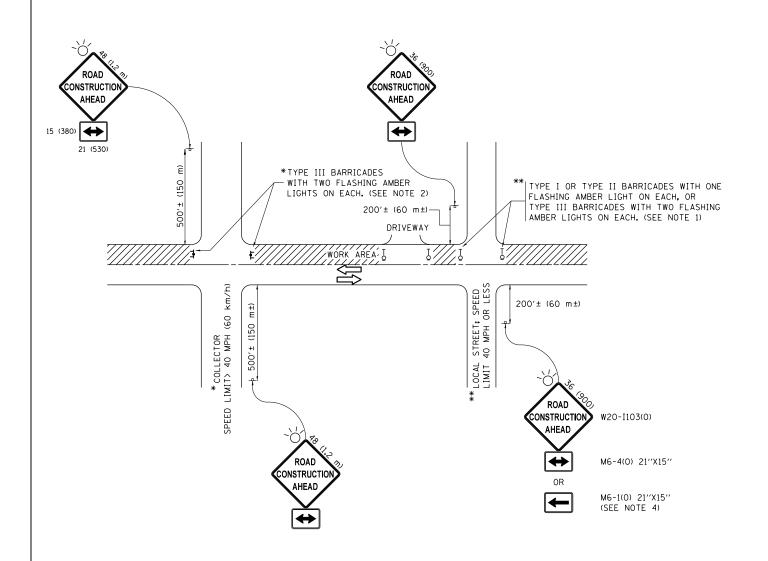

NOTES:

- SIDE ROAD WITH A SPEED LIMIT OF 40 MPH (60 km/h) OR LESS AS SHOWN ON THE DRAWING AND AS DIRECTED BY THE ENGINEER:
 - a) ONE "ROAD CONSTRUCTION AHEAD" SIGN 36 x 36 (900x900) WITH A FLASHER MOUNTED ON IT APPROXIMATELY 200" (60 m) IN ADVANCE OF THE MAIN ROUTE.
 - b) THE CLOSED PORTION OF THE MAIN ROUTE SHALL BE PROTECTED BY BLOCKING WITH TYPE I, TYPE II OR TYPE III BARRICADES, 1/3 OF THE CROSS SECTION OF THE CLOSED PORTION.
- 2. SIDE ROAD WITH A SPEED LIMIT GREATER THAN 40 MPH (60 km/h) AS SHOWN ON THE DRAWING AND AS DIRECTED BY THE ENGINEER:
 - a) ONE "ROAD CONSTRUCTION AHEAD" SIGN 48 x 48 (1.2 m x 1.2 m) WITH A FLASHER MOUNTED ON IT APPROXIMATELY 500" (150 m) IN ADVANCE OF THE MAIN ROUTE.
 - b) THE CLOSED PORTION OF THE MAIN ROUTE SHALL BE PROTECTED BY BLOCKING WITH TYPE III BARRICADES, 1/2 OF THE CROSS SECTION OF THE CLOSED PORTION.
- 3. CONES MAY BE SUBSTITUTED FOR BARRICADES OR DRUMS AT HALF THE SPACING DURING DAY OPERATIONS. CONES SHALL BE A MINIMUM OF 28 (710) IN HEICHT
- 4. WHEN THE SIDE ROAD LIES BETWEEN THE BEGINNING OF THE MAINLINE SIGNING AND THE WORK ZONE, A SINGLE HEADED ARROW (M6-1) SHALL BE USED IN LIEU OF THE DOUBLE HEADED ARROW (M6-4).

SCALE: NONE

- 5. WHEN WORK IS BEING PERFORMED ON A SIDE ROAD OR DRIVEWAY, FOLLOW THE APPLICABLE STANDARD(S). THE DIRECTIONAL ARROW (M6-1 OR M6-4) SHALL BE COVERED OR REMOVED WHEN NO LONGER CONSISTENT WITH THE TRAFFIC CONTROL SET-UP.
- 6. ADVANCE WARNING SIGNS ARE TO BE OMITTED ON DRIVEWAYS UNLESS OTHERWISE SPECIFIED IN THE PLANS OR BY THE ENGINFER.
- 7. THE TRAFFIC CONTROL AND PROTECTION FOR SIDE ROADS, INTERSECTIONS, AND DRIVEWAYS SHALL BE INCLUDED IN THE COST OF SPECIFIED TRAFFIC CONTROL STANDARDS OR ITEMS.


All dimensions are in inches (millimeters) unless otherwise shown.

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DEPARTMENT OF TRANSPORTATION	


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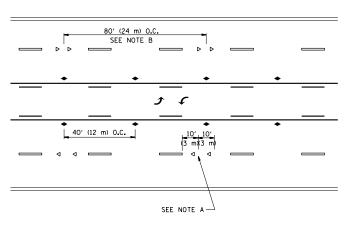
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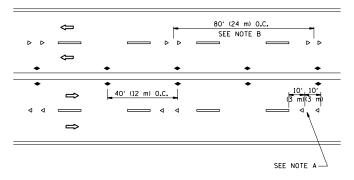
*** REDUCE TO 40' (12 m) O.C. ON CURVES WITH POSTED OR ADVISORY SPEED 45 M.P.H. (70 km/h) OR LESS.

TWO-LANE/TWO-WAY




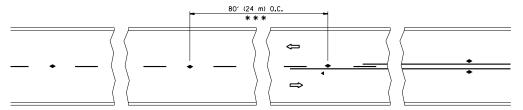

TWO-WAY LEFT TURN

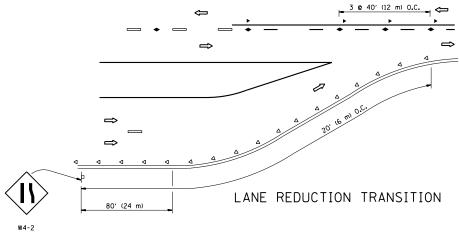

MULTI-LANE/UNDIVIDED

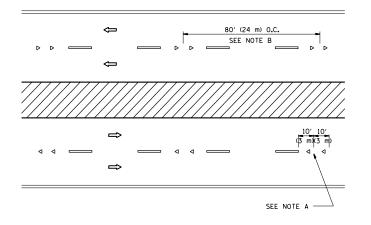

MULTI-LANE/DIVIDED

GENERAL NOTES

- MARKERS USED WITH DASHED LINES SHALL BE CENTERED IN THE GAP BETWEEN SEGMENTS.
- 2. MARKERS USED ADJACENT TO SOLID LINES SHALL BE OFFSET 2 TO 3 (50 TO 75) TOWARD TRAFFIC AS SHOWN.
- 3. MARKERS THROUGH TANGENTS LESS THAN 500' (150 m) IN LENGTH BETWEEN CURVES SHALL BE INSTALLED AT THE LESSER OF THE TWO CURVE SPACINGS.

LANE MARKER NOTES

A. USE DOUBLE LANE LINE MARKERS SPACED AS SHOWN.

B. REDUCE TO 40' (12 m) O.C. ON CURVES WHERE ADVISORY SPEEDS ARE 10 M.P.H (20 km/h) LOWER THAN POSTED SPEEDS.

SYMBOLS

---- YELLOW STRIPE

WHITE STRIPE

- ONE-WAY AMBER MARKER
- ONE-WAY CRYSTAL MARKER (₩/O)
- ◆ TWO-WAY AMBER MARKER


DESIGN NOTES

- 1. DOUBLE LANE LINE MARKERS SHALL BE USED UNLESS SPECIFIED OTHERWISE.
- 2. EXCEPT AS SHOWN ON THE LANE REDUCTION TRANSITION AND FREEWAY EXIT RAMP DETAIL, MARKERS ARE NOT TO BE SPECIFIED ON RIGHT EDGE LINES.
- 3. THE EXACT MARKER LIMITS, SPACING, AND COLOR SHALL BE INCLUDED IN THE PLANS WHEN STANDARD SPECIFICATIONS ARE NOT BEING USED.
- 4. MARKERS SHOULD NOT BE USED ALONGSIDE CURBS EXCEPT FOR EXTREMELY SHORT SECTIONS OF CURBS WHERE NOT MORE THAN TWO MARKERS WOULD BE INVOLVED.

LEFT TURN


All dimensions are in inches (millimeters) unless otherwise shown.

	FILE NAME =	USER NAME = bartonrw	DESIGNED -	REVISED	-T. RAMMACHER 09-19-94			TYPICAL APPLICATIONS		RTF.	SECTION	COUNTY	SHEETS NO.
	pw:\\IL084EBIDINTEG.:ll:no:s.gov:PWIDOT\Do	:uments\IDOT Offices\District 1\Projects\D1070	D TRAMIN ata\Design\Diststd.dgn	REVISED	-T. RAMMACHER 03-12-99	STATE OF ILLINOIS			.,	1541	2016-079RS	соок	20 15
		PLOT SCALE = 100.0000 ' / in.	CHECKED -	REVISED	-T. RAMMACHER 01-06-00	DEPARTMENT OF TRANSPORTATION	KAISED R	EFLECTIVE PAVEMENT MARKERS (SNO	<i>N</i> –PLOW RESISTANT)		TC-11	CONTRACT	NO. 62D61
L		PLOT DATE = 3/23/2017	DATE -	REVISED	- C. JUCIUS 09-09-09		SCALE: NONE	SHEET NO. 1 OF 1 SHEETS STA.	TO STA.	FED. ROAD	DIST. NO. 1 ILLINOIS FED. A		

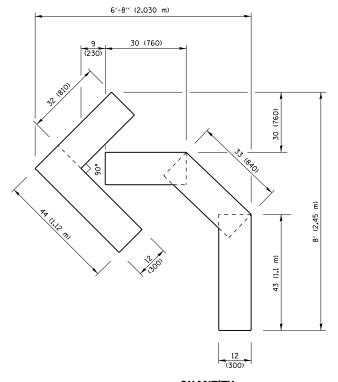


QUANTITY

4 (100) LINE = 45.5 ft. (13.9 m) 15.2 sq. ft. (1.41 sq. m)

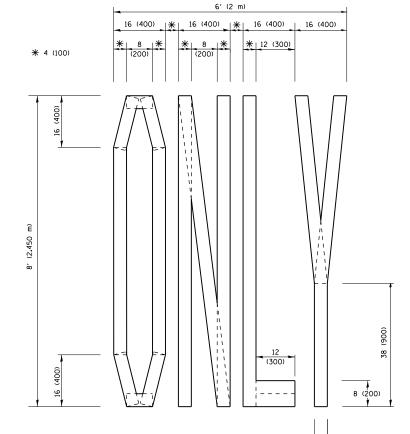

4 (100) LINE = 64.1 ft. (19.5 m) 21.4 sq. ft. (1.99 sq. m)

QUANTITY

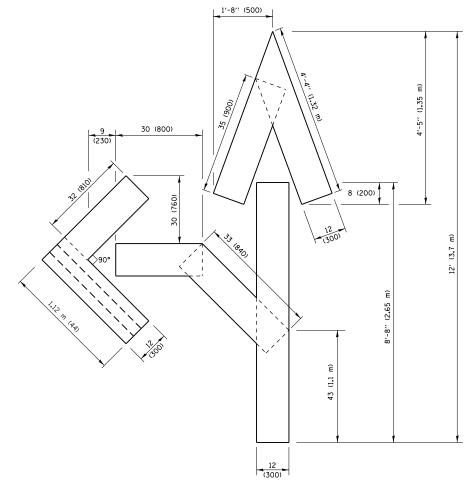


QUANTITY

4 (100) LINE = 82.5 ft. (25.1 m) 27.5 sq. ft. (2.53 sq. m)

NOTE:


ALL QUANTITIES OF PLACEMENT ARE REPRESENTED IN LINEAR FEET OF 4" LINES TO MATCH THE 4" TEMPORARY TAPE PAY ITEM AND REPRESENTS THE TOTAL QUANTITY OF 4" TAPE REQUIRED.

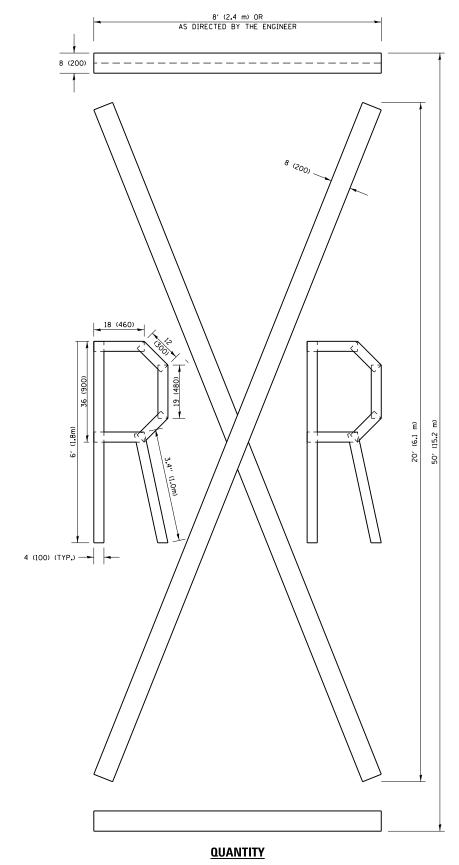

4 (100) LINE = 225.9 ft. (68.9 m) 75.3 sq. ft. (6.99 sq. m)

All dimensions are in inches (millimeters) unless otherwise shown.

FILE NAME =	USER NAME = bartonrw	DESIGNED -	REVISED -T. RAMMACHER 03-02-98			F.A.U. RTF.	SECTION	COUNTY	TOTAL SHEET
pw:\\ILØ84EBIDINTEG.:111:no:s.gov:PWIDOT\Do	cuments\IDOT Offices\District 1\Projects\D10	701 07RGAMDN ata\Design\Diststd.dgn	REVISED - E. GOMEZ 08-28-00	STATE OF ILLINOIS	SHORT TERM PAVEMENT MARKING LETTERS AND SYMBOLS	1541	2016-079RS	соок	20 16
	PLOT SCALE = 100.0010 ' / in.	CHECKED -	REVISED -E. GOMEZ 08-28-00	DEPARTMENT OF TRANSPORTATION			TC-16	CONTRACT	NO. 62D61
1	PLOT DATE = 3/23/2017	DATE - 09-18-94	REVISED - A. SCHUETZE 09-15-16		SCALE: NONE SHEET NO. 1 OF 1 SHEETS STA. TO STA.	FED. RO.	DAD DIST. NO. 1 ILLINOIS FED. A		

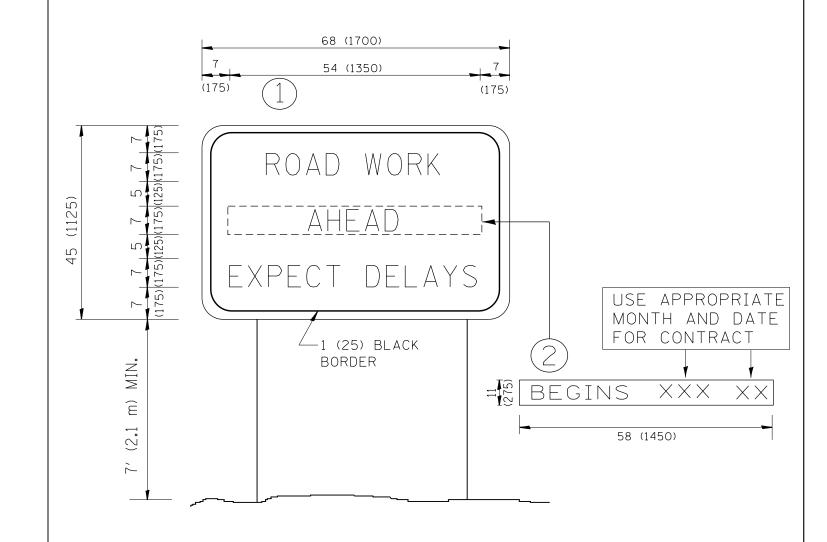



NOTES:


- 1. USE BLACK LETTERING ON ORANGE BACKGROUND.
- 2. ERECT SIGNS IN ADVANCE OF THE LOCATION FOR THE "ROAD CONSTRUCTION AHEAD" SIGN AT LOCATIONS AS DIRECTED BY THE ENGINEER.
- 3. ERECT SIGN (1) WITH INSTALLED PANEL (2) ONE WEEK PRIOR TO THE START OF CONSTRUCTION.
- 4. REMOVE PANEL (2) SOON AFTER THE START OF CONSTRUCTION.
- 5. SEE SPECIAL PROVISION FOR "TEMPORARY INFORMATION SIGNING" FOR ADDITIONAL INFORMATION.
- 6. ONE SIGN ASSEMBLY EQUALS 25.70 SQ. FT. (2.3 SQ. M.)
- 7. SHALL BE PAID FOR AS TEMPORARY INFORMATION SIGNING.

ALL DIMENSIONS ARE IN INCHES (MILLIMETERS) UNLESS OTHERWISE SHOWN.


Ī	FILE NAME =	USER NAME = bartonrw	DESIGNED -	REVISED - R. MIRS	S 09-15-97			ARTERIAL ROA	ın		F.A.U. RTF	SECTION	COUNTY	TOTAL	SHEET
	pw:\\IL084EBIDINTEG.:ll:no:s.gov:PWIDOT\Do	cuments\IDOT Offices\District 1\Projects\D107	01 0RAMUN ata\Design\Diststd.dgn		S 12-11-97	STATE OF ILLINOIS		INFORMATION			1541	2016-079RS	соок	20	17
		PLOT SCALE = 100.0000 ' / in.	CHECKED -		CHER 02-02-99	DEPARTMENT OF TRANSPORTATION			SIGN			TC-22	CONTRACT	NO. 62	2D61
		PLOT DATE = 3/23/2017	DATE -	REVISED - C. JUCI	CIUS 01-31-07		SCALE: NONE	SHEET NO. 1 OF 1 SHEETS	STA.	TO STA.	FED. ROAD DI	ST. NO. 1 ILLINOIS FED. A	D PROJECT		

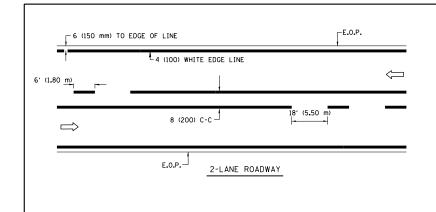


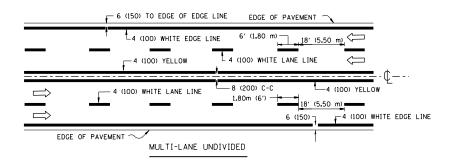

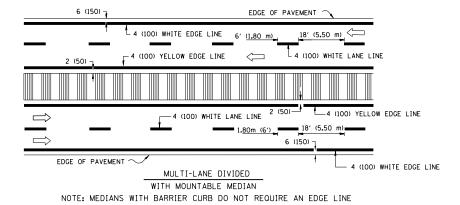

TYPICAL LANE AND EDGE LINE MARKING

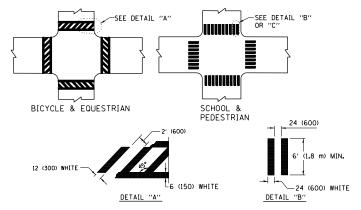


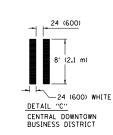


2-4 (100) © 8 (200) C-C (MINIMUM 5)

- *FOR MEDIAN LENGTHS WHERE DIAGONAL SPACING CANNOT BE ATTAINED, USE 5 (FIVE) EQUALLY SPACED DIAGONAL LINES.
- * DIAGONAL LINE SPACING: 20' (6.1 m) C-C

PAINTED MEDIANS

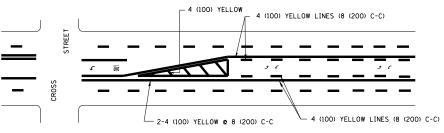


A MINIMUM OF TWO PAIRS OF TURN ARROWS SHALL BE USED, WHITE IN COLOR. ADDITIONAL PAIRS SHALL BE PLACED AT 200' (60 m) TO 300' (90 m) INTERVALS

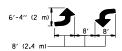

MEDIAN WITH TWO-WAY LEFT TURN LANE

TYPICAL PAINTED MEDIAN MARKING

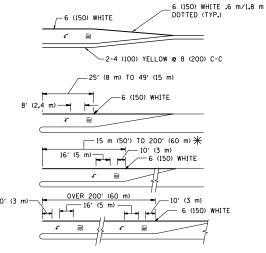


FULL SIZE LETTERS 8' (2.4 m) AND ARROWS SHALL BE USED. \P AREA = 15.8 SO. FT. (1.47 m²) ONLY AREA = 22.9 SO. FT. (2.13 m²)

* TURN LANES IN EXCESS OF 400' (120 m) IN LENGTH MAY HAVE AN ADDITIONAL SET OF ARROW - "ONLY" INSTALLED MIDWAY BETWEEN THE OTHER TWO SETS OF ARROW - "ONLY".

TYPICAL LEFT (OR RIGHT) TURN LANE

TYPICAL TURN LANE MARKING

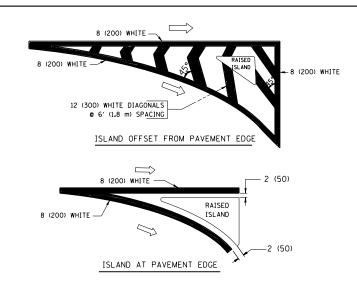

TYPICAL ISLAND MARKING

TURE OF HARMING				CD LOVID / DELLIBUS
TYPE OF MARKING	WIDTH OF LINE	PATTERN	COLOR	SPACING / REMARKS
CENTERLINE ON 2 LANE PAVEMENT	4 (100)	SKIP-DASH	YELLOW	6' (1.80 m) LINE WITH 18' (5.50 m) SPACE
CENTERLINE ON MULTI-LANE UNDIVIDED PAVEMENT	2 @ 4 (100)	SOLID	YELLOW	8 (200) C-C
NO PASSING ZONE LINES: FOR ONE DIRECTION FOR BOTH DIRECTIONS	4 (100) 2 @ 4 (100)	SOLID SOLID	YELLOW YELLOW	8 (200) C-C
LANE LINES	4 (100) 5 (125) ON FREEWAYS	SKIP-DASH SKIP-DASH	WHITE WHITE	6' (1.80 m) LINE WITH 18' (5.50 m) SPACE
DOTTED LINES (EXTENSIONS OF CENTER, LANE OR TURN LANE MARKINGS)	SAME AS LINE BEING EXTENDED	SKIP-DASH	SAME AS LINE BEING EXTENDED	2' (600) LINE WITH 6' (1.8) SPACE
EDGE LINES	4 (100)	SOLID	YELLOW-LEFT WHITE-RIGHT	OUTLINE MOUNTABLE MEDIANS IN YELLOW: EDGE LINES ARE NOT USED NEXT TO BARRIER CURB
TURN LANE MARKINGS	6 (150) LINE; FULL SIZE LETTERS & SYMBOLS (8' (2.4 m))	SOLID	WHITE	SEE TYPICAL TURN LANE MARKING DETAIL
TWO WAY LEFT TURN MARKING	2 @ 4 (100) EACH DIRECTION	SKIP-DASH AND SOLID	YELLOW	6' (1.8 m) LINE WITH 18' (5.50 m) SPACE FOR SKIP-DASH: 8 (200) C-C BETWEEN SOLID LINE AND SKIP-DASH LINE
	8' (2.4 m) LEFT ARROW	IN PAIRS	WHITE	SEE TYPICAL TWO-WAY LEFT TURN MARKING DETAIL
CROSSWALK LINES A. DIAGONALS (BIKE & EQUESTRIAN) B. LONGITUDINAL BARS (SCHOOL & PEDESTRIAN)	12 (300) © 45° 24 (600) © 90°	SOLID SOLID	WHITE WHITE	2' (600) APART 2' (600) APART SEE TYPICAL CROSSWALK MARKING DETAILS.
STOP LINES	24 (600)	SOLID	WHITE	PLACE 4' (1.2 m) IN ADVANCE OF AND PARALLEL TO CROSSMALK, IF PRESENT, OTHERNISE, PLACE AT DESIRED STOPPING POINT. PARALLEL TO CROSSROAD CENTERLINE, WHERE POSSIBLE
PAINTED MEDIANS	2 @ 4 (100) WITH 12 (300) DIAGONALS @ 45°	SOLID	YELLOW: TWO WAY TRAFFIC WHITE: ONE WAY TRAFFIC	8 (200) C-C FOR THE DOUBLE LINE SEE TYPICAL PAINTED MEDIAN MARKING.
GORE MARKING AND CHANNELIZING LINES	8 (200) WITH 12 (300) DIAGONALS @ 45°	SOLID	WHITE	DIAGONALS: 20' (6.1 m) (LESS THAN 30 MPH (50 km/h))
RAILROAD CROSSING	24 (600) TRANSVERSE LINES; "RR" IS 6' (1.8 m) LETTERS; 16 (400) LINE FOR "X"	SOLID	WHITE	SEE STATE STANDARD 780001 AREA OF: "R":3.6 SO. FT. (0.33m²) EACH "X":54.0 SO. FT. (5.0 m²)


FOR FURTHER DETAILS ON PAVEMENT MARKING REFER TO STREET MARKING STANDARDS. PRINTED BY CITY OF CHICAGO. DEPARTMENT OF TRANSPORTATION, BUREAU OF TRAFFIC


ALL DIMENSIONS ARE IN INCHES (MILLIMETERS) UNLESS OTHERWISE SHOWN.

ı	FILE NAME =	USER NAME = bartonrw	DESIGNED -	REVISED	-T. RAMMACHER	12-07-00
	pw:\\IL084EBIDINTEG.:ll:nois.gov:PWIDOT\Do	cuments\IDOT Offices\District 1\Projects\D107	Ø IDRIMMIN ata\Design\Diststd.dgn	REVISED	- K. ENG	02-28-12
		PLOT SCALE = 100.0000 ' / in.	CHECKED -	REVISED	-	
		PLOT DATE = 3/23/2017	DATE -	REVISED	-	

TYPICAL CROSSWALK MARKING

	CITY O	F CHICAGO		RTE.	SECTION	COUNTY	SHEETS	NO.
	TYDICAL DAVE	MENT MARKINGS	1541	2016-079RS	соок	20	18	
	TIFICAL FAVE		TC-24	CONTRACT	NO. 6	2D61		
SCALE: NONE	SHEET NO. 1 OF 3 SI	FED. R	DAD DIST. NO. 1 ILLINOIS FED. A	ID PROJECT				

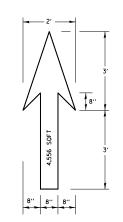

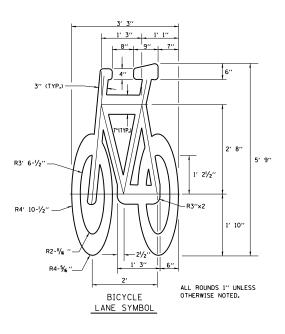


- NOTE:

 1.) FOR BIKE LANE SYMBOLS ONLY,

 USE PRE-FORMED THERMOPLASTIC

 WITH A MINIMUM THICKNESS OF 90 MILS, MINIMUM SKID RESISTANCE VALUE OF 60 BPN, & A MINIMUM INDEX OF REFRACTION OF 1.50.
- 2.) THE RESIDENT ENGINEER SHALL CONTACT MR. BEN GOMBERG AT 312-744-8093 AT LEAST ONE CALENDAR WEEK PRIOR TO INSTALLING BIKE LANE SYMBOLS.

TYPICAL BIKE LANE SYMBOLS DRAWING #28

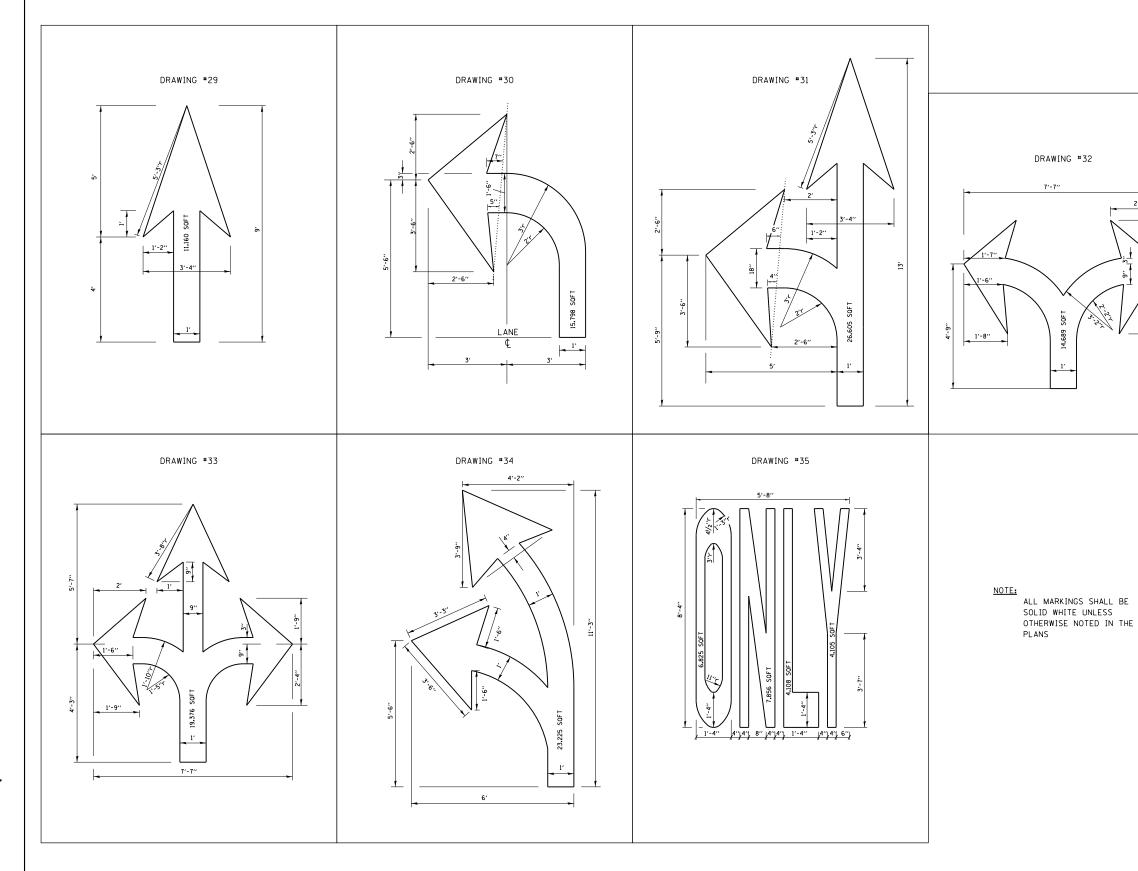

FILE NAME =	USER NAME = bartonrw	DESIGNED -	REVISED -	r. RAMMACH	HER 12	2-07-00			CITY OF CHIC	:AGO		F.A.U. RTE.	SECTION	COUNTY	TOTAL SHEET
pw:\\IL084EBIDINTEG.:Ill:nois.gov:PWIDOT\Documents\IDOT Offices\District !\Projects\D1070 DRAMD ata\Design\Diststd.dgn				K. ENG	0	01-12-12	STATE OF ILLINOIS	TYPICAL PAVEMENT MARKINGS				1541	2016-079RS	соок	20 19
	PLOT SCALE = 100.0000 ' / in. CHECKED -			REVISED -			DEPARTMENT OF TRANSPORTATION					TC-24	CONTRACT NO. 62D61		
	PLOT DATE = 3/23/2017	DATE -	REVISED -					SCALE: NONE	SCALE: NONE SHEET NO. 2 OF 3 SHEETS STA. TO STA. FE			FED. ROA	ED. ROAD DIST. NO. 1 ILLINOIS FED. A		

