TRAFFIC DATA

ADT (2010) = 20,300

POSTED SPEED LIMIT = 35 MPH DESIGN SPEED LIMIT = 40 MPH

DESIGN DESIGNATION

PROJECT LOCATED IN THE

VILLAGE OF NORRIDGE

STATE OF ILLINOIS
DEPARTMENT OF TRANSPORTATION
DIVISION OF HIGHWAYS
PLANS FOR PROPOSED
FEDERAL AID HIGHWAY
FAU ROUTE 2729 (MONTROSE AVENUE)
CANFIELD AVENUE TO SAYRE AVENUE
RESURFACING

SECTION NO. 10-00060-00-RS
PROJECT NO. TCSP-M-9003(748)

VILLAGE OF NORRIDGE COOK COUNTY

Call
Before
You Dig

ILLINOIS
ONE-CALL SYSTEM

PROJECT BEGINS STATION 1+00 MONTROSE AVENUE

0 10' 20' SCALE: 1" = 10'
0 20' 40'

0 30' 60' SCALE: 1" = 30'


0 40' 80' SCALE: 1" = 40'

0 50' 100' SCALE: 1" = 50'

FULL SIZE PLANS HAVE BEEN PREPARED USING STANDARD ENGINEERING SCALES. REDUCED SIZED PLANS WILL NOT CONFORM TO STANDARD SCALES. IN MAKING MEASUREMENTS ON REDUCED PLANS, THE ABOVE SCALES MAY BE USED.

SCALE: 1" = 20'

CONTRACT NO. 63582

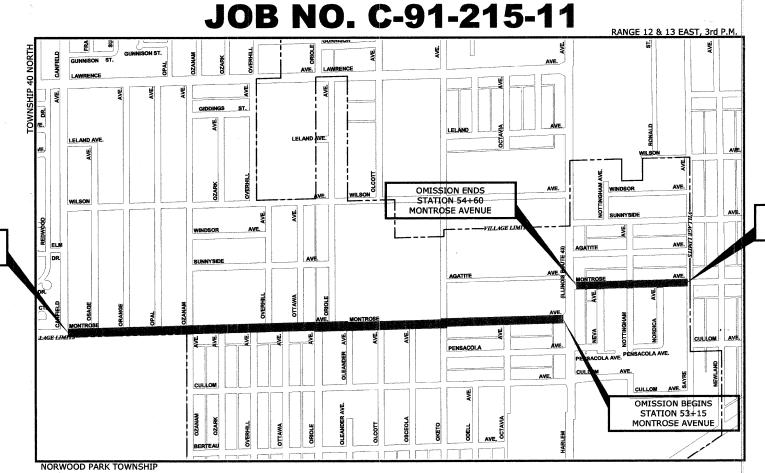

- AREA OF IMPROVEMENT NOT TO SCALE

GROSS LENGTH OF IMPROVEMENT = 6,545 FT (1.24 MI.) NET LENGTH OF IMPROVEMENT = 6,400 FT (1.21 MI.) ROUTE NO. SECTION COUNTY TOTAL SHEET NO.

FAU 2729 10-00060-00-RS COOK 17 1

ILLINOIS PROJECT TCSP-M-9003(748)

CONTRACT NO. 63382



STATE OF ILLINOIS ILLINOIS
DEPARTMENT OF TRANSPORTATION
DIVISION OF HIGHWAYS

APPROVED

APPROVED

APPROVED

VILLAGE OF NORRIGGE, PRESIDENT

PASSED

APPRIL 11

20 11

CHARLESTOPHER
DISTRICT ENGINEER OF LOCAL ROADS & STREETS

RELEASED FOR BID
BASED ON LIMITED

Y DIRECTOR OF HIGHWAYS,
REGION 1 ENGINEER

PRINTED BY THE AUTHORITY
OF THE STATE OF ILLINOIS

STATION 66+45
MONTROSE AVENUE



DATE SIGNED: 03-29-//

EDWIN HANCOCK ENGINEERING COMPANY 9933 ROOSEVELT ROAD PHONE: (708) 865-0300 WESTCHESTER, ILLINOIS 60154

INDEX OF SHEETS

SHEET NO.	DESCRIPTION
1	COVER SHEET, LOCATION MAP
2	INDEX OF SHEETS, I.D.O.T. STANDARD DRAWINGS, LEGEND OF SYMBOLS, AND GENERAL NOTES
3	SUMMARY OF QUANTITIES
4	EXISTING AND PROPOSED TYPICAL CROSS SECTIONS
5-9	MONTROSE AVENUE PAVING PLAN
10	DETECTOR LOOP DETAILS
11	DETAILS
12	DETAILS FOR FRAMES AND LIDS ADJUSTMENT WITH MILLING (BD 08)
13	PAVEMENT PATCHING FOR HMA SURFACE PAVEMENT (BD 22)
14	BUTT JOINT AND HMA TAPER DETAILS (BD 32)
15	TRAFFIC CONTROL AND PROTECTION FOR SIDE ROADS, INTERSECTIONS, AND DRIVEWAYS (TC 10)
16	TYPICAL APPLICATIONS RAISED REFLECTIVE MARKERS (SNOW-PLOW RESISTANT) (TC 11)

I.D.O.T. STANDARD DRAWINGS

DISTRICT ONE TYPICAL PAVEMENT MARKINGS (TC 13)

STANDARD NO.	TITLE OR DESCRIPTION
000001-06	STANDARD SYMBOLS, ABBREVIATIONS AND PATTERNS
424001-05	CURB RAMPS FOR SIDEWALKS
442201-03	CLASS C&D PATCHES
604001-03	FRAMES AND LIDS, TYPE 1
701501-06	URBAN LANE CLOSURE, 2-LANE, 2-WAY, UNDIVIDED
701606-07	URBAN LANE CLOSURE, MULTILANE, 2W WITH MOUNTABLE MEDIAN
701701-07	URBAN LANE CLOSURE, MULTILANE INTERSECTION
701801-04	LANE CLOSURE, MULTILANE, 1W OR 2W CROSSWALK OR SIDEWALK CLOSURE
701901-01	TRAFFIC CONTROL DEVICES
780001-02	TYPICAL PAVEMENT MARKINGS

LEGEND OF SYMBOLS

EXISTING	PROPOSED	DESCRIPTION
0	•	MANHOLE
		INLET
0	•	CATCH BASIN
Я		FIRE HYDRANT
		WATER MAIN VALVE VAULT
Ø		POWER POLE
\$		STREET LIGHT
627.60 620.35	627.60 620.35	RIM ELEVATION INVERT ELEVATION
	Ā	STRUCTURE TO BE ADJUSTED
	A*	STRUCTURE TO BE ADJUSTED (SPECIAL)
	1C	TYPE 1 FRAME AND CLOSED LID
	1P	TYPE 1 FRAME AND OPEN LID
	RC	STRUCTURE TO BE RECONSTRUCTED

GENERAL NOTES

STANDARDS

REFERENCES TO STANDARDS IN THE PLANS AND SPECIAL PROVISIONS SHALL BE THE LATEST STANDARD OF THE ILLINOIS DEPARTMENT OF TRANSPORTATION AS SHOWN ON THE INDEX OF SHEETS. ALL CONSTRUCTION SHALL BE IN ACCORDANCE WITH THE "STANDARD SPECIFICATIONS FOR ROAD AND BRIDGE CONSTRUCTION" ADOPTED JANUARY 1, 2007, THE "SUPPLEMENTAL SPECIFICATIONS AND RECURRING SPECIAL PROVISIONS" ADOPTED JANUARY 1, 2011, THE LATEST EDITION OF THE "ILLINOIS MANUAL ON UNIFORM TRAFFIC CONTROL DEVICES FOR STREETS AND HIGHWAYS". "THE STANDARD SPECIFICATIONS FOR WATER AND SEWER MAIN CONSTRUCTION IN ILLINOIS" JULY 2009 SIXTH EDITION. THE DETAILS IN THE PLANS, AND THE SPECIAL PROVISIONS.

UNDERGROUND UTILITIES

BEFORE STARTING EXCAVATION, THE CONTRACTOR SHALL CALL "JULIE" AT 811 FOR FIELD LOCATIONS OF BURIED **ELECTRICAL, TELEPHONE AND GAS FACILITIES (48 HOURS NOTIFICATION IS REQUIRED)**

THE LOCATIONS OF THE UNDERGROUND UTILITIES, IE SHOWN ON THE PLANS, HAVE BEEN ORTAINED BY FIELD SURVEYS AND SEARCHES OF AVAILABLE RECORDS. IT IS BELIEVED THAT DATA IS ESSENTIALLY CORRECT, BUT THE VILLAGE OF NORRIDGE, THE ILLINOIS DEPARTMENT OF TRANSPORTATION AND/OR OTHER OFFICES AND AGENCIES ASSOCIATED WITH THE DEVELOPMENT OF THESE PLANS DO NOT GUARANTEE THEIR ACCURACY OR COMPLETENESS. THE CONTRACTOR WILL BE REQUIRED TO VERIFY THE LOCATION OF EACH FACILITY WITH THE UTILITY COMPANY, AND SHALL TAKE DUE CARE IN ALL PHASES OF THE CONSTRUCTION TO PROTECT SUCH FACILITIES THAT MAY BE AFFECTED BY THE WORK. ALL DAMAGE TO EXISTING UTILITIES SHALL BE REPAIRED AT THE CONTRACTOR'S EXPENSE IN ACCORDANCE WITH ARTICLES 107.20 AND 107.31.

THE CONTRACTOR SHALL COORDINATE CONSTRUCTION ACTIVITIES WITH UTILITY OWNERS AND THE ENGINEER.

NOTIFICATION OF RESIDENTS

THE CONTRACTOR WILL BE RESPONSIBLE FOR PROVIDING WRITTEN NOTICE TO ALL RESIDENCES AND/OR PLACES OF BUSINESS AT LEAST ONE (1) WORKING DAY PRIOR TO PERFORMING ALL CONSTRUCTION ACTIVITY THAT WILL ELIMINATE ACCESS TO THEIR PROPERTY. THE WRITTEN NOTICE SHALL BE APPROVED BY THE ENGINEER AND A COPY PROVIDED TO THE VILLAGE PRIOR TO THE BEGINNING OF CONSTRUCTION.

MAINTENANCE OF TRAFFIC

MONTROSE AVENUE WILL REMAIN OPEN TO THRU TRAFFIC DURING ALL OPERATIONS. FLAGGERS SHALL BE USED FOR THE INSTALLATION OF THE POLYMERIZED LEVELING BINDER, THE HOT-MIX ASPHALT SURFACE AND THERMOPLASTIC STRIPING

FIELD OFFICE

THE CONTRACTOR WILL NOT BE ALLOWED TO SET UP A YARD OR FIELD OFFICE ON STATE OR VILLAGE PROPERTY ROW WITHOUT WRITTEN PERMISSION FROM THE ENGINEER.

BARRICADES

THE CONTRACTOR SHALL PROVIDE AND INSTALL TWO (2) WEIGHTED SANDBAGS ON EACH TYPE I OR TYPE II BARRICADE USED, ONE (1) WEIGHTED SANDBAG ACROSS EACH BOTTOM RAIL.

OPEN EXCAVATIONS

THE CONTRACTOR SHALL NOT BE ALLOWED TO LEAVE EXCAVATION NECESSARY FOR PAVEMENT PATCHES OR STRUCTURE ADJUSTMENTS OPEN OVERNIGHT. THE CONTRACTOR SHALL BE RESPONSIBLE FOR COMPLETELY BACKFILLING OR INSTALLING A PLATE OVER ALL EXCAVATIONS AT THE END OF EACH DAY IN ACCORDANCE WITH ARTICLE 107.09.

CONCRETE BREAKERS

WHEN REMOVING PAVEMENT AND/OR ANY OTHER STRUCTURES, THE USE OF ANY TYPE OF CONCRETE BREAKERS SUCH AS DROP HAMMERS, WHICH MIGHT DAMAGE UNDERGROUND PUBLIC OR PRIVATE UTILITIES, WILL NOT BE PERMITTED. UNDER NO CIRCUMSTANCES WILL THE USE OF A FROST BALL BE PERMITTED .

THE CONTRACTOR SHALL SAW CLIT ASPHALT PAVEMENT AS INDICATED ON THE PLANS TO SEPARATE THE EXISTING PAVEMENT TO BE REMOVED BY APPROVED MEANS OR AN APPROVED CONCRETE SAW TO A DEPTH AS DIRECTED BY THE ENGINEER. SUITABLE GUIDELINES OR DEVICES SHALL BE USED TO ASSURE CUTTING A NEAT, STRAIGHT LINE AS SHOWN ON THE PLANS. CARE SHALL BE TAKEN BY THE CONTRACTOR NOT TO DAMAGE THE REMAINING PAVEMENT DIRECTLY ADJACENT TO THE PAVEMENT TO BE REMOVED. DAMAGE TO THE EXISTING PAVEMENT RESULTING FROM PAVEMENT REMOVAL OPERATIONS SHALL BE REPAIRED AT THE CONTRACTOR'S EXPENSE. THE COST OF SAW CUTTING DESCRIBED ABOVE SHALL BE INCLUDED IN THE COST OF ITEM BEING REMOVED.

CURB AND GUTTER TRANSITIONS

TRANSITIONS FROM THE PROPOSED CURB AND GUTTERS TO THE DEPRESSED CURB AND GUTTERS AND PROPOSED CURB AND GUTTERS TO EXISTING CURB AND GUTTERS SHALL BE CONSTRUCTED AS DIRECTED BY THE ENGINEER.

THIS WORK WILL NOT BE PAID FOR SEPARATELY BUT WILL BE INCLUDED IN THE UNIT PRICE OF THE RESPECTIVE COMBINATION CONCRETE CURB AND GUTTER ITEMS.

PAVEMENT PATCHING

LOCATIONS OF PATCHES WILL BE DETERMINED IN FIELD BY ENGINEER AFTER MILLING OPERATIONS.

CURING AND PROTECTION

AFTER THE CONCRETE HAS BEEN FINISHED AND THE WATER SHEEN HAS DISAPPEARED FROM THE SURFACE OF THE CONCRETE, THE SURFACE SHALL BE SEALED WITH MEMBRANE CURING COMPOUND OF A TYPE APPROVED BY THE ENGINEER. THE SEAL SHALL BE MAINTAINED FOR THE SPECIFIED CURING PERIOD. THE EDGES OF THE CONCRETE SHALL ALSO BE SEALED IMMEDIATELY AFTER THE FORMS ARE REMOVED. IN ADDITION, ALL CONCRETE PLACED DURING PERIODS OF COLD WEATHER SHALL BE PROTECTED IN ACCORDANCE WITH ARTICLE 720.13 OF THE STANDARD SPECIFICATIONS. THIS WORK SHALL BE INCLUDED IN THE COST OF THE CONTRACT.

THE WORK SHALL BE UNDER THE CHARGE AND CARE OF THE CONTRACTOR UNTIL FINAL ACCEPTANCE BY THE DEPARTMENT. THE CONTRACTOR SHALL ASSUME ALL RESPONSIBILITY FOR INJURY OR DAMAGE TO THE WORK FROM ANY CAUSE WHATSOEVER AND HE SHALL REBUILD, REPAIR OR RESTORE THE DAMAGED WORK AT HIS OWN EXPENSE

THIS ITEM WILL NOT BE PAID FOR SEPARATELY BUT WILL BE INCLUDED IN THE UNIT PRICE FOR THE VARIOUS CONCRETE ITEMS IN THE CONTRACT.

MAINTENANCE OF EXISTING DRAINAGE STRUCTURES

WHEN LOOSE MATERIAL IS DEPOSITED IN THE FLOW LINE OF GUTTERS AND DRAINAGE STRUCTURE OBSTRUCTING THE NATURAL FLOW OF WATER, THE LOOSE MATERIAL SHALL BE REMOVED AT THE CLOSE OF EACH WORKING DAY. AT THE CONCLUSION OF THE CONSTRUCTION OPERATIONS, ALL DRAINAGE FACILITIES SHALL BE CLEAN AND FREE OF ALL **OBSTRUCTIONS CAUSED BY CONSTRUCTION OPERATIONS.**

MAINTENANCE OF SEWER FLOWS

THE CONTRACTOR SHALL CONDUCT HIS/HER OPERATIONS TO MAINTAIN FLOW AT ALL TIMES THROUGH EXISTING STORM AND SANITARY SEWER SYSTEMS. HE/SHE SHALL PROVIDE AND MAINTAIN AN EFFICIENT PUMPING PLANT, IF NECESSARY, AND A TEMPORARY OUTLET AND BE PREPARED AT ALL TIMES TO DISPOSE OF THE WATER COLLECTED IN A SAFE MANNER WITHOUT DAMAGE OF ANY KIND TO ADJACENT PROPERTIES. THE ENDS OF EXISTING DRAINAGE LINES THAT ARE NOT TO BE INCORPORATED INTO THE PROJECT ARE TO BE SEALED AS SPECIFIED IN THE SPECIAL PROVISIONS. EXISTING STRUCTURES ARE TO BE INSPECTED BEFORE CONSTRUCTION STARTS - ACCUMULATION OF MATERIAL IN THE STRUCTURE DUE TO CONSTRUCTION OPERATIONS SHALL BE REMOVED BY THE CONTRACTOR AT HIS/HER EXPENSE.

FRAMES AND LIDS

THE LOCATION AND TYPE OF FRÂMES AND LIDS REQUIRED FOR ALL MANHOLES AND VALVE VAULTS LISTED IN THE SUMMARY OF QUANTITIES MAY BE FOUND ON THE PLANS. WHERE LIDS ARE CALLED FOR ON THE PLANS. THEY SHALL BE IN ACCORDANCE WITH ARTICLE 604.04 OF THE STANDARD SPECIFICATIONS AND THE TERM LID IS USED IN LIEU OF GRATE. ALL. LIDS ON SANITARY MANHOLES. COMBINED SEWER MANHOLES. AND VALVE VAULTS SHALL BE OF THE SELF SEALING TYPE.

THE FRAMES AND LIDS OF EXISTING CATCH BASINS, INLETS, MANHOLES, AND VALVE VALUES. THAT ARE TO BE ABANDONED ARE TO REMAIN THE PROPERTY OF THE VILLAGE OF NORRIDGE. THE CONTRACTOR IS TO DELIVER FRAMES AND LIDS TO THE VILLAGE OF NORRIDGE PUBLIC WORKS YARD LOCATED AT 8415 W FOSTER AVENUE. THE COST OF THIS WORK SHALL BE INCLUDED IN THE COST OF EACH BID ITEM.

FRAMES AND LIDS, TYPE 1

ALL COMBINED SEWER CLOSED LIDS SHALL BE SELF-SEALING WITH RECESSED PICK HOLES. ALL FRAMES WITH CLOSED LIDS TO BE FURNISHED AS PART OF THIS CONTRACT FOR CONSTRUCTION, ADJUSTMENT, OR RECONSTRUCTION OF ANY MANHOLE OR VALVE VAULT SHALL HAVE CAST INTO THE LID ONE OF THE FOLLOWING WORDS:

STRUCTURE TYPE	NEENAH FOUNDRY* FRAME AND LID	SELF SEALING	WORD CAST INTO LID
SANITARY MANHOLE	R-1713-B	YES	SANITARY
COMBINATION MANHOLE	R-1713-B	YES	SANITARY
STORM MANHOLE	R-1713-B	NO	STORM
VALVE VAULT	R-1713-B	YES	WATER
CATCH BASIN	R-2504-D	NO	retines statement from
INLET	R-2504-D	NO	***************************************

^{*} NOTE: OR ENGINEER APPROVED EQUAL.

PRECAST CONCRETE SECTIONS FOR STRUCTURES

ALL NEW STRUCTURES AND STRUCTURES TO BE RECONSTRUCTED SHALL BE BUILT WITH PRECAST REINFORCED CONCRETE SECTIONS FABRICATED IN ACCORDANCE WITH A.S.T.M. DESIGNATION C-478.

CONNECTING EXISTING PIPES TO STRUCTURES

ANY PIPE, UP TO FOUR FEET (4') IN LENGTH PER EACH PIPE AND THE NECESSARY TRENCH BACKFILL, USED TO CONNECT EXISTING PIPES TO THE STRUCTURE TO BE RECONSTRUCTED OR TO THE NEW STRUCTURE SHALL BE INCLUDED IN THE COST OF THE STRUCTURE TO BE RECONSTRUCTED OR THE NEW STRUCTURE.

CONNECTION OF DISSIMILAR PIPE MATERIALS

NON-SHEAR CONNECTORS SHALL BE USED WHERE NEW SEWER PIPES ARE TO BE CONNECTED TO EXISTING SEWER PIPES. THE NON-SHEAR CONNECTORS SHALL CONSIST OF A SYNTHETIC RUBBER SLEEVE, WHICH WILL RESIST DETERIORATION CAUSED BY WASTES FOUND IN SEWERS AND TWO STAINLESS STEEL STRAPS. THE CONNECTORS SHALL BE "MISSION" COUPLINGS, "FERNCO" COUPLINGS, OR ENGINEER APPROVED EQUAL. ALL LABOR AND MATERIAL REQUIRED TO CONNECT NEW SEWER PIPE TO EXISTING SEWER PIPE SHALL BE CONSIDERED INCLUDED IN THE COST OF THE CONTRACT.

FORMS FOR CONCRETE SIDEWALKS, DRIVEWAYS AND GUTTER FLAGS

THIS WORK SHALL BE IN ACCORDANCE WITH ARTICLE 424.05, 423.05, AND 1103.05 EXCEPT THAT A 2 x 6 BOARD WILL BE USED AS A FORM FOR ALL SIDEWALKS TO BE INSTALLED FIVE INCHES (5") IN THICKNESS. A 2 x 8 BOARD WILL BE USED AS A FORM FOR ALL DRIVEWAYS TO BE INSTALLED SEVEN INCHES (7") IN THICKNESS. A 2 x 10 BOARD WILL BE USED AS A FORM FOR ALL DRIVEWAYS TO BE INSTALLED EIGHT INCHES (8") IN THICKNESS. A 2×12 BOARD WILL BE USED AS A FORM FOR ALL GUTTER FLAGS TO BE INSTALLED TEN INCHES (10") IN THÍCKNESS. ALL FORMS MUST BE OF A MINIMUM HEIGHT OF THE PROPOSED THICKNESS OF THE RESPECTIVE CONCRETE ITEMS TO BE INSTALLED.

AGGREGATE BEDDING FOR CONCRETE WORK

NEW SIDEWALK AND DRIVEWAY PAVEMENT SHALL BE PLACED ON A MINIMUM OF TWO INCHES (2") OF COMPACTED CA-6 STONE BEDDING. 8" DRIVEWAY PAVEMENT SHALL BE PLACED ON A MINIMUM OF FOUR INCHES (4") OF COMPACTED CA-6 STONE BEDDING. ADDITIONAL AGGREGATE REQUIRED TO ADJUST THE EXISTING ELEVATION OF THE SUBGRADE TO THE PROPOSED ELEVATION WILL BE INCLUDED AS PART OF THIS WORK.

THIS ITEM WILL NOT BE PAID FOR SEPARATELY BUT WILL BE INCLUDED IN THE UNIT PRICE FOR THE RESPECTIVE CONCRETE ITEMS IN THE CONTRACT.

BUTT JOINTS

SCALE: NONE

BUTT JOINTS WILL BE INSTALLED AT THE ENDS OF ALL RESURFACING (WHERE RESURFACING MEETS EXISTING PAVEMENT) IN ACCORDANCE WITH THE "BUTT JOINT AND HMA TAPER" DETAIL SHEET INCLUDED IN THE PLANS, UNLESS OTHERWISE SPECIFIED.

PROTECTIVE COAT

ALL NEW CONCRETE SURFACES SHALL BE PROTECTIVELY COATED WITH A BOILED LINSEED OIL MIXTURE REGARDLESS OF THE TIME OF YEAR THE CONCRETE WORK IS CONSTRUCTED. THE PREPARATION AND APPLICATION OF THIS MIXTURE SHALL BE IN ACCORDANCE WITH ARTICLE 420.18 OF THE "STANDARD SPECIFICATIONS FOR ROAD AND BRIDGE CONSTRUCTION".

TO STA.

INDEX OF S	SHEETS, I.D	.O.T. STAN	IDARD DRA	AWINGS,
LEGEND	OF SYMBO	LS, AND G	ENERAL N	OTES

SHEET NO. 1 OF 1 SHEETS STA.

F.A.U. RTE.	SECTION	COUNTY	TOTAL SHEETS	SHEET NO.
2729	10-00060-00-RS	COOK	17	2
		CONTRACT	NO. 63	582
FED.	ROAD DIST. NO. 1 ILLINOIS	FED. AID PRO	DJECT -	




DESIGNED -REVISED -DRAWN -REVISED -CHECKED -REVISED DATE - 03/25/11 REVISED -

STATE OF ILLINOIS **DEPARTMENT OF TRANSPORTATION**

	SUMMARY OF QUANTITIES					
CODE	PAY ITEM	UNIT	TOTAL QUANTITY	CONSTRUCTION TYPE CODE RESURFACING 005 80% FEDERAL 20% STATE		
21101615	TOPSOIL FURNISH AND PLACE, 4"	SQ YD	500	500		
25200100	SODDING	SQ YD	500	500		
40600100	BITUMINOUS MATERIALS (PRIME COAT)	GALLON	6900	6900		
40600300	AGGREGATE (PRIME COAT)	TON	140	140		
40600895	CONSTRUCTING TEST STRIP	EACH	2	2		
40600982	HOT-MIX ASPHALT SURFACE REMOVAL - BUTT JOINT	SQYD	360	360		
40603340	HOT-MIX ASPHALT SURFACE COURSE, MIX "D", N70	TON	4000	4000		
40800050	INCIDENTAL HOT-MIX ASPHALT SURFACING	TON	15	15		
42101300	PROTECTIVE COAT	SQ YD	1125	1125		
42300300	PORTLAND CEMENT CONCRETE DRIVEWAY PAVEMENT, 7 INCH	SQ YD	250	250		
42300400	PORTLAND CEMENT CONCRETE DRIVEWAY PAVEMENT, 8 INCH	SQ YD	40	40		
42400200	PORTLAND CEMENT CONCRETE SIDEWALK 5 INCH	SQFT	3100	3100		
42400800	DETECTABLE WARNINGS	SQFT	560	560		
44000160	HOT-MIX ASPHALT SURFACE REMOVAL, 2 3/4"	SQ YD	34500	34500		
44000200	DRIVEWAY PAVEMENT REMOVAL	SQ YD	360	360		
44000500	COMBINATION CURB AND GUTTER REMOVAL	FOOT	1900	1900		
44000600	SIDEWALK REMOVAL	SQFT	3700	3700		
44201737	CLASS D PATCHES, TYPE I, 8 INCH	SQ YD	30	30		
44201741	CLASS D PATCHES, TYPE II, 8 INCH	SQ YD	60	60		
44201745	CLASS D PATCHES, TYPE III, 8 INCH	SQ YD	100	100		
44201747	CLASS D PATCHES, TYPE IV, 8 INCH	SQ YD	150	150		

					CONSTRUCTION TYPE CO
CODE	PAYITEM		UNIT	TOTAL QUANTITY	RESURFACING 005 80% FEDERAL 20% STATE
60257900	MANHOLES TO BE RECONSTRUCTED	! !	EACH	15	1
60300305	FRAMES AND LIDS TO BE ADJUSTED	7	EACH	55	.5
60406000	FRAMES AND LIDS, TYPE 1, OPEN LID		EACH	25	2
60406100	FRAMES AND LIDS, TYPE 1, CLOSED LID		EACH	40	4
60603800	COMBINATION CONCRETE CURB AND GUTTER, TYPE	3-6.12	FOOT	825	82
60604400	COMBINATION CONCRETE CURB AND GUTTER, TYPE I	3-6.18	FOOT	1075	107
67100100	MOBILIZATION		LSUM	1	
70102620	TRAFFIC CONTROL AND PROTECTION, STANDARD 70	1501	LSUM	1	
70102625	TRAFFIC CONTROL AND PROTECTION, STANDARD 70	1606	LSUM	1	
70102635	TRAFFIC CONTROL AND PROTECTION, STANDARD 70	1701	LSUM	1	
70102640	TRAFFIC CONTROL AND PROTECTION, STANDARD 70	1801	LSUM	1	
70300100	SHORT TERM PAVEMENT MARKING		FOOT	8000	800
78000100	THERMOPLASTIC PAVEMENT MARKING - LETTERS AM	ID SYMBOLS	SQFT	475	47
78000200	THERMOPLASTIC PAVEMENT MARKING - LINE 4"		FOOT	21500	2150
78000400	THERMOPLASTIC PAVEMENT MARKING - LINE 6"		FOOT	1800	180
78000600	THERMOPLASTIC PAVEMENT MARKING - LINE 12"		FOOT	750	75
78000650	THERMOPLASTIC PAVEMENT MARKING - LINE 24"		FOOT	400	40
78100100	RAISED REFLECTIVE PAVEMENT MARKER		EACH	160	16
78300200	RAISED REFLECTIVE PAVEMENT MARKER REMOVAL		EACH	100	10
88600600	DETECTOR LOOP REPLACEMENT		FOOT	700	70
X4060826	POLYMERIZED LEVELING BINDER (MACHINE METHOD)	, IL-4.75, N50	TON	2000	200
X6030310	FRAMES AND LIDS TO BE ADJUSTED (SPECIAL)		EACH	78	7

DENOTES SPECIALTY ITEM

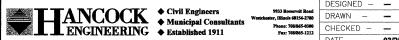

DESIGNED - -REVISED -REVISED -REVISED -DATE - 03/25/11 REVISED -

STATE OF ILLINOIS **DEPARTMENT OF TRANSPORTATION**

	01101011000		RTE.	S
	SUMMARY OF	QUANTITIES	2729	10-00
SCALE: NONE	SHEET NO. 1 OF 1 SHEE	ETS STA. TO STA.	FED.	ROAD DIST.

SYMBOL **DESCRIPTION**


- **EXISTING COMBINATION CONCRETE CURB & GUTTER,**
- $\langle \mathbf{B} \rangle$ **EXISTING PORTLAND CEMENT CONCRETE SIDEWALK**
- EXISTING HOT-MIX ASPHALT SURFACE COURSES, 2" $\langle \mathbf{c} \rangle$

SYMBOL **DESCRIPTION**

- EXISTING HOT-MIX ASPHALT BASE COURSE (APPROX. 10")
- **EXISTING LANDSCAPED PARKWAY**
- HOT-MIX ASPHALT SURFACE REMOVAL, 23/4"

EXISTING TYPICAL SECTION

(CANFIELD ROAD TO HARLEM AVENUE) STA. 1+00 TO STA. 53+15

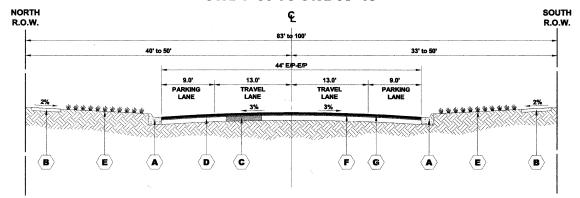

SYMBOL

SYMBOL

DESCRIPTION

- PROPOSED INTERMITTENT COMBINATION CONCRETE CURB
- **EXISTING LANDSCAPED PARKWAY**
- AND GUTTER REMOVAL AND REPLACEMENT **EXISTING PORTLAND CEMENT CONCRETE SIDEWALK**

EXISTING HOT-MIX ASPHALT BASE COURSE

(c) PROPOSED CLASS D PATCH PROPOSED POLYMERIZED LEVELING BINDER (MACHINE METHOD), IL-4.75, N50, 1"

DESCRIPTION

PROPOSED HOT-MIX ASPHALT SURFACE COURSE, MIX "D", N70, 2"

PROPOSED TYPICAL SECTION

(CANFIELD ROAD TO HARLEM AVENUE) STA. 1+00 TO STA. 53+15

SYMBOL

NORTH

R.O.W.

DESCRIPTION

B)E)A

EXISTING COMBINATION CONCRETE CURB & GUTTER

 $\langle {f c}
angle$

- **EXISTING PORTLAND CEMENT CONCRETE SIDEWALK**
- EXISTING HOT-MIX ASPHALT SURFACE COURSES, 2" (c)

SYMBOL DESCRIPTION

EXISTING PORTLAND CEMENT CONCRETE BASE COURSE (APPROX. 8")

 $\langle {f B}
angle$

SOUTH

R.O.W.

EXISTING LANDSCAPED PARKWAY

 $\langle \mathbf{E} \rangle$

HOT-MIX ASPHALT SURFACE REMOVAL, 23/4"

EXISTING TYPICAL SECTION

42' to 45' E/P-E/P


TRAVEL

 $\langle \mathbf{F} \rangle$

11.5' to 13.0' TRAVEL

 $\langle \mathbf{D} \rangle$

(HARLEM AVENUE TO SAYRE AVENUE) STA. 54+60 TO STA. 66+45

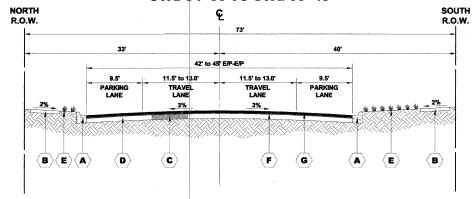

SYMBOL

DESCRIPTION

- PROPOSED INTERMITTENT COMBINATION CONCRETE CURB
- AND GUTTER REMOVAL AND REPLACEMENT
- EXISTING PORTLAND CEMENT CONCRETE SIDEWALK
- $\langle {f c}
 angle$ PROPOSED CLASS D PATCH

- SYMBOL
- **DESCRIPTION**
 - **EXISTING LANDSCAPED PARKWAY** PROPOSED POLYMERIZED LEVELING BINDER (MACHINE METHOD), IL-4.75, N50, 1"
 - PROPOSED HOT-MIX ASPHALT SURFACE COURSE, MIX "D". N70. 2"
- EXISTING PORTLAND CEMENT CONCRETE BASE COURSE

PROPOSED TYPICAL SECTION

(HARLEM AVENUE TO SAYRE AVENUE) STA. 54+60 TO STA. 66+45

HOT MIY ASSUALT (UMA) MIYTLISE DECLISEMENTS

HOT-MIX ASPHALT (HMA) MIXTURE REQUIREMENTS		
MIXTURE TYPE	AIR VOIDS @ Ndes	
RESURFACING		
HOT-MIX ASPHALT SURFACE COURSE, MIX "D", N70 (IL - 9.5mm), 2"	4% @70 GYR.	
POLYMERIZED LEVELING BINDER (MACHINE METHOD), IL - 4.75, N50, 1"	4% @ 50 GYR.	
INCIDENTAL HMA SURFACING		
HOT-MIX ASPHALT SURFACE COURSE, MIX "D", N50 (IL - 9.5mm)	4% @50 GYR.	
PATCHING		
CLASS D PATCHES (HOT-MIX ASPHALT BINDER COURSE, IL - 19.0), 8" (IN 3 LIFTS)	4% @ 70 GYR.	

THE UNIT WEIGHT USED TO CALCULATE ALL HMA SURFACE MIXTURE QUANTITIES IS 112 LBS/SQ YD/IN.

THE "AC TYPE" FOR POLYMERIZED HMA MIXES SHALL BE "SBS/SBR PG 70-22" AND FOR NON-POLYMERIZED HMA THE "AC TYPE" SHALL BE "PG 64-22" UNLESS MODIFIED BY DISTRICT ONE SPECIAL PROVISIONS. FOR "PERCENT OF RAP" SEE DISTRICT ONE SPECIAL PROVISIONS.

THE CONTRACTOR SHALL MILL BEFORE PATCHING.

ANCOCK

Civil Engineers

Municipal Cons


ENGINEERING ◆ Established 1911


REVISED DRAWN -CHECKED -REVISED


STATE OF ILLINOIS DEPARTMENT OF TRANSPORTATION


EXISTING AND PROPOSED TYPICAL CROSS SECTIONS SHEET NO. 1 OF 1 SHEETS STA.

SECTION COLINTY SHEETS COOK 17 4 2729 10-00060-00-RS CONTRACT NO. 63582 FED. ROAD DIST. NO. 1 ILLINOIS FED. AID PROJECT -

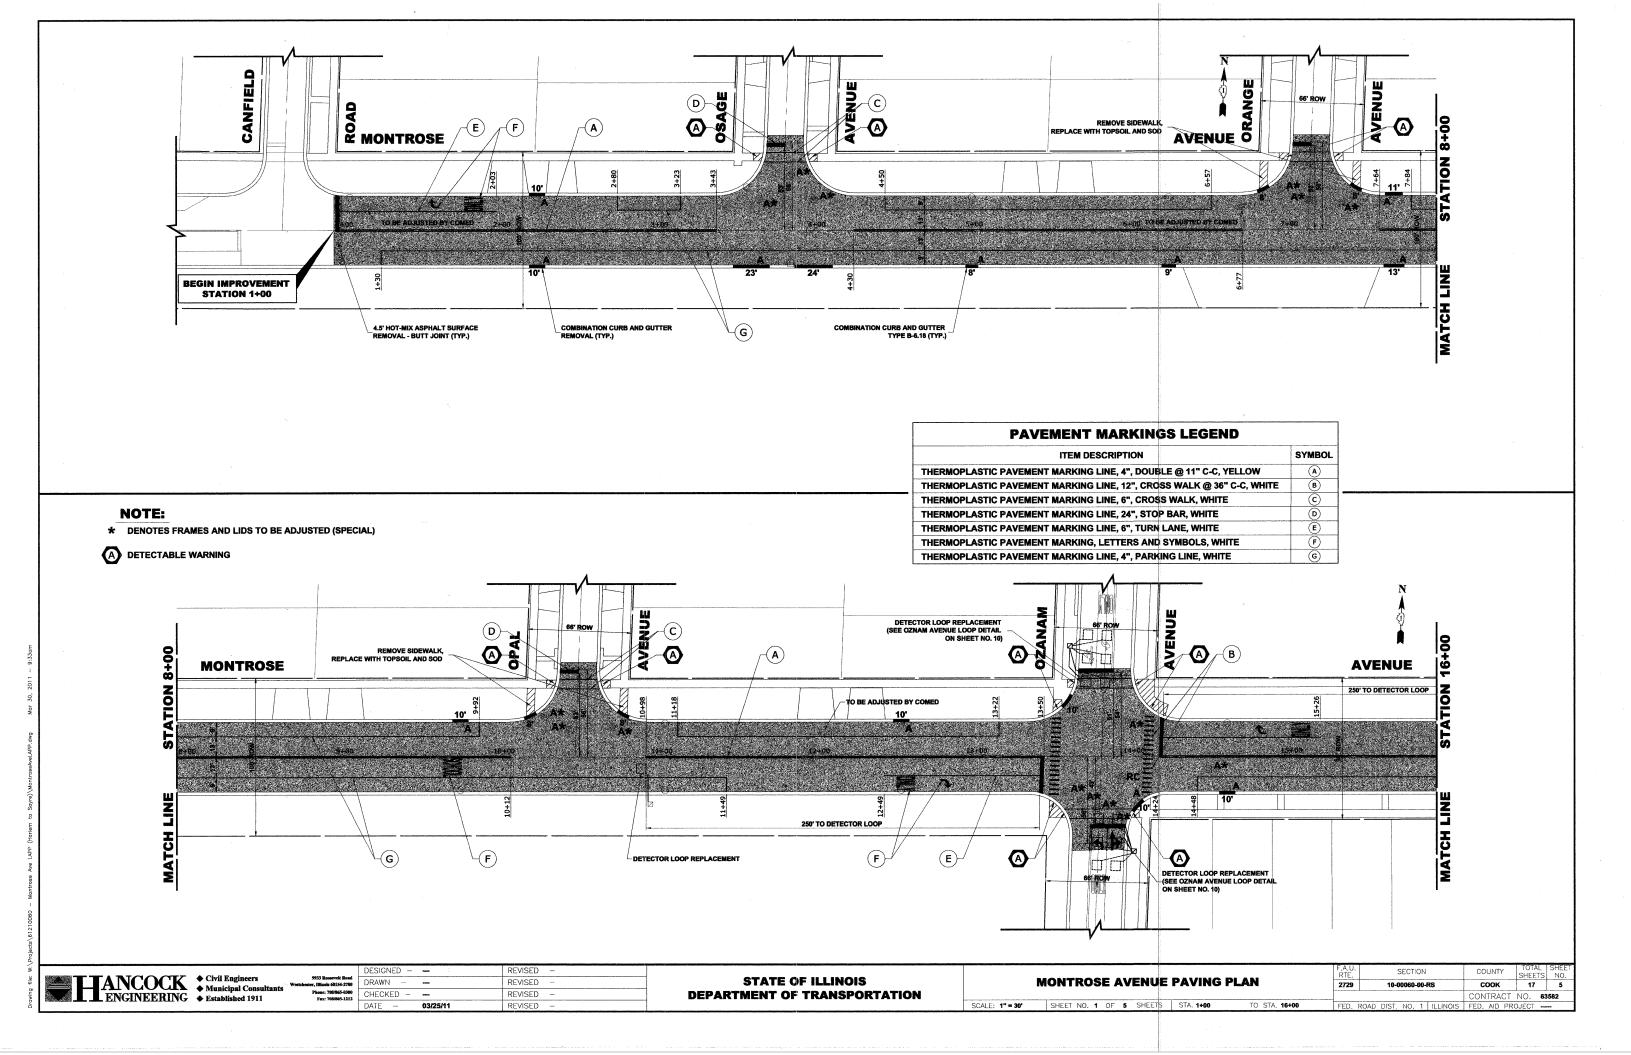

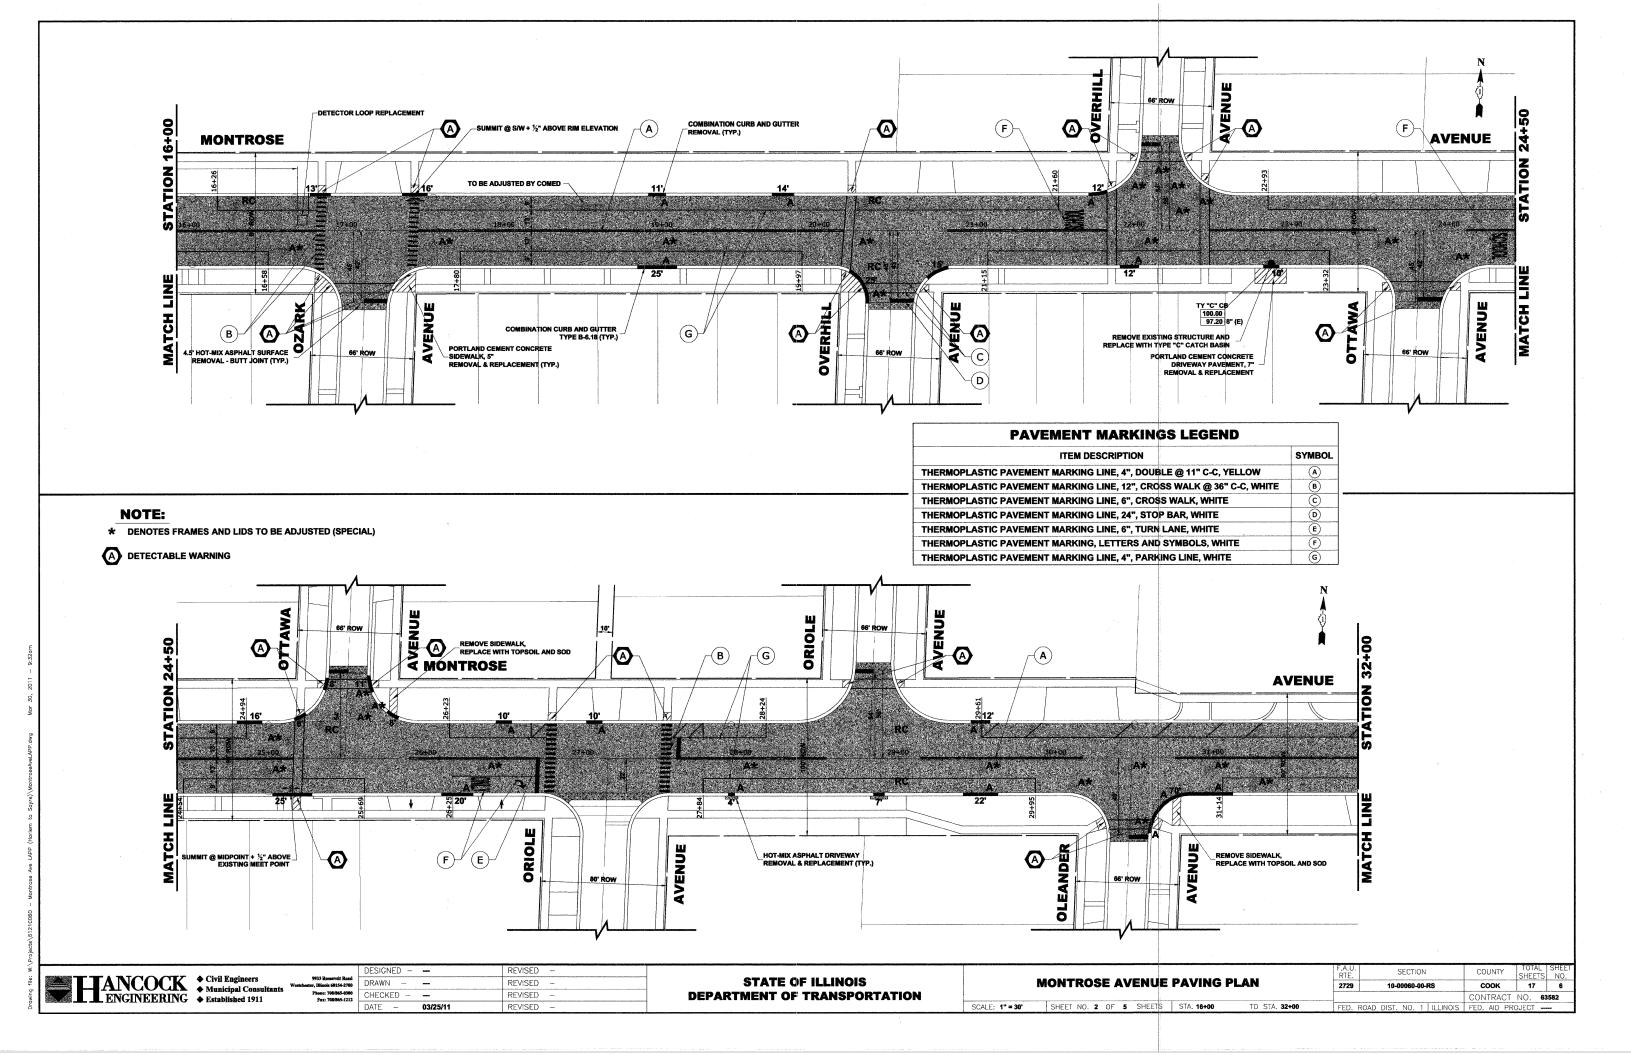

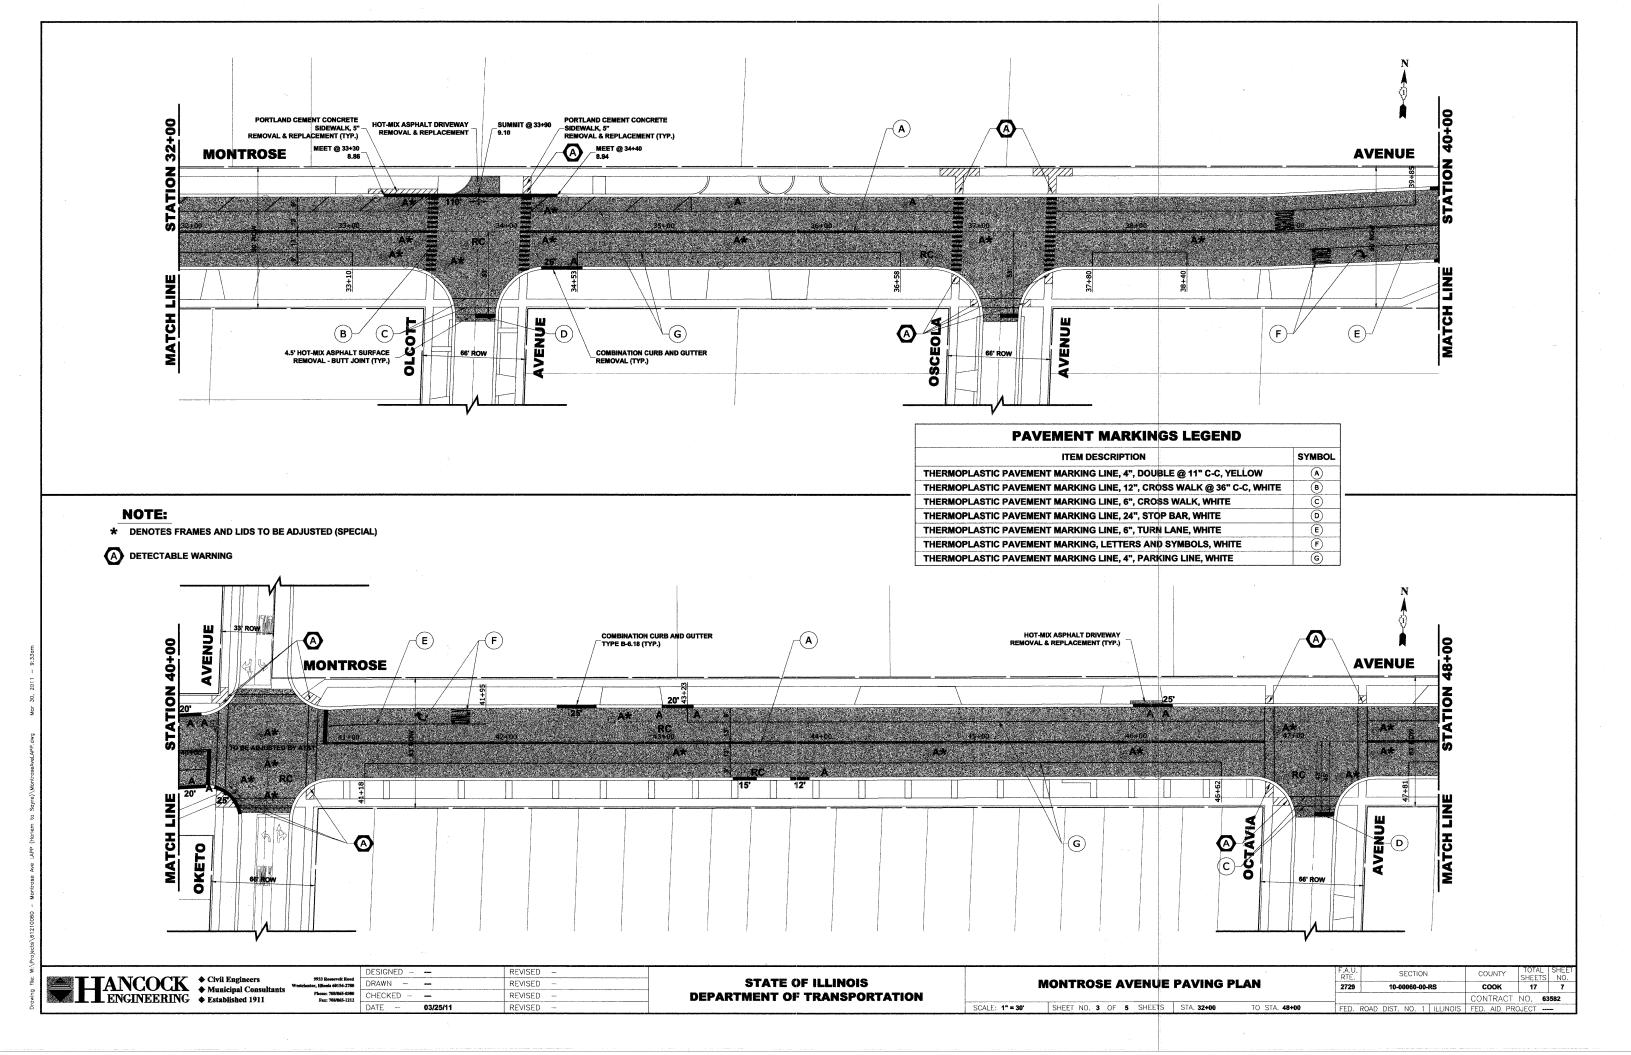

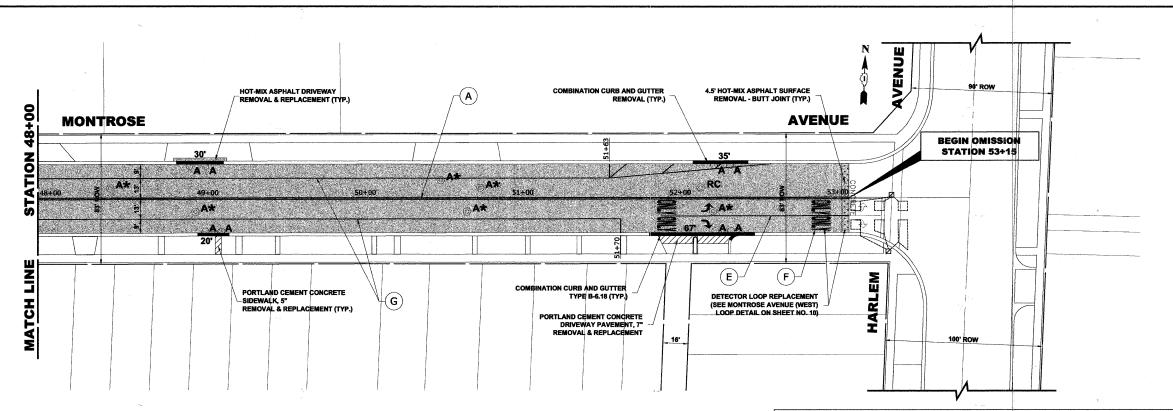

NOTE:

* DENOTES FRAMES AND LIDS TO BE ADJUSTED (SPECIAL)

A DETECTABLE WARNING

PAVEMENT MARKINGS LEGEND	
ITEM DESCRIPTION	SYMBOL
THERMOPLASTIC PAVEMENT MARKING LINE, 4", DOUBLE @ 11" C-C, YELLOW	(A)
THERMOPLASTIC PAVEMENT MARKING LINE, 12", CROSS WALK @ 36" C-C, WHITE	В
THERMOPLASTIC PAVEMENT MARKING LINE, 6", CROSS WALK, WHITE	C
THERMOPLASTIC PAVEMENT MARKING LINE, 24", STOP BAR, WHITE	D
THERMOPLASTIC PAVEMENT MARKING LINE, 6", TURN LANE, WHITE	E
THERMOPLASTIC PAVEMENT MARKING, LETTERS AND SYMBOLS, WHITE	F
THERMOPLASTIC PAVEMENT MARKING LINE, 4", PARKING LINE, WHITE	(G)

ANCOCK


Output


DESIGNED - --REVISED DRAWN -REVISED CHECKED - -REVISED DATE - 03/25/11 REVISED -


STATE OF ILLINOIS **DEPARTMENT OF TRANSPORTATION**

MONTROSE AVENUE PAVING PLAN SCALE: 1" = 30" SHEET NO. 4 OF 5 SHEETS STA. 48+00 TO STA. 53+15


SECTION SHEETS NO. 2729 соок CONTRACT NO. 63582 FED. ROAD DIST. NO. 1 ILLINOIS FED. AID PROJECT

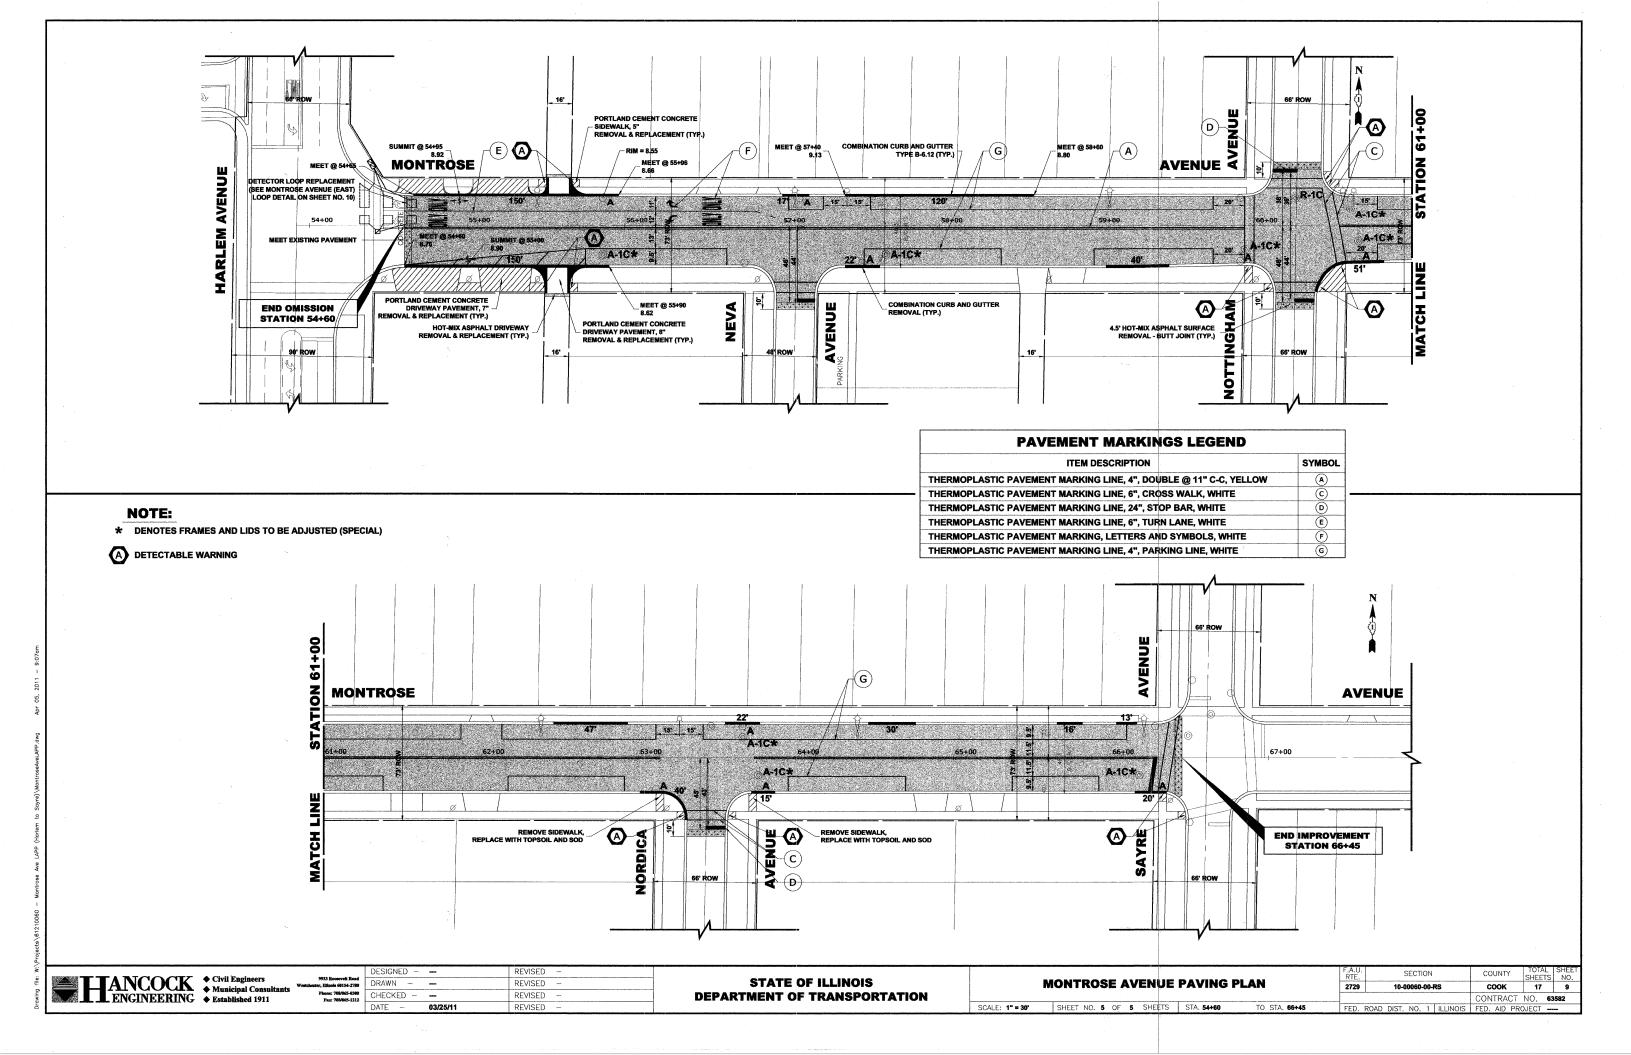

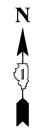

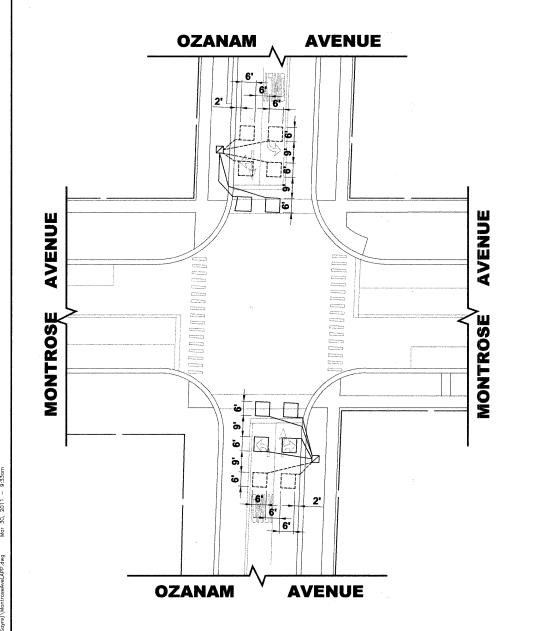

HARLEM AVENUE HARLEM AVENUE

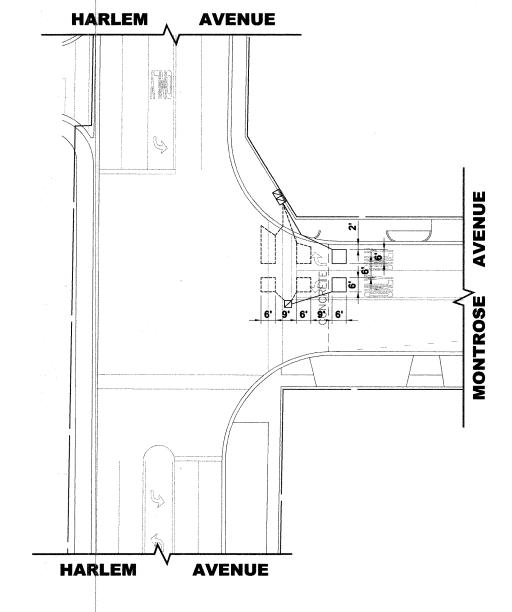

OZANAM AVENUE LOOP DETAIL

MONTROSE AVENUE (WEST) LOOP DETAIL

MONTROSE AVENUE (EAST) LOOP DETAIL

HANCO	CK
-------	----

♦ Civil Engineers

REVISED REVISED DRAWN CHECKED - -REVISED

STATE OF ILLINOIS **DEPARTMENT OF TRANSPORTATION**


DETECTOR LOOP DETAILS

SECTION
 COUNTY
 SHEETS
 NO.


 COOK
 17
 10
 2729

CONTRACT NO. 63582


A.D.A. RAMP

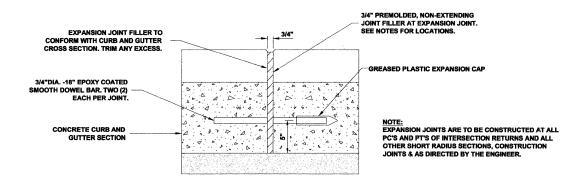


TYPICAL CURB AND GUTTER EXPANSION JOINT

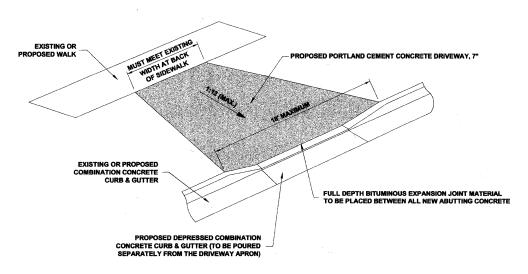

DRIVEWAY

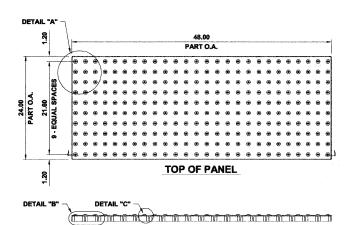

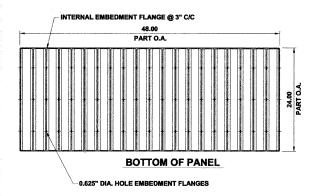


2.35 DETAIL "A"

INTERNAL EMBEDMENT FLANGE @ 3" C/C (SEE PLAN FOR ORIENTATION) DIA. EQUAL SPACES OF .750 0.625" DIA. HOLE EMBEDMENT FLANGES 2° A/S DRAFT AS SHOWN IN PLAN .1875 .1875 3.00 DETAIL "B" DETAIL "C"

NOTE:
COMPOSITE PAVER TILE USED SHALL BE AS MANUFACTURED BY ADA SOLUTIONS, INC., OR AS APPROVED BY ENGINEER.

CAST-IN-PLACE COMPOSITE PAVER TILE FOR DETECTABLE WARNING

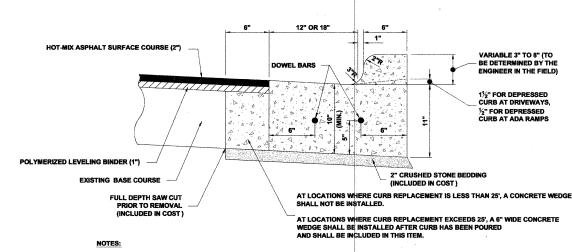

- 1. PROVIDE 2 3/" DIAMETER, 18" LONG EPOXY COATED SMOOTH BARS WITH PLASTIC EXPANSION CAPS AT EACH EXPANSION JOINT.
- 2. CONTRACTION JOINT 2" DEEP CONTRACTION JOINTS SHALL BE SAWED AT EQUAL SPACES (NOT EXCEEDING 15 FEET) BETWEEN NORMAL EXPANSION JOINTS, IN THE UPPER $\,^1\!\!/_3$ OF CURB & GUTTERS WITHIN 24 HOURS OF PLACEMENT.
- 3. A LEAN CONCRETE WEDGE IS TO BE POURED IN THE SPACE BETWEEN THE NEW CURB & THE EXISTING PAVEMENT AFTER THE CURB HAS REACHED ITS INITIAL SET.

COMBINATION CONCRETE CURB & GUTTER



DESIGNED -REVISED DRAWN -REVISED REVISED DATE -03/25/11 REVISED

STATE OF ILLINOIS **DEPARTMENT OF TRANSPORTATION** **DETAILS**

SCALE: NONE

SECTION COUNTY 2729 10-00060-00-RS COOK 17 CONTRACT NO. 63582 SHEET NO. 1 OF 1 SHEETS STA. FED. ROAD DIST. NO. 1 ILLINOIS FED. AID PROJECT TO STA.

NOTES:

EXISTING BROKEN FRAMES AND LIDS SHALL BE REMOVED AND DISPOSED OF BY THE CONTRACTOR AND SHALL BE REMOVED AND DISPOSED OF BY THE ENGINEER. REPLACEMENT FRAMES AND LIDS WILL BE PAID FOR IN ACCORDANCE WITH ARTICLE 109.04 OF THE STANDARD SPECIFICATIONS UNLESS A SEPARATE PAY ITEM HAS BEEN PROVIDED.

IF THE EXISTING LIDS ARE OPEN, THE FRAME WILL BE ADJUSTED TO THE ELEVATION OF THE MILLED PAVEMENT SURFACE PRIOR TO THE MILLING OPERATION. THE FRAME WILL NOT BE REMOVED AND COVERED BY THE METAL PLATE.

CITY OF CHICAGO CASTINGS ARE THE PROPERTY OF THE CITY AND THE CONTRACTOR SHALL NOTIFY THE CITY FOR REMOVAL AND DISPOSITION OF THE CASTINGS.

THE METAL PLATE USED TO COVER THE STRUCTURE SHALL REMAIN THE PROPERTY OF THE CONTRACTOR.

WHEN STRUCTURES ARE TO BE ADJUSTED OR RECONSTRUCTED, THE LOWERING AND RAISING OF THE FRAMES AND LIDS WILL NOT BE PAID FOR SEPARATELY BUT WILL BE INCLUDED IN THE COST OF THE CORRESPONDING PAY ITEM.

SCALE: NONE

CONSTRUCTION PROCEDURES

STAGE 1 (BEFORE PAVEMENT MILLING)

- A) REMOVE A MINIMUM OF 12 (300) OF THE PAVEMENT FROM AROUND THE STRUCTURE.
- B) REMOVE THE EXISTING FRAME AND LID FROM THE STRUCTURE.
- C) COVER THE STRUCTURE OPENING WITH A 36 (900) DIAMETER
- D) BACKFILL WITH CRUSHED STONE AND A MINIMUM 1½ (40) THICK HMA SURFACE MIX APPROVED BY THE ENGINEER.

STAGE 2 (AFTER PAVEMENT MILLING)

- A) REMOVE THE HMA SURFACE MIX AND CRUSHED STONE.
- B) INSTALL THE FRAME AND LID; ADJUST THE FRAME TO ITS FINAL SURFACE ELEVATION.
- C) THE SURROUNDING SPACE SHALL BE FILLED WITH CLASS PP-1* CONCRETE TO THE ELEVATION OF THE SURFACE OF THE EXISTING BASE COURSE OR THE BINDER COURSE.
- *UNLESS OTHERWISE SPECIFIED IN THE PLANS.

THE PROCEDURE EXPLAINED ABOVE SHALL CONFORM TO THE APPLICABLE PORTIONS OF SECTIONS 353, 406, 602, AND 603 OF THE STANDARD SPECIFICATIONS.

LEGEND

- 1) SUB-BASE GRANULAR MATERIAL
- 6 FRAME AND LID (SEE NOTES)
- 2 EXISTING PAVEMENT
- (7) CLASS PP-1* CONCRETE
- (3) 36 (900) DIAMETER METAL PLATE
- (8) PROPOSED HMA SURFACE COURSE
- 4 PROPOSED CRUSHED STONE AND HMA SURFACE MIX
- 9 PROPOSED HMA BINDER COURSE
- (5) EXISTING STRUCTURE

TO STA.

LOCATION OF STRUCTURES:

THE CONTRACTOR WILL BE REQUIRED TO KEEP A RECORD OF THE LOCATIONS OF THE BURIED STRUCTURES ACCORDING TO THE STATION AND DISTANCE LEFT OR RIGHT OF THE CENTERLINE OF PAVEMENT. UPON COMPLETION OF THE WORK, THE CONTRACTOR WILL DELIVER THE RECORD TO THE ENGINEER.

BASIS OF PAYMENT: THIS WORK WILL BE PAID FOR AT THE CONTRACT UNIT PRICE PER EACH FOR "FRAMES

NEW FRAMES AND LIDS, WHEN SPECIFIED, WILL BE PAID FOR SEPARATELY.

DETAILS FOR FRAMES AND LIDS ADJUSTMENT WITH MILLING

ALL DIMENSIONS ARE IN INCHES (MILLIMETERS) UNLESS OTHERWISE SHOWN

USER NAME = DESIGNED - R. SHAH REVISED - A. ABBAS 03-21-97 DRAWN REVISED - R. WIEDEMAN 05-14-04 CHECKED REVISED - R. BORO 01-01-07 PLOT DATE == DATE - 10-25-94 REVISED - R. BORO 03-09-11

STATE OF ILLINOIS **DEPARTMENT OF TRANSPORTATION**


DETAILS FOR FRAMES AND LIDS ADJUSTMENT WITH MILLING

SHEET NO. 1 OF 1 SHEETS STA.

SECTION 2729 10-00060-00-RS BD600-03 (BD-8)

COOK 17 12 CONTRACT NO. 63582

COUNTY

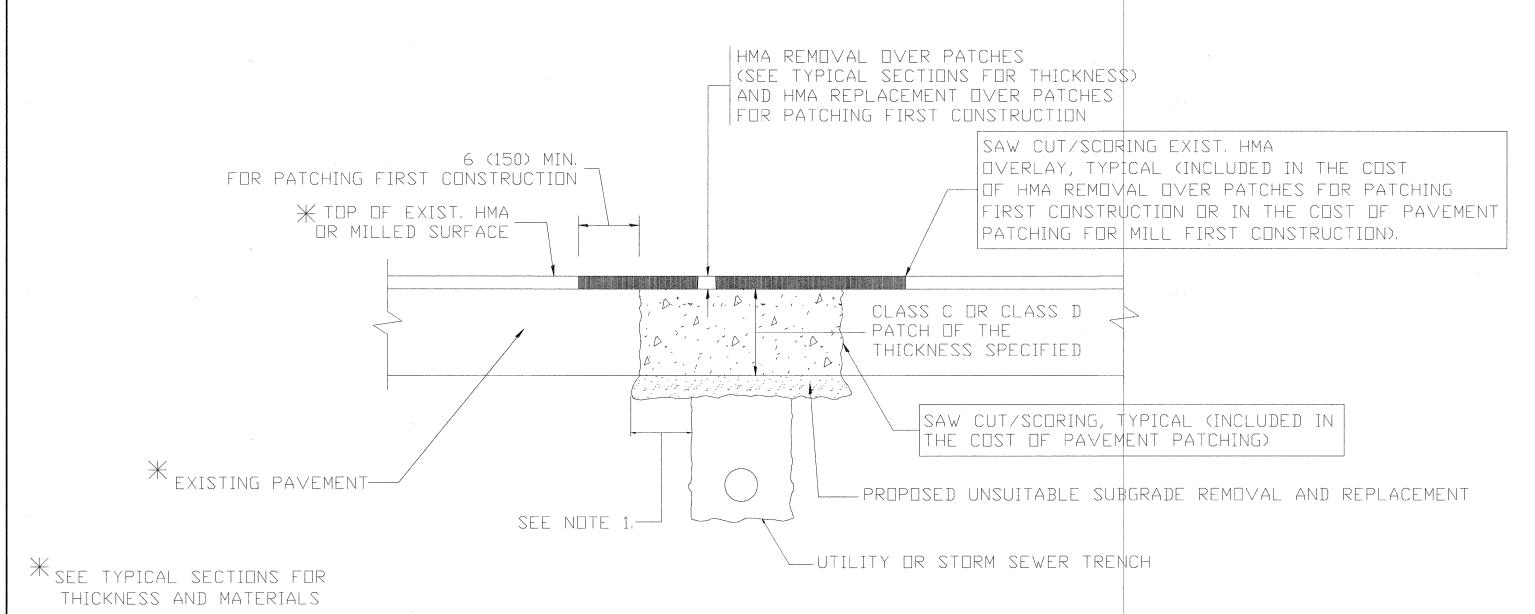

NOTES:

- 1. THE WIDTH OF THE FULL DEPTH PATCH OVER A TRENCH SHALL BE 12 (300) WIDER ON EACH SIDE OF THE TRENCH.
- 2. FOR METHOD OF MEASUREMENT AND BASIS OF PAYMENT, SEE RECURRING SPECIAL PROVISION "PATCHING WITH HOT-MIX ASPHALT OVERLAY REMOVAL".

SEQUENCE OF CONSTRUCTION (PATCHING FIRST)


- 1. REMOVE THE EXISTING HMA MATERIAL OVER THE AREA TO BE PATCHED.
- 2. REMOVE AND REPLACE WITH CLASS C OR D PATCH.
- 3. REPLACE HMA MATERIAL OVER THE AREA TO BE PATCHED.

SEQUENCE OF CONSTRUCTION (MILLING FIRST)


- 1. MILL HMA FIRST IF THERE IS AT LEAST 4 1/2 INCHES OR MORE OF HMA MATERIAL ON TOP OF THE EXISTING PAVEMENT OR IF THE PAVEMENT IS FULL DEPTH HMA. A MINIMUM OF 2 INCHES OF HMA MATERIAL SHALL BE IN PLACE AFTER MILLING.
- 2. REMOVE AND REPLACE WITH FULL DEPTH CLASS D PATCHES TO TOP OF MILLED SURFACE.

ALL DIMENSIONS ARE IN INCHES (MILLIMETERS) UNLESS OTHERWISE SHOWN

USER NAME =	DESIGNED - R.SHAH	REVISED - A. ABBAS 04-27-98		PAVEMENT PATCHING FOR	F.A.U. SECTION	COUNTY SHE	TAL SHEET
	DRAWN -	REVISED - R. BORO 01-01-07	STATE OF ILLINOIS	HMA SURFACED PAVEMENT	2729 10-00060-00-RS	COOK 1	17 13
PLOT SCALE ==	CHECKED ~	REVISED - R. BORO 09-04-07	DEPARTMENT OF TRANSPORTATION	TIMA SON ACED FAVERENT	BD400-04 (BD-22), 63582
PLOT DATE =	DATE - 10-25-94	REVISED - K. ENG 10-27-08		SCALE: NONE SHEET NO. 1 OF 1 SHEETS STA. TO STA.	FED. ROAD DIST. NO. 1 ILLINOIS	FED. AID PROJECT	

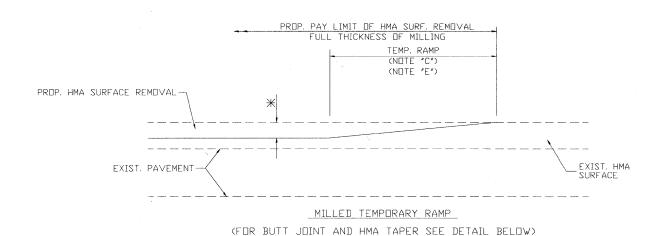


- OPTION 1

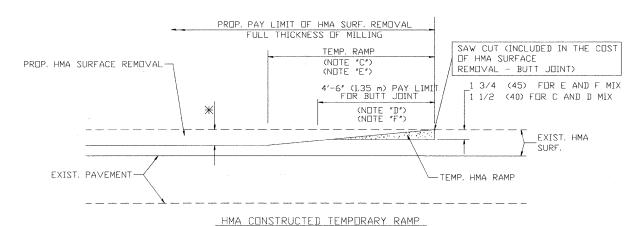

(FOR BUTT JOINT AND HMA TAPER SEE DETAIL BELOW)

OPTION 2

TYPICAL TEMPORARY RAMP

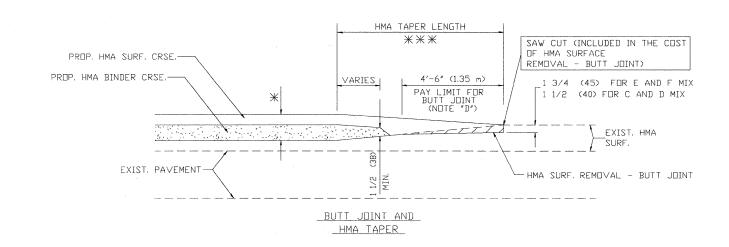

TYPICAL BUTT JOINT AND HMA TAPER FOR MILLING AND RESURFACING

USER NAME == DESIGNED - M. DE YONG REVISED - R. SHAH 10-25-94 PLOT SCALE = CHECKED REVISED - M. GOMEZ 04-06-01 PLOT DATE = DATE 06-13-90 REVISED - R. BORO 01-01-07

STATE OF ILLINOIS **DEPARTMENT OF TRANSPORTATION**

ALL DIMENSIONS ARE IN INCHES (MILLIMETERS) UNLESS OTHERWISE SHOWN SHEETS **BUTT JOINT AND** 17 14 10-00060-00-RS COOK HMA TAPER DETAILS BD400-05 (BD-32) CONTRACT NO. 63582 SCALE: NONE SHEET NO. 1 OF 1 SHEETS STA TO STA.

PROP. HMA OR PCC

30'-0" (9.0 m) (NOTE "A")

15'-0" (4.5 m) (NOTE "B")

(NOTE "D")

BUTT JOINT DETAIL

TAPER LENGTH **

HMA TAPER DETAIL

TYPICAL BUTT JOINT AND HMA TAPER FOR RESURFACING ONLY

SAW CUT (INCLUDED IN THE COST

1 3/4 (45) FOR E AND F MIX 1 1/2 (40) FOR C AND D MIX

1 3/4 (45) FOR E AND F MIX

1 1/2 (40) FOR C AND D MIX

- BUTT JOINT)

OF HMA OR P.C.C. SURFACE REMOVAL

SURFACE REMOVAL - BUTT JOINT

NOTES

EXIST, HMA OR PCC SURFACE

₩ EXIST, PAVEMENT-

VARIES

A: MAINLINE ROADWAYS AND MAJOR SIDE ROADS.

* * EXIST, PAVEMENT

PROP. HMA SURF. CRSE.-

PROP. HMA BINDER CRSE.-

- C: THE TEMP, RAMP SHALL BE CONSTRUCTED IMMEDIATELY UPON REMOVAL OF THE EXISTING HMA SURFACE,
- D: THE BUTT JOINT SHALL BE CONSTRUCTED IMMEDIATELY PRIOR TO PLACING THE PROPOSED HMA COURSES.

* * PC CONCRETE, HMA OR HMA RESURFACED PAVEMENT.

- E: TAPER THE TEMP, RAMP AT A RATE OF 3'-0' (900 mm) PER 1 INCH (25 mm) OF MILLING THICKNESS.
- F: INSTALLATION AND REMOVAL OF THE 4'-6" (1.35 m) TEMP. RAMP IS INCLUDED IN COST OF HMA SURFACE REMOVAL - BUTT JOINT
- G: SEE ARTICLE 406.08 AND 406.14 OF THE STANDARD SPECIFICATIONS FOR "HMA AND/OR PCC SURFACE REMOVAL, BUTT JOINT".


* SEE TYPICAL SECTIONS FOR MILLING THICKNESS.

 $\mbox{\em $\#$}\mbox{\em $\#$}$ 10'-0" (3.0 m) PER 1 (25) RESURFACING (NOTE "B")

BASIS OF PAYMENT:

THE BUTT JOINT WILL BE PAID FOR AT THE CONTRACT UNIT PRICE PER SQUARE YARD (SQUARE METER)
FOR "HOT-MIX ASPHALT SURFACE REMOVAL - BUTT JOINT" OR
FOR "PORTLAND CEMENT CONCRETE SURFACE REMOVAL - BUTT JOINT".



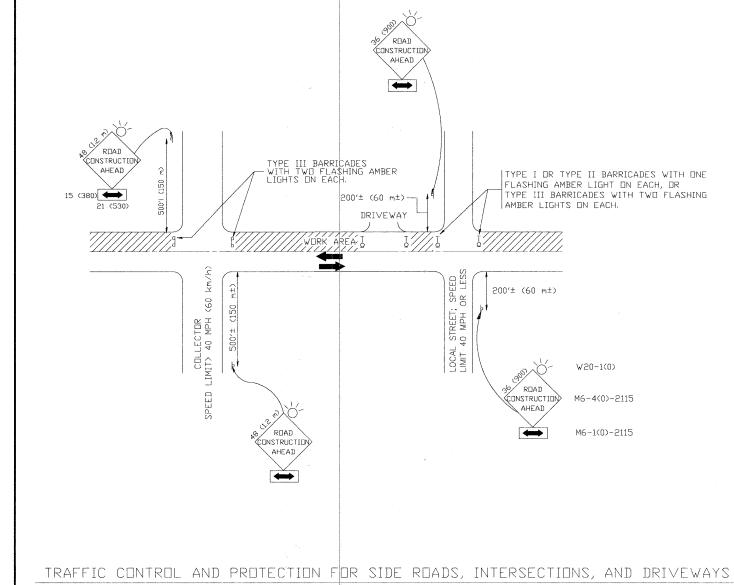

NOTES:

- A. FOR NO LANE RESTRICTION ON THE SIDE ROAD OR DRIVEWAYS
- 1. SIDE ROAD WITH A SPEED LIMIT OF 40 MPH (60 km/h) OR LESS AS SHOWN ON THE DRAWING AND AS DIRECTED BY THE ENGINEER:
- a) DNE ROAD CONSTRUCTION AHEADSIGN 36 x 36 (900x900) WITH A FLASHER AND FLAG MOUNTED ON IT APPROXIMATELY 200' (60 m) IN ADVANCE OF THE MAIN ROUTE.
- b) THE CLOSED PORTION OF THE MAIN ROUTE SHALL BE PROTECTED BY BLOCKING WITH TYPE I, TYPE II OR TYPE III BARRICADES, 1/3 OF THE CROSS SECTION OF THE CLOSED PORTION.
- 2. SIDE ROAD WITH A SPEED LIMIT GREATER THAN 40 MPH (60 km/h) AS SHOWN ON THE DRAWING AND AS DIRECTED BY THE ENGINEER:
- 0) ONE ROAD CONSTRUCTION AHEA $\bar{\bf s}$ IGN 48 \times 48 (1.2 m \times 1.2 m) WITH A FLASHER MOUNTED ON IT APPROXIMATELY 500' (150 m) IN ADVANCE OF THE MAIN ROUTE.
- b) THE CLOSED PORTION OF THE MAIN ROUTE SHALL BE PROTECTED BY BLOCKING WITH TYPE III BARRICADES, 1/2 OF THE CROSS SECTION OF THE CLOSED PORTION.
- 3. WHEN THE SIDE ROAD LIES BETWEEN THE BEGINNING OF THE MAINLINE SIGNING AND THE WORK ZONE, A SINGLE HEADED ARROW (M6-1) SHALL BE USED IN LIEU OF THE DOUBLE HEADED ARROW (M6-4).

- B. FOR A LANE CLOSURE ON A SIDE ROAD OR DRIVEWAY:
- USE APPLICABLE PORTIONS OF THE TYPICAL APPLICATION OF TRAFFIC CONTROL DEVICES (STD. 701501, STD. 701606 OR THE APPROPRIATE STANDARD). THE SPACING OF SIGNS AND BARRICADES SHALL BE ADJUSTED FOR FIELD CONDITIONS AS DIRECTED BY THE ENGINEER. THE DIRECTIONAL ARROW SHALL BE COVERED OR REMOVED WHEN NO LONGER CONSISTENT WITH THE SIDE ROAD LANE CLOSURE.
- C. ADVANCE WARNING SIGNS ARE TO BE OMITTED ON DRIVEWAY UNLESS OTHERWISE NOTED.
- D. THE TRAFFIC CONTROL AND PROTECTION FOR SIDE ROADS, INTERSECTIONS, AND DRIVEWAYS SHALL BE INCIDENTAL TO THE COST OF SPECIFIED TRAFFIC CONTROL STANDARDS OR ITEMS.


All dimensions are in millimeters (inches) unless otherwise shown.

USER NAME =	DESIGNED - LHA	REVISED - J. OBERLE 10-18-95
-	DRAWN -	REVISED - A. HOUSEH 03-06-96
PLOT SCALE =	CHECKED -	REVISED - A. HOUSEH 10-15-96
PLOT DATE =	DATE - 06-89	REVISED - T. RAMMACHER 01-06-00

STAT	E OF	F ILLINOIS
DEPARTMENT	OF	TRANSPORTATION


:							TION FOR DRIVEWAYS	
SCALE: NONE	SHEET	NO. 1	OF	1	SHEETS	STA.	TO	S


RTE.	RTE. SECTION							Υ	SHEETS	NO.		
2729 10-00060-00-RS						COOK		17	15			
		T	C-	10		CONTR	ACT	NO. 6	3582			
						FED. A	D PROJECT					

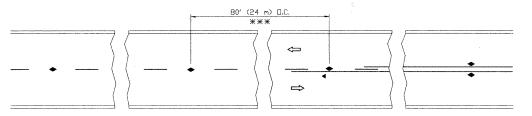


*** REDUCE TO 40' (12 m) D.C. ON CURVES WITH POSTED OR ADVISORY SPEED 45 M.P.H. (70 km/h) OR LESS.

TWO-LANE/TWO-WAY

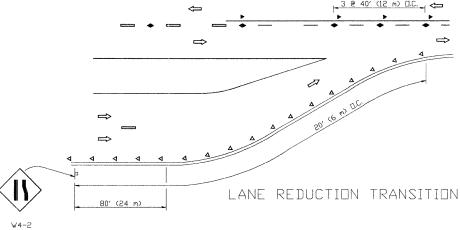


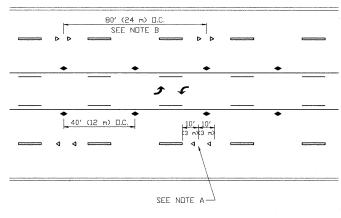

TWO-WAY LEFT TURN

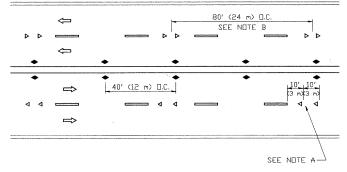



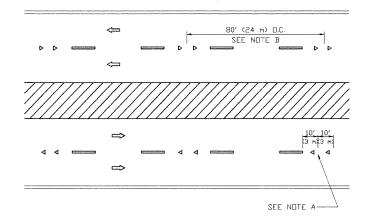

GENERAL NOTES

- 1. MARKERS USED WITH DASHED LINES-SHALL BE CENTERED IN THE GAP BETWEEN SEGMENTS.
- 2. MARKERS USED ADJACENT TO SOLID LINES SHALL BE OFFSET 2 TO 3 (50 TO 75) TOWARD TRAFFIC AS SHOWN.
- 3. MARKERS THROUGH TANGENTS LESS THAN 500' (150 m) IN LENGTH BETWEEN CURVES SHALL BE INSTALLED AT THE LESSER OF THE TWO CURVE SPACINGS.

LANE MARKER NOTES

- A. USE DOUBLE LANE LINE MARKERS SPACED AS SHOWN.
- B. REDUCE TO 40' (12 m) D.C. ON CURVES WHERE ADVISORY SPEEDS ARE 10 M.P.H. (20 km/h) LOWER THAN POSTED SPEEDS.

SYMBOLS


--- YELLOW STRIPE

WHITE STRIPE

- ONE-WAY AMBER MARKER
- ONE-WAY CRYSTAL MARKER (W/O)
- ◆ TWD-WAY AMBER MARKER

DESIGN NOTES


- 1, DOUBLE LANE LINE MARKERS SHALL BE USED UNLESS SPECIFIED DTHERWISE.
- 2. EXCEPT AS SHOWN ON THE LANE REDUCTION TRANSITION AND FREEWAY EXIT RAMP DETAIL, MARKERS ARE NOT TO BE SPECIFIED ON RIGHT EDGE LINES.
- 3. THE EXACT MARKER LIMITS, SPACING, AND COLOR SHOULD BE INCLUDED IN THE PLANS.
- 4. MARKERS SHOULD NOT BE USED ALONGSIDE CURBS EXCEPT FOR EXTREMELY SHORT SECTIONS OF CURBS WHERE NOT MORE THAN TWO MARKERS WOULD BE INVOLVED.

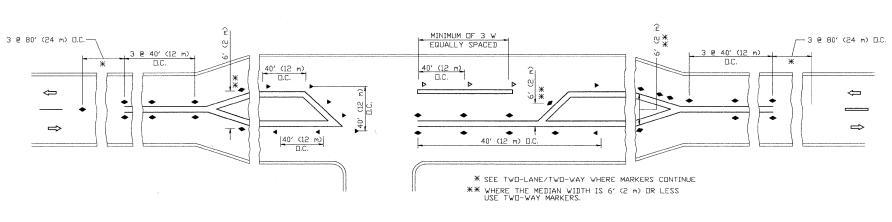



LEFT TURN

All dimensions are in millimeters (inches) unless otherwise shown.

USER NAME = DESIGNED REVISED - T. RAMMACHER 09-19-94 SECTION COUNTY SHEETS NO. TYPICAL APPLICATIONS STATE OF ILLINOIS DRAWN REVISED - T. RAMMACHER 03-12-99 RAISED REFLECTIVE PAVEMENT MARKERS (SNOW-PLOW RESISTANT) СООК 17 DEPARTMENT OF TRANSPORTATION PLOT SCALE = CHECKED REVISED - T. RAMMACHER 01-06-00 TC-11 CONTRACT NO. 63582 SCALE: NONE SHEET NO. 1 OF 1 SHEETS STA. PLOT DATE : DATE REVISED - C. JUCIUS 09-09-09

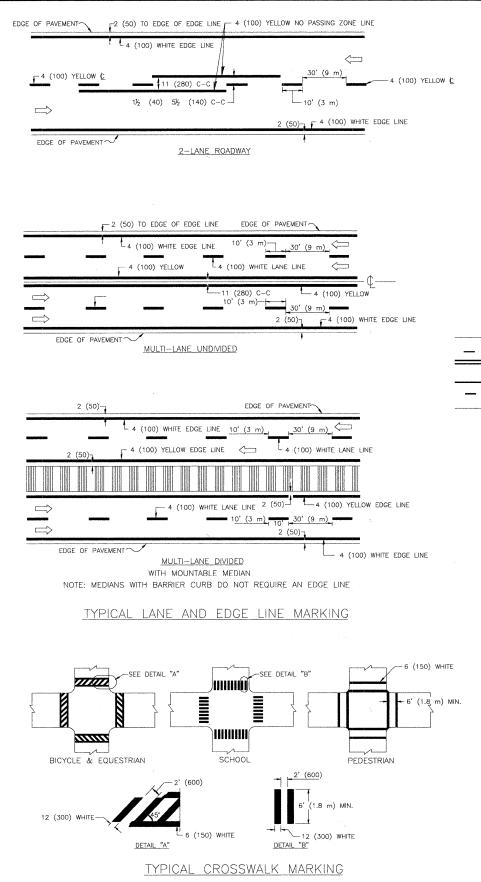

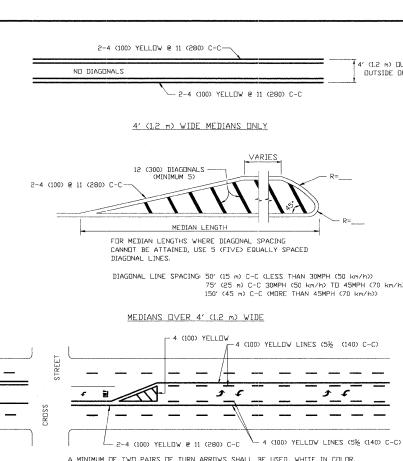

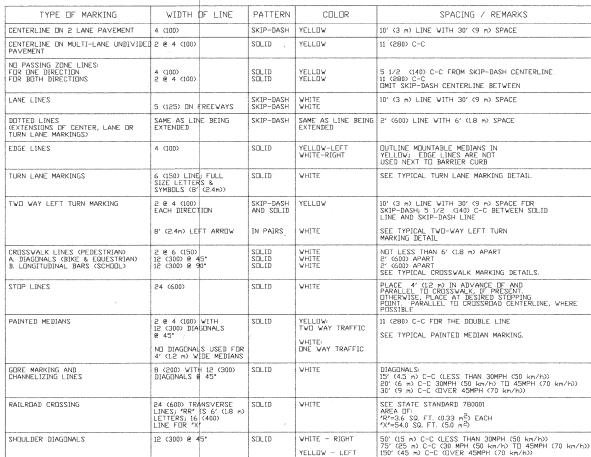

8 (200) WHITE

8 (500) AHITE

12 (300) WHITE DIAGONALS @ 10' (3 m) DR LESS SPACING

8 (200) WHITE

ISLAND OFFSET FROM PAVEMENT EDG

ISLAND AT PAVEMENT EDGE

TYPICAL ISLAND MARKING

RAISED ISLAND

FOR FURTHER DETAILS ON PAVEMENT MARKING REFER TO STANDARD SPECIFICATIONS FOR ROAD AND BRIDGE CONSTRUCTION AND STATE STANDARD 780001.

All dimensions are in inches (millimeters) unless otherwise shown.

TYPICAL TURN LANE MARKING

FULL SIZE LETTERS 8' (2.4 m) AND ARRDWS SHALL BE USED. \P AREA = 15.6 SQ. FT. (1.5 m²) Π AREA = 20.8 SQ. FT. (1.9 m²)

ADDITIONAL PAIRS SHALL BE PLACED AT 200' (60 m) TO 300' (90 m) INTERVALS.

MEDIAN WITH TWO-WAY LEFT TURN LANE

-25' (8 m) TD 49' (15 m)

-6 (150) VHITE

-50' (15 m) T□ 200' (60 m) **

OVER 200' (60 m) 10' (3 m) 10' (3 m) 6 (150) WHITE

* TURN LANES IN EXCESS OF 400' (120 m) IN LENGTH MAY HAVE AN ADDITIONAL

TYPICAL LEFT (OR RIGHT) TURN LANE

SET OF ARROW - "ONLY" INSTALLED MIDWAY BETWEEN THE OTHER TWO SETS OF

16′ (5 m)

₹ 3 }

TYPICAL PAINTED MEDIAN MARKING

USER NAME = drivakosgn	DESIGNED - EVERS	REVISED - T.RAMMACHER 10-27-94		DISTRICT ONE TYPICAL PAVEMENT MARKINGS			F.A.U. RTE.	SECTION	COUNTY	TOTAL SHEET SHEET NO.
	DRAWN -	REVISED - C. JUCIUS 09-09-09	STATE OF ILLINOIS				2729	10-00060-00-RS	соок	17 17
PLOT SCALE = 50.000' / IN.	CHECKED	REVISED -	DEPARTMENT OF TRANSPORTATION						TC-13	CONTRAC
PLOT DATE = 9/9/2009	DATE - 03-19-90	REVISED -		SCALE: NONE	SHEET NO. 1 OF 1 SHEETS STA.	TO STA.	FED. RO	OAD DIST. NO. 1 ILLINOIS FED. A	ND PROJECT	
									E.H.E. PROJE	ECT NO. 612-10-06001

4' (1.2 m) DUTSIDE TO

DUTSIDE OF LINES