06-17-2022 LETTING ITEM 106

FOR INDEX OF SHEETS, SEE SHEET NO. 2

STATE OF ILLINOIS

DEPARTMENT OF TRANSPORTATION

PROPOSED HIGHWAY PLANS

ROUTE NA **GREEN BAY TRAIL AT HAZEL AVENUE SECTION 21-00065-00-BT** PROJECT NO. 8WYN(211) **SHARED-USE PATH RECONSTRUCTION COOK COUNTY** C-91-132-22

SECTION 7 R 13 E **LOCATION MAP** NOT TO SCALE **DUNDEE RD END PROJECT** STA. 17 + 16.85

DESIGN DESIGNATION: LOCAL ROAD OB STREET

HAZEL AVENUE

2022 AADT = 250

DESIGN SPEED = 25 MPH

POSTED SPEED = 25 MPH



ENGINEERING SCALES. REDUCED SIZED PLANS WILL NOT CONFORM TO STANDARD SCALES. IN MAKING MEASUREMENTS ON REDUCED PLANS, THE ABOVE SCALES MAY BE USED.


J.U.L.I.E.

JOINT UTILITY LOCATION INFORMATION FOR EXCAVATORS 1-800-892-0123


OR 811

GROSS LENGTH = 400 FT. = 0.076 MILE NET LENGTH = 400 FT. = 0.076 MILE

SECTION COOK 35 1 21-00065-00-BT

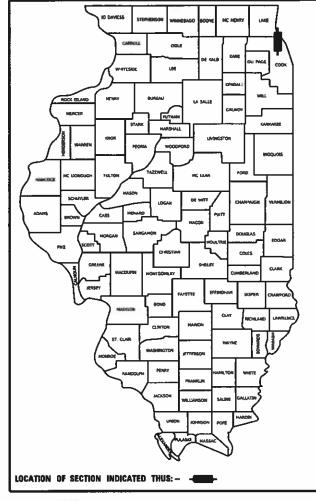



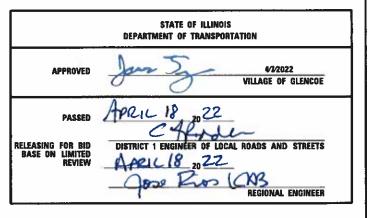

PRINTED BY THE AUTHORITY OF THE STATE OF ILLINOIS

CONTRACT NO. 61H69

INDEX OF SHEETS

HEET NO.	DESCRIPTION
1	COVER SHEET
2	INDEX OF SHEETS, LIST OF DISTRICT DETAILS, HIGHWAY STANDARDS, GENERAL NOTES
3 - 7	SUMMARY OF QUANTITIES
8	TYPICAL SECTIONS
9	ALIGNMENT, TIES, AND BENCHMARKS
10	EXISTING CONDTIONS AND REMOVAL PLANS
11	PROPOSED PLAN
12	PROPOSED PROFILE
13	MAINTENANCE OF TRAFFIC/DETOUR
14	PROPOSED SIGNAGE AND PAVEMENT MARKING PLAN
15 - 20	ELECTRICAL SHEETS
21 - 25	STRUCTURAL SHEETS
26	BORING LOGS
27 - 31	DISTRICT DETAILS / STANDARDS
32 - 35	CROSS SECTIONS

DISTRICT 1 DETAILS

DESCRIPTION

DETA**I**L NO.

BD-07	STORM SEWER CONNECTION TO EXISTING SEWER
BD-08	FRAMES AND LIDS ADJUSTMENT WITH MILLING
BD-22	PAVEMENT PATCHING FOR HMA SURFACING PAVEMENT
BD-24	CURB OR CURB AND GUTTER REMOVAL AND REPLACEMENT
TC-10	TRAFFIC CONTROL AND PROTECTION FOR SIDE ROADS INTERSECTIONS AND DRIVEWAYS

INDEX OF HIGHWAY STANDARDS

STANDARD NO.	<u>DESCRIPTION</u>
000001-08	STANDARD SYMBOLS, ABBREVIATIONS AND PATTERNS
424001-11	PERPENDICULAR CURB RAMPS
442201-03	CLASS C AND D PATCHES
602301-04	INLET - TYPE A
604001-05	FRAME AND LIDS TYPE 1
606001-08	CONCRETE CURB TYPE B AND COMBINATION CONCRETE CURB AND GUTTER
641006 - 01	SIGHT SCREEN WOOD PLANK FENCE TYPE P
701006-05	OFF-ROAD OPERATIONS, 2L, 2W, 15' (4.5 m) TO 24" (600 mm) FROM PAVEMENT EDGE
701011-04	OFF-ROAD OPERATIONS, 2L, 2W, DAY ONLY
701306-04	LANE CLOSURE, 2L, 2W, SLOW MOVING OPERATIONS DAY ONLY FOR SPEEDS >/= 45 MPH
701311-03	LANE CLOSURE, 2L, 2W, MOVING OPERATIONS - DAY ONLY
701801-06	SIDEWALK, CORNER OR CROSSWALK CLOSURE
701901-08	TRAFFIC CONTROL DEVICES
720001-01	SIGN PANEL MOUNTING DETAILS
720006-04	SIGN PANEL ERECTION DETAILS
720011-01	METAL POSTS FOR SIGNS, MARKERS & DELINEATORS
836001-04	LIGHT POLE FOUNDATION

GENERAL NOTES

- 1. ALL CONSTRUCTION SHALL BE DONE IN ACCORDANCE WITH THE "DETAILS" IN THE PLANS, THE "SPECIAL PROVISIONS" INCLUDED IN THE CONTRACT DOCUMENTS, THE "STANDARD SPECIFICATIONS FOR ROAD AND BRIDGE CONSTRUCTION" ADOPTED JANUARY 1, 2022 EDITION OF "SUPPLEMENTAL SPECIFICATIONS AND RECURRING SPECIAL PROVISIONS" ADOPTED JANUARY 1, 2022 EDITION AND JUNE 2014 REVISION OF THE "ILLINOIS MANUAL ON UNIFORM TRAFFIC CONTROL DEVICES FOR STREETS AND HIGHWAYS" (IMUTCD), THE AMERICANS WITH DISABILITIES ACT OF 1990 ACCESSIBILITY GUIDELINES, THE "DRAFT" REHABILITATION ACT OF 1973 (SECTION 504), AND THE LATEST PUBLIC RIGHT-OF-WAY ACCESSIBILITY GUIDELINES.
- THE CONTRACTOR SHALL COMPLY WITH ALL RULES AND REGULATIONS OF OSHA DURING CONSTRUCTION OF IMPROVEMENTS AND RESTORATION. NEITHER THE VILLAGE, DEPARTMENT, NOR THE APPOINTED ENGINEER SHALL BE RESPONSIBLE FOR THE CONTRACTOR'S COMPLIANCE WITH OSHA.
- THE CONTRACTOR SHALL GIVE NOTICES AND COMPLY WITH APPLICABLE LAWS, ORDINANCES, RULES, REGULATIONS AND LAWFUL ORDERS OF ALL PUBLIC AUTHORITIES BEARING ON SAFETY OF PERSONS OR PROPERTY OR THEIR PROTECTION FROM DAMAGE, INJURY OR LOSS.
- THE CONTRACTOR SHALL BE RESPONSIBILITY TO VERIFY ALL DIMENSIONS AND CONDITIONS
 PRIOR TO ORDERING MATERIALS AND BEGINNING CONSTRUCTION.
- 5. THE CONTRACTOR SHALL LIMIT CONSTRUCTION ACTIVITIES TO THE WORK AREAS DESIGNATED ON THE PLANS. ANY DAMAGE TO AREAS OUTSIDE OF THESE LIMITS SHALL BE REPAIRED BY THE CONTRACTOR TO THE SATISFACTION OF THE ENGINEER.
- 5. THE CONTRACTOR SHALL RELOCATE OR REMOVE AND REPLACE SIGNS THAT INTERFERE WITH CONSTRUCTION OPERATIONS, AND TO TEMPORARILY RESET ALL SUCH SIGNS DURING CONSTRUCTION OPERATIONS. IF EXISTING SIGNS ARE DAMAGED DURING THE REMOVAL AND REPLACEMENT PROCESS, THE SIGN SHALL BE REPLACED.
- . AT THE END OF EACH DAY, THE CONTRACTOR SHALL BE RESPONSIBLE TO ASSURE THAT ALL STREETS ADJACENT TO THE PROJECT ARE FREE OF ALL CONSTRUCTION RELATED DEBRIS INCLUDING DIRT, STONE, NAILS, ETC. THE WORK SHALL BE DONE TO THE SATISFACTION OF THE ENGINEER AS COORDINATED WITH THE VILLAGE OF GLENCOE.
- THE CONTRACTOR SHALL CONTACT THE DISTRICT ONE TRAFFIC CONTROL SUPERVISOR AT (847) 705-4470 A MINIMUM OF 72 HOURS IN ADVANCE OF BEGINNING WORK.

- THE LOCATIONS OF EXISTING UNDERGROUND UTILITIES, SUCH AS: WATER MAIN, SEWERS, GAS LINES, ETC. AS SHOWN ON THE PLANS, HAVE BEEN DETERMINED FROM THE BEST AVAILABLE INFORMATION AND ONLY REPRESENT THE OPINION OF THE VILLAGE OF GLENCOE AS TO THEIR LOCATIONS. THE PROVIDED LOCATIONS OF EXISTING UNDERGROUND UTILITIES IS GIVEN FOR THE CONVENIENCE OF THE BIDDER. THE CONTRACTOR SHALL COORDINATE WITH THE UTILITY COMPANIES TO LOCATE THEIR FACILITIES IN THE FIELD PRIOR TO CONSTRUCTION. BEFORE STARTING ANY EXCAVATION, THE CONTRACTOR SHALL CALL JULIE AT (800) 892-0123 FOR FIELD LOCATIONS OF BURIED UTILITIES (48-HOUR NOTIFICATION IS REQUIRED).
- 10. THE CONTRACTOR SHALL BE RESPONSIBLE FOR THE PROTECTION OF ALL UNDERGROUND OR SURFACE UTILITIES EVEN THOUGH THEY MAY NOT BE SHOWN ON THE PLANS. ANY UTILITY THAT IS DAMAGED BY THE CONTRACTOR DURING CONSTRUCTION SHALL BE REPAIRED TO THE SATISFACTION OF THE ENGINEER.
- 11. DRAINAGE: DURING THE CONSTRUCTION OPERATIONS WHEN ANY LOOSE MATERIAL IS DEPOSITED IN THE FLOW LINE OF DITCHES, GUTTERS OR DRAINAGE STRUCTURES SO THE NATURAL FLOW OF WATER IS OBSTRUCTED, THE MATERIAL SHALL BE REMOVED AT THE CLOSE OF EACH WORKING DAY. AT THE CONCLUSION OF THE CONSTRUCTION OPERATIONS ALL DRAINAGE STRUCTURES SHALL BE FREE FROM ALL DIRT AND DEBRIS CAUSED BY THE CONSTRUCTION
- 12. THE CONTRACTOR SHALL BE SOLELY RESPONSIBLE FOR JOB SITE SAFETY AS WELL AS SUPERVISION/ DIRECTION AND MEANS/METHODS OF CONSTRUCTION.
- 13. THE CONTRACTOR SHALL INSTALL/MAINTAIN/REMOVE INLET FILTERS IN ALL OPEN LID DRAINAGE STRUCTURES IN THE PAVEMENT THAT ARE WITHIN THE WORK ZONE OR ACCEPT STORMWATER THAT FLOWS OUT OF THE WORK ZONE, AND AT LOCATIONS AS DIRECTED BY THE ENGINEER.
- 14. AREAS OF PARKWAY RESTORATION ARE SHOWN ON THE PLANS. AREAS DISTURBED BY THE CONTRACTOR BEYOND THOSE SHOWN IN THE PLANS SHALL BE REPAIRED AT NO COST TO THE SATISFICATION OF THE ENGINEER
- 15. THE CONTRACTOR SHALL COORDINATE CONSTRUCTION ACTIVITIES WITH UTILITY COMPANIES, LOCAL GOVERNMENT AGENCIES AND IDOT.
- 16. SOIL STOCKPILES OR OTHER CONSTRUCTION MATERIALS SHALL NOT BE LOCATED WITHIN THE FLOOD PROTECTION AREA.
- 17. VERTICAL DATUM: NAVD 1988
- 18. CONTRACTOR SHALL TAKE PRECAUTION BY PRESERVING EXISTING TREES WITHIN THE RIGHT OF WAY. IF ANY DAMAGE OCCURS, TREES SHALL BE REPLACED IN KIND PER ARTICLE 201.07 REPAIR OR REPLACEMENT OF EXISTING PLANT MATERIAL REQUIREMENTS STATED HEREIN.

<u>COMMITMENTS</u>

NONE.

SER NAME = mmichalowicz DESIGNED -REVISED SECTION COUNTY INDEX OF SHEETS, LIST OF DISTRICT DETAILS, DRAWN -MLM REVISED STATE OF ILLINOIS 21-00065-00-BT COOK 35 2 LIST OF HIGHWAY STANDARDS, GENERAL NOTES REVISED **DEPARTMENT OF TRANSPORTATION** CONTRACT NO. 61H69 SHEETS STA.

					CMAP FUNDI		
					80% FED / 20% LOCAL		
		ITEM	UNIT	TOTAL QUANTITY (80% FEDERAL 20% LOCAL)	FACILITIES FOR BICYCLE/PEDESTRIAN TRAILS 0028	TRAINEES 0042	
	20101000	TEMPORARY FENCE	FOOT	250	250		
	20101100	TREE TRUNK PROTECTION	EACH	9	9		
Δ	20101200	TREE ROOT PRUNING	EACH	5	5		
	20200100	EARTH EXCAVATION	CU YD	670	670		
	20800150	TRENCH BACKFILL	CU YD	12	12		
	21101615	TOPSOIL FURNISH AND PLACE, 4"	SQ YD	417	417		
Δ	25200100	SODDING	SQ YD	417	417		
Δ	25200200	SUPPLEMENTAL WATERING	UNIT	1	1		
	28000250	TEMPORARY EROSION CONTROL SEEDING	POUND	10	10		
	04404000	2.450.457 COANNA AND AND TERMAN TIME B. 411	60.40	roo	500		
	31101200	SUBBASE GRANULAR MATERIAL, TYPE B 4"	SQ YD	508	508		
	40000000	DITUMINOUS MATERIAIS (TACK COAT)	DOLINO	125	125		
	40600290	BITUMINOUS MATERIALS (TACK COAT)	POUND	133	133		
	40600000	TEMPORARY RAMP	SO VD	45	<i>1</i> 5		
	40000330	TEM OVART MAIN	30,10		43		
	40603085	HOT-MIX ASPHALT BINDER COURSE, II-19 0, N70	TON	25.2	25.2		
	40604062	HOT-MIX ASPHALT SURFACE COURSE, IL-9.5, MIX "D". N70	TON	16.8	16.8		
						.,,,	
	42400200	PORTLAND CEMENT CONCRETE SIDEWALK 5 INCH	SQ FT	2045	2045		
	Δ	 20101000 20101100 20101100 20101200 20200100 20200100 20800150 21101615 25200100 25200200 28000250 31101200 40600290 40600990 40603085 40604062 40604062 40604062 	20101000 TEMPORARY FENCE 20101100 TREE TRUNK PROTECTION A 20101200 TREE ROOT PRUNING 20200100 EARTH EXCAVATION 20800150 TRENCH BACKFILL 21101615 TOPSOIL FURNISH AND PLACE, 4" A 25200100 SODDING	20101000 TEMPORARY FENCE FOOT	S.I. CODE NO. ITEM UNIT (80% FEDERAL 20% LOCAL) 2 20101000 TEMPORARY FENCE FOOT 250 2 20101100 TREE TRUNK PROTECTION EACH 9 △ 20101200 TREE ROOT PRUNING EACH 5 ✓ 20200100 EARTH EXCAVATION CU YD 670 ✓ 20800150 TRENCH BACKFILL CU YD 12 ✓ 21101615 TOPSOIL FURNISH AND PLACE, 4" SQ YD 417 △ 25200100 SODDING SQ YD 417 ✓ 28000250 TEMPORARY EROSION CONTROL SEEDING UNIT 1 ✓ 28000250 TEMPORARY EROSION CONTROL SEEDING POUND 10 ✓ 31101200 SUBBASE GRANULAR MATERIAL, TYPE B 4" SQ YD 508 ✓ 40600290 BITUMINOUS MATERIALS (TACK COAT) POUND 135 ✓ 40600308 HOT-MIX ASPHALT BINDER COURSE, IL-19.0, N70 TON 25.2 ✓ 40604062 HOT-MIX ASPHALT SURFACE COURSE, IL-9.5, MIX "D", N70 TON 16.8	S.I. CODE NO. ITEM	

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CHRISTOPHER B. BURKE ENGNEERING, LTD. STS W. Higgins Road, Subs 600 Rosemont, Sincle 60118	ı
PAUL AND	ı

	USER NAME = mmichalowicz	DESIGNED - MLM	REVISED -
٠.	****	DRAWN - MLM	REVISED -
	PLOT SCALE = 2'	CHECKED - MEK	REVISED -
	PLOT DATE = 11/11/2021	DATE - 11/11/202	

STATI	E OF	ILLINOIS
DEPARTMENT	OF	TRANSPORTATION

				MUN RTE.	SECTION	COUNTY	SHEETS	NO.		
SUMMARY OF QUANTITIES							21-00065-00-BT	COOK	35	3
						CONTRAC	T NO. 6:	1H69		
SCALE:	SHEET	OF	SHEETS	STA.	TO STA.	ILLINOIS FED. AID PROJECT				

CONSTRUCTION CODE

						COMPTROCTION	CODE
						CMAP FUNDI	VG
						80% FED / 20% L	
					TOTAL QUANTITY	FACILITIES FOR BICYCLE/PEDESTRIAN	TRAINEES
	CODE NO.	ITEM	UNIT	(80% FEDERAL 20% LOCAL)	TRAILS 0028	0042	
			1.00			0020	
		42400300	PORTLAND CEMENT CONCRETE SIDEWALK 6 INCH	SQ FT	2525	2525	
		42400800	DETECTABLE WARNINGS	SQ FT	70	70	
		44000100	PAVEMENT REMOVAL	SQ YD	60	60	
					-		
		44000164	HOT-MIX ASPHALT SURFACE REMOVAL, 3 3/4"	SQ YD	200	200	
		44000500	COMBINATION CURB AND GUTTER REMOVAL	FOOT	270	270	
		44000600	SIDEWALK REMOVAL	SQ F⊤	4220	4220	
		44204602	CLASS D DATSHES TYPE II. 2 INCH	SQ YD	20	20	
		44201682	CLASS D PATCHES, TYPE II, 3 INCH	30,10	20	20	
		44201683	CLASS D PATCHES, TYPE III, 3 INCH	SQ YD	20	20	
		50200100	STRUCTURE EXCAVATION	CUYD	155	155	
		30203130	STREET ONL EXCITATION				
		50300225	CONCRETE STRUCTURES	CU YD	105	105	
		F080030F	DEINICODETATANT DADE EDOVY COATED	POUND	12965	12965	
		50800205	REINFORCEMENT BARS, EPOXY COATED	POOND	12963	12903	
	Δ	50901750	PARAPET RAILING	FOOT	225	225	
		E0001760	PIPE HANDRAIL	FOOT	100	100	
	Δ	20301/00	FIFE HANDINIL	1001	100	100	
		55080050	STORM SEWERS, CLASS B, TYPE 1 12"	FOOT	30	30	

CI

CHRUSTOPHER B, BURKE ENGINEERING, LTL BOTS W, Region Road, S.As 800 Rosentort, Briola 80018 (part) 82-8000

USER	NAME = mmichalowicz	DESIGNED		MLM	REVISED	-
		DRAWN	-	MLM	REVISED	-
PLOT	SCALE = 2'	CHECKED	•	MEK	REVISED	-
PLOT	DATE = 11/11/2021	DATE	-	11/11/2021	REVISED	-

STA	re of	ILLINOIS
DEPARTMENT	r OF	TRANSPORTATION

				MUN RTE.	SECTION	COUNTY	TOTAL SHEETS	SHEET NO.		
SUMMARY OF QUANTITIES							21-00065-00-BT	соок	35	4
								CONTRACT	NO, 6	1H69
SCALE:	SHEET	OF	SHEETS	STA.	TO STA.		ILLINOIS FED. AID PROJECT			

CONSTRUCTION CODE

						CONSTRUCTION	CODE
						CMAP FUNDI	
						80% FED / 20% L	OCAL
S.P.	S.I.	CODE NO.	ITEM	UNIT	TOTAL QUANTITY (80% FEDERAL 20% LOCAL)	FACILITIES FOR BICYCLE/PEDESTRIAN TRAILS 0028	TRAINEES 0042
		550B0340	STORM SEWERS, CLASS B, TYPE 2 12"	FOOT	30	30	
		60234200	INLETS, TYPE A, TYPE 1 FRAME, OPEN LID	EACH	3	3	
		60603800	COMBINATION CONCRETE CURB AND GUTTER, TYPE B-6.12	FOOT	237	237	
		6/100115	SIGHT SCREEN (WOODEN FENCE), TYPE P 6'	FOOT	1 35	135	
	Δ	04100113	SIGHT SCREEN (WOODENTENCE), TIFE F 0	1001	133		_
		67100100	MOBILIZATION	L SUM	1	1	
	Δ	72000100	SIGN PANEL - TYPE 1	SQ FT	88	88	
		72400200	REMOVE SIGN PANEL ASSEMBLY - TYPE B	EACH	3	3	
	Δ	72900100	METAL POST - TYPE A	FOOT	54	54	
	•	70000400	THERMORIA STIC DAY FRANKITA AA DIVINIG HETTERS AND SVAAROUS	COFF	82	82	
	Δ	78000100	THERMOPLASTIC PAVEMENT MARKING - LETTERS AND SYMBOLS	SQ FT	82	82	
	Δ	78000400	THERMOPLASTIC PAVEMENT MARKING - LINE 6"	FOOT	275	275	
	Δ	78000600	THERMOPLASTIC PAVEMENT MARKING - LINE 12"	FOOT	250	250	
	Δ	78005110	EPOXY PAVEMENT MARKING - LINE 4"	FOOT	390	390	
	Δ	78005180	EPOXY PAVEMENT MARKING - LINE 24"	FOOT	10	10	
	Δ	80400100	ELECTRIC SERVICE INSTALLATION	EACH	1	1	
	-3	30 .00 100		2,7011	<u> </u>		
*	Δ	80400200	ELECTRIC UTILITY SERVICE CONNECTION	L SUM	1	1	

CHRISTOPHER B, BURKE ENGINEERING, LTD.

STS W. Hopins Road, Sude 600

Roammond, Brook 60018

]	USER NAME = mmichalowicz	DESIGNED	-	MLM	REVISED	-
D.		DRAWN		MLM	REVISED	-
	PLOT SCALE = 2'	CHECKED	-	MEK	REVISEO	•
	PLOT DATE = 11/11/2021	DATE		11/11/2021	REVISED	-

STAT	E O	F ILLINOIS
DEPARTMENT	OF	TRANSPORTATION

							MUN RTE.	SECTION	COUNTY	TOTAL	SHEET NO.
		S	UMMARY	OF QUA	ANTITIES			21-00065-00-BT	COOK	35	5
L								· · · ·	CONTRACT	NO. 6	LH69
	SCALE:	SHEET	OF	SHEETS	STA.	TO STA.		ILLINOIS FED. A	ID PROJECT		

						CONSTRUCTION	CODE
						CMAP FUNDI	
S.P.	S.I.	CODE NO.	ITEM	UNIT	TOTAL QUANTITY (80% FEDERAL 20% LOCAL)	80% FED / 20% L FACILITIES FOR BICYCLE/PEDESTRIAN TRAILS 0028	TRAINEES 0042
	Δ	81028180	UNDERGROUND CONDUIT, GALVANIZED STEEL, 1 1/4" DIA.	FOOT	350	350	
·····							
	Δ	81028210	UNDERGROUND CONDUIT, GALVANIZED STEEL, 2 1/2" DIA.	FOOT	30	30	
	Δ	81028730	UNDERGROUND CONDUIT, COILABLE NONMETALLIC CONDUIT, 1 1/4" DIA.	FOOT	290	290	
	_	01020,00	endended denden, dendende normen zeld den en, 11, 12, 12, 11	1001		200	
	Δ	81702110	ELECTRIC CABLE IN CONDUIT, 600V (XLP-TYPE USE) 1/C NO. 10	FOOT	1550	1550	
	Δ	81702130	ELECTRIC CABLE IN CONDUIT, 600V (XLP-TYPE USE) 1/C NO. 6	FOOT	1200	1200	
	Δ	83600200	LIGHT POLE FOUNDATION, 24" DIAMETER	FOOT	18	18	
	Δ	D2003772	EVERGREEN, THUJA OCCIDENTALIS (AMERICAN ARBORVITAE), 6' HEIGHT, BALLED	EACH	8	8	
*		X0300266	WOODEN FENCE REMOVAL	FOOT	35	35	
*		X0321690	BRICK WALL REMOVAL	FOOT	20	20	
*		V02366E4	ORNAMENTAL LIGHT UNIT, COMPLETE	EACH	3	3	
_	Δ	X0320034	ORNAMENTAL LIGHT ONT, COMPLETE	LACII	J	3	
*		X0350805	FOLD DOWN BOLLARDS	EACH	1	1	
*		X7010216	TRAFFIC CONTROL AND PROTECTION, (SPECIAL)	LSUM	1	1	
		Voorses	CCD (GC INCT N. LATION (GD CO.A.)				***************************************
*	Δ	X8050095	SERVICE INSTALLATION (SPECIAL)	EACH	1	1	
*	Δ	XX006066	SIGN TO BE RELOCATED	EACH	1	1	

CHRISTOPHER B. BURKE ENGINEERING, LTD.
5073 VI. Hazera Road, Sula 600
Romerod, Broke 60013
Romerod, Broke 60013

USER HAME = mm[chalowicz	DESIGNED - MLM	REVISED -
	DRAWN - MLM	REVISED -
PLOT SCALE = 2'	CHECKED - MEK	REVISED -
PLOT DATE * 11/11/2021	DATE - 11/11/2021	REVISED -

STATE	E OF	ILLINOIS
DEPARTMENT	OF	TRANSPORTATION

						MUN RTE.	SECT	TON		COUNTY	TOTAL	SHEET NO.
		SUMMARY	OF QU.	ANTITIES			21-0006	5-00-BT		соок	35	6
										CONTRACT	NO. 6	1H69
SCALE:	SHEET	OF	SHEETS	STA.	TO STA.	 	·	ILLINOIS	FED. A	ID PROJECT		

						CONSTRUCTION	CODE
						CMAP FUNDI	
						80% FED / 20% L	OCAL
S.P.	S.1.	CODE NO.	ITEM	UNIT	TOTAL QUANTITY (80% FEDERAL 20% LOCAL)	FACILITIES FOR BICYCLE/PEDESTRIAN TRAILS 0028	TRAINEES 0042
*	D	XX008910	PAVEMENT MARKING (SPECIAL)	SQ FT	300	300	
*		Z0013798	CONSTRUCTION LAYOUT	LSUM	1	1	
*		Z0030850	TEMPORARY INFORMATION SIGNING	SQ FT	100	100	
*		Z0076600	TRAINEES	HOUR	500		500
*		Z0076604	TRAINEES TRAINING PROGRAM GRADUATE	HOUR	500		500

CHRISTOPHER B, BURKE DYGALDONG, (
BATTAL Right GOTS
SAMMOR, Road GOTS
SAMMOR, Road GOTS

	USER NAME = mmichalowicz	DESIGNED	-	MLM	REVISED	-
D.		DRAWN		MEM	REVISED	•
	PLOT SCALE = 2'	CHECKED	•	MEK	REVISED	•
	PLOT DATE → 11/11/2021	DATE	-	11/11/2021	REVISED	-


STATI	E 01	F ILLINOIS
DEPARTMENT	OF	TRANSPORTATION

				MUN RTE.	SECTION	COUNTY	TOTAL SHEETS	SHEET NO.		
	S	UMMAR	Y OF QU		21-00065-00-BT	соок	35	7		
								CONTRACT	T NO. 6	1H69
SCALE:	SHEET	OF	SHEETS	STA.	TO STA.	ILLINOIS FED. AID PROJECT				

SIDEWALK REMOVAL (44000600)

EXISTING TYPICAL SECTION STA. 13 + 00.00 TO STA. 15 + 32.24 STA. 15 + 64.50 TO STA. 17 + 16.85

EDGE OF PATH/PGL

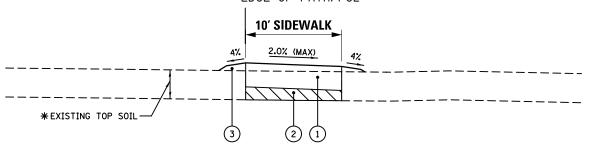

SUBBASE GRANULAR MATERIAL, TYPE B 4" (31101200)

1) PORTLAND CEMENT CONCRETE SIDEWALK 6 INCH (42400300)

TOPSOIL FURNISH AND PLACE, 4" (21101615) SODDING (25200100)

PROPOSED TYPICAL SECTION STA. 13 + 00.00 TO STA. 15 + 32.24 STA. 15 + 64.50 TO STA. 17 + 16.85

HOT-MIX ASPHALT MIXTURE REQUIREMENTS

MIXTURE TYPE	AIR VOIDS (%) @ NDES	QMP
HAZEL AVENUE RESURFACING		
HOT-MIX ASPHALT BINDER COURSE, IL-19.0, N70 2.5"	4% c 70 GYR.	LR 1030-2
HOT-MIX ASPHALT SURFACE COURSE, IL-9.5, MIX "D", N70 1.5"	4% @ 70 GRY.	LR 1030-2
CLASS D PATCHES		
HOT-MIX ASPHALT BINDER COURSE, IL-19.0, N70	4% @ 70 GYR.	LR 1030-2


NOTES:

- 1. THE UNIT WEIGHT USED TO CALCULATE ALL HOT-MIX ASPHALT SURFACE QUANTITIES IS 112 LB/SQ TD/IN.
 2. THE "AC TYPE" FOR POLYMERIZED HMA MIXES SHALL BE "SBS/SBR PG 76-22" AND FOR NON-POLYMERIZED HMA THE "AC TYPE" SHALL BE "PG 64-22" UNLESS MODIFIED BY RECLAIMED MATERIALS SPECIFICATIONS.

:	
TEL NOTHER	CHRISTOPHER B. BURKE ENGINEERING, LTD. 9575 W. Higgins Road, Suite 600 Rosemont. Illinois 60018 (847) 823-0500

USER NAME = mmichalowicz	DESIGNED -	MLM	REVISED -
	DRAWN -	MLM	REVISED -
PLOT SCALE = 2'	CHECKED -	MEK	REVISED -
PLOT DATE = 11/11/2021	DATE -	11/11/2021	REVISED -

						MUN RTE.	SECTION	COUNTY	TOTAL SHEETS	SHEET NO.
	TYPICAL SECTIONS						21-00065-00-BT	соок	35	8
								CONTRAC	T NO. 6	1H69
SCALE:	SHEET	OF	SHEETS	STA.	TO STA.		ILLINOIS FED. A	AID PROJECT		

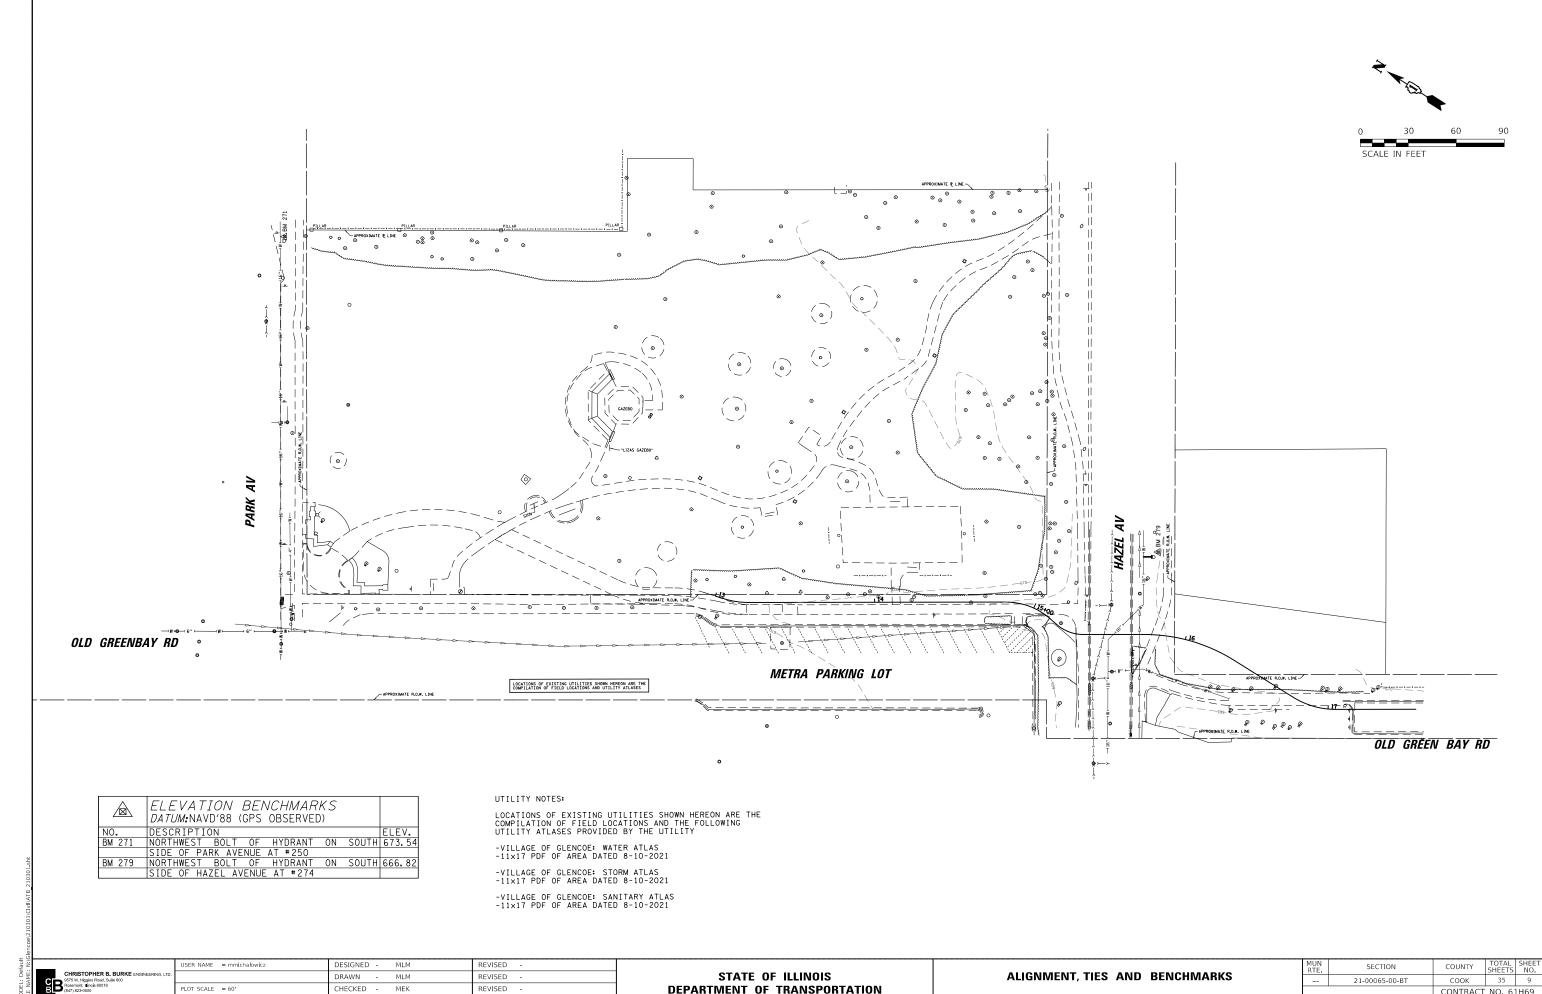



LOT SCALE = 60' CHECKED -MEK REVISED PLOT DATE = 11/11/2021


DEPARTMENT OF TRANSPORTATION


OF SHEETS STA.

CONTRACT NO. 61H69

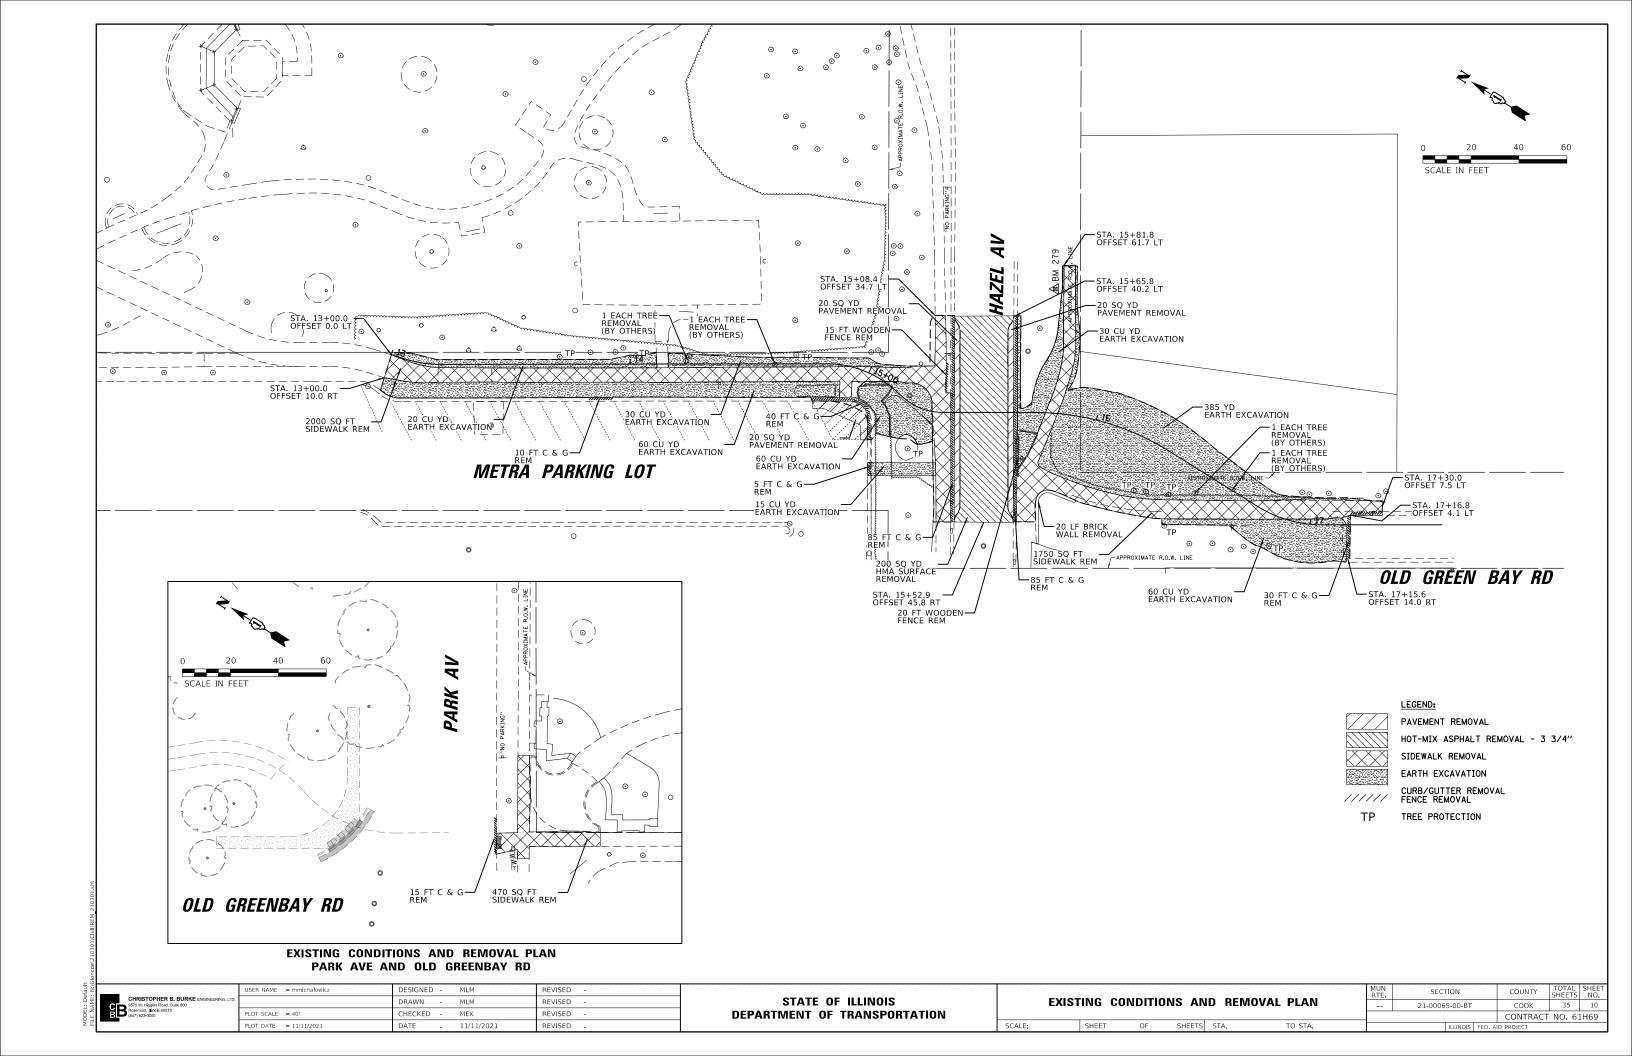

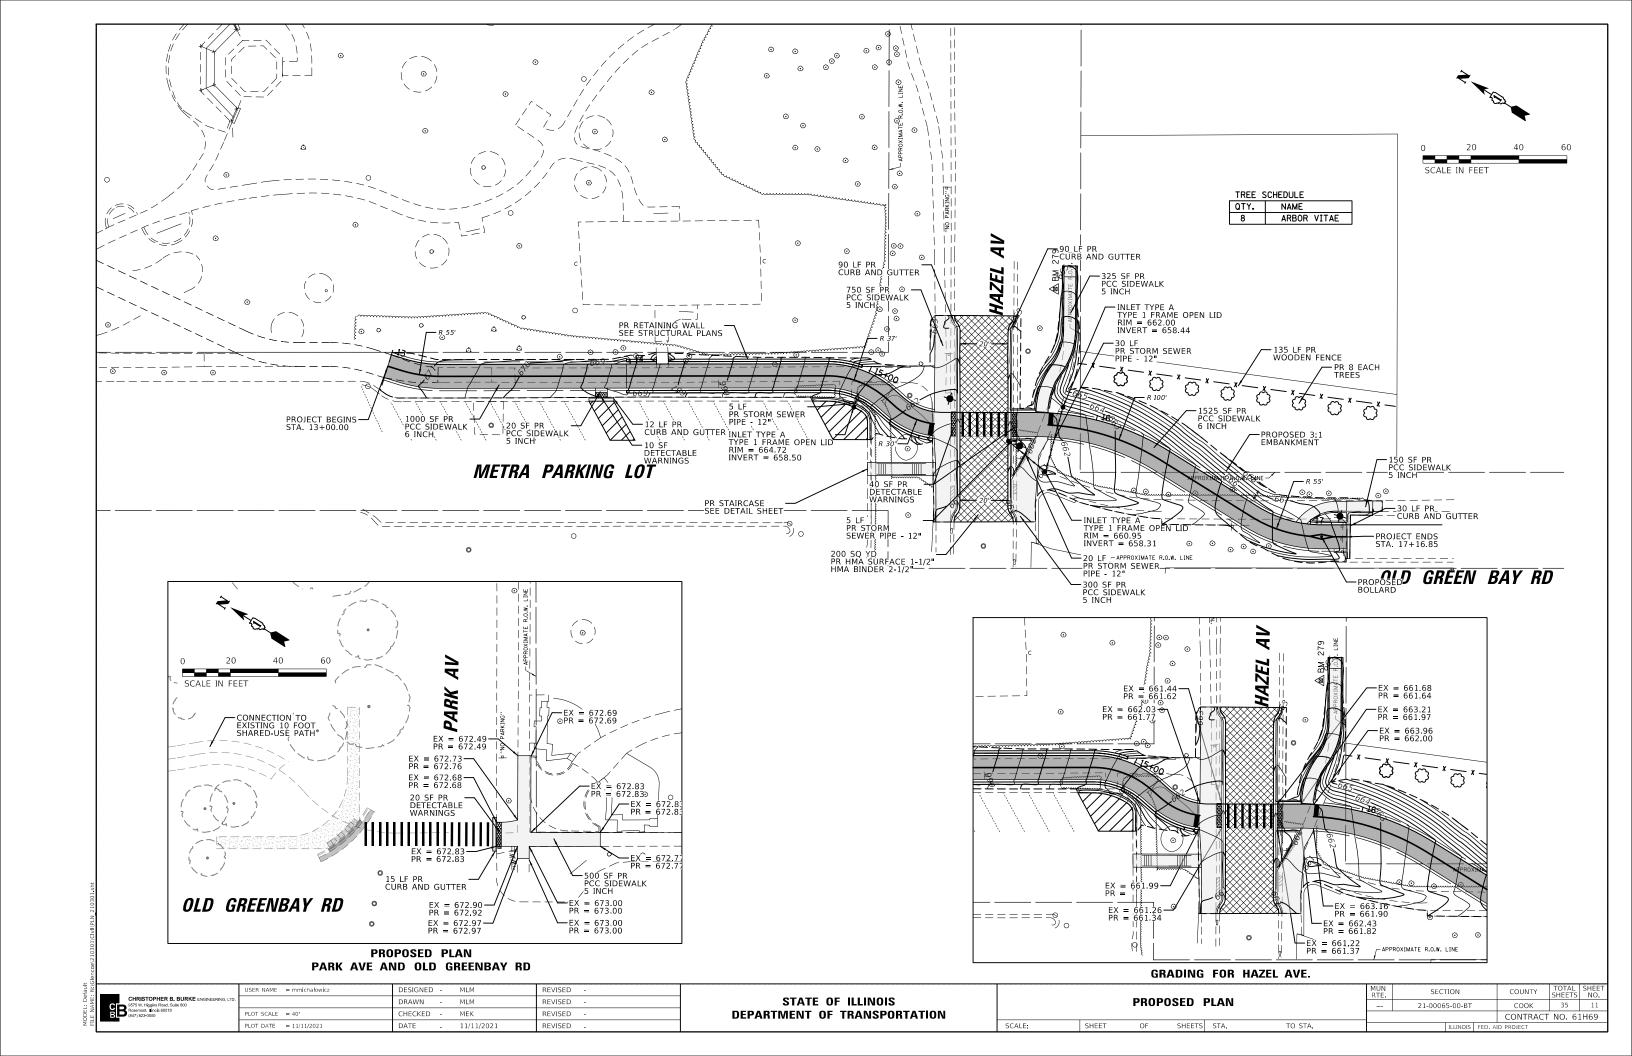

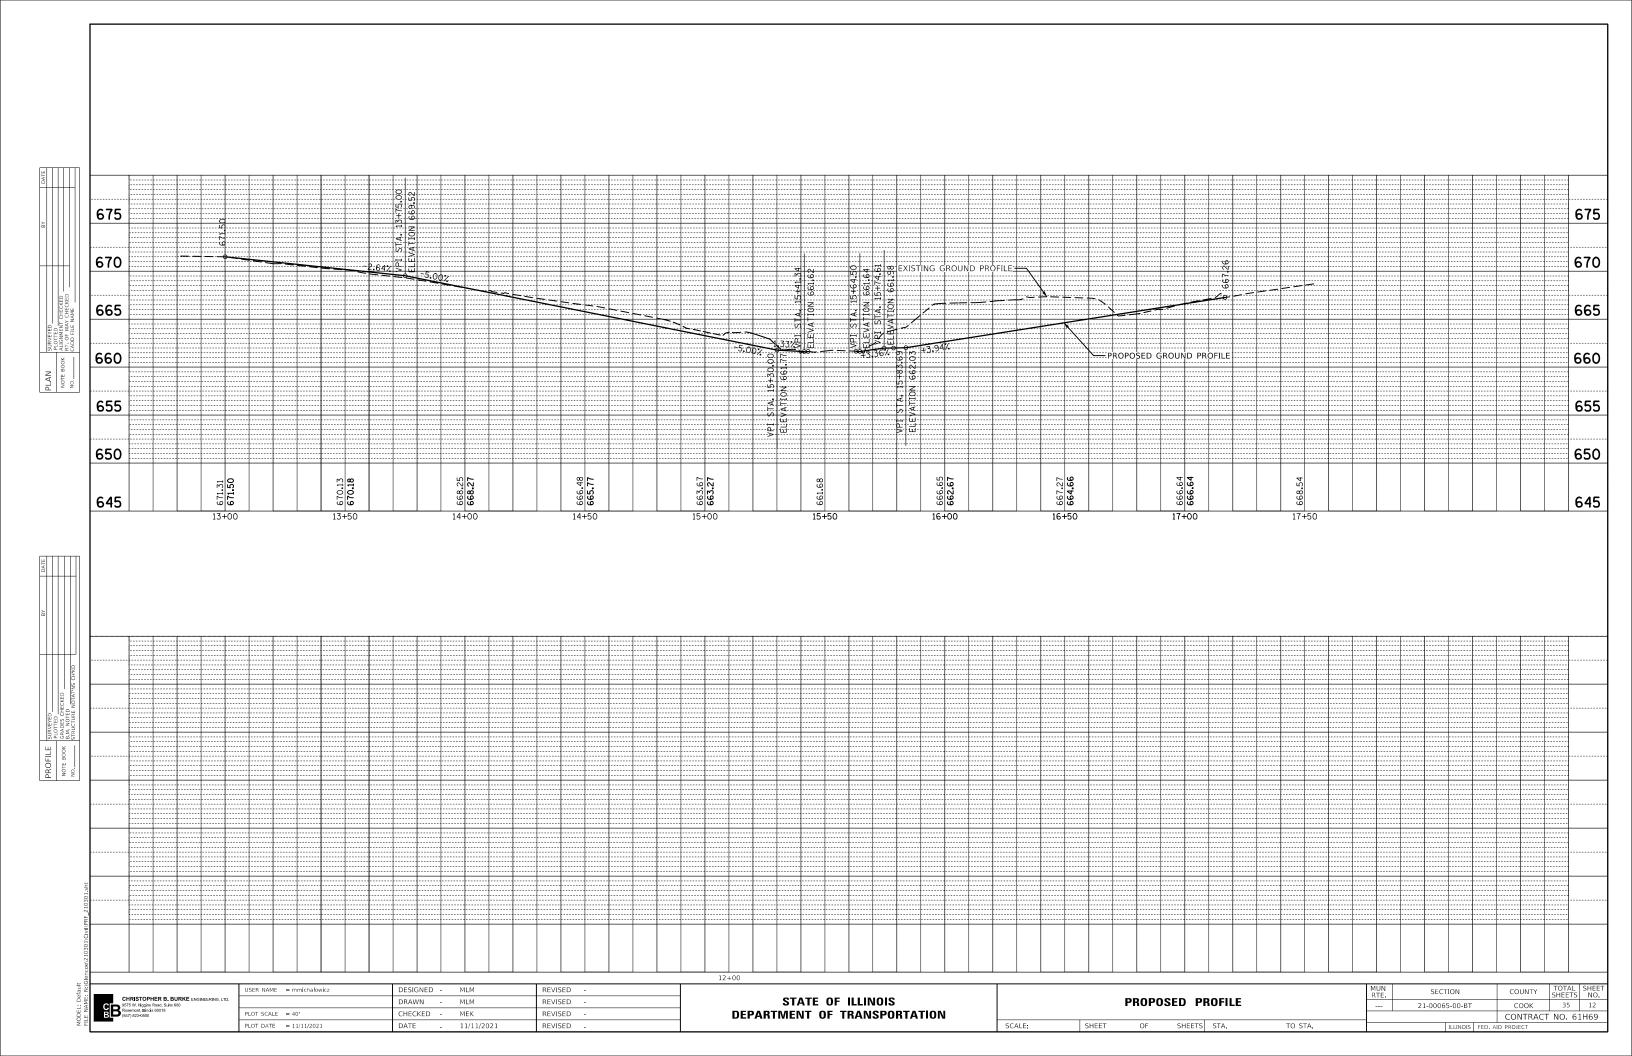

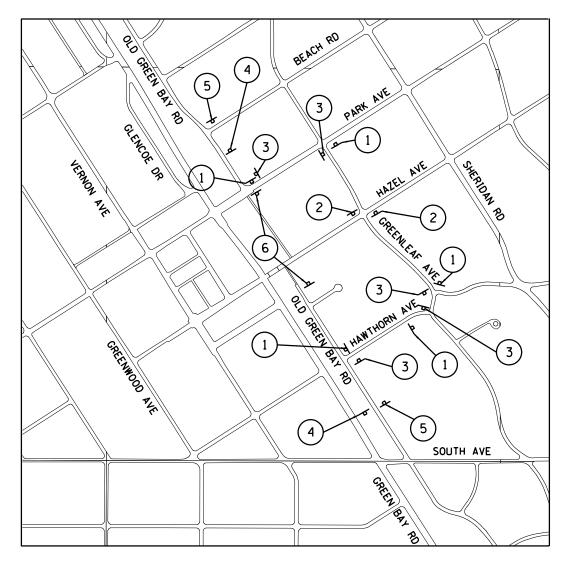

BIKE DETOUR PLAN



M4-9a (L) 3021

4

M4-8A 2418

END

DETOUR



M4-9a 3021

2

DETOUR AHEAD

W20-2 (0) 48 X 48

5

Ø **1** DETOUR

M4-9a (R) 3021

3

 $\begin{array}{c} {\rm PATH} \\ {\rm CLOSED} \end{array}$

R11-2(mod) 4830

6


JSER NAME = mmichalowicz DESIGNED - MLM REVISED DRAWN -MLM REVISED -LOT SCALE = 40' CHECKED -MEK REVISED

STATE OF ILLINOIS **DEPARTMENT OF TRANSPORTATION**

DETOUR PLAN AND MAINTENANCE OF TRAFFIC PLAN SHEETS STA.

SECTION COUNTY COUNTY SHEETS NO.

COOK 35 13 21-00065-00-BT CONTRACT NO. 61H69

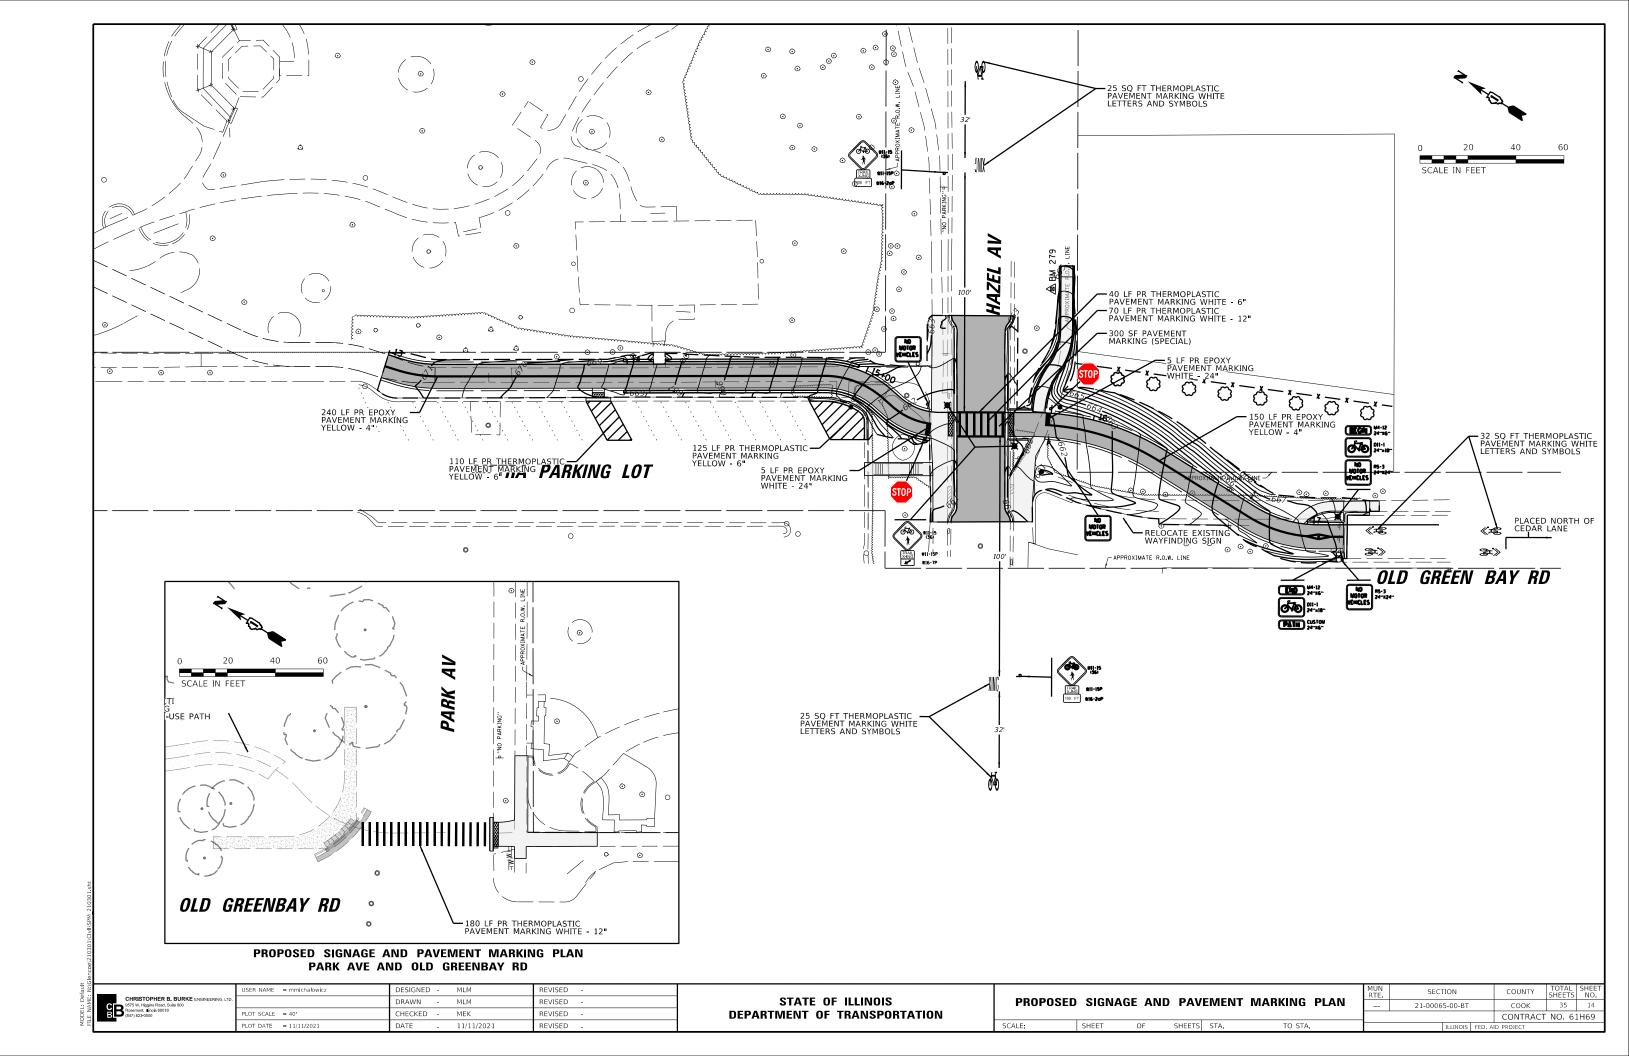

GENERAL NOTES

- THE CONTRACTOR SHALL BE LICENSED TO PERFORM WORK WITH THE OWNER AND OBTAIN THE REQUIRED PERMITS FROM THE BUILDING DEPARTMENT AND SHALL BE RESPONSIBLE FOR OBTAINING/RETAINING THE REQUIRED INSURANCE AND BONDS BEFORE THE START OF WORK. ANY COST FOR THE LICENSING, BONDS OR INSURANCE SHALL BE INCLUDED IN THE ENTIRE COST OF THE CONTRACT.
- THE EXACT LOCATIONS OF ALL UTILITIES SHALL BE VERIFIED BY THE CONTRACTOR BEFORE THE INSTALLATION OF ANY COMPONENTS OF THE LIGHTING OR IRRIGATION SYSTEM. FOR THE LOCATIONS OF THE UTILITIES, CALL JULIE TOLL FREE AT (800) 892-0123.
- 3. BEFORE INSTALLING LIGHT STANDARDS NEAR OVERHEAD AND UNDERGROUND ELECTRIC UTILITIES, CONTRACTOR SHALL CALL COM ED FOR LOCATION APPROVAL AND MINIMUM CLEARANCE REQUIREMENTS.
- THE WORK PERFORMED UNDER THIS CONTRACT SHALL IN NO WAY INTERFERE WITH THE NORMAL OPERATION OF ANY EXISTING UTILITY SERVICE. THE CONTRACTOR SHALL FURNISH ALL NECESSARY ITEMS OF EQUIPMENT REQUIRED TO MAINTAIN SUCH NORMAL OPERATION AT NO ADDITIONAL COST TO THE OWNER. THE COST ASSOCIATED FOR THIS WORK SHALL BE CONSIDERED INCIDENTAL TO THE COST OF THE CONTRACT, AND NO ADDITIONAL COMPENSATION SHALL BE AWARDED.
- ALL DISTURBED AREAS WHERE RESTORATION IS NOT COVERED BY APPLICABLE SECTIONS OF THE SPECIAL PROVISIONS MUST BE RESTORED TO THE SATISFACTION OF THE OWNER. THE WORK WILL BE CONSIDERED INCLUDED IN THE COST OF THE CONTRACT. SEPARATE PAYMENT WILL NOT BE MADE.
- THE CONTRACTOR SHALL BE SOLELY RESPONSIBLE FOR JOB SITE SAFETY AS WELL AS SUPERVISION/DIRECTION AND MEANS/METHODS OF CONSTRUCTION.
- 7. ALL WORK SHALL BE IN ACCORDANCE WITH THE LATEST EDITION OF THE FOLLOWING SPECIFICATIONS, WHICH ARE HEREBY MADE A PART HEREOF:
 - A. "STANDARD SPECIFICATIONS FOR ROAD AND BRIDGE CONSTRUCTION", AS PREPARED BY IDOT
 - B. THE NATIONAL ELECTRICAL CODE
 - C. MUNICIPAL CODES AND STANDARDS
- 8. NO MATERIALS SHALL BE DELIVERED TO THE JOB SITE UNTIL ALL PERTINENT EQUIPMENT SUBMITTALS HAVE BEEN REVIEWED BY THE ENGINEER.
- THE CONTRACTOR SHALL LABEL ALL WIRES WITH WIRE MARKERS INDICATING THE CIRCUIT ID IN EVERY POLE BASE, HAND HOLE AND SPLICE/CONNECTION POINT. WIRE MARKERS SHALL BE WHITE NYLON WITH INTEGRAL MECHANICAL FASTENER WITH MINIMUM 34" X 1" WRITEABLE AREA.
- 10. ALL UNDERGROUND WIRING SHALL BE XLP TYPE-USE, EXTRA ABRASION RESISTANCE, 600 VOLTS, INSTALLED IN SCH 40 HDPE CONDUIT A MINIMUM 30 INCHES BELOW FINISH GRADE, FOLLOWING THE ROADWAY OR SIDEWALK EDGE.
- 11. TO MAINTAIN THE STRUCTURAL INTEGRITY OF LIGHT POLES WITH LUMINAIRE ARMS, THEY SHALL NOT BE ERECTED AND LEFT TO STAND WITHOUT LUMINAIRES.
- 12. NO POLES SHALL BE ERECTED UNTIL THE RESPECTIVE FOUNDATIONS HAVE CURED AND HAVE BEEN REVIEWED BY THE ENGINEER.
- 13. THE LIGHT POLE LOCATIONS SHALL COMPLY WITH THE MINIMUM CLEAR WIDTH FOR AN ACCESSIBLE ROUTE FOR SIDEWALKS PER CURRENT AMERICAN WITH DISABILITIES ACT (ADA) REQUIREMENTS, BDE CHAPTER 17-4.04, AND PUBLIC RIGHT-OF-WAY ACCESSIBILITY GUIDELINES (PROWAG) R301.3.1.
- 14. THE CONTRACTOR SHALL BE RESPONSIBLE FOR THE ESTABLISHMENT OF THE TOP OF FOUNDATION ELEVATION WITH THE FINISH GRADE.
- 15. EQUIPMENT GROUND CONDUCTORS SHALL BE SPLICED AND BONDED AT EACH LIGHT POLE OR OTHER PIECE OF EQUIPMENT.
- 16. IT SHALL BE THE CONTRACTOR'S RESPONSIBILITY TO MARK THE PROPOSED LOCATIONS OF ALL LIGHT POLES FOR EXAMINATION AND CONFIRMATION WITH THE ENGINEER. ALL UTILITIES SHALL BE LOCATED PRIOR TO MARKING PROPOSED LIGHT POLE LOCATIONS. THE ELECTRICAL CONTRACTOR SHALL FURNISH TWO SETS OF FULL SIZE RECORD DRAWINGS (HARD COPY, AUTOCAD AND PDF) TO THE ENGINEER UPON COMPLETION OF THE LIGHTING AND ELECTRICAL IMPROVEMENTS. THE DRAWINGS SHALL SHOW THE INSTALLED LOCATIONS OF ALL LIGHT POLES, UNDERGROUND CONDUITS/WRING, HANDHOLES, JUNCTION BOXES AND CONTROLLER CABINETS. THE DRAWINGS WILL BE REVIEWED BY THE ENGINEER.
- UPON COMPLETION OF THE PROPOSED LIGHTING IMPROVEMENTS, THE CONTRACTOR SHALL PERFORM ELECTRICAL TESTING AND VERIFY THAT THE INSTALLATION COMPLIES WITH THE LATEST EDITION OF THE STANDARD SPECIFICATIONS FOR ROAD AND BRIDGE CONSTRUCTION IN ILLINOIS. ALL ELECTRICAL TESTING SHALL BE PERFORMED IN THE PRESENCE OF THE ENGINEER.
- 19. ALL TREE TRIMMING REQUIRED AS DIRECTED BY THE OWNER'S REPRESENTATIVE SHALL BE PERFORMED BY THE OWNER.
- 20. ALL REMOVAL OR EXCAVATION ITEMS BEING DISPOSED OF AT AN UNCONTAMINATED SOIL FILL OPERATION OR CLEAN CONSTRUCTION AND DEMOLITION DEBRIS (CCDD) FILL SITE SHALL MEET THE REQUIREMENTS OF PUBLIC ACT 96-1416. ALL COSTS ASSOCIATED WITH MEETING THESE REQUIREMENTS SHALL BE INCLUDED IN THE UNIT PRICE COST FOR THE ASSOCIATED REMOVAL OR EXCAVATION ITEMS IN THE CONTRACT. THESE COSTS SHALL INCLUDE BUT ARE NOT LIMITED TO ALL REQUIRED TESTING, LAB ANALYSIS, CERTIFICATION BY A LICENSED PROFESSIONAL ENGINEER, AND STATE OR LOCAL TIPPING FEES.
- 21. ALL STEEL SHALL BE FROM DOMESTIC SOURCE.

BILL OF MATERIALS

DESCRIPTION	UNIIT	QUANTITY
ELECTRIC SERVICE INSTALLATION	EACH	1
ELECTRIC SERVICE UTILITY CONNECTION	L SUM	1
UNDERGROUND CONDUIT, GALVANIZED STEEL, 1 1/4" DIA.	FOOT	350
UNDERGROUND CONDUIT, GALVANIZED STEEL, 2 1/2" DIA.	FOOT	30
UNDERGROUND CONDUIT, COILABLE NONMETALLIC, 1 1/4" DIA.	FOOT	290
ELECTRIC CABLE IN CONDUIT, 600V (XLP-TYPE USE) 1/C NO. 10	FOOT	1,550
ELECTRIC CABLE IN CONDUIT, 600V (XLP-TYPE USE) 1/C NO. 6	FOOT	1,200
LIGHT POLE FOUNDATION, 24" DIAMETER	FOOT	18
ORNAMENTAL LIGHT UNIT, COMPLETE	EACH	3
SERVICE INSTALLATION (SPECIAL)	EACH	1

* SEE SPECIAL PROVISIONS

CAUTION! NOTE TO CONTRACTOR:

THE CONTRACTOR IS SPECIFICALLY CAUTIONED TO THE LOCATION AND/OR ELEVATION OF EXISTING AND PROPOSED UTILITIES AS SHOWN ON THESE DRAWINGS. THE INFORMATION IS NOT TO BE RELIED ON AS BEING EXACT OR COMPLETE. THE CONTRACTOR MUST CALL THE LOCAL UTILITY LOCATION CENTER AT LEAST 72 HOURS BEFORE ANY EXCAVATION TO REQUEST EXACT FIELD LOCATIONS OF THE UTILITIES, IT SHALL BE THE RESPONSIBILITY OF THE CONTRACTOR TO INFORM ENGINEER OF ANY EXISTING UTILITIES WHICH CONFLICT WITH THE PROPOSED IMPROVEMENTS.

THE VILLAGE OF GLENCOE WILL OWN AND MAINTAIN THE PROPOSED LIGHTING SYSTEM AT THE GREEN BAY TRAIL AND HAZEL AVENUE CROSSING

ABBREVIATIONS

ATS ATTACHED TO STRUCTURE

СВ CIRCUIT BREAKER

CKT CIRCUIT

COILABLE NON-METALLIC CONDUIT

CURRENT TRANSFORMER

EIS EMBEDDED IN STRUCTURE

FT

FOC FACE OF CURB

GND GROUND

HDPF HIGH DENSITY POLYETHYLENE

HAND HOLE

HIGH INTENSITY DISCHARGE

HIGH PRESSURE SODIUM

JUNCTION BOX

KILOWATTS

LIGHT EMITTING DIODE

MAST ARM

MOUNTING HEIGHT

NTS NOT TO SCALE

POLYVINYL CHLORIDE RIGID GALVANIZED STEEL CONDUIT

RIGHT OF WAY

STAINLESS STEEL


STA

XFMR TRANSFORMER UNIT DUCT

VOLTS

WEATHER RESISTANT

FILE NAME =	USER NAME = mmichalowicz	DESIGNED	DRK	REVISED -						TES AND BILL OF		MUN RTF.	SECTION	COUNTY	TOTAL	SHEET NO.
\\tbg.net\CBBEL\CBBELDFT\Glencoe\210301\	Mech\01-N0T_210301.sht	DRAWN	CPG	REVISED -	STATE OF ILLINOIS	GREEN BA	Y TRAI	IL AND	HAZEI	L AVENUE CROSSI	NG IMPROVEMENTS		21-00065-00-BT	соок	35	15
D 6 1.	PLOT SCALE = 40'	CHECKED	DRK	REVISED -	DEPARTMENT OF TRANSPORTATION				GLENG	COE, ILLINOIS				CONTRAC	CT NO. 61	169
Default	PLOT DATE = 3/17/2022	DATE	3/17/2022	REVISED -		SCALE: N.T.S.	SHEE	ET 1	0F	SHEETS STA.	TO STA.		ILLINOIS FED. A	ID PROJECT		

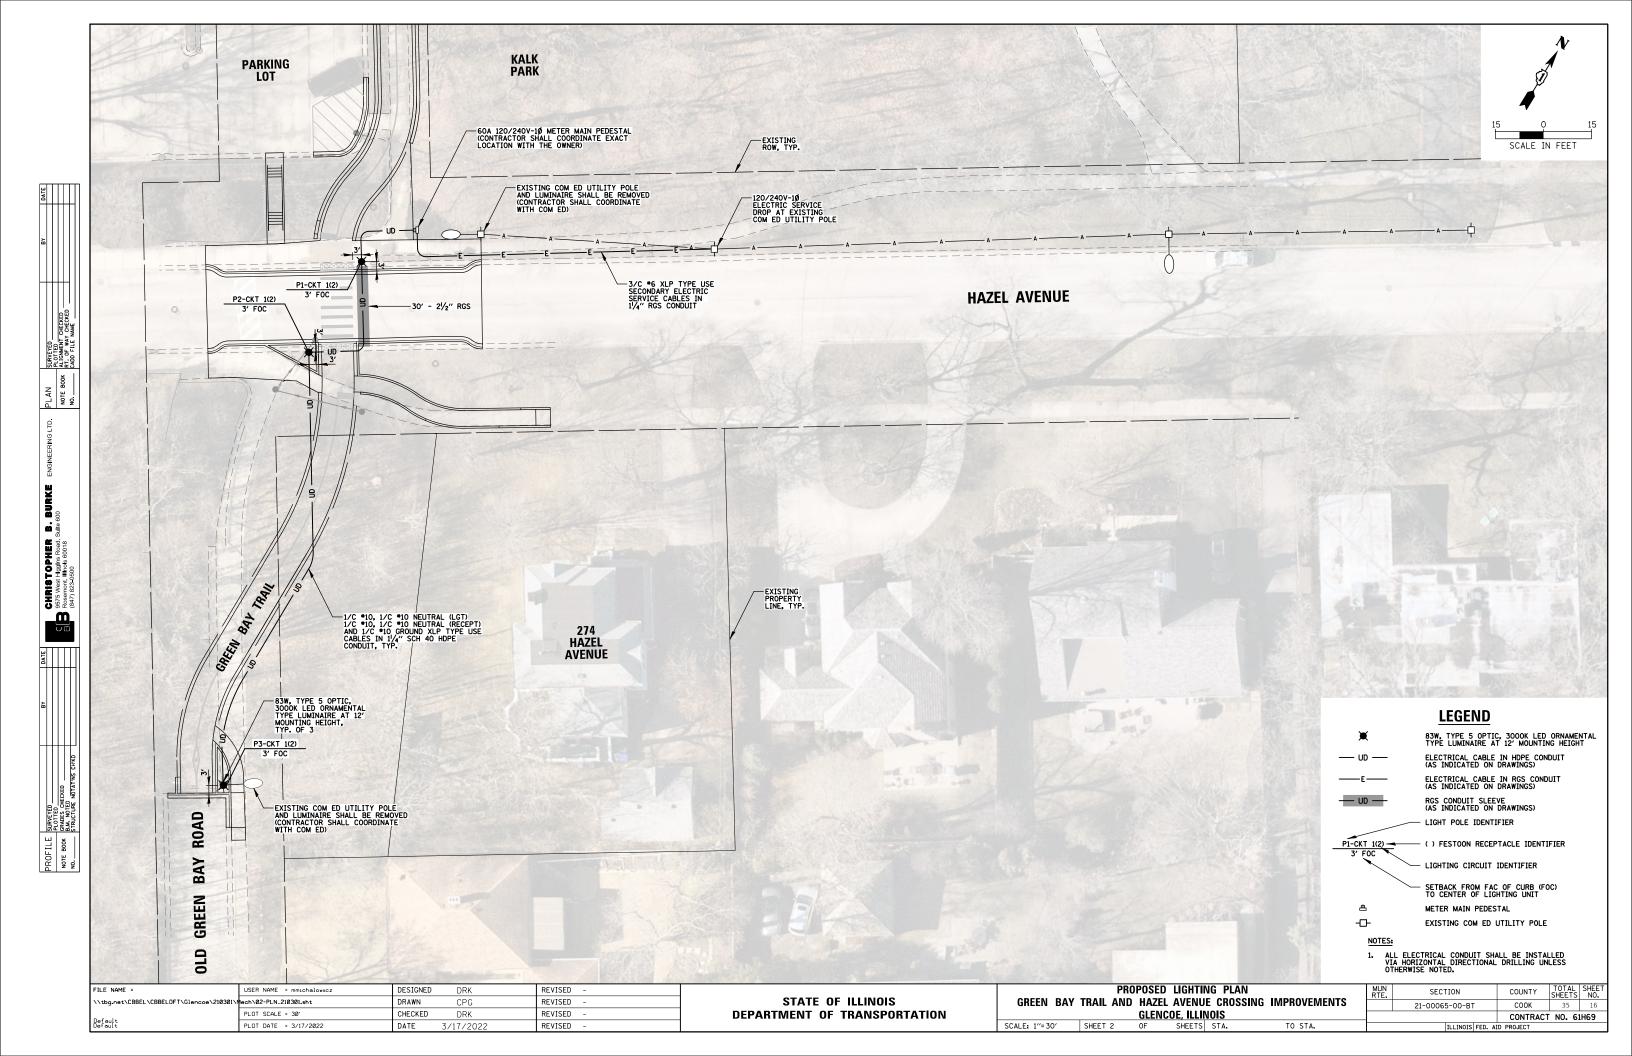

METER MAIN PEDESTAL LOADS									
CIRCUIT ID (INSULATION COLOR)	CIRCUIT BREAKER/POLES	LED ORNAMENTAL LUMINAIRE		FESTOOON RECEPTACLE		TOTAL CIRCUIT LOAD			
	BREAKER/POLES	QTY.	LOAD (WATTS)	QTY.	LOAD (WATTS)	WATTS	AMPS	VOLTS	
1 - RED/GRAY	20A-1P	3	83	0	180	249	2.1	120	
2 - BLACK/WHITE	20A-1P	0	83	3	180	540	4.5	120	
3 - SPARE	20A-1P	0	83	0	180	0	0.0	120	
4 - SPARE	20A-1P	0	83	0	180	0	0.0	120	
TOTAL	-	3	-	3	-	789W	3.29A	240\	

HOT DIPPED GALVANIZAED STEEL 15%" X 21%6", 12 GAUGE SOLID STRUT

STRUI "%" GALVANIZED STEEL BÖLT & NUT WITH RUBBER WASHER INSIDE/OUTSIDE TO MAKE WATERTIGHT CONNECTION

-60A 120/240V-1Ø METER MAIN PEDESTAL, ARRANGED FOR DIRECT EMBEDMENT (COM ED APPROVED)

-60A, 2-POLE, 240V, 10 KAIC MAIN BREAKER

-(4) 20A, 1-POLE, 120V, 10 KAIC BRANCH CIRCUIT BREAKERS


21/16"

1. ALL CIRCUIT BREAKERS SHALL HAVE LOCKABLE COVERS.


THE METER MAIN PEDESTAL, GROUND ROD/CABLES AND STRUT SHALL BE INCLUDED IN THE PRICE BID FOR "SERVICE INSTALLATION (SPECIAL)." CONDUIT AND CABLE FROM THE METER PEDESTAL TO/FROM LIGHING, FESTOON RECEPTACLES AND ELECTRIC SERVICE DROP SHALL BE PAID FOR SEPARATELY.

METER MAIN PEDESTAL DETAIL

FINISH-GRADE

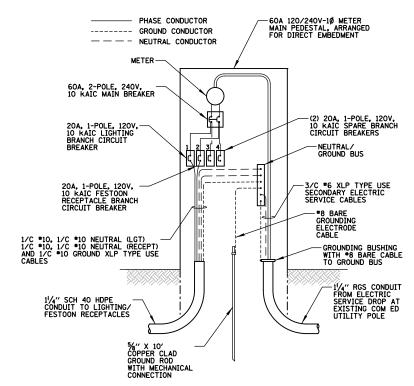

METER MAIN PEDESTAL WIRING DIAGRAM

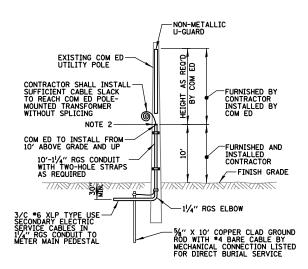

- ALL WORK SHALL CONFORM TO COM ED'S BOOK OF "INFORMATION AND REQUIREMENTS FOR THE SUPPLY OF ELECTRIC SERVICE."
- 2. CONTRACTOR SHALL PROVIDE CONDUIT BUSHING AND SEALING COMPOUND AT TOP OF RISER.
- 3. IT IS THE CONTRACTOR'S RESPONSIBILITY TO INSTALL APPROPRIATE FITTINGS WHEN TRANSFERRING FROM HDPE CONDUIT TO ABOVE GRADE RGS CONDUIT.
- 4. ALL MATERIAL ABOVE GRADE (EXCEPT FOR EXISTING COM ED UTILITY POLE) SHALL BE INCLUDED IN THE PRICE BID FOR "ELECTRIC SERVICE INSTALLATION". HORIZONTAL CONDUIT AND CABLE TO METER MAIN PEDESTAL SHALL BE PAID FOR SEPERATELY.

ELECTRIC SERVICE INSTALLATION DETAIL


FILE NAME =	USER NAME = mmichalowicz	DESIGNED DRK	REVISED -		LIGHTING DETAILS (1 OF 4) GREEN BAY TRAIL AND HAZEL AVENUE CROSSING IMPROVEMENTS		SECTION	COUNTY	TOTAL SHEET
\\tbg.net\CBBEL\CBBELDFT\Glencoe\210301\	Mech\03-LDT_210301.sht	DRAWN CPG	REVISED -	STATE OF ILLINOIS			21-00065-00-BT	соок	35 17
Default	PLOT SCALE = 40'	CHECKED DRK	REVISED -	DEPARTMENT OF TRANSPORTATION	GLENCOE, ILLINOIS			CONTRAC	T NO. 61H69
Default	PLOT DATE = 3/17/2022	DATE 3/17/202	REVISED -		SCALE: N.T.S. SHEET 3 OF SHEETS STA. TO STA.		ILLINOIS FED. AI	ID PROJECT	

• CHRISTOPHER 9575 West Higgins Road, SI Rosemont, Illinois 60018 (847) 823-0500

2 ②_MIN. 2' MIN. 2'_ VARIABLE R.O.W. R.O.W. 1 RGS CONDUIT

- ① SLEEVE SHALL BE HEAVY WALL RIGID GALVANIZED STEEL (RGS) CONDUIT
- 2 SLEEVE SHALL EXTEND A MINIMUM OF 2' BEYOND BACK OF CURB
- 3 SLEEVE SHALL BE A MINIMUM OF 30" BELOW ROADWAY OR CURB BOTTOM

ROADWAY/PAVEMENT CROSSING

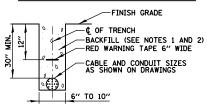


TRENCH CROSS SECTION


NOTES:

- BACKFILL MATERIAL SHALL BE FREE OF BRICK, ROCK, OR ANY MATERIAL THAT COULD DAMAGE THE CONDUIT.
- 2. BACKFILL MATERIAL FOR TRENCHES WHERE THE INNER EDGE OF THE TRENCH IS WITHIN 2 FT OF THE EDGE OF THE PROPOSED PAVEMENT, CURB, GUTTER, CURB AND GUTTER, STABILIZED SHOULDER, OR SIDEWALK SHALL BE TRENCH BACKFILL IN ACCORDANCE WITH THE PROVISIONS OF SECTION 208 OF THE STANDARD SPECIFICATIONS AND SHALL BE CONSIDERED INCIDENTAL TO THE TOTAL COST OF THE CONTRACT.


ELECTRIC CONDUIT INSTALLATION DETAIL

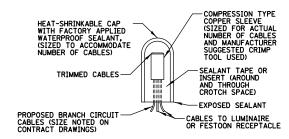


ELECTRIC CABLE SPLICE DETAIL

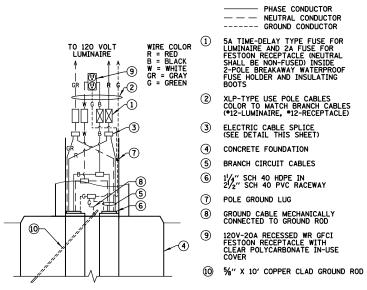

ORNAMENTAL LIGHT UNIT HANDHOLE WIRING DIAGRAM

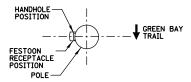

POSITION OF LIGHT UNIT HANDHOLE DETAIL

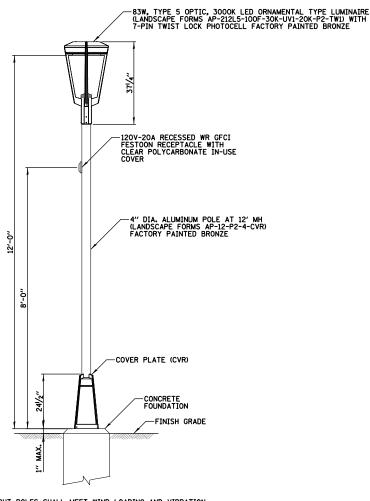


NOTES:

- 1. ALL LIGHT POLES SHALL MEET WIND LOADING AND VIBRATION REQUIREMENTS ACCORDING TO THE LATEST AASHTO STANDARDS AND ARTICLE 1069.01 IN STANDARD SPECIFICATIONS FOR ROAD AND BRIDGE CONSTRUCTION. CONTRACTOR SHALL SUBMIT LIGHT POLE LOADING CALCULATIONS, STAMPED BY A LICENSED STRUCTURAL ENGINEER, TO THE OWNER'S REPRESENTATIVE TO SHOW THAT LIGHT POLE CAN STRUCTURALLY SUPPORT PROPOSED LUMINAIRE.
- 2. ALL LIGHT POLES SHALL BE UL LISTED.


ORNAMENTAL LIGHT UNIT DETAIL

FILE NAME =	USER NAME = mmichalowicz	DESIGNED	DRK	REVISED -		LIGHTING DETAILS (2 OF 4)	MUN	SECTION	COUNTY	TOTAL SHEET
\\tbg.net\CBBEL\CBBELDFT\Glencoe\210301\	Mech\04-LDT_210301.sht	DRAWN	CPG	REVISED -	STATE OF ILLINOIS	GREEN BAY TRAIL AND HAZEL AVENUE CROSSING IMPROVEMENTS	1112	21-00065-00-BT	соок	35 18
Default	PLOT SCALE = 40'	CHECKED	DRK	REVISED -	DEPARTMENT OF TRANSPORTATION	GLENCOE, ILLINOIS			CONTRACT	T NO. 61H69
Default	PLOT DATE = 3/17/2022	DATE	3/17/2022	REVISED -		SCALE: N.T.S. SHEET 4 OF SHEETS STA. TO STA.		ILLINOIS FED. AI	D PROJECT	


SOIL CONDITIONS	DESIGN DEPTH "D" OF FOUNDATION				
SOFT CLAY Ou = 0.375 TON/SO. FT.	6′-0′′				
MEDIUM CLAY Qu = 0.75 TON/SQ.FT	6′-0′′				
STIFF CLAY Qu = 1.50 TON/SQ. FT.	6'-0''				
LOOSE SAND Ø = 34°	6'-0''				
MEDIUM SAND Ø = 37.5°	6'-0''				
DENSE SAND Ø = 40°	6′-0′′				

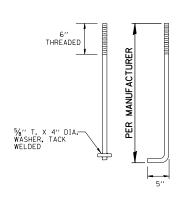


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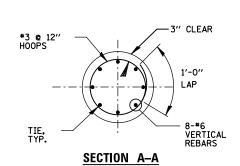


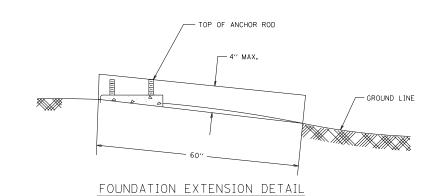ANCHOR BOLT DETAIL



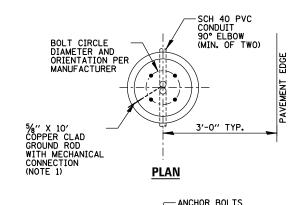

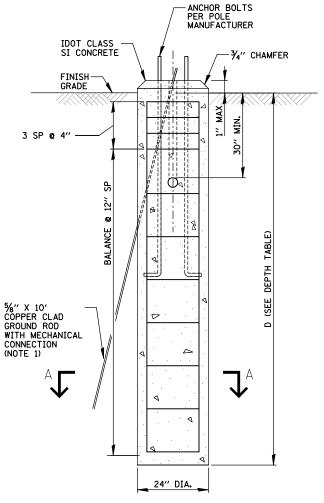FOUNDATION DETAIL



NOTES

- 1. THE ANCHOR RODS AND RACEWAYS SHALL BE PROPERLY SECURED IN PLACE BEFORE THE CONCRETE IN PLACED.
- THE FOUNDATION SHALL NOT PROTRUDE MORE THAN 4 IN. ABOVE THE FINISHED GRADE WITHIN A 60 IN. CHORD ACROSS THE FOUNDATION, WITH ANCHOR RODS INCLUDED, IN ACCORDANCE WITH AASHTO GUIDELINES. IF THE FOUNDATION HEIGHT, INCLUDING ANCHOR RODS, EXTENDS BEYOND THESE SPECIFIED LIMITS, THE FOUNDATION SHALL BE REPLACED AT THE CONTRACTOR'S EXPENSE. SEE FOUNDATION EXTENSION DETAIL.
- 3. THE HOLE FOR THE FOUNDATION SHALL BE MADE BY DRILLING WITH AN AUGER, OF THE SAME DIAMETER AS THE FOUNDATION. IF SOIL CONDITIONS REQUIRE THE USE OF A LINER TO FORM THE HOLE, THE LINER SHALL BE WITHDRAWN AS THE CONCRETE IS DEPOSITED.
- . THE TOP OF THE FOUNDATION SHALL BE CONSTRUCTED LEVEL. A LINER OR FORM SHALL BE USED TO PRODUCE A UNIFORM SMOOTH SIDE TO THE TOP OF THE FOUNDATION. FOUNDATION TOP SHALL BE CHAMFERED 3/4".
- 5. THE CONCRETE SHALL BE CLASS SI. CONCRETE SHALL CURE ACCORDING TO ARTICLE 1020.13 BEFORE LIGHT POLES ARE INSTALLED.
- 6. THE ANCHOR ROD SHALL BE A HOOK ROD TYPE, COLD BENDING OF THE ANCHOR ROD WILL NOT BE ALLOWED. THE RADIUS OF THE HOOK BEND SHALL NOT BE LESS THAN 4 TIMES THE NOMINAL DIAMETER OF THE ANCHOR ROD. A TACK WELDED ANCHOR ROD MAY BE SUBSTITUTED WITH THE APPROVAL OF THE ENGINEER.
- 7. THE ANCHOR RODS SHALL BE ACCORDING TO ASTM F1554 GRADE 725 (GRADE 105), NUTS SHALL BE HEXAGON NUTS ACCORDING TO ASTM A 194 2H OR ASTM A 563 DH, AND WASHERS SHALL BE ACCORDING TO ASTM F 436.
- 3. ANCHOR RODS, NUTS AND WASHERS SHALL BE COMPLETELY GALVANIZED BY EITHER THE HOT-DIPPED PROCESS CONFORMING WITH AASHTO M 232, THE MECHANICAL PLATING METHOD CONFORMING TO AASHTO M 298, CLASS 50 WITH A MAXIMUM COATING THICKNESS OF 150 UM(6 MILS) OR THE ELECTROLYTIC PROCESS ACCORDING TO ASTM F 1136.
- THE ANCHOR RODS SHALL BE THREADED A MINIMUM OF 6 INCHES WITH A MINIMUM OF 3 INCHES OF THREADED ANCHOR ROD EMBEDDED IN THE FOUNDATION.
- O. ANCHOR RODS SHALL PROJECT NO MORE THAN 2 3/4" ABOVE THE TOP OF THE FOUNDATION, IF BREAKAWAY COUPLINGS ARE SPECIFIED, THE CONTRACTOR SHALL CAREFULLY COORDINATE THE ANCHOR ROD PROJECTION WITH THE INSTALLATION REQUIREMENTS OF THE BREAKAWAY COUPLINGS.
- THE CONTRACTOR SHALL USE A "3 SPIRAL AT 6" PITCH OR MAY SUBSTITUTE "3 TIES AT 12" O.C. WITH THE APPROVAL OF THE ENGINEER.
- THE CABLE TRENCHES AND FOUNDATION SHALL BE BACK FILLED AND COMPACTED AS SPECIFIED BEFORE THE LIGHT POLE IS ERECTED.
- 13. THE RACEWAYS SHALL PROJECT 1" ABOVE THE TOP OF THE FOUNDATION.
- 14. GROUND ROD SHALL BE CAST INTO CONCRETE FOUNDATION WITH 8' IN CONTACT WITH SOIL.
- 15. FOUNDATIONS SHALL BE VIBRATED IN ACCORDANCE WITH IDOT STANDARD PRACTICES.
- 16. PAID FOR UNDER "LIGHT POLE FOUNDATION, 24" DIAMETER"



COUNTY

COOK

35 19

CONTRACT NO. 61H69

FILE NAME =	USER NAME = mmichalowicz	DESIGNED DRK	REVISED -	
\\tbg.net\CBBEL\CBBELDFT\Glencoe\210301\M	lech\05-LDT_210301.sht	DRAWN CPG	REVISED -	
	PLOT SCALE = 40'	CHECKED DRK	REVISED -	DEP#
Default Default	PLOT DATE = 3/17/2022	DATE 3/17/2022	REVISED -	

STATE OF ILLINOIS DEPARTMENT OF TRANSPORTATION

		ING DETAILS (3 OF 4)		<i>'</i>	MUN RTE.	SECTION				
GREEN BAY	TRAIL AND			SING IMPROVEMENTS		21-00065-00-BT				
	GLENCOE, ILLINOIS									
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BY					
	SURVEYED	- PLOTTED	ALIGNMENT CHECKED	RT. OF WAY CHECKED	CADD FILE NAME
:	L AN		NOTE BOOK		ġ
	ENGINEERING LTD.				
	CHRISTOPHER B. BURKE	0675 West Wagles Dood Suite 600	SOLO West Higgins Load, Julie 000	ROSEMONI, IIINOIS BUU 18	(847) 823-0500
DATE					
BY					
	VEYED	PLOTTED	DES CHECKED	B.M. NOTED	JCTURE NOTATINS CHIKD

SWITCH RATING (%)

COMMERCIAL & INDUSTRIAL LOAD INFORMATION
FORM TO BE COMPLETED BY QUALIFIED ELECTRICAL PROFESSIONAL

SITE & BUILDING INFORMATIO	N					
PROJECT NAME		PROJECT TYPE	EXISTING COMED ACCOUNT #			
Green Bay Trail and Hazel Aver	nue Crossing Improvements	Other	1119092153			
SITE ADDRESS		CITY	ZIP CODE			
274 Hazel Avenue		Glencoe	60022			
REQUESTED SERVICE		UNIT TYPE (IF APPLICABLE)				
Permanent	porary	Residential Com	nercial			
RESIDENTIAL # OF UNITS	TOTAL RESIDENTIAL SQ. FOOTAGE	COMMERCIAL # OF UNITS	TOTAL COMMERCIAL SQ. FOOTAGE			
-	-	-	-			
HOURS OF NORMAL OPERATION						
Start: AM	PM End:	☐ AM ☐ PM 2 4-hour				
EQUIPMENT AND VOLTAGE						
PREFERRED SERVICE EQUIPMENT TYPE						
✓ Underground	Overhead	☐ Vault/High-rise	Outdoor Lighting			
SERVICE VOLTAGE						
✓ 120/240V 1-phase 3-wire	120/240V 3-phase 4-wire	120/208V 3-phase 4-wire	277/480V 3-phase 4-wire			
\square 480V 3-phase 3-wire (B-phase g	rounded, not allowed in Chicago)	\square 480V 3-phase 3-wire (ungrounded, req. special equipment & approva				
4kV	\square 12kV	☐ 34kV	Other:			
SWITCH INFORMATION (if mor	e than one, please attach the fol	lowing information per switch)				
SWITCH NAME		# TOTAL SWITCHES FOR PROJECT	# SWITCHES IDENTICAL TO THIS APP			
Green Bay Trail and Hazel Aver	nue Crossing Lighting Controller	1	1			
SWITCH LOCATION, IF KNOWN		SWITCH SIZE (AMPS)	SIZE OF CONDUCTOR			
Meter Main Pedestal		60	#6 AWG			

CONDUCTOR MATERIAL

☑ CU ☐ AL

NUMBER OF SECONDARY SETS

COMMERCIAL & INDUSTRIAL LOAD INFORMATION

FORM TO BE COMPLETED BY QUALIFIED ELECTRICAL PROFESSIONAL

PROJECT NAME
Green Bay Trail and Hazel Avenue Crossin
SWITCH NAME
Green Bay Trail and Hazel Avenue Crossin

CATEGORY	DESCRIPTION	I-PHASE CONNECTED LOAD	I-PHASE DIVERSIFIED CAPACITY*	3-PHASE CONNECTED LOAD	3-PHASE DIVERSIFIED CAPACITY*
Lighting		249			
Appliances					
Receptacle		540			
Process Heat					
Water Heat					
Motors**					
HVAC/Heating					
HVAC/Cooling					
Ventilation-All Year					
Other					
Total		789			

*Diversify connected load per Chicago Electrical Code in the City of Chicago and applicable areas, diversify per National Electrical Code in all other areas.

COMMERCIAL & INDUSTRIAL PROJECT INFORMATION

SITE INFORMATION							
PROJECT NAME		CONTACT NAME					
Green Bay Trail and Hazel A	venue Crossing Improvements	Douglas Kerr	Douglas Kerr				
SITE ADDRESS		CITY	ZIP CODE				
274 Hazel Avenue		Glencoe	60022				
CONTACT EMAIL	CONTACT PHONE	TOTAL NUMBER OF SERVICE ENTRANCE LOCATIONS					
dkerr@cbbel.com	(847) 823-0500	1					
ELECTRICAL PERMIT#	DATE OF GROUNDBREAKING	TOTAL NUMBER OF SWITCHES (Points o	f Service)				
-	2/1/2022	1					
DATE COMED CAN BEGIN WORK	PREFERRED SERVICE DATE	TOTAL NUMBER OF METERS REQUESTED					
4/1/2022	4/1/2022	1					

BUSINESS INFORMAT	non-		
LEGAL NAME OF ENTITY (ELECTRIC CONSUMER) Village of Glencoe		TAX I.D.	EXISTING COMED ACCOUNT # 1119092153
☐ Corporation	Partnership	Sole Proprietor	✓ Other:

PRINCIPLE(S) to sign agreements for service	, easements, etc.
PROPERTY OWNER	PHONE
Village of Glencoe	(847) 835-4111
BUILDING OWNER	PHONE
James Tigue, Village Engineer	(847) 461-1119
BUILDING MANAGER	PHONE
James Tigue, Village Engineer	(847) 461-1119


For all questions in regards to proposed Com Ed utility coordination, please contact:

> COMMONWEALTH EDISON Larry Shank 1500 Franklin Boulevard LibertyvIIIe, IL 60048 (847) 921-7629 larry.shank@ComEd.com

ELECTRICAL SERVICE APPLICATION FOR INFORMATIONAL PURPOSES ONLY

	FILE NAME =	USER NAME = mmichalowicz	DESIGNED	DRK	REVISED -		LIGHTING DETAILS (4 OF 4)	MUN RTF	SECTION	COUNTY	TOTAL SHEET
	\\tbg.net\CBBEL\CBBELDFT\Glencoe\210301\f	lech\06-LDT_210301.sht	DRAWN	CPG	REVISED -	STATE OF ILLINOIS	GREEN BAY TRAIL AND HAZEL AVENUE CROSSING IMPROVEMENTS	11.12	21-00065-00-BT	СООК	35 20
	Default	PLOT SCALE = 40'	CHECKED	DRK	REVISED -	DEPARTMENT OF TRANSPORTATION	GLENCOE, ILLINOIS			CONTRACT	T NO. 61H69
Default		PLOT DATE = 3/17/2022	DATE	3/17/2022	REVISED -		SCALE: N.T.S. SHEET 6 OF SHEETS STA. TO STA.		ILLINOIS FED. AII	D PROJECT	

 $^{**}Please\ provide\ mechanical\ switch board\ schedule.$

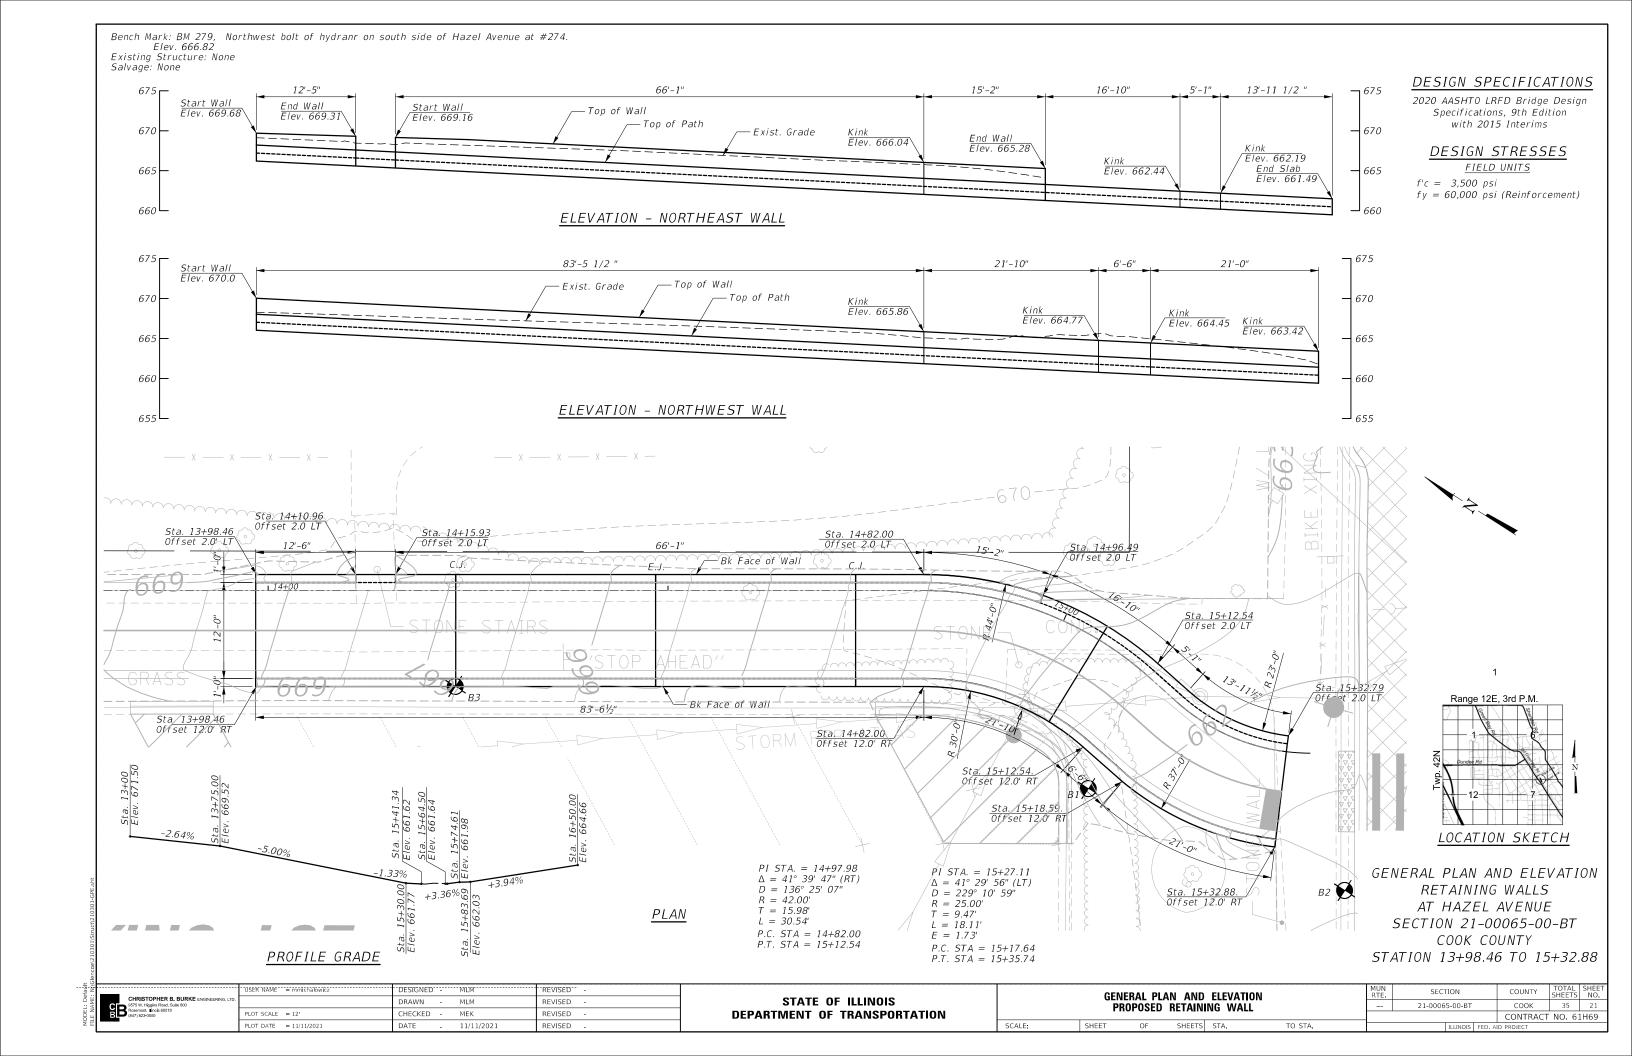

GENERAL NOTES

<u>CAST-IN-PLACE CONCRETE</u>

 All exposed concrete edges shall have a ³/₄" x 45º chamfer, except where shown otherwise. Chamfer on vertical edges shall be continued a minimum of one foot below finished ground level.

REINFORCEMENT BARS


- 2. Reinforcement bars, including epoxy-coated reinforcement bars, shall conform to the requirements of aashto m-31 (astm a706), grade 60, deformed bars.
- 3. Reinforcement bars designated "(e)" shall be epoxy coated.
- Reinforcement bar bending details shall be in accordance with the latest "M anual of Standard Practice for Detailing Reinforced Concrete Structures", ACI 315.
- 5. Reinforcement bar bending dimensions are out to out.
- 6. Bars noted thus, 3x2-#5 indicates 3 lines of bars with 2 lengths of bars per line.
- 7. Cover from the face of concrete to face of reinforcement bars shall be 3" for surfaces formed against earth and 2" for all other surfaces unless otherwise shown.

CONSTRUCTION

- Contractor shall not scale dimensions from the contract plans for construction purposes. Scales shown are for information only.
- 9. No construction joints except those shown on the plans shall be allowed unless approved by the engineer.
- 10. No concrete cutting shall be permitted until the cutting limits have been outlined by the contractor and approved by the engineer.
- 11. It shall be the Contractor's responsibility to verify the location of all utilities prior to starting construction. contact J.U.L.I.E., 800-892-0123.
- 12. Temporary soil retention systems, sheeting, bracing or cofferdams shall be constructed at the locations shown on the plans and/or as required for the excavation to protect the adjacent areas from settling or falling into the excavated areas.
- 13. The soil boring logs represent point information. Presentation of this information in no way implies that subsurface conditions are the same at locations other than the exact location of the boring.
- 14. Whenever any material is deposited into a drainage system or drainage structures, the deposited material shall be removed at the close of each working day. At the conclusion of construction operations, all drainage systems and structures shall be free from dirt and debris deposited during the various construction operations.

INDEX OF STRUCTURAL SHEETS

SHEET NO	<u>TITLE</u>
S-1	GENERAL PLAN & ELEVATION
5-2	GENERAL NOTES, INDEX & BOM
S-3	PLAN AND ELEVATION DETAILS
5-4	SECTION AND DETAILS
S-5	BICYCLE RAILING DETAILS
S-6	BORING LOGS

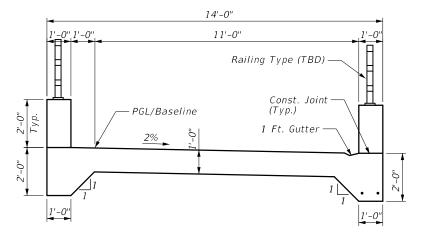

TYPICAL SECTION


TOTAL BILL OF MATERIAL


PAY ITEM NO.	ITEM	UNIT	TOTAL	RECORD QUANTITY
50200100	Structure Excavation	Cu. Yd.	155	
50800205	Reinforcement Bars, Epoxy Coated	Pound	12,965	
50300225	Concrete Structures	Cu. Yd.	105.0	
50901750	Parapet Railing	Foot	225	
50901760	Pipe Handrail	Foot	44	

CHRISTOPHER B. BURKE ENGINEERING 8575 W. Higgins Road, Suite 600 Rosemont, Litrois 60018 (847) 823-9500


Ī	USER NAME = mmichalowicz	DESIGNED -	MLM	REVISED -	
		DRAWN -	MLM	REVISED -	
	PLOT SCALE = 2'	CHECKED -	MEK	REVISED -	
	PLOT DATE = 11/11/2021	DATE -	11/11/2021	REVISED -	

						MUN RTE.	SEC ⁻	TION	COUNTY	TOTAL SHEETS	SHEET NO.
GENERAL NOTES							21-00065-00-BT		соок	35	22
									CONTRACT	NO. 6	1H69
SCALE:	SHEET	OF	SHEETS	STA.	TO STA.	ILLINOIS FED. AID PROJECT					

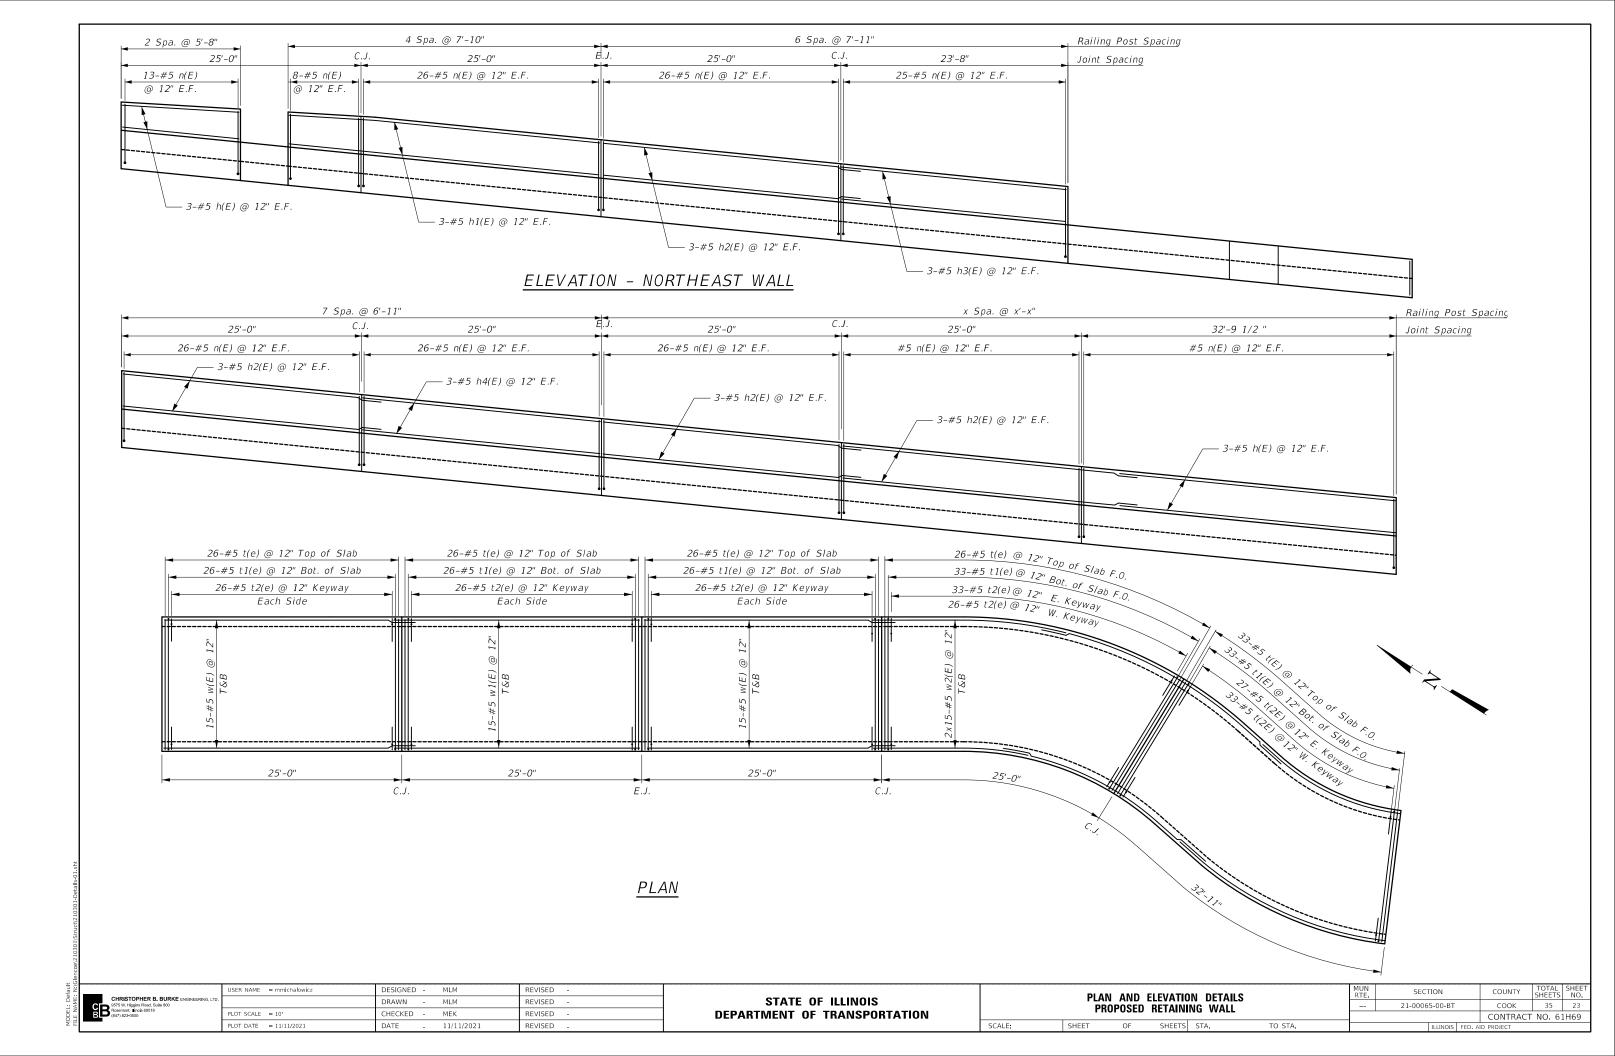

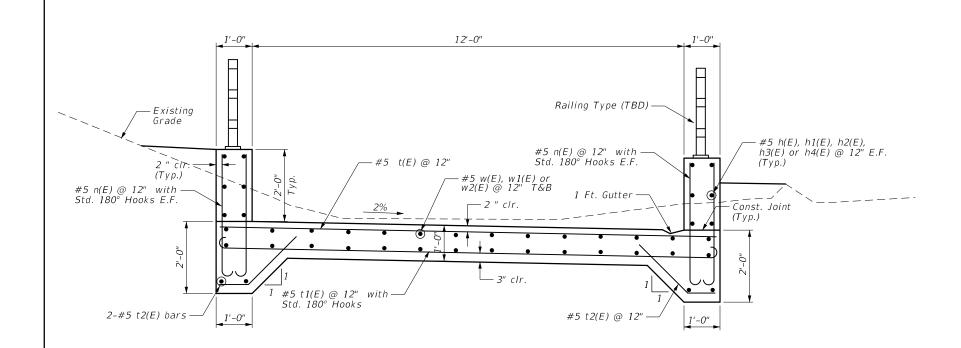


TYPICAL SECTION

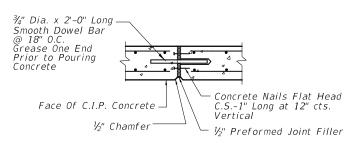


EXPANSION JOINT DETAILS


Max. Spacing = 90'-0"

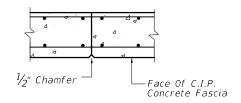

CONTROL JOINT DETAILS

Max. Spacing = 30'-0"
(Contractor shall Coordinate Control Joint with Architectural Form Liner)

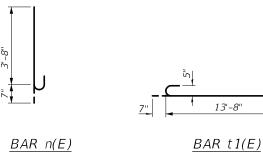

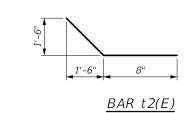

SUPERSTRUCTURE BILL OF MATERIAL

		01 1	7717 2 711	<u> </u>
Bar	No.	Size	Length	Shape
n(E)	468	#5	4'-3"	
h(E)	6	#5	12'-1"	
h1(E)	6	#5	<i>32'-3"</i>	
h2(E)	24	#5	28'-5"	
h3(E)	6	#5	23'-6"	
h4(E)	6	#5	24'-10"	
h5(E)	6	#5	32'-7"	
t(E)	144	#5	13'-8"	
t1(E)	144	#5	14'-10"	
t2(E)	275	#5	2'-1"	\
w(E)	60	#5	21'-3"	
w1(E)	30	#5	24'-10"	
w2(E)	60	#5	31'-5"	
Reinfo	rcemen	t Bars,	Lbs.	12,520
Ероху	Coated	1	LUS.	12,320
Concre	ete		Cu. Yds.	101.3
Struct	ure		cu. Tus.	101.5
Parc in	dicated	thuc 1	v 2 #1 c	etc indica

Bars indicated thus 1×2 -#4 etc. indicates 1 line of bars with 2 lengths per line.

847) 823-0500

DESIGNED - MLM	REVISED
DRAWN - MLM	REVISED
CHECKED - MEK	REVISED
DATE - 11/11/2021	REVISED
-	DRAWN - MLM CHECKED - MEK


STATE OF ILLINOIS
DEPARTMENT OF TRANSPORTATION

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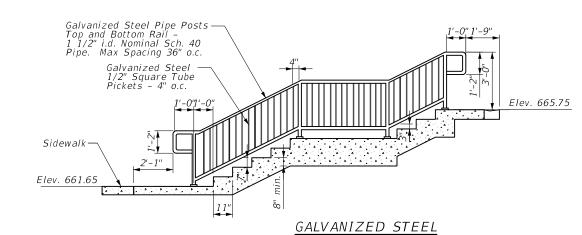
TO STA.

SCALE:

MUN RTE.	SECTION		COUNTY	TOTAL SHEETS	SHEET NO.
	21-00065-00-B	Г	соок	35	24
			CONTRACT	NO. 6	1H69
	ILLINOIS	FED. A	ID PROJECT		

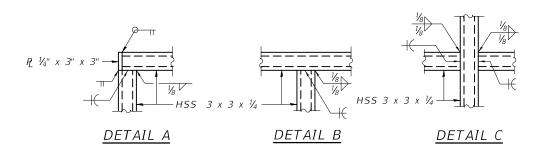

All steel rail elements shall be galvanized according to Article 509.05 of the Standard Specifications.




CENTER STAIR RAILING

 $-HSS 3 \times 3 \times \frac{1}{4}$


-1" x 1½" Slotted Holes

#4 REBAR-TRANSVERSE #5 REBAR-LONGITUDINAL @ 9" O.C.

STAIR SECTION

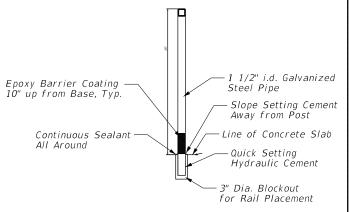


METAL RAIL TYPICAL SECTION AT STAIR

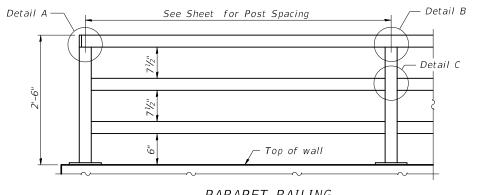


PARAPET RAILING ELEVATION

(Inside Face of Three Element Rail)

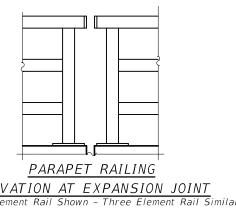

ELEVATION AT EXPANSION JOINT (Two Element Rail Shown - Three Element Rail Similar)

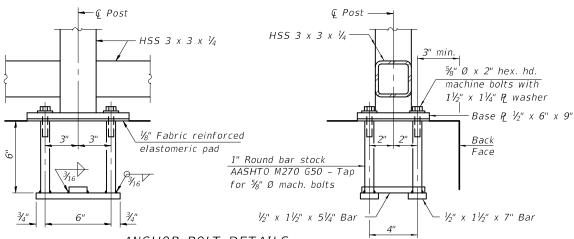


SCALE:

SHEET

BASE R

ANCHOR BOLT DETAILS

In lieu of the cast-in-place anchor device shown, the Contractor has the option of drilling and setting 5%" Ø anchor rods according to Article 509.06 of the Standard Specifications. Embedment shall be according to the manufacturer's specifications.

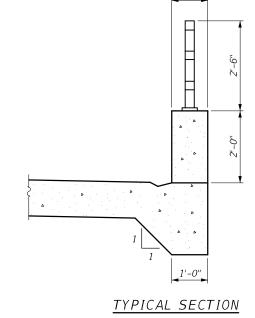

BILL	0F	MATERIAL

Item	Unit	Quantity
Parapet Railing	Foot	225
Pipe Handrail	Foot	44

-HSS 3 x 3 x 1/4 P_ %" x 1%" x 9" 1/4" rail splice Top & Bottom PL 3/8" x 17/8" x 9' Each side <u>Ç</u> ¾" Selftapping screws RAIL SPLICE

Notes:


All structural steel tubing, post and railing, for parapet railing shall be CVN tested according to 1006.34(b) of the Standard Specifications. CVN testing may be omitted for the Bicycle Railing.


CHRISTOPHER B. BURKE ENGINEERING, LTD. 5675W. Higgers Road, State 800 CRAWN - MLM REVISED - CRAWN - MLM REVISED	
Rosemont Utinois 60018	
PLOT SCALE = 2 CHECKED - MEK REVISED -	
PLOT DATE = 11/11/2021 DATE - 11/11/2021 REVISED -	

STATE OF ILLINOIS **DEPARTMENT OF TRANSPORTATION**

BICYCLE PATH RAILING					SECT	ΠΟN		COUNTY	TOTAL SHEETS	SHEET NO.
AND STAIR DETAILS				21-00065-00-BT			СООК	35	25	
								CONTRACT	NO. 63	1H69
OF	SHEETS	STA.	TO STA.			ILLINOIS	FED. A	ID PROJECT		

	CLIENT							ıg, Ltd.		ton, IL
	BORING	1			DATI	E STAR	ΓED	9-7-2	1	DATE COMPLETED 9-7-21 JOB L-93,071
	GROUND	SURF	_	668	ATION: 5.5		_			WATER LEVEL OBSERVATIONS ▼ WHILE DRILLING Dry
	END OF BO	ORIN	G _	650).5					 ✓ AT END OF BORING Dry ▼ 24 HOURS
0-	LENGTH	_	IPLE TYPE	N	wc	Qu	γ _{DRY}	DEPTH	ELEV.	SOIL DESCRIPTIONS
-	₫₽			B				0.6 1.0	664.9 664.5	7" Bituminous Concrete 5" Crushed Stone FILL - Brown trace to little black silty CLAY,
-		1	SS	10	11.6	1.0*	128	3.0	662.5	little to some sand and gravel with Crushed Stone, trace organic, moist (CL)
5—		2	SS	18	17.1	4.13 4.5*				Hard brown silty CLAY, little sand, trace gravel,
-		3	SS	16	17.2	4.5+*				moist (CL)
-		4	SS	18	13.0	2.5*		8.0	657.5	Very stiff brownish-gray silty CLAY, little sand, occasional silt and sand seams, moist (CL)
10— - - - - 15—		5	SS	19	17.5	4.26 3.75*		10.5	655.0	Hard to very stiff brownish-gray silty CLAY, little sand, trace gravel, moist (CL)
- 15 —		6	SS	16	16.8	3.5*				
-										End of Boring at 15.0' * Approximate unconfined compressive strength based on measurements with a calibrated pocket penetrometer.
20-										
25-	. RIG NO.	200			approxi	mate bou	ndaries b	oosits repre etween soi be gradual.	types;	

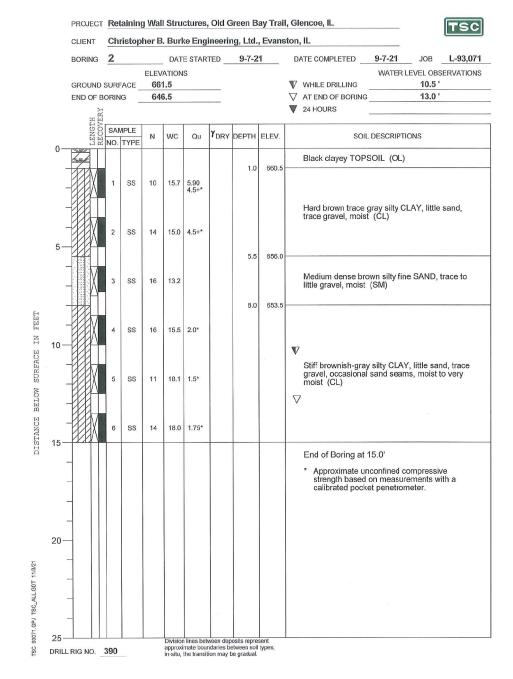

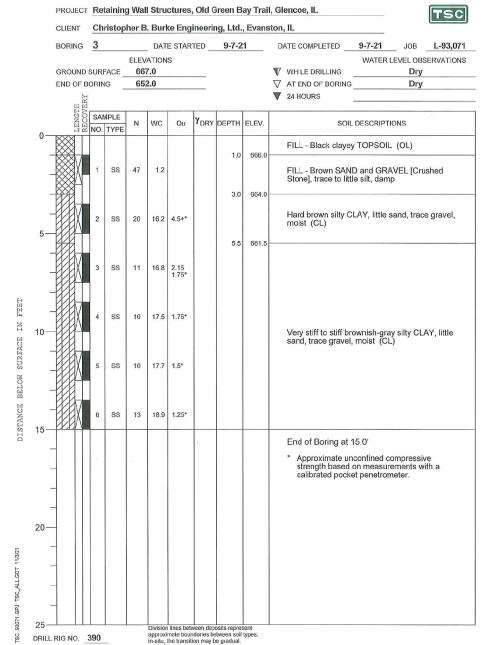

CHRISTOPHER B. BURKE ENGINEERIN
875 W. Higgins Road, Suite 600
Rosemont, Ilinois 60018
(847) 823-0500

STATE OF ILLINOIS
DEPARTMENT OF TRANSPORTATION

SHEET


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 SECTION
 COUNTY SHEETS
 SHEETS NO.

 - 21-00065-00-BT
 COOK
 35
 26


 CONTRACT NO. 61H69


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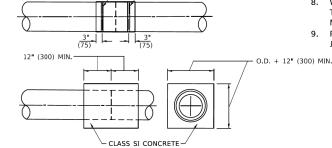


DETAIL "A"

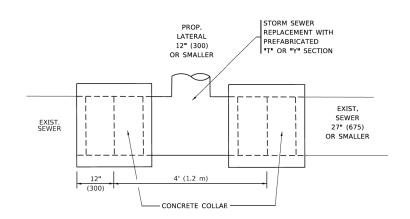LATERAL CONNECTION TO EXISTING SEWER
OF 27" (675) OR SMALLER



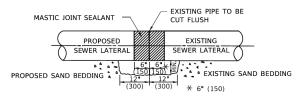

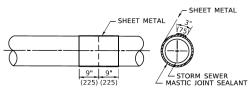


METAL BINDING

DETAIL "B"CLASS SI CONCRETE COLLAR

CONSTRUCTION SEQUENCE

- CUT THE EXISTING END OF THE PIPE SO AS TO PRESENT A FLUSH BUTT JOINT. BRUSH AND CLEAN ALL PIPES.
- 2. APPLY THE MASTIC JOINT SEALANT TO THE FIRST 6" (150) OF EACH PIPE.
- 3. BUTT THE PIPES TOGETHER LEAVING A MINIMUM OF 12' x 6' (300 x 150) DEEP EXCAVATION UNDER AND AROUND EACH PIPE END
- CUT A PIECE OF SHEET METAL GAGE NO. 19 1.1 (0.0418) 18" (450) WIDE BY THE OUTSIDE CIRCUMFERANCE OF THE PIPE PLUS 3" (75) LONG.
- WRAP THE SHEET METAL AROUND THE PIPES, 9" (225) ON EACH SIDE OF THE JOINT, STARTING AT THE TOP OF THE PIPE.
- LAP THE SHEET METAL AT LEAST 3" (75)
 AT THE TOP OF THE PIPE AND PLACE THE
 MASTIC JOINT SEALANT BETWEEN THE LAP.
- 7. PLACE TWO METAL BANDS AROUND THE SHEET METAL AND TIGHTEN.
- 8. WIPE OFF ANY EXCESS MASTIC JOINT SEALANT THAT OOZES OUT FROM BETWEEN THE SHEET METAL AND THE PIPES.
- 9. PLACE CLASS SI CONCRETE AROUND THE IOINT.

* ALL DIMENSIONS ARE IN INCHES (MILLIMETERS) UNLESS OTHERWISE SHOWN.

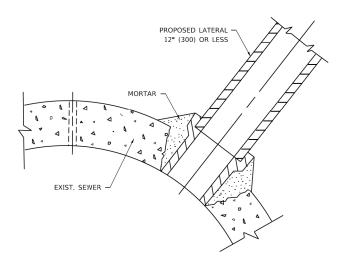

DETAIL "C"

PROPOSED LATERAL
CONNECTION TO EXISTING SEWER
OF 30" (750) OR LARGER

NOTES:

MATERIAL

MATERIAL USED FOR THE TEE OR WYE SECTION SHALL BE COMPATIBLE WITH THE EXISTING STORM SEWER OR THE PROPOSED STORM SEWER.

CONSTRUCTION METHODS

- I. THIS WORK SHALL BE CONSTRUCTED IN CONFORMANCE WITH THE APPLICABLE PORTIONS OF SECTION 550 OF THE STANDARD SPECIFICATIONS.
- II. CONNECTION TO AN EXISTING STORM SEWER SHALL BE BY EITHER OF THE FOLLOWING METHODS:

 A) PROPOSED STORM SEWER CONNECTION TO EXISTING SEWER OF 27" (675) OR SMALLER SEE

 DETAIL "A" AND "B".
 - B) PROPOSED STORM SEWER CONNECTION TO EXISTING SEWER OF 30" (750) OR LARGER SEE DETAIL "C"

IF THE EXISTING SEWER PIPE IS CRACKED, BROKEN OR OTHERWISE DAMAGED BY THE CONTRACTOR IN MAKING THE CIRCULAR OPENING, THE CONTRACTOR SHALL REPLACE THAT SECTION OF PIPE WITH PIPE EQUAL AND SIMILAR IN ALL RESPECTS TO THE PIPE IN THE EXISTING SEWER, IN A CAREFUL WORKMANLIKE MANNER, WITHOUT EXTRA COMPENSATION.

GENERAL

CARE MUST BE TAKEN TO PREVENT DEBRIS FROM ENTERING THE SEWER.
ALL DEBRIS WHICH ENTERS THE SEWER MUST BE REMOVED. THE SEWER MUST
BE LEFT CLEAN AND UNOBSTRUCTED UPON COMPLETION OF THE CONTRACT.

CARE MUST BE TAKEN TO PREVENT ANY PART OF THE NEW PIPE CONNECTION FROM PROJECTING INTO THE EXISTING SEWER.

BASIS OF PAYMENT

TEE OR WYE CONNECTIONS SHALL BE PAID FOR AT THE CONTRACT UNIT PRICE EACH FOR STORM SEWER TEE OR WYE OF THE TYPE AND SIZE SPECIFIED IN THE PLANS, THIS PRICE SHALL INCLUDE ALL EXCAVATION OF THE TRENCH, REMOVAL OF THE EXISTING STORM SEWER, FURNISHING AND INSTALLING THE SPECIFIED TEE OR WYE SECTION, FURNISHING AND INSTALLING THE REQUIRED CONCRETE COLLAR, AND ALL OTHER MATERIAL NECESSARY TO COMPLETE THIS WORK AS SHOWN AND SPECIFIED.

REMOVAL AND REINSTALLATION OF EXISTING STORM SEWER ADJACENT TO THE PROPOSED TEE OR WYE SECTION, FOR THE PURPOSE OF FACILITATING THE INSTALLATION OF THE TEE OR WYE SECTION, WILL NOT BE PAID FOR SEPARATELY BUT SHALL BE INCLUDED IN THE UNIT PRICE BID FOR THE WORK.

TRENCH BACKFILL, EXCAVATION IN ROCK AND REMOVAL AND REPLACEMENT OF UNSUITABLE MATERIAL BELOW PLAN BEDDING GRADE WILL BE PAID FOR SEPARATELY.

CONCRETE COLLAR FOR CONNECTING A PROPOSED STORM SEWER TO AN EXISTING STORM SEWER WILL NOT BE PAID PAID FOR SEPARATELY BUT SHALL BE INCLUDED IN THE COST OF THE PROPOSED STORM SEWER

 USER NAME
 — footemj
 DESIGNED
 — M. DE YONG
 REVISED
 — M. DE YONG 5.8-92

 DRAWN
 — REVISED
 — R. SHAH 09-09-94


 PLOT SCALE
 = 50,0000 ' / in.
 CHECKED
 — REVISED
 — R. SHAH 10-25-94

 PLOT DATE
 = 3/27/2019
 DATE
 — 07-25-90
 REVISED
 — R. SHAH 06-12-96

STATE OF ILLINOIS
DEPARTMENT OF TRANSPORTATION

DETAIL OF STORM SEWER
CONNECTION TO EXISTING SEWER

NE SHEET 1 OF 1 SHEETS STA.

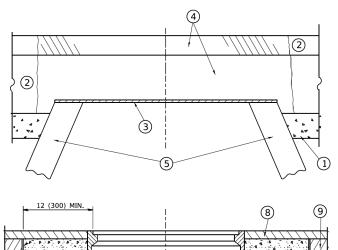

12 (300) MIN. (3) (6) (7) (7) PROPOSED BRICK, MORTAR, OR CONC. ADJUSTING RINGS

NOTES

EXISTING BROKEN FRAMES AND LIDS SHALL BE REMOVED AND DISPOSED OF BY THE CONTRACTOR AND SHALL BE REPLACED AS DIRECTED BY THE ENGINEER. REPLACEMENT FRAMES AND LIDS WILL BE PAID FOR IN ACCORDANCE WITH ARTICLE 109.04 OF THE STANDARD SPECIFICATIONS UNLESS A SEPARATE PAY ITEM HAS BEEN PROVIDED.

IF THE EXISTING LIDS ARE OPEN, THE FRAME WILL BE ADJUSTED TO THE ELEVATION OF THE MILLED PAVEMENT SURFACE PRIOR TO THE MILLING OPERATION. THE FRAME WILL NOT BE REMOVED AND COVERED BY THE METAL PLATE.

CITY OF CHICAGO CASTINGS ARE THE PROPERTY OF THE CITY AND THE CONTRACTOR SHALL NOTIFY THE CITY FOR REMOVAL AND DISPOSITION OF THE CASTINGS.

THE METAL PLATE USED TO COVER THE STRUCTURE SHALL REMAIN THE PROPERTY OF THE CONTRACTOR.

WHEN STRUCTURES ARE TO BE ADJUSTED OR RECONSTRUCTED, THE LOWERING AND RAISING OF THE FRAMES AND LIDS WILL NOT BE PAID FOR SEPARATELY BUT WILL BE INCLUDED IN THE COST OF THE CORRESPONDING PAY ITEM.

CONSTRUCTION PROCEDURES

STAGE 1 (BEFORE PAVEMENT MILLING)

- A) REMOVE A MINIMUM OF 12 (300) OF THE PAVEMENT FROM AROUND THE STRUCTURE.
- B) REMOVE THE EXISTING FRAME AND LID FROM THE STRUCTURE.
- C) COVER THE STRUCTURE OPENING WITH A 36 (900) DIAMETER
- D) BACKFILL WITH CRUSHED STONE AND A MINIMUM 1½ (40)
 THICK HMA SURFACE MIX APPROVED BY THE ENGINEER.

STAGE 2 (AFTER PAVEMENT MILLING)

- A) REMOVE THE HMA SURFACE MIX AND CRUSHED STONE.
- B) INSTALL THE FRAME AND LID; ADJUST THE FRAME TO ITS FINAL SURFACE ELEVATION.
- C) THE SURROUNDING SPACE SHALL BE FILLED WITH CLASS PP-1 *
 CONCRETE TO THE ELEVATION OF THE SURFACE OF THE EXISTING
 BASE COURSE OR THE BINDER COURSE.
- * UNLESS OTHERWISE SPECIFIED IN THE PLANS.

THE PROCEDURE EXPLAINED ABOVE SHALL CONFORM TO THE APPLICABLE PORTIONS OF SECTIONS 353, 406, 602, AND 603 OF THE STANDARD SPECIFICATIONS EXCEPT THAT "THE CONTRACTOR SHALL ADJUST THE STRUCTURES TO THE FINISHED PAVEMENT ELEVATION NO MORE THAN 5 CALENDAR DAYS PRIOR TO PLACEMENT OF THE FINAL LIFT OF SURFACE UNLESS APPROVED BY THE ENGINEER."

LEGEND

- 1 SUB-BASE GRANULAR MATERIAL
- 6 FRAME AND LID (SEE NOTES)
- 2 EXISTING PAVEMENT
- 7) CLASS PP-1 *CONCRETE
- 3 36 (900) DIAMETER METAL PLATE
- 8 PROPOSED HMA SURFACE COURSE
- PROPOSED CRUSHED STONE AND HMA SURFACE MIX

 (5) EXISTING STRUCTURE
- (9) PROPOSED HMA BINDER COURSE

LOCATION OF STRUCTURES

THE CONTRACTOR WILL BE REQUIRED TO KEEP A RECORD OF THE LOCATIONS OF THE BURIED STRUCTURES ACCORDING TO THE STATION AND DISTANCE LEFT OR RIGHT OF THE CENTERLINE OF PAVEMENT. UPON COMPLETION OF THE WORK, THE CONTRACTOR WILL DELIVER THE RECORD TO THE ENGINEER.

BASIS OF PAYMENT

REMOVING FRAMES AND LIDS ON DRAINAGE AND UTILITY STRUCTURES IN THE PAVEMENT PRIOR TO MILLING, AND ADJUSTING TO FINAL GRADE PRIOR TO PLACING THE SURFACE COURSE, WILL BE PAID FOR AT THE CONTRACT UNIT PRICE EACH FOR "FRAMES AND LIDS TO BE ADJUSTED (SPECIAL)."

THIS WORK WILL NOT BE PAID FOR WHEN DRAINAGE AND UTILITY STRUCTURES ARE SPECIFIED FOR PAYMENT AS STRUCTURE RECONSTRUCTION.

NEW FRAMES AND LIDS, WHEN SPECIFIED, WILL BE PAID FOR SEPARATELY.

DETAILS FOR FRAMES AND LIDS ADJUSTMENT WITH MILLING

ALL DIMENSIONS ARE IN INCHES (MILLIMETERS) UNLESS OTHERWISE SHOWN


STATE OF ILLINOIS
DEPARTMENT OF TRANSPORTATION

FRAMES AND LIDS ADJUSTMENT WITH MILLING

ALE: NONE SHEET 1 OF 1 SHEETS STA. TO STA.

F.A. SECTION COUNTY TOTAL SHEETS NO. 21-00065-00-BT COOK 35 28

BD600-03 (BD-8) CONTRACT NO. 61H69

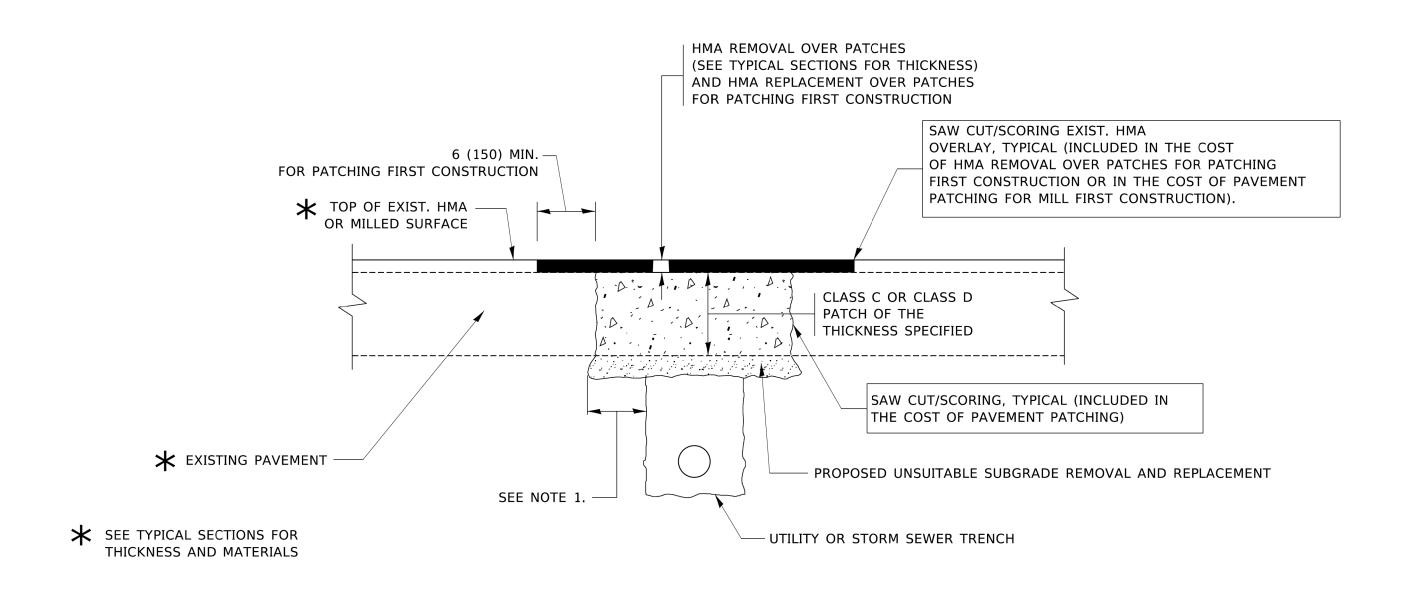

NOTES:

- 1. THE WIDTH OF THE FULL DEPTH PATCH OVER A TRENCH SHALL BE 12 (300) WIDER ON EACH SIDE OF THE TRENCH.
- 2. FOR METHOD OF MEASUREMENT AND BASIS OF PAYMENT, SEE RECURRING SPECIAL PROVISION "PATCHING WITH HOT-MIX ASPHALT OVERLAY REMOVAL".

SEQUENCE OF CONSTRUCTION (PATCHING FIRST)

- 1. REMOVE THE EXISTING HMA MATERIAL OVER THE AREA TO BE PATCHED.
- 2. REMOVE AND REPLACE WITH CLASS C OR D PATCH.
- 3. REPLACE HMA MATERIAL OVER THE AREA TO BE PATCHED.

SEQUENCE OF CONSTRUCTION (MILLING FIRST)

- 1. MILL HMA FIRST IF THERE IS AT LEAST $4\frac{1}{2}$ INCHES OR MORE OF HMA MATERIAL ON TOP OF THE EXISTING PAVEMENT OR IF THE PAVEMENT IS FULL DEPTH HMA. A MINIMUM OF 2 INCHES OF HMA MATERIAL SHALL BE IN PLACE AFTER MILLING.
- 2. REMOVE AND REPLACE WITH FULL DEPTH CLASS D PATCHES TO TOP OF MILLED SURFACE.

ALL DIMENSIONS ARE IN INCHES (MILLIMETERS) UNLESS OTHERWISE SHOWN.


COOK 35 29

CONTRACT NO. 61H69

USER NAME - footemj	DESIGNED - R, SHAH	REVISED - A. ABBAS 04-27-98
	DRAWN -	REVISED - R. BORO 01-01-07
PLOT SCALE = 50,0000 ' / in.	CHECKED -	REVISED - R. BORO 09-04-07
PLOT DATE = 3/27/2019	DATE - 10-25-94	REVISED - K. ENG 10-27-08

STATE OF ILLINOIS DEPARTMENT OF TRANSPORTATION

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		BD400-04 (BD-22)								
CALE: NONE	SHEET	1	OF	1	SHEETS	STA.	TO STA.		ILLINOIS	FED.

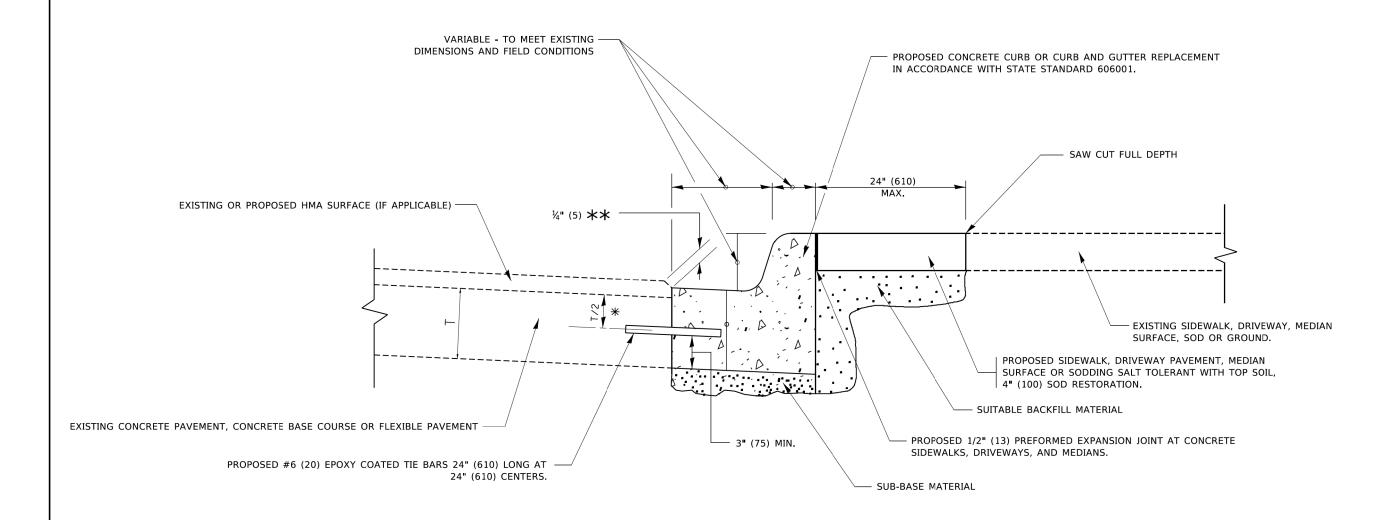

- igspace 3" (75) MINIMUM FROM TOP AND BOTTOM OF THE CONCRETE PAVEMENT OR BASE COURSE.
- ** IF THE FINAL SURFACE OF THE PAVEMENT IS CONCRETE, THE GUTTER IS TO BE FLUSH WITH THE PAVEMENT.

CURB OR CURB AND GUTTER REMOVAL AND REPLACEMENT


ALL DIMENSIONS ARE IN INCHES (MILLIMETERS) UNLESS OTHERWISE SHOWN.

USER NAME - footemj	DESIGNED - A, HOUSEH	REVISED - A. ABBAS 03-21-97	Т
	DRAWN -	REVISED - M. GOMEZ 01-22-03	П
PLOT SCALE = 50,0000 ' / in.	CHECKED -	REVISED - R. BORO 12-15-09	٦
PLOT DATE = 7/11/2019	DATE - 03-11-94	REVISED - K. SMITH 07-11-19	٦

STATE OF ILLINOIS
DEPARTMENT OF TRANSPORTATION

CURB OR CURB AND GUTTER
REMOVAL AND REPLACEMENT

ALE: NONE SHEET 1 OF 1 SHEETS STA.

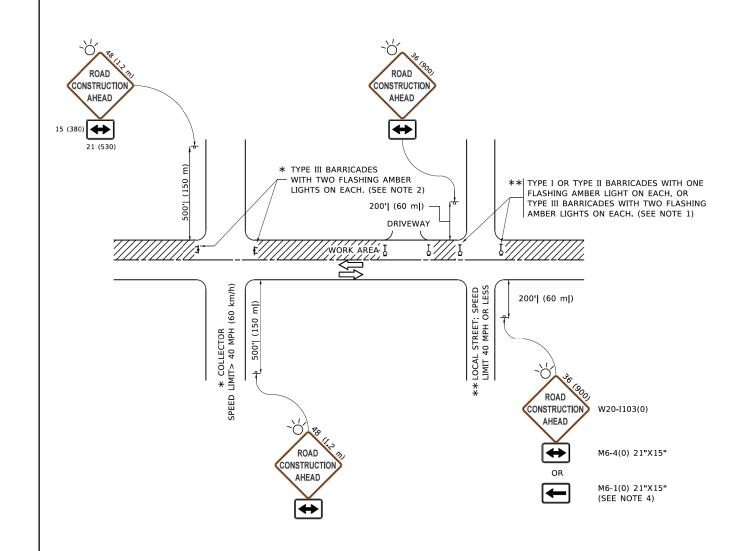

NOTES:

- 1. SIDE ROAD WITH A SPEED LIMIT OF 40 MPH (60 km/h) OR LESS AS SHOWN ON THE DRAWING AND AS DIRECTED BY THE ENGINEER:
- a) ONE "ROAD CONSTRUCTION AHEAD" SIGN 36 x 36 (900x900) WITH A FLASHER MOUNTED ON IT APPROXIMATELY 200' (60 m) IN ADVANCE OF THE MAIN ROUTE.
- b) THE CLOSED PORTION OF THE MAIN ROUTE SHALL BE PROTECTED BY BLOCKING WITH TYPE I, TYPE II OR TYPE III BARRICADES, 1/3 OF THE CROSS SECTION OF THE CLOSED PORTION.
- 2. SIDE ROAD WITH A SPEED LIMIT GREATER THAN 40 MPH (60 km/h) AS SHOWN ON THE DRAWING AND AS DIRECTED BY THE ENGINEER:
- a) ONE "ROAD CONSTRUCTION AHEAD" SIGN 48 x 48 (1.2 m x 1.2 m) WITH A FLASHER MOUNTED ON IT APPROXIMATELY 500' (150 m) IN ADVANCE OF THE MAIN ROUTE.
- THE CLOSED PORTION OF THE MAIN ROUTE SHALL BE PROTECTED BY
 b) BLOCKING WITH TYPE III BARRICADES, 1/2 OF THE CROSS SECTION
 OF THE CLOSED PORTION.
- CONES MAY BE SUBSTITUTED FOR BARRICADES OR DRUMS AT HALF THE SPACING DURING DAY OPERATIONS. CONES SHALL BE A MINIMUM OF 28 (710) IN HEIGHT.
- WHEN THE SIDE ROAD LIES BETWEEN THE BEGINNING OF THE MAINLINE
 4. SIGNING AND THE WORK ZONE, A SINGLE HEADED ARROW (M6-1) SHALL
 BE USED IN LIEU OF THE DOUBLE HEADED ARROW (M6-4).

- 5. WHEN WORK IS BEING PERFORMED ON A SIDE ROAD OR DRIVEWAY, FOLLOW THE APPLICABLE STANDARD(S). THE DIRECTIONAL ARROW (M6-1 OR M6-4) SHALL BE COVERED OR REMOVED WHEN NO LONGER CONSISTENT WITH THE TRAFFIC CONTROL SET-UP.
- ADVANCE WARNING SIGNS ARE TO BE OMITTED ON DRIVEWAYS UNLESS OTHERWISE SPECIFIED IN THE PLANS OR BY THE ENGINEER.
- THE TRAFFIC CONTROL AND PROTECTION FOR SIDE ROADS, INTERSECTIONS, AND DRIVEWAYS SHALL BE INCLUDED IN THE COST OF SPECIFIED TRAFFIC CONTROL STANDARDS OR ITEMS.

All dimensions are in inches (millimeters) unless otherwise shown.

 USER NAME
 - footemj
 DESIGNED
 - L.H.A.
 REVISED
 - A. HOUSEH 10-15-96

 DRAWN
 REVISED
 - T. RAMMACHER 01-06-00

 PLOT SCALE
 = 50.0000 ' / in.
 CHECKED
 REVISED
 - A. SCHUETZE 07-01-13

 PLOT DATE
 = 3/4/2019
 DATE
 06-89
 REVISED
 - A. SCHUETZE 09-15-16

STATE OF ILLINOIS
DEPARTMENT OF TRANSPORTATION

TRAFFIC CONTROL AND PROTECTION FOR SIDE ROADS, INTERSECTIONS, AND DRIVEWAYS

ALE: NONE SHEET 1 OF 1 SHEETS STA. TO STA.

