




	USER NAME = PEberhart	DESIGNED - YSE CHECKED - JMH	REVISED -	STATE OF ILLINOIS	PIER 3 DETAILS	F.A.I. RTE	SECTION (25-4-1, 25-5)R	COUNTY SHEETS
1928 SrA Bradley R. Smith Drive	PLOT SCALE=	DRAWN - PRE	REVISED -	DEPARTMENT OF TRANSPORTATION	STRUCTURE NO. 025-0064		(== : :, == =), :	CONTRACT NO. 7459
Troy, IL 62294 PHONE: 618.667.1400	PLOT DATE = 4/6/2022	CHECKED - REB	REVISED -		SHEET 6 OF 6 SHEETS		ILLINOIS FI	


## <u>NOTES</u>

- 1. Bars shall be drilled and grouted according to Section 584 of the Standard Specifications.
- 2. Concrete Sealer shall be applied only to exposed surface of the new concrete on Pier 3.
- 3. Bars indicated thus, 9 x 2-#5 bars indicates 9 lines of bars with 2 lengths per line.
- Field verify that proposed crashwall extension extends a minimum of 5'-0" above the proposed profile grade.

Bar	No.	Size	Length	Shape
d(E)	16	#5	3'-9"	
p(E)	18	#5	7'-9"	
s(E)	24	#5	6'-0"	
Concre	te Stru	ctures	Cu. Yd.	3.3
Concre	te Seal	'er	Sq. Ft.	94
	rcemen Coated	t Bars,	Pound	360

BILL OF MATERIAL

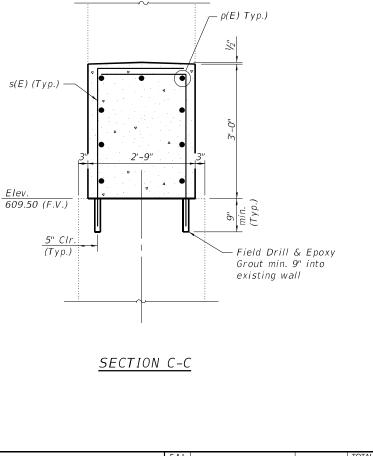

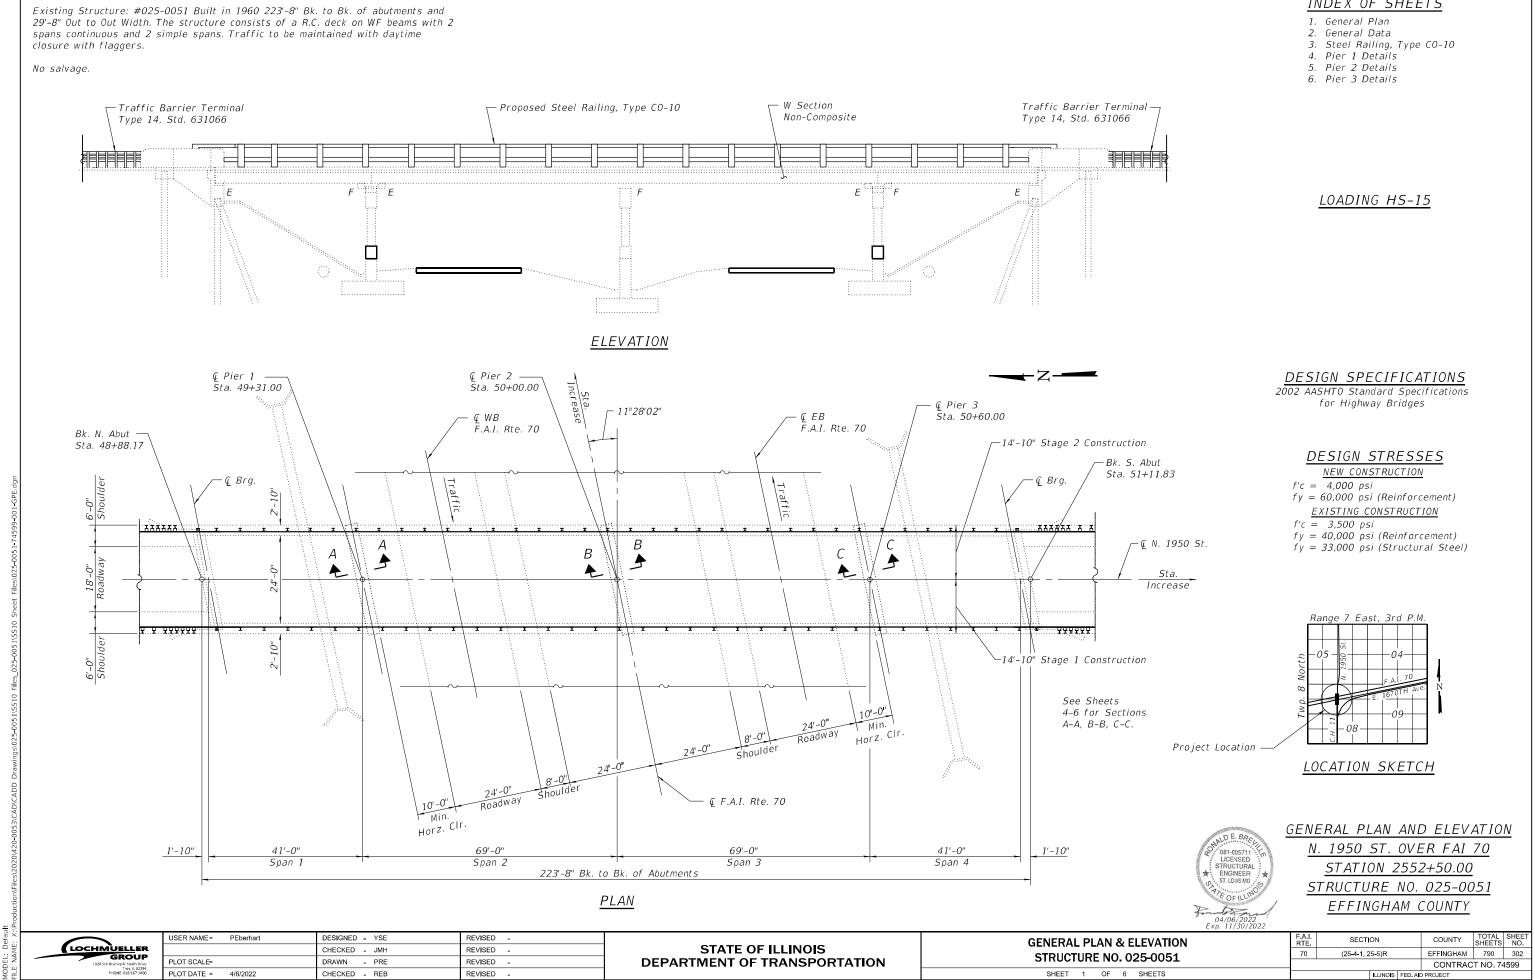

4/6/2022 11:21:57 AM

Bench Mark:

## INDEX OF SHEETS




### GENERAL NOTES

- 1. No field welding is permitted except as specified in the contract documents.
- 2. Reinforcement bars designated (E) shall be epoxy coated.
- 3. Plan dimensions and details relative to existing plans are subject to nominal construction variations. The Contractor shall field verify existing dimensions and details affecting new construction and make necessary approved adjustments prior to construction or ordering of materials. Such variations shall not be cause for additional compensation for a change in scope of the work, however, the Contractor will be paid for the quantity actually furnished at the unit price bid for the work.
- 4. Concrete Sealer shall be applied to the designated areas of the piers.
- 5. The existing structural steel coating contains lead. The Contractor shall take appropriate precautions to deal with the presence of lead on this project.
- 6. All elevations shown on plans are based on 1960 plans and therefore NGVD 29 Datum. Elevations shall be confirmed with survey.

## SCOPE OF WORK

- 1. Install Steel Railing Type CO-10.
- Construct crashwalls at piers. 2.
- 3. Patch concrete at piers.

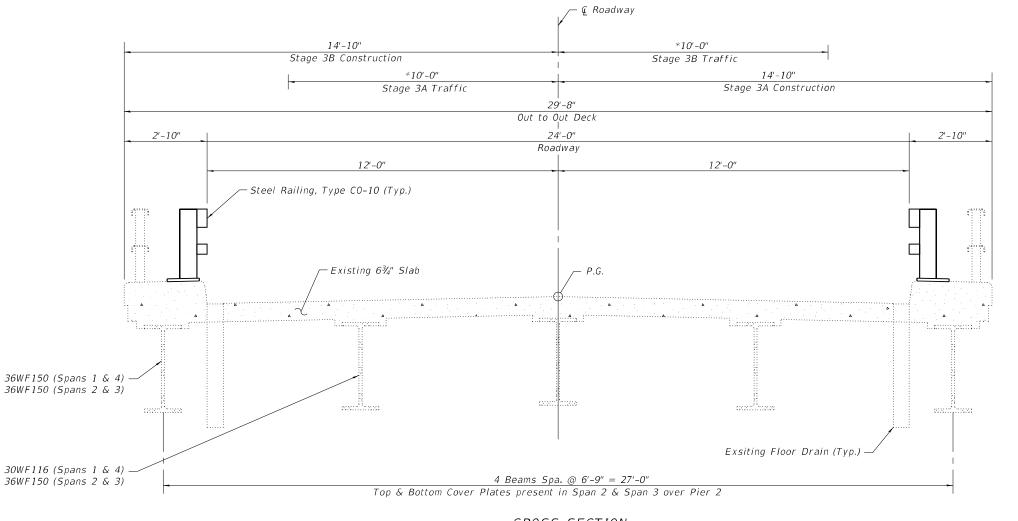

CROSS SECTION


(Looking South)

efau :: X:		USER NAME = PEberhart	DESIGNED - YSE	REVISED -		GENERAL DATA	F.A.I. SECTION	COUNTY TOTAL SHEET
C W C C C C C C C C C C C C C C C C C C		CHECKED - JMH	REVISED -	STATE OF ILLINOIS		70 (25-4-1, 25-5)R	EFFINGHAM 790 303	
	1928 SrA Bradley R. Smith Drive	PLOT SCALE=	DRAWN - PRE	REVISED -	DEPARTMENT OF TRANSPORTATION	STRUCTURE NO. 025-0051		CONTRACT NO. 74599
D MO	PHONE: 618.667.1400	PLOT DATE = 4/6/2022	CHECKED - REB	REVISED -		SHEET 2 OF 6 SHEETS	ILLINOIS FEE	AID PROJECT
4/6/	2022 11:21:59 AM	•	•	•			· · ·	

TOTAL BILL OF MATERIAL

ITEM	UNIT	SUPER	SUB	TOTAL
crete Structures	Cu. Yd.	-	11.1	11.1
crete Sealer	Sq. Ft.	-	315	315
nforcement Bars, Epoxy Coated	Pounds	-	1140	1140
el Railing, Type CO-10	Foot	433	-	433
uctural Repair of Concrete (Depth al to or Less Than 5 Inches)	Sq. Ft.	-	7	7

\*Lane Closure, 2L 2W, Day only for speeds  $\geq$  45 mph. Std. 701201-05

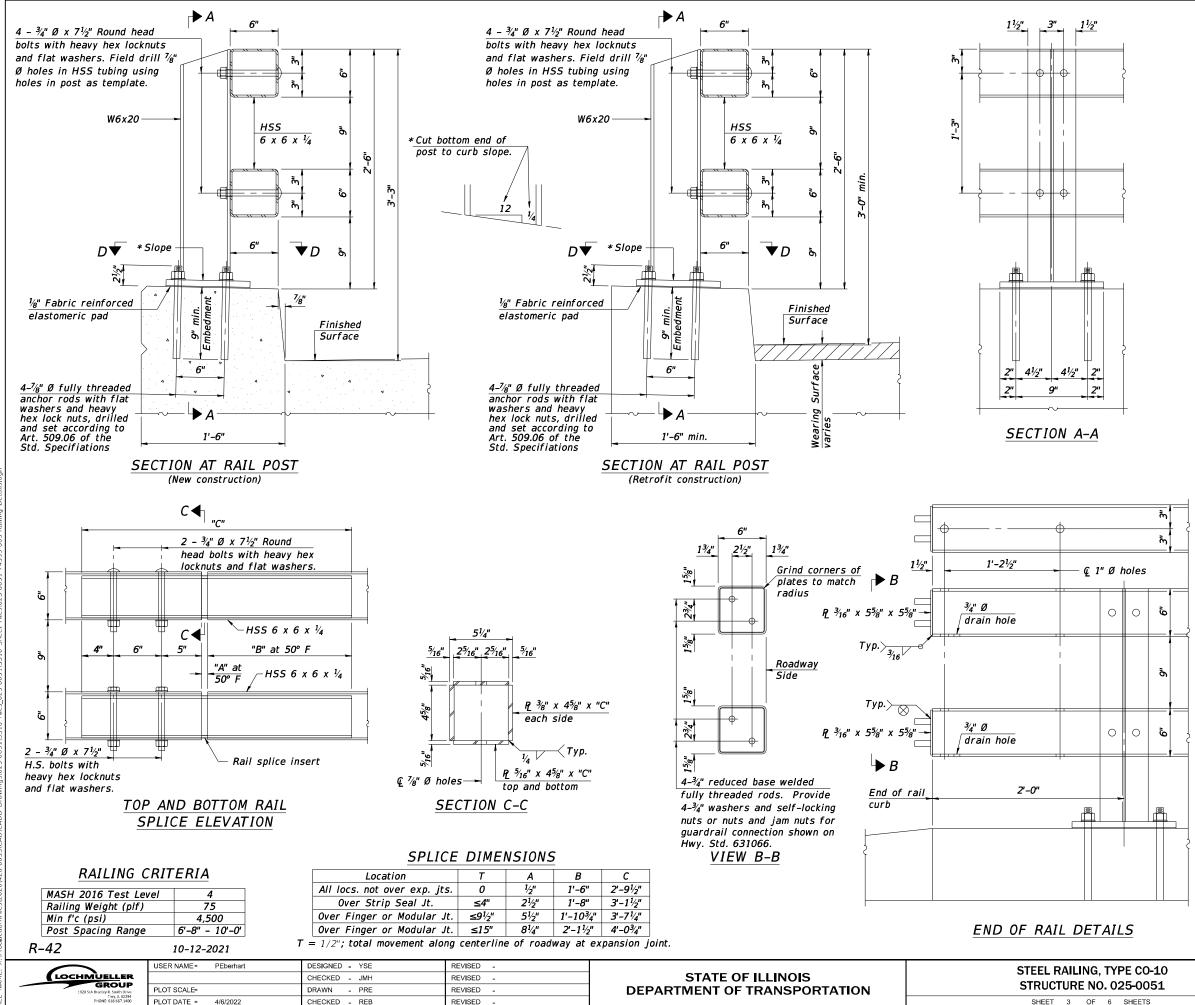

4/6/2022 11:22:03 AM

PLOT DATE = 4/6/2022

CHECKED - REB

REVISED -



All HSS tubing shall be ASTM A500 grade C. All plates shall be AASHTO M270 grade 50.

All heavy hex nuts shall be according to ASTM A563 grade DH.

All fully threaded anchor rods shall be ASTM F1554 grade 105.

The post base plate shall be fastened to the curb snug tight and given an additional  $\frac{1}{8}$ " turn.

Posts shall not be located closer than 2'-6" to a bridge expansion joint.

Provide one  $\frac{1}{8}$ " and two  $\frac{1}{16}$ " steel shims for 25% of the posts. Shims shall be similar to base plates in size and holes.

All steel rail elements shall be galvanized according to Article 509.05 of the Standard Specifications. All HSS tubing shall be CVN tested according to

Article 1006.34(b) of the Standard Specifications.

Rail splice inserts may be built out of  $2 -\frac{3}{8}$ " bent plates in lieu of the 4 plate rail splice inserts shown, provided the outside dimensions are matched.

All round head bolts shall be ASTM A449. The centerline of rail splices shall be placed between 1'-8" to 2'-6" from the centerline of the posts. The free end of the splice tube shall be oriented away from the closest post.

As Required

% +

Without Slot

or Recess

2


CONTRACT NO. 74599

2½"


3"

1⁄8" max.

<u>³⁄8"</u>\_\_

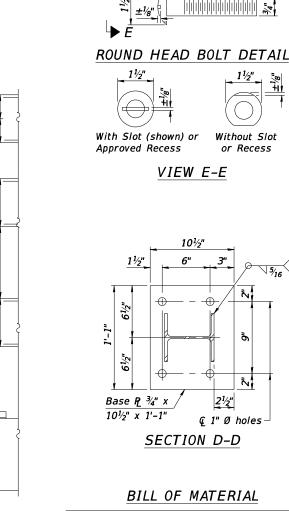

		DILL OF MATERIA						
[		Item			Jnit	Qua	antity	
	Steel	l Rail	ing, Type CO-10	F	oot	4	133	
0		F.A.I. RTE	SECTION		COUNT	Υ	TOTAL SHEETS	SHEET NO.
		70	(25-4-1, 25-5)R		EFFINGH	IAM	790	304

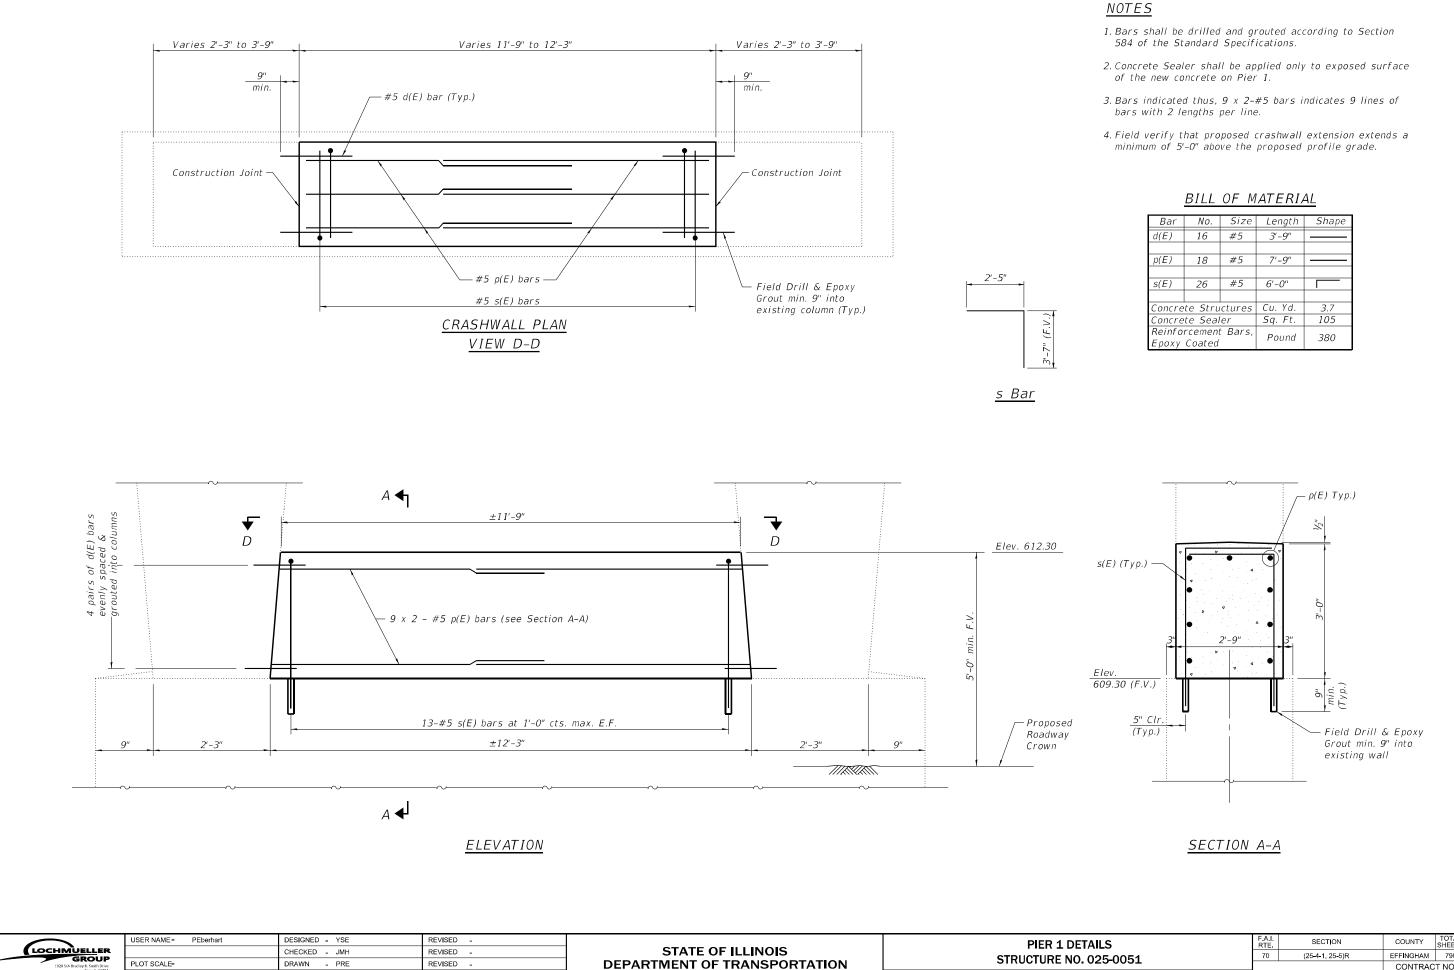

4/6/2022 11:22:05 AM

Troy, IL 52294 PHONE: 618.667.1400

PLOT DATE = 4/6/2022


CHECKED - REB

REVISED -

SHEET 4 OF 6

Bar	No.	Size	Length	Shape
d(E)	16	#5	3'-9"	
p(E)	18	#5	7'-9"	
s(E)	26	#5	6'-0"	
Concre	te Stru	ctures	Cu.Yd.	3.7
Concre	te Seal	er	Sq. Ft.	105
	rcemen Coated	t Bars,	Pound	380

CONTRACT NO. 74599	TAILS		SECT	ON		COUNTY	TOTAL SHEETS	SHEET NO.
CONTRACT NO. 74599	. 025-0051		0 (25-4-1, 25-5)R		EFFINGHAM	790	305	
6 SHEETS						CONTRAC	T NO. 74	1599
	6 SHEETS	ILLINOIS FED. A			FED. AI	PROJECT		

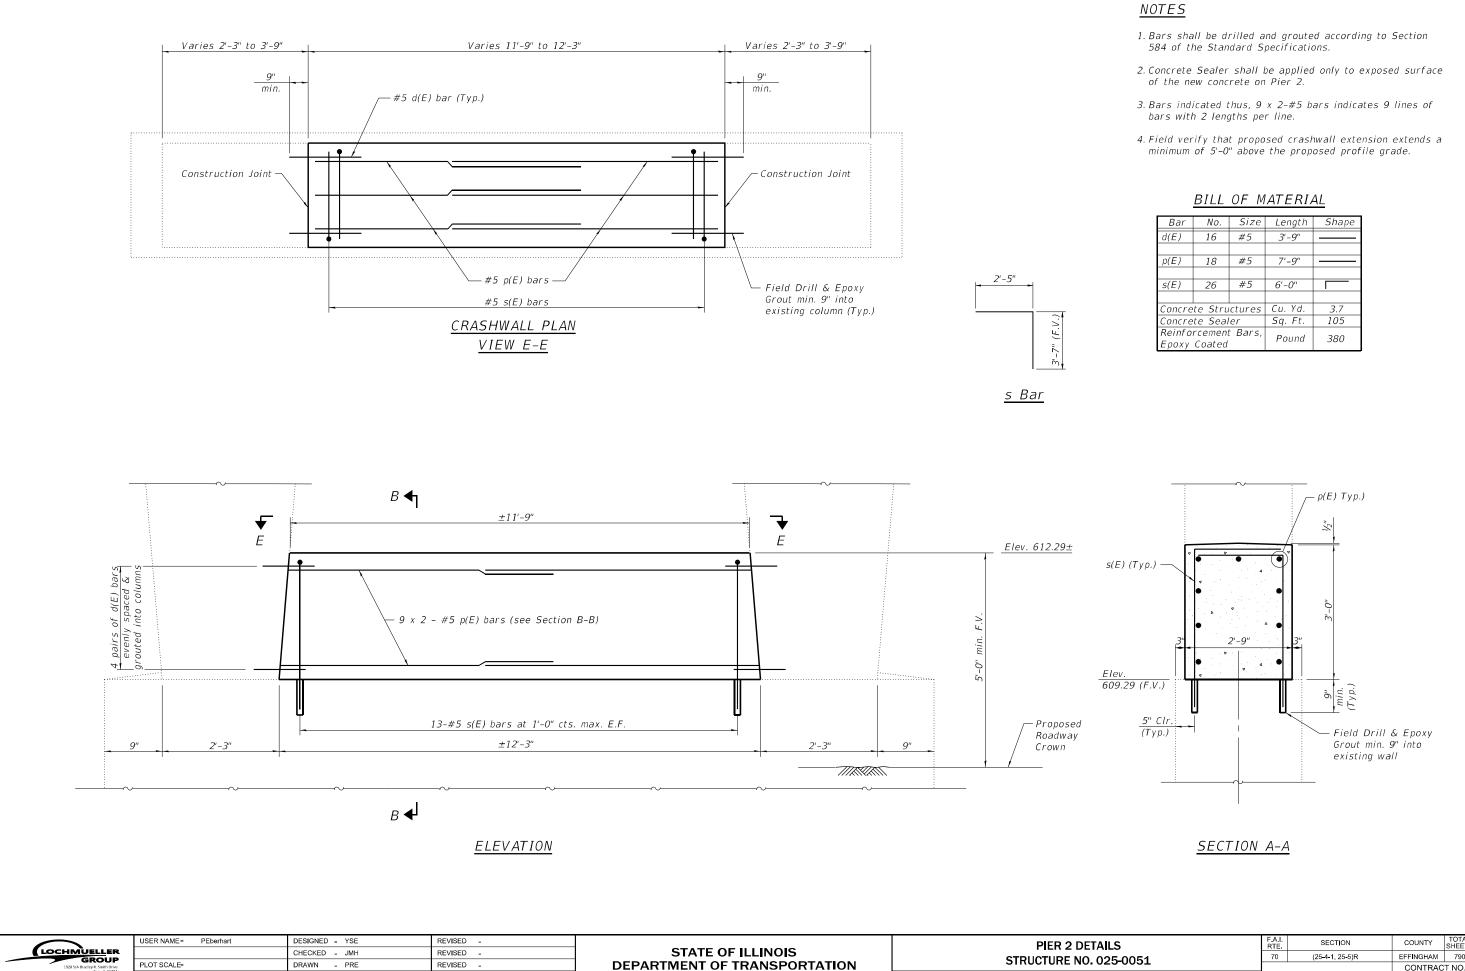

MO

Troy, IL 52294 PHONE: 618.667.1400


PLOT DATE = 4/6/2022

CHECKED - REB

REVISED -

Bar	No.	Size	Length	Shape
d(E)	16	#5	3'-9"	
p(E)	18	#5	7'-9"	
s(E)	26	#5	6'-0"	
Concre	te Stru	ctures	Cu. Yd.	3.7
Concre	te Seal	er	Sq. Ft.	105
	rcemen Coated	t Bars,	Pound	380

TAILS		SECT	ON		COUNTY	TOTAL SHEETS	SHEET NO.
025-0051		70 (25-4-1, 25-5)R		EFFINGHAM	790	306	
					CONTRAC	T NO. 74	1599
6 SHEETS	ILLINOIS FED. A			FED. AID	PROJECT		

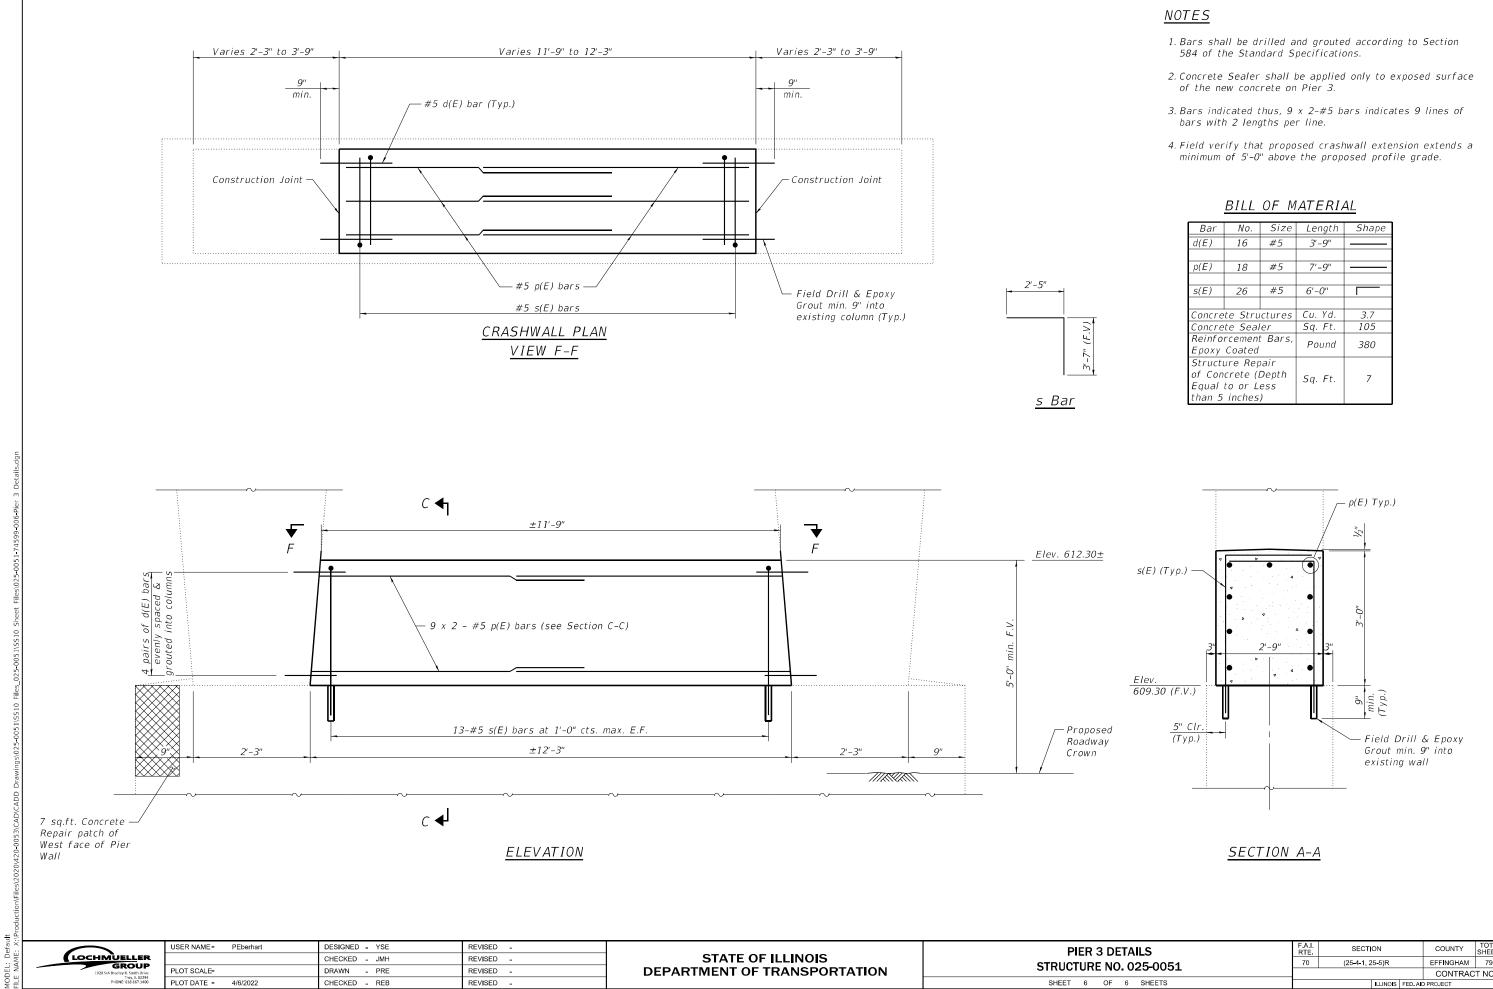


4/6/2022 11:22:08 AM

SHEET 6 OF 6

Bar	No.	Size	Length	Shape
d(E)	16	#5	3'-9"	
p(E)	18	#5	7'-9"	
s(E)	26	#5	6'-0"	
Concre	te Stru	ctures	Cu.Yd.	3.7
Concre	te Seal	er	Sq. Ft.	105
	rcement	: Bars,	Pound	380
Ероху	Coated		1 ound	500
	ure Rep			
	crete (l	'	Sq. Ft.	7
	to or L			
than 5	inches	)		

	F.A.I.						
TAILS 025-0051		SECT	ON		COUNTY	TOTAL SHEETS	SHEET NO.
		(25-4-1, 25-5)R		EFFINGHAM	790	307	
					CONTRAC	T NO. 74	1599
6 SHEETS			ILLINOIS	FED. AIC	PROJECT		

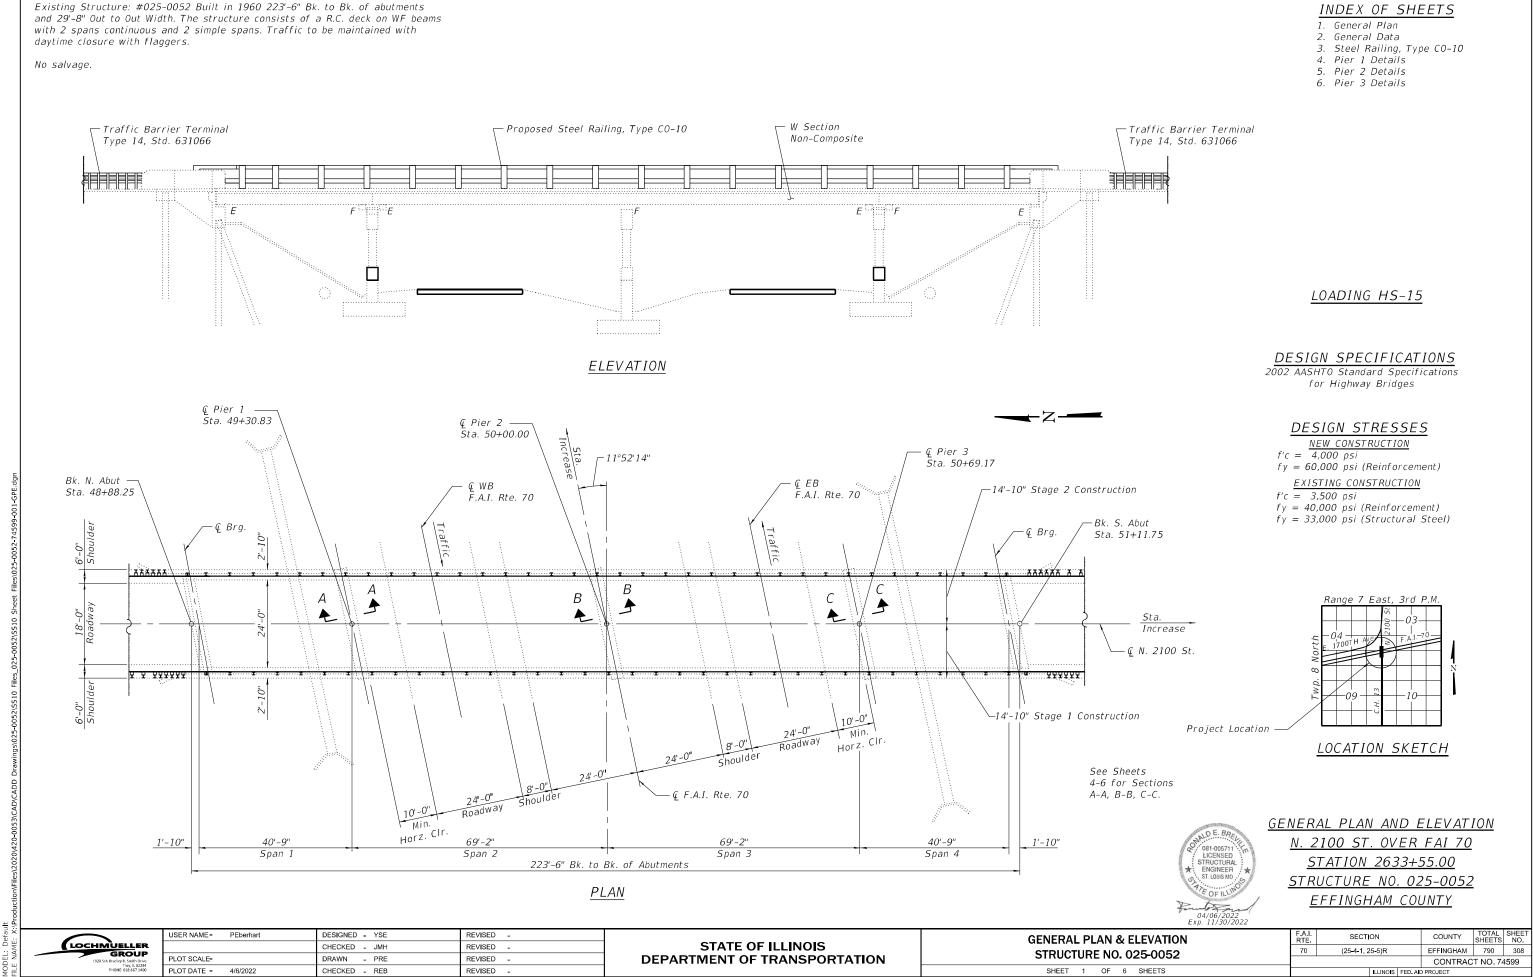

4/6/2022 11:22:11 AM


Bench Mark:

## **GENERAL NOTES**

- 1. No field welding is permitted except as specified in the contract documents.
- 2. Reinforcement bars designated (E) shall be epoxy coated.
- 3. Plan dimensions and details relative to existing plans are subject to nominal construction variations. The Contractor shall field verify existing dimensions and details affecting new construction and make necessary approved adjustments prior to construction or ordering of materials. Such variations shall not be cause for additional compensation for a change in scope of the work, however, the Contractor will be paid for the quantity actually furnished at the unit price bid for the work.
- 4. Concrete Sealer shall be applied to the designated areas of the piers.
- 5. The existing structural steel coating contains lead. The Contractor shall take appropriate precautions to deal with the presence of lead on this project.
- 6. All elevations shown on plans are based on 1960 plans and therefore NGVD 29 Datum. Elevations shall be confirmed with survey.

## SCOPE OF WORK


- 1. Install Steel Railing Type CO-10.
- 2. Construct crashwalls at piers.

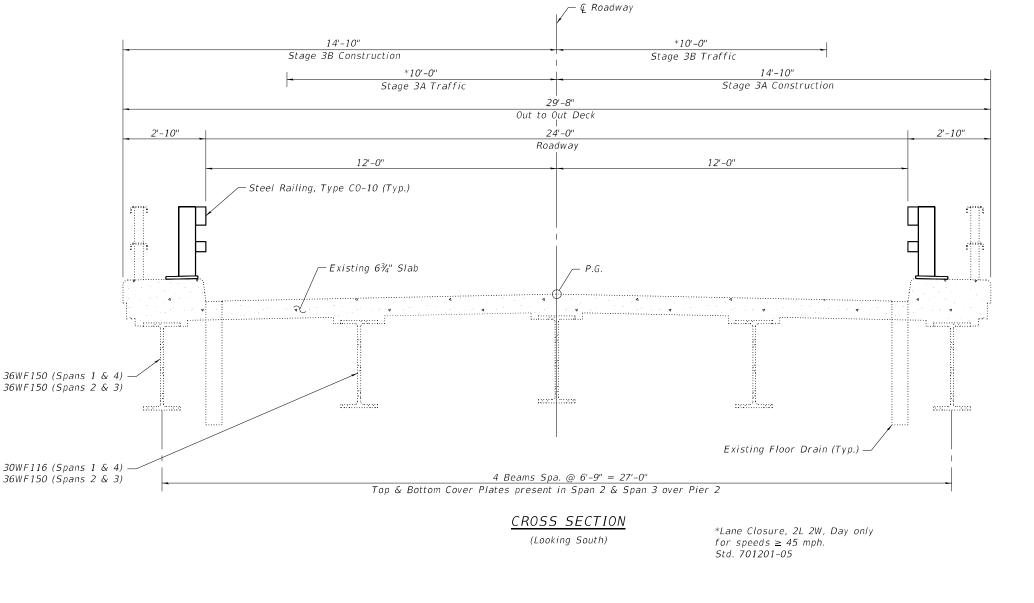

efau :: X:		USER NAME = PEberhart	DESIGNED - YSE	REVISED -		GENERAL DATA	F.A.I. SECTION	COUNTY TOTAL SHEET
AME :			CHECKED - JMH	REVISED -	STATE OF ILLINOIS	STRUCTURE NO. 025-0052	70 (25-4-1, 25-5)R	EFFINGHAM 790 309
	1928 SrA Bradley R. Smith Drive Trov. IL 62294	PLOT SCALE=	DRAWN - PRE	REVISED -	DEPARTMENT OF TRANSPORTATION	STRUCTURE NO. 020-0002		CONTRACT NO. 74599
FILE	PHONE: 618.667.1400	PLOT DATE = 4/6/2022 CHECKED - REB		REVISED -		SHEET 2 OF 6 SHEETS	S ILLINOIS FED. A	

TOTAL BILL OF MATERIAL

ITEM	UNIT	SUPER	SUB	TOTAL
crete Structures	Cu. Yd.	-	11.1	11.1
crete Sealer	Sq. Ft.	-	315	315
nforcement Bars, Epoxy Coated	Pounds	-	1140	1140
el Railing, Type CO-10	Foot	433	1	433

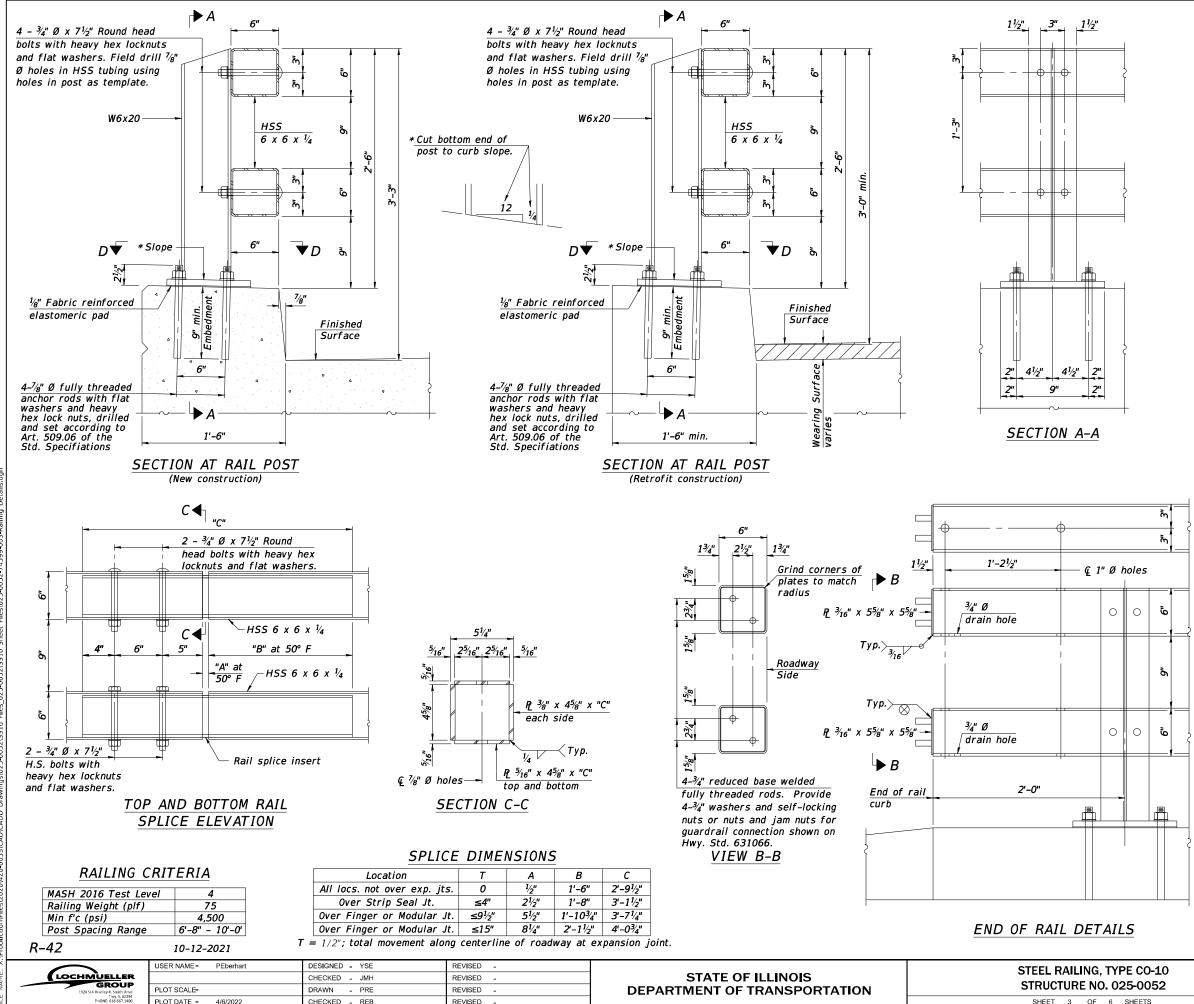

4/6/2022 11:22:16 AM

PLOT DATE = 4/6/2022

CHECKED - REB

REVISED -

SHEET 3 OF 6 SHEETS

### Notes:

All HSS tubing shall be ASTM A500 grade C. All plates shall be AASHTO M270 grade 50.

All heavy hex nuts shall be according to ASTM A563 grade DH.

All fully threaded anchor rods shall be ASTM F1554 grade 105.

The post base plate shall be fastened to the curb snug tight and given an additional <sup>1</sup>/<sub>8</sub>" turn.

Posts shall not be located closer than 2'-6" to a bridge expansion joint.


Provide one  $\frac{1}{8}$ " and two  $\frac{1}{16}$ " steel shims for 25% of the posts. Shims shall be similar to base plates in size and holes.


All steel rail elements shall be galvanized according to Article 509.05 of the Standard Specifications. All HSS tubing shall be CVN tested according to

Article 1006.34(b) of the Standard Specifications. Rail splice inserts may be built out of  $2 -\frac{3}{8}$ " bent

plates in lieu of the 4 plate rail splice inserts shown, provided the outside dimensions are matched. All round head bolts shall be ASTM A449.

The centerline of rail splices shall be placed between 1'-8" to 2'-6" from the centerline of the posts. The free end of the splice tube shall be oriented away from the closest post.

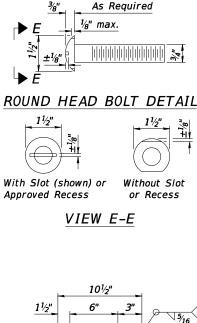

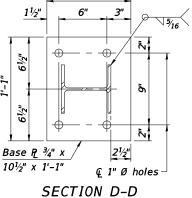



ILLINOIS FED AID PROJECT


EFFINGHAM 790 310

CONTRACT NO. 74599

	Item	Unit	Quantity	
	Steel Railing, Type CO-10	Foot	433	
0	F.A.I. SECTION	COUN	TY TOTAL SHEETS	SHEE NO.

(25-4-1, 25-5)R

70

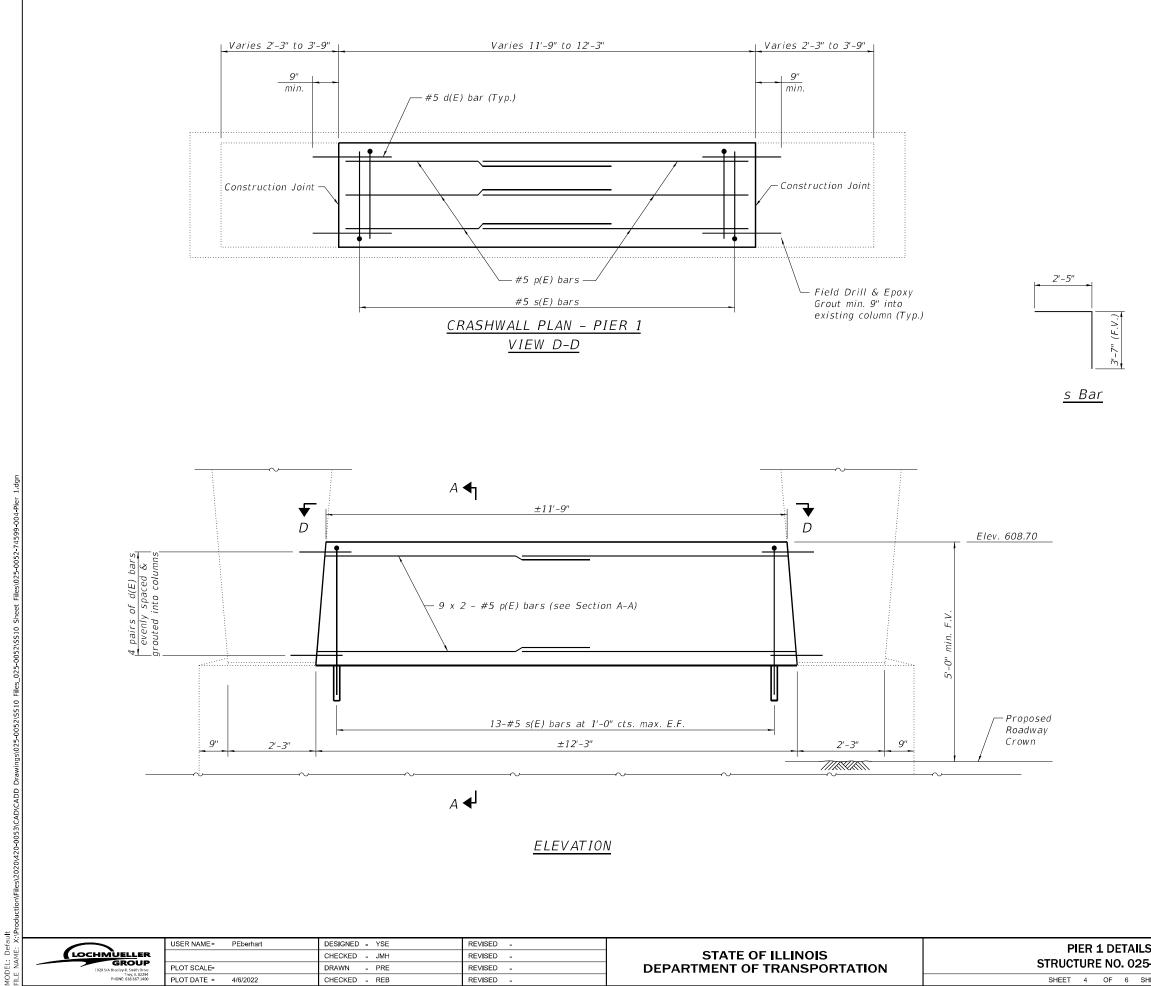

4/6/2022 11:22:19 AM

### <u>NOTES</u>

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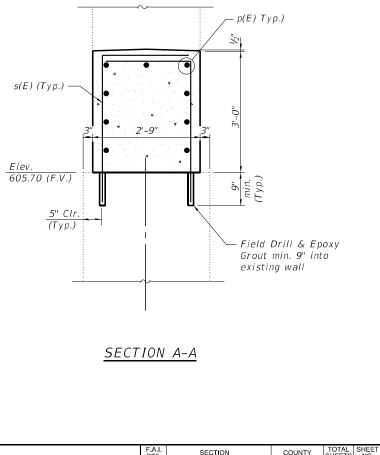
(F.V.

3'-7"


- 1. Bars shall be drilled and grouted according to Section 584 of the Standard Specifications.
- 2. Concrete Sealer shall be applied only to exposed surface of the new concrete on Pier 1.
- 3. Bars indicated thus, 9 x 2-#5 bars indicates 9 lines of bars with 2 lengths per line.
- 4. Field verify that proposed crashwall extension extends a minimum of 5'-0" above the proposed profile grade.


Bar	No.	Size	Length	Shape
d(E)	16	#5	3'-9"	
p(E)	18	#5	7'-9"	
s(E)	26	#5	6'-0"	
Concre	te Stru	ctures	Cu. Yd.	3.7
Concre	te Seal	er	Sq. Ft.	105
	rcemen Coated	t Bars,	Pound	380

BILL OF MATERIAL




TAILS	RTE.	SECT	ON		COUNTY	SHEETS	NO.
. 025-0052	70	(25-4-1, 2	25 <b>-</b> 5)R		EFFINGHAM	790	311
. 025-0052					CONTRAC	T NO. 74	1599
6 SHEETS			ILLINOIS	FED. AI	PROJECT		

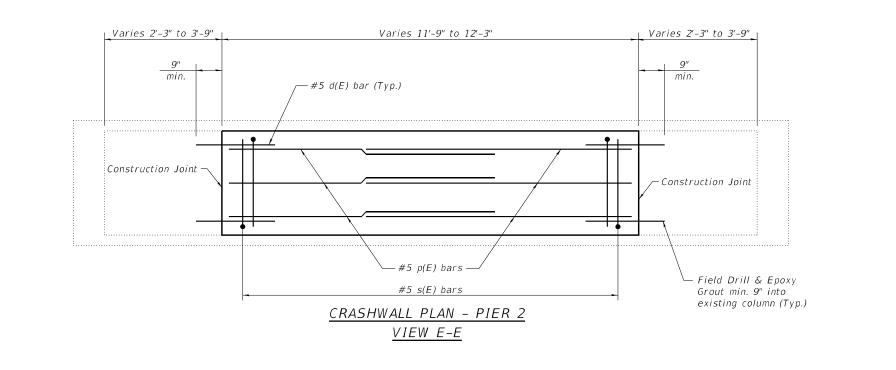

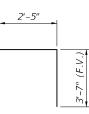



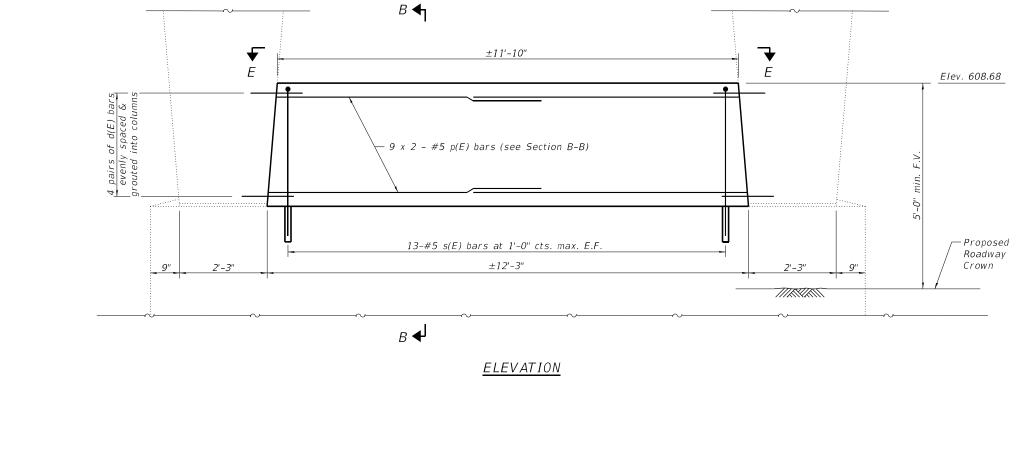

efau	$\bigcirc$	USER NAME = PEberhart	DESIGNED - YSE	REVISED -		PIER 2 DETAILS	F.A.I. RTE	SECTION	COUNTY	TOTAL SHEET SHEETS NO.
AME :					70	(25-4-1, 25-5)R	EFFINGHAM	790 312		
	1928 SrA Bradley R. Smith Drive Troy. II 62294	PLOT SCALE=	DRAWN - PRE	REVISED -	DEPARTMENT OF TRANSPORTATION	STRUCTURE NO. 025-0052			CONTRAC	T NO. 74599
Р П Ц	PHONE: 618.667.1400	PLOT DATE = 4/6/2022	CHECKED - REB	REVISED -		SHEET 5 OF 6 SHEETS		ILLINOIS FED. 4	AID PROJECT	


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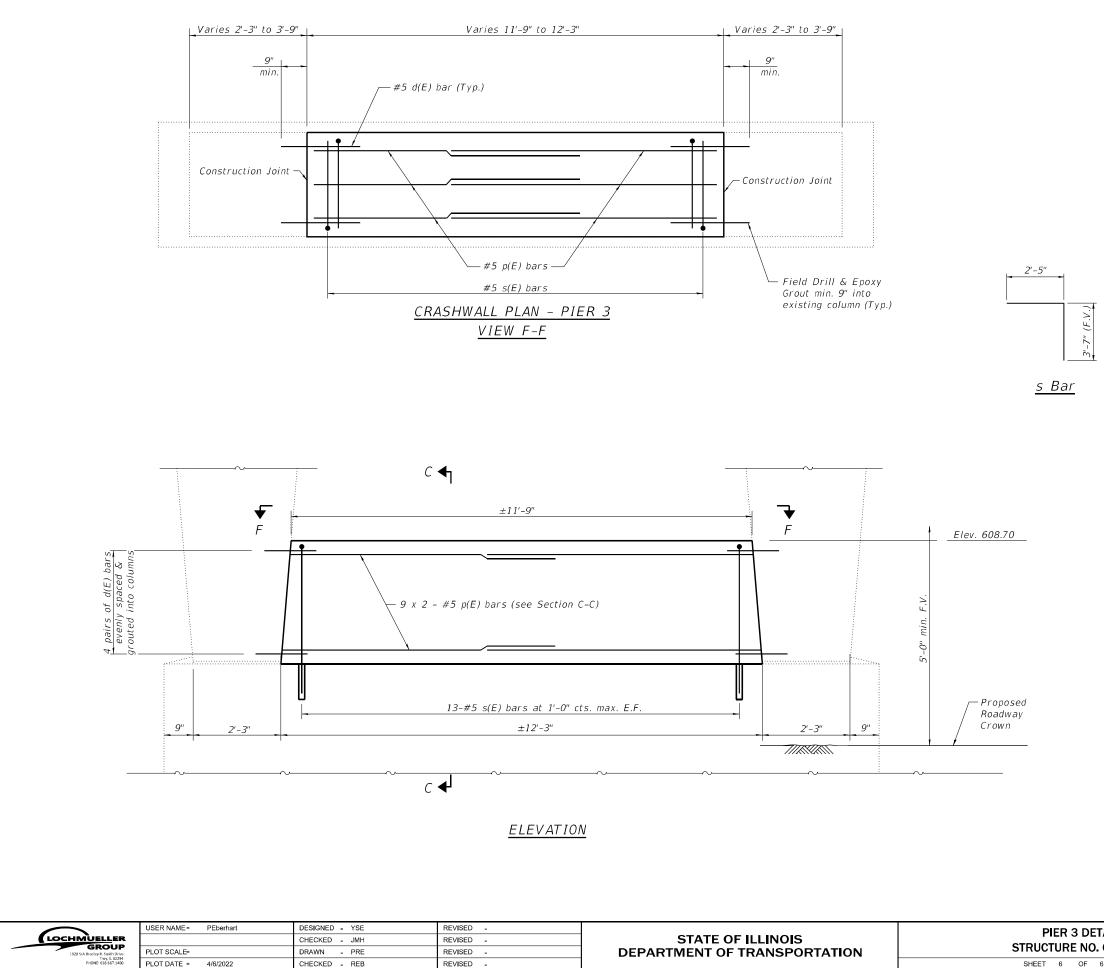
## <u>NOTES</u>

- 1. Bars shall be drilled and grouted according to Section 584 of the Standard Specifications.
- 2. Concrete Sealer shall be applied only to exposed surface of the new concrete on Pier 2.
- 3. Bars indicated thus, 9 x 2-#5 bars indicates 9 lines of bars with 2 lengths per line.
- Field verify that proposed crashwall extension extends a minimum of 5'-0" above the proposed profile grade.

Bar	No.	Size	Length	Shape
d(E)	16	#5	3'-9"	
p(E)	p(E) 18 #5		7'-9"	
s(E)	26 #5		6'-0"	
Concre	te Stru	ctures	Cu. Yd.	3.7
Concre	te Seal	er	Sq. Ft.	105
	rcemen Coated	t Bars,	Pound	380

BILL OF MATERIAL



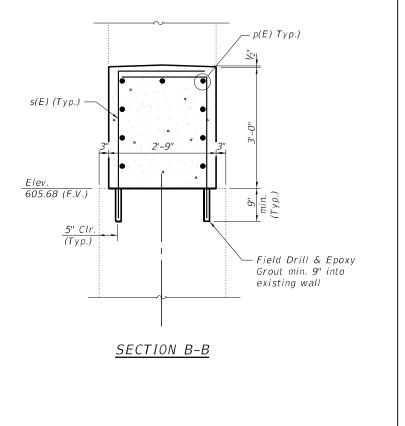

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MO

## <u>NOTES</u>


(F.V

"~ ñ,

- 1. Bars shall be drilled and grouted according to Section 584 of the Standard Specifications.
- 2. Concrete Sealer shall be applied only to exposed surface of the new concrete on Pier 3.
- 3. Bars indicated thus, 9 x 2-#5 bars indicates 9 lines of bars with 2 lengths per line.
- 4. Field verify that proposed crashwall extension extends a minimum of 5'-0" above the proposed profile grade.


Bar	No.	Size	Length	Shape
d(E)	16	#5	3'-9"	
p(E)	E) 18 #5		7'-9"	
s(E)	26 #5		6'-0"	
Concre	te Stru	ctures	Cu.Yd.	3.7
Concre	te Seal	er	Sq. Ft.	105
	rcemen Coated	t Bars,	Pound	380

BILL OF MATERIAL

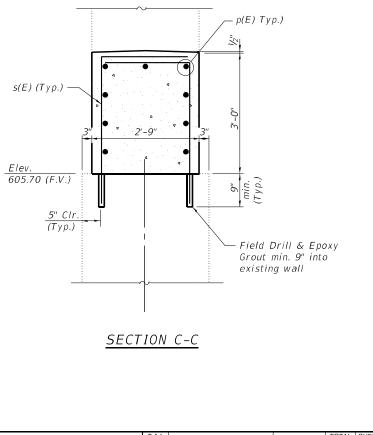



TAILS . 025-0052		SECTION		COUNTY	TOTAL SHEETS	SHEET NO.	
		70 (25-4-1, 25-5)R			EFFINGHAM	790	313
					CONTRAC	T NO. 74	1599
6 SHEETS	ILLINOIS FED. AID			PROJECT			

Existing Structure: The existing structure is a ±285' long, precast reinforced concrete pipe that has a 72" inner diameter. There are no existing structure plans available.

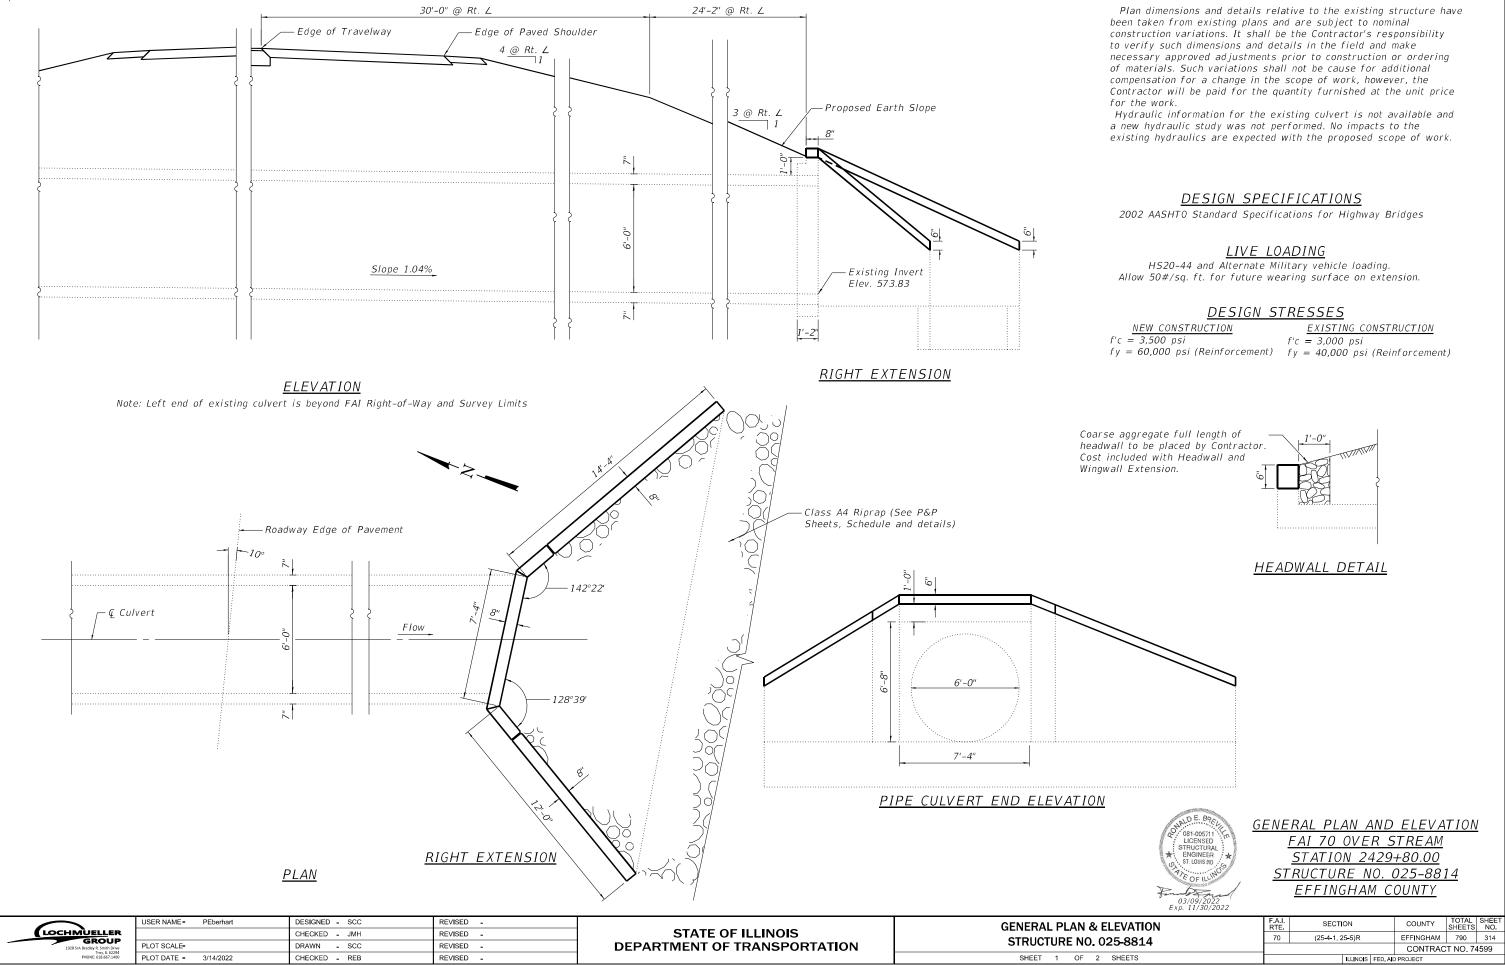


## **GENERAL NOTES**

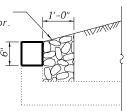

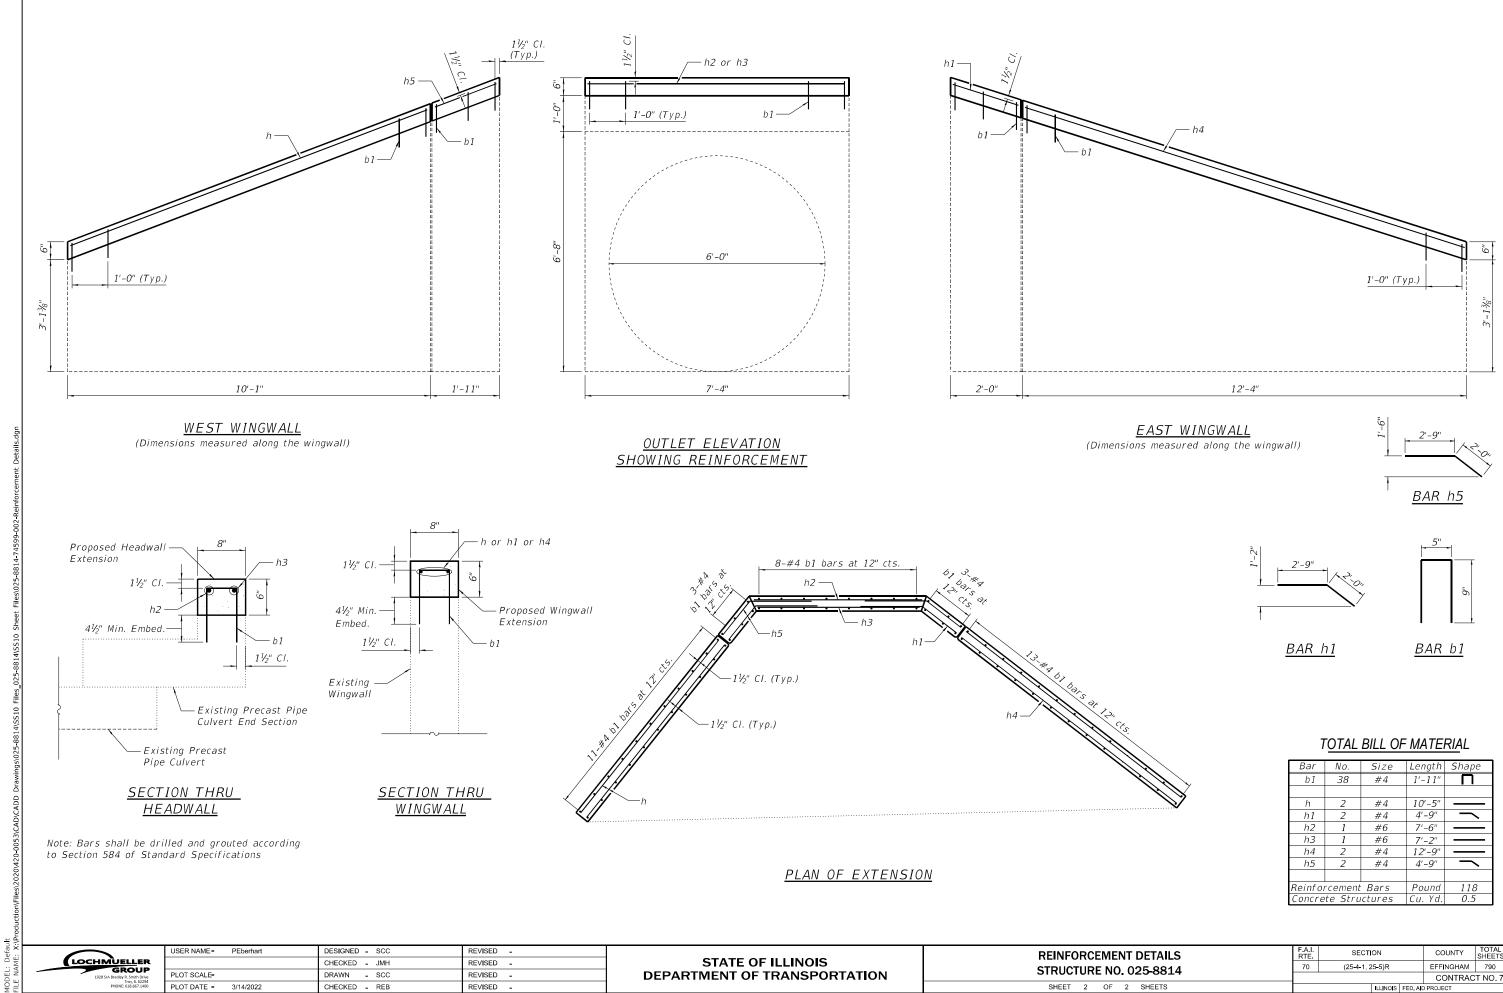

3/14/2022 3:11:34 PM

DETAILS 025-8814	F.A.I. RTE			COUNTY	TOTAL SHEETS	SHEET NO.	
	70	) (25-4-1, 25-5)R		EFFINGHAM	790	315	
23-0014					CONTRAC	T NO. 74	599
SHEETS			<b>LLINOIS</b>	FED. AIC	PROJECT		
SHEETS			LLINOIS	FED. ALC	PROJECT		

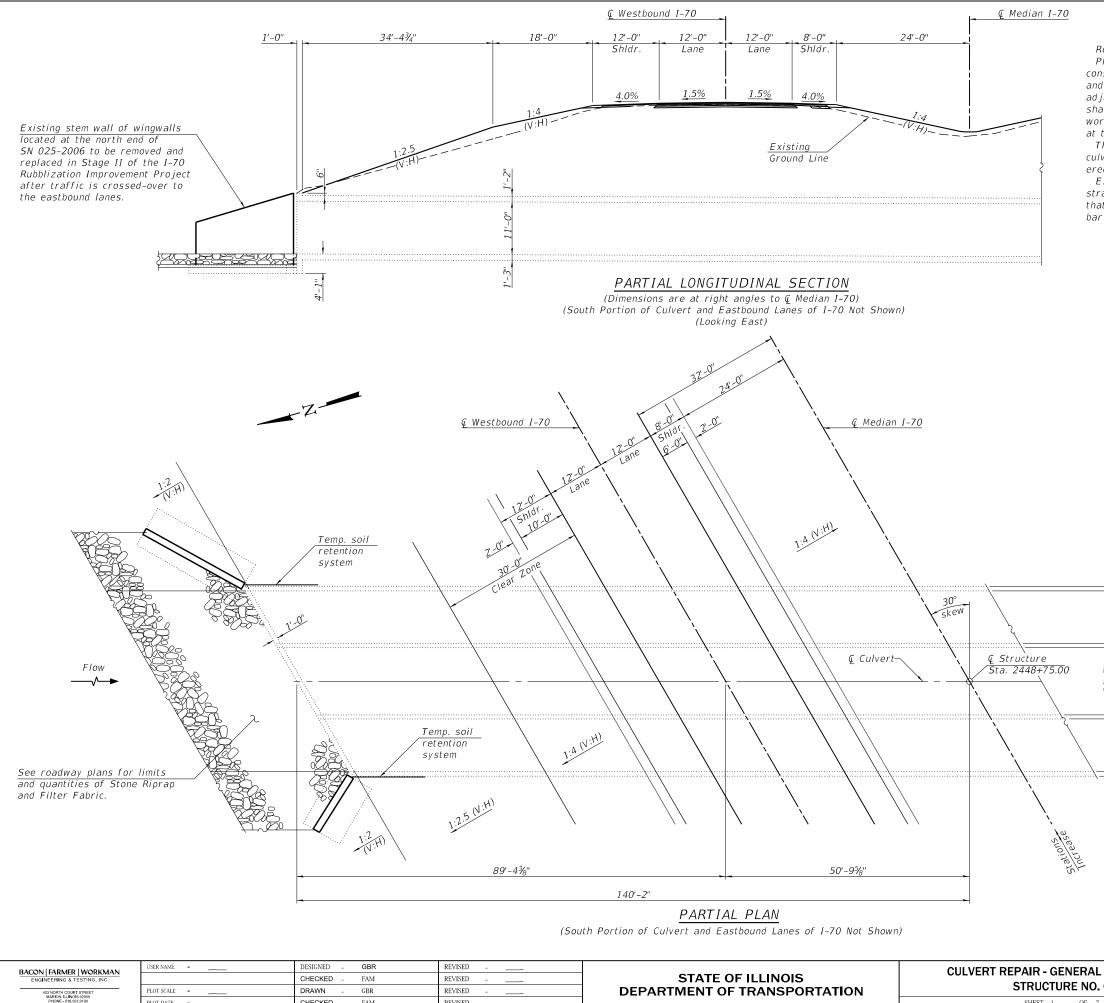

\$DATE\$ \$TIME\$

LOT DATE =

CHECKED

FAM

REVISED

SHEET 1 OF 7

11/2"

111/5"

## GENERAL NOTES

Reinforcement bars designated (E) shall be epoxy coated.

Plan dimensions and details relative to existing plans are subject to nominal construction variations. The Contractor shall field verify existing dimensions and details affecting new construction and make necessary approved

adjustments prior to construction or ordering of materials. Such variations shall not be cause for additional compensation for a change in scope of the work, however, the Contractor will be paid for the quantity actually furnished at the unit price bid for the work.

The Contractor shall take care not to damage the wingwall footings and box culvert during excavation, the removal of existing wingwall stems, and the erection of temporary soil retention systems.

Existing reinforcement bars extending into the removal area shall be cleaned, straightened and incorporated into the new construction. Any reinforcement bars that are damaged during concrete removal shall be replaced with an approved bar splicer or anchorage system. Cost included with Concrete Removal.

### DESIGN STRESSES

FIELD UNITS (New Construction)

f'c = 3,500 psi fy = 60,000 psi(Reinforcement)


## TOTAL BILL OF MATERIAL

ITEM	UNIT	TOTAL
Concrete Removal	Cu.Yd.	16.6
Reinforcement Bars	Pound	1720
Reinforcement Bars, Epoxy Coated	Pound	2230
Temporary Soil Retention System	Sq. Ft.	29
Concrete Box Culvert	Cu. Yd.	22.2




GENERAL PLAN AND ELEVATION F.A.I. 70 OVER SECOND SALT CREEK STATION 2448+75.00 STRUCTURE NO. 025-2006 EFFINGHAM COUNTY

. PLAN AND ELEVATION 025-2006		A.I. SECTION		COUNTY	TOTAL SHEETS	SHEET NO.	
		(25-4-1,25-5)R			EFFINGHAM	790	316
SHEETS			ILLINOIS	EED AIP	CONTRA PROJECT	CT NO. 7	4599
SIMETO			ILLINO15	FED. AID	FROJECT		

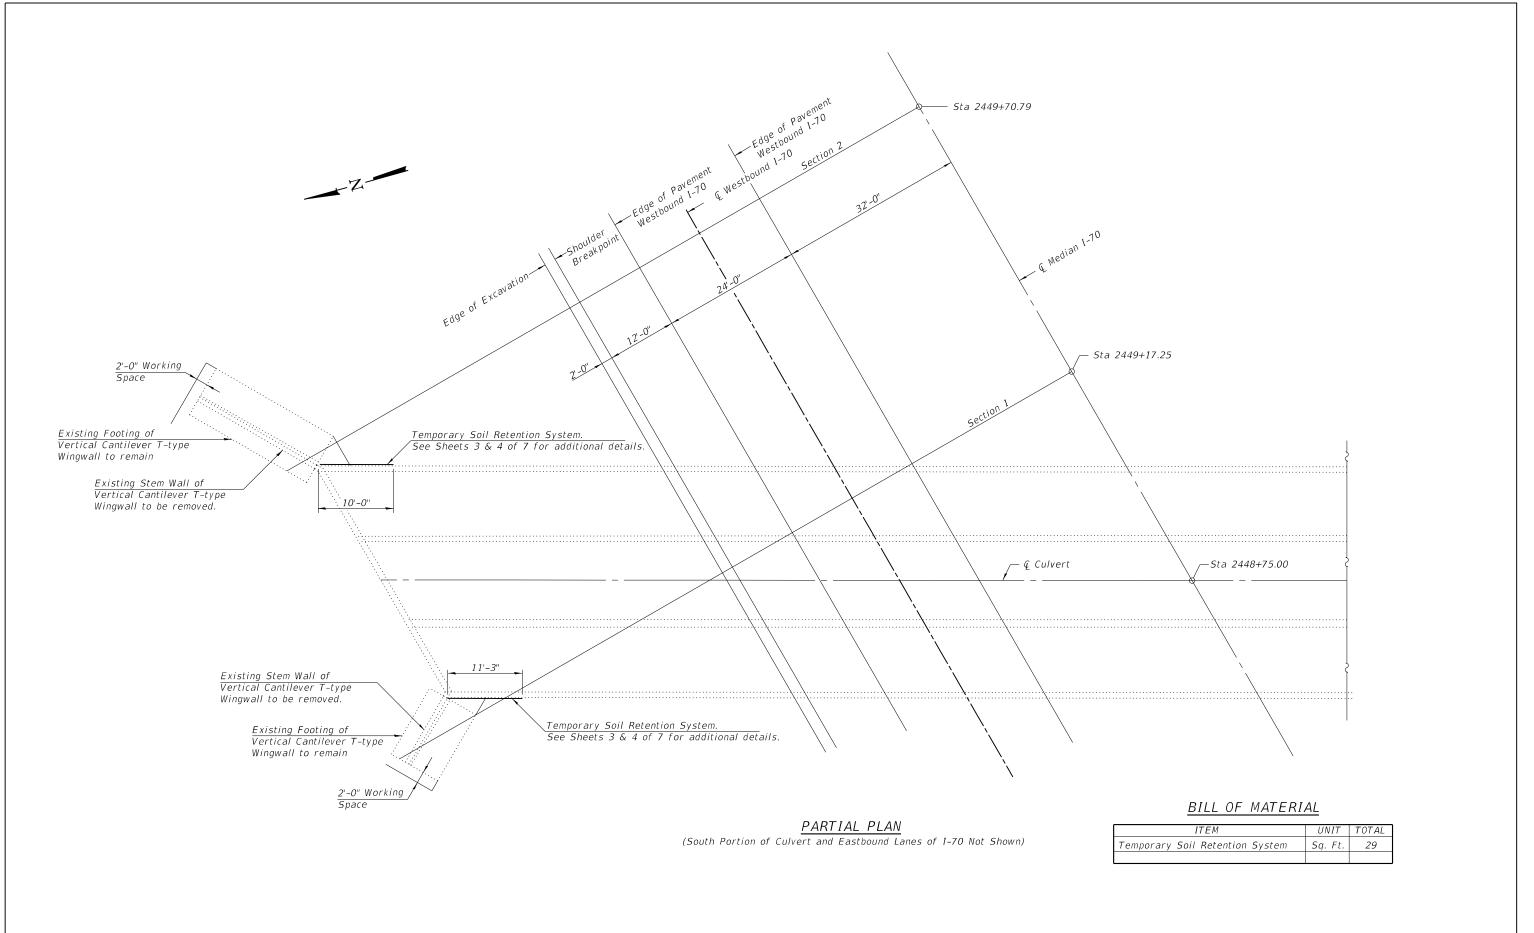


빙륜								
MOL ::	BACON FARMER WORKMAN	USER NAME	DESIGNED - GBR	REVISED -		CULVERT REPAIR - TEMPORARY SOIL RETENTION SYSTEM	F.A.I. SECTION	COUNTY TOTAL SHEET SHEFTS NO
		CHECKED - FAM REVISED -		STATE OF ILLINOIS	STRUCTURE NO. 025-2006	70 (25-4-1,25-5)R	EFFINGHAM 790 317	
	403 NORTH COURT STREET MARION & UNOB 52559	PLOT SCALE	DRAWN - GBR	REVISED -	DEPARTMENT OF TRANSPORTATION	STRUCTURE NO. 025-2006		CONTRACT NO. 74599
₽ E L	PHONE 618,997,9190	PLOT DATE	CHECKED - FAM	REVISED		SHEET 2 OF 7 SHEETS	ILLING	S FED. AID PROJECT

(Sheet 1 of 3)

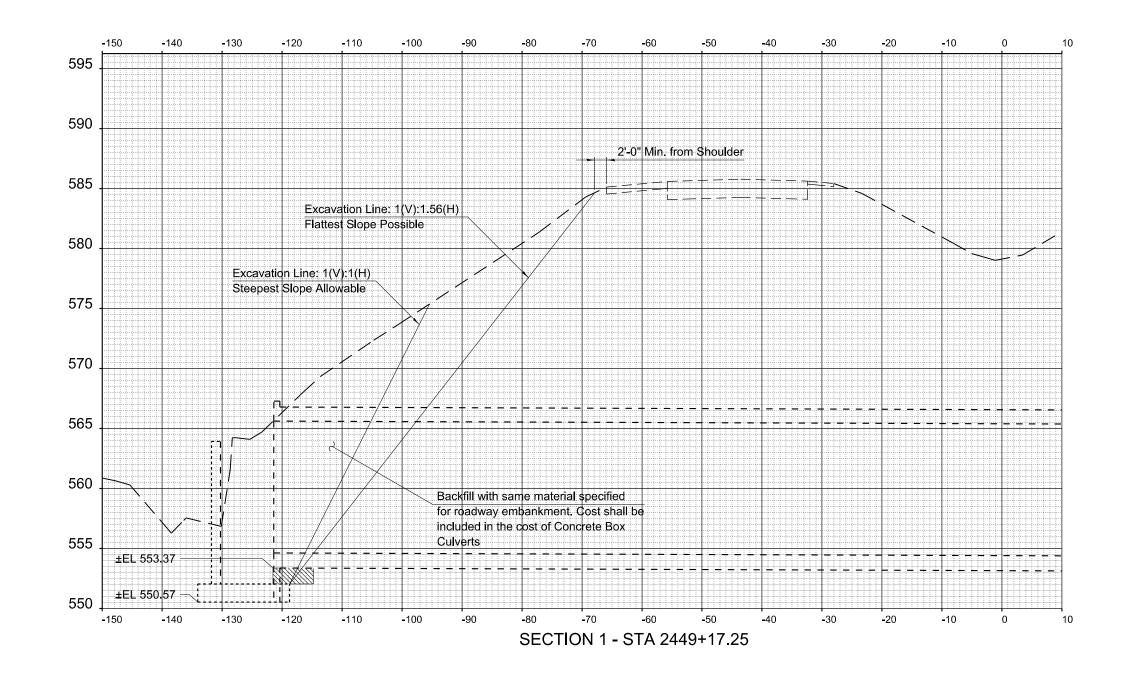


Estimated surface area to be retained by temp. soil retention system

BACON FARMER I WORKMAN	USER NAME	DESIGNED - GBR	REVISED -		CULVERT REPAIR - TEMPORARY SOIL RETENTION SYSTEM	F.A.I. RTE.	SECTION	COUNTY TOTAL SHEFTS	
ENGINEERING & TESTING, INC.		CHECKED - FAM	REVISED -	STATE OF ILLINOIS		70	(25-4-1,25-5)R	EFFINGHAM 790	
403 NORTH COURT STREET MARION, ILLINOIS 62959 PHONE 618,997,9190	PLOT SCALE	DRAWN - GBR	REVISED -	DEPARTMENT OF TRANSPORTATION	STRUCTURE NO. 025-2006		. , ,	CONTRACT NO. 7	
PHONE 618,997,9190	Net INGE 32560 PLOT DATE CHECKED FAM REVISED	REVISED		SHEET 3 OF 7 SHEETS	ILLINOIS FED. AID PROJECT				

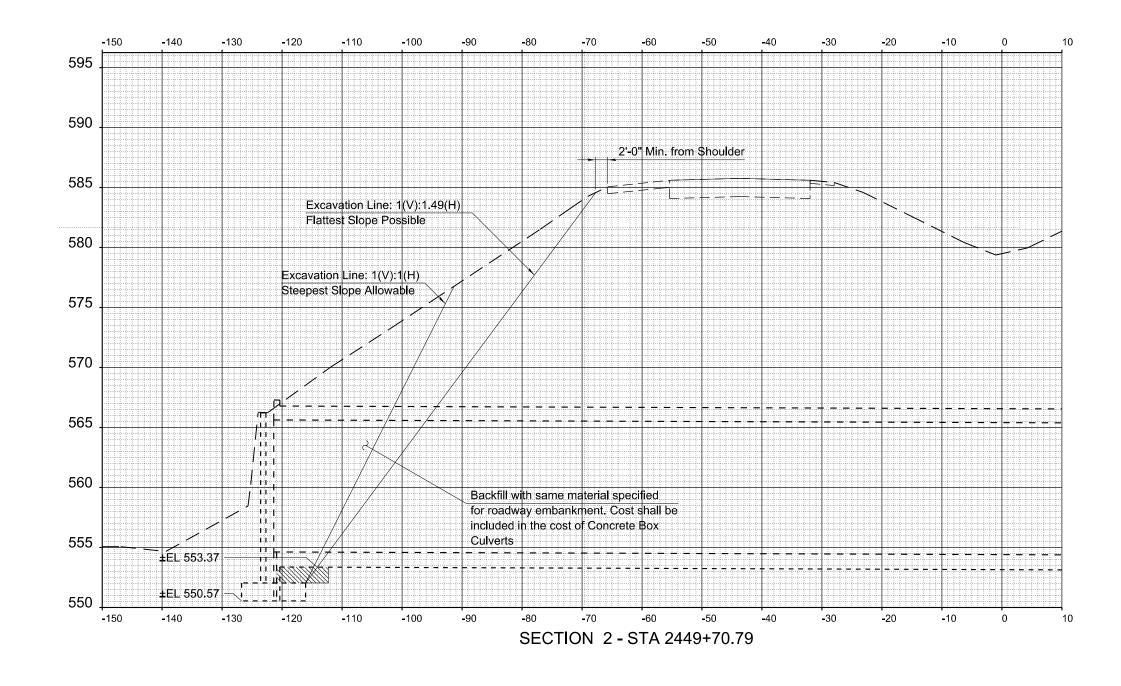

	BACON FARMER WORKMAN	USER NAME	DESIGNED - GBR REVISED				CULVERT REPAIR - TEMPORARY SOIL RETENTION SYSTEM	F.A.I. RTE	SECTION	COUNTY TOTAL SHEETS
AME	ENGINEERING & TESTING, INC.		CHECKED - FA	AM REVISED -		STATE OF ILLINOIS	STRUCTURE NO. 025-2006		(25-4-1,25-5)R	EFFINGHAM 790
z	403 NORTH COURT STREET MARION, LUNCIS 62959	PLOT SCALE	DRAWN - GB	BR REVISED -		DEPARTMENT OF TRANSPORTATION	STRUCTURE NO. 025-2006			CONTRACT NO. 745
E	PHONE 618,997,9190	PLOT DATE	CHECKED - FA	AM REVISED -			SHEET 4 OF 7 SHEETS		ILLINOIS J	ED. AID PROJECT

Estimated surface area to be retained by temp. soil retention system

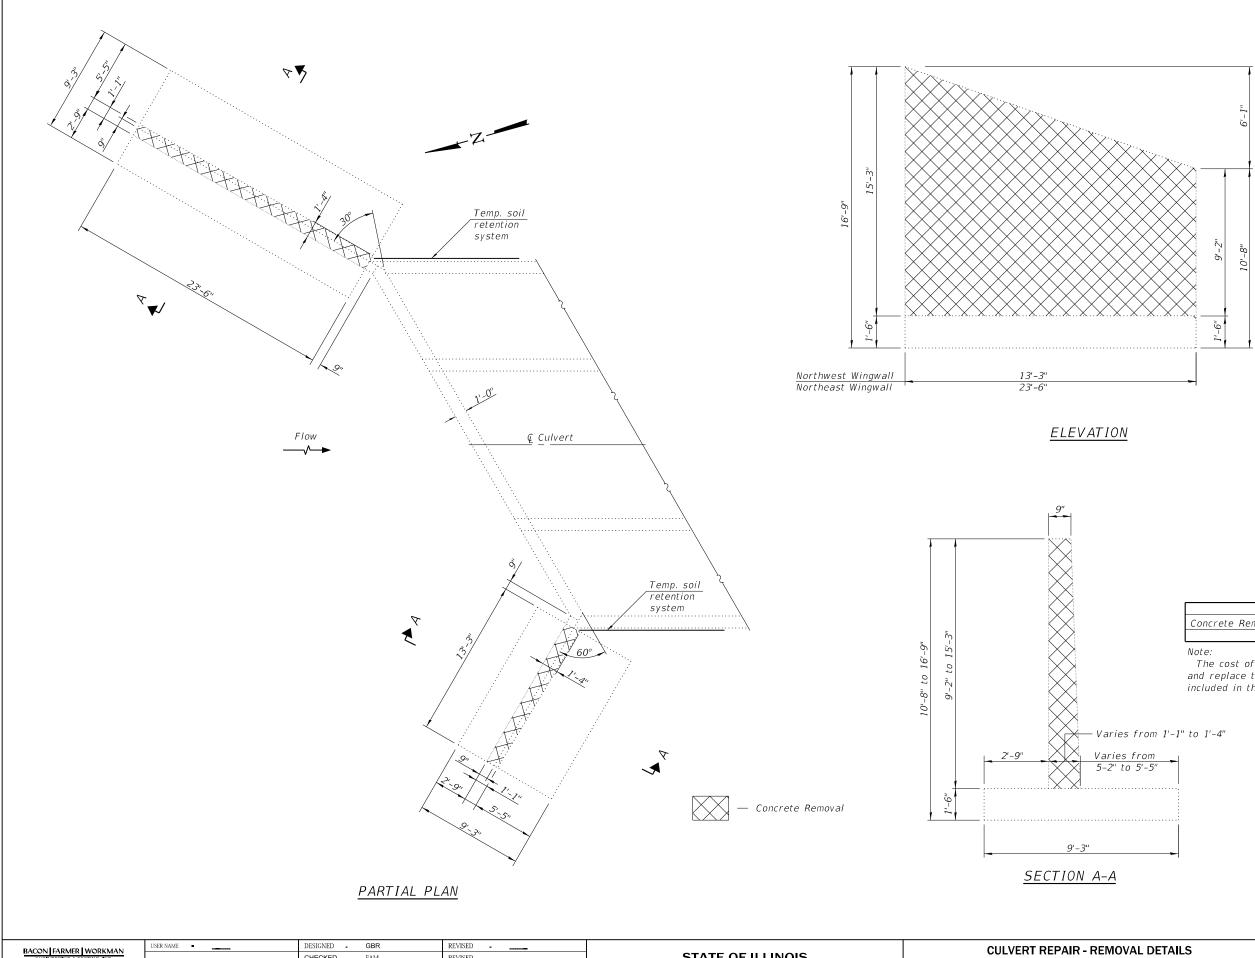


MOI FILE

	BACON FARMER WORKMAN	USER NAME	DESIGNED - GBR	REVISED -		CULVERT REPAIR - REMOVAL DETAILS	F.A.I. RTE SECTION	COUNTY TOTAL SHEET SHEETS NO	
AME	ENGINEERING & TESTING, INC.		CHECKED - FAM	REVISED -	STATE OF ILLINOIS	STRUCTURE NO. 025-2006	70 (25-4-1,25-5)R	EFFINGHAM 790 320	
Z III	403 NORTH COURT STREET MARION ILLINOIS 62959 PHONE • 619,997,9190	PLOT SCALE	DRAWN - GBR	REVISED -	DEPARTMENT OF TRANSPORTATION	51RUCTURE NO. 025-2000	;	CONTRACT NO. 74599	
EL	PHONE 618,997,9190	PLOT DATE  CHECKED FAM REVISED		REVISED		SHEET 5 OF 7 SHEETS	ILLINOIS FED.	FED. AID PROJECT	
¢г									

# BILL OF MATERIAL


ITEM	UNIT	TOTAL
Concrete Removal	Cu. Yd.	16.6

The cost of excavation required to remove and replace the exixtsing wingwalls shall be included in the cost of Concrte Box Culvert.

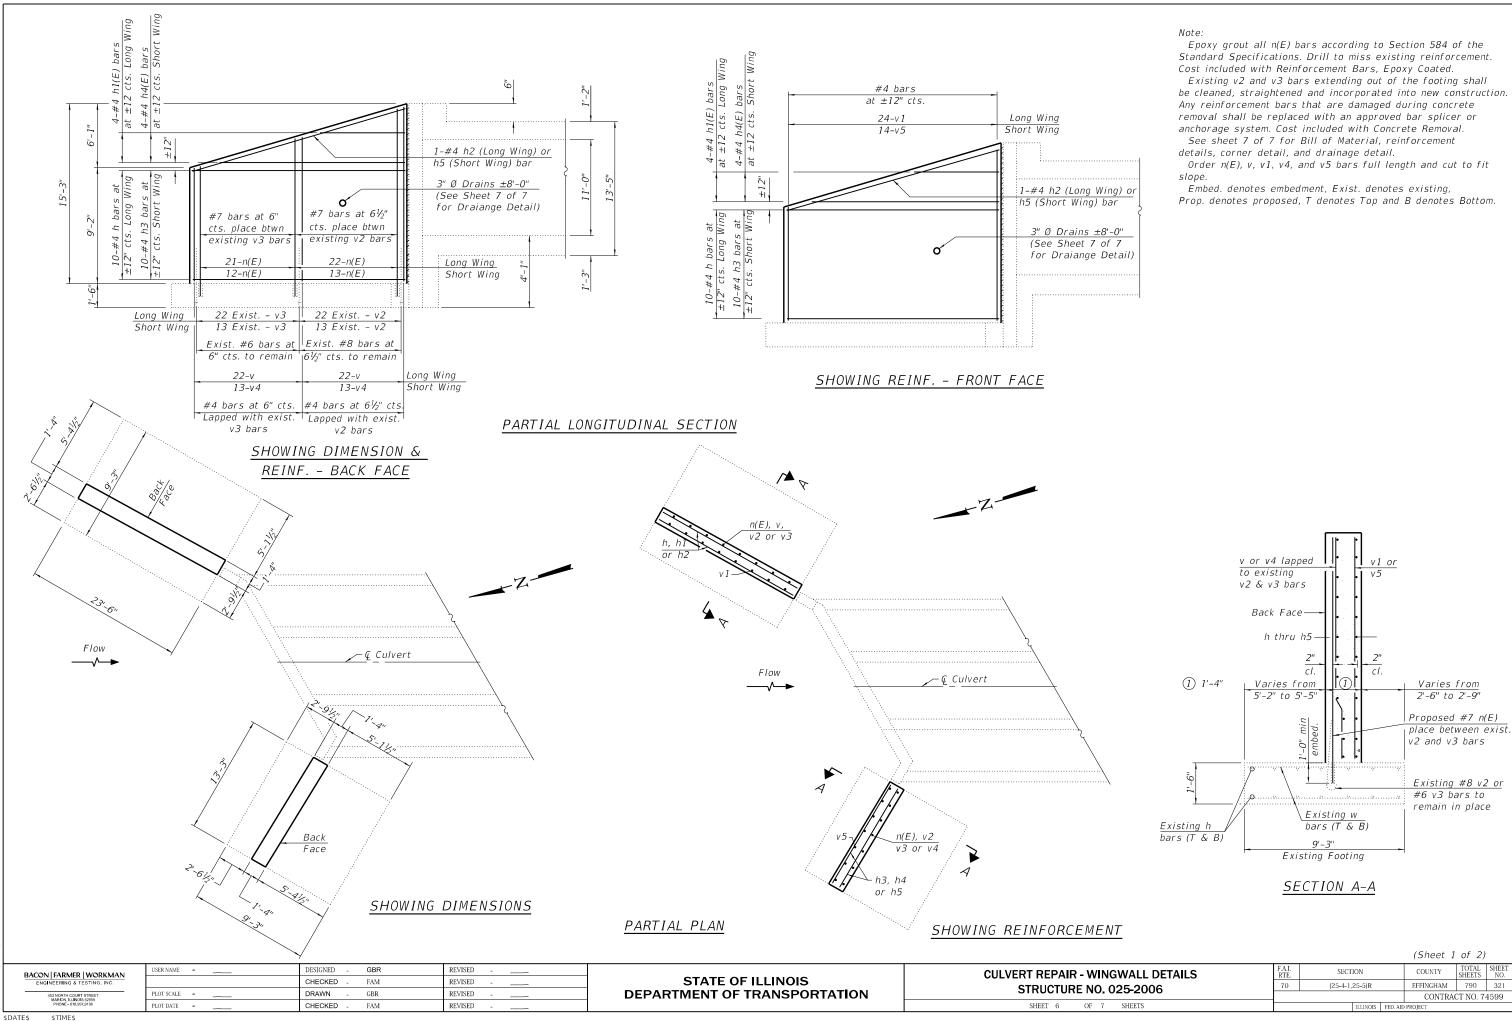

\$DATE\$

	(Sheet 1 of 2)						
NGWALL DETAILS	F.A.I. RTE.	SECTION			COUNTY	TOTAL SHEETS	SHEET NO.
025-2006		(25-4-1,25-5)R			EFFINGHAM	790	321
					CONTRA	CT NO. 74	4599
SHEETS			ILLINOIS	FED. AID	PROJECT		

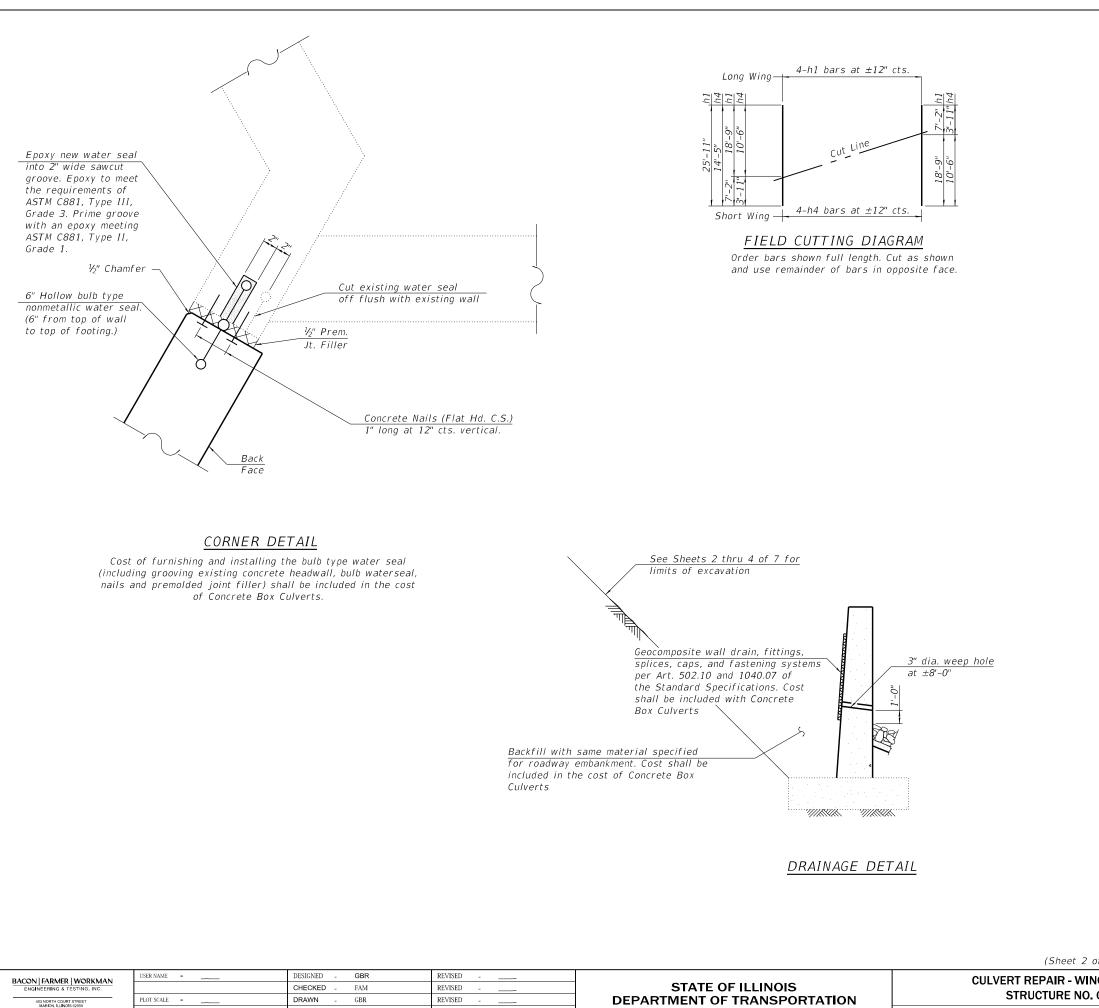

N	STRUCTURE		
	SHEET 7	OF 7	(

403 NORTH COURT STRE MARION, ILLINOIS 62959 PHONE - 618.997.9190

PLOT DATE =

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FAM

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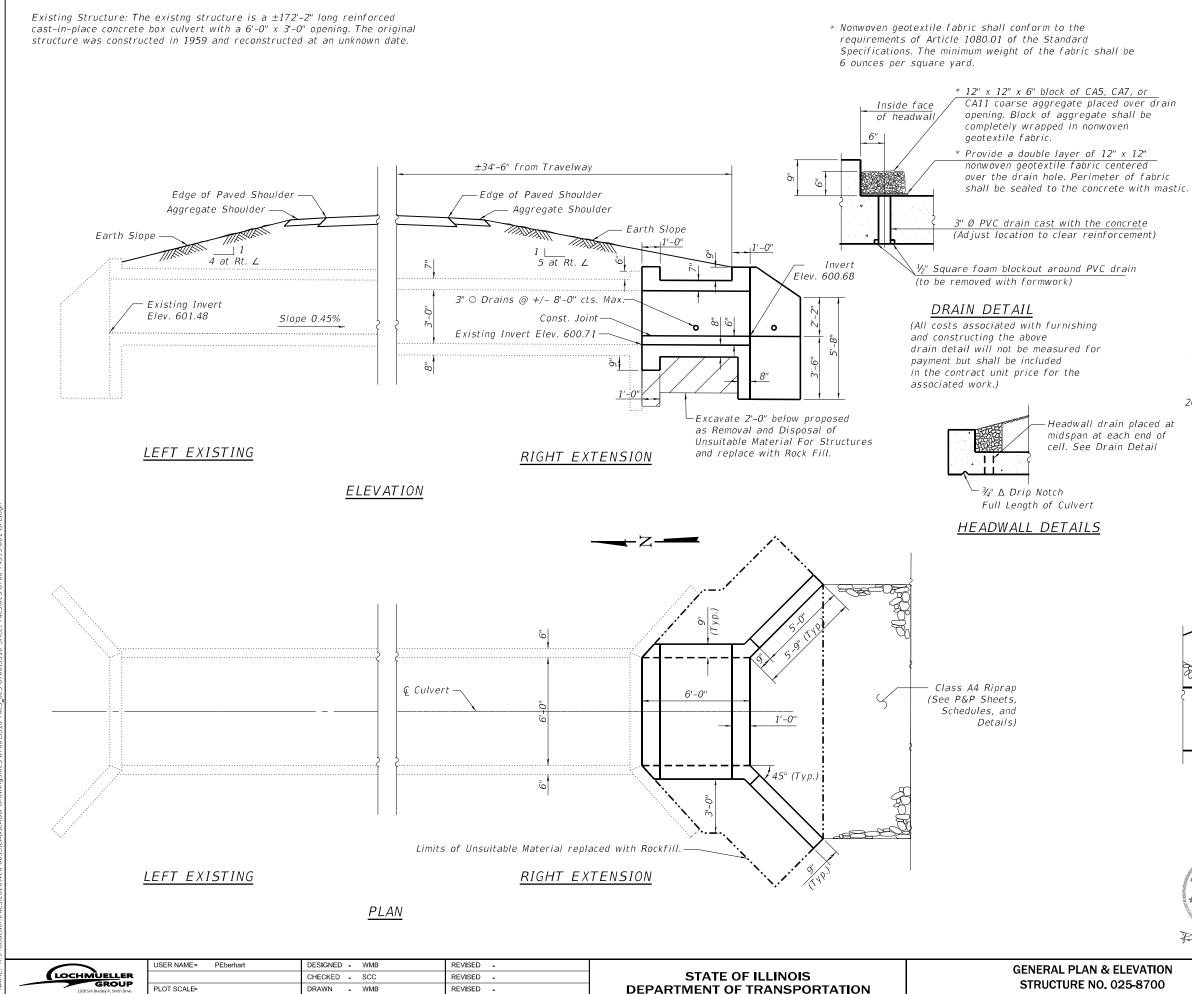
Bar	No.	Size	Length	Shape
h	20	#4	23'-2"	
h1	4	#4	25'-11"	
h2	2	#4	23'-11"	
h3	20	#4	12'-11"	
h4	4	#4	14'-5"	
h5	2	#4	14'-2"	
n(E)	68	#7	16'-0"	
V	44	#4	14'-10''	
v 1	24	#4	14'-10"	
v4	26	#4	14'-10"	
v5	14	#4	14'-10"	
		Culverts	Cu. Yd.	22.2
Reinfo	rcemen	t Bars	Pound	1720
Reinfo	rcemen	t Bars,	Pound	2230
Epoxy	Coated		, cana	2250

BILL OF MATERIAL

Note:

Order n(E), v, v1, v4, and v5 bars full length and cut to fit slope.

(Sheet 2 of 2)							
PAIR - WINGWALL DETAILS CTURE NO. 025-2006		SECTION			COUNTY	TOTAL SHEETS	SHEET NO.
		(25-4-1,25-5)R			EFFINGHAM	790	322
010112 NO: 020-2000					CONTRACT NO. 74599		
7 OF 7 SHEETS			ILLINOIS	FED. AID	PROJECT		



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PLOT DATE = 3/14/2022

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SHEET 1 OF 3 SHEETS

## GENERAL NOTES

Plan dimensions and details relative to the existing structure have been taken from existing plans and are subject to nominal construction variations. It shall be the Contractor's responsibility to verify such dimensions and details in the field and make necessary approved adjustments prior to construction or ordering of materials. Such variations shall not be cause for additional compensation for a change in the scope of work, however, the Contract will be paid for the quantity furnished at the unit price for the work. Expansion bolts shall be according to Standard Specification Article 1006.09.

Hydraulic information for the existing culvert is not available and a new hydraulic study was not performed. No impacts to the existing hydraulics are expected with the proposed scope of work.

## LIVE LOADING


HS20-44 and Alternate Military Vehicle design live load. Allow 50#/sq. ft. for future wearing surface on extension.


## DESIGN SPECIFICATIONS

2002 AASHTO Standard Specifications for Highway Bridges

## DESIGN STRESSES


- NEW CONSTRUCTION
- $f'c = 3,500 \ psi$ fy = 60,000 psi (Reinforcement) EXISTING CONSTRUCTION
- $f'c = 3,000 \ psi$
- fy = 40,000 psi (Reinforcement)

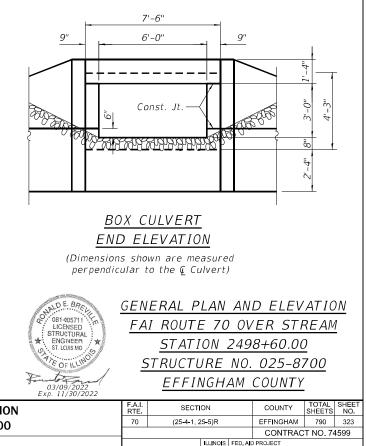

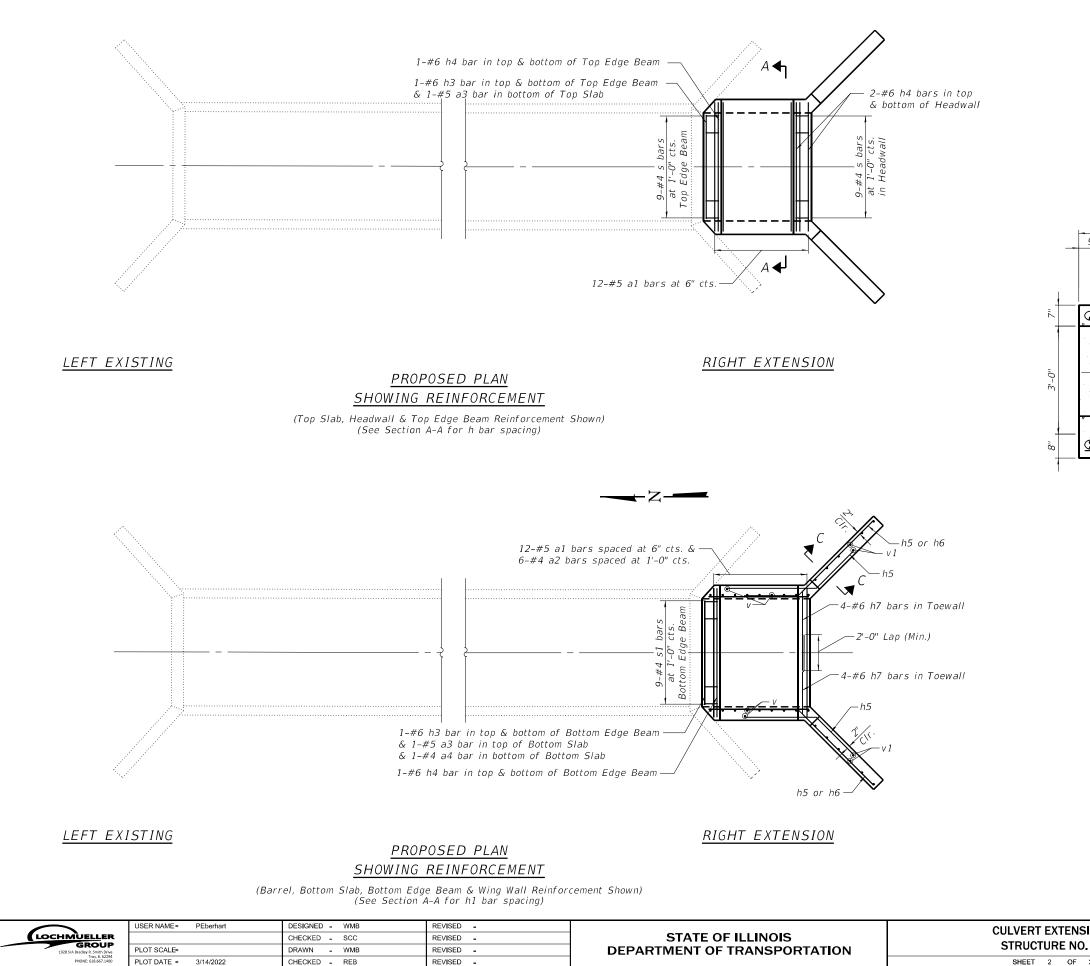

ê E 3/14/2022 3:11:41 PM SHEET 2 OF


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SECTION A-A

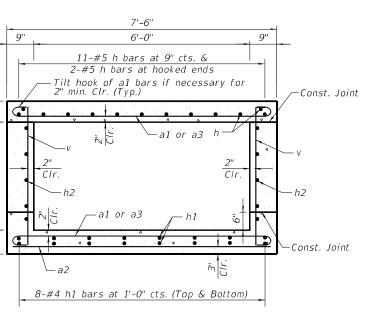Notes: For Section C-C see Sheet 3 of 3. For Elevation, Bar Bends and Bill of Materials, see Sheet 3 of 3.


ION DETAILS . 025-8700					COUNTY	TOTAL SHEETS	SHEET NO.
		(25-4-1, 25-5)R			EFFINGHAM	790	324
					CONTRAC	T NO. 74	1599
3 SHEETS			ILLINOIS	FED. AID	PROJECT		




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SHEET 3 OF

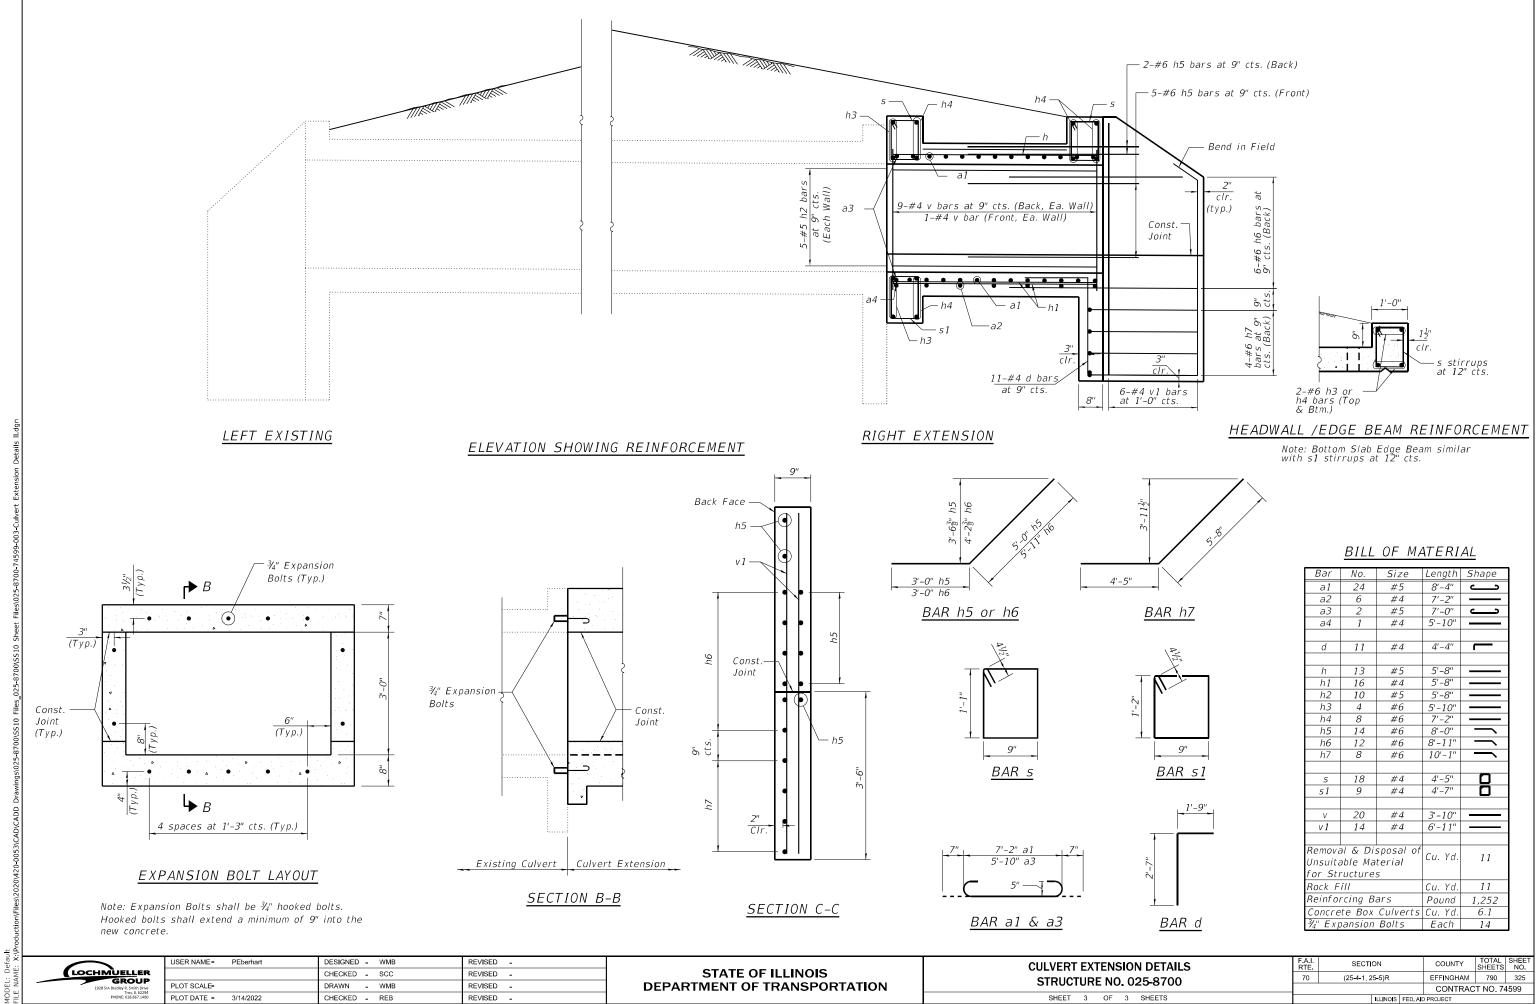ION DETAILS . 025-8700		SECTION			COUNTY	TOTAL SHEETS	SHEET NO.
		(25-4-1, 25-5)R			EFFINGHAM	790	325
					CONTRAC	T NO. 74	1599
3 SHEETS			ILLINOIS	FED. AL	PROJECT		



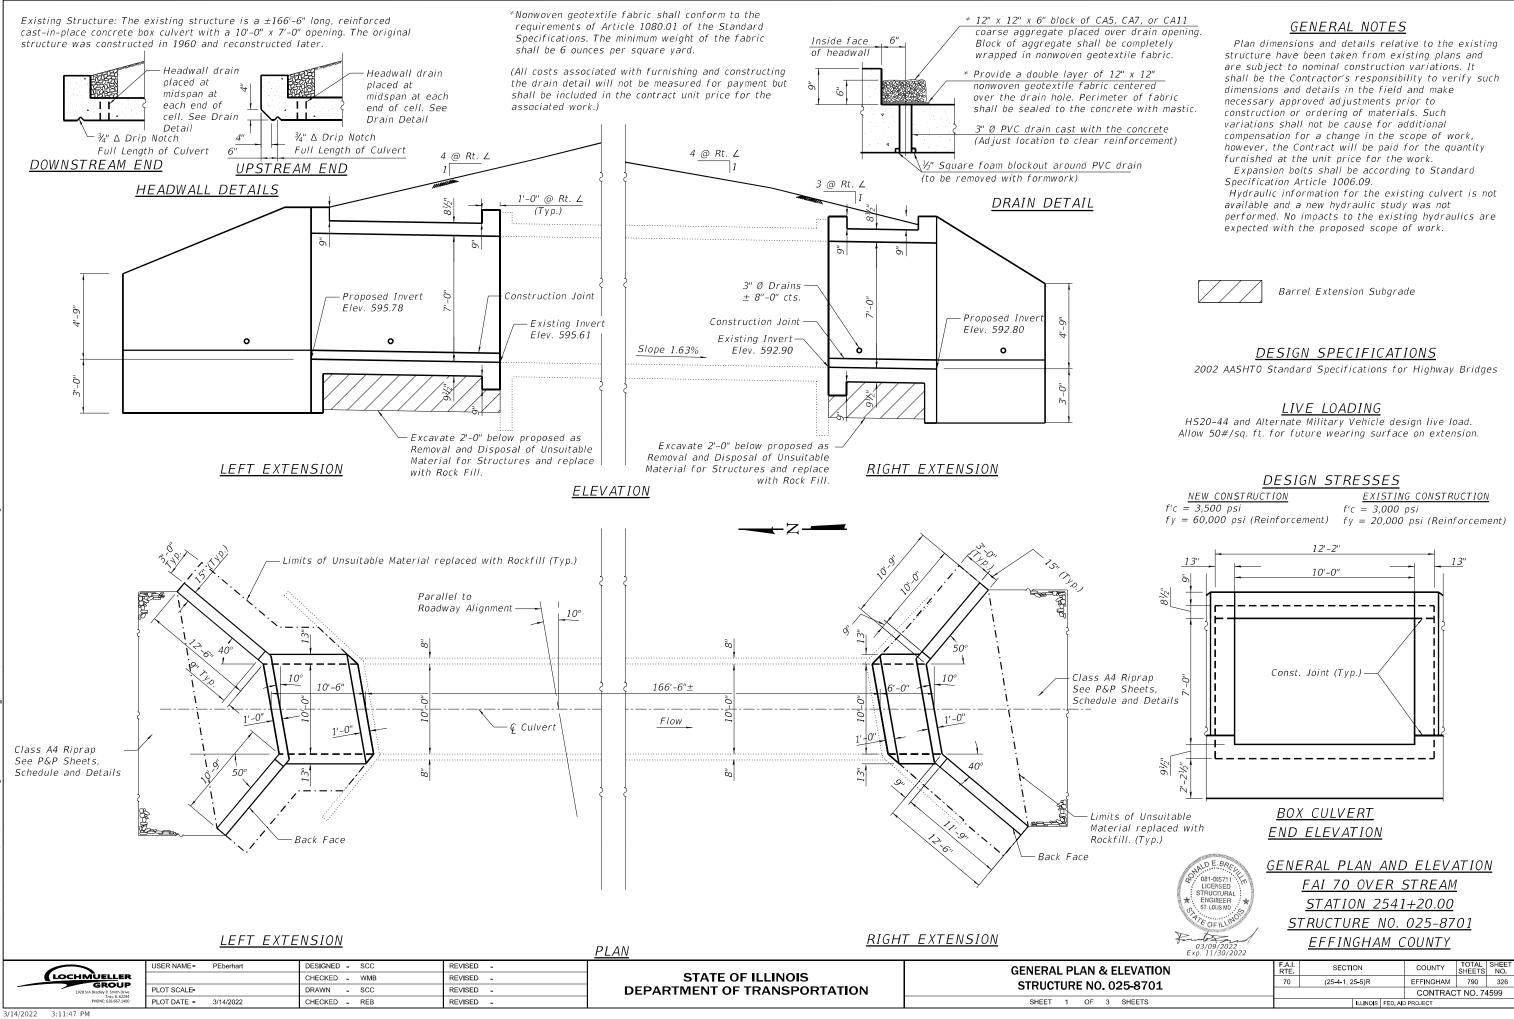


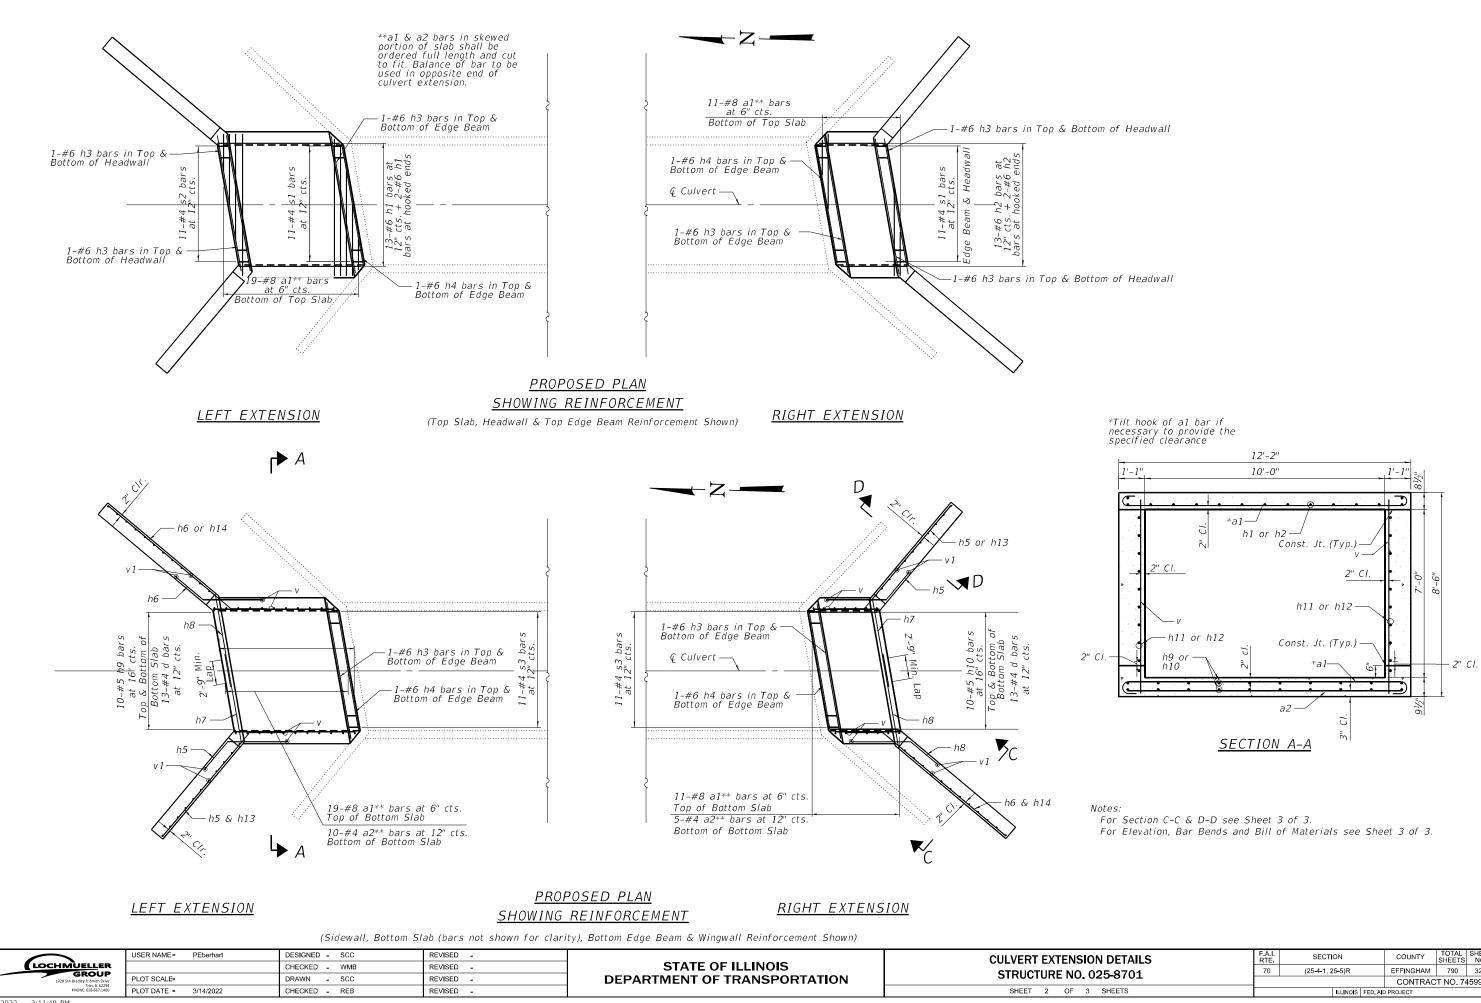

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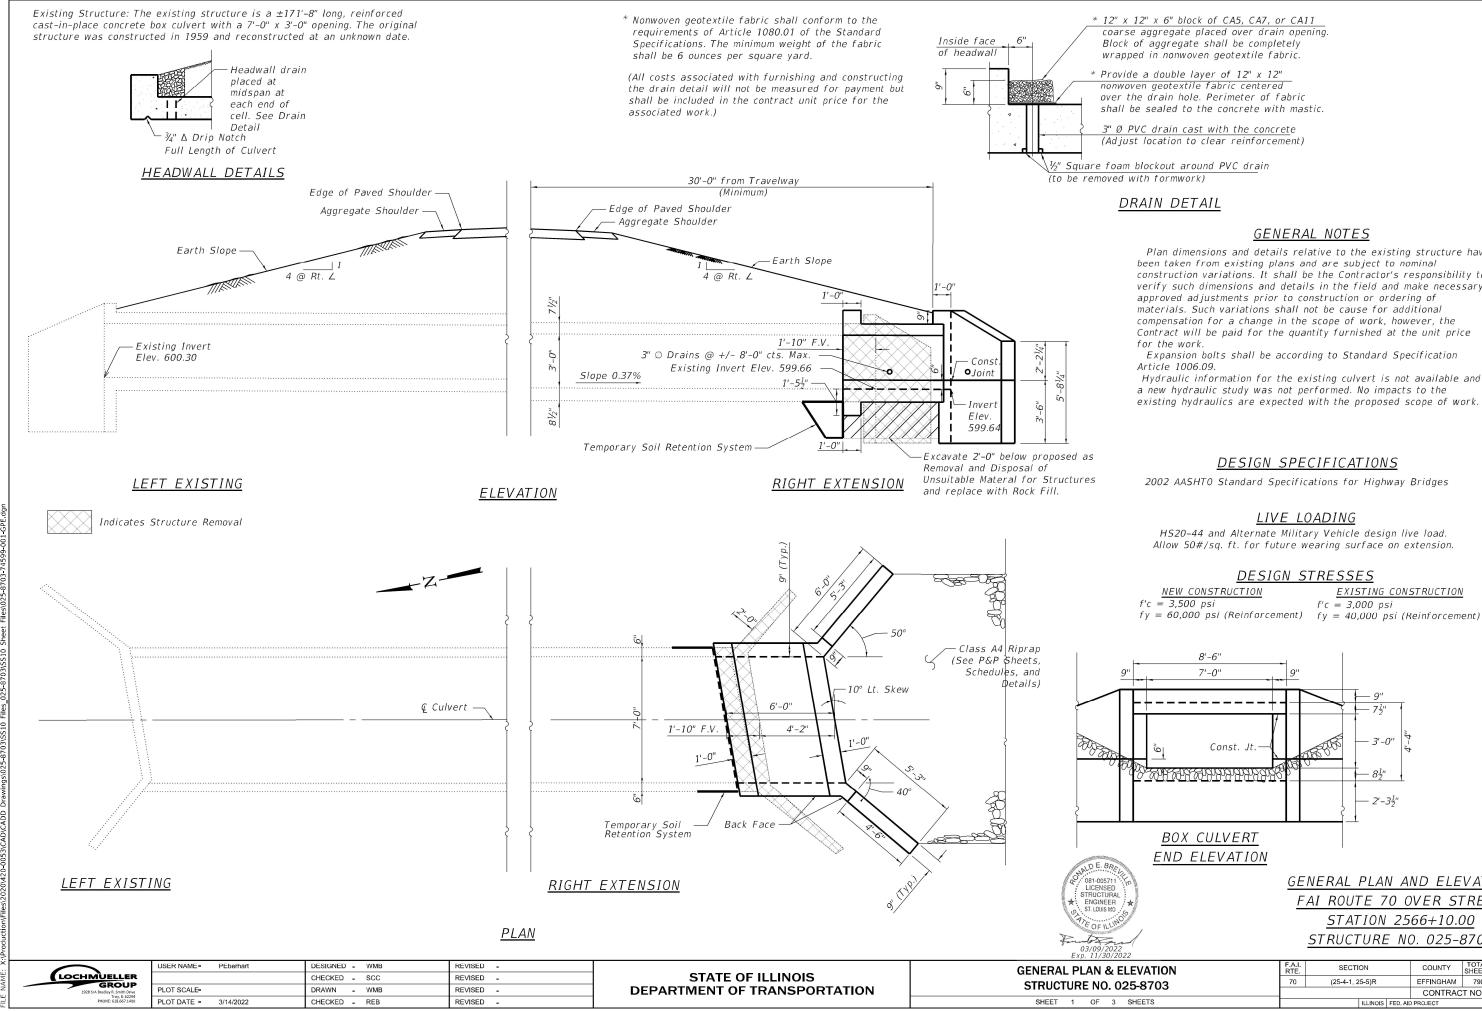
GION DETAILS 0. 025-8701		F.A.I. RTE SECTION			COUNTY	TOTAL SHEETS	SHEET NO.
		(25-4-1, 25-5)R		EFFINGHAM	790	327	
					CONTRAC	T NO. 74	4599
3 SHEETS			ILLINOIS	FED. ALC	PROJECT		



3/14/2022 3:11:51 PM

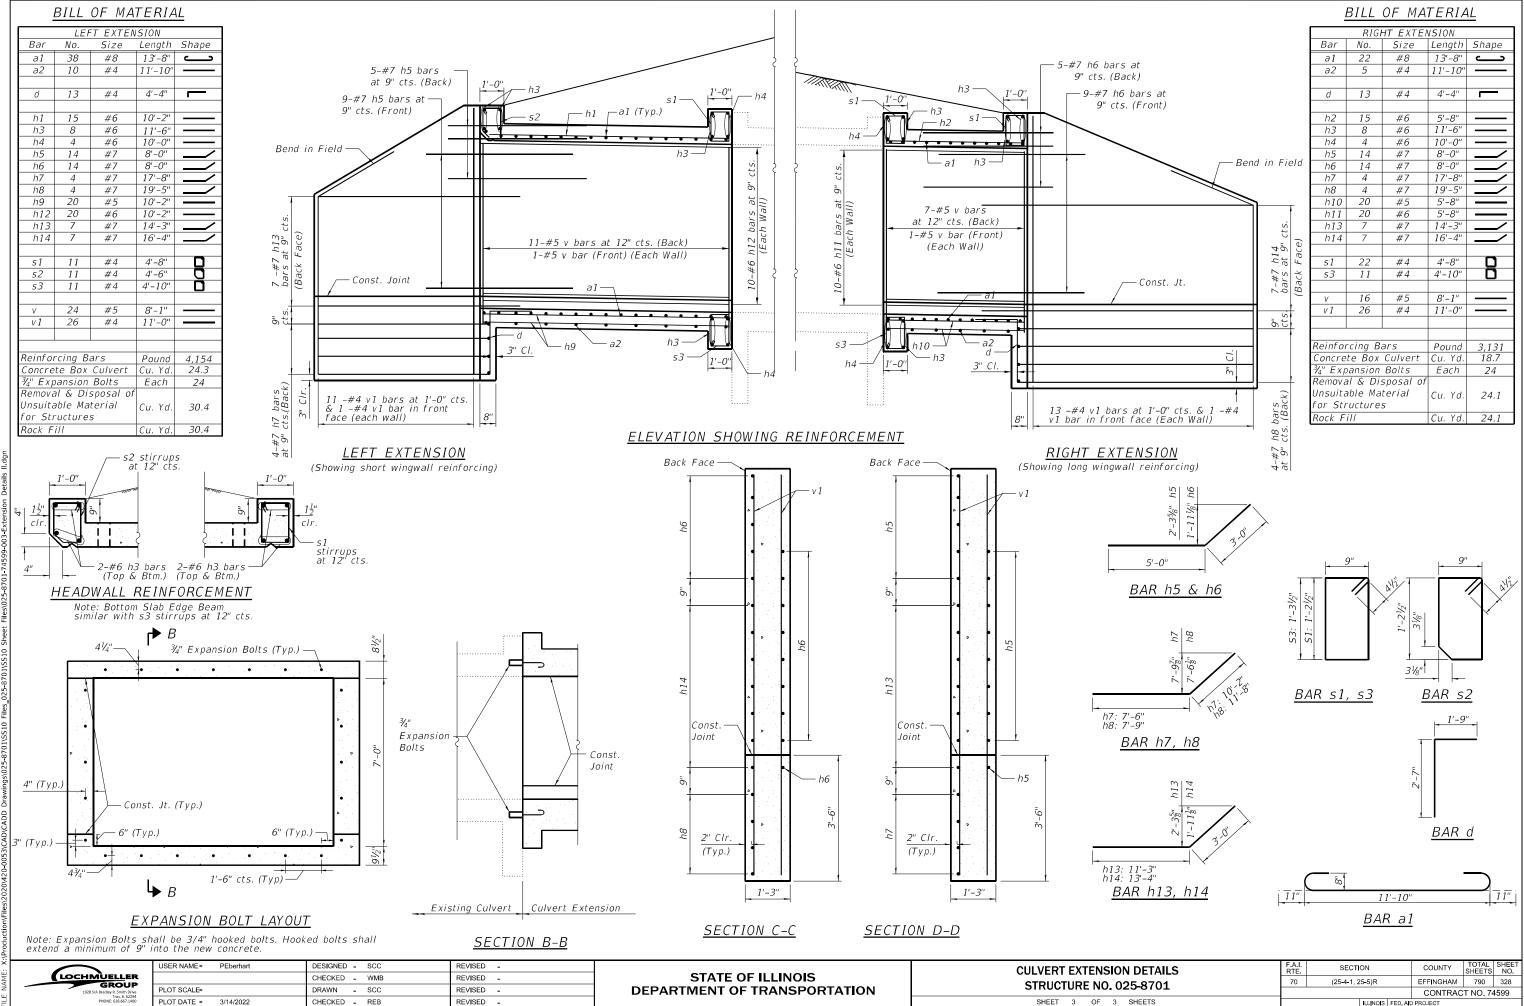ILLINOIS FED AID PROJECT

SHEET 3 OF 3 SHEETS



3/14/2022 3:11:55 PM

Plan dimensions and details relative to the existing structure have been taken from existing plans and are subject to nominal construction variations. It shall be the Contractor's responsibility to verify such dimensions and details in the field and make necessary approved adjustments prior to construction or ordering of materials. Such variations shall not be cause for additional compensation for a change in the scope of work, however, the Contract will be paid for the quantity furnished at the unit price

Expansion bolts shall be according to Standard Specification

Hydraulic information for the existing culvert is not available and a new hydraulic study was not performed. No impacts to the existing hydraulics are expected with the proposed scope of work.


2002 AASHTO Standard Specifications for Highway Bridges

Allow 50#/sq. ft. for future wearing surface on extension.

EXISTING CONSTRUCTION


GENERAL PLAN AND ELEVATION FAI ROUTE 70 OVER STREAM STATION 2566+10.00 STRUCTURE NO. 025-8703

)/2022							
& ELEVATION	F.A.I. RTE.	SECTI	ON		COUNTY	TOTAL SHEETS	SHEET NO.
. 025-8703		(25-4-1, 25-5)R			EFFINGHAM	790	329
					CONTRAC	T NO. 74	1599
3 SHEETS			ILLINOIS	FED. AID	PROJECT		

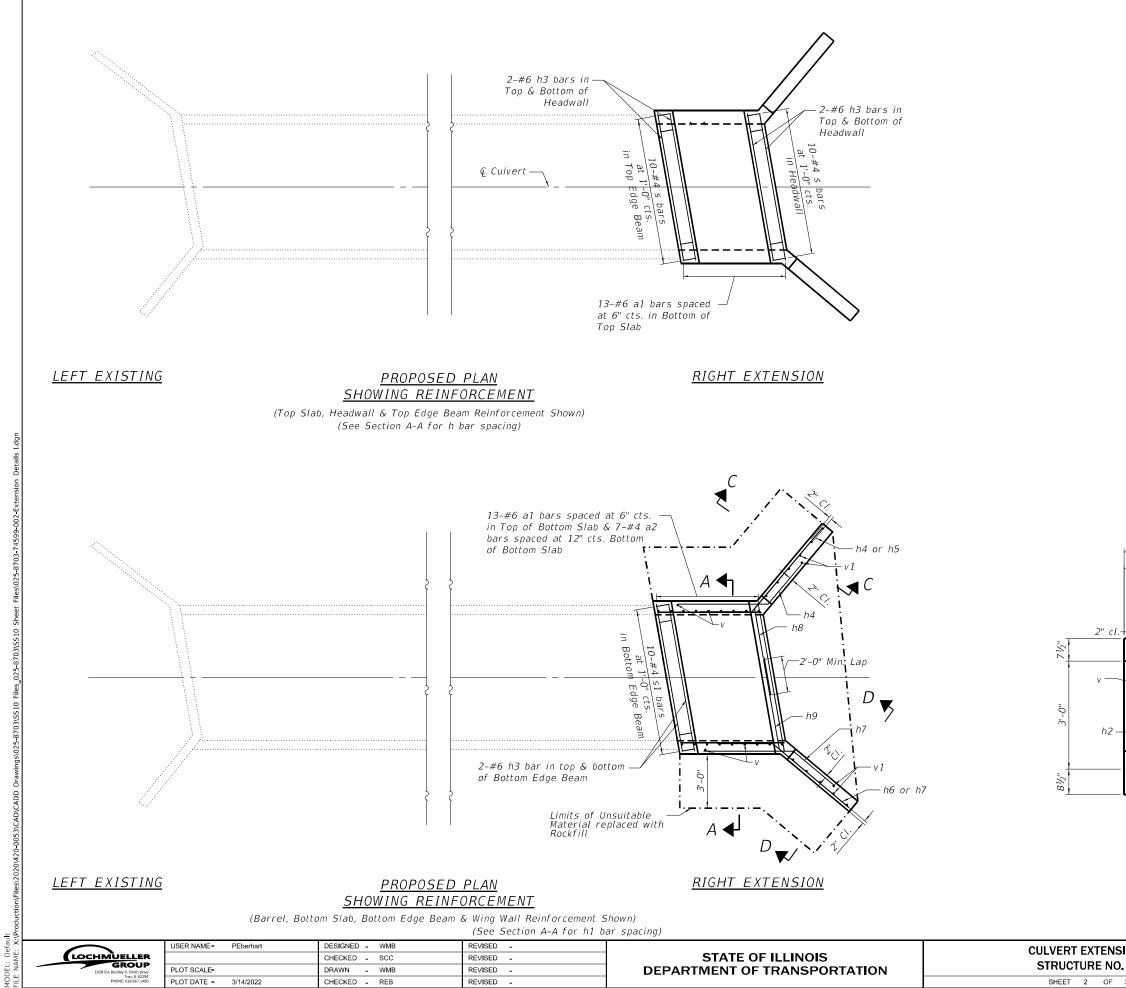

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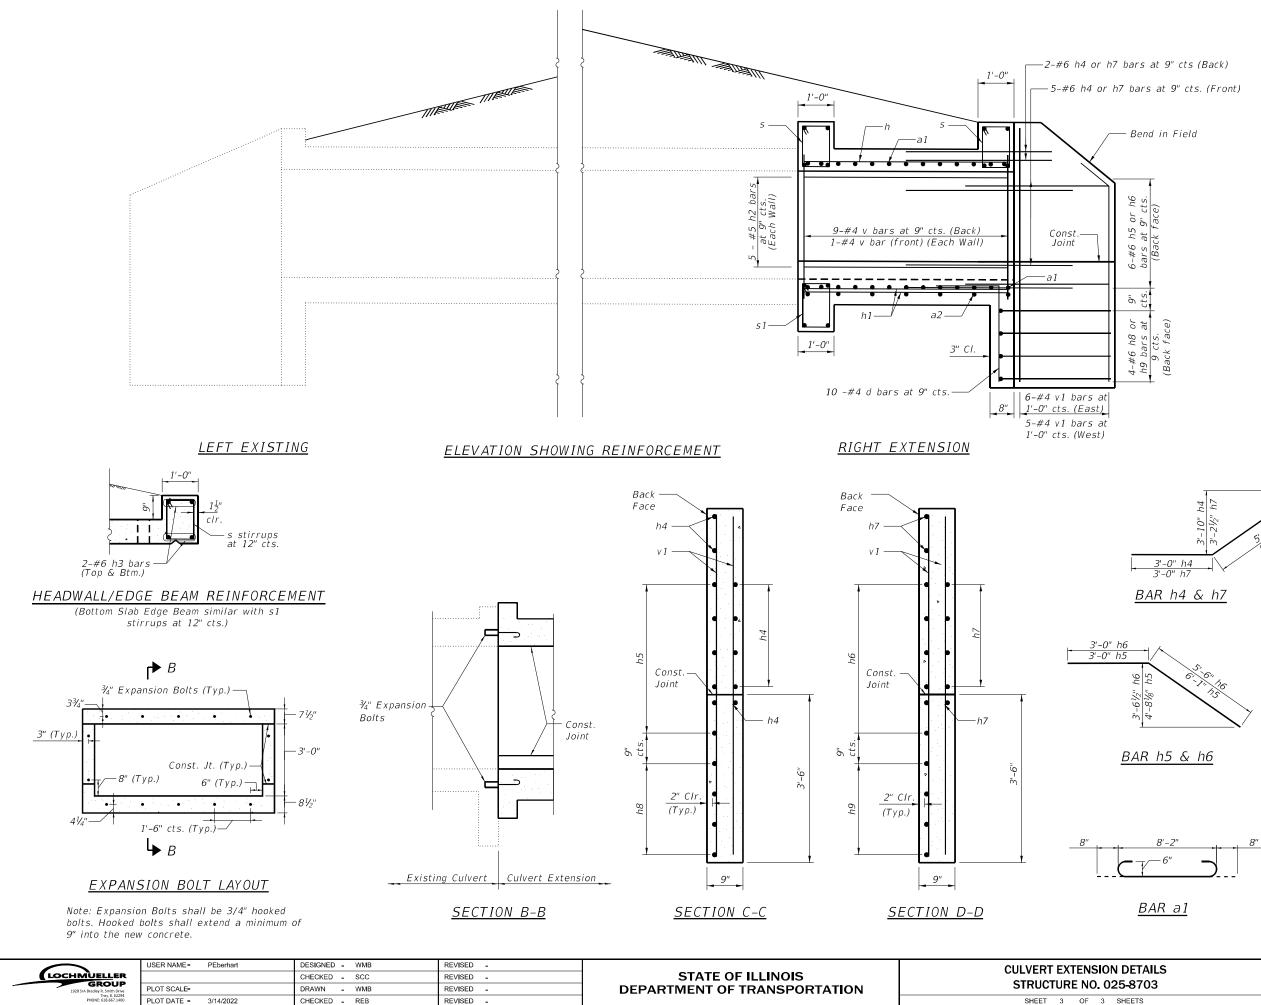
SHEET 2 OF

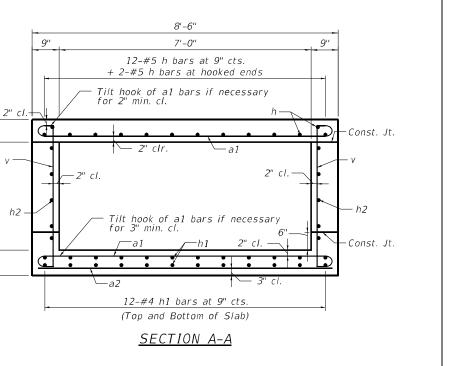

Notes:

For Section C-C & Section D-D see Sheet 3 of 3. For Elevation, Bar Bends and Bill of Materials see Sheet 3 of 3.

ION DETAILS		SECTION	COUNTY	TOTAL SHEETS	SHEET NO.	
. 025-8703		(25-4-1, 25-5)R	EFFINGHAM	790	330	
. 023-8703			CONTRAC	T NO. 74	1599	
3 SHEETS	ILLINOIS FED. AID PROJECT					



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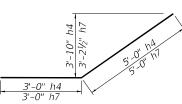
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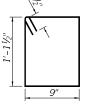
REVISED -

SHEET 3 OF 3

		<u>BILL</u>	OF MA	ATERI	<u>AL</u>
	Bar	No.	Size	Length	Shape
	a1	26	#6	9'-6"	Ĵ
' bars at 9" cts (Back)	a2	7	#4	8'-2"	
17 bars at 9" cts. (Front)	d	10	#4	4'-4''	_
	h	14	#5	5'-8"	
	h1	24	#4	5'-8"	
— Bend in Field	h2	10	#5	5'-8"	
	h3	12	#6	8'-2"	
	h4	7	#6	8'-0"	)
	h5	6	#6	9'-1"	
ł	h6	6	#6	8'-6"	ļ
2. Q	h7	7	#6	8'-0"	ļ
e c t	h8	4	#6	10'-10"	
6-#6 h5 or h6 bars at 9" cts. (Back face)	h9	4	#6	10'-0"	ĺ
A 15					
90	5	20	#4	4'-6"	
6-#6 bars , (Bac	s1	10	#4	4'-8"	
P 0					
•	V	20	#4	3'-11"	
= vit	v 1	13	#4	6'-11"	
<u>ets</u>					
			sposal of	Cu. Yd.	12
3 or ace)	Unsuita	able Ma	terial		12
fest stars					
$\frac{2}{2}$	Rock F			Cu. Yd.	12
4-#6 h8 or h9 bars at 9 cts. (Back face)		rcing B	Pound	1,474	
<u> </u>		te Box	Cu. Yd.	6.7	
		oansion		Each	14
		te Rem		Cu. Yd.	3.1
		Soil Rei 1 & Qua		SFT	33












13


-21/2


ION DETAILS		I. SECTION		COUNTY	TOTAL SHEETS	SHEET NO.	
025-8703		(25-4-1, 25-5)R			EFFINGHAM	790	331
025-8703					CONTRAC	T NO. 74	1599
3 SHEETS			ILLINOIS	FED. AIC	PROJECT		

1'-9"


<u>BAR d</u>

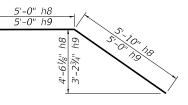

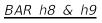

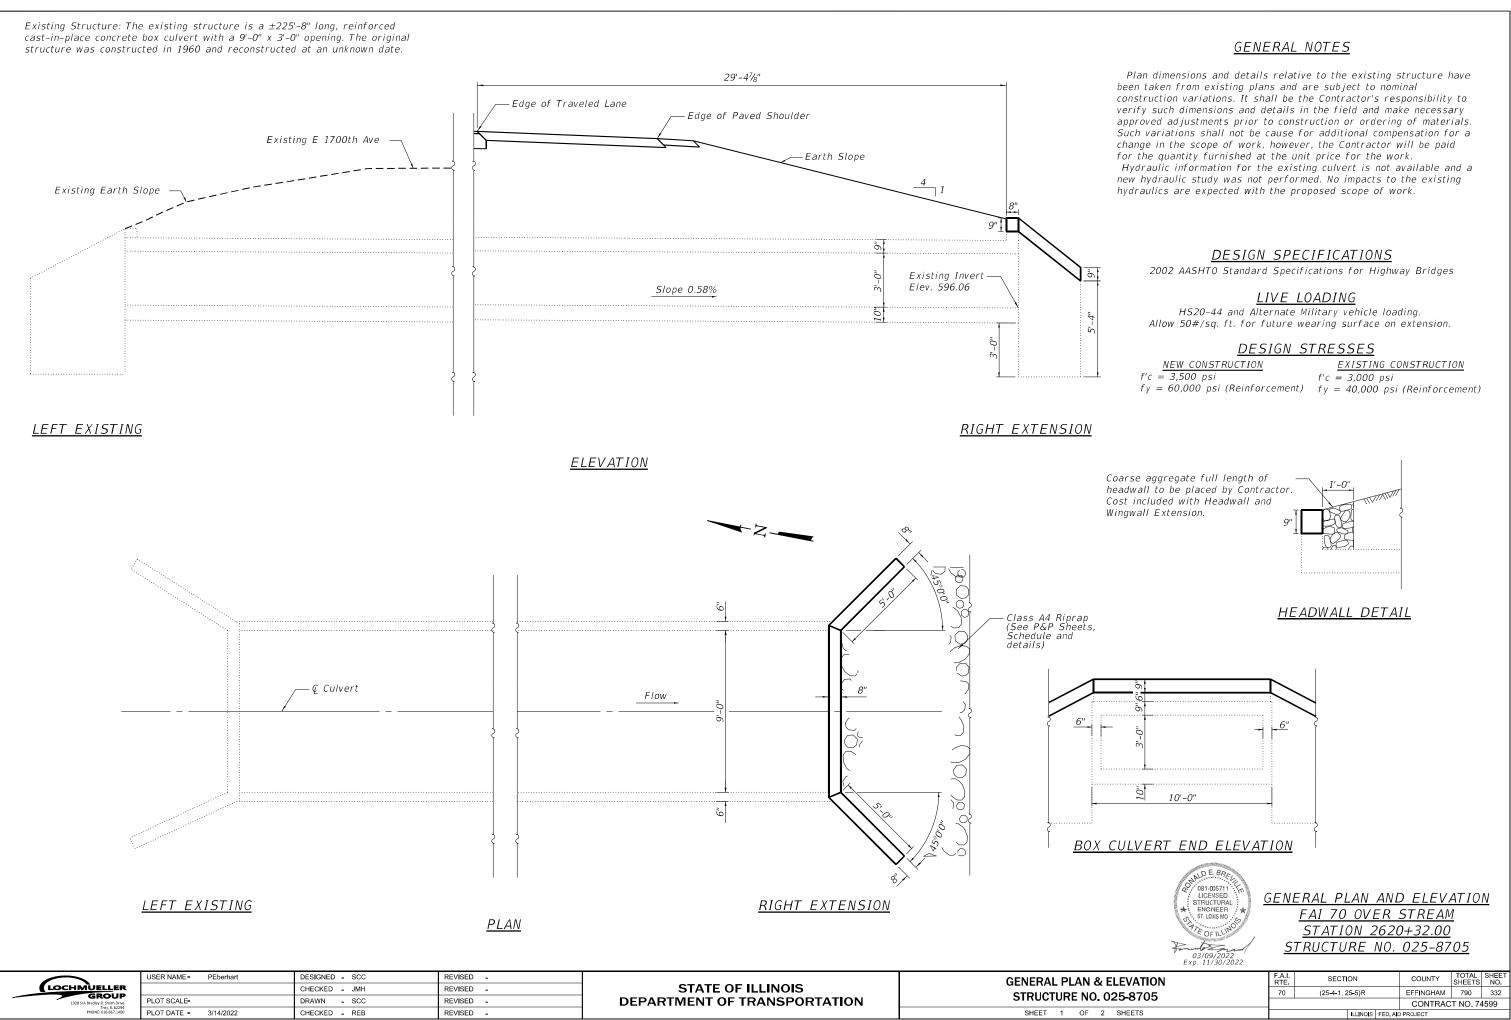

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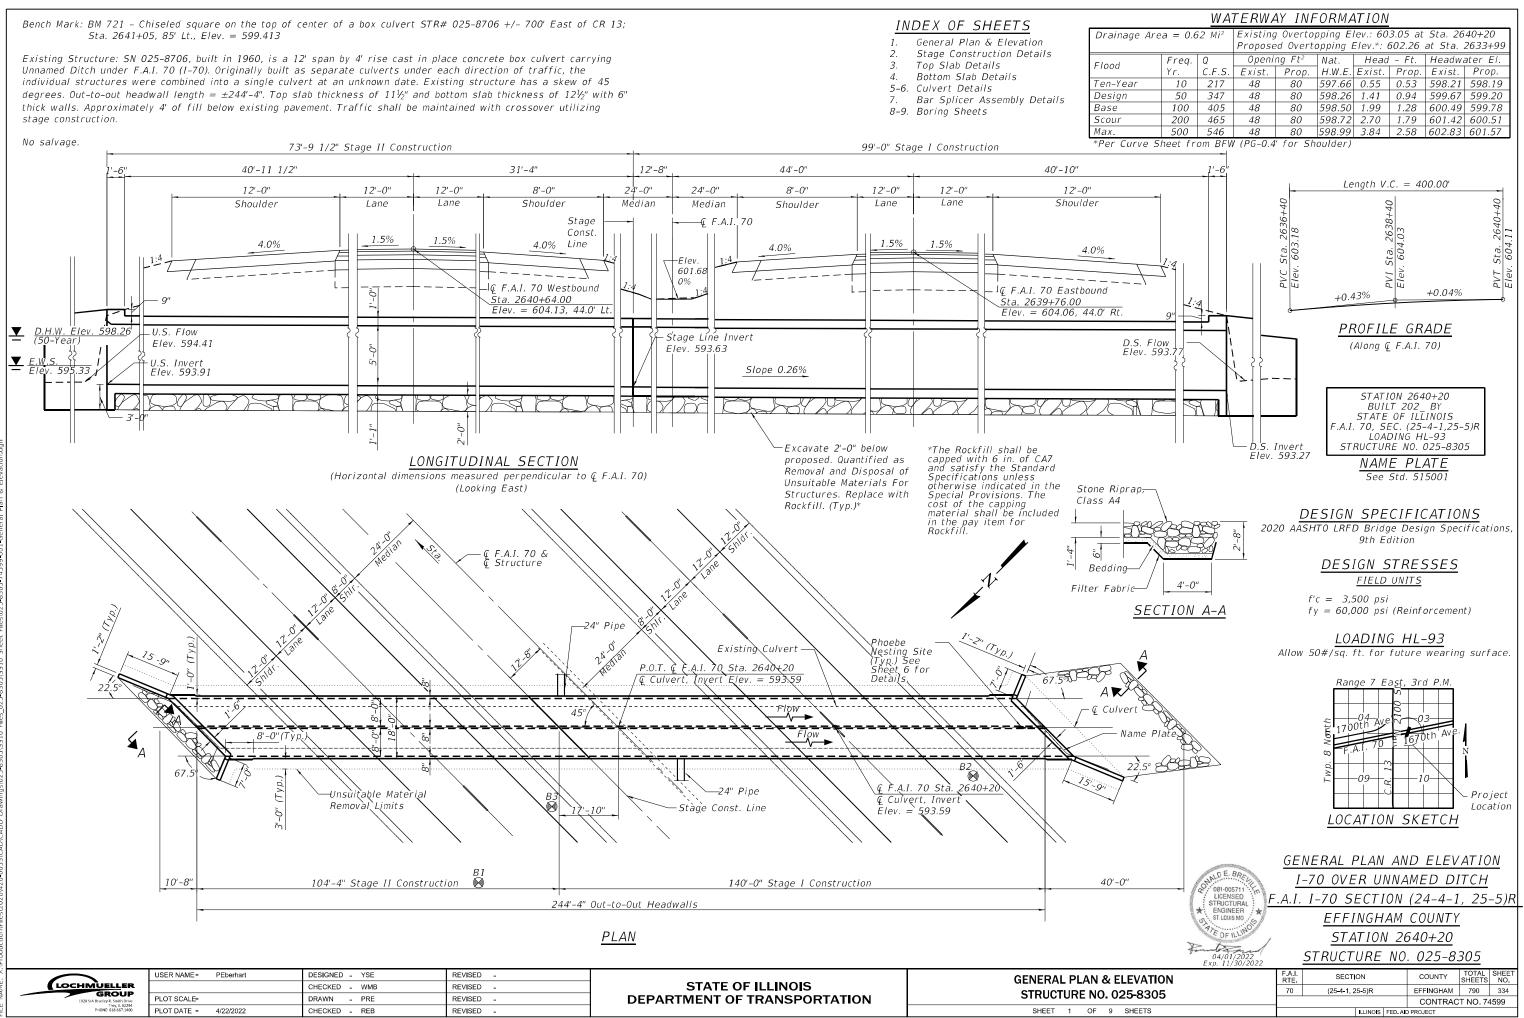
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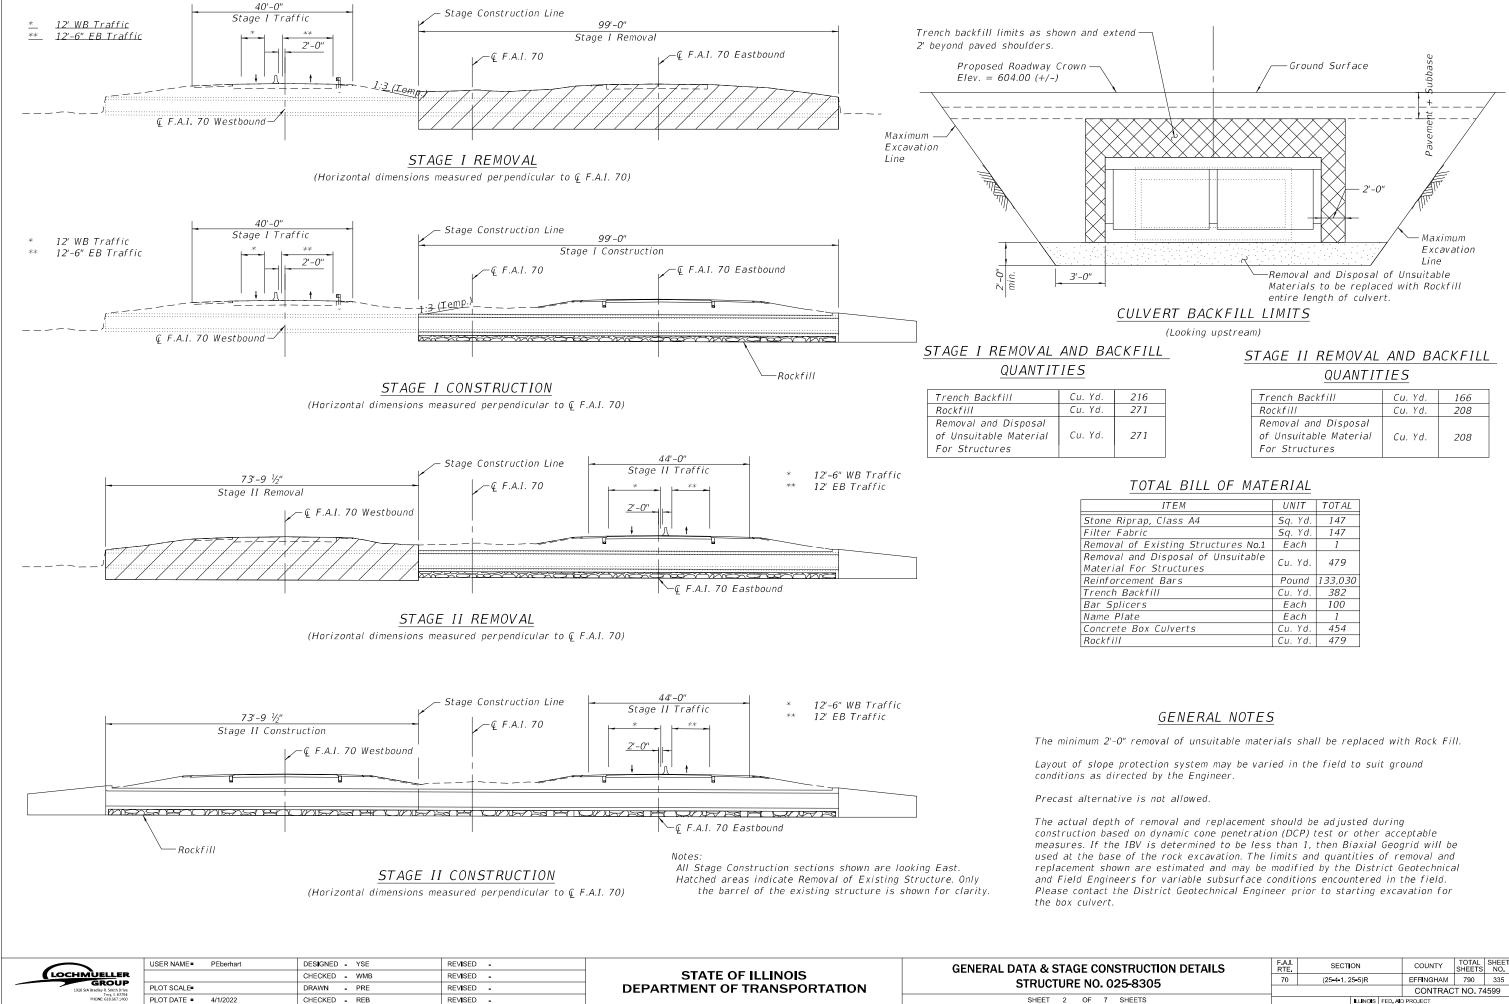
# BILL OF MATERIAL

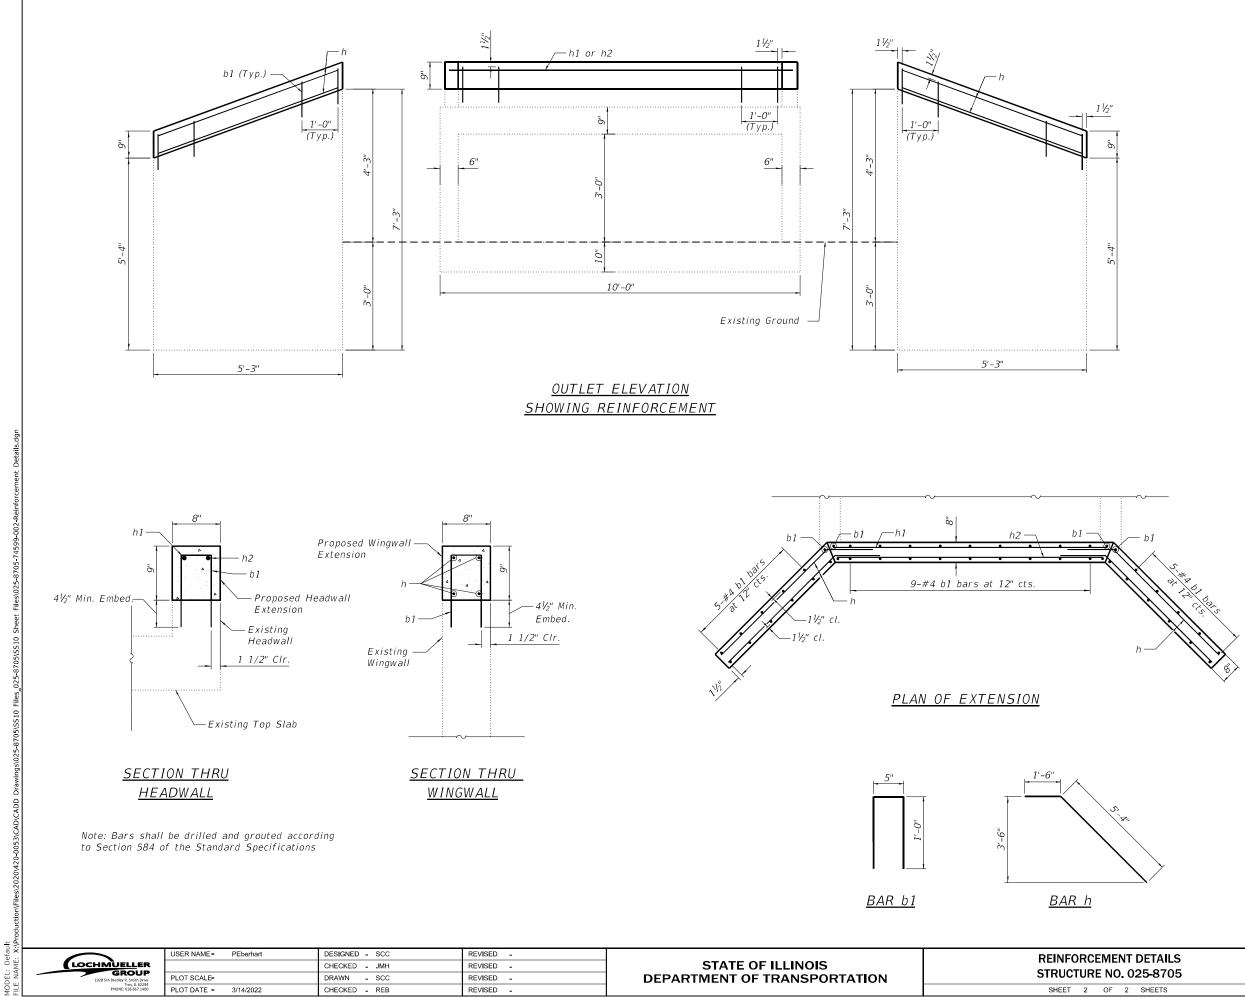DILL OF MATLINIAL								
Bar	No.	Size	Length	Shape				
b1	23	#4	2'-5"	Π				
h	8	#4	6'-10"	/				
h1	1	#6	9'-2"					
h2	1	#6	8'-10"					
Reinfo	rcing B	Pound	103					
Concre	te Stru	ctures	Cu. Yd.	0.4				

IT DETAILS		SECTION	COUNTY	TOTAL SHEETS	SHEET NO.	
025-8705		(25-4-1, 25-5)R	EFFINGHAM	790	333	
023-8703			CONTRAC	T NO. 74	4599	
2 SHEETS	ILLINOIS FED. AID PROJECT					



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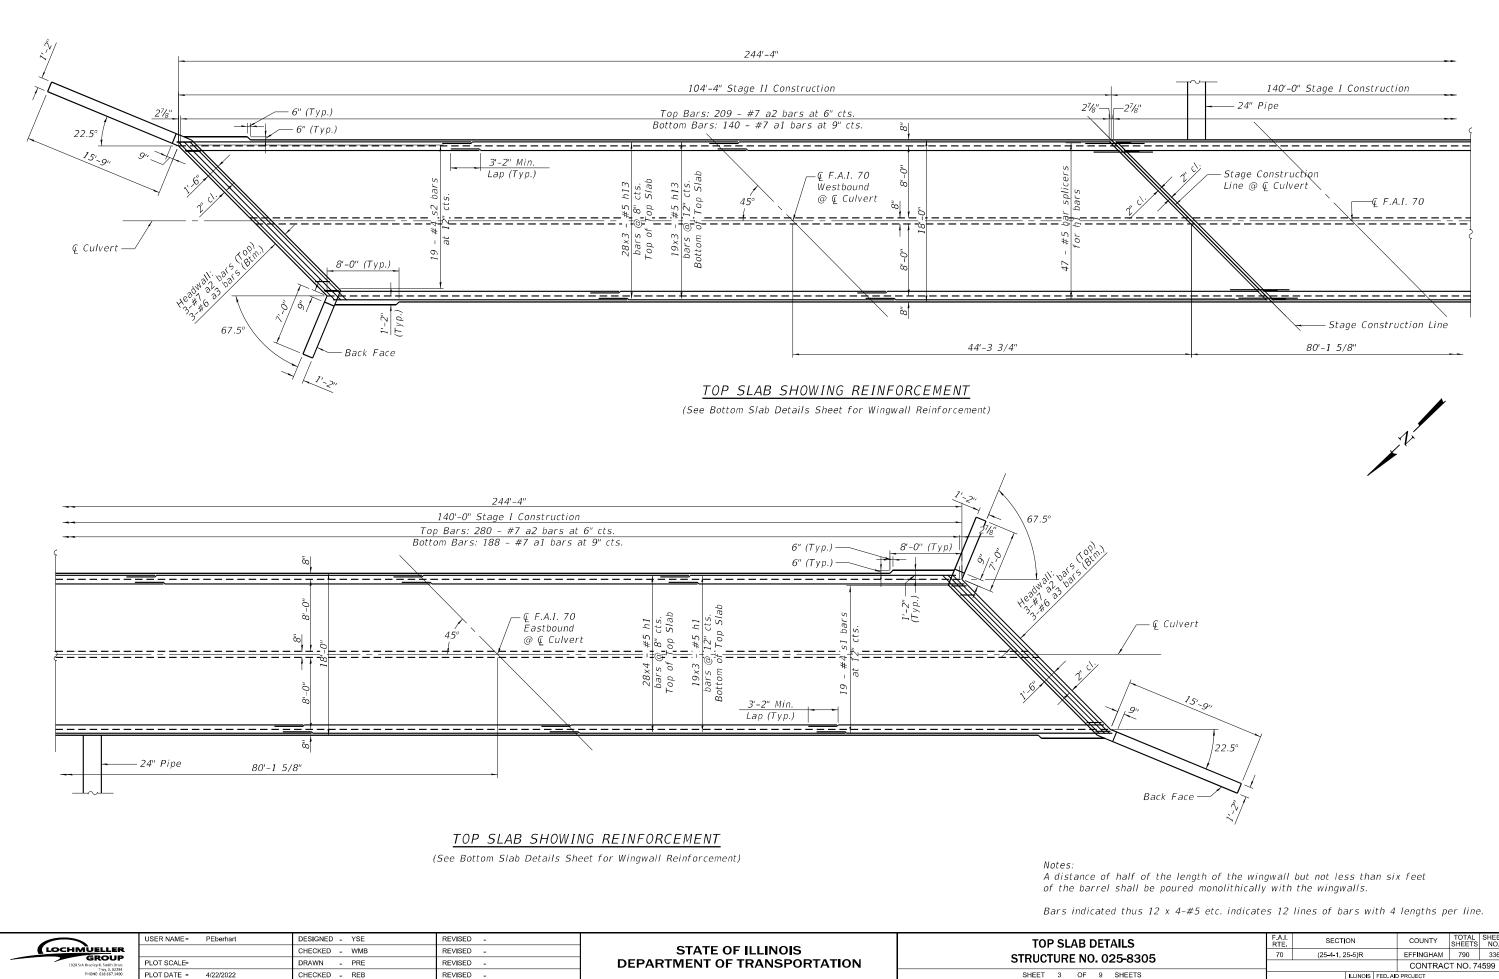


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	-			
216		Trench Backfill	Cu. Yd.	166
271		Rockfill	Cu. Yd.	208
271		Removal and Disposal of Unsuitable Material For Structures	Cu. Yd.	208

ITEM	UNIT	TOTAL
ne Riprap, Class A4	Sq. Yd.	147
er Fabric	Sq. Yd.	147
noval of Existing Structures No.1	Each	1
oval and Disposal of Unsuitable erial For Structures	Cu. Yd.	479
nforcement Bars	Pound	133,030
nch Backfill	Cu. Yd.	382
Splicers	Each	100
ne Plate	Each	1
crete Box Culverts	Cu. Yd.	454
kfill	Cu. Yd.	479


ONSTRUCTION DETAILS		A.I. SECTION			COUNTY	TOTAL SHEETS	SHEET NO.
025-8305		(25-4-1, 25-5)R			EFFINGHAM	790	335
. 025-8505				CONTRAC	T NO. 74	1599	
7 SHEETS	LLINOIS FED			FED, ALC	PROJECT		



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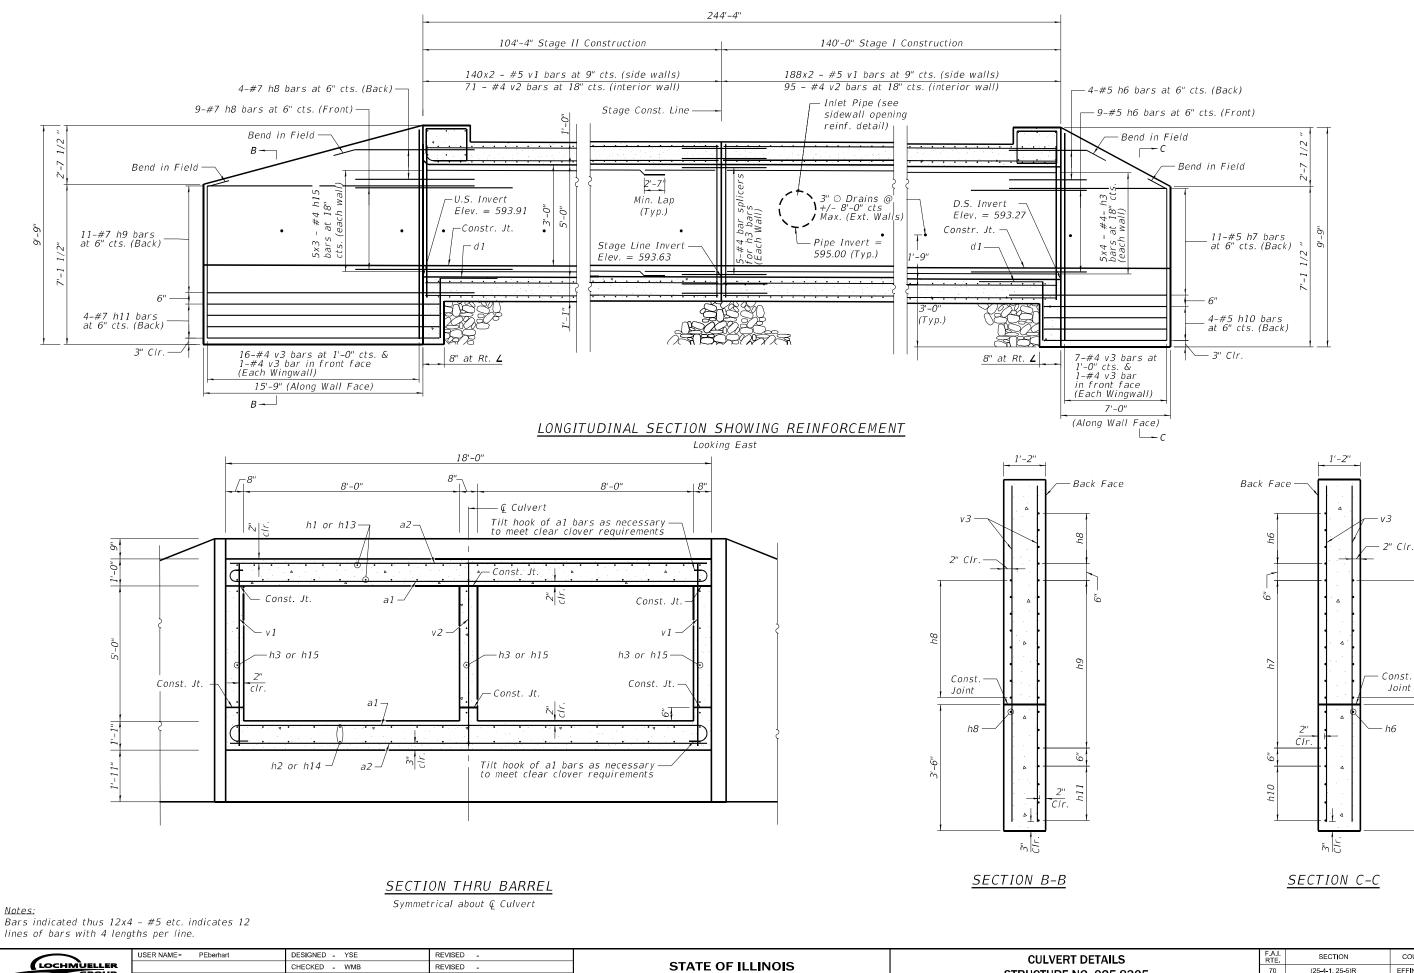
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PETAILS		A.I. SECTION			COUNTY	TOTAL SHEETS	SHEET NO.
. 025-8305			EFFINGHAM	790	336		
. 023-8303			CONTRAC	T NO. 74	1599		
9 SHEETS			ILLINOIS	FED. AI	PROJECT		



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B DETAILS	F.A.I. RTE	SECT	ON		COUNTY	TOTAL SHEETS	SHEET NO.	
025-8305		(25-4-1, 2	5-5)R		EFFINGHAM	790	337	
023-0303					CONTRACT NO. 74599			
9 SHEETS			ILLINOIS	FED. AI	FED. AID PROJECT			

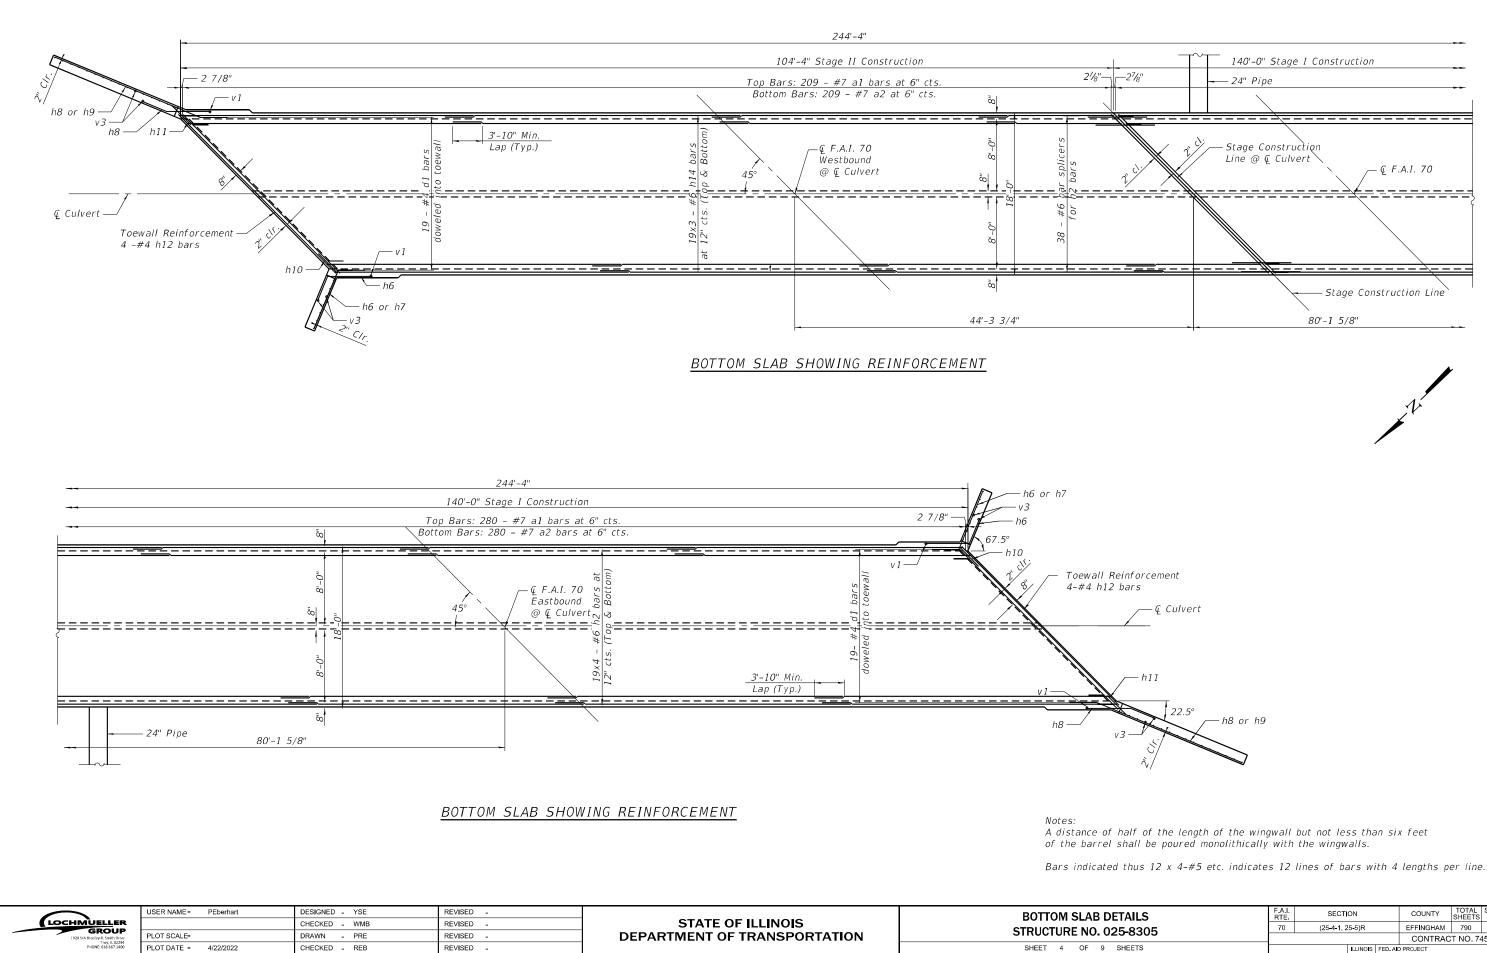

**DEPARTMENT OF TRANSPORTATION** 

Troy, IL 62294 PHONE: 618.667.1400

PLOT SCALE=

PLOT DATE = 4/22/2022

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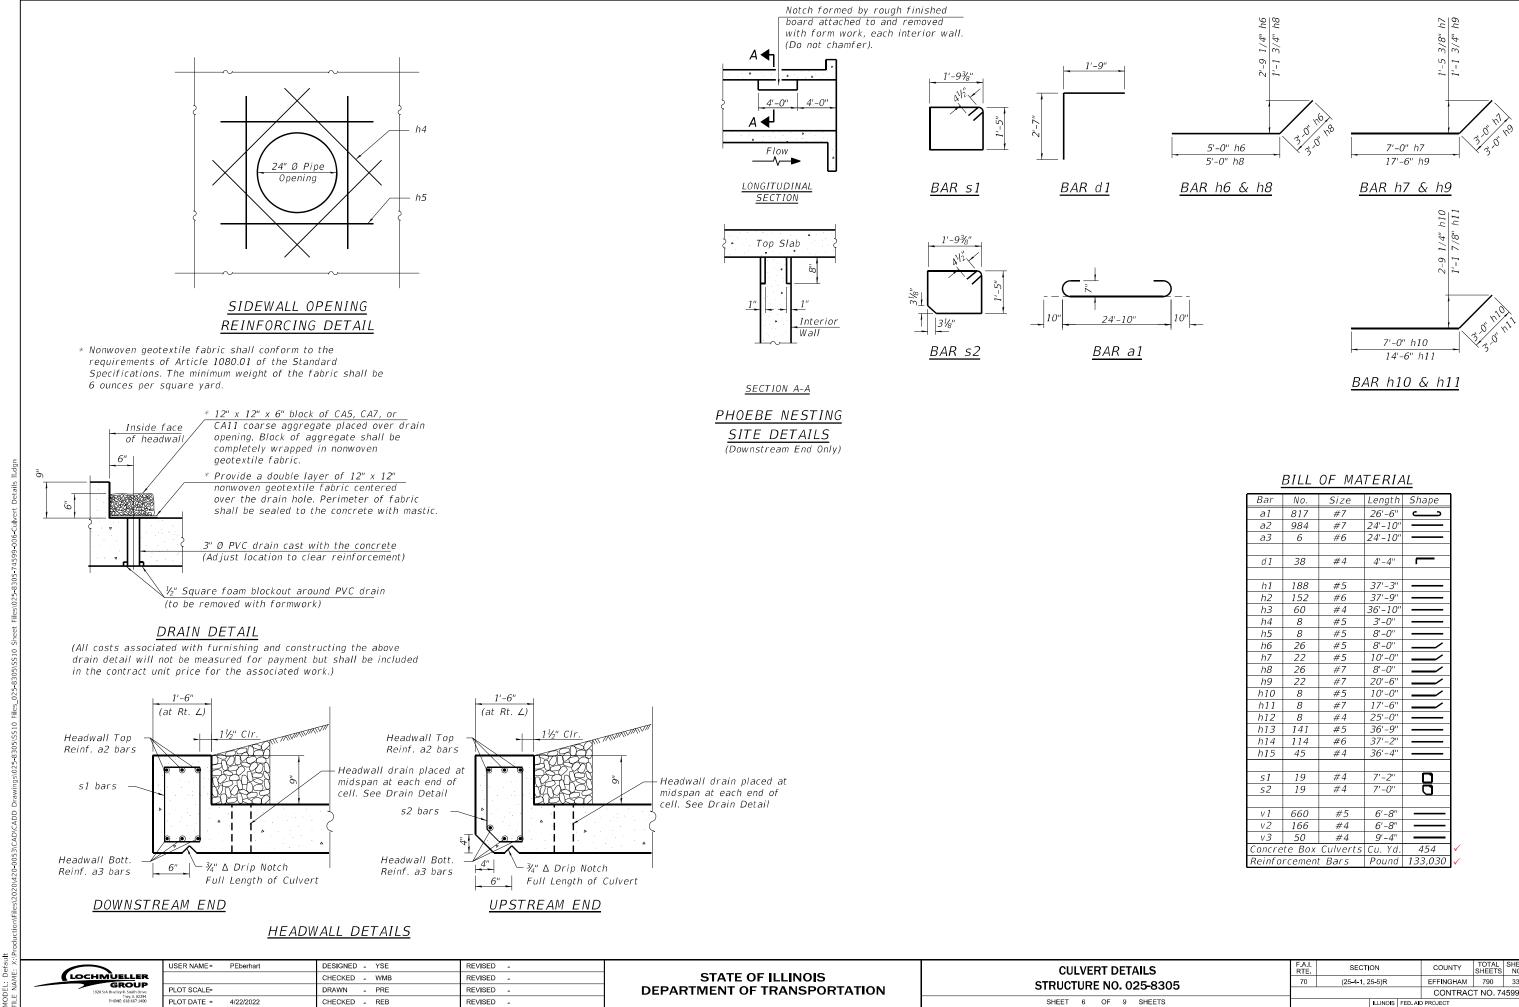
ETAILS	F.A.I. RTE	SECT	ON		COUNTY	TOTAL SHEETS	SHEET NO.	
025-8305		(25-4-1, 25-5)R			EFFINGHAM	790	338	
. 025-8505					CONTRACT NO. 74599			
9 SHEETS	ILLINOIS F				ED. AID PROJECT			

- v3

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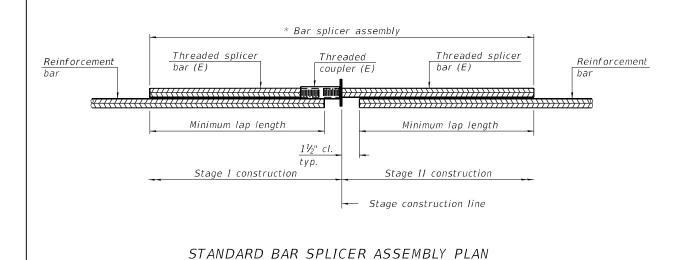
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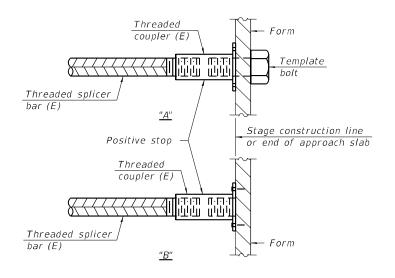
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4/22/2022 11:56:41 AM

ETAILS	F.A.I. RTE	SECT	ON		COUNTY	TOTAL SHEETS	SHEET NO.	
. 025-8305		(25-4-1, 2	5-5)R		EFFINGHAM	790	339	
. 025-0505					CONTRACT NO. 74599			
9 SHEETS			ILLINOIS	FED. AIC	PROJECT			





#### INSTALLATION AND SETTING METHODS

- "A" : Set bar splicer assembly by means of a template bolt.
- "B" : Set bar splicer assembly by nailing to wood forms or cementing to steel forms.

(E) : Indicates epoxy coating.

Threaded splicer bar length = min. lap length +  $1\frac{1}{2}$ " + thread length

\* Epoxy not required on Bar Splicer Assembly components used in conjunction with black bars.


(All components shall be provided from one supplier)

Location	Bar	No. assemblies	Minimum
LOCATION	size	required	lap length
Sidewall at Stage Line	#4	15	5'-5"
Top Slab at Stage Line	#5	47	6'-7"
Bottom Slab at Stage Line	#6	38	7'-11"



1-1-2020

<u><u></u><u></u><u></u><u></u><u></u><u></u><u></u><u></u><u></u><u></u><u></u><u></u><u></u><u></u><u></u><u></u><u></u><u></u><u></u></u>	-1	1-1-2020								
efau		USER NAME = PEberhart	DESIGNED - YSE	REVISED -		BAR SPLICER ASSEMBLY AND MECHANICAL SPLICER DETAILS	F.A.I. RTE	SECTION	COUNTY	TOTAL SHEET SHEETS NO.
AME	GROUP		CHECKED - WMB	REVISED -	STATE OF ILLINOIS	STRUCTURE NO. 025-8305	70	(25-4-1, 25-5)R	EFFINGHAM	790 340
DEL		PLOT SCALE=	DRAWN - PRE	REVISED -	DEPARTMENT OF TRANSPORTATION	STRUCTURE NO. 025-8505			CONTRAC	CT NO. 74599
HLE MO	Troy, IL 62294 PHONE: 618.667.1400	PLOT DATE = 4/22/2022	CHECKED - REB	CHECKED - REB REVISED -		SHEET 7 OF 9 SHEETS		ILLINOIS	FED. AID PROJECT	
ΣEL		FEOT DATE - 4/22/2022	CHECKED - KEB	REVISED -		SHEET 7 OF 5 SHEETS	<u>ــــــــــــــــــــــــــــــــــــ</u>	ILLINOIS	FED. AID PROJECT	

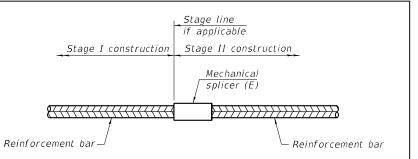

#### STANDARD MECHANICAL SPLICER


Location	Bar	No. assemblies
LUCATION	size	required


Notes:

Splicer bars shall be deformed with threaded ends and have a minimum 60 ksi yield strength.

All reinforcement shall be lapped and tied to the splicer bars. Bar splicer assemblies shall be epoxy coated according to the requirements for reinforcement bars. See Section 508 of the Standard Specifications.

See approved list of bar splicer assemblies and mechanical splicers for alternatives.

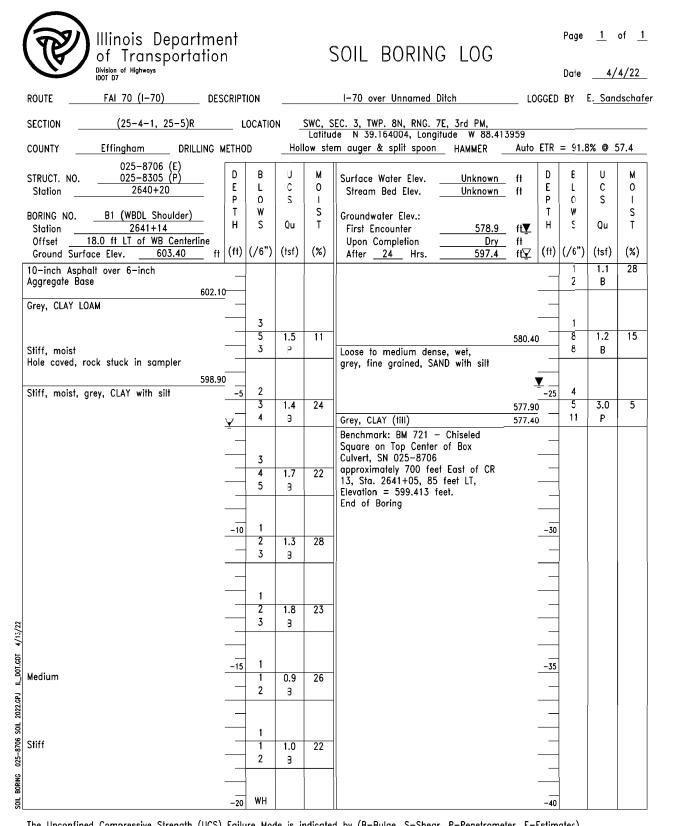

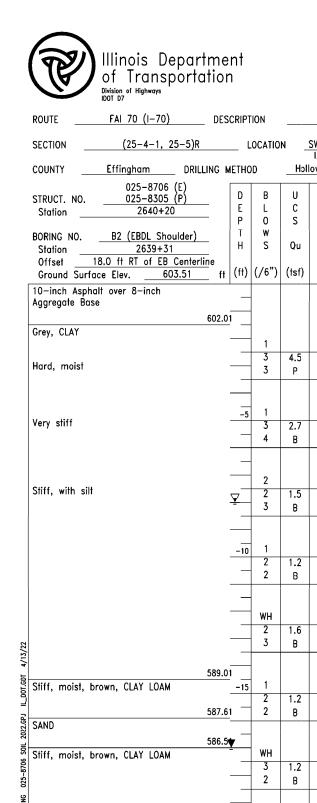

The Unconfined Compressive Strength (UCS) Failure Mode is indicated by (B-Bulge, S-Shear, P-Penetrometer, E-Estimatec) The SPT (N value) is the sum of the last two blow values in each sampling zone (AASHTO T206), WH-Weight of Hammer, NT-Not Tested.

BBS, form 137 (Rev. 8-99)

The Unconfined Compressive Strength (UCS) Failure Mode is indicated by (B-Bulge, S-Shear, P-Penetrometer, E-Estimated) The SPT (N value) is the sum of the last two blow values in each sampling zone (AASHTO T206), WH-Weight of Hammer, NT-Not Tested.

 USER NAME •
 PEberhart
 DESIGNED - YSE
 REVISED 

 CHECKED WMB
 REVISED STATE OF ILLINOIS

 PLOT SCALE •
 DRAWN - PRE
 REVISED DEPARTMENT OF TRANSPORTATION

 PLOT DATE •
 3/14/2022
 CHECKED - REB
 REVISED

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P II

Tray, IL 62294 PHONE: 618.667.1400 584.01

583.51 -20

SOIL BORING LOG

Page <u>1</u> of <u>1</u>

Date \_\_\_\_\_4/4/22\_\_\_

I-70 over Unnamed Ditch

LOGGED BY E. Sandschafer

	EC. 3, TWP. 8N, RNG. 7E, 3rd		- 7 0											
	atitude N 39.163566, Longitude W 88.414536 w stem auger & split spoon HAMMER Auto ETR = 91.8% @ 57.4													
М	Surface Water ElevUn	known	ft	D	В	U	м							
0	Stream Bed Elev. Un	known	ft	E P	L O	C S	0							
S T	Groundwater Elev.: First Encounter	586.5	ft <b>⊻</b>	T H	W S	Qu	S T							
(%)	Upon Completion After24 Hrs	Dry 595.5	ft ft <u></u> ⊻	(ft)	(/6")	(tsf)	(%)							
	Hard, moist, grey, CLAY till			_	3 6	4.1 B	13							
				_										
12	Very stiff			_	1 4	2.7	15							
					5	В								
				-25	2									
20	Hard		577.51		6 10	4.5 B	11							
	Benchmark: BM 721 - Chisele Square on Top Center of Box Culvert, SN 025-8706													
27	approximately 700 feet East of 13, Sta. 2641+05, 85 feet LT Elevation = 599.413 feet. End of Boring	, ,												
				-30										
30														
23														
				-35										
19														
				_										
19				_										
				_										
				-40										
	•													

BBS, form 137 (Rev. 8-99)


BORINGS	F.A.I. RTE	SECT	ON		COUNTY	TOTAL SHEETS	SHEET NO.	
. 025-8305		(25-4-1, 2	!5-5)R		EFFINGHAM	790	341	
.020-0000					CONTRACT NO. 74599			
7 SHEETS	ILLINOIS FED. AID PROJECT							
			ILLINOIS	FED. AID		T NO. 74	4599	

(	Illinois Departm of Transportatio	ent on				SOIL BORING LOG		Page Date		of <u>1</u> 4/22_
	ROUTE FAI 70 (I-70) D	ESCRIPT	ION			I—70 over Unnamed Ditch	LOGGED	BY E	E. Sand	<u>lschaf</u> er
	SECTION(25-4-1, 25-5)R	L	OCATIO	N _	SWC, S		4275			
	COUNTYEffinghamDRILLING	METHO	D	_Hol		m auger & split spoon HAMMER _	Auto ETR =	91.8	% @ 5	57.4
	025-8706 (E)           STRUCT. NO.         025-8305 (P)           Station         2640+20           BORING NO.         B3 (WBPL Shoulder)           Station         2640+18           Offset         14.0 ft RT of WB Centerline           Ground Surface Elev.         603.18	D E P T H	B L O W S (/6")	U C S Qu (1sf)	M 0 I S T (%)	Surface Water Elev.       Unknown         Stream Bed Elev.       Unknown         Groundwater Elev.:       First Encounter       Dry         Upon Completion       Dry         After       24       Hrs.       597.2	ft E P T ft H	B L O W S	U C S Qu (tsf)	M 0 I S T (%)
	10—inch Asphalt over 8—inch Aggregate Base 601	.68				No recovery, rock stuck in sampler shoe.		10 11	NT NT	23
	Brown, CLAY LOAM Hard, moist		1 3	4.0	14	Very stiff, moist, grey, CLAY LOAM Till	581.18	2	2.7	10
	598 Very stiff, moist, grey, CLAY	.68	4	Р			-25	11 8	В	
	,,, g,,	<u> </u>	5 5	3.1 B	23	Recovery = 33%. Rock stuck in sampler shoe. Benchmark: BM 721 - Chiseled	577.18	10 12	3.0 P	11
	Stiff, with silt		1 2 3	1.4 B	25	Square on Top Center of Box Culvert, SN 025-8706 approximately 700 feet East of CR 13, Sta. 2641+05, 85 feet LT, Elevation = 599.413 feet. End of Boring				
		-10	1 2 3	1.0 B	27		30 			
22			1 2 3	1.7 B	26					
SOIL BORING 025-8706 SOIL 2022.GPJ IL_DOT.GDT 4/3/22			1	1.2	30		 			
06 SOIL 2022.GPJ	586 Stiff, moist, brown, CLAY LOAM	.18	2	B						
ORING 025-87(	Sandy		1 3	1.2 B	16					
Soll B	583	.18 -20	6				-40			

The Unconfined Compressive Strength (UCS) Failure Mode is indicated by (B-Bulge, S-Shear, P-Penetrometer, E-Estimated) The SPT (N value) is the sum of the last two blow values in each sampling zone (AASHTO T206), WH-Weight of Hammer, NT-Not Tested.


BBS, form 137 (Rev. 8-99)

LOCHMUELLER GROUP	USER NAME PEberhart	DESIGNED - YSE	REVISED -		STRUCTURE BORINGS	F.A.I. RTE	SECTION	COUNTY TOTAL
		CHECKED - WMB	REVISED -	STATE OF ILLINOIS		70	(25-4-1, 25-5)R	EFFINGHAM 790
		DRAWN - PRE REVISED -	DEPARTMENT OF TRANSPORTATION	STRUCTURE NO. 025-8305		, , , , , , , , , , , , , , , , , , , ,	CONTRACT NO.	
L Tray, IL 62294 PHONE: 618.667.1400			SHEET OF 7 SHEETS		ED. AID PROJECT			

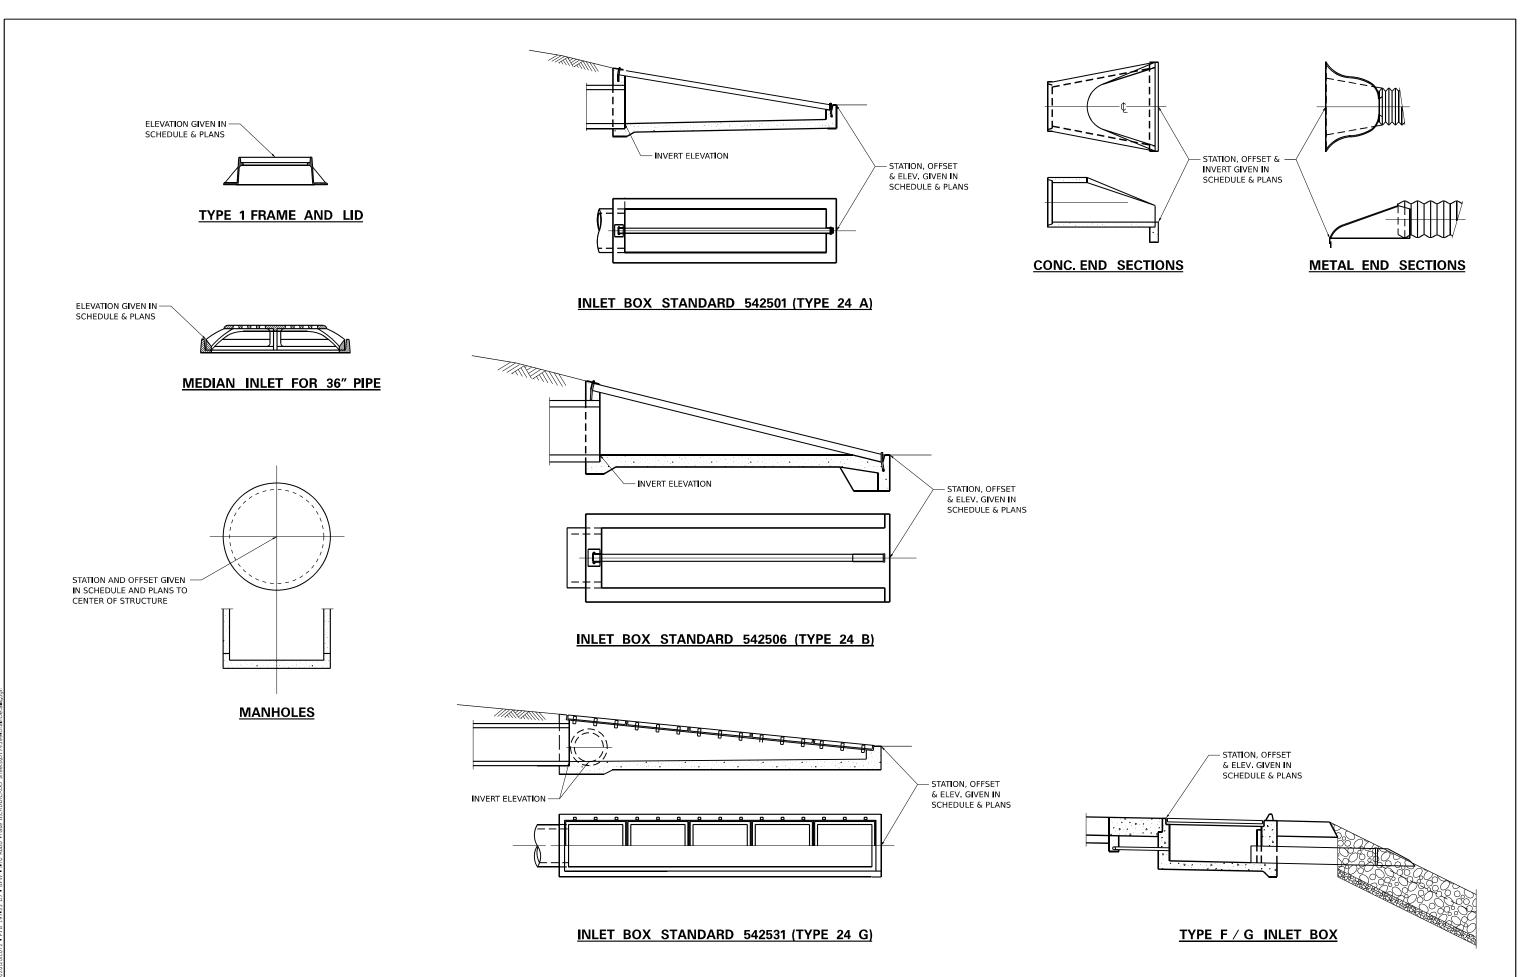

	USER NAME 🗖 sdulakis	DESIGNED -	SCD	REVISED -			I–70	F.A.I. RTE	SECTION	COUNTY	TOTAL S	HEET NO
( ) ⊨		DRAWN -	SCD	REVISED -	STATE OF ILLINOIS			70	(25-4-1, 25-5)R	EFFINGHAM	790	343
	PLOT SCALE 2 0000 / in	CHECKED -	SMK	REVISED -	DEPARTMENT OF TRANSPORTATION		DRAINAGE STRUCTURE REFERENCE POINTS	CONTRAC			NO. 745	99ز
QUIGG ENGINEERING INC	PLOT DATE = 3/11/2022	DATE -	11/30/2021	REVISED -		SCALE: NONE	SHEET 1 OF 1 SHEETS STA, TO STA.		ILLINOIS FED.	AID PROJECT		
	•			•	•		· · · · · ·					

		EXISTING CULVERT		POSED VERT	601	.LAR		s BA	D	RE	INFORC		BARS				EXPANSION BOLTS 3/4"	CLASS S CONCRET COLLAR
STATION	SKEW	SIZE	I.D.	0.D.	HEIGHT	WIDTH	NO.	SIZE	LENGTH	NO.	SIZE	A	B	LAP	LENGTH	LBS	EACH	CU YD
-70		1			1		1		1								1	
2415+00.00		24"	24"	30"	42"	42"	12	#4	18"	6	#4	36"	27"	18"	90"	6.0		0.54
2415+00.00		24"	24"	30"	42"	42"	12	#4	18"	6	#4	36"	27"	18"	90"	6.0		0.54
2431+00.00		24"	24"	30"	42"	42"	12	#4	18"	6	#4	36"	27"	18"	90"	6.0		0.54
2431+00.00		24"	24"	30"	42"	42"	12	#4	18"	6	#4	36"	27"	18"	90"	6.0		0.54
2449+00.00		24"	24"	30"	42"	42"	12	#4	18"	6	#4	36"	27"	18"	90"	6.0		0.54
2464+00.00		24"	24"	30"	42"	42"	12	#4	18"	6	#4	36"	27"	18"	90"	6.0		0.54
2464+00.00		24"	24"	30"	42"	42"	12	#4	18"	6	#4	36"	27"	18"	90"	6.0		0.54
2483+00.00		24"	24"	30"	42"	42"	12	#4	18"	6	#4	36"	27"	18"	90"	6.0		0.54
2518+00.00		24"	24"	30"	42"	42"	12	#4	18"	6	#4	36"	27"	18"	90"	6.0	_	0.54
2518+00.00		24"	24"	30"	42"	42"	12	#4	18"	6	#4	36"	27"	18"	90"	6.0		0.54
2538+00.00		24"	24"	30"	42"	42"	12	#4	18"	6	#4	36"	27"	18"	90"	6.0		0.54
2538+00.00		24"	24"	30"	42"	42"	12	#4	18"	6	#4	36"	27"	18"	90"	6.0		0.54
2547+00.00		24"	24"	30"	42"	42"	12	#4	18"	6	#4	36"	27"	18"	90"	6.0		0.54
2588+00.00		24"	24"	30"	42"	42"	12	#4	18"	6	#4	36"	27"	18"	90"	6.0		0.54
2588+00.00		24"	24"	30"	42"	42"	12	#4	18"	6	#4	36"	27"	18"	90"	6.0		0.54
2606+50.00		24"	24"	30"	42"	42"	12	#4	18"	6	#4	36"	27"	18"	90"	6.0		0.54
2659+00.00		24"	24"	30"	42"	42"	12	#4	18"	6	#4	36"	27"	18"	90"	6.0		0.54
2659+00.00		24"	24"	30"	42"	42"	12	#4	18"	6	#4	36"	27"	18"	90"	6.0		0.54
2687+00.00		24"	24"	30"	42"	42"	12	#4	18"	6	#4	36"	27"	18"	90"	6.0		0.54
2700+00.00		24"	24"	30"	42"	42"	12	#4	18"	6	#4	36"	27"	18"	90"	6.0		0.54
2715+00.00		24"	24"	30"	42"	42"	12	#4	18"	6	#4	36"	27"	18"	90"	6.0		0.54
2715+00.00		24"	24"	30"	42"	42"	12	#4	18"	6	#4	36"	27"	18"	90"	6.0		0.54
2726+05.00		24"	24"	30"	42"	42"	12	#4	18"	6	#4	36"	27"	18"	90"	6.0		0.54
2734+05.00		24"	24"	30"	42"	42"	12	#4	18"	6	#4	36"	27"	18"	90"	6.0		0.54
2734+05.00		24"	24"	30"	42"	42"	12	#4	18"	6	#4	36"	27"	18"	90"	6.0		0.54
2749+00.00		24"	24"	30"	42"	42"	12	#4	18"	6	#4	36"	27"	18"	90"	6.0		0.54
2749+00.00		24"	24"	30"	42"	42"	12	#4	18"	6	#4	36"	27"	18"	90"	6.0		0.54
2756+00.00		24"	24"	30"	42"	42"	12	#4	18"	6	#4	36"	27"	18"	90"	6.0		0.54
2767+05.00		24"	24"	30"	42"	42"	12	#4	18"	6	#4	36"	27"	18"	90"	6.0		0.54
2767+05.00		24"	24"	30"	42"	42"	12	#4	18"	6	#4	36"	27"	18"	90"	6.0		0.54
15+40.00		24"	24"	30"	42"	42"	12	#4	18"	6	#4	36"	27"	18"	90"	6.0		0.54
15+40.00		24"	24"	30"	42"	42"	12	#4	18"	6	#4	36"	27"	18"	90"	6.0		0.54
															OTALS	192.0		17.28
															USE	200		17.3

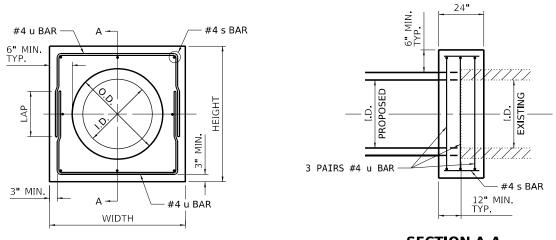


<u>P</u>	F

MODEL: Default FILE NAME: 5:2020/2012 • FIB. 197-35 D7 • BFW • I.70 Rubb Phase III.CADD.CADD Sh	D\CADD Shi		
MODEL: Default FILE NAME: 5:2020/2010/2 • FIB 197-35 D7 - BFW - 1:70 RU0b	Phase INCAD		
MODEL: Default HLE NAME: 55,0202011072 • PTB 197-35 D7 • BFW	- 1-70 Rubb		
MODEL: Default FILE NAME: 5/2020020L0/2 • PTB 19/4	35 D7 - BFW		
MODEL: Default FILE NAME: 5:2020/201L07	2 PTB 197		
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L Q	40DEL: Defaul		
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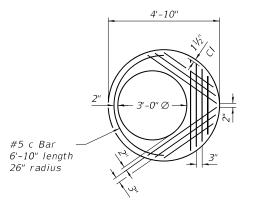
	USER NAME = sdulakis	DESIGNED -	SCD	REVISED -			I_70		F.A.I. BTE	SECTION	COUNTY TOTAL SHEETS	SHEET NO.
		DRAWN -	SCD	REVISED -	STATE OF ILLINOIS				70	(25-4-1, 25-5)R	EFFINGHAM 790	344
	PLOT SCALE = 40.0000 / in	CHECKED -	SMK	REVISED -	DEPARTMENT OF TRANSPORTATION		CONCRETE COLLAR DETAIL				CONTRACT NO. 74	1599
QUIGG ENGINEERING INC	PLOT DATE = 3/11/2022	DATE -	11/30/2021	REVISED -		SCALE: NONE	SHEET 1 OF 1 SHEETS STA.	TO STA.		ILLINOIS FED. A	ID PROJECT	

# SECTION A-A

### **IPE CULVERT EXTENSION COLLAR**

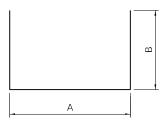



#### <u>#4 u BAR</u>



PLAN - FLAT SLAB TOP

(Showing layout of reinforcement bars and c bar) (See Std 602601 for details of reinforcement requirements. Cost of flat slab top included in manhole)

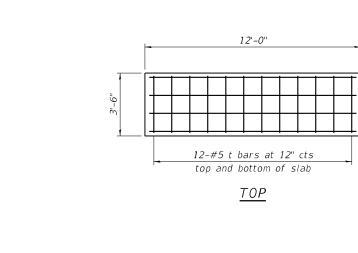


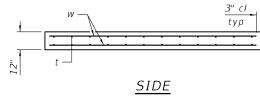

CONCRETE BASE SLAB

\* Concrete for Concrete Base Slab under manhole will be paid for as Miscellaneous Concrete.

	USER NAME 🔳 sduljakis	DESIGNED -	SCD	REVISED -			I–70	F.A.I. RTE	SECTION	COUNTY TOTAL SHEET SHEETS NO.
		DRAWN -	SCD	REVISED -	STATE OF ILLINOIS			70	(25-4-1, 25-5)R	EFFINGHAM 790 345
_	PLOT SCALE = 0:2.0000 : / in	CHECKED -	MDC	REVISED -	DEPARTMENT OF TRANSPORTATION		FT MANHOLE AND MEDIAN INLET DETAILS			CONTRACT NO. 74599
QUIGG ENGINEERING INC	PLOT DATE = 3/11/2022	DATE -	02/28/2022	REVISED -		SCALE: NONE	SHEET 1 OF 1 SHEETS STA. TO STA,		ILLINOIS FED. /	AID PROJECT

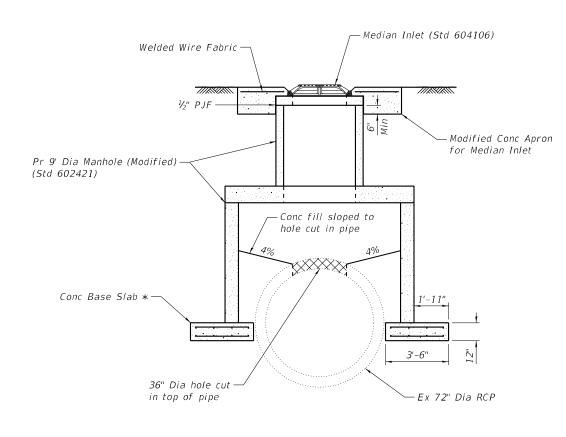


Concrete Apron —

24"

34"

PLAN - CONCRETE APRON

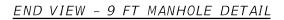








#### BILL OF MATERIAL

Bar	No.	Size	Leng	th		Shape
t	48	#5	3'-0	μ	-	
W	16	#5	11'-6	5″	-	
	Iten		Uni	t	Total	
Reinforce	ment Bar	°S		Pour	nd	350
Miscellane	eous Con	crete		Cu. Y	'd.	3.2


#### LT STA 2429+80 SN 025-8814

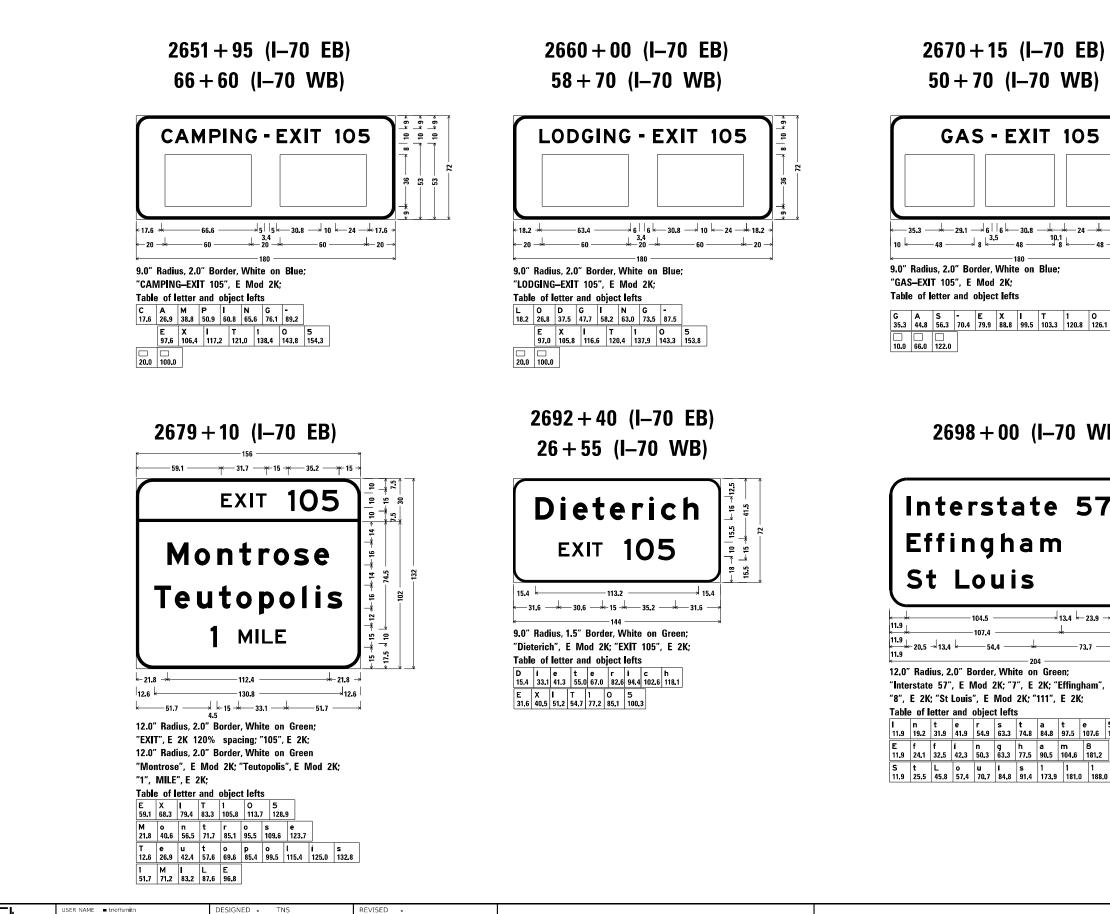


STATE OF ILLINOIS DRAWN - TNS REVISED -OT SCALE = 2.0000 / in. HECKED - FBN REVISED -**DEPARTMENT OF TRANSPORTATION** QUIGG ENGINEERING INC LOT DATE = 3/11/2022 DATE - JANUARY 2022 REVISED -


SCALE: NTS SHEET 1 OF 6 SHEET

SIGN PAN

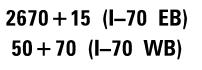


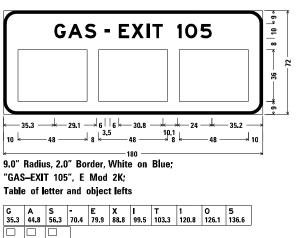



# 2698 + 00 (I-70 WB)

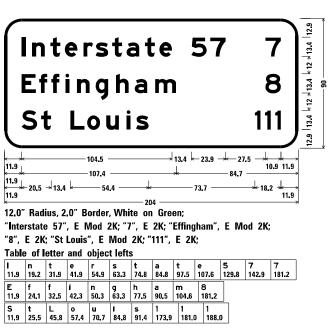


			F.A.I. RTE	SECT	ION		COUNTY	TOTAL SHEETS	SHEET NO.
٧E	LS		70	(25-4-1,	25•5)R		EFFINGHAM	790	346
							CONTRACT	NO. 74	1599
TS	STA.	TO STA.			ILLINOIS	FED, AI	D PROJECT		

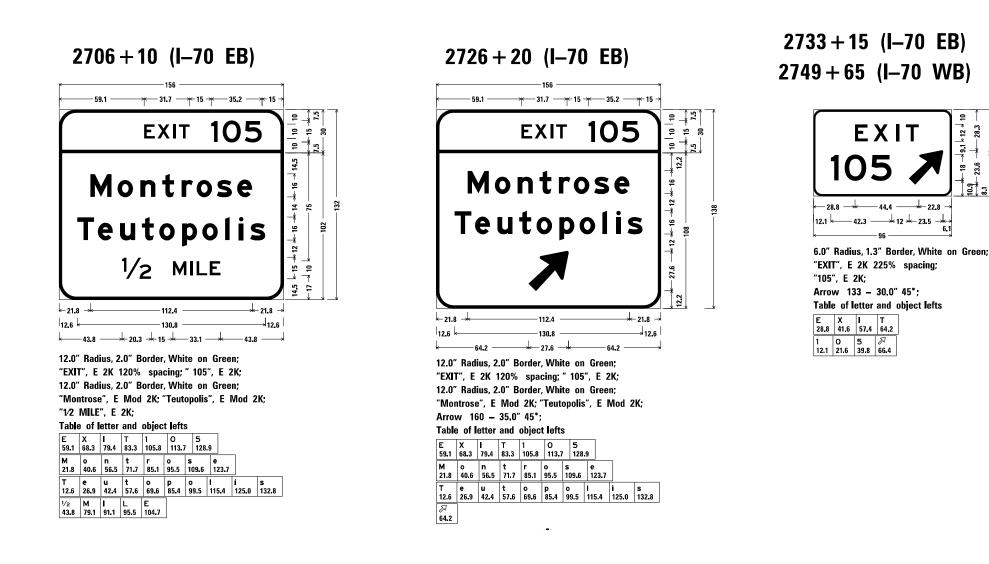

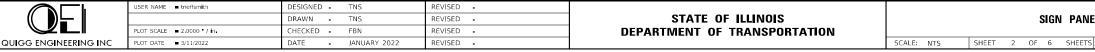

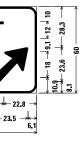

			F.A.I. RTE	SECT	TION		COUNTY	TOTAL SHEETS	SHEET NO.
NE	LS		70	(25-4-1,	25•5)R		EFFINGHAM	790	347
							CONTRACT	NO. 74	1599
TS	STA.	TO STA.			ILLINOIS	FED. AI	D PROJECT		

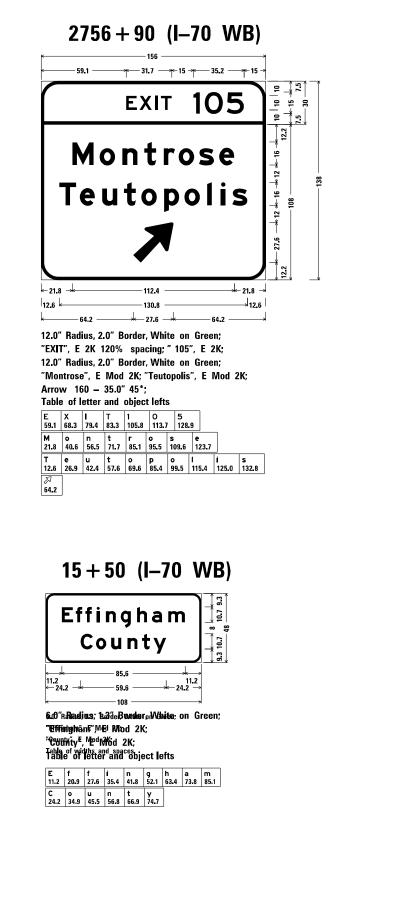

2770 + 90 (I-70 WB) 15 + 50 (I-70 EB) Cumberland EXIT 105 County Montrose - 30.2 .<u>+</u> 16 + ∶ Teutopolis 6.0" Radius, 1.3" Border, White on Green; 102 "Cumberland", E Mod 2K, "County", E Mod 2K;  $1/_2$  MILE Table of letter and object lefts -<u>1</u>-12 
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 9.7
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 C o u n t y 30.2 40.9 51.5 62.8 72.9 80.7 ← 21.8 k−21.8 → - 112 4 126 + -130.8 > 12 6 - 43 8 12.0" Radius, 2.0" Border, White on Green: "EXIT", E 2K 120% spacing; " 105", E 2K; 12.0" Radius, 2.0" Border, White on Green; "Montrose", E Mod 2K; "Teutopolis", E Mod 2K; "1/2 MILE", E 2K: Table of letter and object lefts 
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 128.9


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 T e u t o p o l i s s 12.6 26.9 42.4 57.6 69.6 85.4 99.5 115.4 125.0 132.8 <sup>1</sup>/<sub>2</sub> M I L E 43.8 79.1 91.1 95.5 104.7 24 + 00 (I-70 EB) Illinois 130 13 57 **Terre Haute** 129 Indianapolis ← 21 8 12.6 15 5 - 523 ----→13.3 k → 17.9 → 30.2 → 15.5 15.5 130.9 12.0" Radius, 2.0" Border, White on Green; "Illinois 130", E Mod 2K; "13", E 2K; "Terre Haute", E Mod 2K; "1 MILE", E 2K; "57", E 2K; "Indianapolis", E Mod 2K; "129", E 2K; Table of letter and object lefts Table of letter and object lefts E X I T 1 O 5 59.1 68.3 79.4 83.3 105.8 113.7 128.9 
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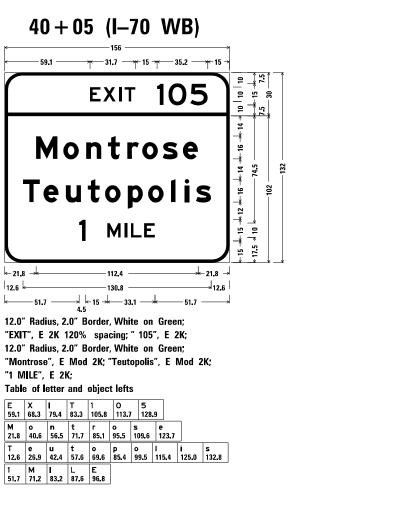
 15.5
 27.4
 40.3
 50.2
 58.9
 81.1
 95.3
 109.5
 122.2
 132.2
 171.4
 183.7
 I n d i a n a p o I i s 15.5 22.7 35.7 49.8 56.7 70.8 83.8 98.0 109.7 123.0 131.0 137.6 1 M I L E 51.7 71.2 83.2 87.6 96.8 1 2 9 164.3 171.0 183.7








4.5

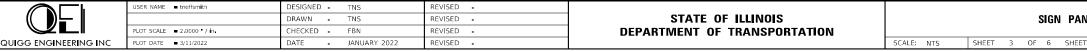


		F.A.I. RTE	SECT	ION		COUNTY	TOTAL SHEETS	SHEET NO.
VELS		70	(25-4-1, 25-5)R			EFFINGHAM	348	
						CONTRACT	NO. 74	1599
TS STA	TO STA.			ILLINOIS	FED. AI	D PROJECT		


# 428 + 20 (RAMP B)

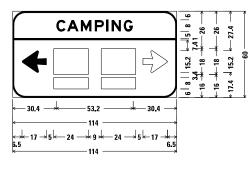

9.0" Radius, 1.0" Border, White on Blue; "CAMPING", E Mod 2K; Arrow 80 – 17.0" 180°; Table of letter and object lefts

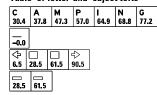


### 429 + 55 (RAMP B)

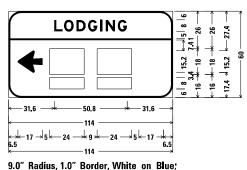

"LODGING", E Mod 2K; Arrow 80 – 17.0" 180°;

Table of letter and object lefts

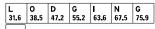




431 + 55 (RAMP B)

 $|6 + 17.9 \rightarrow 8 + 51.5 \rightarrow 12.6|$  $|6 + 17.9 \rightarrow 8 + 44.3 - + 19.8 \rightarrow 19.8 \rightarrow 19.8 -$ 

9.0" Radius, 1.5" Border, White on Green; Standard Arrow Custom 17.9" X 10.9" 180°; "Montrose", E 2K; 9.0" Radius, 1.5" Border, White on Green; Standard Arrow Custom 17.9" X 10.9" 180°; "Teutopolis", E 2K; 9.0" Radius, 1.5" Border, White on Green; Standard Arrow Custom 17.9" X 10.9" 180°; "Dieterich", E 2K; Table of letter and object lefts  $\boxed{6.0 \ 31.9 \ 9.6.7 \ 62.6 \ 73.2 \ 74.6 \ 50.4 \ 54.6 \ 60.9 \ 66.8 \ 73.2 \ 76.0 \ 78.5 \ 60.3 \ 31.9 \ 38.7 \ 44.6 \ 50.4 \ 54.6 \ 60.9 \ 66.8 \ 73.2 \ 76.0 \ 78.5 \ 60.3 \ 31.9 \ 38.9 \ 42.5 \ 47.9 \ 52.1 \ 58.1 \ 62.7 \ 65.3 \ 71.2 \ 53.1 \ 53.$ 

433+65 (RAMP B)

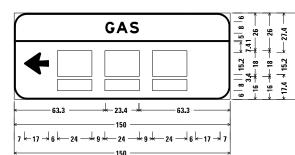


9.0" Radius, 1.0" Border, White on Blue; "GAS", E Mod 2K; Arrow 80 – 17.0" 180°; Table of letter and object lefts






	USER NAME   the	DESIGNED -	TNS	REVISED -					F.A.I. BTE	SECTION	COUNTY TOTAL	L SHEET
		DRAWN -	TNS	REVISED -	STATE OF ILLINOIS		SIGN PANELS		70	(25-4-1, 25-5)R	EFFINGHAM 790	349
	PLOT SCALE = 2.0000 / in	CHECKED -	FBN	REVISED -	DEPARTMENT OF TRANSPORTATION						CONTRACT NO. 7	74599
QUIGG ENGINEERING INC	PLOT DATE = 3/11/2022	DATE -	JANUARY 2022	REVISED -		SCALE: NTS	SHEET 4 OF 6 SHEETS STA.	TO STA.		ILLINOIS FED. /	AID PROJECT	


# 468 + 10 (RAMP D)

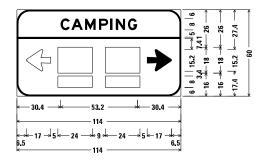

9.0" Radius, 1.0" Border, White on Blue; "CAMPING", E Mod 2K; Arrow 80 – 17.0" 0°; Table of letter and object lefts

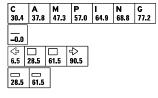


# 469 + 50 (RAMP D)

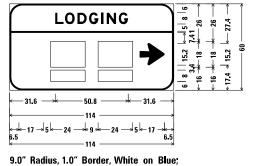

"LODGING", E Mod 2K; Arrow 80 – 17.0" 0°; Table of letter and object lefts L 0 D G I N G 31.6 38.5 47.2 55.2 63.6 67.5 75.9



471 + 55 (RAMP D)

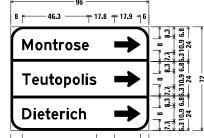


9.0" Radius, 1.5" Border, White on Green; "Montrose", E 2K; Standard Arrow Custom 17.9" X 10.9" 0°; 9.0" Radius, 1.5" Border, White on Green; "Teutopolis", E 2K; Standard Arrow Custom 17.9" X 10.9" 0°; 9.0" Radius, 1.5" Border, White on Green; "Dieterich", E 2K; Standard Arrow Custom 17.9" X 10.9" 0°;


Table of letter and object lefts

	USER NAME    theffsmith	DESIGNED - TNS	REVISED -			F.A.I. SECTION	COUNTY TOTAL SHEET SHEETS NO.
		DRAWN - TNS	REVISED -	STATE OF ILLINOIS	SIGN PANELS	70 (25-4-1, 25-5)R	EFFINGHAM 790 350
	PLOT SCALE 2.0000 / in	CHECKED - FBN	REVISED -	DEPARTMENT OF TRANSPORTATION		-	CONTRACT NO. 74599
QUIGG ENGINEERING INC	PLOT DATE = 3/11/2022	DATE - JANUARY 2022	REVISED -		SCALE: NTS SHEET 5 OF 6 SHEETS STA, TO STA,	ILLINOIS FED.	AID PROJECT

# 473 + 75 (RAMP D)

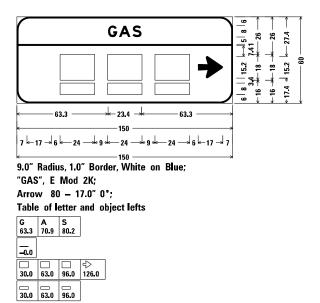

### 488 + 55 (FA 160 SB)

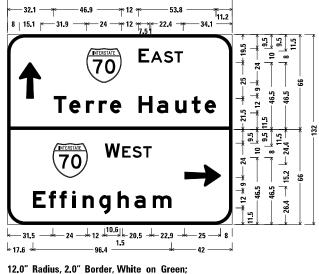

 Term
 Balans, 2.0
 Border, white on Green,

 Arrow
 80 - 25.0"
 90°; "EAST", E 2K;

 "Terre Haute", E Mod 2K;

 12.0" Radius, 2.0" Border, White on Green;

 "WEST", E 2K; "Effingham", E Mod 2K;

 Arrow
 80 - 25.0" 0°;


 Table of letter and object lefts

  $\widehat{\mathbb{T}}$  E

  $\widehat{\mathbb{T}}$  F


  $\widehat{\mathbb{T}}$  F

# 490+15 (FA 160 NB)

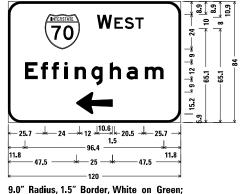



# E f i n g h a m 11.8 22.7 30.3 39.1 46.3 57.9 70.6 82.3 95.0 47.5

# 495+00 (FA 160 SB)

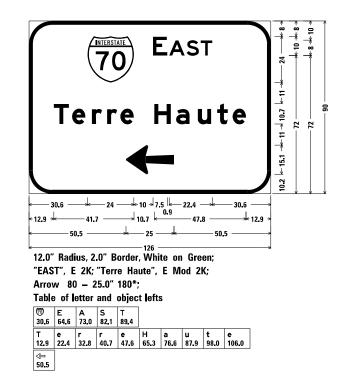

	USER NAME	DESIGNED -	TNS	REVISED -					F.A.I. BTE	SECTION	COUNTY TOTAL SHEET
		DRAWN -	TNS	REVISED -	STATE OF ILLINOIS		SIGN PANELS		70	(25-4-1, 25-5)R	EFFINGHAM 790 351
	PLOT SCALE = 2.0000 / in	CHECKED -	FBN	REVISED -	DEPARTMENT OF TRANSPORTATION						CONTRACT NO. 74599
QUIGG ENGINEERING INC	PLOT DATE = 3/11/2022	DATE -	JANUARY 2022	REVISED -		SCALE: NTS	SHEET 6 OF 6 SHEETS STA.	TO STA.		ILLINOIS FEE	AID PROJECT

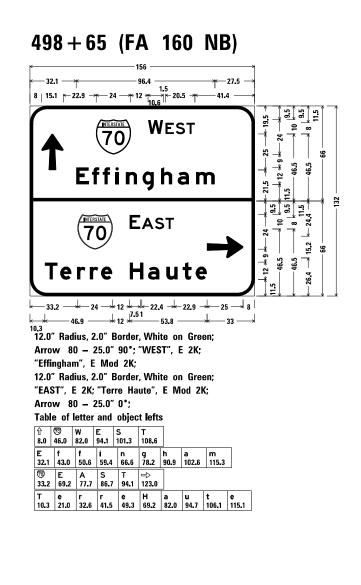

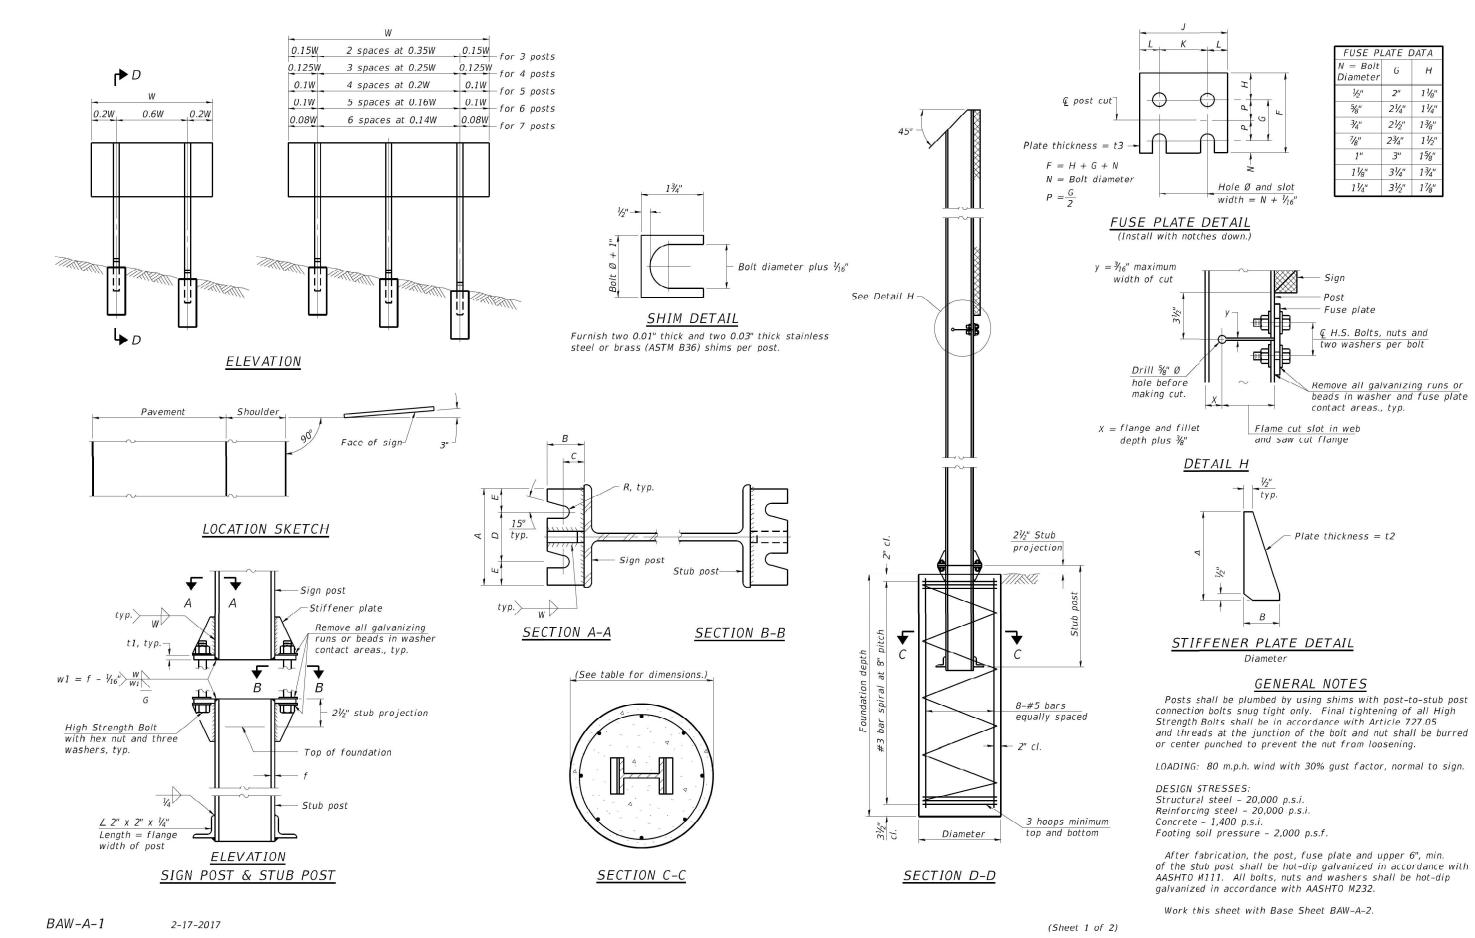


pwc/		USER NAME = scraven	DESIGNED -	REVISED -			BREAK-AWAY WIDE FLANGE		F.A.I. RTE	SECTION	COUNTY TOTAL S	SHEET
AME: C	BACON   FARMER   WORKMAN		DRAWN -	REVISED -	STATE OF ILLINOIS		STEEL SIGN POST DETAILS	·	70	(25-4-1,25-5)R	EFFINGHAM 790	352
	ENGINEERING & TESTING, INC.	PLOT SCALE = 0.8000 '/in	CHECKED -	REVISED -	DEPARTMENT OF TRANSPORTATION		STEEL SIGN PUST DETAILS		 I		CONTRACT NO. 745	,99
ž II		PLOT DATE = 3/16/2022	DATE -	REVISED -		SCALE: N.T.S.	SHEET 1 OF 2 SHEETS STA. TO ST	TA.		ILLINOIS FED, A	JD PROJECT	

			CONC	RETE FOUNDAT	TION TABL	E		~		PO	ST TO	STUB	POST (	CONNE	CTION	DATA			FU	SE PL	ATE DA	4TA
POST		Foundatio	n	Re	einforcem	ent		Stub Post														
1051	Diameter	* <sup>Minimum</sup> Depth	Concrete(1) cu.yds.)	Vertical Bars Length	Bar S Diameter	opirals Length	lbs. (2)	Length	Bolt Size	Α	В	С	D	Ε	t 1	t2	R	W	J	K	L	t3
W6x9	2'-0"	6'-0"	0.70	5'-9"	1'-8½"	79'-0"	78	2'-3"	5⁄8″ x 3¹⁄₄″	6"	2¼″	11/4"	31/2"	1 1⁄4"	3/4"	<sup>1</sup> / <sub>2</sub> "	11/ <sub>32</sub> "	1/4"	4"	2¼″	7/3"	1⁄4"
W6x15	2'-0"	6'-0"	0.70	5'-9"	1'-8½"	79'-0"	78	2'-6"	5⁄8" x 3¹⁄₄"	6"	2¼″	11/4"	3½"	1 1⁄4″	3/4"	1/2"	11/ <sub>32</sub> "	1/4"	6"	31/2"	i ¼"	-3/8"
W8x18	2'-0"	6'-0"	0.70	5'-9"	1'-8½"	79'-0"	78	2'-6"	¾" x 3¾"	6"	21/2"	13%"	31⁄4"	1¾"	1"	1/2"	<sup>13</sup> / <sub>32</sub> "	<i>⁵</i> ∕16"	5¼″	2¾"	11/4"	3/8"
W10x22	2'-6"	6'-6"	1.18	6'-3"	2'-2 <sup>1</sup> / <sub>2</sub> "	105'-0"	92	3'-0"	<sup>3</sup> ⁄4" x 3 <sup>3</sup> ⁄4"	6"	2½"	13%"	3¼"	1¾"	1"	1/2"	13/ <sub>32</sub> "	5∕16″	5¾"	23/4"	: <i>1</i> /2"	<sup>1</sup> /2"
W10x26	2'-6"	7'-0"	1.27	6'-9"	2'-21/2"	112'-0"	98	3'-0"	7⁄8″ x 4″	7"	2¾"	11/2"	4"	11/2"	1"	3/4"	15/ <sub>32</sub> "	3/8"	5¾″	23/4"	:1/2"	5/8''
W12x26	2'-6"	7'-9"	1.41	7'-6"	2'-2 <sup>1</sup> /5"	119'-0"	107	3'-0"	7⁄8″ x 4″	7"	2¾"	11/2"	4"	11/2"	1"	3/4"	15/32"	3/8"	6½"	31/2"	:1/2"	5/8"
W14x30	3'-0"	7'-3"	1.90	7'-0"	2'-8½"	145'-0"	113	3'-0"	<sup>7</sup> / <sub>8</sub> " x 4"	7"	23/4"	11/2"	4"	11/2"	1"	3/4"	15/ <sub>32</sub> "	3/8"	63/4"	31/2"	15%"	1/2"
W14x38	3'-0"	8'-0"	2.09	7'-9"	2'-8½"	153'-0"	122	3'-6"	1" x 4½"	7½"	3"	1 <i>³</i> /4″	4"	13⁄4"	1 ¼"	3/4"	<sup>17</sup> / <sub>32</sub> "	<i>³</i> ∕8″	6¾″	31/2"	15⁄8″	1/2"
W16x45	3'-0"	8'-6"	2.23	8'-3"	2'-8½"	162'-0"	130	3'-6"	1" x 4½"	7½"	3"	13/4"	4"	13/4"	1¼"	3/4"	<sup>17</sup> / <sub>32</sub> "	<i>³\8</i> "	7"	31/2"	13⁄4"	1/2"

\*Dimensional changes required for varying site conditions shall be approved by the Engineer.

										FUS	SE PLATE	BOLT SIZ	E								
POST											Sign	Height								1	
1001	4'-0"	5'-0"	6'-0"	7'-0"	8'-0''	9'-0"	10'-0"	11'-0"	12'-0"	13'-0"	14'-0"	15'-0"	16'-0"	17'-0"	18'-0"	19'-0"	20'-0"	21'-0"	22'-0"	23'-0"	24'-0"
W6x9	1/2" x 11/2"	½" x 1½"	½" x 1½"	<sup>1</sup> / <sub>2</sub> " x 1 <sup>1</sup> / <sub>2</sub> "			<u></u>	·			··			·							
W6x15	½" x 1¾"	½" x 1¾"	½" x 1¾"	5⁄8" x 2"	5⁄8" x 2"	¾″ x 2′	' <sup>3</sup> ⁄₄" x 2"	∛4" x 2"	³⁄₄" x 2"												
W8x18	<sup>1</sup> / <sub>2</sub> " x 1 <sup>3</sup> / <sub>4</sub> "	<sup>1</sup> / <sub>2</sub> " x 1 <sup>3</sup> / <sub>4</sub> "	<sup>1</sup> / <sub>2</sub> " x 1 <sup>3</sup> / <sub>4</sub> "	<sup>1</sup> / <sub>2</sub> " x 1 <sup>3</sup> / <sub>4</sub> "	5‰" x 2"	5‰" x 2'	' <sup>3</sup> ⁄₄" x 2"	¾" x 2"	3⁄4" x 2"	<sup>3</sup> / <sub>4</sub> " x 2"	a <u></u>		0								
W10x22	<sup>1</sup> / <sub>2</sub> " x 2"	½″ x 2″	<sup>1</sup> ⁄₂" x 2"	½″ x 2″	½″ x 2″	5⁄8" x 2"	5⁄8" x 2"	<sup>3</sup> / <sub>4</sub> " x 2 <sup>1</sup> / <sub>4</sub> "	<sup>3</sup> / <sub>4</sub> " x 2 <sup>1</sup> / <sub>4</sub> "	<sup>3</sup> / <sub>4</sub> " x 2 <sup>1</sup> / <sub>4</sub> "	¾″ x 2¼″	<sup>3</sup> / <sub>4</sub> " x 2 <sup>1</sup> / <sub>4</sub> "	<sup>3</sup> /4" x 2 <sup>1</sup> /4"	· · · · · · · · ·							
W10x26	1/2" x 2"	½″ x 2″	<sup>1</sup> ∕₂" x 2"	½″ × 2″	½″ x 2″	5⁄8" x 2¹/.	4" 5%" x 2¼4"	<sup>3</sup> / <sub>4</sub> " x 2 <sup>1</sup> / <sub>2</sub> "	¾" x 2½"	3⁄4" x 2¹⁄2"	¾" x 2½"	3⁄4" x 2¹⁄2"	¾" x 2½"	<sup>3</sup> / <sub>4</sub> " x 2 <sup>1</sup> / <sub>2</sub> "							
W12x26	<sup>1</sup> / <sub>2</sub> " x 2"	½" x 2"	<sup>1</sup> ⁄₂" x 2″	½″ x 2″	½" x 2"	5%" x 21/	4" <sup>5</sup> /8" x 2 <sup>1</sup> /4"	<sup>3</sup> ⁄4" x 2 <sup>1</sup> ⁄2"	<sup>3</sup> / <sub>4</sub> " x 2 <sup>1</sup> / <sub>2</sub> "	<sup>3</sup> ⁄4" x 2 <sup>1</sup> ⁄2"	3⁄4" x 2½"	<sup>3</sup> ⁄4" x 2 <sup>1</sup> ⁄2"	<sup>3</sup> ⁄4" x 2 <sup>1</sup> ⁄2"	<sup>3</sup> / <sub>4</sub> " x 2 <sup>1</sup> / <sub>2</sub> "	<sup>3</sup> / <sub>4</sub> " x 2 <sup>1</sup> / <sub>2</sub> "						
W14x30	<sup>1</sup> / <sub>2</sub> " x 2"	½″ x 2″	<sup>1</sup> / <sub>2</sub> " x 2"	½″ x 2″	½″ x 2″	5⁄8″ x 2′	5⁄8″ x 2″	<sup>3</sup> / <sub>4</sub> " x 2 <sup>1</sup> / <sub>4</sub> "	<sup>3</sup> / <sub>4</sub> " x 2 <sup>1</sup> / <sub>4</sub> "	<sup>3</sup> ⁄ <sub>4</sub> " x 2¹⁄ <sub>4</sub> "	<sup>3</sup> / <sub>4</sub> " x 2 <sup>1</sup> / <sub>4</sub> "	<sup>3</sup> / <sub>4</sub> " x 2 <sup>1</sup> / <sub>4</sub> "	<sup>3</sup> ⁄4" x 2 <sup>1</sup> ⁄4"	<sup>3</sup> / <sub>4</sub> " x 2 <sup>1</sup> / <sub>4</sub> "	¾" x 2¼"	<sup>3</sup> / <sub>4</sub> " x 2 <sup>1</sup> / <sub>4</sub> "	<sup>3</sup> / <sub>4</sub> " x 2 <sup>1</sup> / <sub>4</sub> "				
W14x38	½″ x 2″	<sup>1</sup> ⁄₂" x 2"	¹⁄₂" x 2″	¹⁄₂" x 2"	½" x 2"	5%" x 21/	4" <sup>5</sup> / <sub>8</sub> " x 2 <sup>1</sup> / <sub>4</sub> "	<sup>3</sup> / <sub>4</sub> " x 2 <sup>1</sup> / <sub>2</sub> "	<sup>3</sup> / <sub>4</sub> " x 2 <sup>1</sup> / <sub>2</sub> "	<sup>3</sup> ⁄ <sub>4</sub> " x 2 <sup>1</sup> ⁄ <sub>2</sub> "	<sup>3</sup> / <sub>4</sub> " x 2 <sup>1</sup> / <sub>2</sub> "	7/8" x 2 <sup>1</sup> /2"	7/8" x 2 <sup>1</sup> /2"	1" x 2¾"	1" x 2 <sup>3</sup> /4"	1" x 2¾"	1" x 2¾"	1" x 2¾"	1" x 2¾"	1" x 2¾"	1" x 2¾"
W16x45	· · · · · ·	¹⁄₂" x 2"	¹⁄₂" x 2"	<sup>1</sup> / <sub>2</sub> " x 2"	½″ x 2″	1/2" x 2'	' <sup>1</sup> / <sub>2</sub> " x 2"	5⁄8″ x 2¹⁄₄″	5⁄8" x 2¹⁄₄"	5⁄8" x 2¹⁄₄"	<sup>3</sup> / <sub>4</sub> " x 2 <sup>1</sup> / <sub>2</sub> "	<sup>3</sup> / <sub>4</sub> " x 2 <sup>1</sup> / <sub>2</sub> "	7⁄8" x 2¹⁄₂"	7⁄8″ x 2¹⁄₂″	<sup>7</sup> / <sub>8</sub> " x 2 <sup>1</sup> /₂"	1" x 2¾"	1" x 2¾"	1" x 2¾"	1" x 2¾"	1" x 2¾"	1" x 2¾"

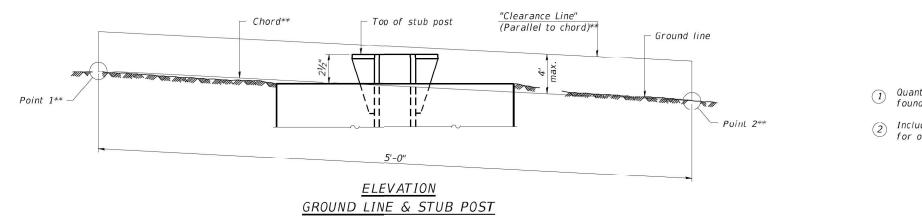

\*\* For all "Point 1" and "Point 2" locations, "Clearance Line" must be at or above top of stub post.

11 //bfwme-pw	BAW-A-2	2-17-2017				(Sheet 2 of 2)		
pw:		USER NAME = scraven	DESIGNED -	REVISED -		BREAK-AWAY WIDE FLANGE	F.A.I. SECTION	COUNTY TOTAL SHEET SHEETS NO.
AME: St	BACON   FARMER   WORKMAN		DRAWN -	REVISED -	STATE OF ILLINOIS	STEEL SIGN POST TABLES	70 (25-4-1,25-5)R	EFFINGHAM 790 353
DDEL:	ENGINEERING & TESTING, INC.	PLOT SCALE = 0.8000 '/in	CHECKED -	REVISED -	DEPARTMENT OF TRANSPORTATION	STEEL SIGN PUST TABLES		CONTRACT NO. 74599
ž E		PLOT DATE = 3/16/2022	DATE -	REVISED -		SCALE: N.T.S. SHEET 2 OF 2 SHEETS STA. TO STA.	ILLINOIS FED, A	D PROJECT

1 Quantity includes all concrete necessary for one foundation.

Includes reinforcement bars and spiral hooping for one foundation.

#### EROSION CONTROL GENERAL NOTES

- 1. EXCEPT WHERE MODIFIED BY THE SPECIAL PROVISIONS INCLUDED IN THE CONTRACT DOCUMENTS OR THE DETAILS IN THE PLANS, ALL CONSTRUCTION SHALL BE DONE IN ACCORDANCE WITH THE "STANDARD SPECIFICATIONS FOR ROAD AND BRIDGE CONSTRUCTION", ADOPTED JANUARY 1, 2022: THE "SUPPLEMENTAL SPECIFICATIONS AND RECURRING SPECIAL PROVISIONS", ADOPTED JANUARY 1, 2022: THE LATEST EDITION OF THE "ILLINOIS MANUAL ON UNIFORM TRAFFIC CONTROL DEVICES FOR STREETS AND HIGHWAYS", THE "STANDARD SPECIFICATIONS FOR WATER AND SEWER MAIN CONSTRUCTION IN ILLINOIS" MAY 1996 FIFTH EDITION: THE "DETAILS" IN THE PLANS; AND THE "SPECIAL PROVISIONS" IN THE CONTRACT DOCUMENTS.
- ANY REFERENCE TO STANDARDS THROUGHOUT THE PLANS OR SPECIAL PROVISIONS SHALL BE INTERPRETED AS THE LATEST IDOT STANDARDS. 2.
- IT SHALL BE THE CONTRACTOR'S RESPONSIBILITY TO UNDERSTAND THE SOIL AND GROUNDWATER CONDITIONS AT THE SITE. COPIES OF AVAILABLE GEOTECHNICAL з. INFORMATION ARE AVAILABLE FROM IDOT FOR REVIEW AND INFORMATION.
- BEFORE STARTING ANY EXCAVATION, THE CONTRACTOR SHALL CALL "JULIE" AT 1-800-892-0123 FOR FIELD LOCATIONS OF BURIED UTILITIES (48 HOUR NOTIFICATION 4. IS REOURED).
- THE CONTRACTOR SHALL COORDINATE CONSTRUCTION ACTIVITIES WITH UTILITY COMPANIES, MUNICIPALITIES AND COUNTIES. 5.
- THE CONTRACTOR WILL NOT BE ALLOWED TO SET UP A YARD OR FIELD OFFICE ON CITY, COUNTY OR STATE PROPERTY WITHOUT WRITTEN PERMISSION FROM THE 6. DEPARTMENT.
- THE CONTRACTOR SHALL BE REQUIRED TO MAINTAIN ACCESS TO ABUTTING PROPERTY AT ALL TIMES DURING THE CONSTRUCTION OF THIS PROJECT. 7.
- 8. DO NOT SCALE PLANS FOR CONSTRUCTION DIMENSIONS. STATIONS ARE SHOWN FOR REFERENCE ONLY.
- IT SHALL BE THE CONTRACTOR'S RESPONSIBILITY TO VERIEVALL DIMENSIONS AND CONDITIONS EXISTING IN THE FIELD PRIOR TO CONSTRUCTION AND ORDERING 9. OF MATERIALS.
- 10. THE CONTRACTOR SHALL USE CARE IN REMOVING OR EXCAVATING NEAR ALL EXISTING ITEMS WHICH WILL REMAIN, ANY DAMAGE DONE TO EXISTING ITEMS BY THE CONTRACTOR SHALL BE REPAIRED AT THE CONTRACTOR'S EXPENSE.
- 11. THE CONTRACTOR SHALL RESTORE ALL DISTURBED AREAS AT THE DIRECTION OF THE ENGINEER. THIS WORK IS INCLUDED AS PART OF THE CONTRACT AND SHALL BE INCLUDED IN THE CONTRACT BID PRICES FOR ASSOCIATED ITEMS.
- 12. THE CONTRACTOR SHALL COMPLY WITH ALL PERMIT REQUIREMENTS AT THE DIRECTION OF THE PERMITTING AGENCIES. THIS WORK IS INCLUDED AS PART OF THE CONTRACT AND SHALL BE INCLUDED IN THE CONTRACT BID PRICES FOR ASSOCIATED ITEMS.
- 13. CLEARING SHALL BE DONE TO THE CONSTRUCTION LIMITS OF THE PROJECT, CLEARING WILL NOT BE MEASURED FOR PAYMENT,
- THE CONSTRUCTION LIMITS WILL BE STAKED BY THE CONTRACTOR PRIOR TO COMMENCING CONSTRUCTION. PAYMENT FOR THIS WORK WILL BE INCLUDED WITHIN 14. THE ITEM CONSTRUCTION LAYOUT. THE CONSTRUCTION LIMITS MAY BE ADJUSTED BY THE ENGINEER TO PRESERVE TREES AND NO ADDITIONAL COMPENSATION WILL BE PAID TO THE CONTRACTOR FOR CHANGED CONSTRUCTION LIMITS.
- 15. SEDIMENT AND EROSION CONTROL DEVICES SHALL BE FUNCTIONAL BEFORE THE PROJECT SITE IS OTHERWISE DISTURBED.
- UNLESS OTHERWISE INDICATED, ALL VEGETATIVE AND STRUCTURAL EROSION AND SEDIMENT CONTROL PRACTICES WILL BE CONSTRUCTED ACCORDING TO 16. MINIMUM STANDARDS AND SPECIFICATIONS IN IDOT STANDARD SPECIFICATIONS FOR ROAD AND BRIDGE CONSTRUCTION AND THE ILLINOIS URBAN MANUAL LATEST UPDATE.
- 17. A COPY OF THE APPROVED EROSION AND SEDIMENT CONTROL PLAN SHALL BE MAINTAINED ON SITE AT ALL TIMES.
- 18. PRIOR TO COMMENCING LAND-DISTURBING ACTIVITIES IN AREAS OTHER THAN INDICATED ON THESE PLANS (INCLUDING BUT NOT LIMITED TO, ADDITIONAL PHASES OF DEVELOPMENT AND OFF-SITE BORROW OR WASTE AREAS), A SUPPLEMENTARY EROSION CONTROL PLAN SHALL BE SUBMITTED TO THE OWNER FOR ACCEPTANCE
- 19. THE CONTRACTOR IS RESPONSIBLE FOR INSTALLATION OF ANY ADDITIONAL EROSION CONTROL MEASURES NECESSARY TO PREVENT EROSION AND SEDIMENTATION AS DETERMINED BY THE REGULATORY AUTHORITIES. THESE ADDITIONAL ITEMS ARE INCIDENTAL TO THE CONTRACT.
- DURING DEWATERING OPERATIONS, WATER WILL BE PUMPED INTO SEDIMENT BASINS OR SILT TRAPS, DEWATERING DIRECTLY INTO FIELD TILES OR STORMWATER 20. STRUCTURE IS PROHIBITED
- 21. IT IS THE RESPONSIBILITY OF THE GENERAL CONTRACTOR TO INFORM ANY SUB-CONTRACTOR(S) WHO MAY PERFORM WORK ON THIS PROJECT, OF THE REQUIREMENTS IN IMPLEMENTING AND MAINTAINING THESE EROSION CONTROL PLANS AND THE NATIONAL POLLUTANT DISCHARGE ELIMINATION SYSTEMS (NPDES) PERMIT REQUIREMENTS SET FORTH BY THE ILLINOIS EPA.
- PERIMETER EROSION CONTROL BARRIER SHALL BE ERECTED ADJACENT TO TEMPORARY CONSTRUCTION FENCE IN SELECTED LOCATIONS, THE RESIDENT ENGINEER 22. SHALL HAVE FINAL DETERMINATION OF THE PLACEMENT AND LOCATION OF THE PERIMETER EROSION CONTROL BARRIER.
- COMPLETED SLOPES (SECTION OF ROAD EMBANKMENT) SHALL BE SEEDED AND BLANKETED AS THE EXCAVATION PROCEEDS AS REQUIRED BY THE PERMITS AND AS 23. DESIRABLE AND PRACTICAL, UNDER NO CIRCUMSTANCES SHALL THE CONTRACTOR PROLONG FINAL GRADING AND SHAPING SO THAT THE ENTIRE PROJECT CAN BE PERMANENTLY SEEDED AT ONE TIME.
- 24. CLEANING OF VEHICLES AND EQUIPMENT SHALL BE PERFORMED IN A MANNER TO REDUCE THE AMOUNT OF POLLUTANTS TRIBUTARY TO STORM SEWERS AND OPEN WATERS TO THE MAXIMUM EXTENT POSSIBLE.
- 25. REFER TO STORM WATER POLLUTION PREVENTION PLAN FOR INSPECTION AND MAINTENANCE SCHEDULES, AND SEQUENCE OF ACTIVITIES.
- 26. ALL NECESSARY MEASURES SHALL BE TAKEN TO CONTAIN ANY FUEL OR POLLUTION RUN OFF. LEAKY EQUIPMENT OR SUPPLIES SHALL BE IMMEDIATELY REPAIRED OR REMOVED FROM THE SITE.

#### EROSION CONTROL GENERAL NOTES (CONT'D)

- 27. SITE CONDITIONS AND THE USE OF TEMPORARY OR PERMANENT MEASURES.
- 28. SHALL BE INCLUDED IN THE COST OF THE ASSOCIATED PAY ITEMS.
- 29. DAYS, TEMPORARY STABILIZATION MEASURES CAN BE USED.
- DUST CONTROL MEASURES WILL BE IMPLEMENTED IN ACCORDANCE WITH ARTICLE 107.36 OF THE STANDARD SPECIFICATIONS. 30.
- 31. THEREOF.
- 32. TEMPORARY EROSION CONTROL SEEDING.
- 33. TOPSOIL AND FERTILIZER NUTRIENTS ARE NOT REQUIRED FOR TEMPORARY EROSION CONTROL SEEDING.
- 34. DONE IF THE SOIL IS HARD PACKED OR CAKED.
- 35. EROSION CONTROL SEEDING HAS BEEN COMPLETED AS SHOWN ON THE PLANS, OR AS DIRECTED BY THE ENGINEER.
- 36. ADEQUATE QUANTITY OF SILT FENCE TO CONTROL THE PERIMETER OF THE STOCKPILE.
- 37.
- 38. STABILIZED CONSTRUCTION ENTRANCES SHALL ONLY BE CONSTRUCTED AT LOCATIONS APPROVED BY THE ENGINEER.
- 39. PERMITTING AGENCY MUST BE INSTALLED IMMEDIATELY.
- 40. STABLIZED.
- 41. SELECTED WITH CONSIDERATION OF HOW RAISING WATER LEVELS WILL IMPACT SURROUNDING FACILITIES AND TRAFFIC.

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SOIL DISTURBANCE SHALL BE CONDUCTED IN SUCH A MANNER AS TO MINIMIZE EROSION. SOIL STABILIZATION MEASURES SHALL CONSIDER THE TIME OF YEAR,

THE MAINTENANCE AND REPAIR OR REPLACEMENT OF EROSION CONTROL ITEMS, WHEN DIRECTED BY THE ENGINEER, WILL NOT BE PAID FOR SEPARATELY, BUT

TEMPORARY EROSION CONTROL SEEDING MIXTURE WILL DEPEND ON THE TIME OF YEAR SEED IS TO BE APPLIED AND SHALL BE IN ACCORDANCE WITH ARTICLE 1081.15(G) OF THE STANDARD SPECIFICATIONS. STABILIZATION OF ALL AREAS DISTURBED BY CONSTRUCTION SHALL COMMENCE WITHIN 1 DAY AND BE COMPLETE WITHIN 14 DAYS FOR ANY PORTION OF THE SITE THAT WILL BE IDLE FOR MORE THAN 14 DAYS. IF THAT PORTION OF THE SITE WILL BECOME ACTIVE AGAIN AFTER 14

WHENEVER DURING CONSTRUCTION OPERATIONS, LOOSE MATERIAL IS DEPOSITED IN THE FLOW LINE OF GUTTERS, DRAINAGE STRUCTURES, DITCHES, ETC., SUCH THAT THE NATURAL FLOW LINE OF WATER IS OBSTRUCTED, THE LOOSE MATERIAL SHALL BE REMOVED AT THE CLOSE OF EACH WORKING DAY. AT THE CONCLUSION OF THE CONSTRUCTION OPERATIONS, ALL DRAINAGE STRUCTURES AND FLOW LINES SHALL BE FREE FROM DIRT AND DEBRIS. THE CONTRACTOR'S FAILURE TO PROVIDE THE ABOVE WILL PRECLUDE ANY POSSIBLE ADDED COMPENSATION REQUESTED DUE TO DELAYS OR UNSUITABLE MATERIAL CREATED AS A RESULT

BROADCASTING OF THE SEED BY MACHINE, HAND METHODS, HYDRAULIC SEEDING OR OTHER METHODS APPROVED BY THE ENGINEER WILL BE ALLOWED FOR

SEED BED PREPARATION WILL NOT BE REQUIRED FOR TEMPORARY EROSION CONTROL SEEDING IF THE SOIL IS IN A LOOSE CONDITION. LIGHT DISKING SHALL BE

TEMPORARY EROSION CONTROL BLANKET SHALL BE PLACED IN ACCORDANCE WITH THE REQUIREMENTS OF THE STANDARD SPECIFICATIONS AFTER TEMPORARY

SALVAGED TOPSOIL SHALL BE PLACED ON WELL DRAINED LAND AWAY FROM INTERMITTENT AND LIVE STREAMS OR WETLANDS WITH THE APPROPRIATE RUNOFF CONTROL AND SEDIMENT CONTROL MEASURES INSTALLED AROUND THE STORAGE SITE AND STABILIZED IN ACCORDANCE WITH MULCH METHOD 2 IMMEDIATELY WHEN THE TOPSOIL SHALL BE UNDISTURBED FOR 14 DAYS, AND STABILIZATION SHALL BE COMPLETED WITHIN 14 DAYS. THE CONTRACTOR WILL PROVIDE AN

ALL EROSION AND SEDIMENT CONTROL (ESC) MEASURES SHOULD BE CHECKED WEEKLY AND AFTER EACH RAINFALL. 0.5 INCHES OR GREATER IN A 24 HOUR PERIOD, OR EQUIVALENT SNOWFALL. ADDITIONALLY, DURING WINTER MONTHS, ALL MEASURES SHOULD BE CHECKED AFTER EACH SIGNIFICANT SNOWFALL.

STABILIZED CONSTRUCTION ENTRANCES SHALL BE INSTALLED TO REDUCE OR ELIMINATE THE TRACKING OF SEDIMENT ON PUBLIC RIGHT-OF-WAY OR STREETS.

THE EROSION AND SEDIMENT CONTROLS SHOWN IN THE PLANS REPRESENT THE MINIMUM REQUIREMENTS. ADDITIONAL MEASURES MAY BE REQUIRED BY THE ENGINEER OR REPRESENTATIVES OF REGULATORY OR PERMITTING AGENCIES. ANY EMERGENCY CONTROL MEASURES REQUESTED BY A REGULATORY OR

ALL TEMPORARY EROSION AND SEDIMENT CONTROLS SHALL BE REMOVED ONCE CONSTRUCTION IS COMPLETE AND DISTURBED AREAS ARE PERMANENTLY


THE HEIGHT OF DITCH CHECKS AND INLET PROTECTION SHALL NOT EXCEED 2 FOOT TO PREVENT DEEP POOLS OF WATER. HEIGHTS OF THESE DEVICES SHALL BE


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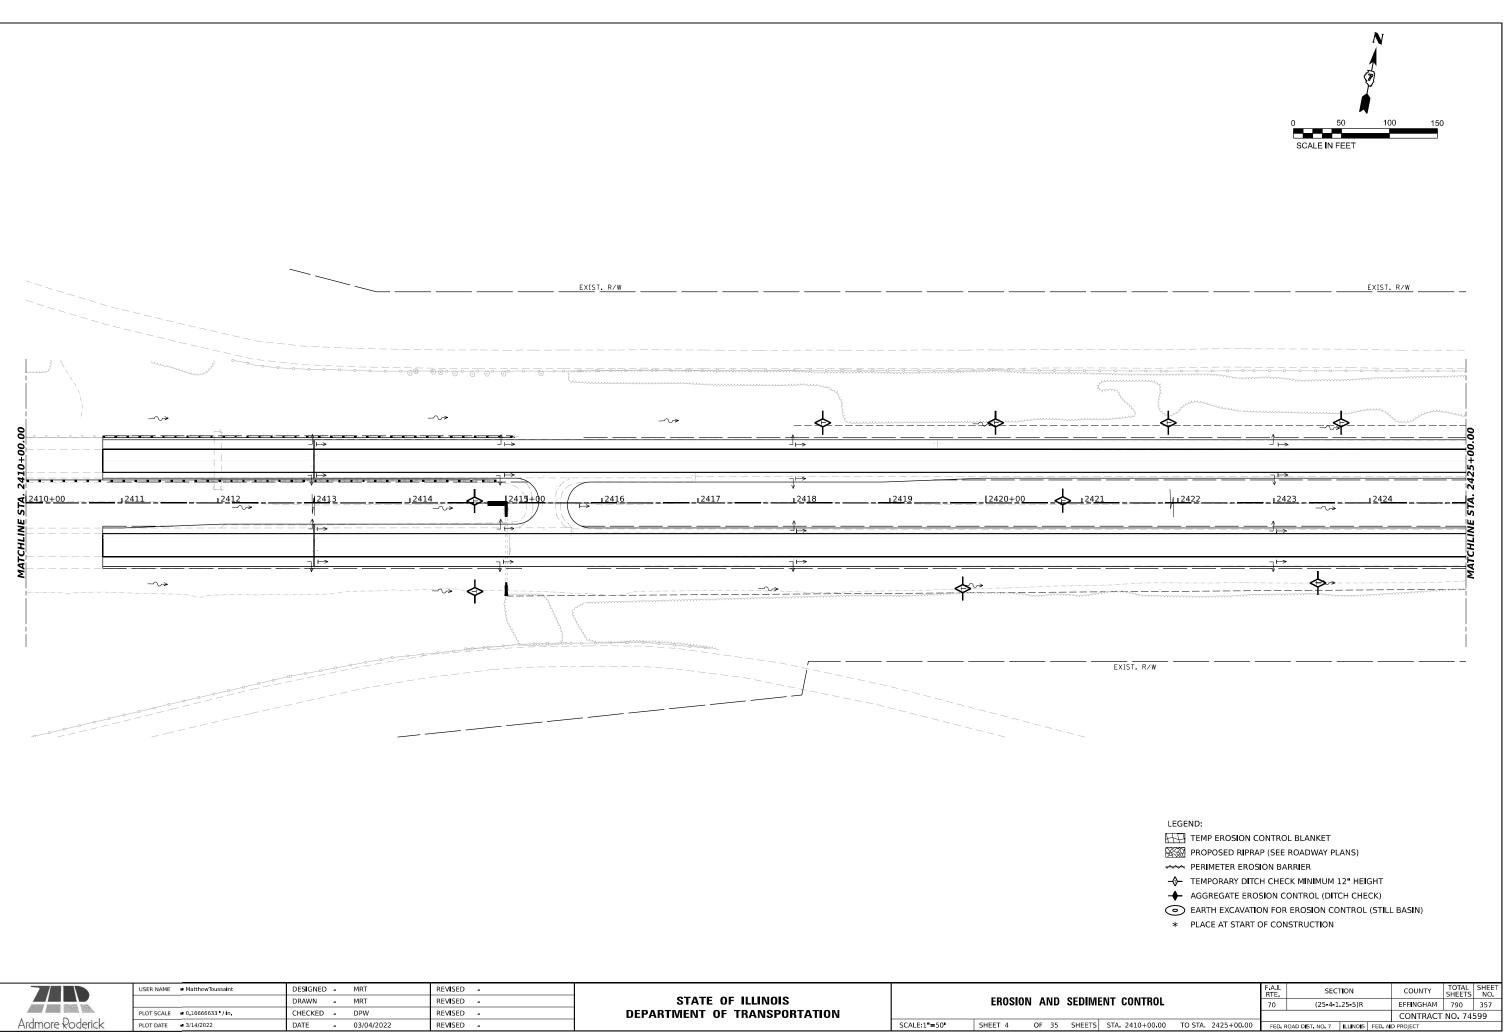
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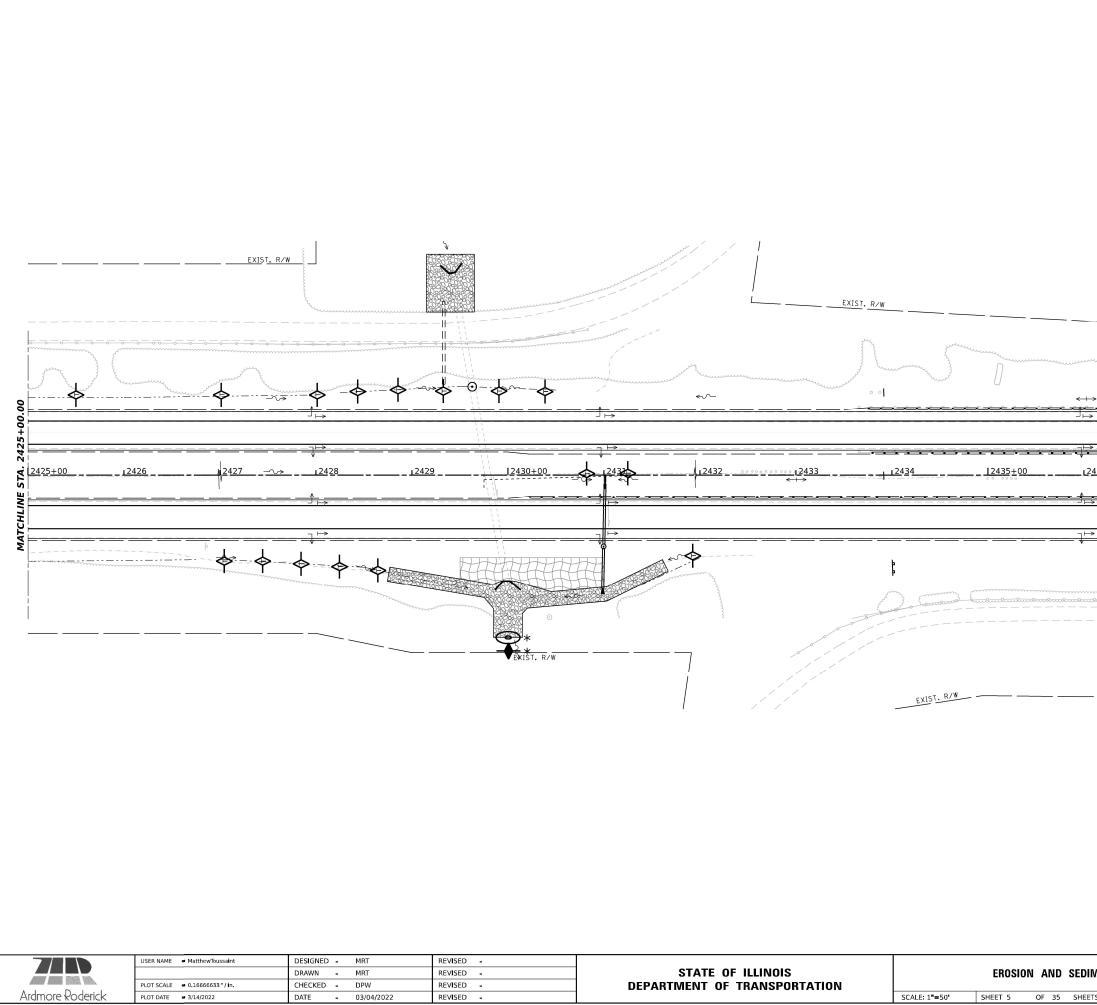




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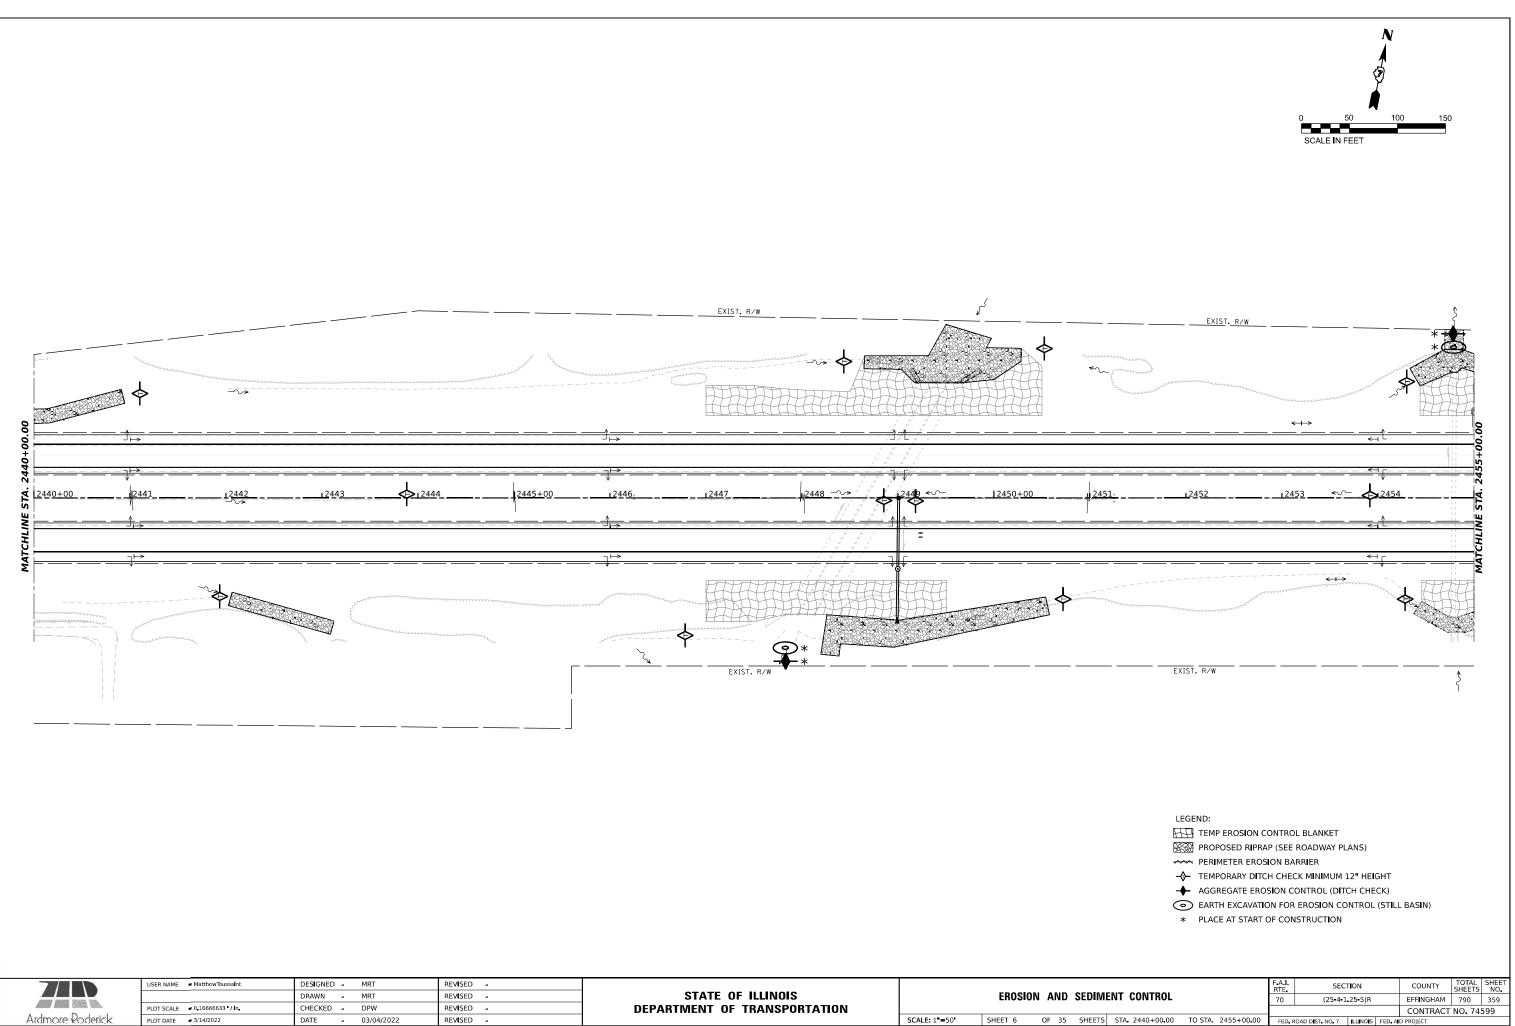



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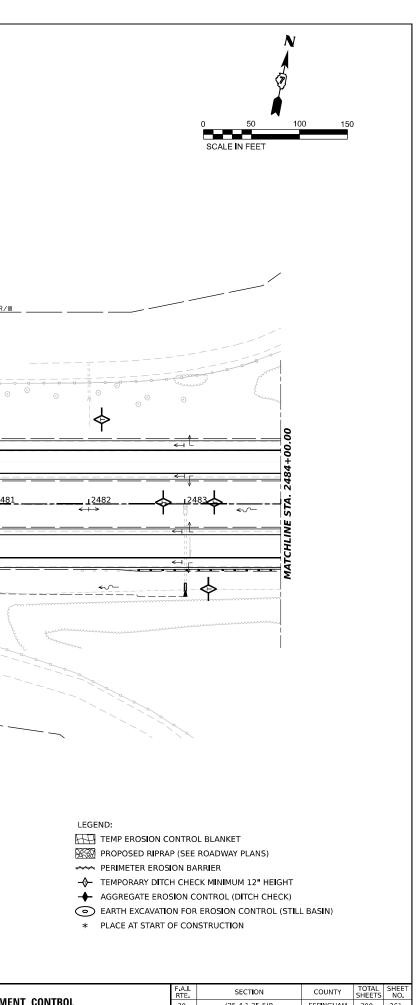
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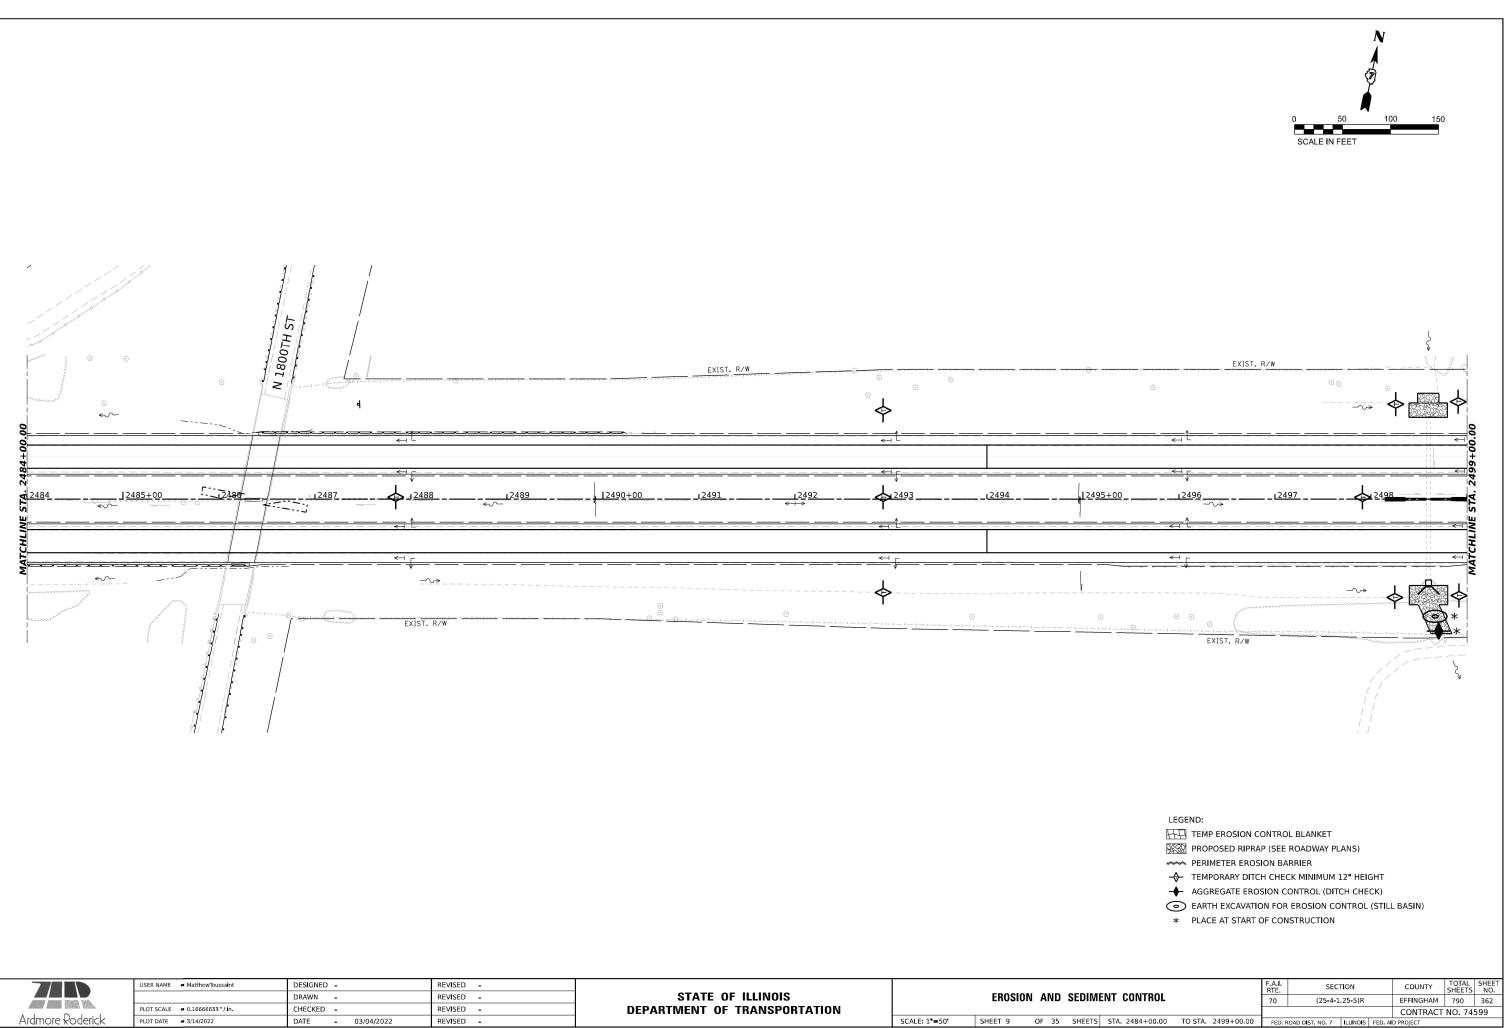
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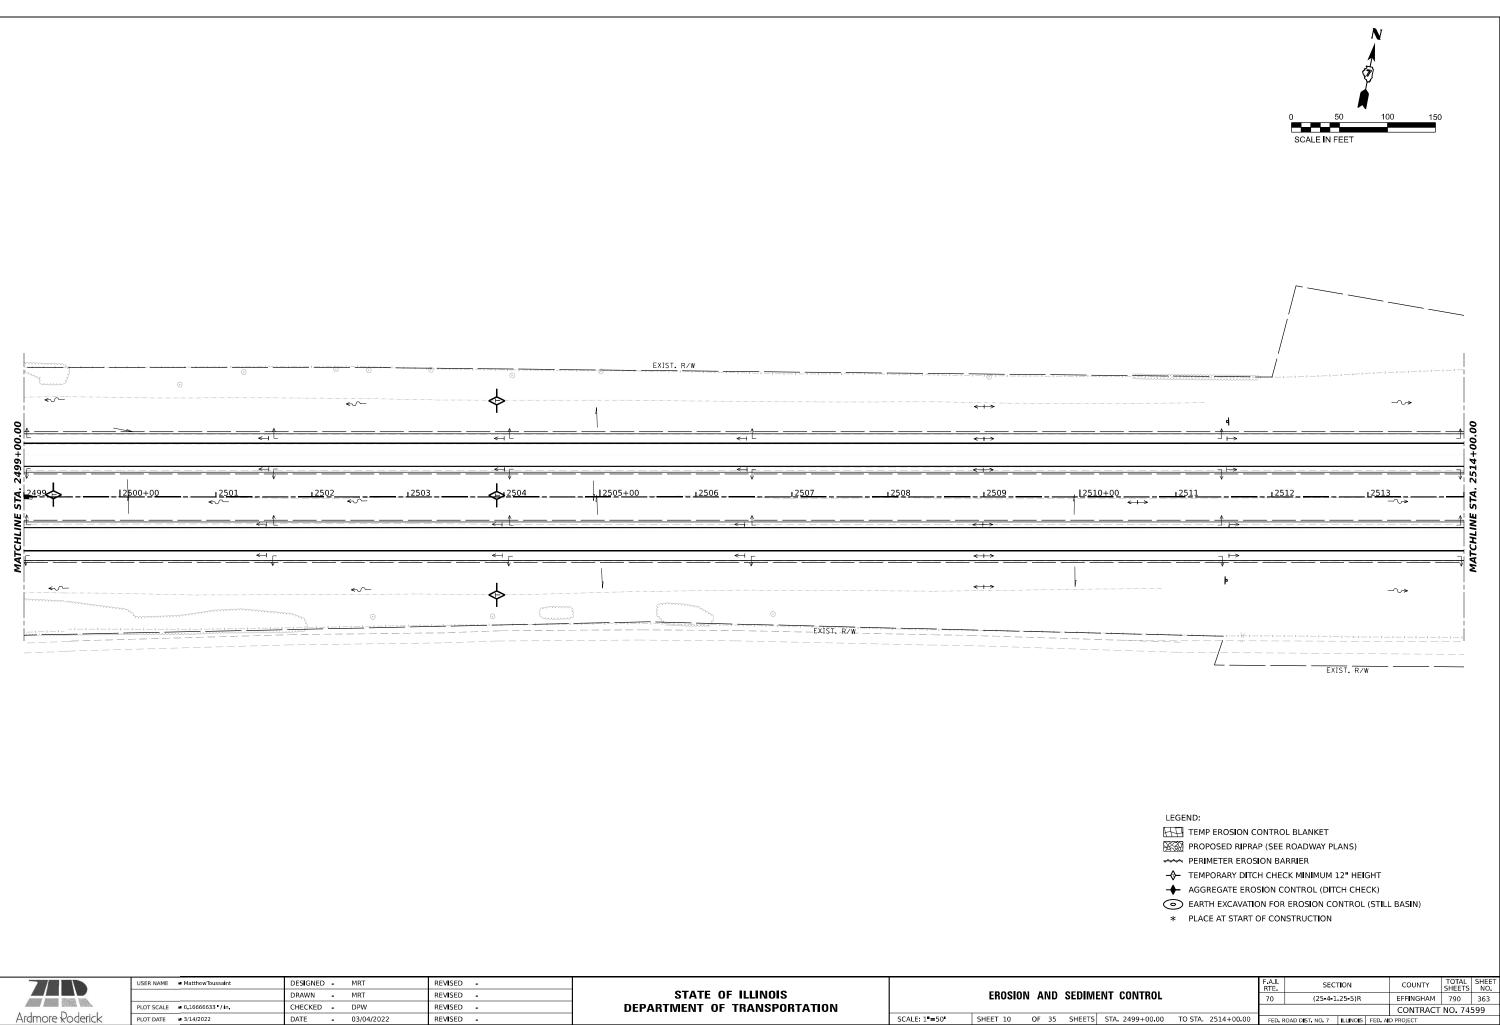


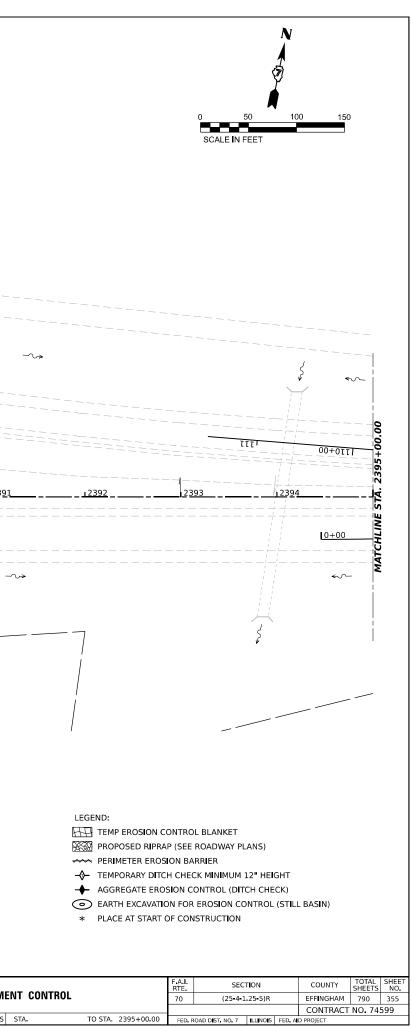

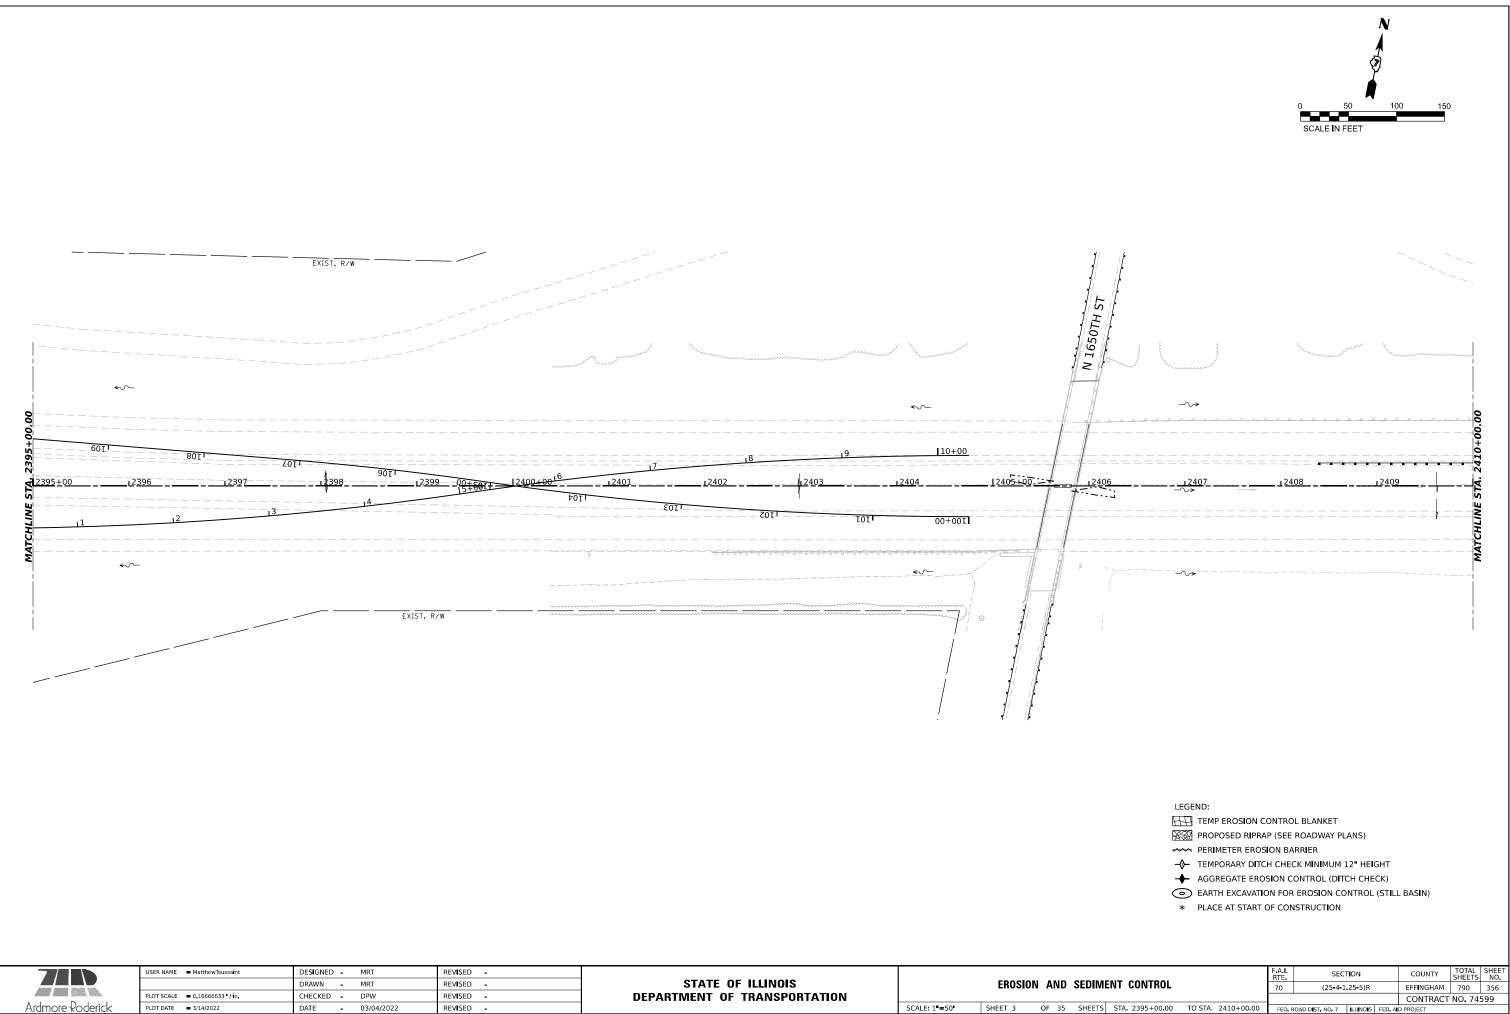
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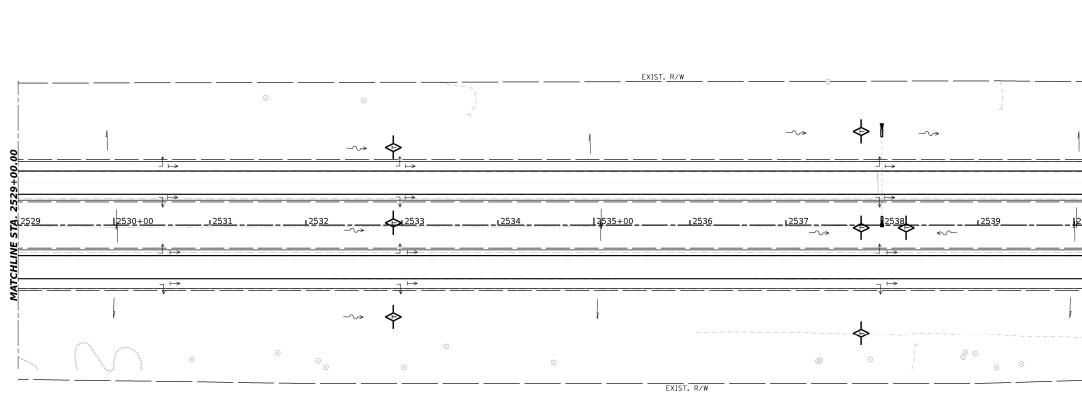





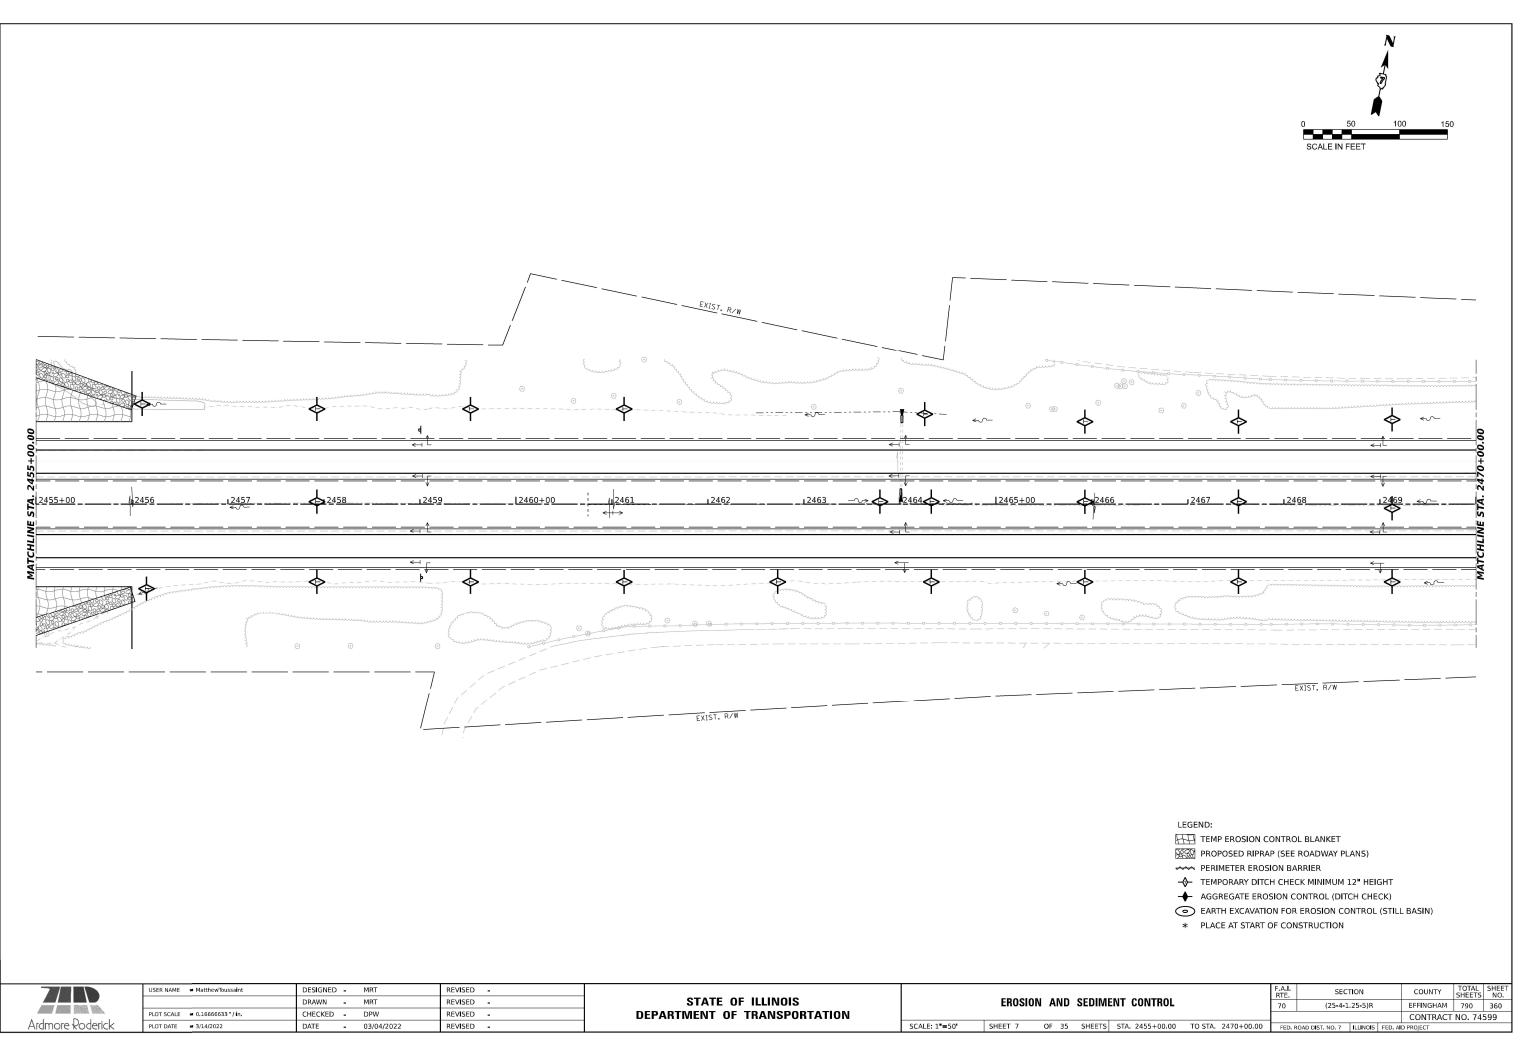


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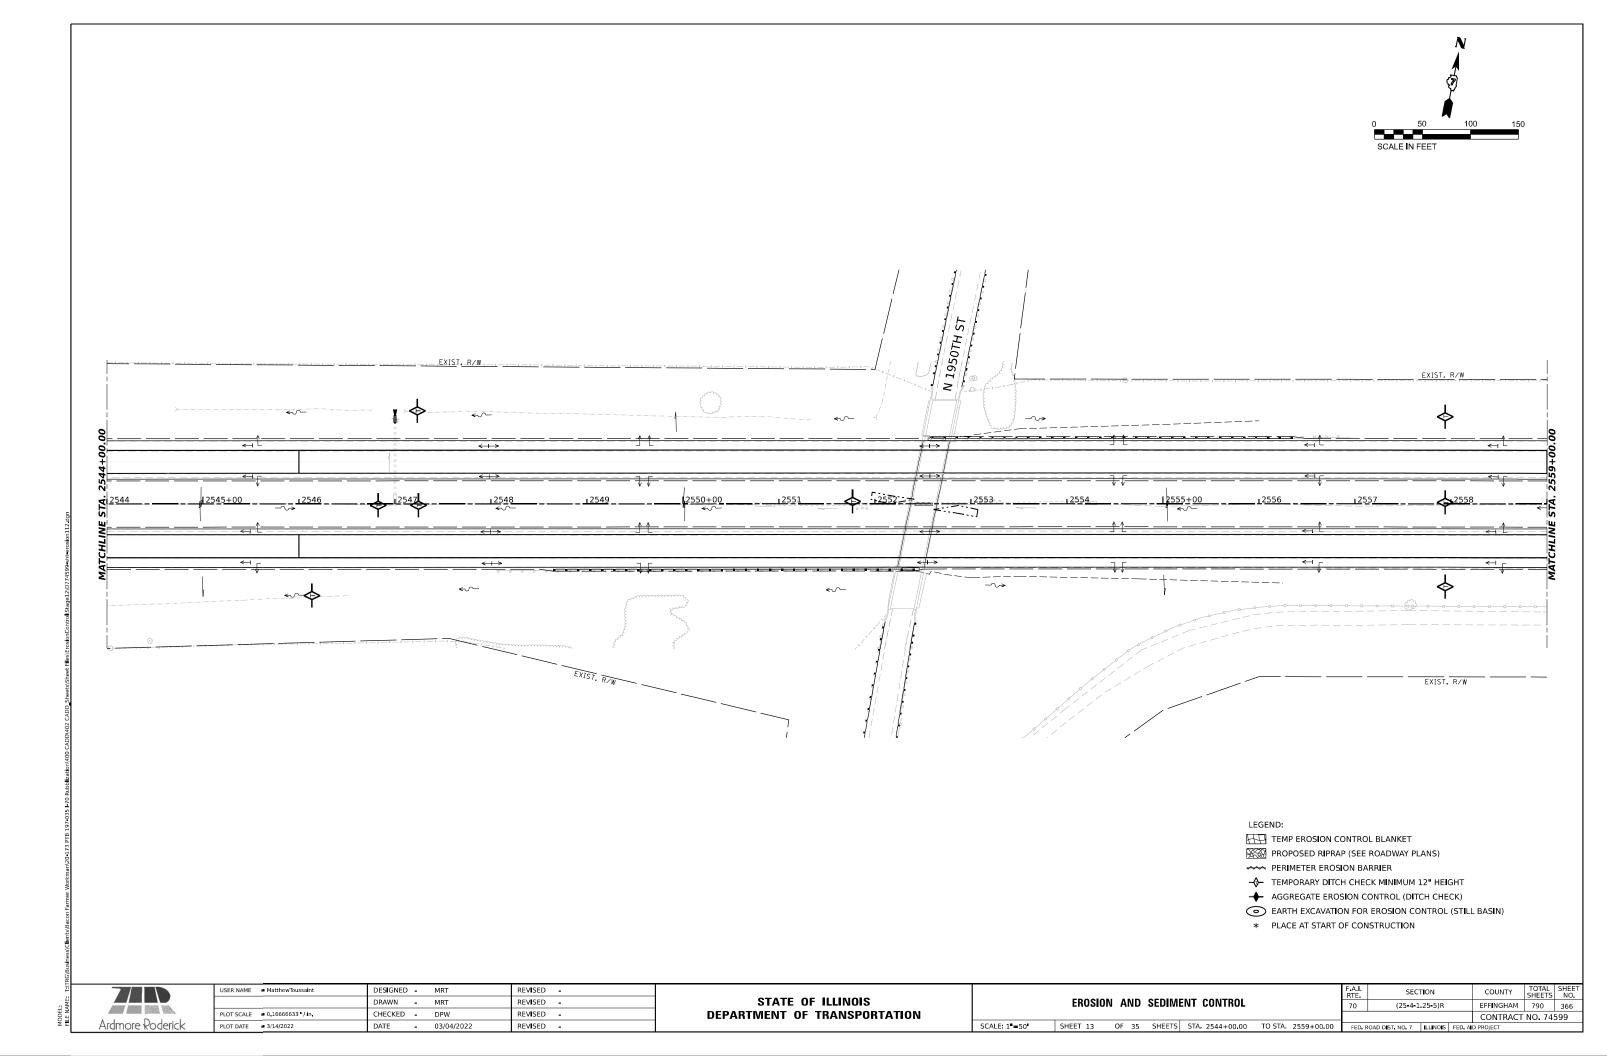




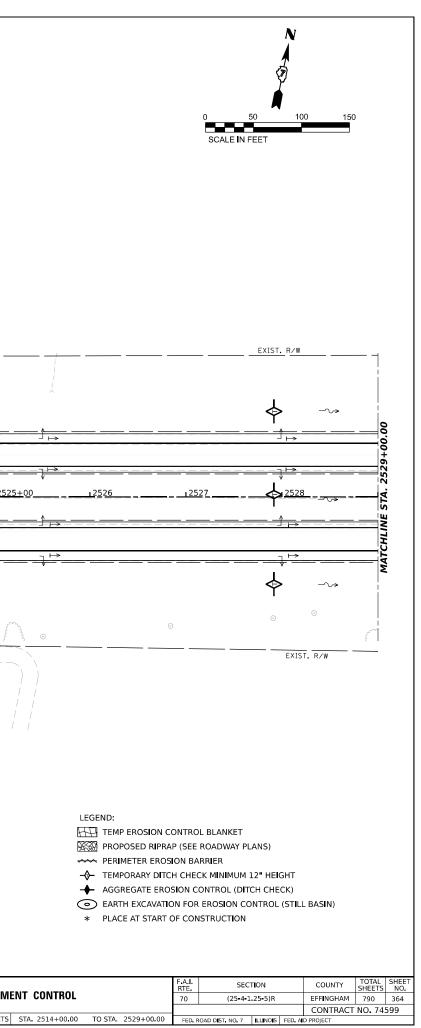

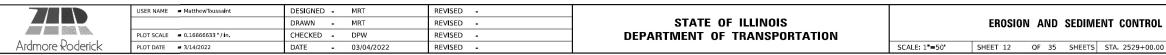

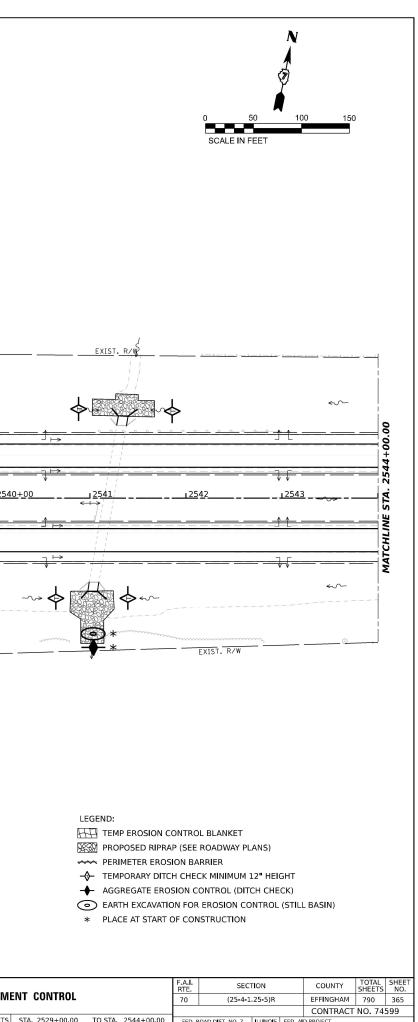
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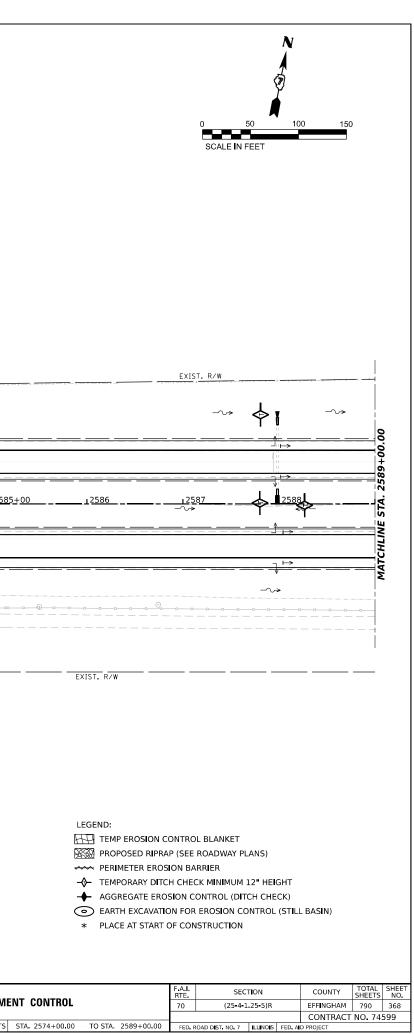
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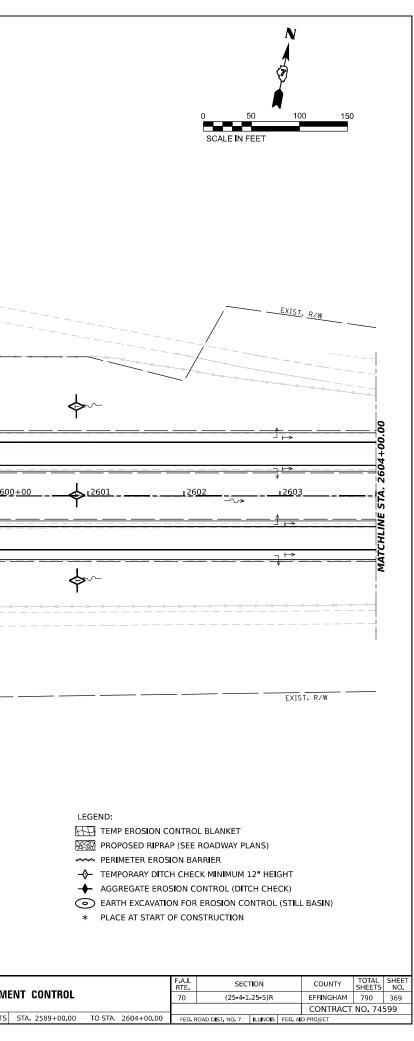



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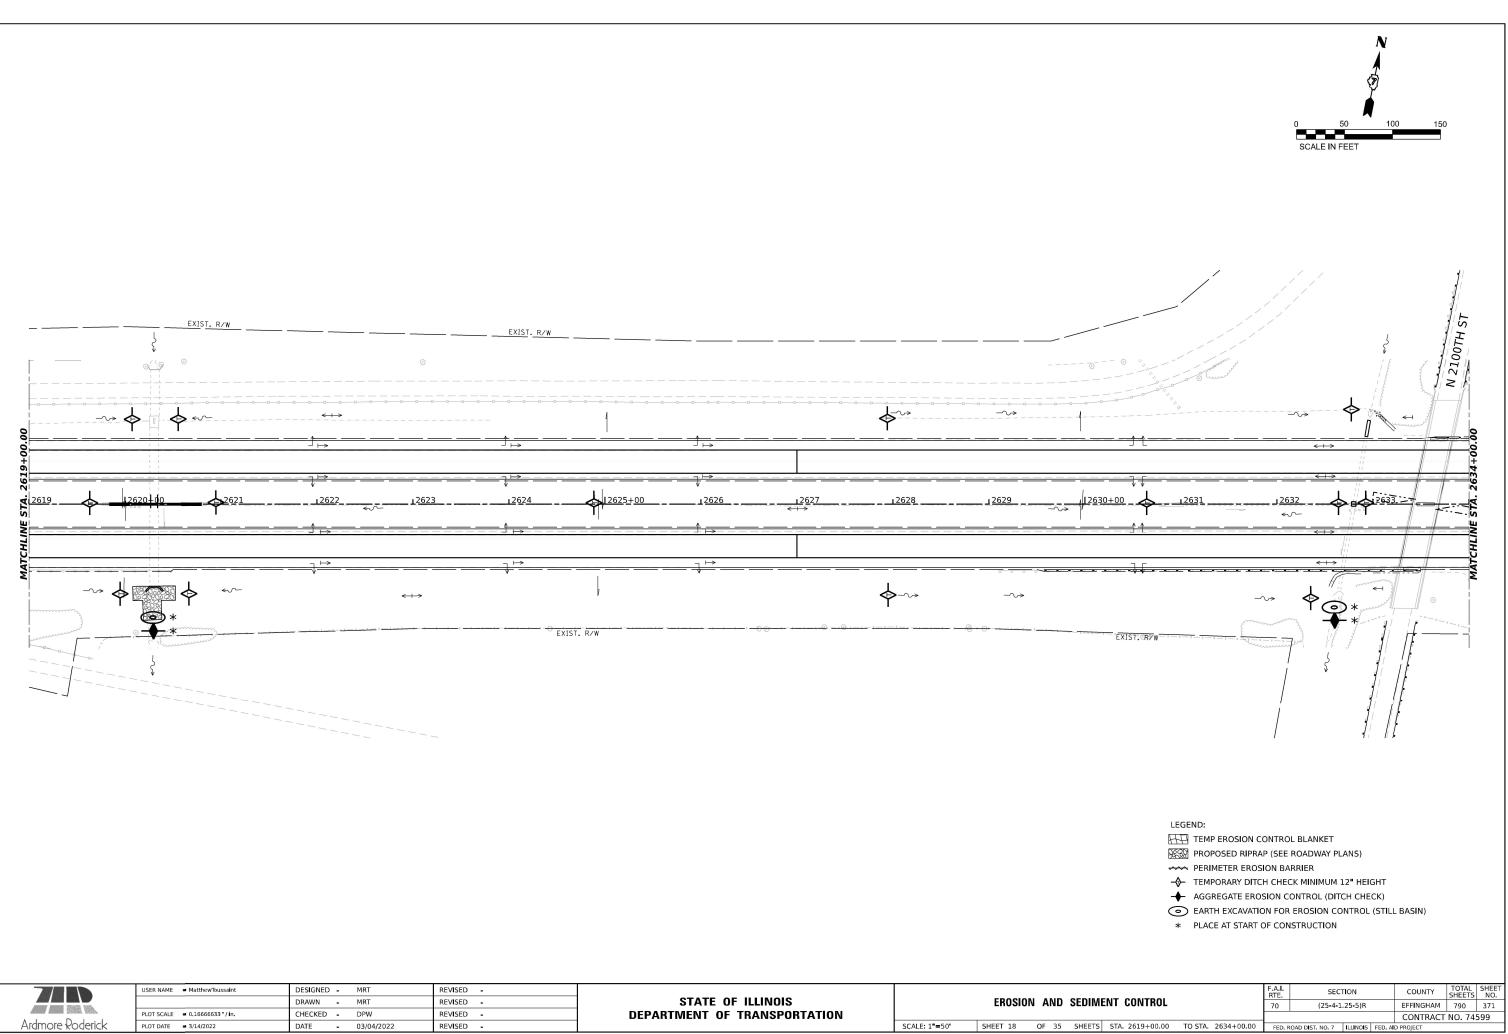
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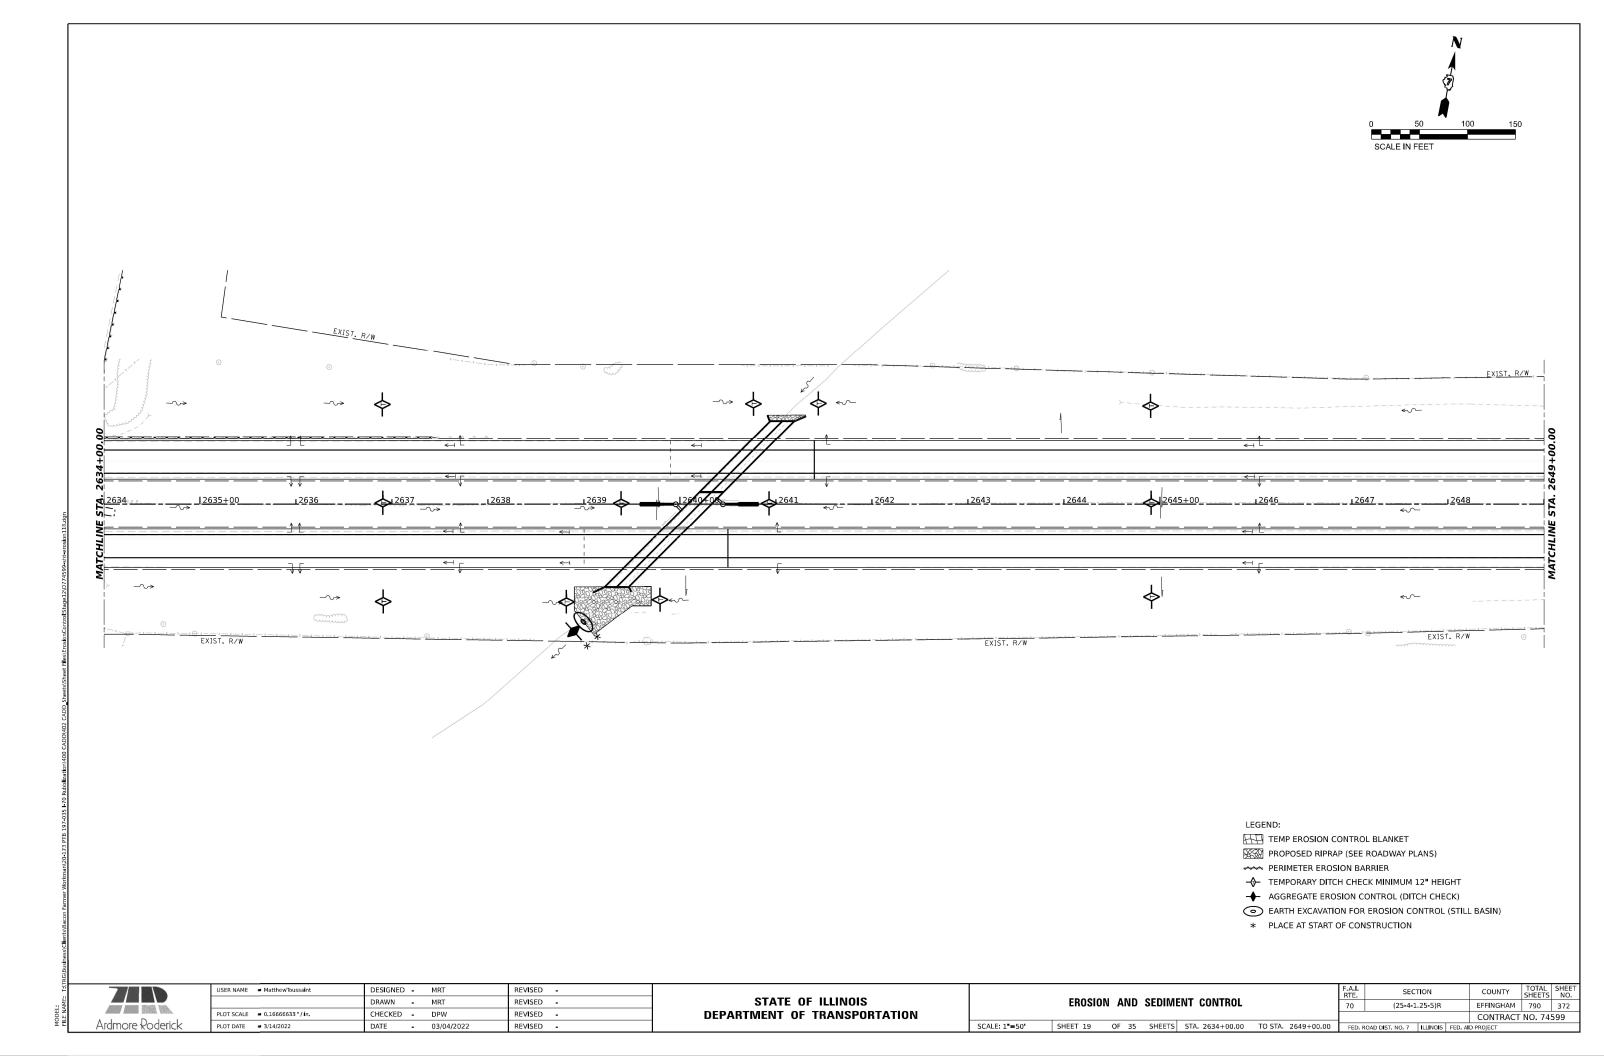
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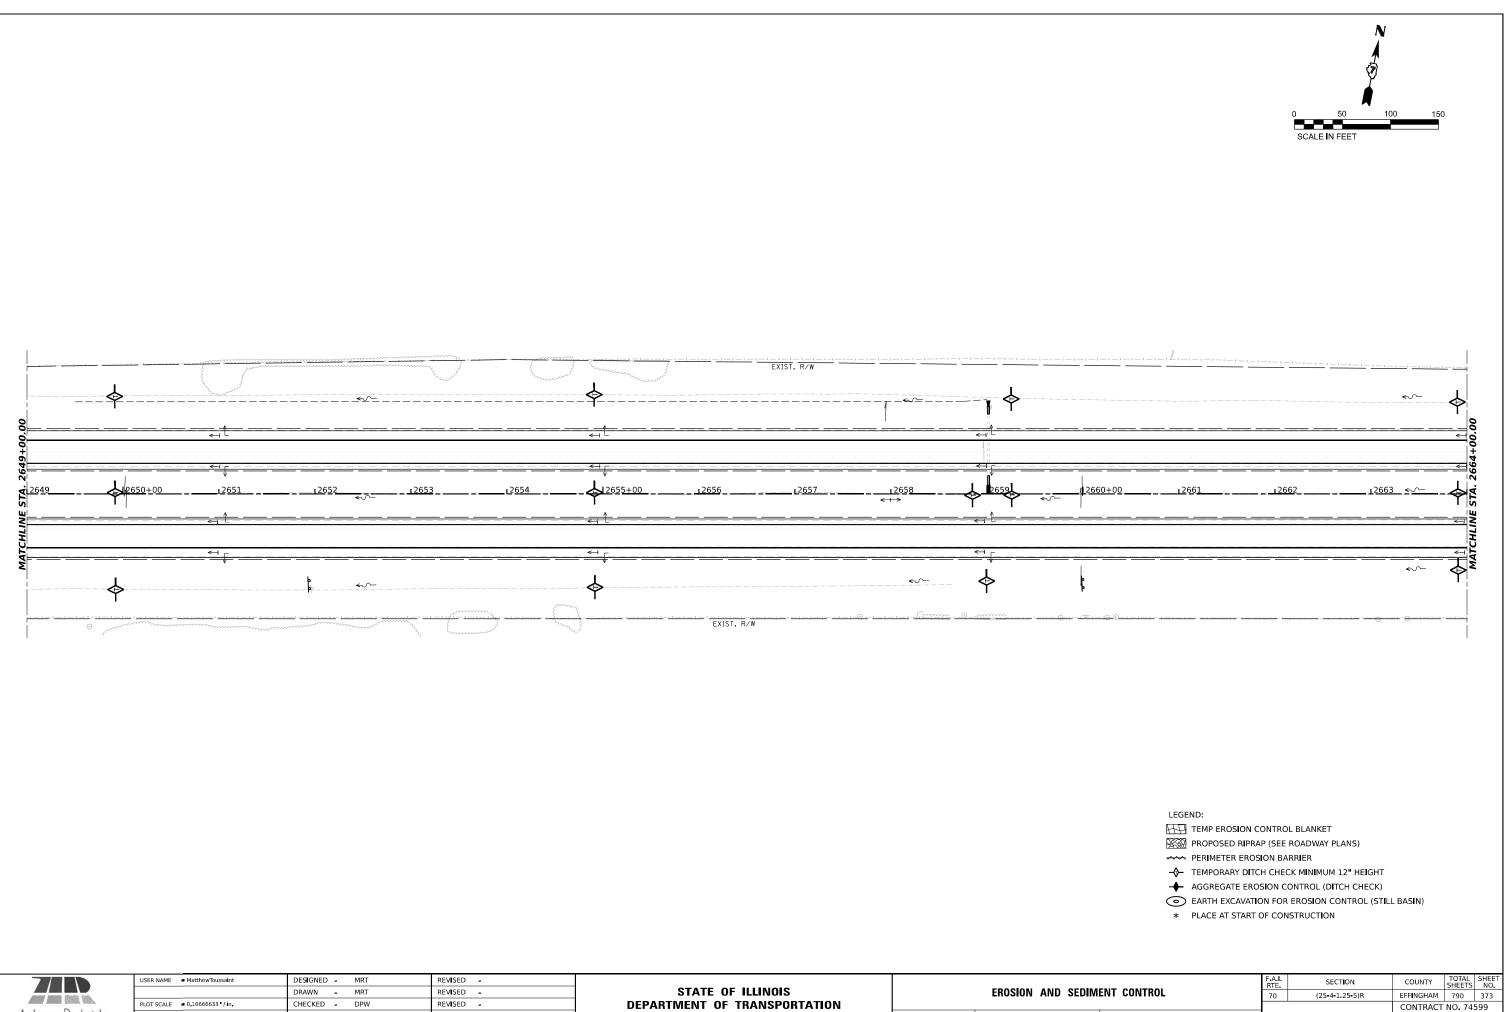
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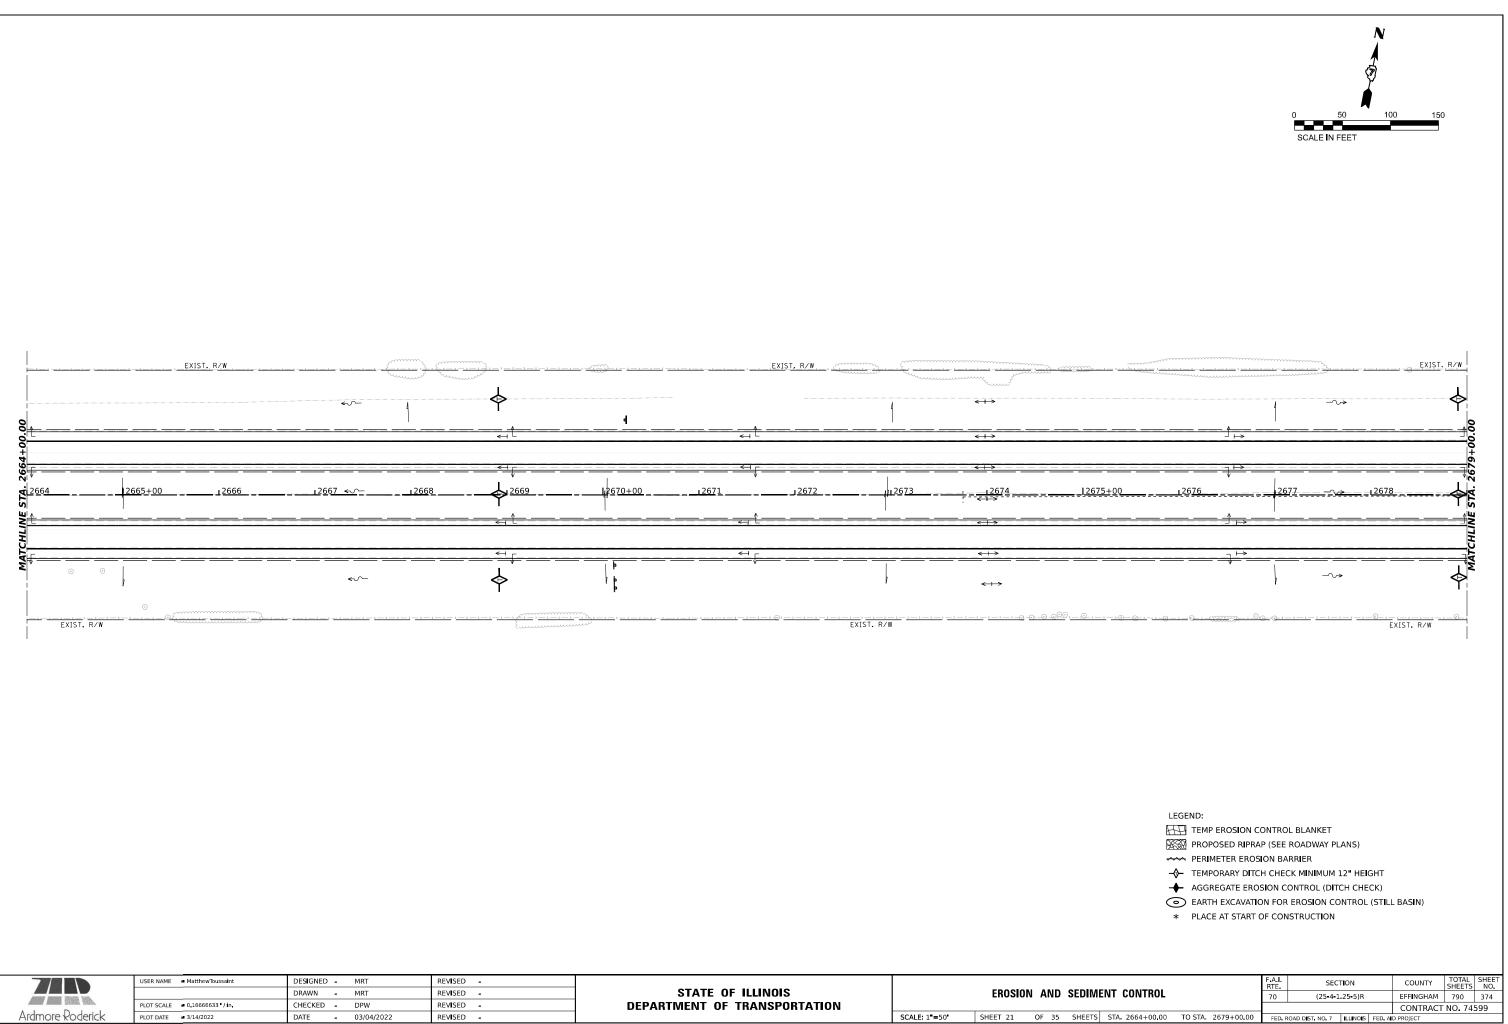
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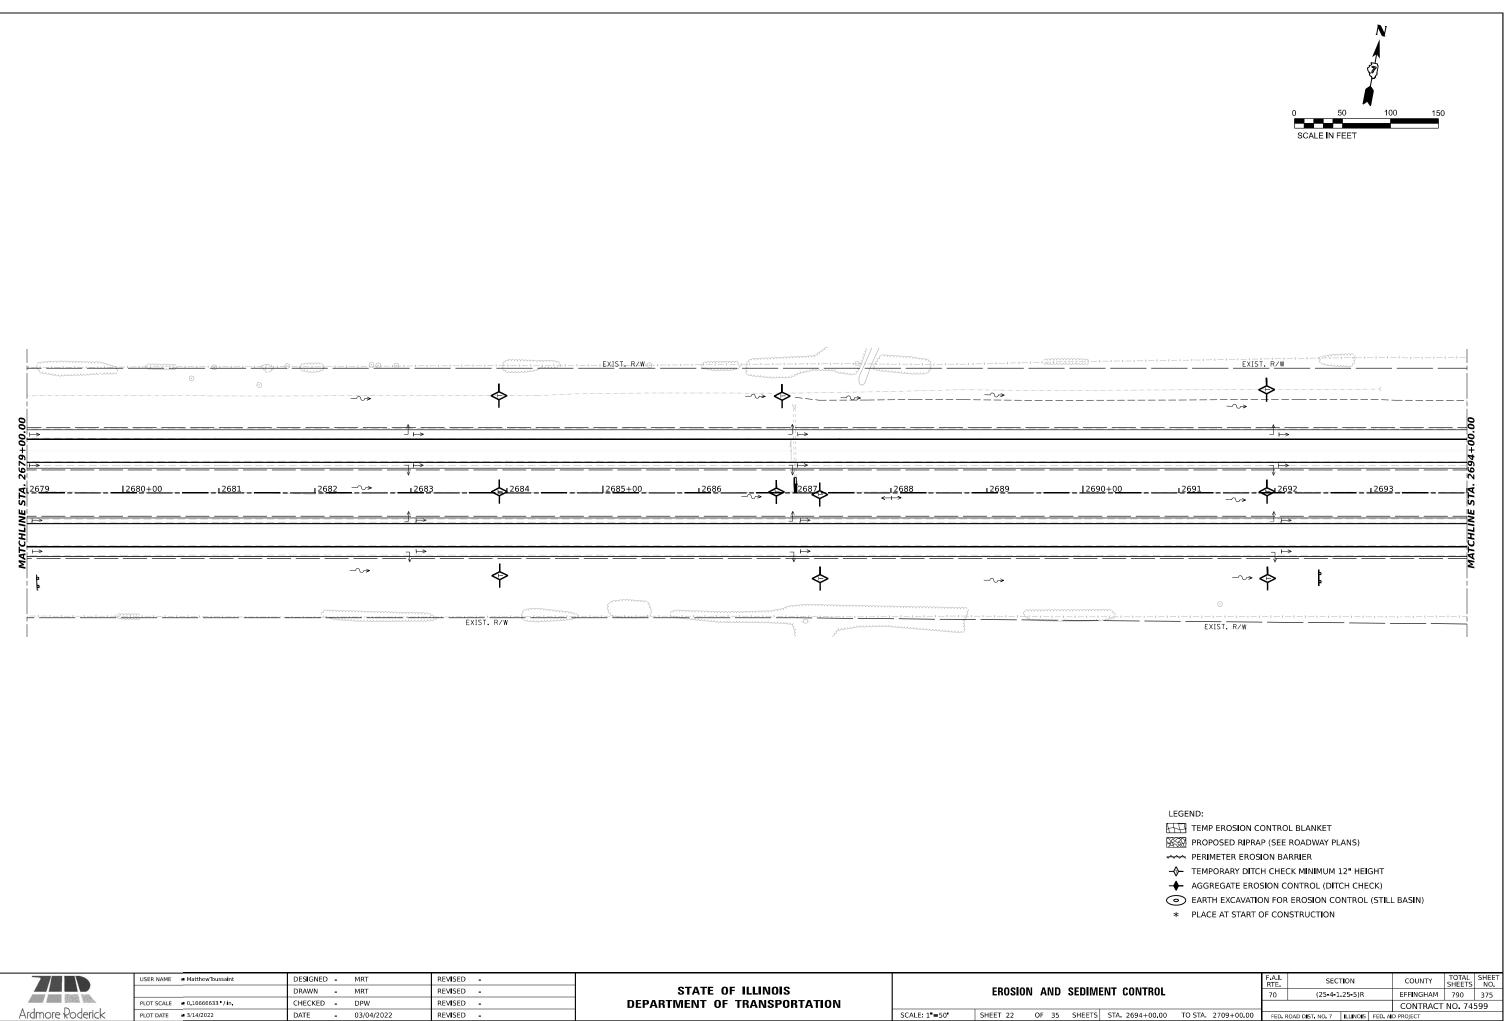
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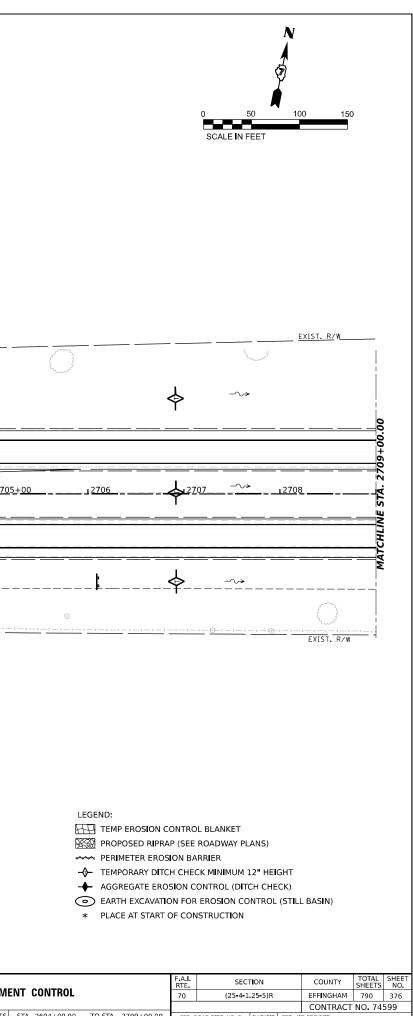
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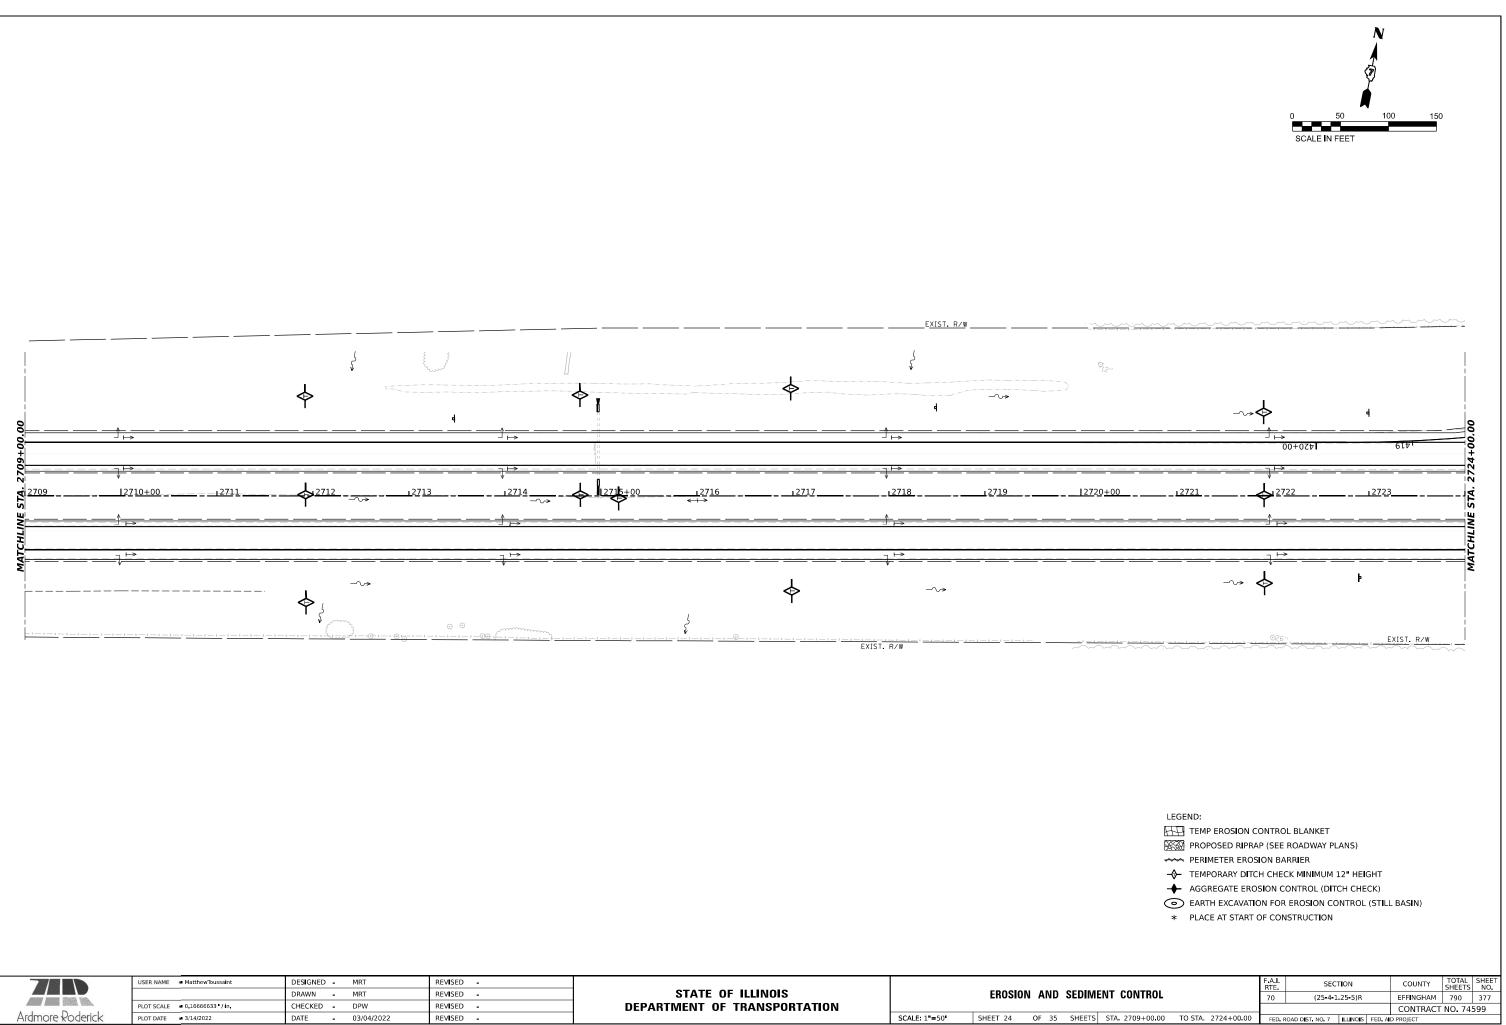
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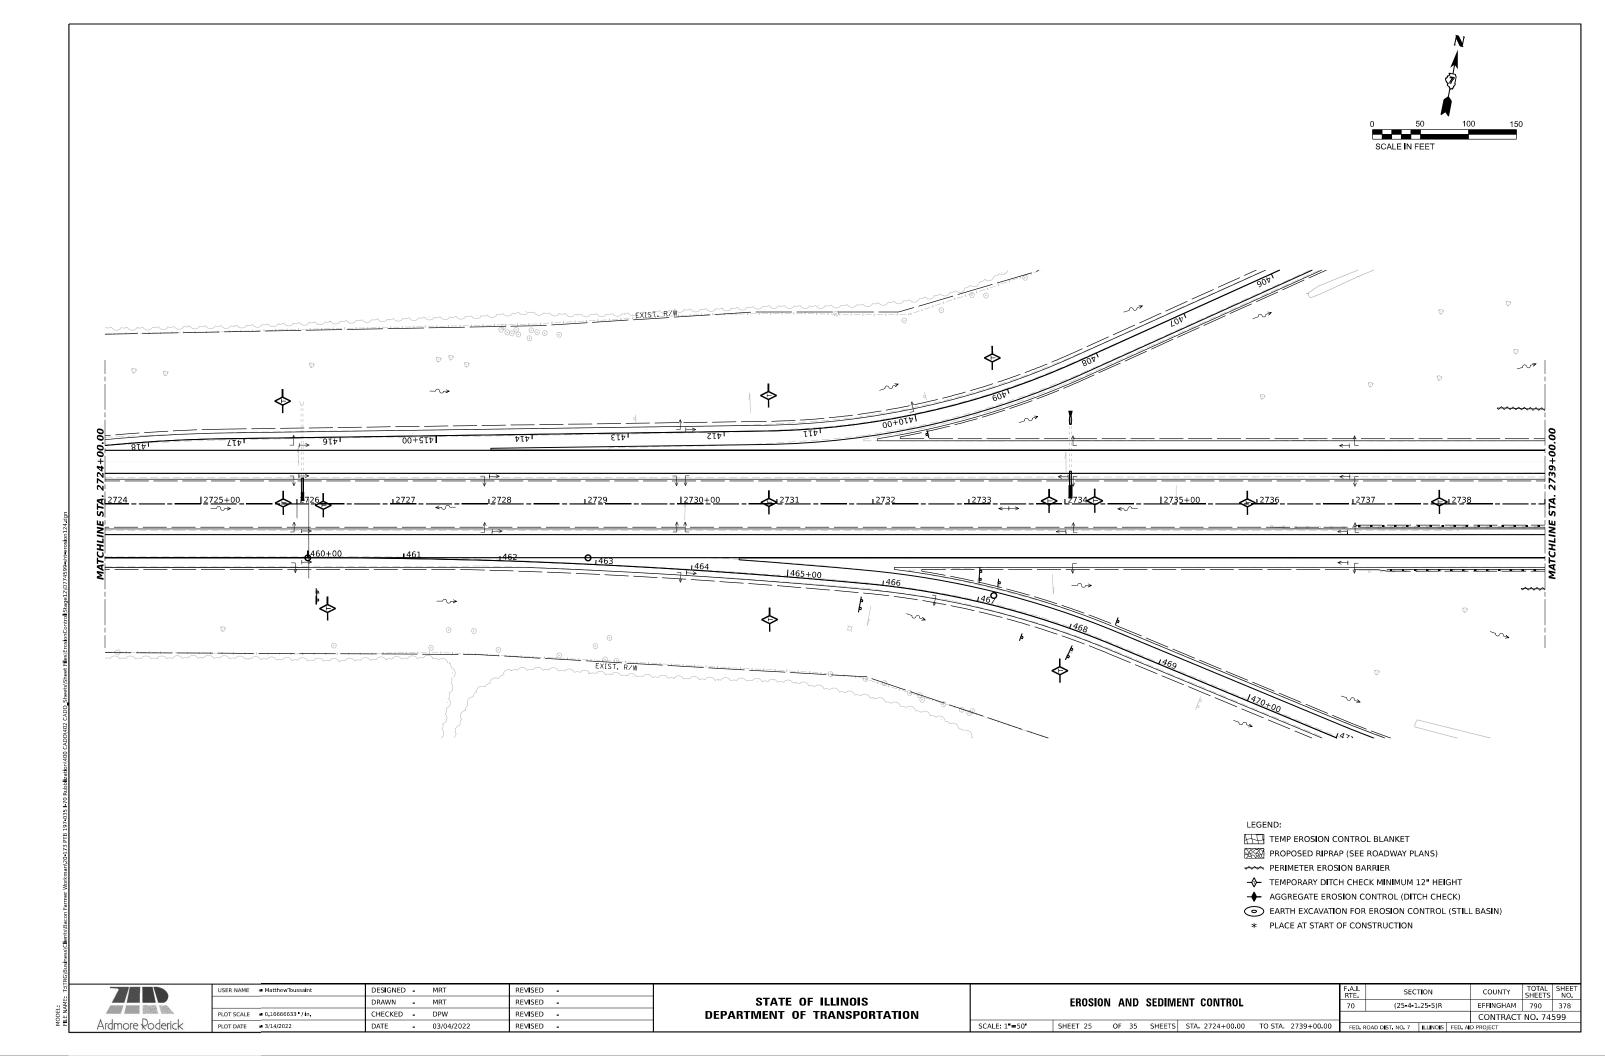
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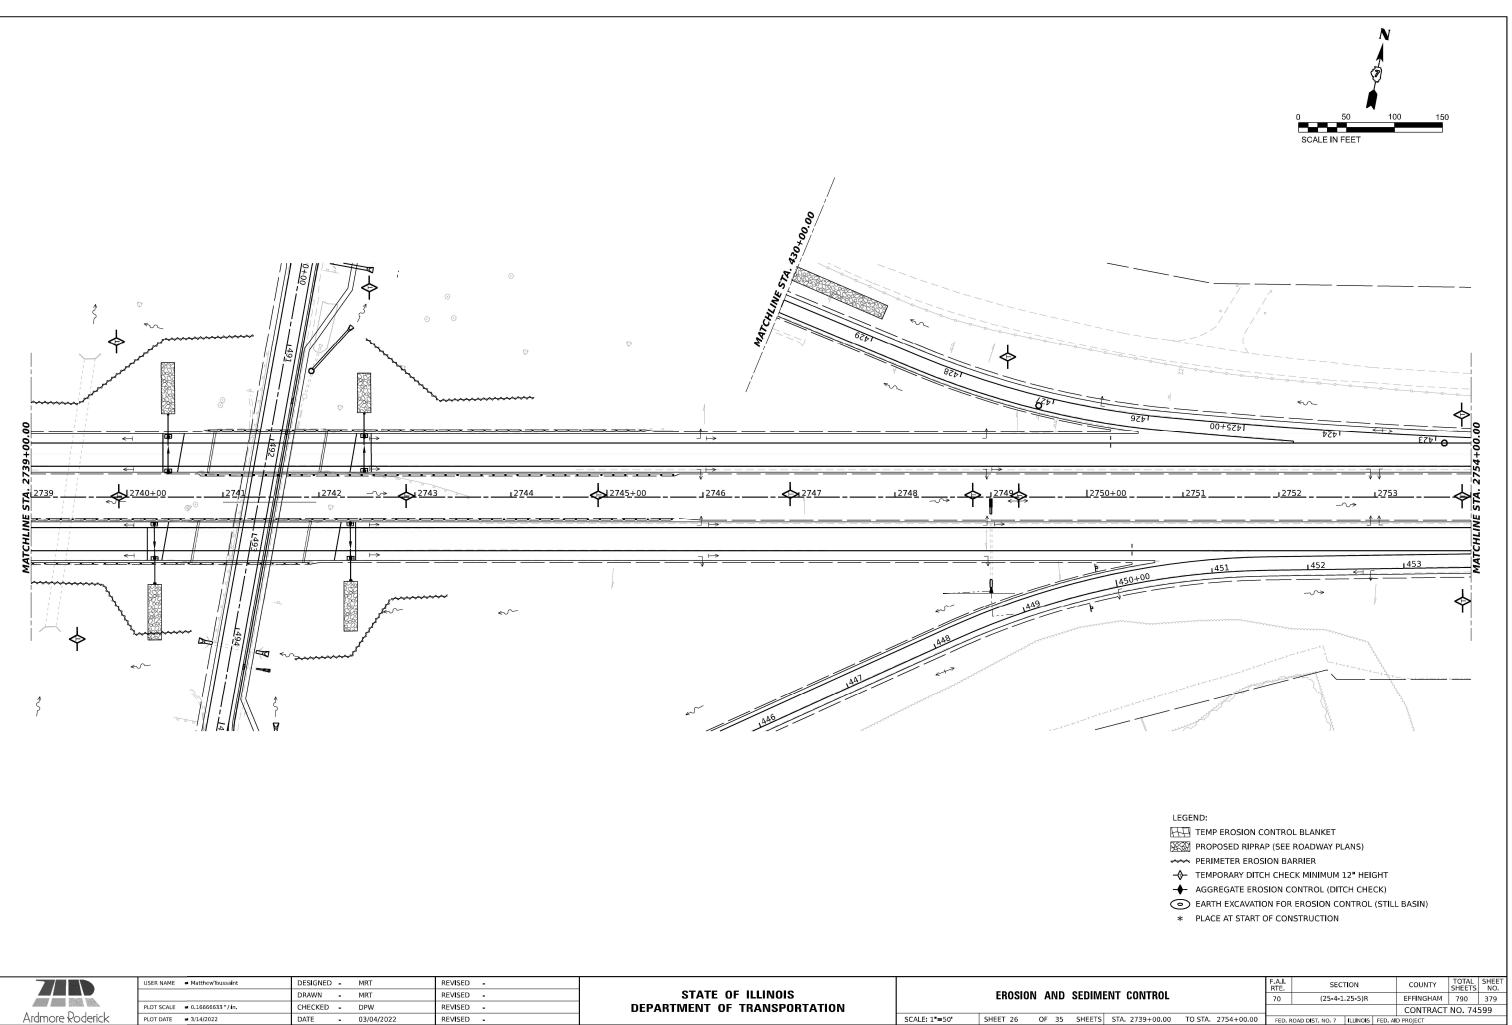


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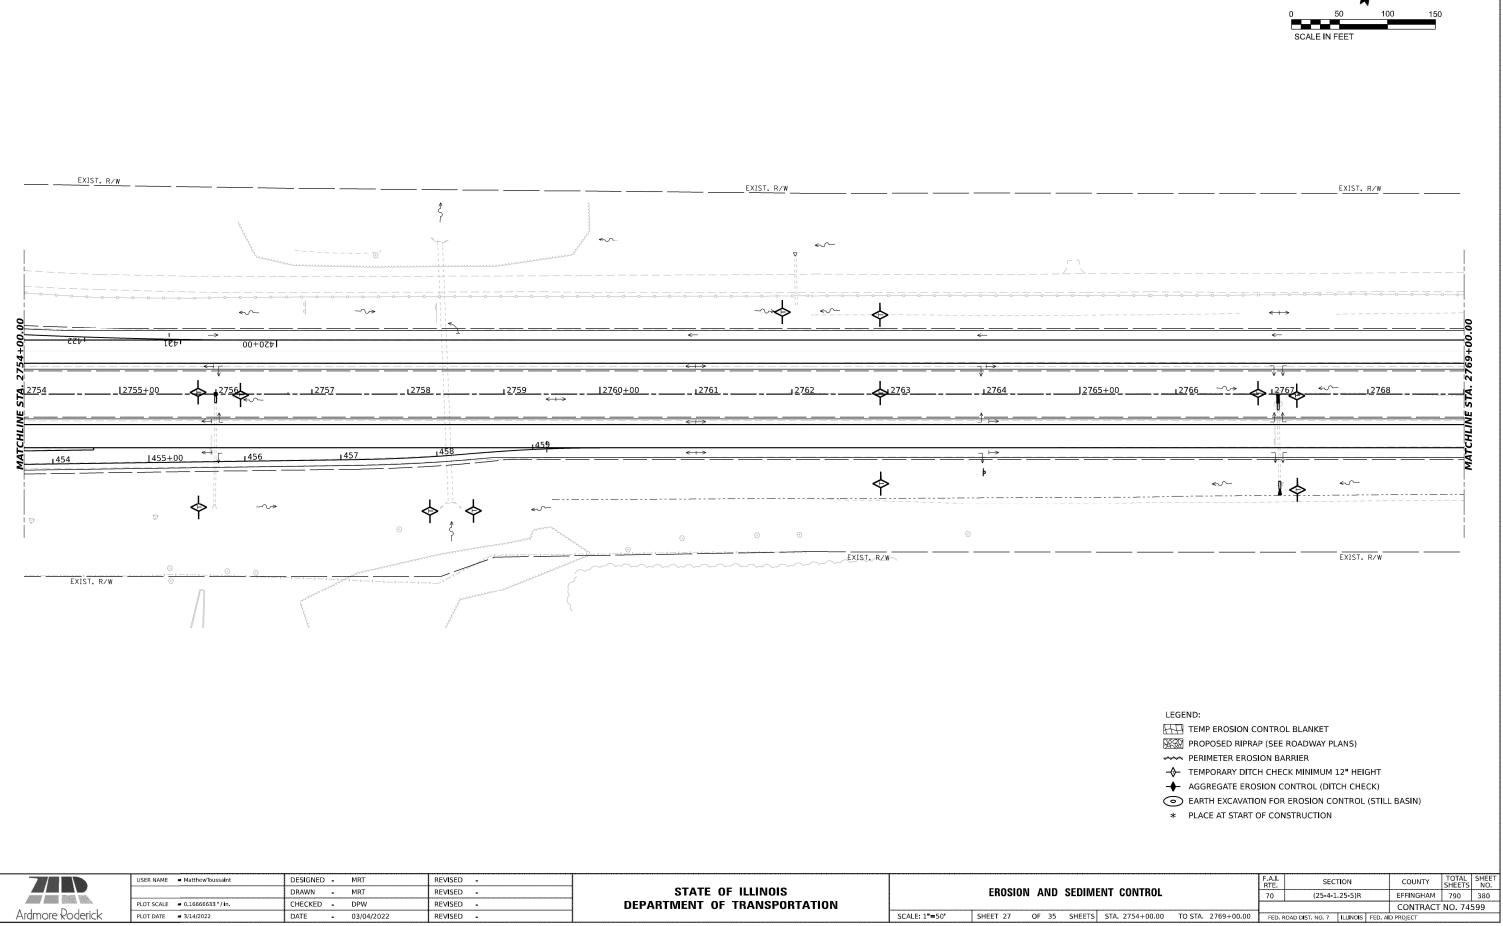


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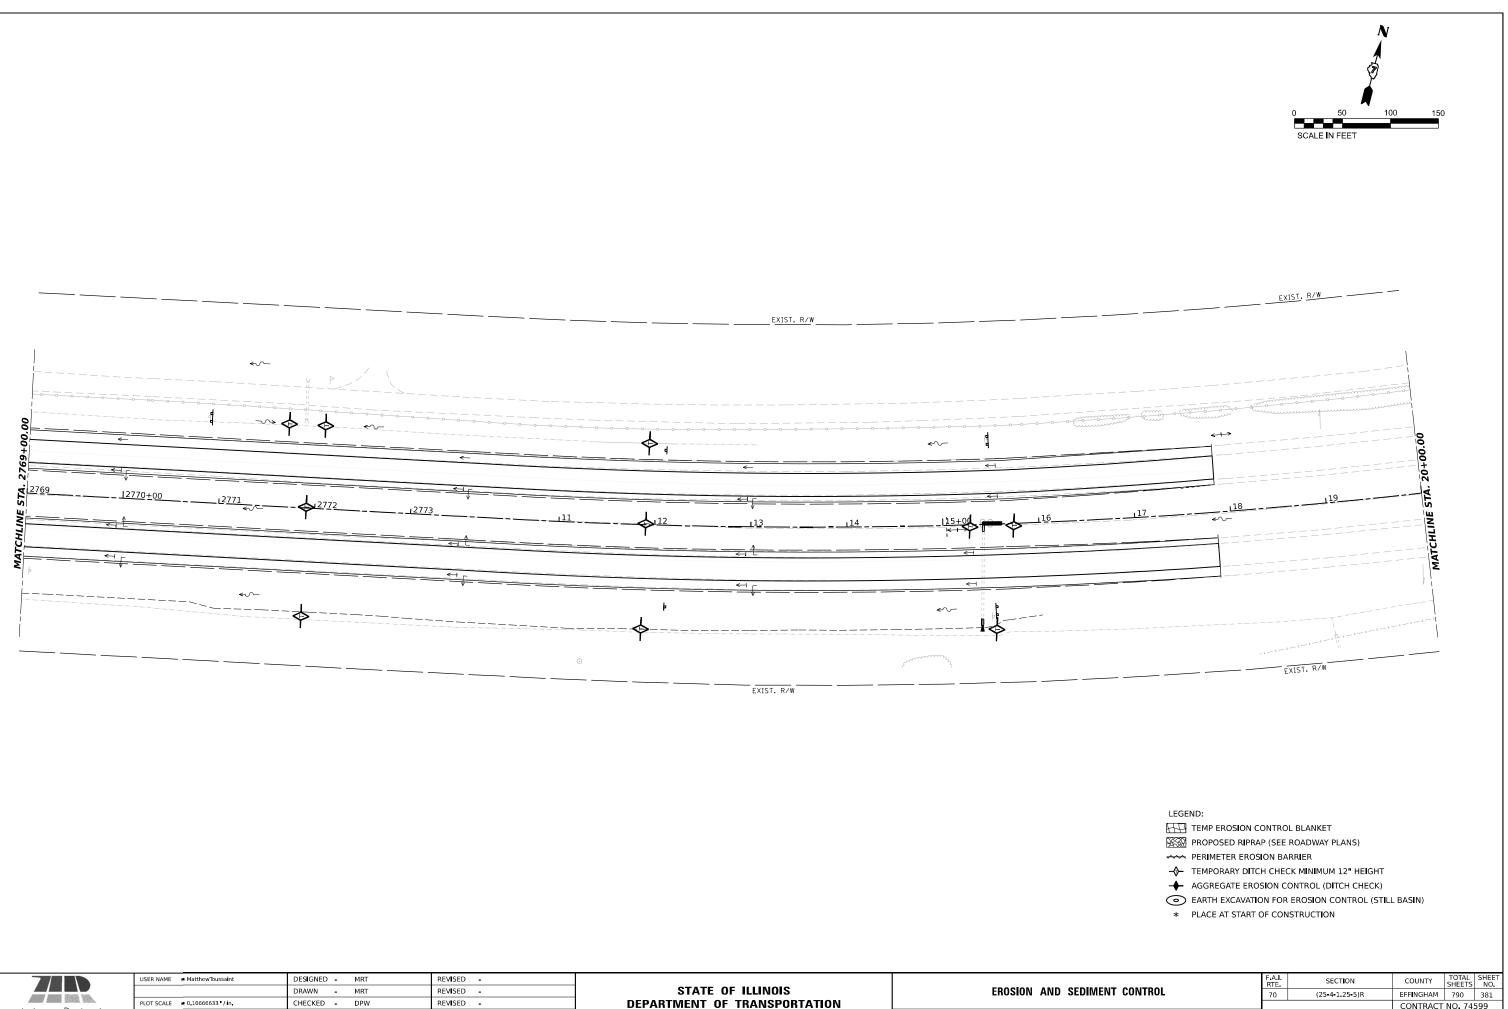


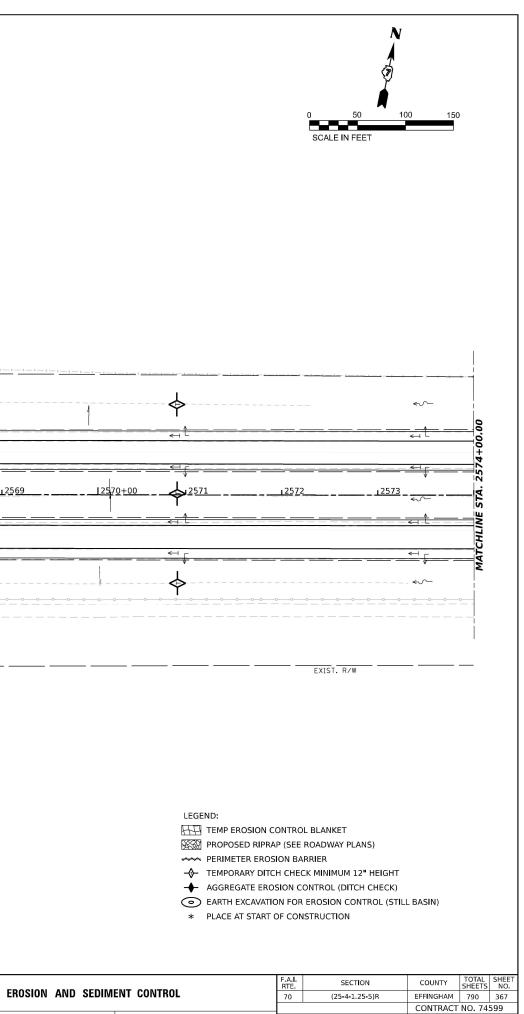

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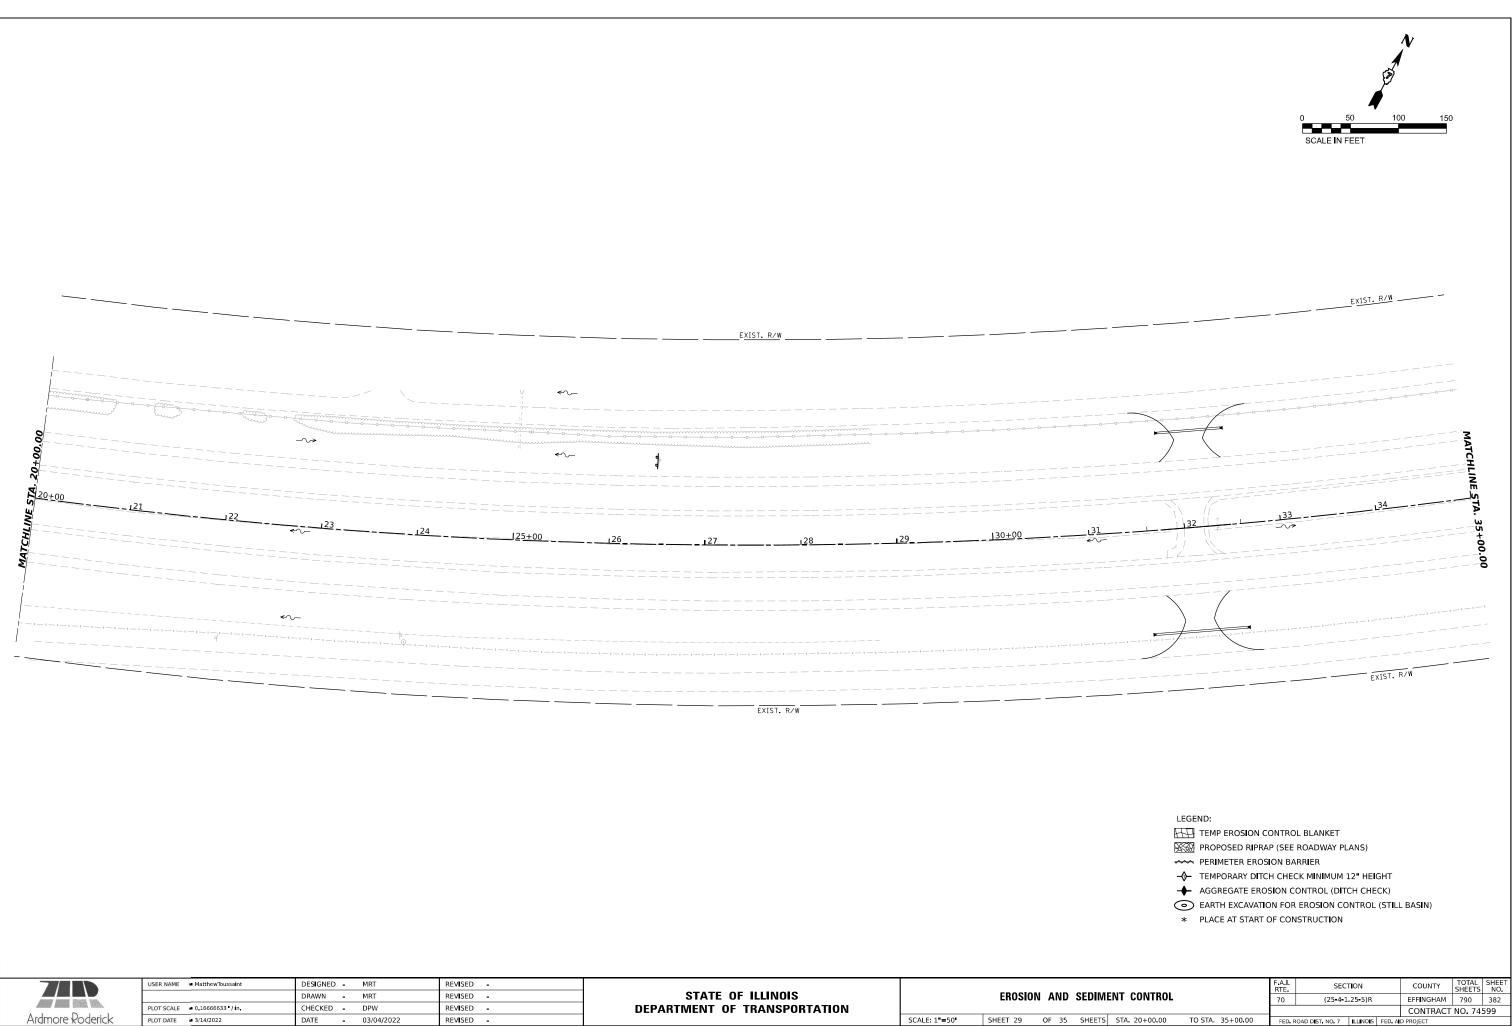


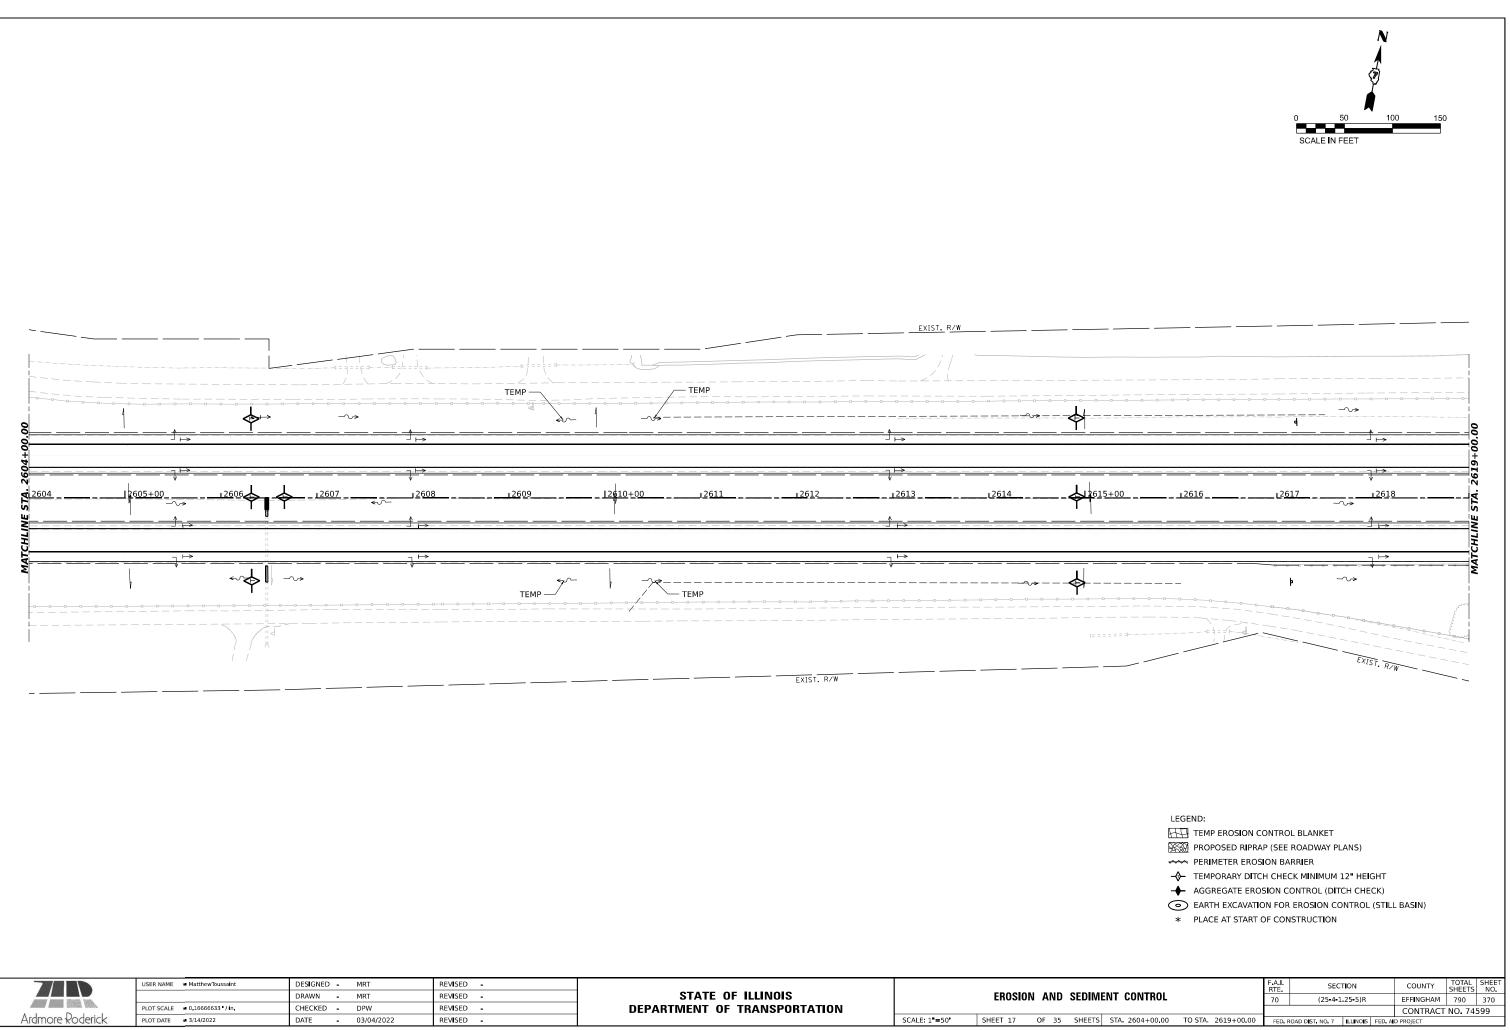
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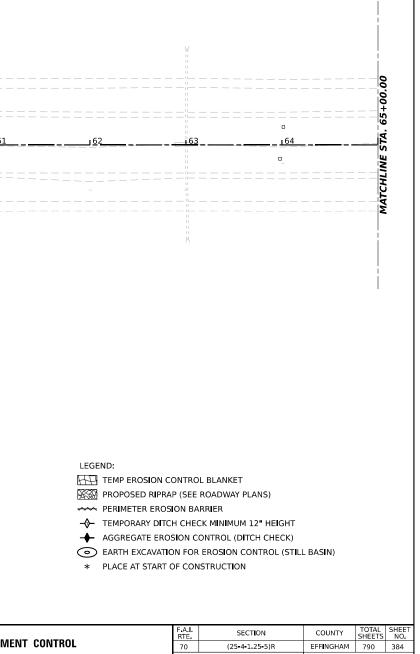
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		DRAWN - MRT	REVISED -	STATE OF ILLINOIS		EROSION	AND SEDIM	ENT CONTROL	-	-
	PLOT SCALE = 0.16666633 / in	CHECKED - DPW	REVISED -	DEPARTMENT OF TRANSPORTATION						-
oderick	PLOT DATE # 3/14/2022	DATE - 03/04/2022	REVISED -		SCALE: 1"=50"	SHEET 30	OF 35 SHEETS	STA. 35+00.00	TO STA. 50+00.00	-


				¥						
00-00 00+00 05	1503	1505	1201		-					
<b>V</b> <b>U</b> <b>U</b> <b>U</b> <b>U</b> <b>U</b> <b>U</b> <b>U</b> <b>U</b> <b>U</b> <b>U</b>	<u>152</u>	<u>_</u> <u>153</u>	54		<u>156</u>	<u>157 _</u>	158	<u>159</u> _	160+00	
MATCHI 				<u> 310+00</u>						


-	
5	
INAN	
	Ardmore Poo

	USER NAME  MatthewToussaint	DESIGNED - MRT	REVISED -							F.A.I. RTE	SECTION	COUNTY
AN 189.		DRAWN - MRT	REVISED -	STATE OF ILLINOIS		EROSIO	N AND SEDIN	ENT CONTROL		70	(25-4-1.25-5)R	EFFINGHAM
essa terra	PLOT SCALE 0 16666633 / in	CHECKED - DPW	REVISED -	DEPARTMENT OF TRANSPORTATION						_		CONTRAC
oderick	PLOT DATE # 3/14/2022	DATE - 03/04/2022	REVISED -		SCALE: 1"=50"	SHEET 31	OF 35 SHEETS	STA. 50+00.00	TO STA. 65+00.00	FED. RC	DAD DIST. NO. 7 ILLINOIS FED. AL	D PROJECT

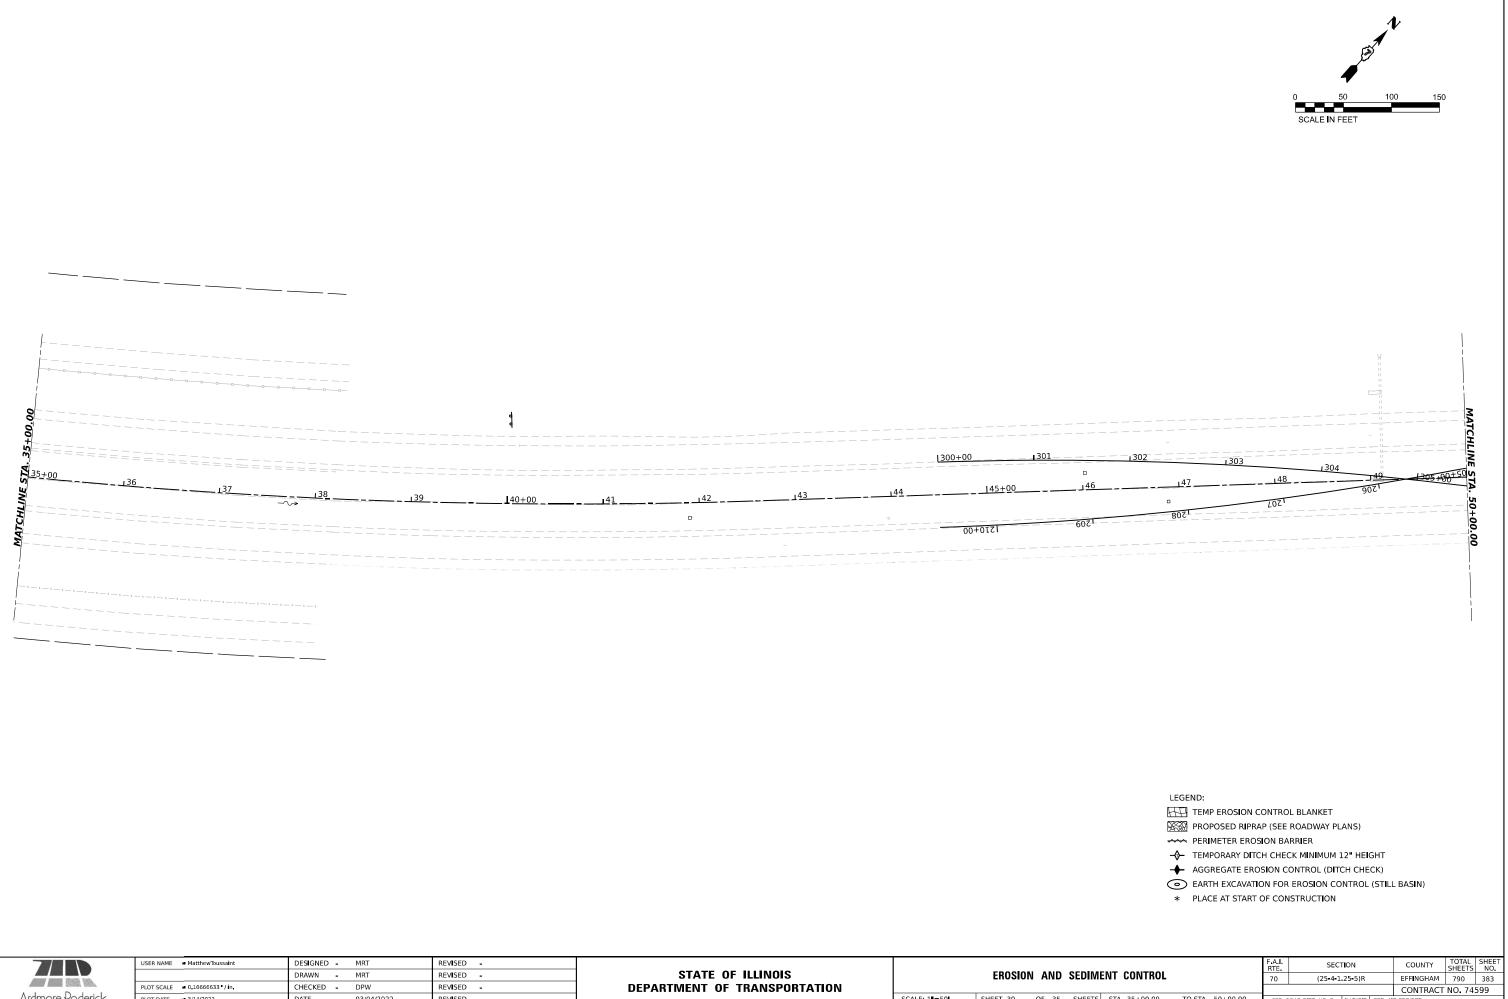


CONTRACT NO. 74599

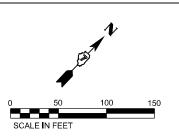

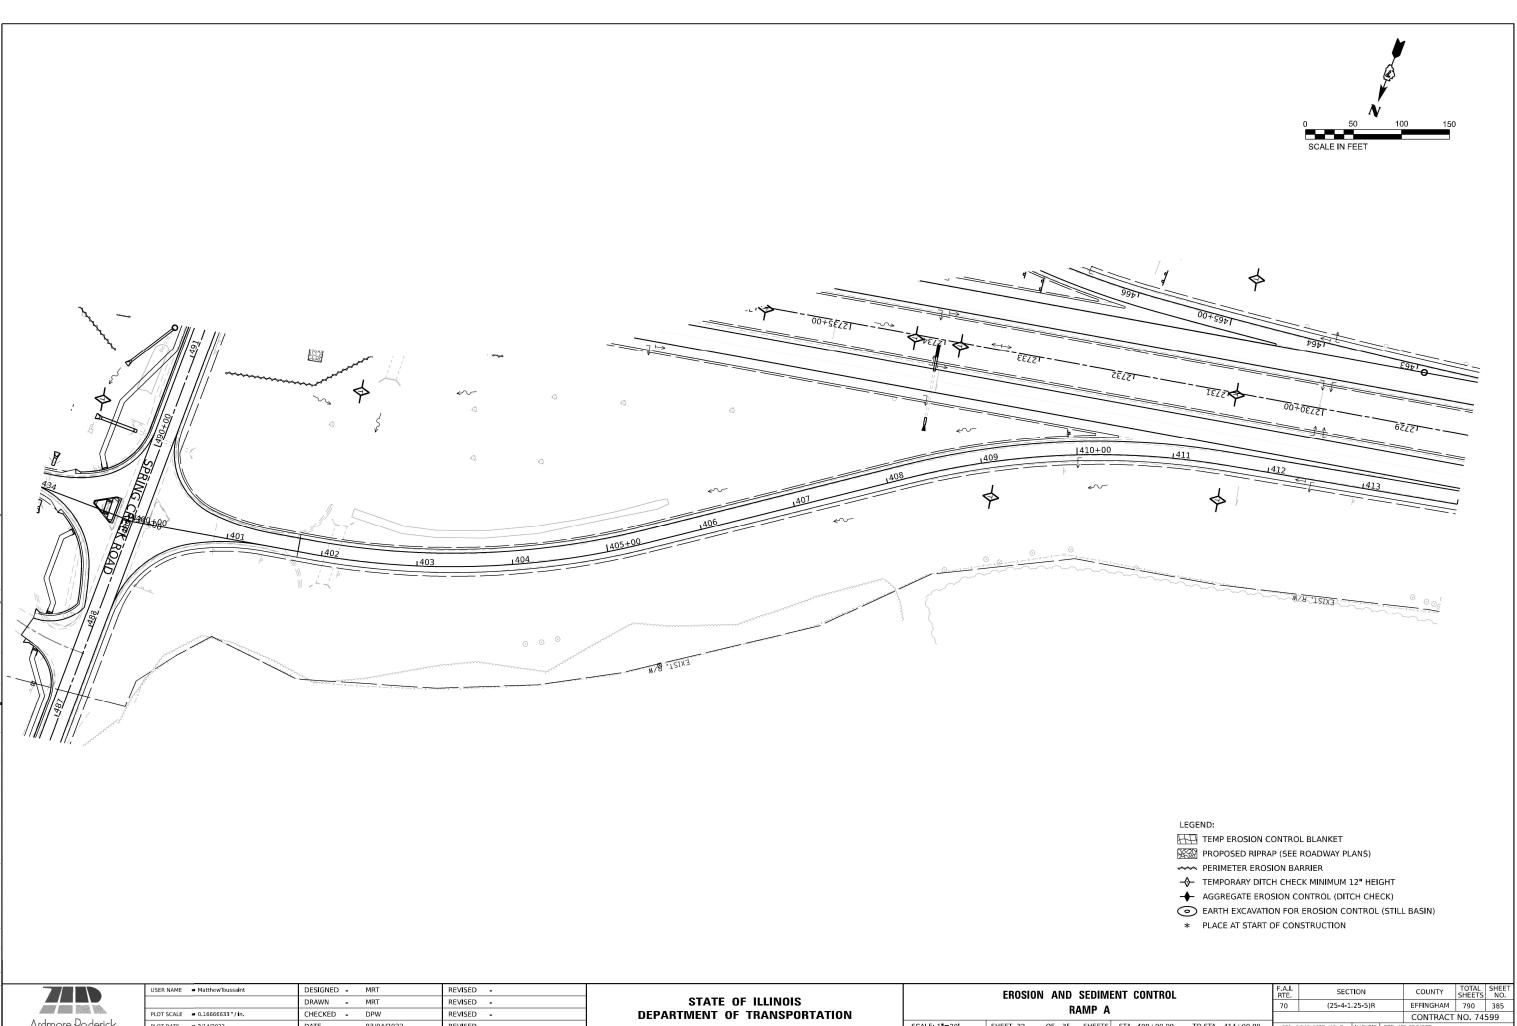

	USER NAME   MatthewToussaint	DESIGNED - MRT	REVISED -			FROS	ον ανσ	SEDIM	ENT CONTROL		F.A.I. BTE.	SECTION	COUNTY
		DRAWN - MRT	REVISED -	STATE OF ILLINOIS		LIIOOI					70	(25-4-1.25-5)R	EFFINGHAM
	PLOT SCALE = 0.16666633 '/in.	CHECKED - DPW	REVISED -	DEPARTMENT OF TRANSPORTATION				RAMP A					CONTRAC
Ardmore Roderick	PLOT DATE = 3/14/2022	DATE - 03/04/2022	REVISED -		SCALE: 1"=20"	SHEET 32	OF 35	SHEETS	STA. 400+00.00	TO STA. 414+00.00	FED. ROAD	DIST. NO. 7 ILLINOIS FED. A	AD PROJECT

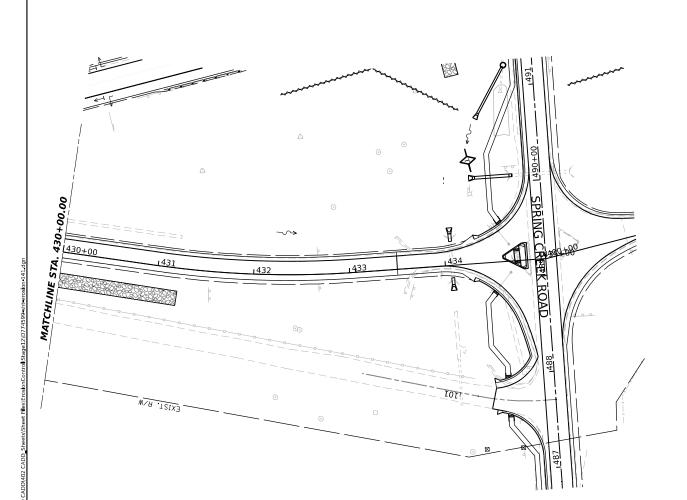

	USER NAME  MatthewToussaint	DESIGNED - MRT	REVISED -		EROSION AND SEDIMENT CONTROL	F.A.I. SECTION COUNTY SHEET	L SHEET
		DRAWN - MRT	REVISED -	STATE OF ILLINOIS		70 (25-4-1.25-5)R EFFINGHAM 790	386
	PLOT SCALE = 0.16666633 / in	CHECKED - DPW	REVISED -	DEPARTMENT OF TRANSPORTATION	RAMP B	CONTRACT NO. 7	74599
Ardmore Roderick	PLOT DATE = 3/14/2022	DATE - 03/04/2022	REVISED -		SCALE: 1"=20" SHEET 33 OF 35 SHEETS STA. 430+00.00 TO STA.	FED. ROAD DIST. NO. 7 ILLINOIS FED. AID PROJECT	

L	EC	δE	NI	D:

HT TEMP EROSION CONTROL BLANKET


----- PERIMETER EROSION BARRIER


- TEMPORARY DITCH CHECK MINIMUM 12" HEIGHT

→ AGGREGATE EROSION CONTROL (DITCH CHECK)


EARTH EXCAVATION FOR EROSION CONTROL (STILL BASIN)

\* PLACE AT START OF CONSTRUCTION

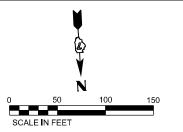

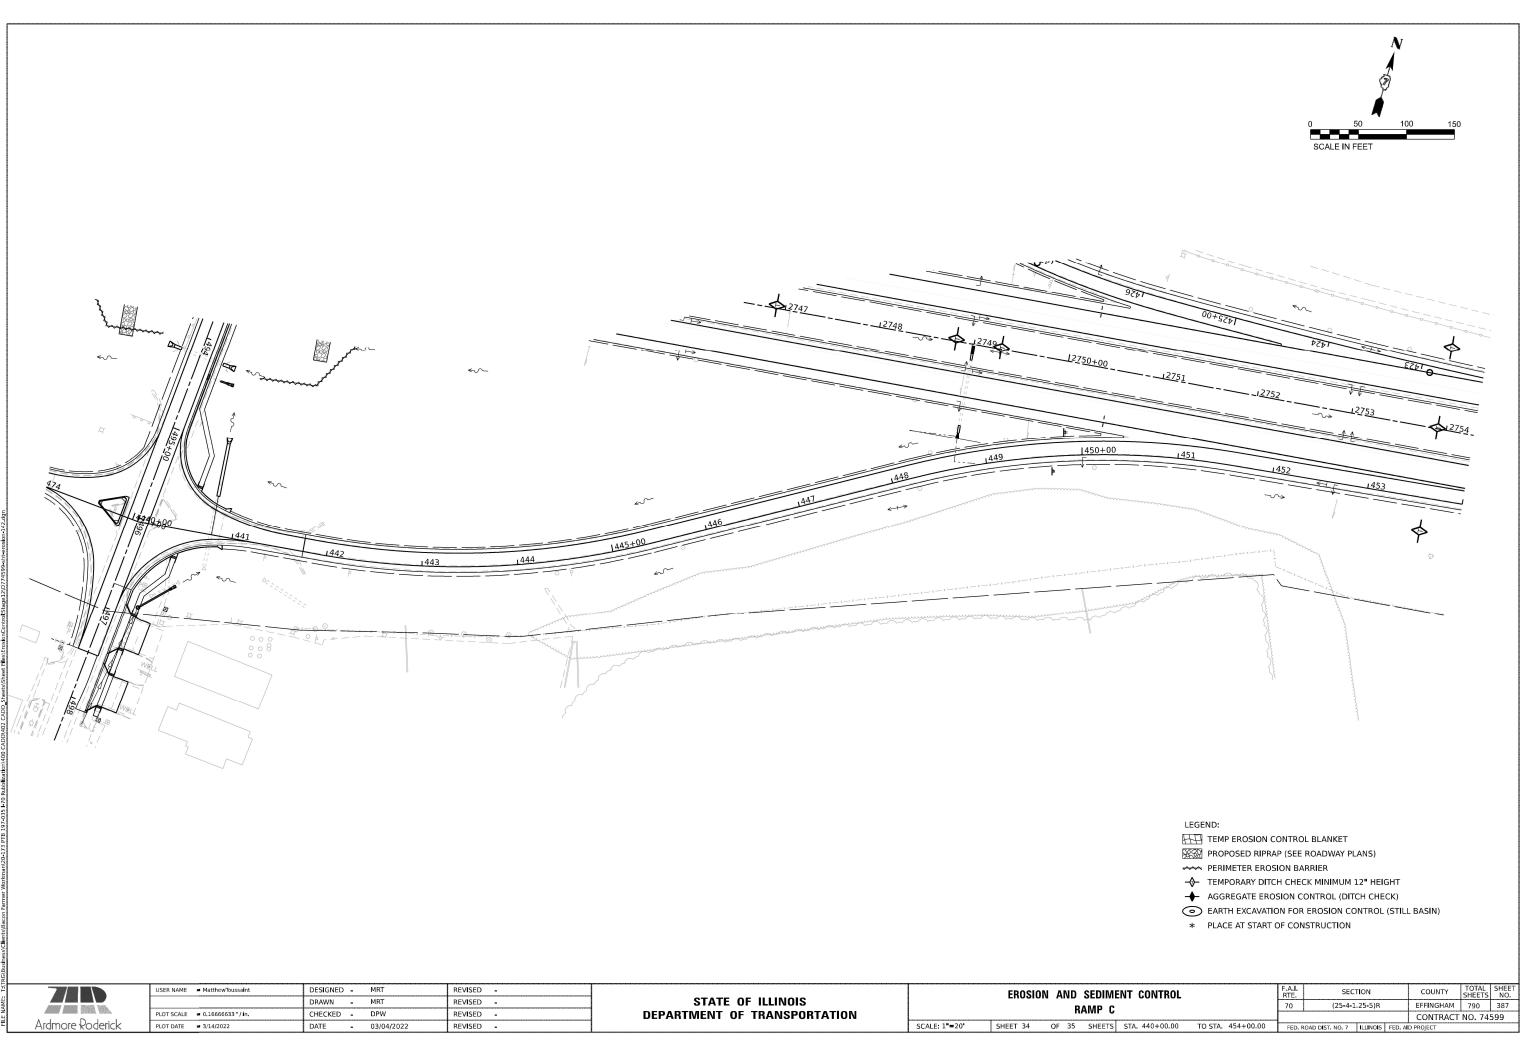

			INIL.					JULLID		
r			70	(25-4-1	.25-5)R		EFFINGHAM	790	387	
							CONTRACT	NO. 74	599	
ΞTS	STA. 440+00.00	TO STA. 454+00.00	FED. P	OAD DIST, NO. 7	ILLINOIS	FED. A	D PROJECT			
										î

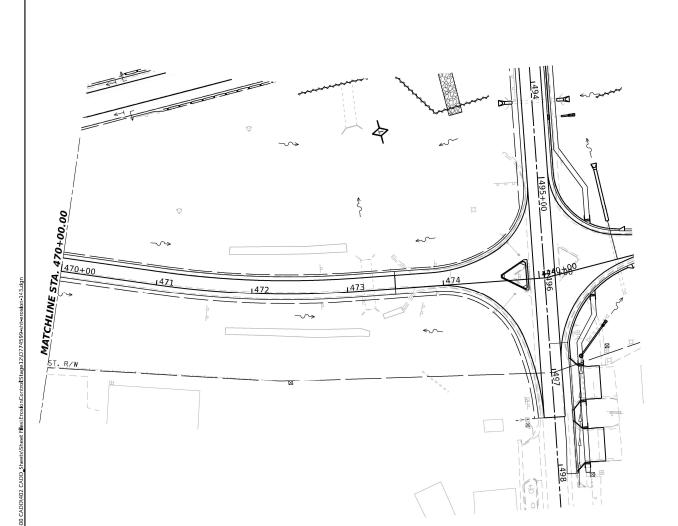

	USER NAME  MatthewToussaint	DESIGNED - MRT	REVISED -			EROSION AND SEDIM	ENT CONTROL		F.A.I. BTE	SECTION	COUNTY TOTAL SHEET
		DRAWN - MRT	REVISED -	STATE OF ILLINOIS		RAMP D			70	(25-4-1.25-5)R	EFFINGHAM 790 388
	PLOT SCALE = 0.16666633 '/in.	CHECKED - DPW	REVISED -	DEPARTMENT OF TRANSPORTATION		RAIVIF D					CONTRACT NO. 74599
Ardmore <del>R</del> oderick	PLOT DATE = 3/14/2022	DATE - 03/04/2022	REVISED -		SCALE: 1"=20"	SHEET 35 OF 35 SHEETS	STA. 470+00.00	TO STA. 475+05.71	FED, ROAD	D DIST. NO. 7 ILLINOIS FED. A	ID PROJECT

→ AGGREGATE EROSION CONTROL (DITCH CHECK)
 ○ EARTH EXCAVATION FOR EROSION CONTROL (STILL BASIN)


----- PERIMETER EROSION BARRIER


H TEMP EROSION CONTROL BLANKET

- TEMPORARY DITCH CHECK MINIMUM 12" HEIGHT


LEGEND:

\* PLACE AT START OF CONSTRUCTION

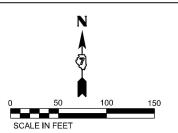

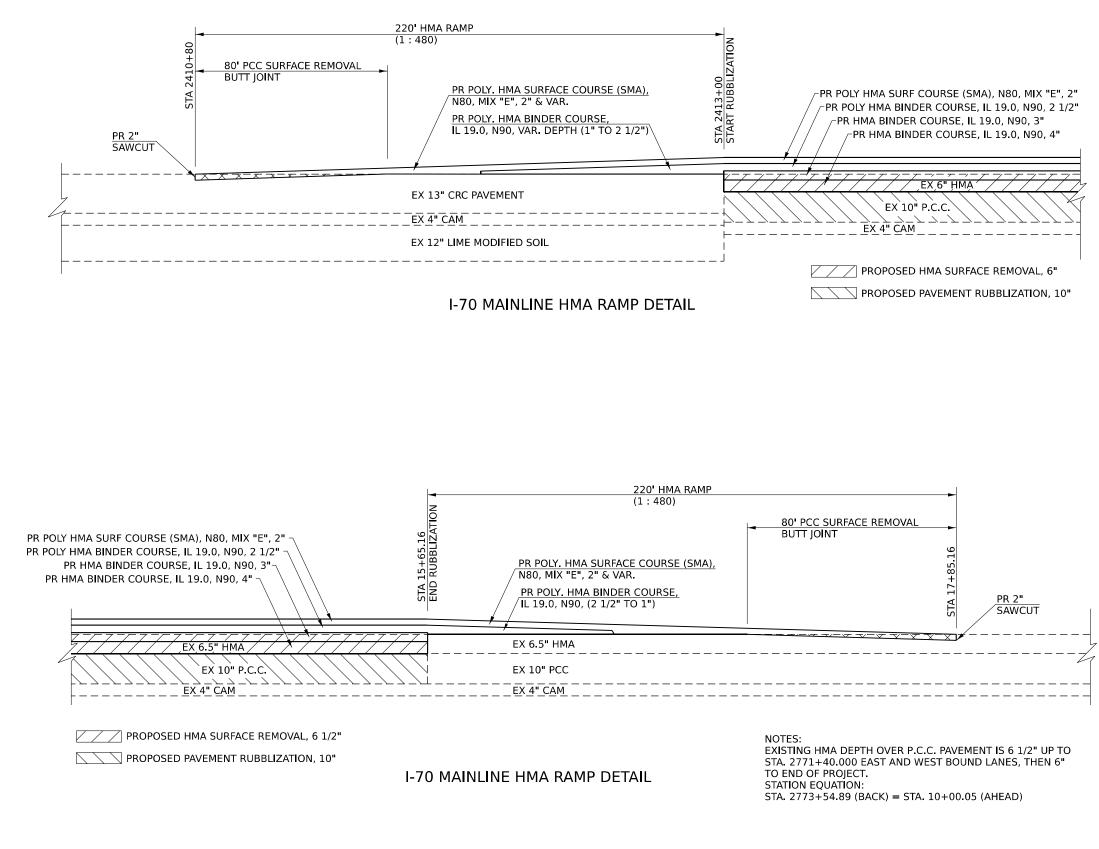

pw:/		USER NAME = tstagte	DESIGNED -	REVISED -			HMA R/			-JOINT D	ITALI S	F.A.I. RTE	SECTION	COUNTY	TOTAL	SHEET
	BACON   FARMER   WORKMAN		DRAWN -	REVISED -	STATE OF ILLINOIS				b borr	oomin b		70	(25-4-1,25-5)R	EFFINGHAM	790	389
	ENGINEERING & TESTING, INC.	PLOT SCALE = 0.8000 '/in	CHECKED -	REVISED -	DEPARTMENT OF TRANSPORTATION									CONTRAC	TNO. 7	4599
žĒ		PLOT DATE = 3/17/2022	DATE -	REVISED -		SCALE: N.T.S.	SHEET 1	OF 22	2 SHEETS	STA.	TO STA.		ILUNOIS FED.	ALD PROJECT		

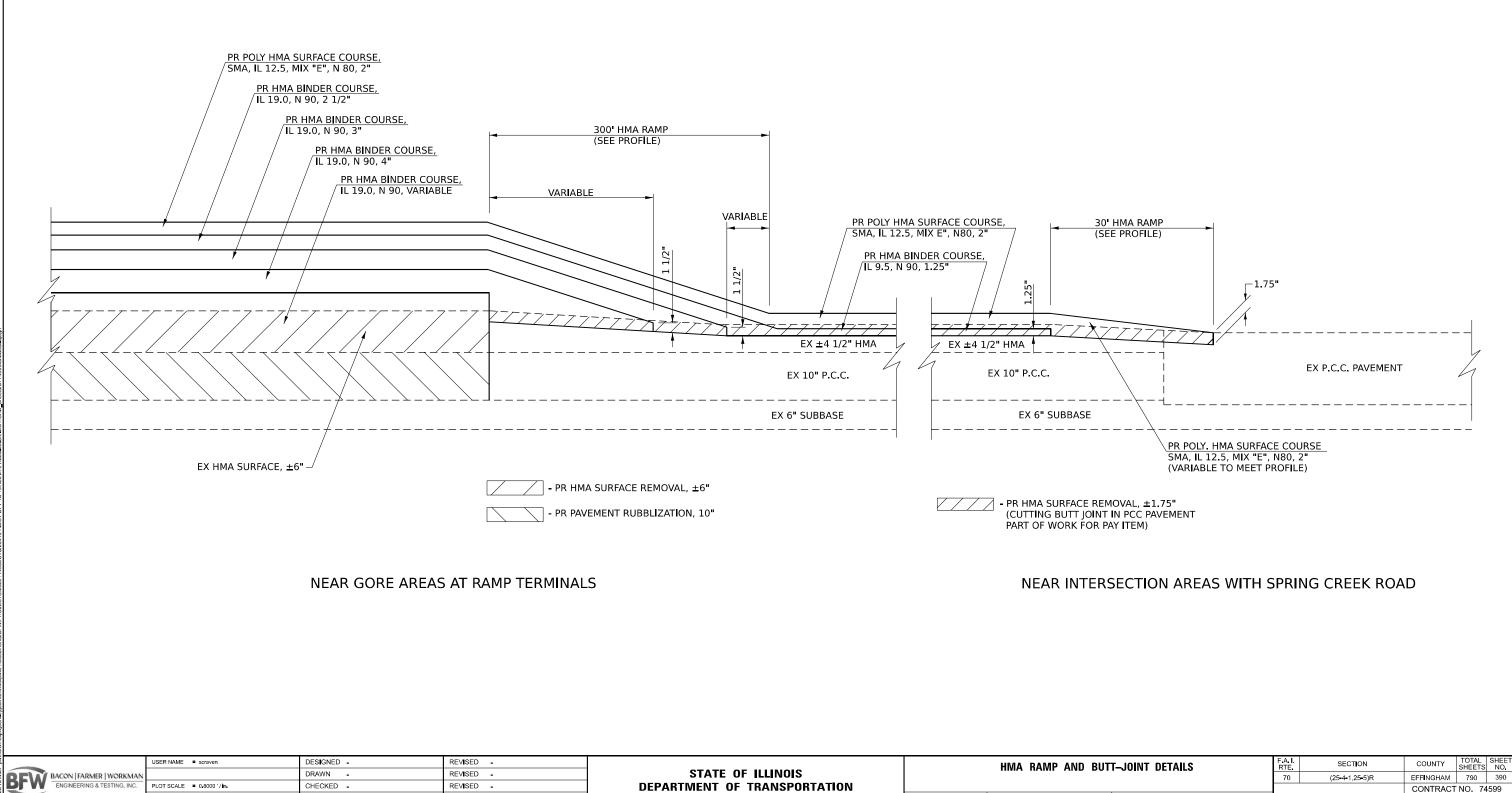


PLOT DATE = 3/16/2022

DATE

REVISED -

SCALE: N.T.S.

HMA RAMP AND BUTT-JOINT DETAILS	F.A.I. RTE	SECTION	COUNTY	TOTAL SHEETS	SHEET NO.
	70	(25-4-1,25-5)R	EFFINGHAM	790	390
			CONTRACT	NO. 74	599
SHEET 2 OF 2 SHEETS STA. TO STA.		ILLINOIS F	ED, AID PROJECT		

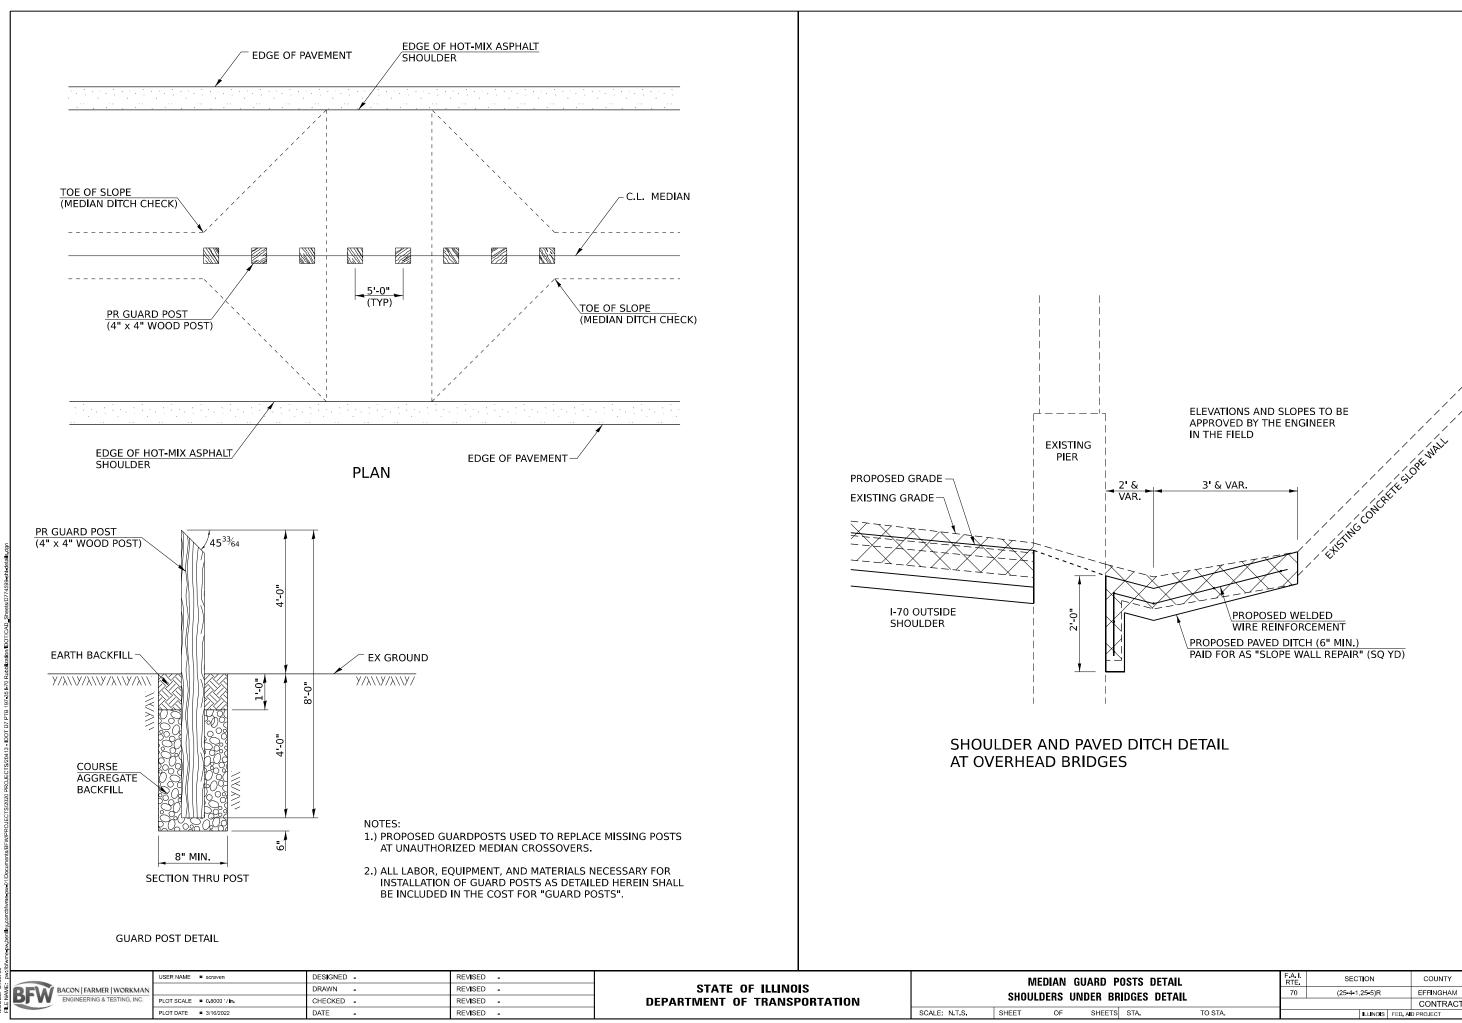


P	OSTS D	ETAIL	F.A.I. RTE	SEC	TION		COUNTY	TOTAL SHEETS	SHEET NO.
RR	IDGES	DETAIL	70	(25-4-1	,25 <b>-</b> 5)R		EFFINGHAM	790	391
יווט			_				CONTRACT	NO. 74	599
TS	STA.	TO STA.			ILLINOIS FED, AID PROJECT				

# THIS SHEET INTENTIONALLY LEFT BLANK

pw2/	USER NAME = tslagle	DESIGNED -	REVISED -							F.A.I. BTE	SECTION	COUNTY	TOTAL SHEET
BACON   FARMER   WORK	MAN	DRAWN -	REVISED -	STATE OF ILLINOIS						70	(25-4-1,25-5)R	EFFINGHAM	790 392
ENGINEERING & TESTING,	NC. PLOT SCALE = 0.8000'/in	CHECKED -	REVISED -	DEPARTMENT OF TRANSPORTATION		-						CONTRACT	NO 74599
	PLOT DATE = 3/17/2022	DATE -	REVISED -		SCALE: N.T.S.	SHEET	OF	SHEETS STA.	TO STA.		ILLINOIS FED, A	D PROJECT	


EMERGENCY MEDIAN CROSSOVERS

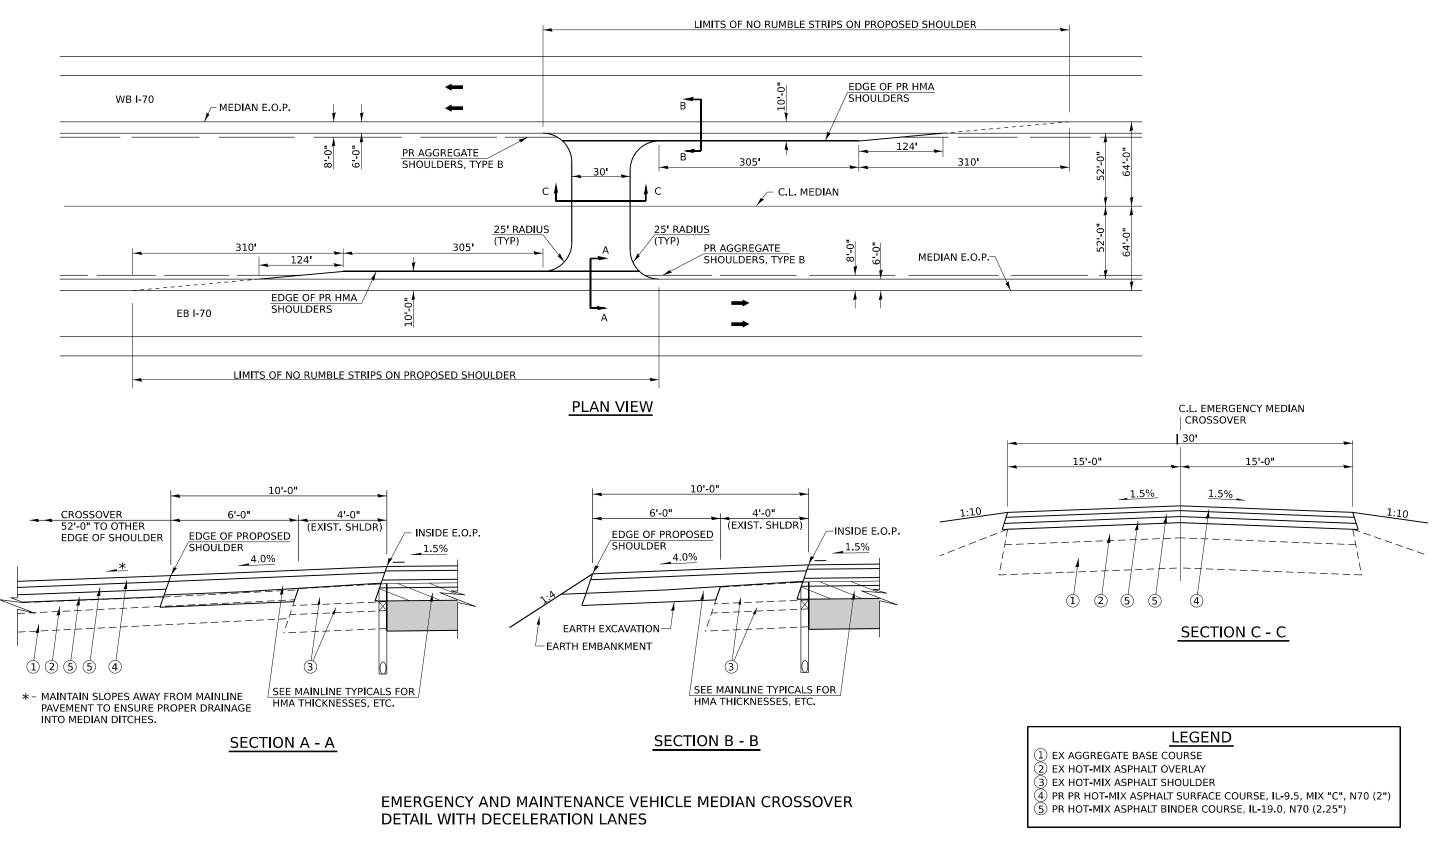

eet 04 pw://t		USER NAME	scraven #	DESIGNED -	REVISED -			EMER	RENCY	ΜΔΙΝ	<b>NTENAN</b>	CE VEHICL	IF	F.A.I. BTE	SECTION	COUNTY	TOTAL SHEET	1
L: Sh IAME:	BACON FARMER WORKIN	N		DRAWN -	REVISED -	STATE OF ILLINOIS				•		TION LAN		70	(25-4-1,25-5)R	EFFINGHAM	790 393	1
AODE ILE N	ENGINEERING & TESTING, INC	PLOT SCALE	≢ 0.8000 '/∎n	CHECKED -	REVISED -	DEPARTMENT OF TRANSPORTATION			133 04							CONTRAC	T NO. 74599	1
- "L		PLOT DATE	≢ 3/16/2022	DATE -	REVISED -		SCALE: N.T.S.	SHEET	OF	S	SHEETS S	SIA.	TO STA.		ILLINOIS FED, A	D PROJECT		1

### NOTE:


TWO DELINEATORS SHALL BE PLACED IN ADVANCE OF THE MEDIAN CROSSOVERS. ONE SHALL BE AT THE CROSSOVER, THE OTHER 800 FT IN ADVANCE OF THE FIRST. THE DELINEATOR AT THE CROSSOVER SHALL HAVE TWO REFLECTORS, AND THE DELINEATOR 800 FT IN ADVANCE SHALL HAVE THREE REFLECTORS

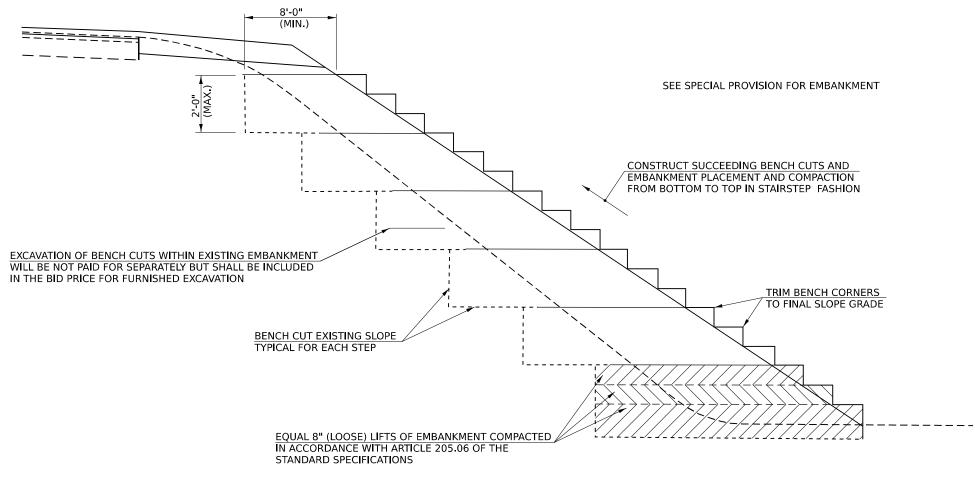

TYPICAL BENCHING FOR EMBANKMENT DETAIL


(FOR FILLS OVER 10' AND 12" THICK)

-90 // 00										
pw:	USER NAME = scraven	DESIGNED -	REVISED -			BENCHING FOR EARTH EMBANKMENT	DETAIL	F.A.I. RTE	SECTION	COUNTY TOTAL SHEET
BACON   FARMER   WOR	MAN	DRAWN -	REVISED -	STATE OF ILLINOIS				70	(25-4-1-25-5)R	FEEINGHAM 790 394
	NC. PLOT SCALE = 0.8000 '/in	CHECKED -	REVISED -	DEPARTMENT OF TRANSPORTATION					(== : :,== =); :	CONTRACT NO. 74599
H	PLOT DATE = 3/16/2022	DATE -	REVISED -		SCALE: N.T.S.	SHEET OF SHEETS STA.	TO STA.	ILLINOIS FED AID PROJECT		) PROJECT

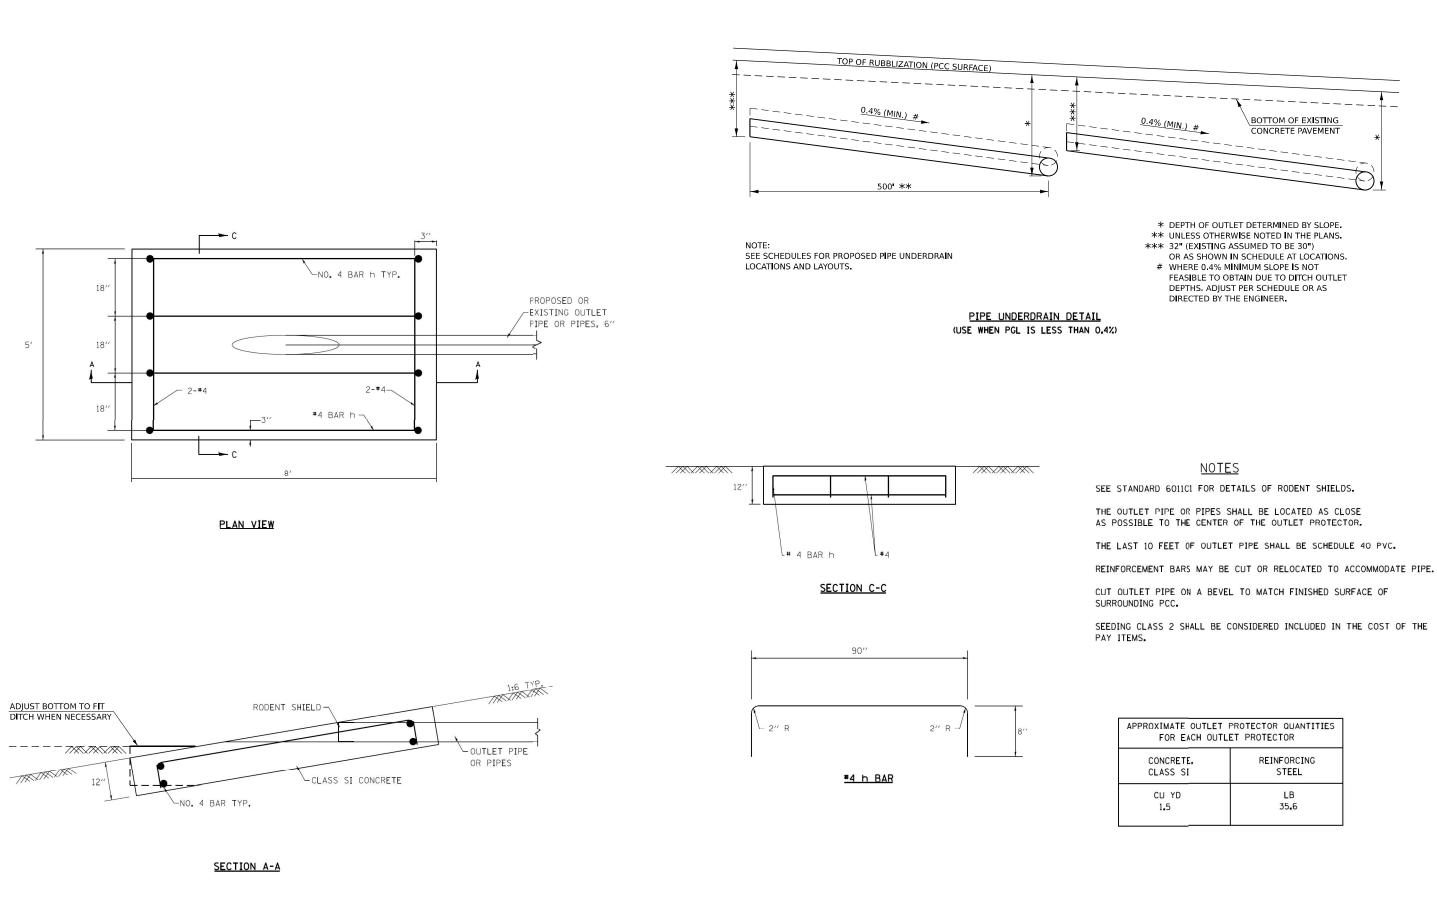


eet 06		USER NAME = scraven	DESIGNED -	REVISED -		OUTLET PROTECTOR FOR					F.A.I. RTF	SECTION	COUNTY	TOTAL SHEET	
AME: S	BEW BACON   FARMER   WORKMAN		DRAWN -	REVISED -	STATE OF ILLINOIS	PIPE UNDERDRAINS DETAIL			70	(25-4-1,25-5)R	EFFINGHAM	790 395			
U D E	ENGINEERING & TESTING, INC.	PLOT SCALE = 0.8000 '/m	CHECKED -	REVISED -	DEPARTMENT OF TRANSPORTATION				_		CONTRAC	T NO. 74599			
źΠ		PLOT DATE = 3/16/2022	DATE -	REVISED -		SCALE: N.T.S.	SHEET	OF	SHEE	S STA.	TO STA.		ILLINOIS FED.	AID PROJECT	

APPROXIMATE OUTLET PROTECTOR QUANTITIES FOR EACH OUTLET PROTECTOR								
CONCRETE.	REINFORCING							
CLASS SI	STEEL							
CU YD	LB							
1.5	35 <b>.</b> 6							

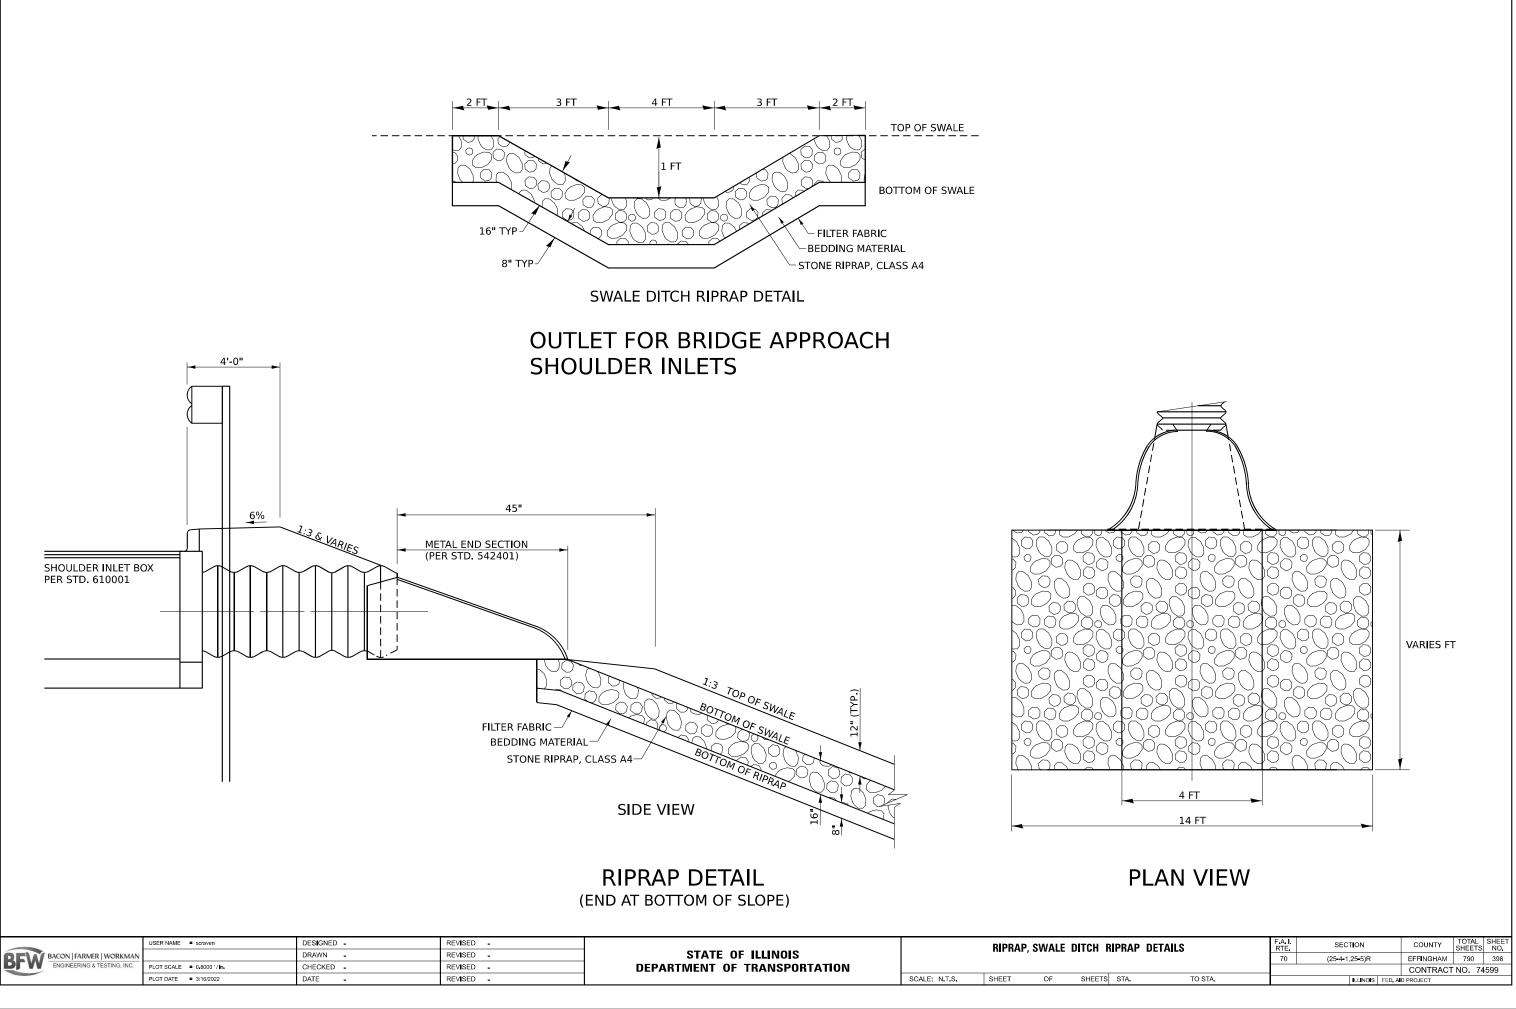

MODEL: She

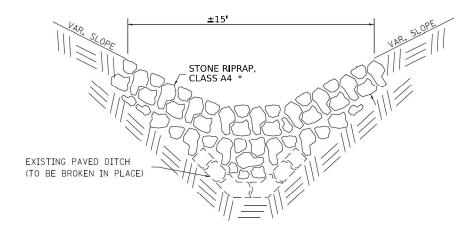


## STONE RIPRAP ON TOP EXISTING PAVED DITCH

\* - SHAPE PER PLANS AND AS DIRECTED BY THE ENGINEER

NOTE: SEE PLANS AND SCHEDULES FOR LOCATIONS AND TYPES


VAR. SLOPE 

t pws/		USER NAME = scraven	DESIGNED -	REVISED -		PERMANENT EROSION CONTROL DETAILS			F.A.I. RTE	SECTION	COUNTY	TOTAL SHEET SHEETS NO.		
BI NAME	BACON   FARMER   WORKMAN		DRAWN -	REVISED -	STATE OF ILLINOIS				70	(25-4-1,25-5)R	EFFINGHAM	790 397		
	ENGINEERING & TESTING, INC.	PLOT SCALE = 0.8000'/in	CHECKED -	REVISED -	DEPARTMENT OF TRANSPORTATION					CONTRAC	T NO. 74599			
2 T		PLOT DATE = 3/16/2022	DATE -	REVISED -		SCALE: N.T.S.	SHEET	OF	SHEETS STA.	TO STA.		ILLINOIS FED	AID PROJECT	

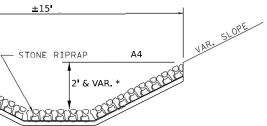


## DETAIL OF STONE RIPRAP DITCH

(THICKNESS PER TYPE; ACCORDING TO STANDARD SPECIFICATIONS)

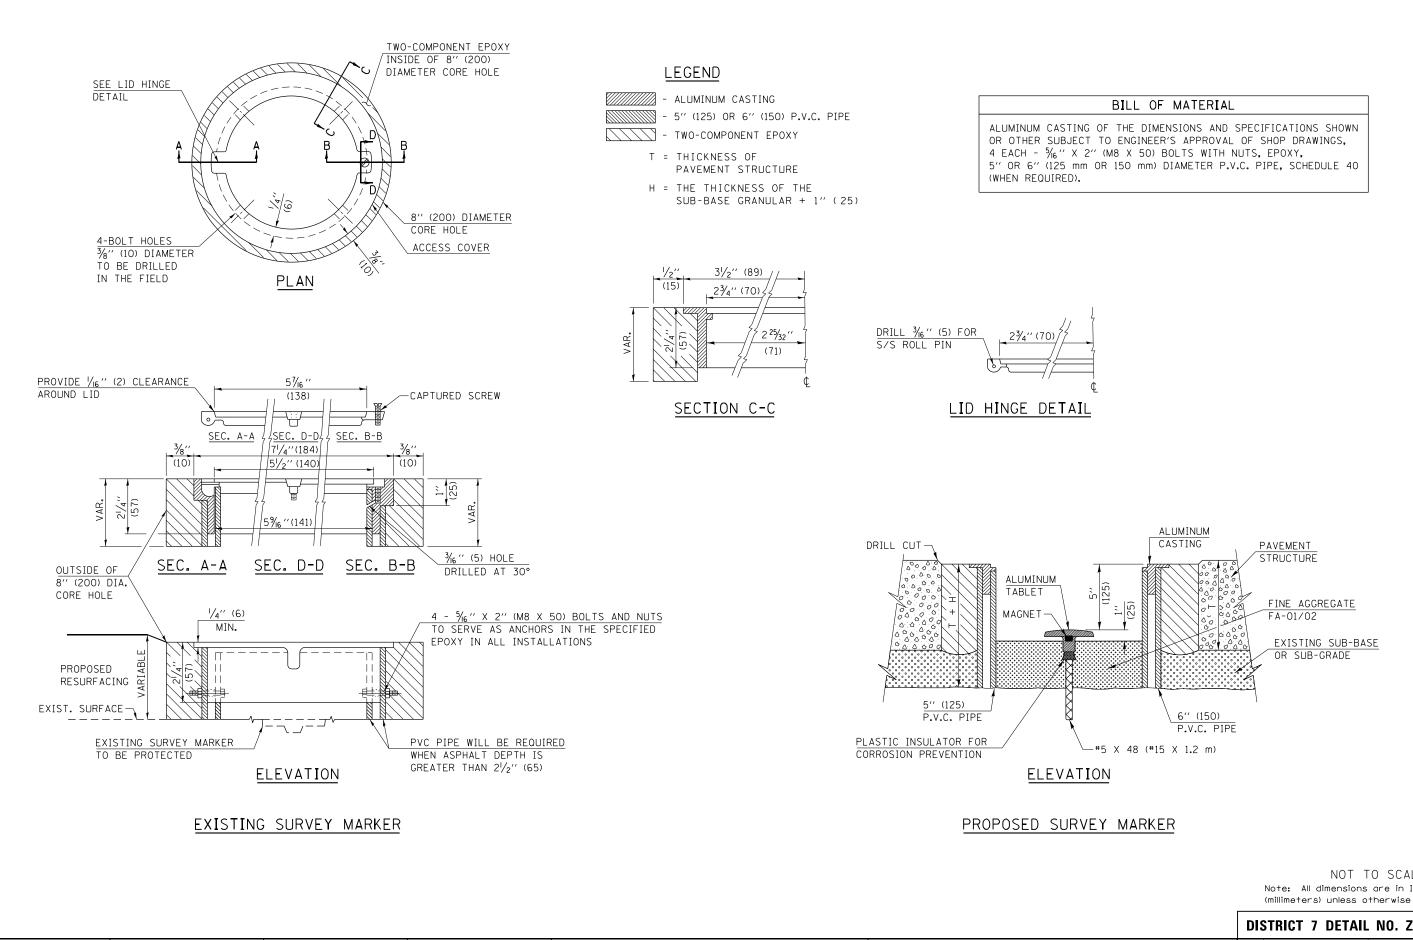

eet C		USER NAME = scraven	DESIGNED -	REVISED -		Í		SURV	EY MARK
Sh Sh	DEW BACON   FARMER   WORKMAN		DRAWN -	REVISED -	STATE OF ILLINOIS	ĺ		3011	
	ENGINEERING & TESTING, INC.	PLOT SCALE = 0.8000 '/in	CHECKED -	REVISED -	DEPARTMENT OF TRANSPORTATION	ĺ			
N E		PLOT DATE = 3/16/2022	DATE -	REVISED -		SCALE: N.T.S.	SHEET	OF	SHEETS

		NOT TO SCALE Note: All dimensions are in INCHES (millimeters) unless otherwise shown.							
			DIS	STRICT 7	DE	<b>FAIL</b>	NO. ZO	0702	02
R	KER VAULT		F.A.I. RTE	SECTION			COUNTY	TOTAL SHEETS	SHEET NO.
			70	(25-4-1,	25 <b>-</b> 5)R		EFFINGHAM	790	398
							CONTRACT	NO. 74	599
ΓS	STA.	TO STA.			ILLINOIS	FED, A	D PROJECT		

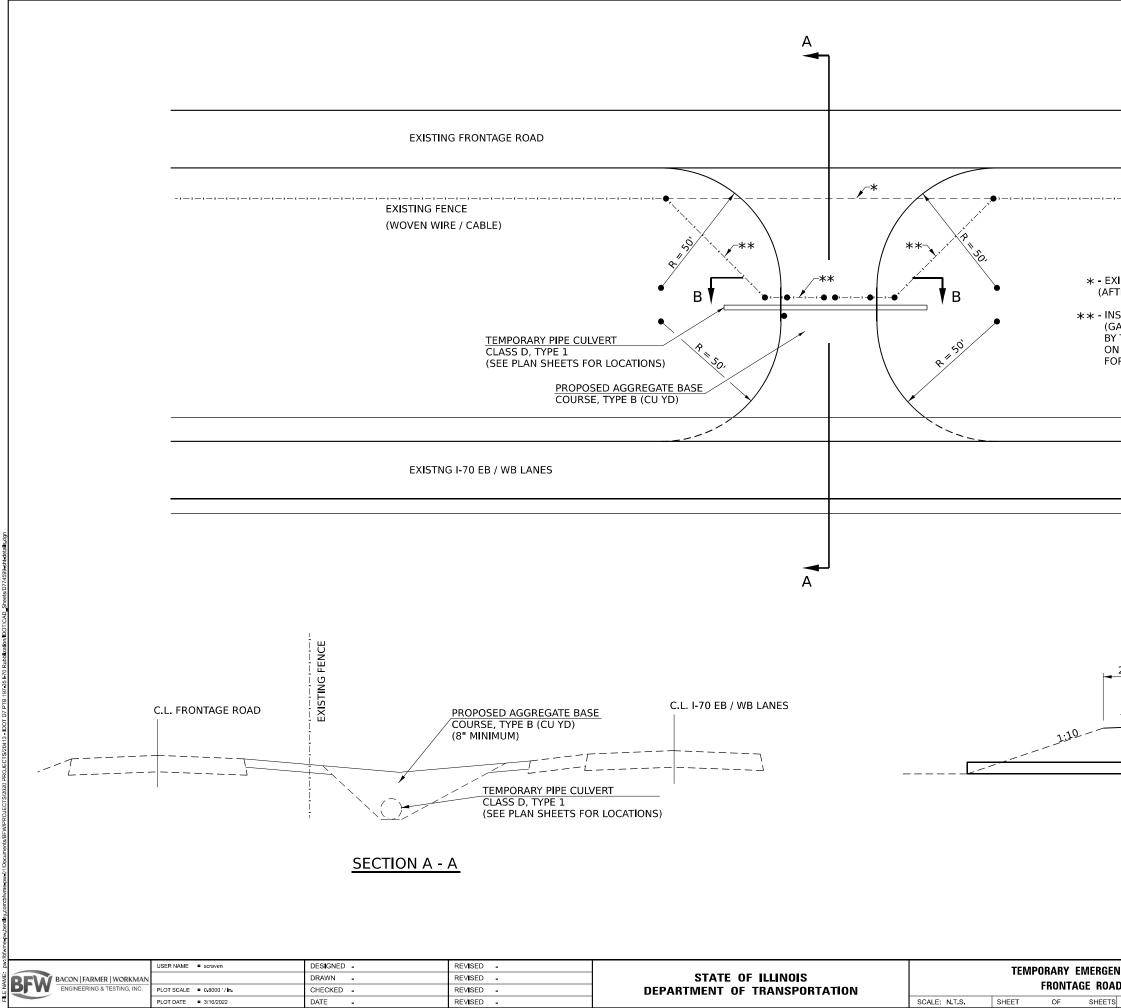

EXISTING FENCE	1 — 1 — X -		
EXISTING FENCE TO BE REMOVED FTER TEMPORARY ACCESS USE) NSTALL TEMPORARY FENCE (SPEC GATES, DOUBLE 4'X24' CHAIN LIN 3Y THE ENGINEER. INSTALL ROAD ON BOTH SIDES OF GATES (COST F OR THE GATES).	IAL) A K) AS CLOS	ND GATES DIRECTED ED SIGNS	
C.L. ACCESS			
20' & VAR. 20' & VAR.		ROPOSED AGGREGATI DURSE, TYPE B (CU YI	
<u>SECTION B - B</u>			L
ENCY ACCESS TO AD DETAILS TS STA. TO STA.	F.A.I. RTE 70	SECTION (25-4-1,25-5)R ILLINOIS FED, AU	COUNTY TOTAL SHEET SHEETS NO. EFFINGHAM 790 399 CONTRACT NO. 74599 D PROJECT

