FOR INDEX OF SHEETS AND HIGHWAY STANDARDS SEE SHEET NO. 2

PV = 67.32%

SU - 4.58%

0

0

0

0

STATE OF ILLINOIS

(37-3,4) RS-2 HENRY 142 1

D-92-029-06

DEPARTMENT OF TRANSPORTATION

PROPOSED

F.A.I. ROUTE 74 (I-74) **SECTION (37–3,4) RS–2** PROJECT NHPP-GTK9 (228) RESURFACING (3R) HENRY COUNTY

SECTION/PROJECT ENDS!

STA. 1672+56

PAVING GAP (1,886') C-92-043-16 IMPROVEMENT BEGINS STA. 1361+60 - STA. 1380+46 (EB) STA. 1195+36 STA. 1361+65 - STA. 1380+41 (WB) R. 1E. R. 2E. SECTION/PROJECT BEGINS STA. 1285+65 PAVING GAP (1,805') STA. 1414+29 - STA. 1432+34 (EB) STA. 1414+17 - STA. 1432+50 (WB) T. 15N.

R. 1E. R. 2E.

GROSS LENGTH = 38,691 FT. = 7.33 MILES

PAVING GAPS = 5,530 FT. = 1.04 MILES NET LENGTH = 30,299 FT. = 6,29 MILES

STATION EQUATION BACK 1657+81.56 (WB)

AHEAD 1658+06.50 (WB)

PAVING GAP (1,839') STA. 1622+10 - STA. 1640+49 (EB) STA. 1621+90 - STA. 1640+76 (WB)

IMPROVEMENT ENDS STA. 1699+63

HIGHWAY PLANS

MU - 28.10% POSTED SPEED: 70 MPH

HIGHWAY CLASSIFICATION

CLASSIFICATION: INTERSTATE

F.A.I. ROUTE 74 (1-74)

ADT: 15,300 (2017)

DESIGN SPEED: 70 MPH

LYNN TOWNSHIP SECTION 13, 24, 25, 36 OXFORD TOWNSHIP SECTION 1, 12, 13, 24



ENGINEERING SCALES. REDUCED SIZED PLANS WILL NOT CONFORM TO STANDARD SCALES. IN MAKING MEASUREMENTS ON REDUCED PLANS, THE ABOVE SCALES MAY BE USED.

JOINT UTILITY LOCATION INFORMATION FOR EXCAVATION 1-800-892-0123 OR 811

PROJECT ENGINEER: FAITH DUNCAN PROJECT MANAGER: ROBERT BARTON (815) 284-5958

CONTRACT NO. 64C06

LOCATION OF SECTION INDICATED THUS: - - -

STATE OF ILLINOIS DEPARTMENT OF TRANSPORTATION

PRINTED BY THE AUTHORITY OF THE STATE OF ILLINOIS

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HIGHWAY STANDARDS

STANDARDS

	STANDARDS
000001-07	STANDARD SYMBOLS, ABBREVIATIONS, AND PATTERNS
001001-02	AREA OF REINFORCEMENT BARS
001001-02	DECIMAL OF AN INCH AND OF A FOOT
280001-07	TEMPORARY EROSION CONTROL SYSTEMS
420001-07	PAVEMENT JOINTS
	24' JOINTED PCC PAVEMENT
420101-06	
420106-06	36' JOINTED PCC PAVEMENT
420701-03	PAVEMENT WELDED WIRE REINFORCEMENT
424001-11	PERPENDICULAR CURB RAMPS FOR SIDEWALKS
424016-05	MID-BLOCK CURB RAMPS FOR SIDEWALKS
442001-04	CLASS A PATCHES
442101-09	CLASS B PATCHES
442201-03	CLASS C AND D PATCHES
542301-03	PRECAST REINFORCED CONCRETE FLARED END SECTION
542526-03	INLET BOX TYPE 24 F
601101-02	CONCRETE HEADWALL FOR PIPE UNDERDRAINS
606001-07	CONCRETE CURB TYPE B AND COMBINATION CONCRETE CURB AND GUTTER
606201-04	TYPE B GUTTER (INLET, OUTLET & ENTRANCE)
630001-12	STEEL PLATE BEAM GUARDRAIL
630301-09	SHOULDER WIDENING FOR TYPE 1 (SPECIAL) GUARDRAIL TERMINALS
631011-10	TRAFFIC BARRIER TERMINAL, TYPE 2
631031-15	TRAFFIC BARRIER TERMINAL, TYPE 6
631046-04	TRAFFIC BARRIER TERMINAL, TYPE 10
635001-02	DELINEATORS
642001-02	SHOULDER RUMBLE STRIPS, 16IN
701101-05	OFF-RD OPERATIONS, MULTILANE, 15' TO 24" FROM PAVEMENT EDGE
701106-02	OFF-RD OPERATIONS, MULTILANE, MORE THAN 15' AWAY
701400-09	APPROACH TO LANE CLOSURE, FREEWAY/EXPRESSWAY
701401-12	LANE CLOSURE, FREEWAY/EXPRESSWAY
701406-12	LANE CLOSURE, FREEWAY/EXPRESSWAY, DAY OPERATIONS ONLY
701411-09	LANE CLOSURE, MULTILANE, AT ENTERANCE OR EXIT RAMP, FOR SPEEDS \geq 45 MPH
701416-11	LANE CLOSURE, FREEWAY/EXPRESSWAY, WITH CROSSOVER AND BARRIER
701426-09	LANE CLOSURE, MULTILANE, INTERMITTENT OR MOVING OPER., FOR SPEEDS \geq 45 MPH
701451-05	RAMP CLOSURE FREEWAY /EXPRESSWAY
701456-05	PARTIAL EXIT RAMP CLOSURE FREEWAY /EXPRESSWAY
701901-08	TRAFFIC CONTROL DEVICES
704001-08	TEMPORARY CONCRETE BARRIER
720001-01	SIGN PANEL MOUNTING DETAILS
720011-01	METAL POSTS FOR SIGNS, MARKERS & DELINEATORS
725001-01	OBJECT AND TERMINAL MARKERS
728001-01	TELESCOPING STEEL SIGN SUPPORT
729001-01	APPLICATIONS OF TYPES A & B METAL POSTS (FOR SIGNS & MARKERS)
780001-05	TYPICAL PAVEMENT MARKINGS
781001-04	TYPICAL APPLICATIONS RAISED REFLECTIVE PAVEMENT MARKERS

USER NAME = bartonrw	DESIGNED -	REVISED -
	DRAWN -	REVISED -
PLOT SCALE = 100.0000 ' / in.	CHECKED -	REVISED -
PLOT DATE = May-06-2019 07:31:02 AM	DATE -	REVISED -

STATE OF ILLINOIS
DEPARTMENT OF TRANSPORTATION

782006

830026-01

GUARDRAIL AND BARRIER WALL REFLECTOR MOUNTING DETAILS

TEMPORARY ROADWAY LIGHTING

			CONSTRUCTIO	N TYPE CODE
PAY ITEM	UNIT	TOTAL QUANTITIES	0005 ROADYWAY NHPP 90% FED 10% STATE	
TREE REMOVAL (6 TO 15 UNITS DIAMETER)	LINIT	68	68	
THEE REMOVAE (0 TO 15 ONTTS DIAMETER)	ONTT	00	00	
EARTH EXCAVATION	CU YD	8,660	8,660	
TOPSOIL FURNISH AND PLACE, 4"	SQ YD	29,479	29,479	
TEMPORARY DITCH CHECKS	FOOT	230	230	
PERIMETER EROSION BARRIER	FOOT	750	750	
INLET AND PIPE PROTECTION	EACH	6	6	
INLET FILTERS	EACH	4	4	
SEEDING, CLASS 2A	ACRE	6.25	6.25	
NITROGEN FERTILIZER NUTRIENT	POUND	549	549	
PHOSPHORUS FERTILIZER NUTRIENT	POUND	549	549	
POTASSIUM FERTILIZER NUTRIENT	POUND	549	549	
MOW I NG	ACRE	3.75	3.75	
EROSION CONTROL BLANKET	SQ YD	17,565	17,565	
TURF REINFORECEMENT MAT	SQ YD	11,776	11,776	
	TREE REMOVAL (6 TO 15 UNITS DIAMETER) EARTH EXCAVATION TOPSOIL FURNISH AND PLACE, 4" TEMPORARY DITCH CHECKS PERIMETER EROSION BARRIER INLET AND PIPE PROTECTION INLET FILTERS SEEDING, CLASS 2A NITROGEN FERTILIZER NUTRIENT PHOSPHORUS FERTILIZER NUTRIENT POTASSIUM FERTILIZER NUTRIENT MOWING EROSION CONTROL BLANKET	TREE REMOVAL (6 TO 15 UNITS DIAMETER) EARTH EXCAVATION CU YD TOPSOIL FURNISH AND PLACE, 4" SQ YD TEMPORARY DITCH CHECKS FOOT INLET AND PIPE PROTECTION EACH INLET FILTERS EACH SEEDING, CLASS 2A ACRE NITROGEN FERTILIZER NUTRIENT POUND POTASSIUM FERTILIZER NUTRIENT POUND MOWING ACRE EROSION CONTROL BLANKET SQ YD	TREE REMOVAL (6 TO 15 UNITS DIAMETER) EARTH EXCAVATION CU YD 8.660 TOPSOIL FURNISH AND PLACE, 4" SQ YD 29,479 TEMPORARY DITCH CHECKS FROT 230 PERIMETER EROSION DARRIER FOOT 750 INLET AND PIPE PROTECTION EACH 6 INLET FILTERS EACH 4 SEEDING, CLASS 2A ACRE 6.25 NITROGEN FERTILIZER NUTRIENT POUND 549 PHOSPHORUS FERTILIZER NUTRIENT POUND 549 MOWING ACRE 3.75 EROSION CONTROL BLANKET SQ YD 17,565	PAY ITEM UNIT TOTAL QUARTITIES ROADYWAY NHPP 90% FED 10% STATE TREE REMOVAL (6 TO 15 UNITS DIAMETER) TREE REMOVAL (6 TO 15 UNITS DIAMETER) TREE REMOVAL (6 TO 15 UNITS DIAMETER) TOTAL QUARTITIES TREE REMOVAL (6 TO 15 UNITS DIAMETER) TOTAL QUARTITIES TREE REMOVAL (6 TO 15 UNITS DIAMETER) TOTAL QUARTITIES TREE REMOVAL (6 TO 15 UNITS DIAMETER) TOTAL QUARTITIES TO

^{*} SPECIALTY ITEMS

[#] NON-PARTICIPATING (100% STATE)

USER NAME = bartonrw	DESIGNED -	REVISED -					F.A.I. RTE.	SECTION	COUNTY TOTA	TAL SHEET ETS NO.
	DRAWN -	REVISED -	STATE OF ILLINOIS		SUMMARY OF QUANTITIES		74	(37-3, 4)RS-2	HENRY 14:	42 3
PLOT SCALE = 100.0000 ' / in.	CHECKED -	REVISED -	DEPARTMENT OF TRANSPORTATION						CONTRACT NO.	. 64C06
PLOT DATE = May-06-2019 11:23:17 AM	DATE -	REVISED -		SCALE:	SHEET 1 OF 11 SHEETS STA.	TO STA.		ILLINOIS FED. A	ID PROJECT	

				CONSTRUCTION TYPE CODE
CODE NUMBER	PAY ITEM	UNIT	TOTAL QUANTITIES	0005 ROADYWAY NHPP 90% FED 10% STATE
28000250	TEMPORARY EROSION CONTROL SEEDING	POUND	7,309	7,309
	TELL CHART ENGINE CONTROL SEEDING	1 00112	,,,,,,,,,,,,,,,,,,,,,,,,,,,,,,,,,,,,,,,	,,,,,,,,,,,,,,,,,,,,,,,,,,,,,,,,,,,,,,,
28100105	STONE RIPRAP, CLASS A3	SQ YD	29,998	29,998
30300106	AGGREGATE SUBGRADE IMPROVEMENT 6"	SQ YD	855	855
30300112	AGGREGATE SUBGRADE IMPROVEMENT 12"	SQ YD	4,711	4,711
40600275	BITUMINOUS MATERIALS (PRIME COAT)	POUND	8,112	8,112
40600290	BITUMINOUS MATERIALS (TACK COAT)	POUND	14,159	14,159
40600295	POLYMERIZED BITUMINOUS MATERIALS (TACK COAT)	POUND	266,054	266,054
40600627	LEVELING BINDER (MACHINE METHOD), IL-9.5FG, N50	TON	2,645	2,645
40600829	POLYMERIZED LEVELING BINDER (MACHINE METHOD), IL-9.5FG, N50	TON	41	41
40600847	POLYMERIZED LEVELING BINDER (MACHINE METHOD), IL-9.5FG, N90	TON	12,837	12,837
40603085	HOT-MIX ASPHALT BINDER COURSE, IL-19.0, N70	TON	595	595
40603310	HOT-MIX ASPHALT SURFACE COURSE, MIX "C", N50	TON	15,318	15,318
40603340	HOT-MIX ASPHALT SURFACE COURSE, MIX "D", N70	TON	251	251
40603545	POLYMERIZED HOT-MIX ASPHALT SURFACE COURSE, MIX "D", N90	TON	42,853	42,853

^{*} SPECIALTY ITEMS

[#] NON-PARTICIPATING (100% STATE)

USER NAME = bartonrw	DESIGNED -	REVISED -					F.A.I.	SECTION	COUNTY	TOTAL SH	ET.
	DRAWN -	REVISED -	STATE OF ILLINOIS		SUMMARY OF QUANTITIES		74	(37-3, 4)RS-2	HENRY	142	<u></u>
PLOT SCALE = 100.0000 ' / in.	CHECKED -	REVISED -	DEPARTMENT OF TRANSPORTATION					(2. 2) .,	CONTRACT	NO. 64CC	6
PLOT DATE = May-06-2019 11:23:41 AM	DATE -	REVISED		SCALE:	SHEET 2 OF 11 SHEETS STA	TO STA	-	TILLIMOTE FED	AID DROIECT		-

				CONSTRUCTIO	N TYPE CODE
CODE NUMBER	PAY ITEM	UNIT	TOTAL QUANTITIES	0005 ROADYWAY NHPP 90% FED 10% STATE	
42000501	PORTLAND CEMENT CONCRETE PAVEMENT 10" (JOINTED)	SQ YD	3,083	3,083	
42300300	PORTLAND CEMENT CONCRETE DRIVEWAY PAVEMENT, 7 INCH	SQ YD	132	132	
42400200	PORTLAND CEMENT CONCRETE SIDEWALK 5 INCH	SQ FT	2,787		2,787
42400800	DETECTABLE WARNINGS	SQ FT	92		92
44000100	PAVEMENT REMOVAL	SQ YD	1,548	1,548	
44000159	HOT-MIX ASPHALT SURFACE REMOVAL, 2 1/2"	SQ YD	725	725	
44000162	HOT-MIX ASPHALT SURFACE REMOVAL, 3 1/4"	SQ YD	2,442	2,442	
44000169	HOT-MIX ASPHALT SURFACE REMOVAL, 5"	SQ YD	286,438	286,438	
44000200	DRIVEWAY PAVEMENT REMOVAL	SQ YD	56	56	
44000300	CURB REMOVAL	FOOT	100	100	
44000500	COMBINATION CURB AND GUTTER REMOVAL	FOOT	482	190	292
44000600	SIDEWALK REMOVAL	SQ FT	2,650		2,650
44004250	PAVED SHOULDER REMOVAL	SQ YD	1,707	1,707	
44200050	WELDED WIRE REINFORCEMENT	SQ YD	1,959	1,959	

^{*} SPECIALTY ITEMS

[#] NON-PARTICIPATING (100% STATE)

USER NAME = bartonrw	DESIGNED -	REVISED -					F.A.I.	SECTION	COUNTY	TOTAL SHEET	
	DRAWN -	REVISED -	STATE OF ILLINOIS		SUMMARY OF QUANTITIES		74	(37-3, 4)RS-2	HENRY	142 5	
PLOT SCALE = 100.0000 ' / in.	CHECKED -	REVISED -	DEPARTMENT OF TRANSPORTATION						CONTRACT	NO. 64C06	
PLOT DATE - May 06 2010 11:22:53 AM	DATE	DEVISED		SCALE:	CHEET 2 OF 11 CHEETS STA	TO STA		TILINOIS SED AL	D DROJECT		

				CONSTRUCTIO	ON TYPE CODE
CODE NUMBER	PAY ITEM	UNIT	TOTAL QUANTITIES	0005 ROADYWAY NHPP 90% FED 10% STATE	
44200529	CLASS A PATCHES, TYPE II, 8 INCH	SQ YD	627	627	
44200533	CLASS A PATCHES, TYPE III, 8 INCH	SQ YD	344	344	
44200535	CLASS A PATCHES, TYPE IV, 8 INCH	SQ YD	334	334	
44200553	CLASS A PATCHES, TYPE II, 10 INCH	SQ YD	22	22	
44200557	CLASS A PATCHES, TYPE III, 10 INCH	SQ YD	35	35	
44200610	CLASS A PATCHES, TYPE II, 13 INCH	SQ YD	43	43	
44200612	CLASS A PATCHES, TYPE III, 13 INCH	SQ YD	72	72	
44200614	CLASS A PATCHES, TYPE IV, 13 INCH	SQ YD	67	67	
44200934	CLASS B PATCHES, TYPE II, 8 INCH	SQ YD	11	11	
44200942	CLASS B PATCHES, TYPE III, 8 INCH	SQ YD	134	134	
44200944	CLASS B PATCHES, TYPE IV, 8 INCH	SQ YD	1,826	1,826	
44201298	DOWEL BARS 1 1/4"	EACH	754	754	
44201725	CLASS D PATCHES, TYPE I, 7 INCH	SQ YD	89	89	
44201729	CLASS D PATCHES, TYPE II, 7 INCH	SQ YD	281	281	

^{*} SPECIALTY ITEMS

[#] NON-PARTICIPATING (100% STATE)

USER NAME = bartonrw	DESIGNED -	REVISED -					F.A.I.	SECTION	COUNTY	TOTAL	SHEET
	DRAWN -	REVISED -	STATE OF ILLINOIS		SUMMARY OF QUANTITIES		74	(37-3, 4)RS-2	HENRY	142	6
PLOT SCALE = 100.0000 ' / in.	CHECKED -	REVISED -	DEPARTMENT OF TRANSPORTATION				1		CONTRACT	NO. 64	,C06
PLOT DATE = May-06-2019 11:24:09 AM	DATE	REVISED		SCALE:	SHEET 4 OF 11 SHEETS STA	TO STA		TILLINOIS SED A	ID DROJECT		

				CONSTRUCTIO	ON TYPE CODE
CODE NUMBER	PAY ITEM	UNIT	TOTAL QUANTITIES	0005 ROADYWAY NHPP 90% FED 10% STATE	
44201733	CLASS D PATCHES, TYPE III, 7 INCH	SQ YD	125	125	
44201733	CLASS D TATCHES, THE TIT, 7 INCH	30 10	123	123	
44201735	CLASS D PATCHES, TYPE IV, 7 INCH	SQ YD	93	93	
44201785	CLASS D PATCHES, TYPE I, 12 INCH	SQ YD	8	8	
44201789	CLASS D PATCHES, TYPE II, 12 INCH	SQ YD	59	59	
44201794	CLASS D PATCHES, TYPE III, 12 INCH	SQ YD	81	81	
44201796	CLASS D PATCHES, TYPE IV, 12 INCH	SQ YD	28	28	
44213000	PATCHING REINFORCEMENT	SQ YD	1,542	1,542	
44213200	SAW CUTS	FOOT	9,312	9,312	
44213204	TIE BARS 3/4"	EACH	499	499	
48100100	AGGREGATE SHOULDERS, TYPE A	TON	7,000	7,000	
48203009	HOT-MIX ASPHALT SHOULDERS, 3"	SQ YD	103,067	103,067	
48203021	HOT-MIX ASPHALT SHOULDERS, 6"	SQ YD	10,839	10,839	
48203029	HOT-MIX ASPHALT SHOULDERS, 8"	SQ YD	845	845	
50105220	PIPE CULVERT REMOVAL	FOOT	104	104	

^{*} SPECIALTY ITEMS

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USER NAME = bartonrw	DESIGNED -	REVISED -					F.A.I. RTE	SECTION	COUNTY TOTAL SHEF
	DRAWN -	REVISED -	STATE OF ILLINOIS		SUMMARY OF QUANTITIES		74	(37-3, 4)RS-2	HENRY 142 7
PLOT SCALE = 100.0000 ' / in.	CHECKED -	REVISED -	DEPARTMENT OF TRANSPORTATION					(21 27 17:12 2	CONTRACT NO. 64C06
PLOT DATE = May-06-2019 11:24:21 AM	DATE	REVISED		SCALE	SHEET 5 OF 11 SHEETS STA	TO STA		ILLIMOIS SED	AID PROJECT

				CONSTRUCTIO	ON TYPE CODE
				0005 ROADYWAY	
CODE NUMBER	PAY ITEM	UNIT	TOTAL QUANTITIES	NHPP	
				90% FED	
				10% STATE	
54213687	PRECAST REINFORCED CONCRETE FLARED END SECTION 42"	EACH	1	1	
54246205	INLET BOX, STANDARD 542526	EACH	1	1	
542D0229	PIPE CULVERTS, CLASS D, TYPE 1, 24"	FOOT	158	158	
60600095	CLASS SI CONCRETE (OUTLET)	CU YD	4	4	
60600605	CONCRETE CURB, TYPE B	FOOT	100	100	
60605000	COMBINATION CONCRETE CURB AND GUTTER, TYPE B-6.24	FOOT	246	246	
60607400	COMPLINATION CONCRETE CURR AND CUTTER TYPE D.O. 24	FOOT	200	200	
60607400	COMBINATION CONCRETE CURB AND GUTTER, TYPE B-9.24	FOOT	208	208	
* 63000001	STEEL PLATE BEAM GUARDRAIL, TYPE A, 6 FOOT POSTS	FOOT	3,237.5	3,237.5	
* 63000003	STEEL PLATE BEAM GUARDRAIL, TYPE A, 9 FOOT POSTS	FOOT	17,762.5	17,762.5	
* 63100045	TRAFFIC BARRIER TERMINAL, TYPE 2	EACH	16	16	
* 63100085	TRAFFIC BARRIER TERMINAL, TYPE 6	EACH	12	12	
* 63100105	TRAFFIC BARRIER TERMINAL, TYPE 10	EACH	3	3	
* 63100167	TRAFFIC BARRIER TERMINAL, TYPE 1 (SPECIAL) TANGENT	EACH	25	25	
63200310	GUARDRAIL REMOVAL	FOOT	21,551	21,551	

^{*} SPECIALTY ITEMS

[#] NON-PARTICIPATING (100% STATE)

USER NAME = bartonrw	DESIGNED -	REVISED -
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PLOT DATE = May-06-2019 11:24:33 AM	DATE -	REVISED -

STATE OF ILLINOIS
DEPARTMENT OF TRANSPORTATION

CULTURE OF CULTURE	F.A.I. SECTION COUNTY TOTAL SHEET NO.
SUMMARY OF QUANTITIES	74 (37-3, 4)RS-2 HENRY 142 8
	CONTRACT NO. 64C06
SHEET 6 OF 11 SHEETS STA. TO STA.	ILLINOIS FED. AID PROJECT

				CONSTRUCTIO	ON TYPE CODE
CODE NUMBER	PAY ITEM	UNIT	TOTAL QUANTITIES	0005 ROADYWAY NHPP 90% FED	
				10% STATE	
63500105	DELINEATORS	EACH	103	103	
63800920	MODULAR GLARE SCREEN SYSTEM, TEMPORARY	FOOT	2,350	2,350	
64200116	SHOULDER RUMBLE STRIPS, 16 INCH	FOOT	148,479	148,479	
66700305	PERMANENT SURVEY MARKERS, TYPE II	EACH	8	8	
67000400	ENGINEER'S FIELD OFFICE, TYPE A	CAL MO	12	12	
67100100	MOBILIZATION	LSUM	1	1	
70100410	TRAFFIC CONTROL AND PROTECTION, STANDARD 701416	EACH	2	2	
70100420	TRAFFIC CONTROL AND PROTECTION, STANDARD 701411	EACH	4	4	
70100700	TRAFFIC CONTROL AND PROTECTION, STANDARD 701406	L SUM	1	1	
70100800	TRAFFIC CONTROL AND PROTECTION, STANDARD 701401	L SUM	1	1	
70100820	TRAFFIC CONTROL AND PROTECTION, STANDARD 701451	L SUM	1	1	
70100825	TRAFFIC CONTROL AND PROTECTION, STANDARD 701456	L SUM	1	1	
70103815	TRAFFIC CONTROL SURVEILLANCE	CAL DA	15	15	
70107025	CHANGEABLE MESSAGE SIGN	CAL DA	520	520	

^{*} SPECIALTY ITEMS

[#] NON-PARTICIPATING (100% STATE)

USER NAME = bartonrw	DESIGNED -	REVISED -					F.A.I. RTE	SECTION	COUNTY TOTAL SHEE
	DRAWN -	REVISED -	STATE OF ILLINOIS		SUMMARY OF QUANTITIES		74	(37-3, 4)RS-2	HENRY 142 9
PLOT SCALE = 100.0000 ' / in.	CHECKED -	REVISED -	DEPARTMENT OF TRANSPORTATION				-		CONTRACT NO. 64C06
PLOT DATE = May-06-2019 11:24:48 AM	DATE -	REVISED -		SCALE:	SHEET 7 OF 11 SHEETS STA	TO STA.		TILLINOIS SED	AID BROIECT

				CONSTRUCTIO	N TYPE CODE
CODE NUMBER	PAY ITEM	UNIT	TOTAL QUANTITIES	0005 ROADYWAY NHPP 90% FED 10% STATE	
70300100	SHORT TERM PAVEMENT MARKING	FOOT	18,071	18,071	
70300150	SHORT TERM PAVEMENT MARKING REMOVAL	SQ FT	6,024	6,024	
70300220	TEMPORARY PAVEMENT MARKING - LINE 4"	FOOT	348,464	348,464	
70300240	TEMPORARY PAVEMENT MARKING - LINE 6"	FOOT	654	654	
70300250	TEMPORARY PAVEMENT MARKING - LINE 8"	FOOT	1,900	1,900	
70300260	TEMPOARY PAVEMENT MARKING - LINE 12"	FOOT	133	133	
70400100	TEMPORARY CONCRETE BARRIER	FOOT	44,875.0	44,875.0	
70400200	RELOCATE TEMPORARY CONCRETE BARRIER	FOOT	38,412.5	38,412.5	
70500100	TEMPORARY STEEL PLATE BEAM GUARDRAIL, TYPE A	FOOT	2,050	2,050	
70500665	TEMPORARY TRAFFIC BARRIER TERMINAL, TYPE 6	EACH	5	5	
72000100	SIGN PANEL - TYPE 1	SQ FT	2	2	
72400100	REMOVE SIGN PANEL ASSEMBLY - TYPE A	EACH	1	1	
72501000	TERMINAL MARKER - DIRECT APPLIED	EACH	25		25
72800100	TELESCOPING STEEL SIGN SUPPORT	FOOT	12	12	

^{*} SPECIALTY ITEMS

[#] NON-PARTICIPATING (100% STATE)

USER NAME = bartonrw	DESIGNED -	REVISED -					F.A.I. RTE	SECTION	COUNTY TOTAL SH
	DRAWN -	REVISED -	STATE OF ILLINOIS		SUMMARY OF QUANTITIES		74	(37-3, 4)RS-2	HENRY 142
PLOT SCALE = 100.0000 ' / in.	CHECKED -	REVISED -	DEPARTMENT OF TRANSPORTATION						CONTRACT NO. 64C0
PLOT DATE - May 06 2019 11:25:00 AM	DATE	DEVISED		SCALE:	CHEET 9 OF 11 CHEETS STA	TO STA	-	THE PROPERTY OF THE PARTY OF TH	ID DROUECT

CODE NUMBER	PAY ITEM	UNIT	TOTAL QUANTITIES	CONSTRUCTION TYPE CODE 0005 ROADYWAY NHPP 90% FED 10% STATE
78000100	THERMOPLASITC PAVEMENT MARKING - LETTERS AND SYMBOLS	SQ FT	25	25
78000200	THERMOPLASTIC PAVEMENT MARKING - LINE 4"	FOOT	156,549	156,549
78000400	THERMOPLASTIC PAVEMENT MARKING - LINE 6"	FOOT	12,862	12,862
78000500	THERMOPLASTIC PAVEMENT MARKING - LINE 8"	FOOT	2,866	2,866
78000600	THERMOPLASTIC PAVEMENT MARKING - LINE 12"	FOOT	1,908	1,908
78003130	PREFORMED PLASTIC PAVEMENT MARKING, TYPE B - LINE 6"	FOOT	8,274	8,274
78009004	MODIFIED URETHANE PAVEMENT MARKING - LINE 4"	FOOT	44,500	44,500
78009006	MODIFIED URETHANE PAVEMENT MARKING - LINE 6"	FOOT	5,563	5,563
78100100	RAISED REFLECTIVE PAVEMENT MARKER	EACH	1,338	1,338
78100200	TEMPORARY RAISED REFLECTIVE PAVEMENT MARKER	EACH	304	304
78200005	GUARDRAIL REFLECTORS, TYPE A	EACH	175	175
78300200	RAISED REFLECTIVE PAVEMENT MARKER REMOVAL	EACH	1,338	1,338
A2000114	TREE, ACER X FREEMANII AUTUMN BLAZE (AUTUMN BLAZE FREEMAN MAPLE), 1-3/4" CALIPER, BALLE	EACH	4	4
A2006514	TREE, QUERCUS BICOLOR (SWAMP WHITE OAK), 1-3/4" CALIPER, BALLED AND BURLAPPED	EACH	3	3

- * SPECIALTY ITEMS
- # NON-PARTICIPATING (100% STATE)

USER NAME = bartonrw	DESIGNED -	REVISED -					F.A.I. RTE	SECTION	COUNTY	TOTAL SHEET
	DRAWN -	REVISED -	STATE OF ILLINOIS		SUMMARY OF QUANTITIES		74	(37-3, 4)RS-2	HENRY	142 11
PLOT SCALE = 100.0000 ' / in.	CHECKED -	REVISED -	DEPARTMENT OF TRANSPORTATION						CONTRACT	NO. 64C06
PLOT DATE = May-06-2019 11:25:10 AM	DATE -	REVISED -		SCALE:	SHEET 9 OF 11 SHEETS STA	TO STA		TILLINOIS SED A	D PROJECT	

				CONSTRUCTION	TYPE CODE
			TOTAL	0005 ROADYWAY	
CODE NUMBER	PAY ITEM	UNIT	QUANTITIES	NHPP 90% FED 10% STATE	
X0322288	MEDIAN CLOSURE	EACH	2	2	
				_	
X0322936	REMOVE EXISTING FLARED END SECTION	EACH	1	1	
# X0324589	PIPE UNDERDRAIN OUTLET EXTENSION FOR 4" PIPE	EACH	70	70	
X0326650	FILLING EXISTING RUMBLE STRIP	FOOT	48,766	48,766	
X0327979	PAVEMENT MARKING REMOVAL - GRINDING	SQ FT	26,300	26,300	
X0327980	PAVEMENT MARKING REMOVAL - WATER BLASTING	SQ FT	11,331	11,331	
X4400196	HOT-MIX ASPHALT SURFACE REMOVAL, SPECIAL	SQ YD	9,346	9,346	
X4401198	HOT-MIX ASPHALT SURFACE REMOVAL, VARIABLE DEPTH	SQ YD	2,329	2,329	
X6024503	INLETS TO BE ADJUSTED WITH NEW FRAME AND GRATE (SPECIAL)	EACH	3	3	
X7030005	TEMPORARY PAVEMENT MARKING REMOVAL	SQ FT	68,575	68,575	
* X7050167	TEMPORARY TRAFFIC BARRIER TERMINAL, TYPE 1, SPECIAL (TANGENT)	EACH	8	8	
X7830060	GROOVING FOR RECESSED PAVEMENT MARKING, LETTERS AND SYMBOLS	SQ FT	25	25	
X7830070	GROOVING FOR RECESSED PAVEMENT MARKING 5"	FOOT	156,549	156,549	
× X7830074	GROOVING FOR RECESSED PAVEMENT MARKING 7"	FOOT	12,862	12,862	

- * SPECIALTY ITEMS
- # NON-PARTICIPATING (100% STATE)

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					CONSTRUCTIO	N TYPE CODE
					0005	
					ROADYWAY	
	CODE NUMBER	PAY ITEM	UNIT	TOTAL		
	CODE NOMBER	TAT TIEM	OWI I	QUANTITIES	NHPP	
					90% FED	
					10% STATE	
	/7020076	CDOOVING FOR RECECCED RAVEMENT MARKING OF	F.00.T	2.066	2.066	
*	K7830076	GROOVING FOR RECESSED PAVEMENT MARKING 9"	FOOT	2,866	2,866	
*	(7830078	GROOVING FOR RECESSED PAVEMENT MARKING 13"	FOOT	1,908	1,908	
*	<8410102	TEMPORARY LIGHTING SYSTEM	L SUM	1	1	
	<u> </u>	CONSTRUCTION LAYOUT	LSUM	1	1	
1	20013796	CONSTRUCTION LATOUT	LSUM	1	1	
*	20016702	DETOUR SIGNING	L SUM	1	1	
-	Z0027800	GEOTECHNICAL FABRIC	SQ YD	641	641	
	20028415	GEOTECHNICAL REINFORCEMENT	SQ YD	855	855	
	Z0033700	LONGITUDINAL JOINT SEALANT	FOOT	132,514	132,514	
	20034105	MATERIAL TRANSFER DEVICE	TON	55,690	55,690	
Ø	Z0076600	TRAINEES	HOUR	2000	2000	
	Z0065775	SLOTTED DRAIN 24" WITH VARIABLE SLOT	FOOT	163	163	
Ø	Z0076604	TRAINEES TRAINING PROGRAM GRADUATE	HOUR	2000	2000	

^{*} SPECIALTY ITEMS

PLOT DATE = May-06-2019 11:25:45 AM

DATE

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USER NAME = bartonin DESIGNED - REVISED - REVISED - STATE OF ILLINOIS SUMMARY OF QUANTITIES

SUMMARY OF QUANTITIES

SUMMARY OF QUANTITIES

SUMMARY OF QUANTITIES

F.A.I. SECTION COUNTY TOTAL SHEETS NO. 54 COUNTY SHEETS N

SHEET 11 OF 11 SHEETS STA.

TO STA.

[#] NON-PARTICIPATING (100% STATE)

GENERAL NOTES

All Borrow/Waste/Use sites must be approved by the Department prior to removing any material from the project or initiating any earthmoving activities, including temporary stockpiling outside the limits of construction.

The final top 4 inches of soil in any right-of-way area disturbed by the Contractor must be capable of supporting vegetation. The soil must be from the A horizon (zero to 2' deep) of soil profiles of local soils. The cost of this work shall be included in the unit prices bid and no additional compensation will be allowed.

The Contractor shall seed all disturbed areas within the project limits. Seeding Class 2A shall be used. Class 2A shall be used on front slopes and ditch bottoms. The Contractor shall verify that permanent seeding has been established before the project is finalized.

Previously pugmilled stockpiles of "Type A" older than 1 month will not be approved for use until a moisture check is run to verify moisture content. Material shipped to projects without being tested will not be accepted.

All "Aggregate Subgrade Improvement" (Section 303), shall be completed in accordance with Articles 311.04, 311.05, 311.05(a), 311.06 and 311.07. All aggregate subgrade thicknesses equal to or less than 12 inches shall be constructed of aggregate of CA02 gradation. All aggregate subgrade thicknesses greater than 12 inches shall be constructed of CS02.

The Contractor will be required to furnish 5 1/2" high brass stencils as approved by the Engineer and install stationing at 250' intervals. Stationing shall be placed on both lanes of 2-lane highways and on the outside lanes in both directions on 4-lane highways. The stations shall be placed 6" inside the pavement marking edge so they can be read from the shoulder. This work will be included in the cost of the final pavement surface.

When laying out for patching, the minimum distance between new patches (saw cut to saw cut) shall be 15 feet. When patch spacing is less than 15 feet, the pavement between patches shall also be removed and replaced.

All mandatory joint sealing for Class A and Class B patches as shown on the plans will not be measured for payment. Optional sawing of the joint for the sealant reservoir will not be measured for payment.

For all concrete patching that will not be resurfaced, the concrete shall be struck off flush with the existing pavement surface at each end of the patch.

The Engineer reserves the right to check all patches for smoothness by the use of a 10' rolling straight edge set to a 3/16" tolerance in the wheel paths. Any patch areas higher than 3/16" must be ground smooth with an approved grinding device consisting of multiple saws. The use of bushhammer or other impact devices will not be permitted. Any patch with depressions greater than 3/16" shall be repaired in a manner approved by the Engineer.

The mandatory saw cuts for pavement patching are:

<u>Class A Patch</u>: Cut two transverse saw cuts at each end of the patch; one full depth and one partial depth. The longitudinal edges of the patch shall be cut full depth. When the patch is adjacent to a pcc shoulder, two saw cuts along the shoulder will be required.

<u>Class B Patch</u>: Cut two transverse saw cuts outlining the patch and one transverse pressure relief saw cut. The longitudinal edges of the patch shall be cut full depth. When the patch is adjacent to a pcc shoulder, two saw cuts along the shoulder will be required.

The mandatory saw cuts will be paid for at the contract unit price per Foot for SAW CUTS.

The following Mixture Requirements are applicable for this project:

Location(s):	Resurfacing				
Mixture Use(s):	Surface	Leveling Binder			
PG:	SBS PG 70-22	SBS PG 70-22			
Design Air Voids:	4.0 @ N90	4.0 @ N90			
Mixture Composition					
(Mixture Gradation):	IL 9.5	IL 9.5 FG			
Friction Aggregate:	D	N/A			
Mixture Weight:	112 lb/sy/in	112 lb/sy/in			
Quality Management Program:	PFP	PFP			
Sublot Size:	1000	1000			
Number of Roller Passes ¹⁾ :					

Location(s):	Shoulders			
Mixture Use(s):	Top lift	All lower lifts		
PG:	PG 64-22	PG 64-22		
Design Air Voids:	4.0 @ N50	4.0 @ N50		
Mixture Composition				
(Mixture Gradation):	IL 9.5	IL 19.0		
Friction Aggregate:	С	N/A		
Mixture Weight:	112 lb/sy/in	112 lb/sy/in		
Quality Management Program:	QCP	QCP		
Sublot Size:	1000	1000		
Number of Roller Passes ¹⁾ :				

Location(s):	U-Turn and Re	st Area Overlay
Mixture Use(s):	Surface	Leveling Binder
PG:	PG 64-22	PG 64-22
Design Air Voids:	4.0 @ N50	4.0 @ N50
Mixture Composition		
(Mixture Gradation):	IL 9.5	IL 9.5 FG
Friction Aggregate:	С	N/A
Mixture Weight:	112 lb/sy/in	112 lb/sy/in
Quality Management Program:	QC/QA	QC/QA
Sublot Size:		
Number of Roller Passes ¹⁾ :		

Location(s):	Temporary	y Crossover
Mixture Use(s):	Surface	Binder
PG:	PG 64-22	PG 64-22
Design Air Voids:	4.0 @ N70	4.0 @ N70
Mixture Composition		
(Mixture Gradation):	IL 9.5	IL 19.0
Friction Aggregate:	D	N/A
Mixture Weight:	112 lb/sy/in	112 lb/sy/in
Quality Management Program:	QC/QA	QC/QA
Sublot Size:		
Number of Roller Passes ¹⁾ :		

The area to be tacked or primed shall be limited to that which can be covered with HMA on the next day's production, but no more than five days in advance of the placement of the HMA, unless approved by the Engineer.

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FILE NAME = 64C06.GN.DOCX	PLOT SCALE =	CHECKED -	REVISED -	DEPARTMENT OF TRANSPORTATION						CONTRACT NO. 6	64C06		
	PLOT DATE = 5/6/2019 7:36 AM	DATE - 5/5/2017 8:29 AM	REVISED -	SCAL SCAL	SCALE:	SHEET NO 1 OF 3 SHEETS	STA. TO STA.				ILLINOIS	FED. AID PROJEC	ΣT

GENERAL NOTES

Install rumble strips in all shoulders in accordance with State Standard 642001 Rumble Strips shall be placed on shoulders on both sides of the pavement.

Embankment quantities for the construction of the Traffic Barrier Terminals as shown in the plans are included in quantities for Earth Excavation.

The Contractor shall supply the Resident Engineer with the manufacturer's installation requirements for the type of Steel Plate Beam Guardrail Terminal Type 1 Special (Flared).

One 16d galvanized nail shall be used to toe nail the wood block out to the wood post on all Traffic Barrier Terminal Type I Specials.

Delineators shall be installed as shown in Standard 635001, except that the post shall be rotated 180° and only metal-backed delineators shall be permitted. Delineators shall be placed at the ends of approach guardrail terminal sections, and at each headwall or end section of AR Culverts. This work will be paid for at the contract unit price each for DELINEATORS.

The Contractor shall be responsible for collecting and maintaining an electronic log of all stakeout survey that is performed on the job, either by him/her or any sub-contractor performing the stakeout. Upon request, all logs shall be submitted to the Department. No additional compensation will be allowed for this work, but shall be considered included in the cost for CONSTRUCTION LAYOUT.

Tree planting layout shall be performed by the District Roadside Management Specialist. Mulch shall be placed 4" thick and to the diameter around the tree as shown on District Standard 92.1. The mulch shall be hardwood wood chips placed on weed barrier fabric. This work shall be included in the cost of the tree. Excess trees that cannot be planted along the I-74 project limits shall be planted at alternative locations in Henry County as determined by the District Roadside Management Specialist.

Pavement Marking shall be done according to Standard 780001, except as follows:

- 1. The distance between yellow no-passing lines shall be 8 inches, not 7 inches, as shown in the detail of Typical Lane and Edge Lines.
- 2. Centerline Skip Dash Pavement Marking on multi-lane divided, multi-lane undivided, and one-way roadway shall be according to District Standard 41.1.

PERMANENT SURVEY MARKERS, TYPE II, shall be set at intervals of 1 mile or as directed by the Engineer. Bridge or culvert projects shall have one survey marker placed near the structure. Estimated: 8 Each.

Permanent Survey Markers, Type II shall be cast-in-place as shown on District Standard 66.2, or another option would be to install a vaulted style, monumented as described by NGS as a 3D monument (Top Security Sleeve Rod Monument), with installation instructions provided by the District Chief of Surveys. If poured in place, the bottom of the marker shall be 5'-0" below the ground surface.

The Permanent Survey Markers, if possible, shall be installed at the beginning of the job and protected throughout.

The Contractor shall submit to the Engineer a description of location, elevation, and coordinates for each permanent survey marker. The horizontal coordinates must be derived by GPS and the elevation derived using an electronic level. The meta data, such as the Geoid used, (NGS adjustment ie: 97 HARN, 03, 07), and the base point(s) name or number shall be submitted along with a complete collection log. If collected using RTK method, it will require either 3 collections (averaged) from 2 different bases, or a minimum of 3 collections (averaged), at least 2 hours apart, from the same base. If using a CORS type network, the collection procedure shall include localizing with check shots on at least 2 different HARN monuments both before and after collection. The level circuit shall be run from furnished mark to furnished mark and then adjusted. The error of closure shall be submitted with the electronic level notes in a recognized format

approved by the Engineer and/or the Chief of Surveys. The Engineer shall submit this information to the District Chief of Surveys.

The Contractor shall be responsible for locating and protecting utility property during construction operations as outlined in Article 107.39 of the Standard Specifications. A minimum of 48 hours advance notice is required for non-emergency work. The JULIE number is 800-892-0123. The following listed utilities located within the project limits or immediately adjacent to the project construction limits are members of JULIE:

AT&T (309) 793-4456 ANR Pipeline Company (708) 342-4726 Woodhull Telephone Company (309) 334-2150 MidAmerican Energy (309) 793-3707 Paetec (630) 925-4751 Village of Woodhull (309) 334-2600

Ameren IP (815) 224-6270 Frontier/Citizens (815) 493-1101 Lightcore (636) 887-4755 MidAmerican Energy (309) 793-3833 Mediacom (309) 743-4750

IDOT is not a member of JULIE. If you are near any overhead lighting, intersection lighting or traffic signals, contact the IDOT Traffic Office at 815/284-5469 at least 48 hours prior to work.

CADD data will be available to Contractors and Consultants working on this project, once the project has been awarded. This information will be provided upon request as MicroStation CADD files and Geopak coordinate geometry files ONLY. If data is required in other formats it will be your responsibility to make these conversions. If any discrepancy or inconsistency arises between the electronic data and the information on the hard copy, the information on the hard copy should be used. Contact the District's Project Engineer to request these files.

Relocate Temporary Impact Attenuators shall include storage and transportation to and from storage, when the device is not needed for a time, as shown on the staging plans. This shall be included in the contract unit price per Each for IMPACT ATTENUATORS, RELOCATE of the type specified.

When Relocate Temporary Concrete Barrier is specified, the wall shall be removed, storage and transportation to and from storage, when the wall is not needed for a time as shown on the staging plans, relocated and reinstated at the new location. The reinstallation requirements shall be the same as those for a new installation. This shall be paid for at the contract unit price per Foot for RELOCATE TEMPORARY CONCRETE BARRIER.

The barrier unit at each end shall be anchored as specified in Article 704.04. All anchoring and pinning holes shall be core drilled.

Excess trees that cannot be planted along the I-74 project limits shall be planted at alternative locations in Henry County as determined by the District Roadside Management Specialist.

During grinding operations, concrete patches will be encountered. The grinding of the concrete shall not be paid for separately, but shall be included in the cost of HMA SURFACE REMOVAL of the thickness specified.

Aggregate shoulders, 8" shall be placed on top of existing aggregate shoulders; no exception is required. No additional payment shall be made for variances in the existing aggregate shoulder drop-off thickness.

I-74 shall be milled to bare concrete. Core reports show an average overlay thickness of 4.8". No additional payment shall be made for variances in the existing HMA surface thickness. This work shall be paid for at the contract unit price per Square Yard for HOT MIX ASPHALT SURFACE COURSE REMOVAL 5".

Stone Riprap, Class 3A does not require the installation of filter fabric. Stone Riprap, Class 3A is to cover all areas of existing riprap and shall be placed on top of the existing stone.

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FILE NAME = 64C06.GN.DOCX	PLOT SCALE =	CHECKED -	REVISED -	DEPARTMENT OF TRANSPORTATION	OENEIVIE NOTES					CONTRAC	CT NO. 64C06	
	PLOT DATE = 5/6/2019 7:38 AM	DATE - 5/5/2017 8:29 AM	REVISED -		SCALE:	SHEET NO 2 OF 3 SHEETS STA. TO STA.			ILLINO	IS FED. AID I	PROJECT	-1

GENERAL NOTES

Closed expansion joints on jointed pavements shall be re-established during the patching operations. Class B Patches - when the pavement requires patching at the location of the expansion joint, a new joint should be established using a dowelled expansion patch as shown on Highway Standard 442101. When the joint is closed, but does not require patching, an expansion joint may be formed by sawing the pavement and filling the saw cut with a preformed expansion joint filler meeting the requirements of Section 1051 of the Standard Specifications as shown on Standard 420001.

Material transfer device must be emptied to cross the following structures:

Structure Number:

037-0013	037-0014	037-0015
037-0016	037-0017	037-0018
037-0166	037-1163	037-1165

COMMITMENTS

All crossovers shall be fully closed after completing the project. No gaps in the chaining will be permitted.

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	PLOT DATE = 5/17/2019 11:38 AM	DATE - 5/5/2017 8:29 AM	REVISED -


STATE OF ILLINOIS
DEPARTMENT OF TRANSPORTATION

	ROUTE	ROUTE SECTION		COUNTY	TOTAL SHEETS	SHEET NO.	
GENERAL NOTES	FAI Route 7	FAI Route 74 (I-74) (37-3,4)RS-2		3,4)RS-2	Henry	142	16
					CONTRACT NO.	64C06	
TNO 3 OF 3 SHEETS STA TO STA				SIONITII	EED VID DDO I		

STA. 1285+65 + STA. 1361+65 STA. 1380+41 - STA. 1414+17 STA. 1432+50 - STA. 1513+62 STA. 1619+26 - STA. 1621+90 STA. 1640+76 - STA. 1672+56

PAVING GAP

STA. 1361+65 - STA. 1380+41 STA. 1414+17 - STA. 1432+50 STA. 1621+90 - STA. 1640+76

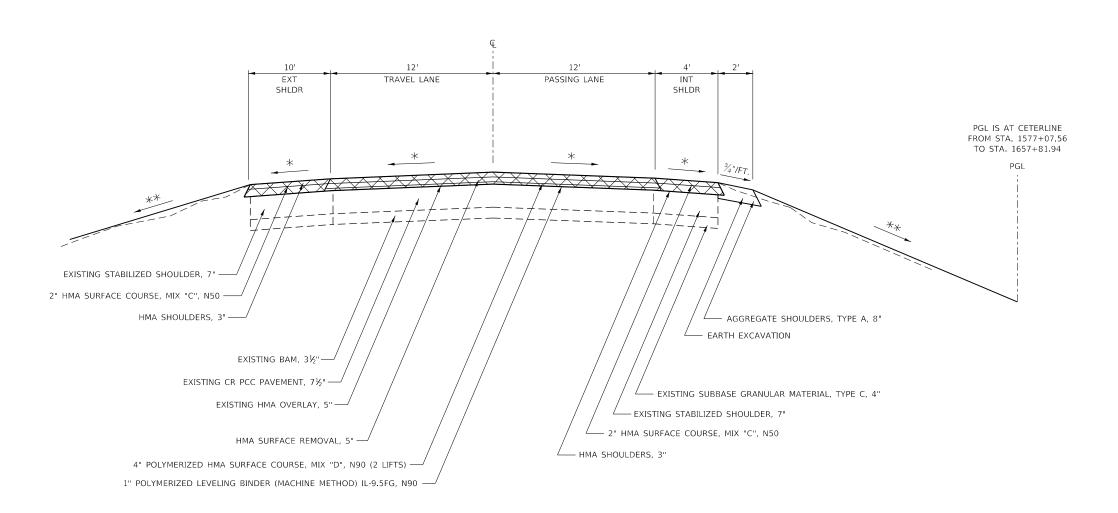



112#/IN/SQ YD

* MATCH EXISTING CROSS SLOPE (MINIMUM ½"/FT)


** MAINTAIN EXISTING FORESLOPE

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STATE OF ILLINOIS
DEPARTMENT OF TRANSPORTATION

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	TYPICAL SECTIONS				I-74	(37-3,4)RS-2		HENRY	142	17		
										CONTRACT	NO. 6	1C06
	SHEET	1	OF 18	SHEETS	STA.	TO STA.	ILLINOIS FED. A			ID PROJECT		

STA 1361+65 - STA 1370+36 STA 1371+78 - STA 1380+41 STA 1414+17 - STA 1422+71 STA 1423+89 - STA 1432+50 STA 1621+90 - STA 1630+59 STA 1631+94 - STA 1640+76

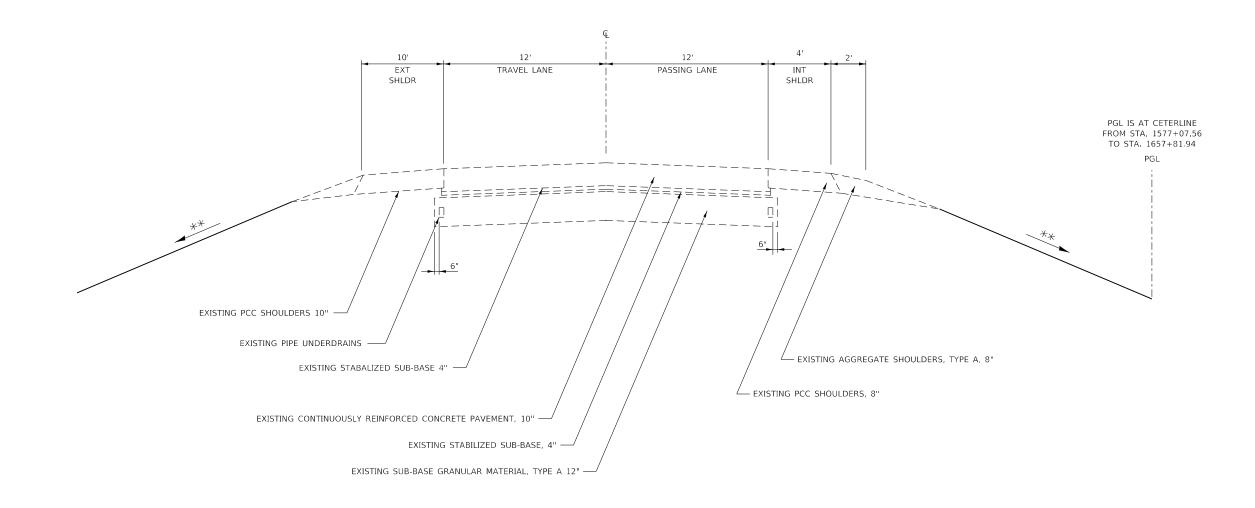

<u>BRIDGE</u> WB (NORTH BOUND)

STA 1370+36 - STA 1371+78 STA 1422+71 - STA 1423+89 STA 1630+59 - STA 1631+94

REMOVAL

112#/IN/SQ YD

★ MATCH EXISTING CROSS SLOPE (MINIMUM ⅓"/FT)


★★ MAINTAIN EXISTING FORESLOPE

USER NAME = bartonrw	DESIGNED -	REVISED -
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STATE OF ILLINOIS DEPARTMENT OF TRANSPORTATION

						F.A.I. RTE	SECTION	COUNTY	TOTAL SHEETS	SHEET NO.
TYPICAL SECTIONS						I-74	(37-3,4)RS-2	HENRY	142	18
								CONTRACT	NO. 64	4C06
SHEET 2	OF	18	SHEETS	STA.	TO STA.		ILLINOIS FEI	D. AID PROJECT		

STA. 1513+62 - STA. 1540+55 STA. 1553+00 - STA. 1568+43 STA. 1574+88 - STA. 1619+26

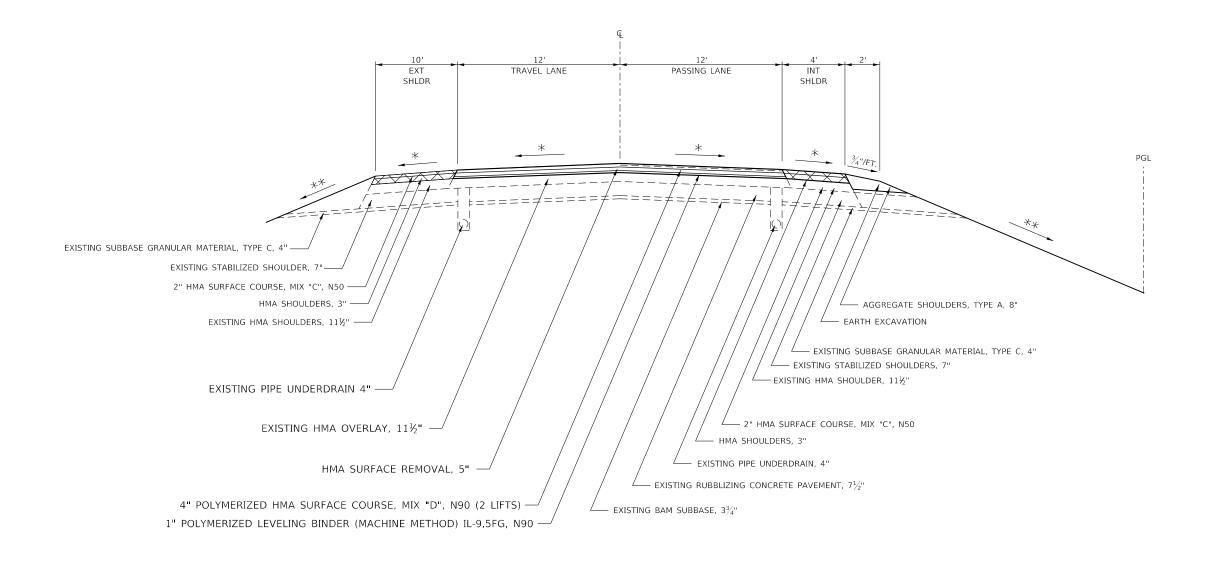

REMOVA

112#/IN/SQ YD

★ MATCH EXISTING CROSS SLOPE (MINIMUM ¾"/FT)


★★ MAINTAIN EXISTING FORESLOPE

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STATE OF ILLINOIS
DEPARTMENT OF TRANSPORTATION

						F.A.I. RTE	SECTION		COUNTY	TOTAL SHEETS	SHEET NO.
TYPICAL SECTIONS						I-74	(37-3,4)RS-2		HENRY	142	19
									CONTRACT	NO. 64	1C06
SHEET 3	OF	18	SHEETS	STA.	TO STA.		ILLINOIS	FED. AI	D PROJECT		

STA. 1540+55 - STA. 1550+05

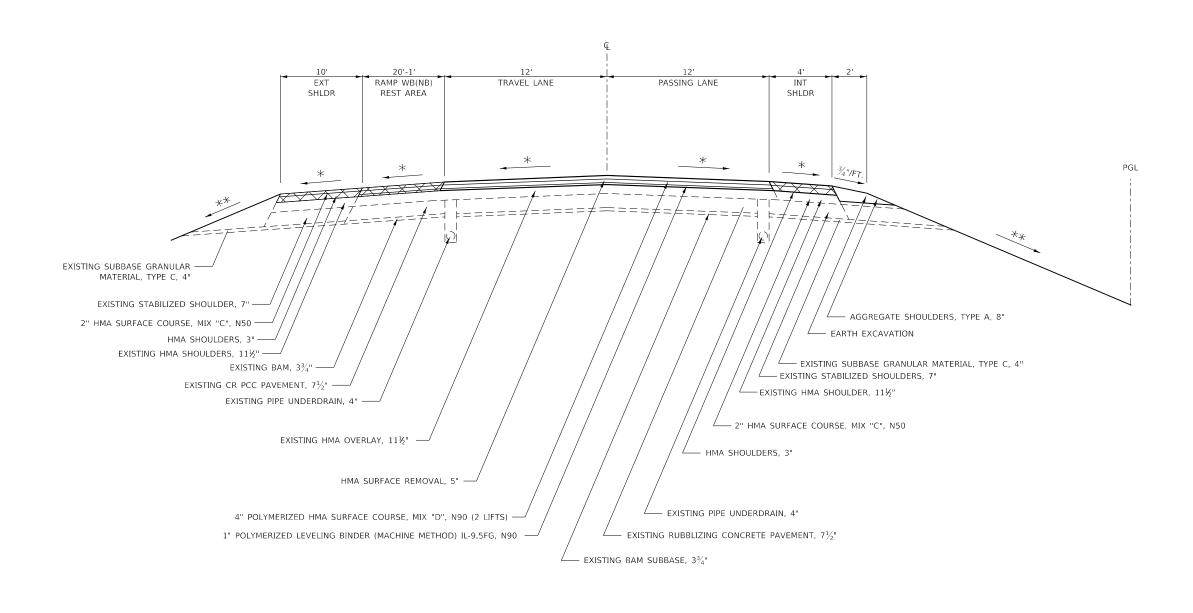

112#/IN/SQ YD


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**	MAINTAIN	EXISTING	FORE	ESLOPE		

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STATE OF	ILLINOIS
DEPARTMENT OF	TRANSPORTATION

						F.A.I. RTE	SECTION	COUNTY	TOTAL SHEETS	SHEET NO.
TYPICAL SECTIONS						I-74	(37-3,4)RS-2	HENRY	142	20
								CONTRACT	NO. 64	4C06
SCALE:	SHEET 4	OF 18	SHEETS	STA.	TO STA.		ILLINOIS FEI	D. AID PROJECT		

STA. 1550+05 - STA. 1553+00

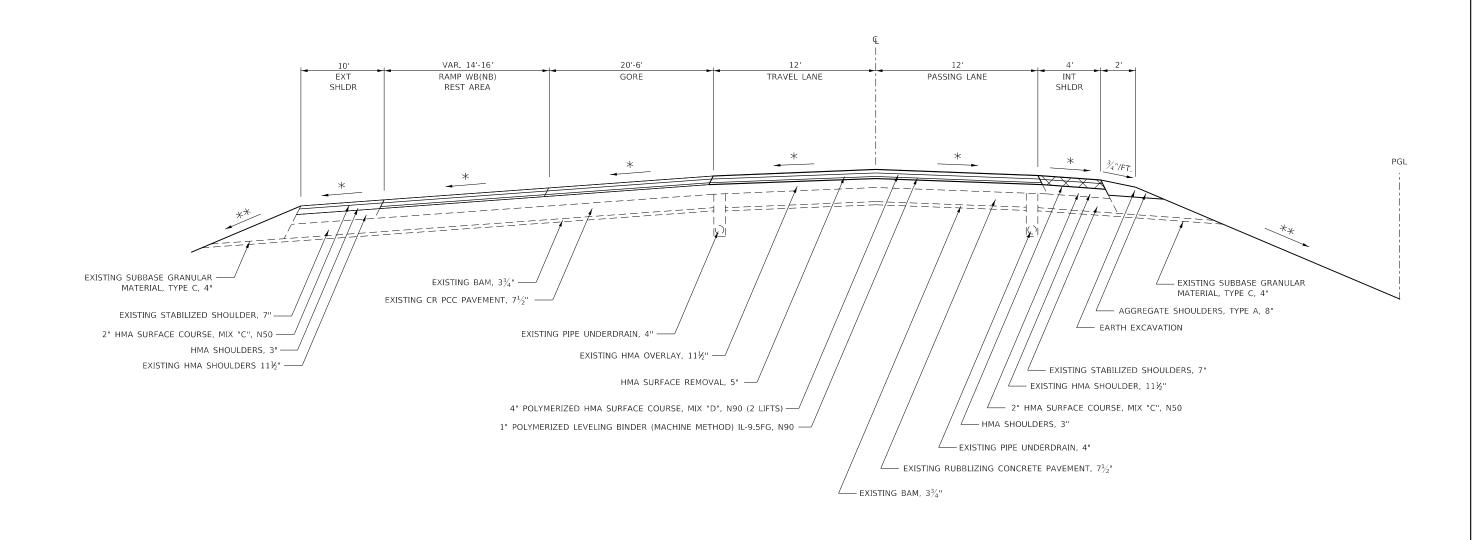

REMOV

112#/IN/SQ YD

* MATCH EXISTING CROSS SLOPE (MINIMUM ½"/FT)

** MAINTAIN EXISTING FORESLOPE

USER NAME = bartonrw	DESIGNED -	REVISED -
	DRAWN - SKV	REVISED -
PLOT SCALE = 80.0000 ' / in.	CHECKED -	REVISED -
PLOT DATE = May-06-2019 07:53:58 AM	DATE -	REVISED -


STATE OF ILLINOIS
DEPARTMENT OF TRANSPORTATION

SCALE:

| F.A.I. | SECTION | COUNTY | SHEETS | NO. | 10 STA. | SHEETS | NO. | SHEETS | SHEETS | NO. | SHEETS | SHEETS | NO. | SHEETS | SHEETS | SHEETS | SHEETS | SHEETS | SHEETS |

MODEL: Default FILE NAME: pw:\balancom dot illin

STA. 1568+43 - STA. 1572+10

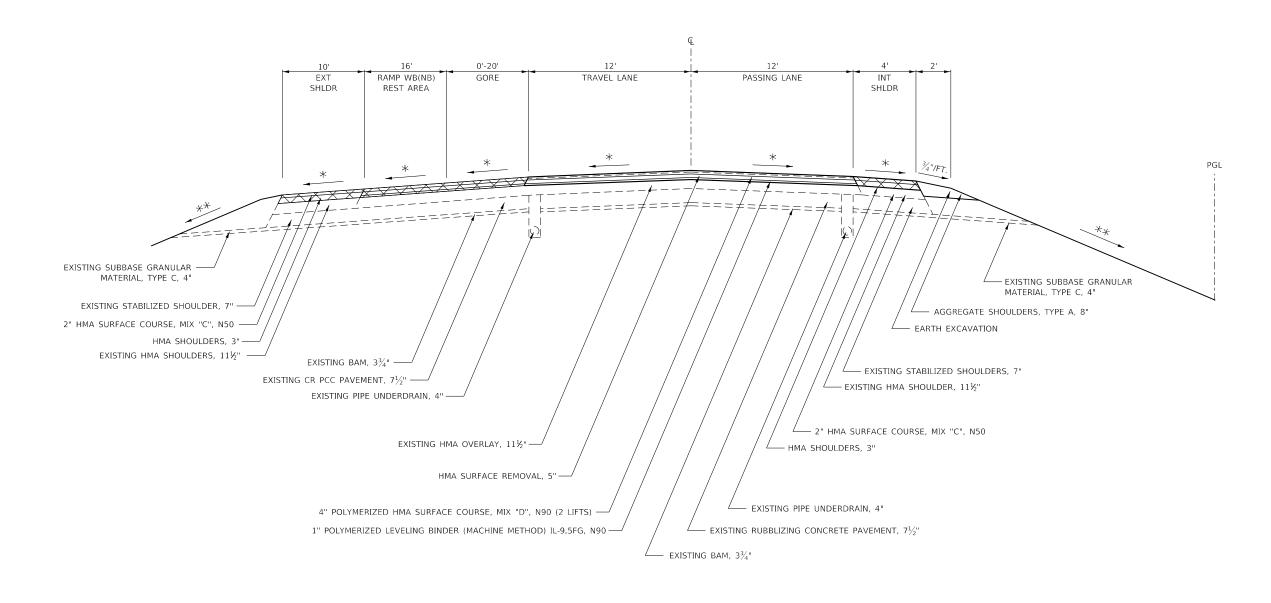

REMOVA

112#/IN/SQ YD

★ MATCH EXISTING CROSS SLOPE (MINIMUM ½"/FT)


★★ MAINTAIN EXISTING FORESLOPE

USER NAME = bartonrw	DESIGNED -	REVISED -
	DRAWN - SKV	REVISED -
PLOT SCALE = 80.0000 ' / in.	CHECKED -	REVISED -
PLOT DATE = May-06-2019 07:54:14 AM	DATE -	REVISED -

STATE OF ILLINOIS
DEPARTMENT OF TRANSPORTATION

			F.A.I. RTE	SECTION	COUNTY	TOTAL SHEETS	SHEET NO.		
		TYPICAL SECT	I-74	(37-3,4)RS-2	HENRY	142	22		
							CONTRACT	NO. 64	1C06
SCALE:	SHEET 6	OF 18 SHEETS	STA.	TO STA.		ILLINOIS FED. A	D PROJECT		

STA. 1572+10 - STA. 1574+88

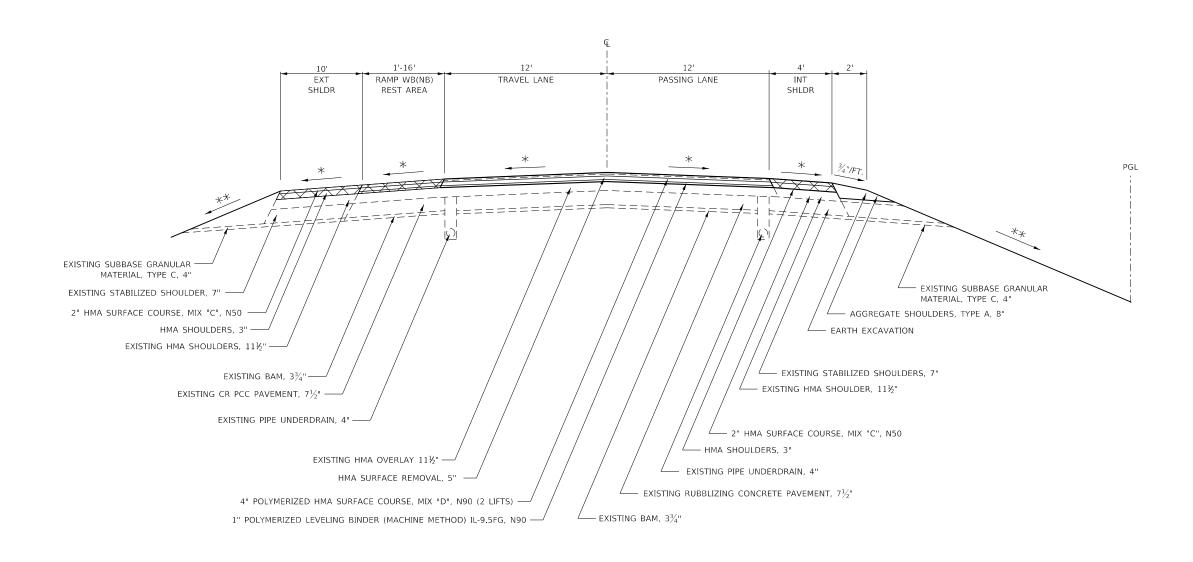

REMOVA

112#/IN/SQ YD * MATCH EXISTING CROSS SLOPE (MINIMUM $\frac{1}{6}$ "/FT)

MAINTAIN EXISTING FORI	ESLOPE	
	USER NAME = bartonrw	DESIGNED -

PLOT SCALE = 80.0000 ' / in.

PLOT DATE = May-06-2019 07:54:28 AM

STATE OF ILLINOIS
DEPARTMENT OF TRANSPORTATION

REVISED -

REVISED -

REVISED

REVISED -

DRAWN - SKV

CHECKED -


DATE

TVDIOAL OFOTIONO						SECTION		COUNTY	TOTAL SHEETS	SHEET NO.
		TYPICAL SEC	TIONS		I-74	(37-3,4)RS-2		HENRY	142	23
								CONTRACT	NO. 64	4C06
SCALE:	SHEET 7	OF 18 SHEET	S STA.	TO STA.		ILLINOIS	FED. AI	D PROJECT		

STA. 1285+65 - STA. 1361+60 STA. 1380+46 - STA. 1414+29 STA. 1432+34 - STA. 1474+31 STA. 1480+84 - STA. 1497+10 STA. 1509+55 - STA. 1622+10 STA. 1640+49 - STA. 1672+56

PAVING GAP

STA. 1361+60 - STA. 1380+46 STA. 1414+29 - STA. 1432+34 STA. 1622+10 - STA. 1640+49

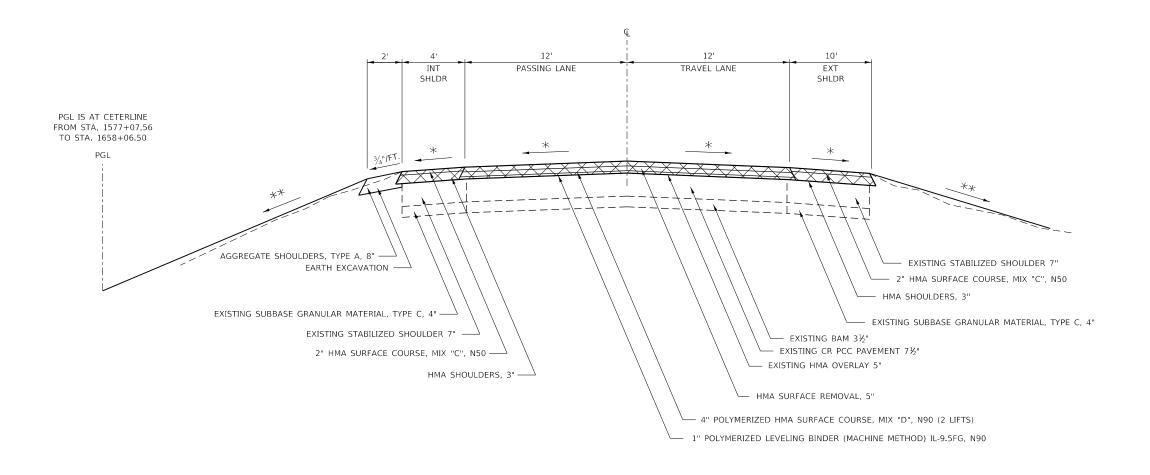




112#/IN/SQ YD * MATCH EXISTING CROSS SLOPE (MINIMUM %"/FT) ** MAINTAIN EXISTING FORESLOPE

USER NAME = bartonrw	DESIGNED -	REVISED -
	DRAWN - SKV	REVISED -
PLOT SCALE = 80.0000 ' / in.	CHECKED -	REVISED -
PLOT DATE = May-06-2019 07:55:01 AM	DATE -	REVISED -

STATE OF ILLINOIS
DEPARTMENT OF TRANSPORTATION

		T /DIO 1				F.A.I. RTE	SECTION		COUNTY	TOTAL SHEETS	SHEET NO.
	TYPICAL SECTIONS						(37-3,4)RS-2		HENRY	142	24
									CONTRACT	NO. 64	1C06
ALE:	SHEET 8	OF 18	SHEETS	STA.	TO STA.		ILLINOIS	FED. AID	PROJECT		

STA 1361+60 - STA 1370+36 STA 1371+78 - STA 1380+46 STA 1414+29 - STA 1422+71 STA 1423+89 - STA 1432+34 STA 1622+10 - STA 1630+66 STA 1632+05 - STA 1640+49

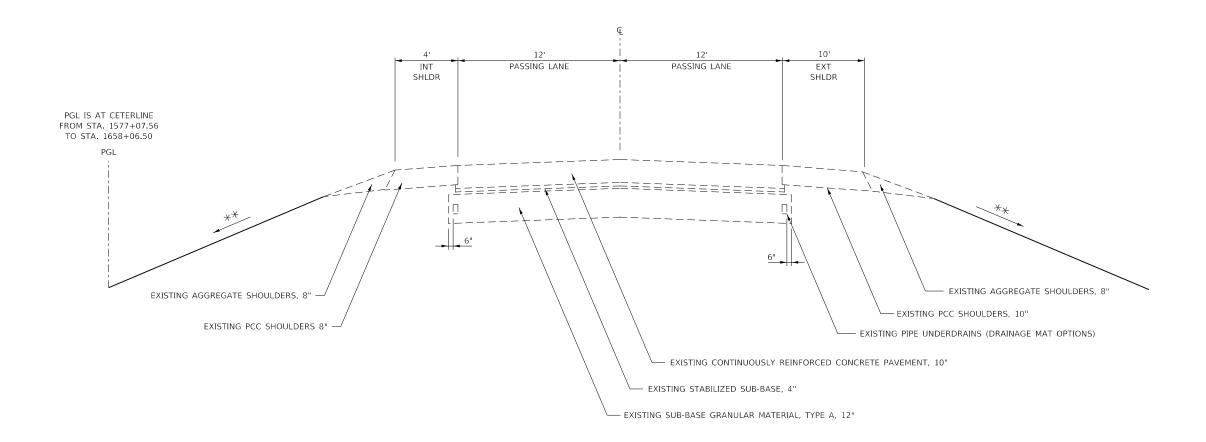



112#/IN/SQ YD * MATCH EXISTING CROSS SLOPE (MINIMUM %"/FT) ** MAINTAIN EXISTING FORESLOPE

BRIDGES EB (SOUTH BOUND)


STA 1370+36 - STA 1371+78 STA 1422+71 - STA 1423+89 STA 1630+66 - STA 1632+05

USER NAME = bartonrw	DESIGNED -	REVISED -
	DRAWN - SKV	REVISED -
PLOT SCALE = 80.0000 ' / in.	CHECKED -	REVISED -
PLOT DATE = May-06-2019 07:55:16 AM	DATE -	REVISED -

STATE OF ILLINOIS
DEPARTMENT OF TRANSPORTATION

							F.A.I. RTE	SECTION	COUNTY	TOTAL SHEETS	SHEET NO.
	TYPICAL SECTIONS						I-74	(37-3,4)RS-2	HENRY	142	25
									CONTRACT	NO. 6	4C06
SCA	LE:	SHEET 9	OF 18	SHEETS	STA.	TO STA.		ILLINOIS FED.	AID PROJECT		

STA. 1474+31 - STA. 1477+27

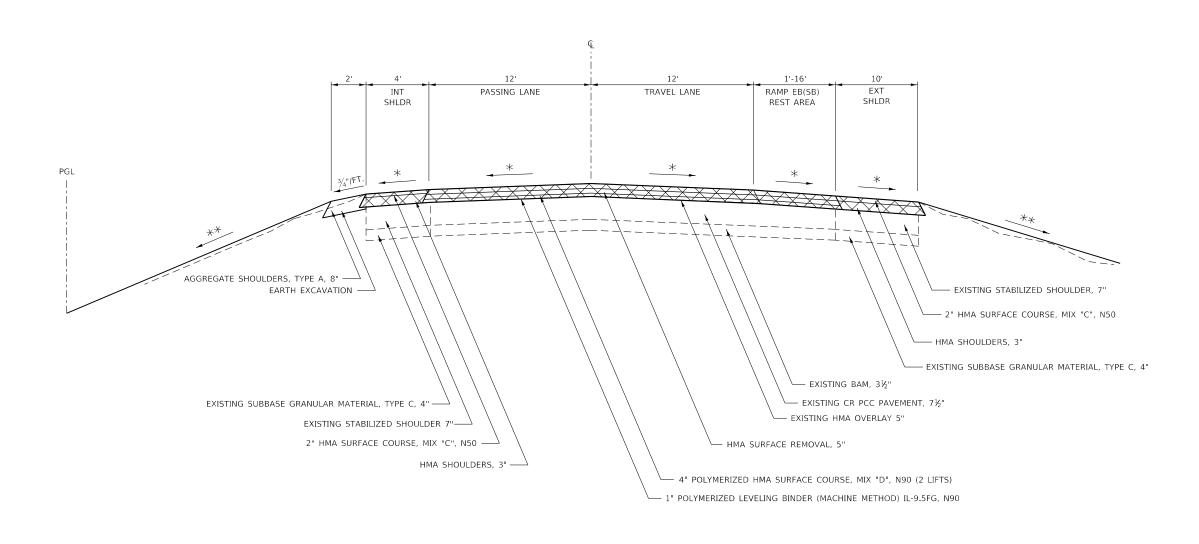

REMOVA

112#/IN/SQ YD
* MATCH EXISTING CROSS SLOPE (MINIMUM ½"/FT)


** MAINTAIN	EXISTING	FORESLOPE
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USER NAME = bartonrw	DESIGNED -	REVISED -
	DRAWN - SKV	REVISED -
PLOT SCALE = 80.0000 ' / in.	CHECKED -	REVISED -
PLOT DATE = May-06-2019 07:55:29 AM	DATE -	BEVISED -

STATE OF ILLINOIS
DEPARTMENT OF TRANSPORTATION

		T /DIA				F.A.I. RTE	SEC.	TION		COUNTY	TOTAL SHEETS	SHEET NO.
	TYPICAL SECTIONS						(37-3,	4)RS-2		HENRY	142	26
										CONTRACT	NO. 64	1C06
SCALE:	SHEET 10	OF 18	SHEETS	STA.	TO STA.			ILLINOIS	FED. AI	D PROJECT		

STA. 1477+27 - STA. 1480+84

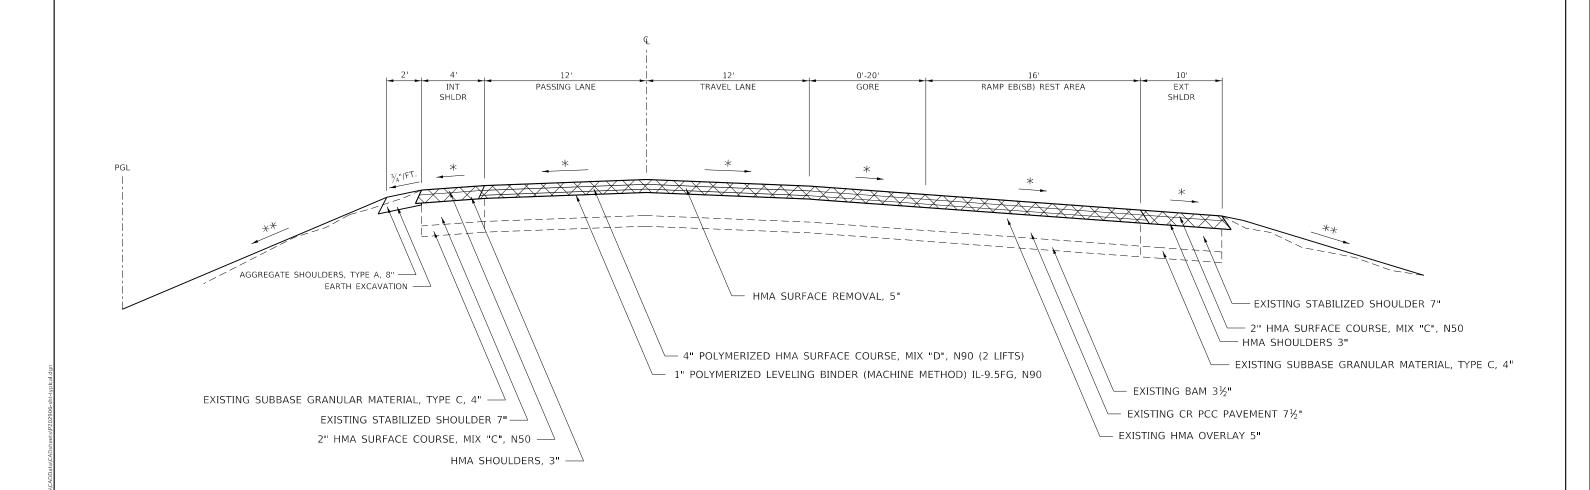

REMOV

112#/IN/SQ YD

★ MATCH EXISTING CROSS SLOPE (MINIMUM ½"/FT)

★★ MAINTAIN EXISTING FORESLOPE

USER NAME = bartonrw	DESIGNED -	

PLOT DATE = May-06-2019 07:55:43 AM

CHECKED -

PLOT SCALE = 80.0000 ' / in.


REVISED -

REVISED -

STATE OF	FILLINOIS
DEPARTMENT OF	TRANSPORTATION

	TVDICAL CECTIONS						SECTION	COUNTY	TOTAL SHEETS	SHEET NO.
	TYPICAL SECTIONS					I-74	(37-3,4)RS-2	HENRY	142	27
								CONTRACT	NO. 6	4C06
	SHEET 11	OF 18	SHEETS	STA.	TO STA.		ILLINOIS FI	ED. AID PROJECT		

STA. 1497+10 - STA. 1500+05

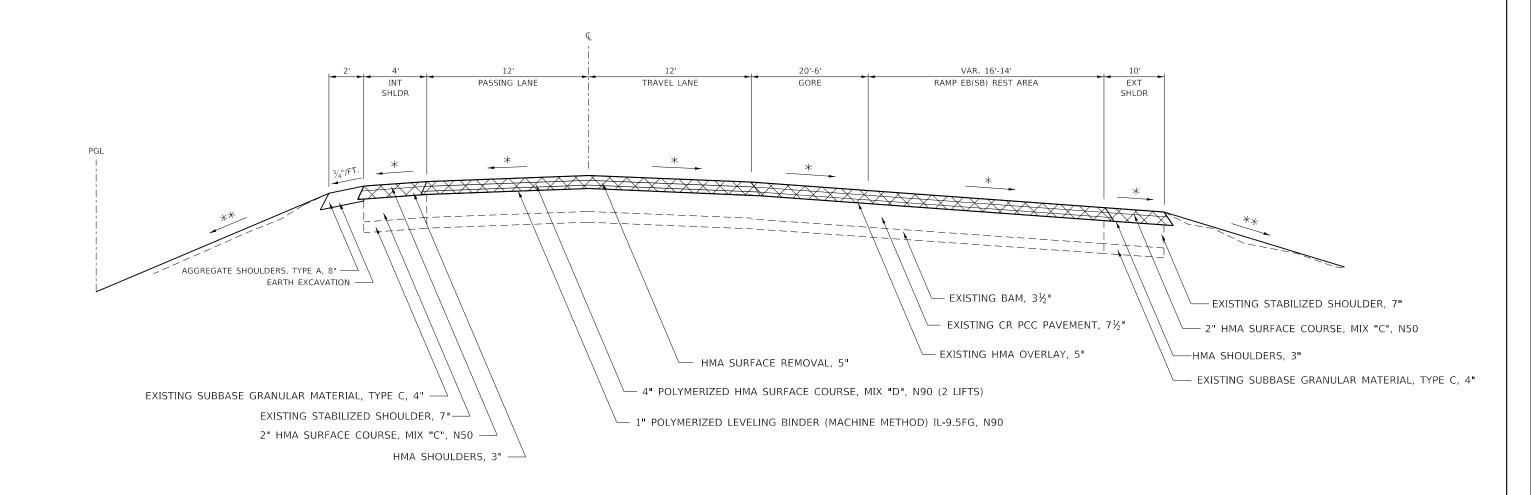


112#/IN/SQ YD * MATCH EXISTING CROSS SLOPE (MINIMUM %"/FT)
** MAINTAIN EXISTING FORESLOPE

USER NAME = bartonrw	DESIGNED -	REVISED -
	DRAWN - SKV	REVISED -
PLOT SCALE = 80.0000 ' / in.	CHECKED -	REVISED -
PLOT DATE = May-06-2019 07:55:56 AM	DATE -	REVISED -

STATE OF ILLINOIS
DEPARTMENT OF TRANSPORTATION

TVDICAL SECTIONS						SECTION	COUNTY	TOTAL SHEETS	SHEET NO.
TYPICAL SECTIONS					I-74	(37-3,4)RS-2	HENRY	142	28
							CONTRACT	NO. 64	4C06
SHEET 12	OF 18	SHEET	STA.	TO STA.	ILLINOIS FED. AID		ID PROJECT		

STA. 1500+05 - STA. 1509+55

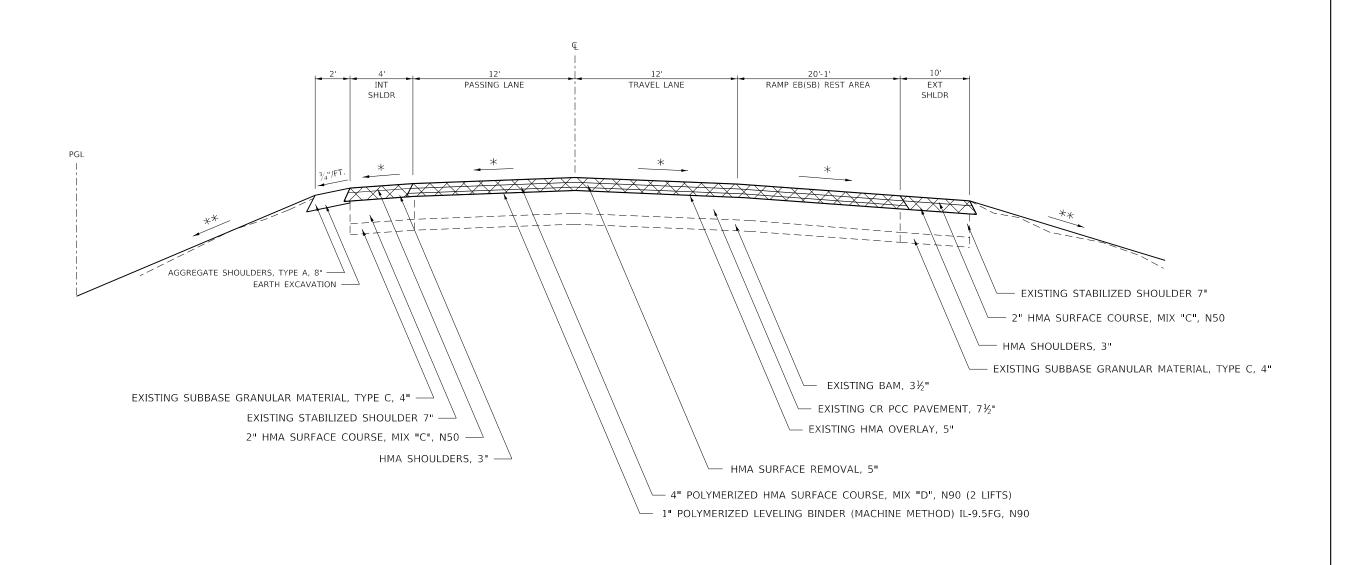

REMOVA

112#/IN/SQ YD

★ MATCH EXISTING CROSS SLOPE (MINIMUM ⅓"/FT)

★★ MAINTAIN EXISTING FORESLOPE

USER NAME	= bartonrw	DESIGNED	-
		DRAWN	

CHECKED -

PLOT SCALE = 80.0000 ' / in.

PLOT DATE = May-06-2019 07:56:21 AM

REVISED -


REVISED -

STATE OF	ILLINOIS
DEPARTMENT OF	TRANSPORTATION

l F							F.A.I. SECTION			COUNTY TOTAL SHEETS		SHEET NO.
TYPICAL SECTIONS						I-74 (37-3,4)RS-2			HENRY	142	29	
										CONTRACT	NO. 64	C06
LE:	SHEET 13	OF	18	SHEETS	STA.	TO STA.	ILLINOIS FED. AID PROJECT					


WB(NB) REST AREA

STA. 6+68 - STA. 11+03 STA. 20+55 - STA. 22+84

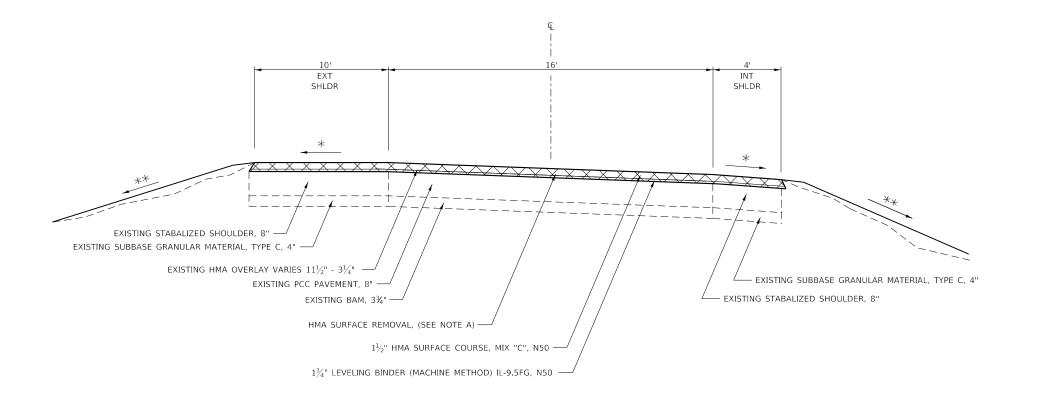

WB(NB) TAPER DETAIL

STA. 10+78 - STA. 11+03 STA. 20+55 - STA. 20+80

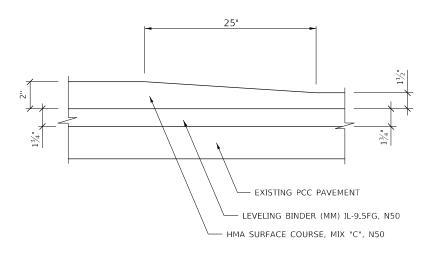

NOTE:

A) HMA SURFACE REMOVAL, $3\frac{1}{4}$ " FROM STA. 6+68 TO STA. 9+37.5 and STA. 22+20.5 TO STA. 22+84

HMA SURFACE REMOVAL VARIABLE DEPTH FROM STA. 9+37.5 TO STA. 11+03 and STA. 20+55 TO STA. 22+20.5

REMOVAL

112#/IN/SQ YD

* MATCH EXISTING CROSS SLOPE (MINIMUM %"/FT)

** MAINTAIN EXISTING FORESLOPE


USER NAME = bartonrw	DESIGNED -	REVISED -
	DRAWN - SKV	REVISED -
PLOT SCALE = 80.0000 ' / in.	CHECKED -	REVISED -
PLOT DATE = May-06-2019 07:56:38 AM	DATE -	REVISED -

STATE OF ILLINOIS					
DEPARTMENT OF TRANSPORTATION					

TVDICAL SECTIONS								F.A.I. SECTION				SHEET NO.			
TYPICAL SECTIONS						I-74	74 (37-3,4)RS-2		HENRY	142	30				
													CONTRACT	NO. 64	4C06
CALE:	SHEET	14	OF 18	S SI	HEETS	STA.	TO STA.				ILLINOIS	FED. A	ID PROJECT		




STA. 6+83 - STA. 12+11 STA. 21+61 - STA. 23+99

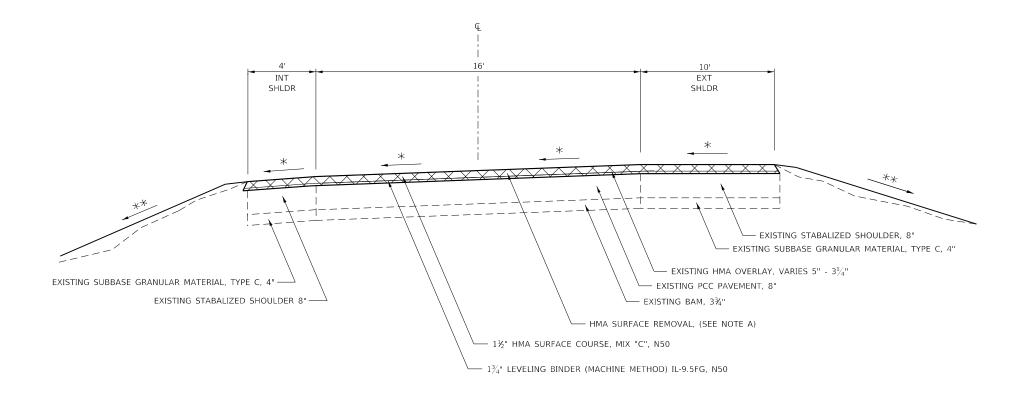

EB(SB) TAPER DETAIL

STA. 11+86 - STA. 12+11 STA. 21+61 - STA. 21+86

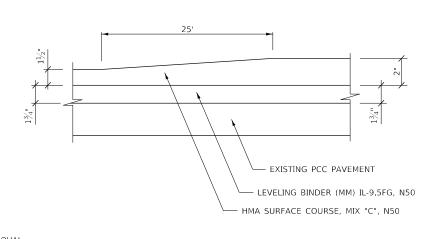


112#/IN/SQ YD

* MATCH EXISTING CROSS SLOPE (MINIMUM 1/8"/FT)

** MAINTAIN EXISTING FORESLOPE

EB(SB) TAPER DETAIL

STA. 6+83 - STA. 7+70.5 STA. 23+11 - STA. 23+99

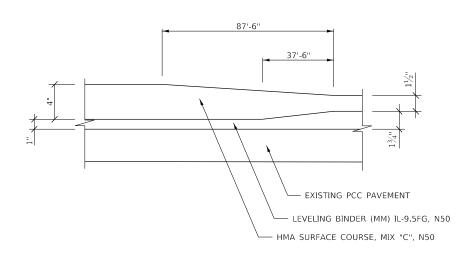

NOTES:

A) HMA SURFACE REMOVAL, VARIABLE DEPTH

FROM STA. 6+83 TO STA. 7+53.5 FROM STA. 10+98 TO STA. 12+11 FROM STA. 21+61 TO STA. 22+74 FROM STA. 23+28.5 TP STA. 23+99

HMA SURFACE REMOVAL, $3\frac{1}{4}$ "

FROM STA. 7+53.5 TO STA. 10+98 FROM STA. 22+74 TO STA. 23+28.5


USER NAME = bartonrw	DESIGNED -	REVISED -
	DRAWN - SKV	REVISED -
PLOT SCALE = 80.0000 ' / in.	CHECKED -	REVISED -
PLOT DATE = May-06-2019 07:56:52 AM	DATE -	REVISED -

STATE OF ILLINOIS DEPARTMENT OF TRANSPORTATION

TVDIOAL CECTIONS				SECTION		COUNTY	TOTAL SHEETS	SHEE NO.
TYPICAL SECTIONS		I-74	(37-3,4)RS-2		HENRY	142	31	
						CONTRACT	NO. 64	4C06
CHEET 15	OF 10 CHEETE CTA	TO STA		II LINIOIS	EED A	D DROJECT		

AUTO PARKING

STA. 11+03 - STA. 15+31 (WB) STA. 12+11 - STA. 16+33 (EB)

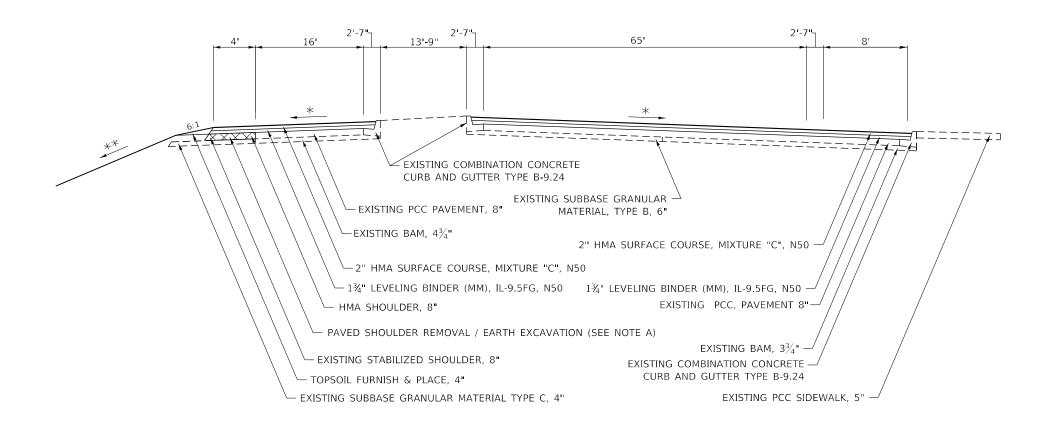

REMOVAL

112#/IN/SQ YD

* MATCH EXISTING CROSS SLOPE (MINIMUM 1/8"/FT)

** MAINTAIN EXISTING FORESLOPE


NOTE:

A) PROPOSED COMBINATION CONCRETE CURB AND GUTTER ENDS STA. 20+02, EB REST AREA ONLY

USER NAME = bartonrw	DESIGNED -	REVISED -							F.A.I. RTF	SECTION	COUNTY	TOTAL SHEET
	DRAWN - SKV	REVISED -	STATE OF ILLINOIS				AL SECTIONS		I-74	(37-3,4)RS-2	HENRY	142 32
PLOT SCALE = 120.0000 ' / in.	CHECKED -	REVISED -	DEPARTMENT OF TRANSPORTATION								CONTRAC	T NO. 64C06
PLOT DATE = May-06-2019 07:57:16 AM	DATE -	REVISED -		SCALE:	SHEET 16	OF 18	SHEETS STA.	TO STA.		ILLINOIS FED. A	D PROJECT	

TRUCK AND RV PARKING

STA. 15+31 - STA. 20+55 (WB) STA. 16+33 - STA. 21+61 (EB)

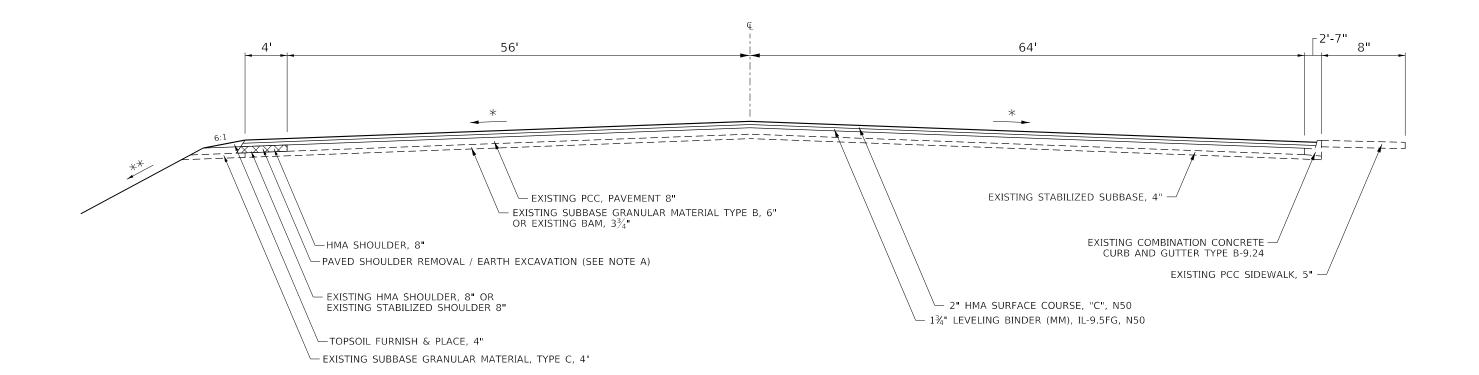

REMOVAL

112#/IN/SQ YD

* MATCH EXISTING CROSS SLOPE (MINIMUM 1/8"/FT)


** MAINTAIN EXISTING FORESLOPE

NOTES: A) EARTH EXCAVATION FROM EB STA. 14+37 TO STA. 19+04

USER NAME = bartonrw	DESIGNED -	REVISED -						F.A.I. RTF	SECTION	COUNTY	TOTAL SHEE	ΞT
	DRAWN - SKV	REVISED -	STATE OF ILLINOIS			TYPICAL SECTIONS		I-74	(37-3,4)RS-2	HENRY	142 33	<u>,</u> —
PLOT SCALE = 120.0000 ' / in.	CHECKED -	REVISED -	DEPARTMENT OF TRANSPORTATION							CONTRAC	T NO. 64C06	, \neg
PLOT DATE = May-06-2019 07:57:31 AM	DATE -	REVISED -		SCALE:	SHEET 17	OF 18 SHEETS STA.	TO STA.		ILLINOIS FED. AI	D PROJECT		╛


DUMP STATION

STA. 117+30 - STA. 19+72 (WB) STA. 18+15.06 - STA. 19+23 (EB)

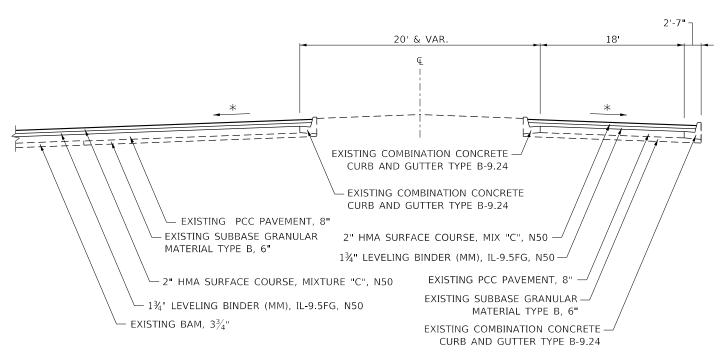

DUMP STATION

STA. 19+72 - STA. 20+55 (WB) STA. 19+23 - STA. 21+61 (EB)

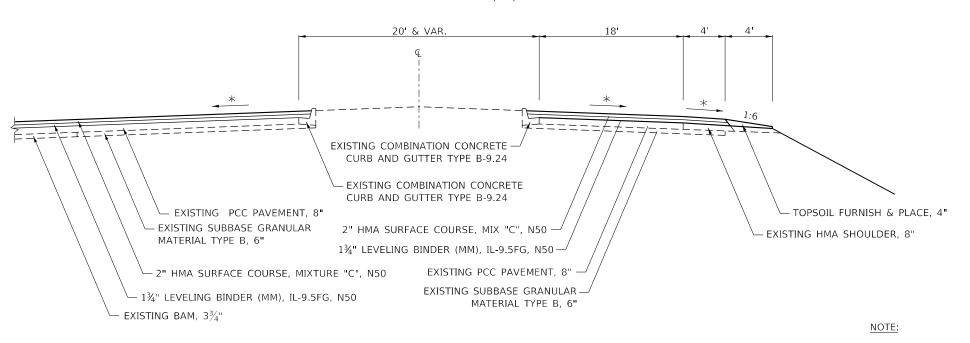

SCALE:

REMOVAL

112#/IN/SQ YD

- * MATCH EXISTING CROSS SLOPE (MINIMUM 1/8"/FT)
- ** MAINTAIN EXISTING FORESLOPE

JSER NAME = bartonrw DESIGNED -REVISED DRAWN - SKV REVISED PLOT SCALE = 120.0000 ' / in. CHECKED -REVISED PLOT DATE = May-06-2019 07:57:46 AM REVISED DATE

STATE OF ILLINOIS **DEPARTMENT OF TRANSPORTATION**

SECTION TYPICAL SECTIONS (37-3,4)RS-2 HENRY 142 34 I-74 CONTRACT NO. 64C06 SHEET 18 OF 18 SHEETS STA. TO STA.

A) PROPOSED COMBINATION CONCRETE CURB AND GUTTER ENDS STA. 20+02, EB REST AREA ONLY

0100110 <u>TREE REMOVAL</u>	<u>(6 TO 15 UNITS DI</u>	AMETER)			FR (2R)				
					1	Sta. 1599+46.55	90.90 RT	Mud Creek (Culvert-	End Section)
<u>UNIT</u>	LOCATION	OFFSET (FT)	<u>REMARKS</u>		1	Sta. 1599+97.10	85.40 LT	Mud Creek (Culvert-	End Section)
<u>EB (SB)</u>					1	Sta. 1662+75.50	0	Median (Permanent C	Crossover)
10.00	Sta. 1616+53.62	48.67 RT	Inside Shoulder		6 T	OTAL			
13.00	Sta. 1616+85.10	38.66 RT	Inside Shoulder						
<u>WB (NB)</u>									
6.00	Sta. 1406+84.91	90.38 RT	Outside Shoulder	28000510	INLET FILTER	<u>S</u>			
6.00	Sta. 1614+09.46	45.37 LT	Inside Shoulder						
14.00	Sta. 1633+13.17	42.45 LT	Inside Shoulder		<u>EACH</u>	LOCATION	OFFSET (FT)	REMARKS	
12.00	Sta. 1633+13.52	45.78 LT	Inside Shoulder		1	Sta. 1373+04.38	0.71 LT	Median	
	Sta. 1642+21.35	53.25 RT	Outside Shoulder		1	Sta. 1373+07.19	0	Median	
68 TO	IAL				1	Sta. 1532+86.96	0	Median	
					1	Sta. 1667+34.43 OTAL	0	Median	
3000305 <u>TEMPORARY DIT</u>	CH CHECKS				4 10	OTAL			
TEMPORARI DIT	CH CHECKS								
FOOT	LOCATION	OFFSET (FT)	REMARKS	28100105	STONE RIPRAP	, CLASS A3			
WB (NB)									
15.00	Sta. 1295+85.92	0	Stage 2 Median (Tem	oorary Crossover)	SQ YD	LOCATION		OFFSET (FT)	<u>REMARKS</u>
20.00	Sta. 1370+36.07	113.94 LT	Edwards River- Offs	et to Inside Edge of Ditch Check	WB (NB)				
20.00	Sta. 1371+78.32	102.30 LT	Edwards River- Offs	et to Inside Edge of Ditch Check	109.10	Sta. 1307+81.15	ГО 1307+92.24	98.09 LT	Outside Shoulder
45.00	Sta. 1531+12.05	126.23 LT		et to Inside Edge of Ditch Check	674.14	Sta. 1310+06.89	ΓΟ 1315+54.80	85.33 LT	Outside Shoulder
15.00	Sta. 1531+87.49	132.74 LT		et to Inside Edge of Ditch Check	152.72	Sta. 1317+91.09		86.40 LT	Outside Shoulder
20.00	Sta. 1599+53.86	89.46 LT		o Inside Edge of Ditch Check	723.07	Sta. 1322+82.19		74.50 - 124.50 LT	Outside Shoulder
20.00	Sta. 1670+83.41	0	Median (Permanent C	rossover)	565.89	Sta. 1423+80.66		81.28 - 115.70 LT	Outside Shoulder
EB (SB)					324.76	Sta. 1437+06.26		69.31 - 104.32 LT	Outside Shoulder
20.00	Sta. 1284+78.37	0	Stage 2 Temporary C		1,013.89	Sta. 1444+94.05		72.58 - 127.00 LT	Outside Shoulder
10.00	Sta. 1370+36.00	131.36 RT		et to Inside Edge of Ditch Check	227.23	Sta. 1472+88.16		131.45 - 172.22 LT	Outside Shoulder
10.00	Sta. 1371+78.32	110.10 RT		et to Inside Edge of Ditch Check	268.67	Sta. 1481+95.49		88.58 - 114.51 LT	Outside Shoulder
20.00 10.00	Sta. 1531+58.54 Sta. 1532+38.06	128.74 RT 140.55 RT		et to Inside Edge of Ditch Check et to Inside Edge of Ditch Check	381.68	Sta. 1520+85.83 Sta. 1524+74.02		74 57 - 99 50 LT 97 12 - 120 93 LT	Outside Shoulder Outside Shoulder
20.00	Sta. 1532+38.06 Sta. 1659+45.84		Median (Permanent C		658.40 94.71	Sta. 1524+74.02 Sta. 1530+53.89		123 18 - 126 65 LT	Outside Shoulder
20.00 230 TO		U	median (reinfallent C		528.05	Sta. 1530+53.69 Sta. 1531+68.32		71.57 -124.03 LT	Outside Shoulder
23010	.,,,_				1,859.34	Sta. 1538+87.23		79.18 - 153.50 LT	
					2,963.70	Sta 1566+85 43		66 01 - 119 11 LT	Outside Shoulder
3000400 <u>PERIMETER ERO</u>	SION BARRIER				2,415.40	Sta. 1580+53.52		29.69 - 98.48 LT	Outside Shoulder
					401.31	Sta. 1592+68.28		24.64 - 88.50 RT	Inside Shoulder
<u>FOOT</u>	LOCATION		OFFSET (FT)	REMARKS	1,009.80	Sta. 1599+53.86	TO 1602+56.80	22.00 LT	Outside Shoulder
<u>WB (NB)</u>					397.17	Sta 1600+76 86	ГО 1604+59.39	32 15 - 97 99 RT	Inside Shoulder
150.00	Sta. 1531+00.00	TO 1532+50.00	98.00 LT	Outside Shoulder	1,079.83	Sta. 1608+03.38	ГО 1616+56.79	24.70 - 67.83 RT	Inside Shoulder
150.00	Sta. 1600+00.00	TO 1601+50.00	66.00 RT	Inside Shoulder	1,365.54	Sta. 1619+92.34	ГО 1630+33.66	39.19 - 98.98 RT	Inside Shoulder
EB (SB)					471.10	Sta. 1627+63.83	TO 1630+91.48	73.61 - 108.83 LT	Outside Shoulder
150.00	Sta. 1531+00.00		97.00 RT	Outside Shoulder	395.40	Sta. 1649+93.78	ΤΟ 1653+05.45	51.02 - 87.13 LT	Outside Shoulder
150.00	Sta. 1599+00.00	TO 1600+50.00	78.00 RT	Outside Shoulder	EB (SB)				
150.00	Sta. 1599+00.00	TO 1600+50.00	73.00 LT	Inside Shoulder	216.27	Sta. 1293+45.81		74.50 - 112.50 RT	Outside Shoulder
750 TO	TAL				482.52	Sta. 1321+81.70		78.46 - 144.51 RT	Outside Shoulder
					2,414.75	Sta. 1388+82.80		81.81 - 92.63 RT	Outside Shoulder
2000E00 INLET AND 515					256.61	Sta. 1437+25.91		75.31 RT	Outside Shoulder
3000500 <u>INLET AND PIP</u>	E PROTECTION				93.98	Sta. 1449+93.14		131.01 - 151.57 RT	Outside Shoulder
FACH	LOCATION	OFFSET (FT)	<u>REMARKS</u>		140.23 190.33	Sta. 1451+01.67 Sta. 1462+91.52		74.97 - 94.50 RT 108.86 - 123.72 RT	Outside Shoulder Outside Shoulder
<u>EACH</u> <u>WB (NB)</u>	LOCATION	ULFSEL (FI)	NEMANY		190.33	Sta. 1462+91.52 Sta. 1471+95.29		108.86 - 123.72 RT 118.99 - 205.97 RT	Outside Shoulder Outside Shoulder
<u>wo (No)</u> 1	Sta. 1369+70.44	0	Median (Culvert- En	Section)	1,074.14	Sta. 1471+93.29 Sta. 1522+79.28		75.45 - 129.08 RT	Outside Shoulder
1	Sta. 1309+70.44 Sta. 1600+82.35	79.60 RT	Mud Creek (Culvert-		56.50	Sta. 1532+79.28		127.95 RT	Outside Shoulder
1	Sta. 1600+62.33	81.00 LT	Mud Creek (Culvert-	·	409.44	Sta. 1549+66.28		76.56 - 92.81 RT	Outside Shoulder
,									
USER NAME		DESIGNED - DRAWN -	REVISED -	STATE OF ILLINOIS		SCHEDIUE (OF QUANTITIES	KIE.	CTION COUNTY TOTA SHEET 3,4)RS-2 HENRY 142
l l									

### ### ### ### ### ### ### ### ### ##	CONCRETE SIDEW LOCATION Aa. 13+60.50 a. 14+06.55 a. 15+23.22 a. 15+87.39 Aa. 14+58.72 a. 15+05.86 a. 16+30.06 a. 17+87.42 NGS LOCATION Aa. 13+70.80 a. 14+14.98 a. 15+41.43 a. 16+05.39	TO 19+80.53 VALK 5 INCH TO 13+90.66	OFFSET (FT) 24.59 RT 2.58 - 24.46 RT	REMARKS	25 17 39 42 18 EB (SB) 32 19 25 25 32 152 18 44000600 SIDEWALH SO F WB (NB) 266 263 367	REST AI 0.18	LOCATION AREA Sta. 13+60.48 Sta. 14+06.32 Sta. 14+18.72 Sta. 15+23.22 Sta. 15+87.37 Sta. 18+76.36 AREA Sta. 14+58.71 Sta. 15+05.86 Sta. 15+12.95 Sta. 16+42.00 Sta. 17+87.42 Sta. 18+66.16 Sta. 19+87.93 AL LOCATION	TO 13+90.66 TO 14+15.29 TO 14+24.32 TO 15+63.13 TO 16+31.39 TO 18+92.82 TO 14+91.28 TO 15+08.33 TO 15+20.99 TO 16+67.18 TO 18+19.79 TO 20+02.18 TO 20+04.45 TO 13+90.66 TO 14+33.81 TO 15+63.12	OFFSET (FT) 22.06 RT 10.06 - 21.88 RT 0 - 12.23 RT 0 19.47 RT 22.29 RT 22.01 - 9.28 RT 0 - 16.58 RT 0 0 10.76 - 36.92 RT 18.91 RT OFFSET (FT) 24.59 RT 6.84 - 24.33 RT 2.50 RT 2.51 RT	REMARKS REMARKS
### ### ### ### ### ### ### ### ### ##	CONCRETE SIDEW LOCATION EA a. 13+60.50 a. 14+06.55 a. 15+23.22 a. 15+87.39 EA a. 14+58.72 a. 15+05.86 a. 16+30.06 a. 17+87.42 NGS LOCATION EA a. 13+70.80 a. 14+14.98 a. 15+41.43	TO 19+80.53 VALK 5 INCH TO 13+90.66 TO 14+32.87 TO 15+63.12 TO 16+31.39 TO 14+91.23 TO 15+31.28 TO 16+67.19 TO 18+19.62 TO 13+75.80 TO 14+19.04 TO 15+46.43	24.59 RT 2.58 - 24.46 RT 2.50 RT 2.51 RT 24.87 RT 2.91 - 24.59 RT 2.64 - 9.61 RT 2.40 - 2.89 RT OFFSET (FT) 24.63 RT 2.91 - 6.09 RT 2.41 RT		FOOT WB (NB) 30 25 17 39 42 18 EB (SB) 32 19 25 25 32 152 18 44000600 SIDEWALL SO F WB (NB) 266 263 367	REST AI 0.18	LOCATION AREA Sta. 13+60.48 Sta. 14+18.72 Sta. 15+23.22 Sta. 15+87.37 Sta. 18+76.36 AREA Sta. 14+58.71 Sta. 15+05.86 Sta. 15+12.95 Sta. 16+42.00 Sta. 17+87.42 Sta. 18+66.16 Sta. 19+87.93 AL LOCATION AREA Sta. 13+60.50 Sta. 13+60.50 Sta. 14+06.53 Sta. 15+23.22	TO 13+90.66 TO 14+15.29 TO 14+24.32 TO 15+63.13 TO 16+31.39 TO 18+92.82 TO 14+91.28 TO 15+08.33 TO 15+20.99 TO 16+67.18 TO 18+19.79 TO 20+02.18 TO 20+04.45 TO 13+90.66 TO 14+33.81 TO 15+63.12	22.06 RT 10.06 - 21.88 RT 0 - 12.23 RT 0 0 19.47 RT 22.29 RT 22.01 - 9.28 RT 0 - 16.58 RT 0 0 10.76 - 36.92 RT 18.91 RT OFFSET (FT) 24.59 RT 6.84 - 24.33 RT 2.50 RT	
### ### ### ### ### ### ### ### ### ##	CONCRETE SIDEW LOCATION EA a. 13+60.50 a. 14+06.55 a. 15+23.22 a. 15+87.39 EA a. 14+58.72 a. 15+05.86 a. 16+30.06 a. 17+87.42 NGS LOCATION EA a. 13+70.80 a. 14+14.98 a. 15+41.43	TO 19+80.53 VALK 5 INCH TO 13+90.66 TO 14+32.87 TO 15+63.12 TO 16+31.39 TO 14+91.23 TO 15+31.28 TO 16+67.19 TO 18+19.62 TO 13+75.80 TO 14+19.04 TO 15+46.43	24.59 RT 2.58 - 24.46 RT 2.50 RT 2.51 RT 24.87 RT 2.91 - 24.59 RT 2.64 - 9.61 RT 2.40 - 2.89 RT OFFSET (FT) 24.63 RT 2.91 - 6.09 RT 2.41 RT		FOOT WB (NB) 30 25 17 39 42 18 EB (SB) 32 19 25 25 32 152 18 44000600 SIDEWALL SO F WB (NB) 266 263 367	REST AI 0.18	LOCATION AREA Sta. 13+60.48 Sta. 14+18.72 Sta. 15+23.22 Sta. 15+87.37 Sta. 18+76.36 AREA Sta. 14+58.71 Sta. 15+05.86 Sta. 15+12.95 Sta. 16+42.00 Sta. 17+87.42 Sta. 18+66.16 Sta. 19+87.93 AL LOCATION AREA Sta. 13+60.50 Sta. 13+60.50 Sta. 14+06.53 Sta. 15+23.22	TO 13+90.66 TO 14+15.29 TO 14+24.32 TO 15+63.13 TO 16+31.39 TO 18+92.82 TO 14+91.28 TO 15+08.33 TO 15+20.99 TO 16+67.18 TO 18+19.79 TO 20+02.18 TO 20+04.45 TO 13+90.66 TO 14+33.81 TO 15+63.12	22.06 RT 10.06 - 21.88 RT 0 - 12.23 RT 0 0 19.47 RT 22.29 RT 22.01 - 9.28 RT 0 - 16.58 RT 0 0 10.76 - 36.92 RT 18.91 RT OFFSET (FT) 24.59 RT 6.84 - 24.33 RT 2.50 RT	
### ### ### ### ### ### ### ### ### ##	CONCRETE SIDEW LOCATION EA a. 13+60.50 a. 14+06.55 a. 15+23.22 a. 15+87.39 EA a. 14+58.72 a. 15+05.86 a. 16+30.06 a. 17+87.42 NGS LOCATION EA a. 13+70.80 a. 14+14.98 a. 15+41.43	TO 19+80.53 VALK 5 INCH TO 13+90.66 TO 14+32.87 TO 15+63.12 TO 16+31.39 TO 14+91.23 TO 15+31.28 TO 16+67.19 TO 18+19.62 TO 13+75.80 TO 14+19.04 TO 15+46.43	24.59 RT 2.58 - 24.46 RT 2.50 RT 2.51 RT 24.87 RT 2.91 - 24.59 RT 2.64 - 9.61 RT 2.40 - 2.89 RT OFFSET (FT) 24.63 RT 2.91 - 6.09 RT 2.41 RT		FOOT WB (NB) 30 25 17 39 42 18 EB (SB) 32 19 25 25 32 152 18 44000600 SIDEWALL SO F WB (NB) 266 263	REST AI 0.18	LOCATION AREA Sta. 13+60.48 Sta. 14+06.32 Sta. 14+18.72 Sta. 15+23.22 Sta. 15+87.37 Sta. 18+76.36 AREA Sta. 14+58.71 Sta. 15+05.86 Sta. 15+12.95 Sta. 16+42.00 Sta. 17+87.42 Sta. 18+66.16 Sta. 19+87.93 AL LOCATION AREA Sta. 13+60.50 Sta. 14+06.53	TO 13+90.66 TO 14+15.29 TO 14+24.32 TO 15+63.13 TO 16+31.39 TO 18+92.82 TO 14+91.28 TO 15+08.33 TO 15+20.99 TO 16+67.18 TO 18+19.79 TO 20+02.18 TO 20+04.45 TO 13+90.66 TO 14+33.81	22.06 RT 10.06 - 21.88 RT 0 - 12.23 RT 0 0 19.47 RT 22.29 RT 22.01 - 9.28 RT 0 - 16.58 RT 0 0 10.76 - 36.92 RT 18.91 RT OFFSET (FT) 24.59 RT 6.84 - 24.33 RT	
### 437.44 Sta.16 ### 126.06 Sta.16: ### 402.31 Sta.11: ### 233.79 Sta.11: ### 29,998 TOTAL ### 42300300 PORTLAND CEMENT CONCR ### SQ YD LOC WB (NB) REST AREA 27.98 Sta.17: ### EB (SB) REST AREA 27.79 Sta.18: ### 75.64 Sta.19: ### 132 TOTAL ### 42400200 PORTLAND CEMENT CONCR ### SO FT LOC WB (NB) REST AREA 264.16 Sta.13: ### 317.41 Sta.14: ### 375.30 Sta.15: ### 495.15 Sta.15: ### 159.03 Sta.15: ### 495.15 Sta.15: ### 259.03 Sta.14: ### 398.99 Sta.15: ### 337.12 Sta.16: ### 338.88 Sta.17: ### 2,787 TOTAL ### 42400800 DETECTABLE WARNINGS ### SO FT LOC WB (NB) REST AREA 10.00 Sta.13: ### 10.00 Sta.13: ### 10.00 Sta.14: #### 10.00 Sta.14: ### 10.00 Sta.14: #### 10.00 Sta.14: #### 10.00 Sta.14: #### 10.00 Sta.14: #### 10.00 Sta.14: ####################################	CONCRETE SIDEW LOCATION EA a. 13+60.50 a. 14+06.55 a. 15+23.22 a. 15+87.39 EA a. 14+58.72 a. 15+05.86 a. 16+30.06 a. 17+87.42 NGS LOCATION EA a. 13+70.80 a. 14+14.98	TO 19+80.53 /ALK 5 INCH TO 13+90.66 TO 14+32.87 TO 15+63.12 TO 16+31.39 TO 14+91.23 TO 15+31.28 TO 16+67.19 TO 18+19.62 TO 13+75.80 TO 14+19.04	24.59 RT 2.58 - 24.46 RT		FOOT WB (NB) 30 25 17 39 42 18 EB (SB) 32 19 25 32 15 25 32 15 44000600 SIDEWALH SO F- WB (NB) 266	REST AI 1.18	LOCATION AREA Sta. 13+60.48 Sta. 14+18.72 Sta. 15+23.22 Sta. 15+87.37 Sta. 18+76.36 AREA Sta. 14+58.71 Sta. 15+05.86 Sta. 15+12.95 Sta. 16+42.00 Sta. 17+87.42 Sta. 18+66.16 Sta. 19+87.93 AL LOCATION AREA Sta. 13+60.50	TO 13+90.66 TO 14+15.29 TO 14+24.32 TO 15+63.13 TO 16+31.39 TO 18+92.82 TO 14+91.28 TO 15+08.33 TO 15+20.99 TO 16+67.18 TO 18+19.79 TO 20+02.18 TO 20+04.45	22.06 RT 10.06 - 21.88 RT 0 - 12.23 RT 0 0 19.47 RT 22.29 RT 22.01 - 9.28 RT 0 - 16.58 RT 0 0 10.76 - 36.92 RT 18.91 RT OFFSET (FT) 24.59 RT	
### 437.44 Sta.16 ### 126.06 Sta.163 ### 402.31 Sta.163 ### 402.31 Sta.163 ### 128.08 REST AREA ### 233.79 Sta.11- ### 29,998 TOTAL ### 42300300 PORTLAND CEMENT CONCR ### SQ YD LOC ### (NB) REST AREA ### 27.98 Sta.17- ### EB (SB) REST AREA ### 27.79 Sta.18- ### 75.64 Sta.19- ### 132 TOTAL ### 132 TOTAL ### 42400200 PORTLAND CEMENT CONCR ### SQ FT LOC ### (NB) REST AREA ### 264.16 Sta.13- ### 317.41 Sta.14- ### 375.30 Sta.15- ### 495.15 Sta.15- ### 159.03 Sta.15- ### 495.15 Sta.15- ### 259.03 Sta.14- ### 398.99 Sta.15- ### 337.12 Sta.16- ### 338.88 Sta.17- ### 2,787 TOTAL ### 42400800 DETECTABLE WARNINGS ### SQ FT LOC ### (NB) REST AREA ### 10.00 Sta.13-	CONCRETE SIDEW LOCATION A a. 13+60.50 a. 14+06.55 a. 15+23.22 a. 15+87.39 A a. 14+58.72 a. 15+05.86 a. 16+30.06 a. 17+87.42 NGS LOCATION A a. 13+70.80	TO 19+80.53 /ALK 5 INCH TO 13+90.66 TO 14+32.87 TO 15+63.12 TO 16+31.39 TO 14+91.23 TO 15+31.28 TO 16+67.19 TO 18+19.62 TO 13+75.80	24.59 RT 2.58 - 24.46 RT 2.50 RT 2.51 RT 24.87 RT 2.91 - 24.59 RT 2.64 - 9.61 RT 2.40 - 2.89 RT OFFSET (FT) 24.63 RT		FOOT WB (NB) 30 25 17 39 44 18 EB (SB) 32 19 25 25 32 152 18 44000600 SIDEWALH SO F- WB (NB)	REST AI 0.18	LOCATION AREA Sta. 13+60.48 Sta. 14+06.32 Sta. 14+18.72 Sta. 15+23.22 Sta. 15+87.37 Sta. 18+76.36 AREA Sta. 14+58.71 Sta. 15+05.86 Sta. 15+12.95 Sta. 16+42.00 Sta. 17+87.42 Sta. 18+66.16 Sta. 19+87.93 AL LOCATION AREA	TO 13+90.66 TO 14+15.29 TO 14+24.32 TO 15+63.13 TO 16+31.39 TO 18+92.82 TO 14+91.28 TO 15+08.33 TO 15+08.33 TO 15+20.99 TO 16+67.18 TO 18+19.79 TO 20+02.18 TO 20+04.45	22.06 RT 10.06 - 21.88 RT 0 - 12.23 RT 0 0 19.47 RT 22.29 RT 22.01 - 9.28 RT 0 - 16.58 RT 0 0 10.76 - 36.92 RT 18.91 RT	
## 437.44 Sta.16 ## 126.06 Sta.16: ## 402.31 Sta.11- ## 29,998 TOTAL ## 42300300 PORTLAND CEMENT CONCR ## (NB) REST AREA ## 27.98 Sta.17- ## EB (SB) REST AREA ## 27.79 Sta.18- ## 75.64 Sta.19- ## 132 TOTAL ## 42400200 PORTLAND CEMENT CONCR ## (NB) REST AREA ## 264.16 Sta.13- ## 317.41 Sta.14- ## 375.30 Sta.15- ## 495.15 Sta.15- ## 495.15 Sta.15- ## 495.15 Sta.15- ## 259.03 Sta.14- ## 398.99 Sta.15- ## 337.12 Sta.16- ## 338.88 Sta.17- ## 2,787 TOTAL ## 42400800 DETECTABLE WARNINGS ## (NB) REST AREA ## 42400800 DETECTABLE WARNINGS ## 42400800 DETECTABLE WARNINGS ## 42400800 DETECTABLE WARNINGS ## 42400800 DETECTABLE WARNINGS	CONCRETE SIDEW LOCATION EA a. 13+60.50 a. 14+06.55 a. 15+23.22 a. 15+87.39 EA a. 14+58.72 a. 15+05.86 a. 16+30.06 a. 17+87.42 NGS LOCATION EA	TO 19+80.53 /ALK 5 INCH TO 13+90.66 TO 14+32.87 TO 15+63.12 TO 16+31.39 TO 14+91.23 TO 15+31.28 TO 16+67.19 TO 18+19.62	24.59 RT 2.58 - 24.46 RT 2.50 RT 2.51 RT 24.87 RT 2.91 - 24.59 RT 2.64 - 9.61 RT 2.40 - 2.89 RT		FOOT WB (NB) 30 25 17 39 44 18 EB (SB) 32 19 25 25 32 152 18 44000600 SIDEWALK	REST AI 0.18	LOCATION AREA Sta. 13+60.48 Sta. 14+06.32 Sta. 14+18.72 Sta. 15+23.22 Sta. 15+87.37 Sta. 18+76.36 AREA Sta. 14+58.71 Sta. 15+05.86 Sta. 15+12.95 Sta. 16+42.00 Sta. 17+87.42 Sta. 18+66.16 Sta. 19+87.93 AL LOCATION	TO 13+90.66 TO 14+15.29 TO 14+24.32 TO 15+63.13 TO 16+31.39 TO 18+92.82 TO 14+91.28 TO 15+08.33 TO 15+20.99 TO 16+67.18 TO 18+19.79 TO 20+02.18	22.06 RT 10.06 - 21.88 RT 0 - 12.23 RT 0 0 19.47 RT 22.29 RT 22.01 - 9.28 RT 0 - 16.58 RT 0 0 10.76 - 36.92 RT 18.91 RT	
### 437.44 Sta.16 ### 126.06 Sta.163 ### 402.31 Sta.163 ### 128.08 REST_AREA ### 233.79 Sta.11- ### 29,998 TOTAL ### 42300300 PORTLAND CEMENT CONCR ### (NB) REST_AREA ### 27.79 Sta.18- ### 75.64 Sta.19- ### 132 TOTAL ### 132 TOTAL ### (NB) REST_AREA ### 27.79 Sta.18- ### 75.64 Sta.19- ### 132 TOTAL ### (NB) REST_AREA ### 264.16 Sta.13- ### 317.41 Sta.14- ### 375.30 Sta.15- ### 495.15 Sta.15- ### 15.15 Sta.15- ### 15.15 Sta.15- ### 15.15 Sta.15- ### 259.03 Sta.14- ### 398.99 Sta.15- ### 337.12 Sta.16- ### 338.88 Sta.17- ### 2,787 TOTAL ### 42400800 DETECTABLE WARNINGS ### SO FT LOCK ### 15.15 Sta.16- ### 338.88 Sta.17- ### 2,787 TOTAL	CONCRETE SIDEW LOCATION EA a. 13+60.50 a. 14+06.55 a. 15+23.22 a. 15+87.39 EA a. 14+58.72 a. 15+05.86 a. 16+30.06 a. 17+87.42 NGS LOCATION	TO 19+80.53 /ALK 5 INCH TO 13+90.66 TO 14+32.87 TO 15+63.12 TO 16+31.39 TO 14+91.23 TO 15+31.28 TO 16+67.19	24.59 RT 2.58 - 24.46 RT 2.50 RT 2.51 RT 24.87 RT 2.91 - 24.59 RT 2.64 - 9.61 RT 2.40 - 2.89 RT		FOOT WB (NB) 30 25 17 39 42 18 EB (SB) 32 19 25 25 32 152 18	REST AI 0.18	LOCATION AREA Sta. 13+60.48 Sta. 14+06.32 Sta. 15+23.22 Sta. 15+87.37 Sta. 18+76.36 AREA Sta. 14+58.71 Sta. 15+05.86 Sta. 15+12.95 Sta. 16+42.00 Sta. 17+87.42 Sta. 18+66.16 Sta. 19+87.93 AL	TO 13+90.66 TO 14+15.29 TO 14+24.32 TO 15+63.13 TO 16+31.39 TO 18+92.82 TO 14+91.28 TO 15+08.33 TO 15+20.99 TO 16+67.18 TO 18+19.79 TO 20+02.18	22.06 RT 10.06 - 21.88 RT 0 - 12.23 RT 0 0 19.47 RT 22.29 RT 22.01 - 9.28 RT 0 - 16.58 RT 0 0 10.76 - 36.92 RT 18.91 RT	
### 437.44 Sta.16 ### 126.06 Sta.16 ### 402.31 Sta.16 ### 128 (SB) REST AREA ### 233.79 Sta.11- ### 239,998 TOTAL ### 42300300 PORTLAND CEMENT CONCR ### SO YD LOC ### (NB) REST AREA ### 27.98 Sta.17- ### EB (SB) REST AREA ### 27.79 Sta.18- ### 75.64 Sta.19- ### 132 TOTAL ### 132 TOTAL ### 42400200 PORTLAND CEMENT CONCR ### SO FT LOC ### (NB) REST AREA ### 264.16 Sta.13- ### 317.41 Sta.14- ### 375.30 Sta.15- ### 495.15 Sta.15- ### 495.15 Sta.15- ### 138.99 Sta.15- ### 337.12 Sta.16- ### 338.88 Sta.17- ### 2,787 TOTAL ### 42400800 DETECTABLE WARNINGS	CONCRETE SIDEW LOCATION EA a. 13+60.50 a. 14+06.55 a. 15+23.22 a. 15+87.39 EA a. 14+58.72 a. 15+05.86 a. 16+30.06 a. 17+87.42	TO 19+80.53 /ALK 5 INCH TO 13+90.66 TO 14+32.87 TO 15+63.12 TO 16+31.39 TO 14+91.23 TO 15+31.28 TO 16+67.19	24.59 RT 2.58 - 24.46 RT 2.50 RT 2.51 RT 24.87 RT 2.91 - 24.59 RT 2.64 - 9.61 RT 2.40 - 2.89 RT	REMARKS	FOOT WB (NB) 30 25 17 39 42 18 EB (SB) 32 19 25 32 152 18	REST AI 1.18	LOCATION AREA Sta. 13+60.48 Sta. 14+18.72 Sta. 15+23.22 Sta. 15+87.37 Sta. 18+76.36 AREA Sta. 14+58.71 Sta. 15+05.86 Sta. 15+12.95 Sta. 16+42.00 Sta. 17+87.42 Sta. 18+66.16 Sta. 19+87.93 AL	TO 13+90.66 TO 14+15.29 TO 14+24.32 TO 15+63.13 TO 16+31.39 TO 18+92.82 TO 14+91.28 TO 15+08.33 TO 15+20.99 TO 16+67.18 TO 18+19.79 TO 20+02.18	22.06 RT 10.06 - 21.88 RT 0 - 12.23 RT 0 0 19.47 RT 22.29 RT 22.01 - 9.28 RT 0 - 16.58 RT 0 0 10.76 - 36.92 RT	REMARKS
437.44 Sta.16 126.06 Sta.16: 402.31 Sta.16: EB (SB) REST AREA 233.79 Sta.11- 29,998 TOTAL 42300300 PORTLAND CEMENT CONCR SO YD LOC WB (NB) REST AREA 27.98 Sta.17- EB (SB) REST AREA 27.79 Sta.18- 75.64 Sta.19- 132 TOTAL 42400200 PORTLAND CEMENT CONCR SO FT LOC WB (NB) REST AREA 264.16 Sta.13- 317.41 Sta.14- 375.30 Sta.15- 495.15 Sta.15- 495.15 Sta.15- EB (SB) REST AREA 259.03 Sta.14- 398.99 Sta.15- 337.12 Sta.16- 338.88 Sta.17- 2,787 TOTAL	CONCRETE SIDEW LOCATION EA a. 13+60.50 a. 14+06.55 a. 15+23.22 a. 15+87.39 EA a. 14+58.72 a. 15+05.86 a. 16+30.06 a. 17+87.42	TO 19+80.53 /ALK 5 INCH TO 13+90.66 TO 14+32.87 TO 15+63.12 TO 16+31.39 TO 14+91.23 TO 15+31.28 TO 16+67.19	24.59 RT 2.58 - 24.46 RT 2.50 RT 2.51 RT 24.87 RT 2.91 - 24.59 RT 2.64 - 9.61 RT	REMARKS	FOOT WB (NB) 30 25 17 39 42 18 EB (SB) 32 19 25 32 15 32	REST AI 0.18	LOCATION AREA Sta. 13+60.48 Sta. 14+18.72 Sta. 15+23.22 Sta. 15+87.37 Sta. 18+76.36 AREA Sta. 14+58.71 Sta. 15+05.86 Sta. 15+12.95 Sta. 16+42.00 Sta. 17+87.42 Sta. 18+66.16 Sta. 19+87.93	TO 13+90.66 TO 14+15.29 TO 14+24.32 TO 15+63.13 TO 16+31.39 TO 18+92.82 TO 14+91.28 TO 15+08.33 TO 15+20.99 TO 16+67.18 TO 18+19.79 TO 20+02.18	22.06 RT 10.06 - 21.88 RT 0 - 12.23 RT 0 0 19.47 RT 22.29 RT 22.01 - 9.28 RT 0 - 16.58 RT 0 0 10.76 - 36.92 RT	REMARKS
437.44 Sta. 16 126.06 Sta. 163 402.31 Sta. 163 EB (SB) REST AREA 233.79 Sta. 113 29,998 TOTAL 42300300 PORTLAND CEMENT CONCR SQ YD LOC WB (NB) REST AREA 27.98 Sta. 173 EB (SB) REST AREA 27.79 Sta. 183 75.64 Sta. 193 132 TOTAL 42400200 PORTLAND CEMENT CONCR SQ FT LOC WB (NB) REST AREA 264.16 Sta. 133 317.41 Sta. 143 317.41 Sta. 143 317.41 Sta. 143 375.30 Sta. 153 495.15 Sta. 153 EB (SB) REST AREA 259.03 Sta. 153 337.12 Sta. 163 338.88 Sta. 173	CONCRETE SIDEW LOCATION EA a. 13+60.50 a. 14+06.55 a. 15+23.22 a. 15+87.39 EA a. 14+58.72 a. 15+05.86 a. 16+30.06 a. 17+87.42	TO 19+80.53 /ALK 5 INCH TO 13+90.66 TO 14+32.87 TO 15+63.12 TO 16+31.39 TO 14+91.23 TO 15+31.28 TO 16+67.19	24.59 RT 2.58 - 24.46 RT 2.50 RT 2.51 RT 24.87 RT 2.91 - 24.59 RT 2.64 - 9.61 RT	REMARKS	FOOT WB (NB) 30 25 17 39 42 18 EB (SB) 32 19 25 32 15 32	REST AI 0.18	LOCATION AREA Sta. 13+60.48 Sta. 14+18.72 Sta. 15+23.22 Sta. 15+87.37 Sta. 18+76.36 AREA Sta. 14+58.71 Sta. 15+05.86 Sta. 15+12.95 Sta. 16+42.00 Sta. 17+87.42 Sta. 18+66.16 Sta. 19+87.93	TO 13+90.66 TO 14+15.29 TO 14+24.32 TO 15+63.13 TO 16+31.39 TO 18+92.82 TO 14+91.28 TO 15+08.33 TO 15+20.99 TO 16+67.18 TO 18+19.79 TO 20+02.18	22.06 RT 10.06 - 21.88 RT 0 - 12.23 RT 0 0 19.47 RT 22.29 RT 22.01 - 9.28 RT 0 - 16.58 RT 0 0 10.76 - 36.92 RT	REMARKS
437.44 Sta. 16 126.06 Sta. 163 402.31 Sta. 163 EB (SB) REST AREA 233.79 Sta. 113 29,998 TOTAL 42300300 PORTLAND CEMENT CONCR SQ YD LOC WB (NB) REST AREA 27.98 Sta. 173 EB (SB) REST AREA 27.79 Sta. 183 75.64 Sta. 193 132 TOTAL 42400200 PORTLAND CEMENT CONCR SQ FT LOC WB (NB) REST AREA 264.16 Sta. 133 317.41 Sta. 143 317.41 Sta. 143 317.41 Sta. 143 375.30 Sta. 153 495.15 Sta. 153 EB (SB) REST AREA 259.03 Sta. 153 337.12 Sta. 163 338.88 Sta. 173	CONCRETE SIDEW LOCATION EA a. 13+60.50 a. 14+06.55 a. 15+23.22 a. 15+87.39 EA a. 14+58.72 a. 15+05.86 a. 16+30.06 a. 17+87.42	TO 19+80.53 /ALK 5 INCH TO 13+90.66 TO 14+32.87 TO 15+63.12 TO 16+31.39 TO 14+91.23 TO 15+31.28 TO 16+67.19	24.59 RT 2.58 - 24.46 RT 2.50 RT 2.51 RT 24.87 RT 2.91 - 24.59 RT 2.64 - 9.61 RT	REMARKS	FOOT WB (NB) 30 25 17 39 42 18 EB (SB) 32 19 25 32 15 32	REST AI 0.18	LOCATION AREA Sta. 13+60.48 Sta. 14+18.72 Sta. 15+23.22 Sta. 15+87.37 Sta. 18+76.36 AREA Sta. 14+58.71 Sta. 15+05.86 Sta. 15+12.95 Sta. 16+42.00 Sta. 17+87.42 Sta. 18+66.16 Sta. 19+87.93	TO 13+90.66 TO 14+15.29 TO 14+24.32 TO 15+63.13 TO 16+31.39 TO 18+92.82 TO 14+91.28 TO 15+08.33 TO 15+20.99 TO 16+67.18 TO 18+19.79 TO 20+02.18	22.06 RT 10.06 - 21.88 RT 0 - 12.23 RT 0 0 19.47 RT 22.29 RT 22.01 - 9.28 RT 0 - 16.58 RT 0 0 10.76 - 36.92 RT	REMARKS
### 437.44 Sta. 16 ### 126.06 Sta. 163 ### 402.31 Sta. 163 ### 402.31 Sta. 113 ### 233.79 Sta. 113 ### 29,998 TOTAL ### 42300300 PORTLAND CEMENT CONCR ### 50 YD LOC ### (NB) REST AREA ### 27.98 Sta. 173 ### EB (SB) REST AREA ### 27.79 Sta. 183 ### 27.64 Sta. 193 ### 132 TOTAL ### 42400200 PORTLAND CEMENT CONCR ### 50 FT LOC ### (NB) REST AREA ### 264.16 Sta. 133 ### 317.41 Sta. 143 ### 375.30 Sta. 143 ### 375.30 Sta. 153 ### 495.15 Sta. 153 ### 495.15 Sta. 153 ### 259.03 Sta. 143 ### 398.99 Sta. 153 ### 337.12 Sta. 163 ### 337.12 Sta. 163 ### 337.12 Sta. 163 ### 338.88 Sta. 173	CONCRETE SIDEW LOCATION EA a. 13+60.50 a. 14+06.55 a. 15+23.22 a. 15+87.39 EA a. 14+58.72 a. 15+05.86 a. 16+30.06 a. 17+87.42	TO 19+80.53 /ALK 5 INCH TO 13+90.66 TO 14+32.87 TO 15+63.12 TO 16+31.39 TO 14+91.23 TO 15+31.28 TO 16+67.19	24.59 RT 2.58 - 24.46 RT 2.50 RT 2.51 RT 24.87 RT 2.91 - 24.59 RT 2.64 - 9.61 RT	REMARKS	FOOT WB (NB) 30 25 17 39 42 18 EB (SB) 32 19 25 32 15 32	REST AI 1.18	LOCATION AREA Sta. 13+60.48 Sta. 14+18.72 Sta. 15+23.22 Sta. 15+87.37 Sta. 18+76.36 AREA Sta. 14+58.71 Sta. 15+05.86 Sta. 15+12.95 Sta. 16+42.00 Sta. 17+87.42 Sta. 18+66.16	TO 13+90.66 TO 14+15.29 TO 14+24.32 TO 15+63.13 TO 16+31.39 TO 18+92.82 TO 14+91.28 TO 15+08.33 TO 15+20.99 TO 16+67.18 TO 18+19.79 TO 20+02.18	22.06 RT 10.06 - 21.88 RT 0 - 12.23 RT 0 0 19.47 RT 22.29 RT 22.01 - 9.28 RT 0 - 16.58 RT 0 0 10.76 - 36.92 RT	REMARKS
437.44 Sta. 16 126.06 Sta. 16: 402.31 Sta. 16: 402.37 Sta. 11: 233.79 Sta. 11: 29,998 TOTAL 42300300 PORTLAND CEMENT CONCR SQ YD LOC WB (NB) REST AREA 27.98 Sta. 17: EB (SB) REST AREA 27.79 Sta. 18: 75.64 Sta. 19: 132 TOTAL 42400200 PORTLAND CEMENT CONCR SO FT LOC WB (NB) REST AREA 264.16 Sta. 13: 317.41 Sta. 14: 375.30 Sta. 15: 495.15 Sta. 15: 495.15 Sta. 15: EB (SB) REST AREA 259.03 Sta. 14: 398.99 Sta. 15: 337.12 Sta. 16:	CONCRETE SIDEW LOCATION EA a. 13+60.50 a. 14+06.55 a. 15+23.22 a. 15+87.39 EA a. 14+58.72 a. 15+05.86 a. 16+30.06	TO 19+80.53 /ALK 5 INCH TO 13+90.66 TO 14+32.87 TO 15+63.12 TO 16+31.39 TO 14+91.23 TO 15+31.28 TO 16+67.19	24.59 RT 2.58 - 24.46 RT 2.50 RT 2.51 RT 24.87 RT 2.91 - 24.59 RT 2.64 - 9.61 RT	REMARKS	FOOT WB (NB) 30 25 17 39 42 18 EB (SB) 32 19 25 25	REST AI 0.18	LOCATION AREA Sta. 13+60.48 Sta. 14+06.32 Sta. 14+18.72 Sta. 15+23.22 Sta. 15+87.37 Sta. 18+76.36 AREA Sta. 14+58.71 Sta. 15+05.86 Sta. 15+12.95 Sta. 16+42.00 Sta. 17+87.42	TO 13+90.66 TO 14+15.29 TO 14+24.32 TO 15+63.13 TO 16+31.39 TO 18+92.82 TO 14+91.28 TO 15+08.33 TO 15+20.99 TO 16+67.18 TO 18+19.79	22.06 RT 10.06 - 21.88 RT 0 - 12.23 RT 0 0 19.47 RT 22.29 RT 22.01 - 9.28 RT 0 - 16.58 RT 0 0	REMARKS
437.44 Sta. 16 126.06 Sta. 16: 402.31 Sta. 16: 402.31 Sta. 16: EB (SB) REST AREA 233.79 Sta. 11- 29,998 TOTAL 42300300 PORTLAND CEMENT CONCR SO YD LOC WB (NB) REST AREA 27.98 Sta. 17- EB (SB) REST AREA 27.79 Sta. 18- 75.64 Sta. 19- 132 TOTAL 42400200 PORTLAND CEMENT CONCR SO FT LOC WB (NB) REST AREA 264.16 Sta. 13- 317.41 Sta. 14- 375.30 Sta. 15- 495.15 Sta. 15- EB (SB) REST AREA 259.03 Sta. 14- 398.99 Sta. 15-	CONCRETE SIDEW LOCATION A a. 13+60.50 a. 14+06.55 a. 15+23.22 a. 15+87.39 A a. 14+58.72 a. 15+05.86	TO 19+80.53 /ALK 5 INCH TO 13+90.66 TO 14+32.87 TO 15+63.12 TO 16+31.39 TO 14+91.23 TO 15+31.28	24.59 RT 2.58 - 24.46 RT 2.50 RT 2.51 RT 24.87 RT 2.91 - 24.59 RT	REMARKS	FOOT WB (NB) 30 25 17 39 42 18 EB (SB) 32 19 25	REST AI 0.18	LOCATION AREA Sta. 13+60.48 Sta. 14+06.32 Sta. 14+18.72 Sta. 15+23.22 Sta. 15+87.37 Sta. 18+76.36 AREA Sta. 14+58.71 Sta. 15+05.86 Sta. 15+12.95 Sta. 16+42.00	TO 13+90.66 TO 14+15.29 TO 14+24.32 TO 15+63.13 TO 16+31.39 TO 18+92.82 TO 14+91.28 TO 15+08.33 TO 15+20.99 TO 16+67.18	22.06 RT 10.06 - 21.88 RT 0 - 12.23 RT 0 0 19.47 RT 22.29 RT 22.01 - 9.28 RT 0 - 16.58 RT 0	REMARKS
437.44 Sta. 16 126.06 Sta. 16: 402.31 Sta. 16: EB (SB) REST AREA 233.79 Sta. 11- 29,998 TOTAL 42300300 PORTLAND CEMENT CONCR SO YD LOC WB (NB) REST AREA 27.98 Sta. 17- EB (SB) REST AREA 27.79 Sta. 18- 75.64 Sta. 19- 132 TOTAL 42400200 PORTLAND CEMENT CONCR SO FT LOC WB (NB) REST AREA 264.16 Sta. 13- 317.41 Sta. 14- 375.30 Sta. 15- 495.15 Sta. 15- EB (SB) REST AREA 259.03 Sta. 14-	CONCRETE SIDEW LOCATION A. 13+60.50 a. 14+06.55 a. 15+23.22 a. 15+87.39 A. a. 14+58.72	TO 19+80.53 VALK 5 INCH TO 13+90.66 TO 14+32.87 TO 15+63.12 TO 16+31.39 TO 14+91.23	24.59 RT 2.58 - 24.46 RT 2.50 RT 2.51 RT 24.87 RT	REMARKS	FOOT WB (NB) 30 25 17 39 42 18 EB (SB) 32 19	REST AI 0.18	LOCATION AREA Sta. 13+60.48 Sta. 14+18.72 Sta. 15+23.22 Sta. 15+87.37 Sta. 18+76.36 AREA Sta. 14+58.71 Sta. 15+05.86 Sta. 15+12.95	TO 13+90.66 TO 14+15.29 TO 14+24.32 TO 15+63.13 TO 16+31.39 TO 18+92.82 TO 14+91.28 TO 15+08.33 TO 15+20.99	22.06 RT 10.06 - 21.88 RT 0 - 12.23 RT 0 0 19.47 RT 22.29 RT 22.01 - 9.28 RT 0 - 16.58 RT	<u>REMARKS</u>
437.44 Sta. 16 126.06 Sta. 16: 402.31 Sta. 16: EB (SB) REST AREA 233.79 Sta. 11- 29,998 TOTAL 42300300 PORTLAND CEMENT CONCR SQ YD LOC WB (NB) REST AREA 27.98 Sta. 17- EB (SB) REST AREA 27.79 Sta. 18- 75.64 Sta. 19- 132 TOTAL 42400200 PORTLAND CEMENT CONCR SO FT LOC WB (NB) REST AREA 264.16 Sta. 13- 317.41 Sta. 14- 375.30 Sta. 15- 495.15 Sta. 15- EB (SB) REST AREA	CONCRETE SIDEW LOCATION EA a. 13+60.50 a. 14+06.55 a. 15+23.22 a. 15+87.39	TO 19+80.53 VALK 5 INCH TO 13+90.66 TO 14+32.87 TO 15+63.12 TO 16+31.39	24.59 RT 2.58 - 24.46 RT 2.50 RT 2.51 RT	REMARKS	FOOT WB (NB) 30 25 17 39 42 18 EB (SB) 32	REST AI 0.18	LOCATION AREA Sta. 13+60.48 Sta. 14+18.72 Sta. 15+23.22 Sta. 15+87.37 Sta. 18+76.36 AREA Sta. 14+58.71 Sta. 15+05.86	TO 13+90.66 TO 14+15.29 TO 14+24.32 TO 15+63.13 TO 16+31.39 TO 18+92.82 TO 14+91.28 TO 15+08.33	22.06 RT 10.06 - 21.88 RT 0 - 12.23 RT 0 0 19.47 RT 22.29 RT 22.01 - 9.28 RT	<u>REMARKS</u>
437.44 Sta. 16 126.06 Sta. 16: 402.31 Sta. 16: 402.31 Sta. 16: EB (SB) REST AREA 233.79 Sta. 11- 29,998 TOTAL 42300300 PORTLAND CEMENT CONCR SO YD LOC WB (NB) REST AREA 27.98 Sta. 17- EB (SB) REST AREA 27.79 Sta. 18- 75.64 Sta. 19- 132 TOTAL 42400200 PORTLAND CEMENT CONCR SO FT LOC WB (NB) REST AREA 264.16 Sta. 13- 317.41 Sta. 14- 375.30 Sta. 15-	CONCRETE SIDEW LOCATION EA a. 13+60.50 a. 14+06.55 a. 15+23.22	TO 19+80.53 /ALK 5 INCH TO 13+90.66 TO 14+32.87 TO 15+63.12	24.59 RT 2.58 - 24.46 RT 2.50 RT	REMARKS	FOOT WB (NB) 30 25 17 39 42 18 EB (SB)	REST Al 0.18	LOCATION AREA Sta. 13+60.48 Sta. 14+06.32 Sta. 14+18.72 Sta. 15+23.22 Sta. 15+87.37 Sta. 18+76.36 AREA	TO 13+90.66 TO 14+15.29 TO 14+24.32 TO 15+63.13 TO 16+31.39 TO 18+92.82	22.06 RT 10.06 - 21.88 RT 0 - 12.23 RT 0 0 19.47 RT	REMARKS
437.44 Sta. 16 126.06 Sta. 16: 402.31 Sta. 16: 402.31 Sta. 16: EB (SB) REST AREA 233.79 Sta. 11- 29,998 TOTAL 42300300 PORTLAND CEMENT CONCR SO YD LOC WB (NB) REST AREA 27.98 Sta. 17- EB (SB) REST AREA 27.79 Sta. 18- 75.64 Sta. 19- 132 TOTAL 42400200 PORTLAND CEMENT CONCR SO FT LOC WB (NB) REST AREA 264.16 Sta. 13- 317.41 Sta. 14-	CONCRETE SIDEW LOCATION EA a. 13+60.50 a. 14+06.55	TO 19+80.53 /ALK 5 INCH TO 13+90.66 TO 14+32.87	24.59 RT 2.58 - 24.46 RT	REMARKS	FOOT WB (NB) 30 25 17 39 42	REST AI 0.18	LOCATION AREA Sta. 13+60.48 Sta. 14+06.32 Sta. 14+18.72 Sta. 15+23.22 Sta. 15+87.37 Sta. 18+76.36	TO 13+90.66 TO 14+15.29 TO 14+24.32 TO 15+63.13 TO 16+31.39	22.06 RT 10.06 - 21.88 RT 0 - 12.23 RT 0 0	<u>REMARKS</u>
437.44 Sta. 16 126.06 Sta. 16: 402.31 Sta. 16: EB (SB) REST AREA 233.79 Sta. 11- 29,998 TOTAL 42300300 PORTLAND CEMENT CONCR SO YD LOC WB (NB) REST AREA 27.98 Sta. 17- EB (SB) REST AREA 27.79 Sta. 18- 75.64 Sta. 19- 132 TOTAL 42400200 PORTLAND CEMENT CONCR SO FT LOC WB (NB) REST AREA 264.16 Sta. 13-	CONCRETE SIDEW LOCATION EA a. 13+60.50	TO 19+80.53 VALK 5 INCH TO 13+90.66	24.59 RT	REMARKS	FOOT <u>WB (NB)</u> 30 25 17 39 44	REST AI 0.18	LOCATION AREA Sta. 13+60.48 Sta. 14+06.32 Sta. 14+18.72 Sta. 15+23.22 Sta. 15+87.37	TO 13+90.66 TO 14+15.29 TO 14+24.32 TO 15+63.13 TO 16+31.39	22.06 RT 10.06 - 21.88 RT 0 - 12.23 RT 0 0	<u>REMARKS</u>
437.44 Sta. 16 126.06 Sta. 16: 402.31 Sta. 16: EB (SB) REST AREA 233.79 Sta. 11- 29,998 TOTAL 42300300 PORTLAND CEMENT CONCR SO YD LOC WB (NB) REST AREA 27.98 Sta. 17- EB (SB) REST AREA 27.79 Sta. 18- 75.64 Sta. 19- 132 TOTAL 42400200 PORTLAND CEMENT CONCR SO FT LOC WB (NB) REST AREA	a. 19+40.66 CONCRETE SIDEW LOCATION	TO 19+80.53		REMARKS	FOOT WB (NB) 30 25 17 39	REST Al 0.18	LOCATION AREA Sta. 13+60.48 Sta. 14+06.32 Sta. 14+18.72 Sta. 15+23.22	TO 13+90.66 TO 14+15.29 TO 14+24.32 TO 15+63.13	22.06 RT 10.06 - 21.88 RT 0 - 12.23 RT 0	<u>REMARKS</u>
437.44 Sta. 16 126.06 Sta. 163 402.31 Sta. 163 EB (SB) REST AREA 233.79 Sta. 11- 29,998 TOTAL 42300300 PORTLAND CEMENT CONCR SQ YD LOC WB (NB) REST AREA 27.98 Sta. 17- EB (SB) REST AREA 27.79 Sta. 18- 75.64 Sta. 19- 132 TOTAL 42400200 PORTLAND CEMENT CONCR	a. 19+40.66 CONCRETE SIDEW LOCATION	TO 19+80.53	OFFSET (FT)	<u>REMARKS</u>	FOOT WB (NB) 30 25 17	REST AI 0.18 9 5.40 9 7.36 9	LOCATION AREA Sta. 13+60.48 Sta. 14+06.32 Sta. 14+18.72	TO 13+90.66 TO 14+15.29 TO 14+24.32	22.06 RT 10.06 - 21.88 RT 0 - 12.23 RT	<u>REMARKS</u>
437.44 Sta. 16 126.06 Sta. 16: 402.31 Sta. 16: EB (SB) REST AREA 233.79 Sta. 11- 29,998 TOTAL 42300300 PORTLAND CEMENT CONCR SO YD LOC WB (NB) REST AREA 27.98 Sta. 17- EB (SB) REST AREA 27.79 Sta. 18- 75.64 Sta. 19- 132 TOTAL	a. 19+40.66 CONCRETE SIDEW	TO 19+80.53	OFFSET (FT)	REMARKS	FOOT WB (NB) 30 25	REST Al	LOCATION AREA Sta. 13+60.48 Sta. 14+06.32	TO 13+90.66 TO 14+15.29	22.06 RT 10.06 - 21.88 RT	<u>REMARKS</u>
437.44 Sta. 16 126.06 Sta. 16: 402.31 Sta. 16: EB (SB) REST AREA 233.79 Sta. 11- 29,998 TOTAL 42300300 PORTLAND CEMENT CONCR SO YD LOC WB (NB) REST AREA 27.98 Sta. 17- EB (SB) REST AREA 27.79 Sta. 18- 75.64 Sta. 19- 132 TOTAL	a. 19+40.66	TO 19+80.53			<u>FOOT</u> <u>WB (NB)</u> 30	REST AI	<u>LOCATION</u> AREA Sta. 13+60.48	TO 13+90.66	22.06 RT	REMARKS
437.44 Sta. 16 126.06 Sta. 16: 402.31 Sta. 16: EB (SB) REST AREA 233.79 Sta. 11- 29,998 TOTAL 42300300 PORTLAND CEMENT CONCR SO YD LOC WB (NB) REST AREA 27.98 Sta. 17- EB (SB) REST AREA 27.79 Sta. 18- 75.64 Sta. 19- 132 TOTAL	a. 19+40.66	TO 19+80.53			FOOT WB (NB)	REST AI	<u>LOCATION</u> AREA			REMARKS
437.44 Sta. 16 126.06 Sta. 16: 402.31 Sta. 16: 402.37 Sta. 16: EB (SB) REST AREA 233.79 Sta. 11- 29,998 TOTAL 42300300 PORTLAND CEMENT CONCR SO YD LOC WB (NB) REST AREA 27.98 Sta. 17- EB (SB) REST AREA 27.79 Sta. 18- 75.64 Sta. 19-	a. 19+40.66				FOOT		LOCATION	REMOVAL	OFFSET (FT)	<u>REMARKS</u>
437.44 Sta. 16 126.06 Sta. 16: 402.31 Sta. 16: 402.37 Sta. 16: EB (SB) REST AREA 233.79 Sta. 11- 29,998 TOTAL 42300300 PORTLAND CEMENT CONCR SO YD LOC WB (NB) REST AREA 27.98 Sta. 17- EB (SB) REST AREA 27.79 Sta. 18- 75.64 Sta. 19-	a. 19+40.66							REMOVAL		
437.44 Sta. 16 126.06 Sta. 16: 402.31 Sta. 16: 402.37 Sta. 16: EB (SB) REST AREA 233.79 Sta. 11- 29,998 TOTAL 42300300 PORTLAND CEMENT CONCR SO YD LOC WB (NB) REST AREA 27.98 Sta. 17- EB (SB) REST AREA 27.79 Sta. 18- 75.64 Sta. 19-	a. 19+40.66				44000500 <u>COMBINA</u>	TION CUP	RB AND GUTTER	REMOVAL		
437.44 Sta. 16 126.06 Sta. 16: 402.31 Sta. 16: EB (SB) REST AREA 233.79 Sta. 11- 29,998 TOTAL 42300300 PORTLAND CEMENT CONCR SQ YD LOC WB (NB) REST AREA 27.98 Sta. 17- EB (SB) REST AREA	.a.18+65./5									
437.44 Sta. 16 126.06 Sta. 16: 402.31 Sta. 16: EB (SB) REST AREA 233.79 Sta. 11- 29,998 TOTAL 42300300 PORTLAND CEMENT CONCR SO YD LOC WB (NB) REST AREA 27.98 Sta. 17-	- 10.CF 75	TO 18+93.22								
437.44 Sta. 16 126.06 Sta. 16: 402.31 Sta. 16: EB (SB) REST AREA 233.79 Sta. 11- 29,998 TOTAL 42300300 PORTLAND CEMENT CONCR SQ YD LOC WB (NB) REST AREA										
437.44 Sta. 16 126.06 Sta. 16: 402.31 Sta. 16: EB (SB) REST AREA 233.79 Sta. 11- 29,998 TOTAL 42300300 PORTLAND CEMENT CONCR	ta.17+59.71	TO 17+86.77				100 TOTA				yı
437.44 Sta. 16 126.06 Sta. 16: 402.31 Sta. 16: EB (SB) REST AREA 233.79 Sta. 11- 29,998 TOTAL 42300300 PORTLAND CEMENT CONCR					<u>1 00 1</u>			00 TO 1672+56.00		Type 6 locations
437.44 Sta. 16 126.06 Sta. 16: 402.31 Sta. 16: EB (SB) REST AREA 233.79 Sta. 11- 29,998 TOTAL	LOCATION		REMARKS		<u>F00T</u>		LOCATION		REMARKS	
437.44 Sta. 16 126.06 Sta. 16: 402.31 Sta. 16: EB (SB) REST AREA 233.79 Sta. 11-	CONCRETE DRIVE	WAY PAVEMENT, 7	INCH		44000300 <u>CURB RE</u>	<u>MOVAL</u>				
437.44 Sta. 16 126.06 Sta. 16: 402.31 Sta. 16: EB (SB) REST AREA 233.79 Sta. 11-										
437.44 Sta. 16 126.06 Sta. 16: 402.31 Sta. 16: EB (SB) REST AREA 233.79 Sta. 11-						56 TOTA	AL			
437.44 Sta. 16 126.06 Sta. 16 402.31 Sta. 16		TO 13+37.06	47.72 - 64.34 RT	Outside Shoulder	27		Sta. 18+65.75	TO 18+93.22		
437.44 Sta. 16 126.06 Sta. 16					EB (SB)	REST A	AREA			
437.44 Sta.16	a. 1629+08.53	TO 1630+91.85	40.74 - 145.55 LT	Inside Shoulder	27	7.97	Sta. 17+59.71	TO 17+86.77		
	a. 1625+92.07	TO 1627+12.11	30.69 - 67.70 RT	Outside Shoulder	WB (NB)					
333.30 3ta.10	a. 1619+90.54	TO 1622+55.58	81.97 - 137.18 RT	Outside Shoulder	<u>SQ YE</u>	<u> </u>	LOCATION		REMARKS	
995.56 Sta. 16	a. 1619+21.70	TO 1627+11.58	24.81 - 120.78 LT	Inside Shoulder						
49.16 Sta. 16	a. 1613+75.40	TO 1613+85.23	29.33 RT	Outside Shoulder	44000200 <u>DRIVEWA</u>	Y PAVEME	ENT REMOVAL			
		TO 1603+11.54	28.61 - 46.03 LT	Inside Shoulder						
		TO 1603+11.87	28.55 - 50.47 RT	Outside Shoulder		52 1017	· ·-			
		TO 1600+34.32	99.60 - 114.71 LT	Inside Shoulder		92 TOTA		10 10107.90	2.73 111	
		TO 1600+54.32	104.43 RT	Outside Shoulder			Sta. 17+99.98		2.43 RT	
		TO 1573+93.23	25.08 - 98.41 LT	Outside Shoulder Inside Shoulder			Sta. 15+09.44 Sta. 16+49.94	TO 15+13.65 TO 16+55.27	2.64 RT	
· ·		TO 1572+36.62 TO 1575+95.25	66.00 RT 74.77 - 150.84 RT	Outside Shoulder			Sta. 14+72.66 Sta. 15+09.44		24.87 RT 3.22 - 6.23 RT	
		TO 1564+93.52	88.68 RT	Outside Shoulder	<u>EB (SB)</u>			TO 14:77 66	24 07 DT	

MODEL: Default

EB (SB) REST AREA	60605000 COMBINATION CONCERETE CURB AND GUTTER, TYPE B-6.24	
260.46 Sta. 14+58.72 TO 14+91.23 24.87 RT		
333.29 Sta. 15+05.86 TO 15+32.67 6.63 - 24.59 RT	FOOT LOCATION OFFS	ET (FT) REMARKS
327.82 Sta. 16+30.06 TO 16+67.19 2.64 - 9.61 RT	WB (NB) REST AREA	
336.91 Sta. 17+87.42 TO 18+19.62 2.40 - 2.89 RT	39.91 Sta.15+23.22 TO 15+63.13	0
2 , 650 TOTAL	44.02 Sta.15+87.37 TO 16+31.39	0
	EB (SB) REST AREA	
	32.37 Sta. 17+87.42 TO 18+19.79	0
50105220 <u>PIPE CULVERT REMOVAL</u>	128.81 Sta. 18+66.16 TO 20+02.18 10.76 -	36.92 RT
	246 TOTAL	
FOOT LOCATION REMARKS		
103.48 Sta. 1663+02.25 TO 1664+05.73		
104 TOTAL	60607400 COMBINATION CONCERETE CURB AND GUTTER, TYPE B-9.24	
	FOOT LOCATION OFFS	ET (FT) REMARKS
54213687 PRECAST REINFORCED CONCRETE FLARED END SECTION 42"	WB (NB) REST AREA	
		06 RT
EACH LOCATION OFFSET (FT) REMARKS	41.76 Sta.14+06.53 TO 14+24.32 0 - 2	21.88 RT
1 Sta. 1539+86.96 100.33 LT Install salvaged grate from existing FES	18.74 Sta. 18+76.36 TO 18+92.82 19.	47 RT
1 TOTAL	EB (SB) REST AREA	
	32.57 Sta. 14+58.71 TO 14+91.28 22.	29 RT
	40.27 Sta.15+05.86 TO 15+20.99 0 - 2	22.01 RT
54246205 <u>INLET BOX, STANDARD 542526</u>	25.18 Sta.16+42.00 TO 16+67.18	0
	18.81 Sta. 19+87.93 TO 20+04.45 18.	91 RT
EACH LOCATION OFFSET (FT) REMARKS		
1 Sta. 1662+75.50 0		
TOTAL		
	63000001 <u>STEEL PLATE BEAM GUARDRAIL, TYPE A, 6 FOOT POSTS</u>	
FARRANCE RIVERTS CLASS B. TVRF 4 RAII	FOOT LOCATION REMARKS	
542D0229 PIPE CULVERTS, CLASS D, TYPE 1 24"	WB (NB) OUTSIDE SHOULDER	
FOOT LOCATION OFFCET (FT) DEMANKS		Shoulder
FOOT LOCATION OFFSET (FT) REMARKS		: Shoulder
157.81 Sta. 1662+75.50 TO 1664+33.31 0		Shoulder
158 TOTAL		: Shoulder
		: Shoulder
COCCOOR CLASS ST. CONCRETE (OUTLET)		Shoulder
60600095 CLASS SI CONCRETE (OUTLET)	EB (SB)	Shourder
CIL VD LOCATION DEMARKS		Shoulder
CU YD LOCATION REMARKS		: Shoulder
EB (SB) REST AREA		: Shoulder
3.32 Sta. 19+83.29 TO 20+18.80		Shoulder
4 TOTAL		: Shoulder
		Shoulder
SOSOOSOS CONCRETE CURR TYRE R	3.237.5TOTAL	5.154 461
60600605 <u>CONCRETE CURB. TYPE B</u>	3,23,13,101/12	
FOOT LOCATION REMARKS		
100 Sta. 1285+75.00 TO 1672+56.00 As needed for TBT, Type 6 locations	63000003 STEEL PLATE BEAM GUARDRAIL, TYPE A, 9 FOOT POSTS	
100 TOTAL		
IOUTOINE	FOOT LOCATION REMARKS	
	WB (NB)	
		Shoulder
	175.00 Sta. 1372+15.50 TO 1373+90.49 Outside	: Shoulder
	712.50 Sta. 1473+38.47 TO 1480+55.16 Outside	Shoulder
	1,275.00 Sta.1566+88.50 TO 1579+61.74 Outside	: Shoulder
	1,275.00 Sta.1594+00.09 TO 1606+76.00 Inside	Shoulder
USER NAME = bartonrw DESIGNED - REVISED -		F.A.I. SECTION TOTAL SHE
DRAWN - REVISED - STATE OF IL		F.A.I. SECTION COUNTY SHEETS NO. 74 (37-3,4)RS-2 HENRY 142 37
PLOT SCALE = 100.0000 '/ in. CHECKED - REVISED - PLOT DATE = May-06-2019 08:02:57 AM DATE - REVISED -	ANSPORTATION	CONTRACT NO. 64C06
PLOT DATE = May-06-2019 08:02:57 AM DATE - REVISED -	SCALE: SHEET 3 OF 13 SHEETS STA. TO STA.	ILLINOIS FED. AID PROJECT

March 1			DRAWN -	REVISED -	STATE OF ILLINOIS SCHEDULE OF QUANTITIES RTE. SECTION COUNTY SHEEL 74 (37-3,4)RS-2 HENRY 14
Part			DESIGNED -	REVISED -	F.A.L SECTION CONTROL TO
1,933 10 10 10 10 10 10 10			TO 1630+70.46	Inside Shoulder	1,767.00 Sta.1562+14.00 TO 1579+81.00 Outside Shoulder
1,353 3	1	Sta. 1630+27.50	TO 1630+65.00	Outside Shoulder	904.00 Sta. 1525+56.00 TO 1534+60.00 Outside Shoulder
1.301.07 1.301.07 1.001.07	1	Sta. 1422+32.50	TO 1422+70.00	Inside Shoulder	691.00 Sta. 1473+17.00 TO 1480+08.00 Outside Shoulder
1.90.10 1.90	1	Sta. 1422+32.50	TO 1422+70.00	Outside Shoulder	365.00 Sta. 1423+89.00 TO 1427+54.00 Inside Shoulder
1,500 32 1,500 135 1,500	1				
1,001.00		Sta. 1369+98.50	TO 1370+36.00	Outside Shoulder	
1,550 5 1,510-94 3 10 1340-91 3 1340-91		5.4, 1051154.00	10 1002101100	INSINC SHOUTUEL	
1.950.0 1.95	1				
March Marc	1				
Part 1.500	1				EOOT LOCATION DEMARKS
Part	1				63200310 <u>GUARDKAIL REMOVAL</u>
1. 1. 1. 1. 1. 1. 1. 1.	1				
1,950 1,95					
Part	<u>EAC</u> H	LOCATION		<u>REMARKS</u>	
1,550.0 1,50	JUGO <u>IKAFFIC BARR</u>	EK IEKMINAL, IYE	<u> </u>		
1.95.0 1	NOS TRACCIO RADO	ED TEDMINAL TYP	E 6		
Part	16 TC	DIAL			
			TO 1634+68.79	Inside Shoulder	
Part	1				
Fig. 158 Fig.	1	Sta. 1602+10.86	TO 1602+23.36	Outside Shoulder	
Fig.	1				1 Sta. 1419+47.63 TO 1419+97.63 Inside Shoulder
RE SE	1	Sta. 1574+61.50	TO 1574+74.00	Outside Shoulder	1 Sta. 1418+95.00 TO 1419+45.00 Outside Shoulder
F.R. Section F.R.	1	Sta. 1532+49.00	TO 1532+61.50	Outside Shoulder	1 Sta. 1367+86.01 TO 1368+36.01 Outside Shoulder
FB FB FB FB FB FB FB FB	1	Sta. 1479+99.02	TO 1480+11.52	Outside Shoulder	1 Sta. 1366+98.57 TO 1367+48.57 Inside Shoulder
FB SB FB SB FB SB FB SB S	1	Sta. 1340+11.32	TO 1340+23.82	Outside Shoulder	
FB SER FB SER FB SER FB SER FB SER FB SER SER	EB (SB)				
Fig. 1, 1950 Sta. 1320+641 Sta. 1320+641	1	Sta. 1617+70.48	TO 1617+82.98	Outside Shoulder	1 Sta. 1634+68.97 TO 1635+18.97 Inside Shoulder
FB / SB FB / SB /	1				
Fig.	1				
FB (5B)	1				
FB (SB)	1				
FB (SB)	1				
FB SB SB SB SB SB SB SB	1				
FB (SB)	1	Sta. 1326+89.93	TO 1327+02.43	Outside Shoulder	
FB SB SB SB SB SB SB SB		LOCALION		<u></u>	
FB CSB SB SB SB SB SB SB	FACH	LOCATION		REMARKS	
BB SB SB SB SB SB SB SB	UTO INAFFIC DAKK	<u>LN ILMMINAL, IIF</u>	<u> </u>		
FB (SB)	OAS TRAFFIC PARK	ED TEDMINIAL TVE	ıF 2		
Name					
EB (SB) 1,950.00 Sta. 1320+64.13 TO 1340+11.32 Outside Shoulder 1,300.00 Sta. 1467+07.53 TO 1479+99.02 Outside Shoulder 400.00 Sta. 1528+49.01 TO 1532+49.00 Outside Shoulder 1,187.50 Sta. 1562+74.00 TO 1574+61.50 Outside Shoulder 1,125.00 Sta. 1590+73.84 TO 1601+98.82 Inside Shoulder 1,025.00 Sta. 1591+85.86 TO 1602+10.86 Outside Shoulder 1,462.50 Sta. 1615+68.42 TO 1630+32.96 Inside Shoulder					
EB (SB) WB (NB) 1,950.00 Sta. 1320+64.13 TO 1340+11.32 Outside Shoulder 1 Sta. 1630+46.50 TO 1630+59.00 Outside Shoulder 1,300.00 Sta. 1467+07.53 TO 1479+99.02 Outside Shoulder 1 Sta. 1630+46.50 TO 1630+59.00 Inside Shoulder 400.00 Sta. 1528+49.01 TO 1532+49.00 Outside Shoulder EB (SB) 1,187.50 Sta. 1562+74.00 TO 1574+61.50 Outside Shoulder 3TOTAL 1,025.00 Sta. 1591+85.86 TO 1602+10.86 Outside Shoulder 3TOTAL					63100167 TRAFFIC BARRIER TERMINAL. TYPE 1 (SPECIAL) TANGENT
EB (SB) WB (NB) 1,950.00 Sta. 1320+64.13 TO 1340+11.32 Outside Shoulder 1 Sta. 1630+46.50 TO 1630+59.00 Outside Shoulder 1,300.00 Sta. 1467+07.53 TO 1479+99.02 Outside Shoulder 1 Sta. 1630+46.50 TO 1630+59.00 Inside Shoulder 400.00 Sta. 1528+49.01 TO 1532+49.00 Outside Shoulder EB (SB) 1,187.50 Sta. 1562+74.00 TO 1574+61.50 Outside Shoulder 1 Sta. 1632+06.11 TO 1632+18.61 Inside Shoulder 1,125.00 Sta. 1590+73.84 TO 1601+98.82 Inside Shoulder 3TOTAL					
EB (SB) WB (NB) 1,950.00 Sta. 1320+64.13 TO 1340+11.32 Outside Shoulder 1,300.00 Sta. 1467+07.53 TO 1479+99.02 Outside Shoulder 400.00 Sta. 1528+49.01 TO 1532+49.00 Outside Shoulder 1,187.50 Sta. 1562+74.00 TO 1574+61.50 Outside Shoulder Sta. 1630+46.50 TO 1630+59.00 Inside Shoulder Sta. 1632+06.11 TO 1632+18.61 Inside Shoulder					STOTAL
EB (SB) 1,950.00 Sta. 1320+64.13 TO 1340+11.32 Outside Shoulder 1,300.00 Sta. 1467+07.53 TO 1479+99.02 Outside Shoulder 400.00 Sta. 1528+49.01 TO 1532+49.00 Outside Shoulder EB (SB) WB (NB) 1 Sta. 1630+46.50 TO 1630+59.00 Outside Shoulder 1 Sta. 1630+46.50 TO 1630+59.00 Inside Shoulder EB (SB)					
<u>WB (NB)</u> 1,950.00 Sta.1320+64.13 TO 1340+11.32 Outside Shoulder 1 Sta.1630+46.50 TO 1630+59.00 Outside Shoulder 1,300.00 Sta.1467+07.53 TO 1479+99.02 Outside Shoulder 1 Sta.1630+46.50 TO 1630+59.00 Inside Shoulder					
EB (SB) 1,950.00 Sta. 1320+64.13 TO 1340+11.32 Outside Shoulder 1 Sta. 1630+46.50 TO 1630+59.00 Outside Shoulder					
EB (SB)					
		Sta. 1617+82.98	TO 1630+46.50	Outside Shoulder	
1,312.50 Sta.1617+34.29 TO 1630+46.50 Inside Shoulder	1,312.30	Sta. 1617+34.29	10 1630+46.50	Inside Shoulder	

862 6,752			DESIGNED - DRAWN -	Mainline REVISED - REVISED -	STATE OF	306.91		0 TO 1414+17.0 DULE OF QUANTITIES		TAL SHEET EETS NO.
862				Mainline 		306.91	Sta. 1380+41.0	0 TO 1414+17.0	-	
862				Mainlino		306 01	Sta 1380±41 ∩	0 TO 1414+17 0	White Outside Edge Line	
	2 69 6	t = 1071 · 70 7		Mainine - Outside	SHOUTUEL	300.91	5.a. 1500741.U	0 10 1414-17.0	milite centertine akih nasil	
071	ı.u/ >	, ca. 1301±03.(Mainline - Outside		306.91		0 TO 1301+03.00 0 TO 1414+17.0	White Centerline Skip Dash	
11,030			00 TO 1301+03.00 00 TO 1370+36.07	Mainline - Outside	Shoulder	690.91		0 TO 1361+65.00	Yellow Inside Edge Line	
11,056			00 TO 1361+65.00	Mainline	Shourder	690.91		0 TO 1361+65.00	White Outside Edge Line	
			00 TO 1306+37.00	U-Turn- Gap Inside	Shoulder	690.91	Sta. 1285+65.0	0 TO 1361+65.00	White Centerline Skip Dash	
4,010			00 TO 1305+70.00	Mainline - Outside Mainline	Shoulder	WB (NB)	233/111011		<u> </u>	
•			08 TO 1274+93.8	Mainline - Outside		<u>F00T</u>	LOCATION		<u>REMARKS</u>	
2,206			33 TO 1244+98.0 38 TO 1274+95.8	Mainline - Outside		, 5555100 <u>51101(1-111(11)</u>	CERTAIN PROMISE TINO			
2,208		Sta 1222±80 <i>6</i>	55 TO 1244+98.0	Mainline - Outside		70300100 <u>SHORT-TERM</u>	PAVEMENT MARKING			
<u> </u>		LOCATION		Inside and Outside	Shoulders					
<u>F00T</u>	-	LOCATION		REMARKS		C	IOIAL			
64200116 SHOULDER	V VOIVIRTE	31K1P3, 10 1	INCH				TOTAL	0 10 10/2+30.00	i per mire	
64200116 CHOULDE	ם פווואטיי	CTDIDC 16 '	INCH				<u>LOCATION</u> Sta. 1285+65.0	0 TO 1672±56 00	1 per mile	
						<u>EACH</u>	LOCATION		REMARKS	
2,	, 350 TOTA	L				OUTOUSUS FERMANENTS	ONVET MANNERS, IT	<u>ı L l l</u>		
			00 TO 1665+75.00			66700305 <u>PERMANENT S</u>	HRVEY MARKEDS TV	PF II		
<u>EB (SE</u>		C+5 16E0+00 0	00 TO 1665.75 00							
		o.a. 1248+/5.(00 TO 1256+25.00			140,4/9	TOTAL			
			00 TO 1230+00.00			148,479	•	10 23790.70	VC31 MIEG EXIL VAIIH	
<u>WB (NE</u>		:+s 1001:75 (10 TO 1220:00 00				Sta. 0+65.04 Sta. 21+61.22		Rest Area Exit Ramp	
<u>Stage</u> wr (Ni							Sta. 6+83.04	TO 12+11 42	Rest Area Entrance Ramp	
<u>FOOT</u>		LOCATION		<u>REMARKS</u>		EB (SB) RE		10 22104.42	NOSE ATEC EXTENSITY	
FOOT	-	LOCATION		REMARKS			Sta. 0+08.10	TO 22+84.42	Rest Area Exit Ramp	
OSOOUSZO MODULAR	OLANE 3	CILLIN JIJIEM,	, ILMIONANI			870.10		TO 11+03.15	Rest Area Entrance Ramp	
63800920 MODULAR	GLARE S	CREEN SYSTEM	TEMPORARY			<u>WB (NB) RE</u> :				
						826.00		0 TO 1672+56.00	Mainline	
	103 IOIA	· L				938.00		0 TO 1668+43.00	Crossover- Gap Inside Shoulder	
			10/2/30/00	. Composity Tot, Type	- (Special) langent	3,712.00		0 TO 1659+05.00	Mainline	
			00 TO 1672+56.00		1 (Special) Tangent	845.50		0 TO 1640+49.00	Mainline - Outside Shoulder	
			00 TO 1672+56.00	TBT, Type 1 (Speci	al) Tangent	857.79		0 TO 1630+67.79	Mainline - Outside Shoulder	
LACI			00 TO 1672+56.00	Pipe underdrains		19,486.00		0 TO 1622+10.00	Mainline	
<u>EACH</u>	l	LOCATION		REMARKS		60.00		0 TO 1524+67.00	U-Turn- Gap Inside Shoulder	
OSSOCIOS <u>DELINEA</u>	10115					13,148.00		0 TO 1524+07.00	Mainline	
63500105 DELINEA	TORS					60.00		0 TO 1457+73.00 0 TO 1458+33.00	U-Turn- Gap Inside Shoulder	
						5,078.00		0 TO 1457+73.00	Mainline	
21	, 3311017					845.13		7 TO 1432+34.00	Mainline - Outside Shoulder	
<u></u>	, 551 TOTA		10 10 10 10 10 10 10 10 10 10 10 10 10 1	.nsrac shoulder		842.17		0 TO 1414+23.00 0 TO 1422+71.17	Mainline - Outside Shoulder	
1,264			00 TO 1630+70.00	Inside Shoulder		6,766.00		0 TO 1414+29.00	Mainline - Outside Shoulder	
1,264			00 TO 1630+66.00	Outside Shoulder		867.68		2 TO 1380+46.00	Mainline - Outside Shoulder	
			00 TO 1602+14.00	Inside Shoulder		876.07		0 TO 1301+00.00 0 TO 1370+36.07	Mainline - Outside Shoulder	
			00 TO 1572+87.00 00 TO 1601+64.00	Outside Shoulder		11,046.00		0 TO 1361+60.00	Mainline	
			00 TO 1531+52.00 00 TO 1572+87.00	Outside Shoulder		4,010.00		0 TO 1305+70.00 0 TO 1306+37.00	U-Turn- Gap Inside Shoulder	
			00 TO 1483+83.00 00 TO 1531+52.00	Outside Shoulder		4,010.00	Sta 1285±65 ∩	0 TO 1305+70.00	Mainline	
1,492			00 TO 1422+71.00 00 TO 1483+83.00	Outside Shoulder		EB (SB)	J.G. 1000743.U	0 10 10/2730.00	MATHEMA	
			00 TO 1422+73.00 00 TO 1422+71.00	Outside Shoulder		938.00 826.00		0 TO 1668+43.00 0 TO 1672+56.00	Crossover- Gap Inside Snoulder Mainline	
			00 TO 1370+36.00 00 TO 1422+73.00	Outside Shoulder Inside Shoulder		3,658.00 938.00		0 TO 1659+05.00 0 TO 1668+43.00	Mainline Crossover– Gap Inside Shoulder	
			00 TO 1370+36.00	Inside Shoulder		881.48			Mainline - Outside Shoulder	
1,490			00 TO 1339+06.00	Outside Shoulder		868.34		0 10 1630+58.34 2 TO 1640+76.00		
EB (SE		Sto 1224:16 0	10 TO 1220106 00	Outcide Chaulder		· ·		0 TO 1621+90.00 0 TO 1630+58.34	Mainline Mainline - Outside Shoulder	
		, .a. 1051+94.(JU TO 1035+/1,00	inside shoulder		19,446.00		0 TO 1524+67.00 0 TO 1621+90.00	Mainline	
			00 TO 1635+22.00 00 TO 1635+71.00	Inside Shoulder		13,148.00		0 TO 1524+67.00	U-Turn- Gap Inside Shoulder	
1,164			00 TO 1630+60.00 00 TO 1635+22.00	Outside Shoulder Outside Shoulder		13,148.00		0 TO 1458+33.00 0 TO 1524+07.00	Mainline	
1,263				Inside Shoulder Outside Shoulder		5,046.00		0 TO 1457+73.00 0 TO 1458+33.00	магитте U-Turn- Gap Inside Shoulder	
			00 TO 1606+16.00 00 TO 1630+59.00	Inside Shoulder		861.13 5,046.00		7 TO 1432+50.00 0 TO 1457+73.00	Mainline - Outside Shoulder Mainline	
1 1 () 1		1505.15		Outside Shoulder		854.17			Mainline - Outside Shoulder	
1,126 1,101	5.00 S	sta. 1594+86.0	00 TO 1606+12.00			0.5.4.1.5				

306.91	Sta. 1380+41.00	TO 1414+17.0	Yellow Inside Edge Line
1,721.82	Sta. 1432+50.00	TO 1621+90.0	White Centerline Skip Dash
1,721.82	Sta. 1432+50.00	TO 1621+90.0	White Outside Edge Line
1,721.82	Sta. 1432+50.00	TO 1621+90.0	Yellow Inside Edge Line
289.09	Sta. 1640+76.00	TO 1672+56.00	White Centerline Skip Dash
289.09	Sta. 1640+76.00	TO 1672+56.00	White Outside Edge Line
289.09	Sta. 1640+76.00	TO 1672+56.00	Yellow Inside Edge Line
EB (SB)			
690.45	Sta. 1285+65.00	TO 1361+60.00	White Centerline Skip Dash
690.45	Sta. 1285+65.00	TO 1361+60.00	White Outside Edge Line
690.45	Sta. 1285+65.00	TO 1361+60.00	Yellow Inside Edge Line
307.55	Sta. 1380+46.00	TO 1414+29.00	White Centerline Skip Dash
307.55	Sta. 1380+46.00	TO 1414+29.00	White Outside Edge Line
307.55	Sta. 1380+46.00	TO 1414+29.00	Yellow Inside Edge Line
1,725.09	Sta. 1432+34.00	TO 1622+10.00	White Centerline Skip Dash
1,725.09	Sta. 1432+34.00	TO 1622+10.00	White Outside Edge Line
1,725.09	Sta. 1432+34.00	TO 1622+10.00	Yellow Inside Edge Line
291.55	Sta. 1640+49.00	TO 1672+56.00	White Centerline Skip Dash
291.55	Sta. 1640+49.00	TO 1672+56.00	White Outside Edge Line
291.55	Sta. 1640+49.00	TO 1672+56.00	Yellow Inside Edge Line

70300150 SHORT TERM PAVEMENT MARKING REMOVAL

USER NAME = bartonrw

PLOT SCALE = 100.0000 ' / in.

PLOT DATE = May-06-2019 08:07:17 AM

18,071TOTAL

SQ FT	LOCATION		<u>REMARKS</u>
WB (NB)			
230.30	Sta. 1285+65.00	TO 1361+65.00	White Centerline Skip Dash
230.30	Sta. 1285+65.00	TO 1361+65.00	White Outside Edge Line
230.30	Sta. 1285+65.00	TO 1361+65.00	Yellow Inside Edge Line
102.30	Sta. 1380+41.00	TO 1414+17.00	White Centerline Skip Dash
102.30	Sta. 1380+41.00	TO 1414+17.00	White Outside Edge Line
102.30	Sta. 1380+41.00	TO 1414+17.00	Yellow Inside Edge Line
573.94	Sta. 1432+50.00	TO 1621+90.00	White Centerline Skip Dash
573.94	Sta. 1432+50.00	TO 1621+90.00	White Outside Edge Line
573.94	Sta. 1432+50.00	TO 1621+90.00	Yellow Inside Edge Line
96.36	Sta. 1640+76.00	TO 1672+56.00	White Centerline Skip Dash
96.36	Sta. 1640+76.00	TO 1672+56.00	White Outside Edge Line
96.36	Sta. 1640+76.00	TO 1672+56.00	Yellow Inside Edge Line
EB (SB)			
230.15	Sta. 1285+65.00	TO 1361+60.00	White Centerline Skip Dash
230.15	Sta. 1285+65.00	TO 1361+60.00	White Outside Edge Line
230.15	Sta. 1285+65.00	TO 1361+60.00	Yellow Inside Edge Line
102.52	Sta. 1380+46.00	TO 1414+29.00	White Centerline Skip Dash
102.52	Sta. 1380+46.00	TO 1414+29.00	White Outside Edge Line
102.52	Sta. 1380+46.00	TO 1414+29.00	Yellow Inside Edge Line
575.03	Sta. 1432+34.00	TO 1622+10.00	White Centerline Skip Dash
575.03	Sta. 1432+34.00	TO 1622+10.00	White Outside Edge Line
575.03	Sta. 1432+34.00	TO 1622+10.00	Yellow Inside Edge Line
97.18	Sta. 1640+49.00	TO 1672+56.00	White Centerline Skip Dash
97.18	Sta. 1640+49.00	TO 1672+56.00	White Outside Edge Line
97.18	Sta. 1640+49.00	TO 1672+56.00	Yellow Inside Edge Line
6,024 TC	DTAL		

DESIGNED -

DRAWN -

CHECKED -

DATE

REVISED -

REVISED -

REVISED -

REVISED -

							F.A.I. RTE.	SECT	ΓΙΟΝ		COUNTY	TOTAL SHEETS	SHEI NO
	SC	HEDU	JLE	OF QU	ANIIIIE	:S	74	(37-3,4	4)RS-2		HENRY	142	40
											CONTRACT	NO. 64	1C06
SHEET	6	OF	13	SHEETS	STA.	TO STA.			ILLINOIS	FFD A	D PROJECT		

WD (IND)			
663.77	Sta. 1220+16.53	TO 1226+80.30	1-Yellow Solid Inside Edge Line
390.65	Sta. 1222+89.65	TO 1226+80.30	1-White Solid Outside Edge Line
3,635.48	Sta. 1226+80.30	TO 1244+98.04	2-White Solid Outside Edge Line
86,912.98	Sta. 1226+80.30	TO 1661+36.79	2-Yellow Solid Inside Edge Line
686.34	Sta. 1244+98.04	TO 1251+84.38	1-White Solid Outside Edge Line
4,623.34	Sta. 1251+84.38	TO 1274+96.05	2-White Solid Outside Edge Line
569.03	Sta. 1274+96.05	TO 1280+65.08	1-White Solid Outside Edge Line
76,143.42	Sta. 1280+65.08	TO 1661+36.79	2-White Solid Outside Edge Line
314.02	Sta. 1661+36.79	TO 1664+50.81	1-White Solid Outside Edge Line
1,489.25	Sta. 1661+36.79	TO 1676+26.04	1-Yellow Solid Inside Edge Line
EB (SB)			
2,605.17	Sta. 1195+35.83	TO 1221+41.00	1-White Solid Outside Edge Line
723.76	Sta. 1219+56.54	TO 1226+80.30	1-Yellow Solid Inside Edge Line
1,078.60	Sta. 1221+41.00	TO 1226+80.30	2-White Solid Outside Edge Line
2,533.19	Sta. 1226+80.30	TO 1252+13.49	1-White Solid Outside Edge Line
877.28	Sta. 1661+36.79	TO 1670+14.07	1-White Solid Outside Edge Line
777.28	Sta. 1661+36.79	TO 1669+14.07	1-Yellow Solid Inside Edge Line
<u>Stage 2</u>			
WB (NB)			
829.04	Sta. 1284+65.00	TO 1292+94.04	1-White Solid Outside Edge Line
729.04	Sta. 1285+65.00	TO 1292+94.04	1-Yellow Solid Inside Edge Line
793.30	Sta. 1661+20.77	TO 1669+14.07	1-Yellow Solid Inside Edge Line
2,763.72	Sta. 1661+20.77	TO 1688+84.49	1-White Solid Outside Edge Line
119.49	Sta. 1688+84.49	TO 1689+24.32	3-White Solid Outside Edge Line
1,038.41	Sta. 1689+24.32	TO 1699+62.73	1-White Solid Outside Edge Line
EB (SB)			
3,994.04	Sta. 1253+00.00	TO 1292+94.04	1-Yellow Solid Inside Edge Line
443.93	Sta. 1288+50.11	TO 1292+94.04	1-White Solid Outside Edge Line
73,653.46	Sta. 1292+94.04	TO 1661+20.77	2-White Solid Outside Edge Line
73,653.46	Sta. 1292+94.04	TO 1661+20.77	2-Yellow Solid Inside Edge Line
330.21	Sta. 1661+20.77	TO 1664+50.98	1-White Solid Outside Edge Line
862.79	Sta. 1661+20.77	TO 1669+83.56	1-Yellow Solid Inside Edge Line
<u>Post Stage</u>			
WB (NB)			
574.00	Sta. 1285+65.00	TO 1291+39.00	1-White Solid Outside Edge Line
574.00	Sta. 1285+65.00	TO 1291+39.00	1-Yellow Solid Inside Edge Line
1,020.16	Sta. 1662+35.84	TO 1672+56.00	1-White Solid Outside Edge Line
1,020.16	Sta. 1662+35.84	TO 1672+56.00	1-Yellow Solid Inside Edge Line
EB (SB)			

1,020.16 Sta. 1662+35.84 TO 1672+56.00 1-White Solid Outside Edge Line 1,020.16 Sta. 1662+35.84 TO 1672+56.00 1-Yellow Solid Inside Edge Line

<u>REMARKS</u>

348,464 TOTAL

SCALE:

70300220 TEMPORARY PAVEMENT MARKING - LINE 4"

LOCATION

<u>FOOT</u>

<u>Stage 1</u> WB (NB)

0300240 <u>TEMPORARY PAVE</u>	<u>EMENT MARKING - LINE 6"</u>		70500100 <u>TEMPORARY ST</u>	EEL PLATE BEAM GU/	ARDRAIL, TYPE A	
<u> FOOT</u>	LOCATION	REMARKS	<u> FOOT</u>	LOCATION		REMARKS
Post Stage			WB (NB)			
WB (NB)			237.50	Sta. 1367+61.00	TO 1369+98.50	Inside Shoulder
	Sta. 1285+65.00 TO 1291+39.00	1-White Centerline Skip Dash	237.50	Sta. 1419+96.17	TO 1422+33.67	Inside Shoulder
	Sta. 1662+35.84 TO 1672+56.00	1-White Centerline Skip Dash	250.00	Sta. 1591+50.09	TO 1594+00.09	Inside Shoulder
EB (SB)			275.00	Sta. 1614+59.29	TO 1617+34.29	Inside Shoulder
	Sta. 1662+35.84 TO 1672+56.00	1-White Centerline Skip Dash	<u>EB (SB)</u>			
654 TOT			212.50	Sta. 1372+16.81	TO 1374+29.31	Inside Shoulder
000.	··· -		225.00	Sta. 1424+24.96	TO 1426+49.96	Inside Shoulder
			200.00	Sta. 1602+16.50	TO 1604+16.50	Inside Shoulder
00250 TEMPORARY PAVE	EMENT MARKING - LINE 8"		412.50	Sta. 1632+41.72	TO 1636+54.22	Inside Shoulder
<u> </u>				OTAL		
<u>FOOT</u>	LOCATION	REMARKS				
<u>Stage 1</u>	<u>= 0</u>					
<u>Stage 1</u> WB (NB)			70500665 <u>TEMPORARY TR</u>	AFFIC BARRIER TERM	MINAL, TYPE 6	
	Sta. 1249+84.38 TO 1251+84.38	1-White Outside Skip Dash				
	Sta. 1274+96.05 TO 1277+61.37	IL 81 Exit - 2-White Outside Gore Stripe	<u>EACH</u>	LOCATION		REMARKS
EB (SB)	5td, 12/4/50.05 TO 12//T01.5/	ie of Exit - 2-wille outstue dole stripe	<u>WB (NB)</u>			
	Sta. 1219+56.46 TO 1221+41.00	IL 81 Exit – 2-White Outside Gore Stripe	1	Sta. 1369+98.50	TO 1370+36.00	Inside Shoulder
	5.4. 1215,50.40 10 1221741.00	ie of Exit 2 willte outstue dole stripe	1	Sta. 1422+33.67		Inside Shoulder
Stage 2			EB (SB)			
<u>WB (NB)</u>	S. 1604.11 FO TO 1600.04 40	11 17 5 · · · · · · · · · · · · · · · · · ·	1	Sta. 1371+79.31	TO 1372+16.81	Inside Shoulder
	Sta. 1684+11.59 TO 1688+84.49	IL 17 Entrance - 2-White Outside Gore Stripe	1	Sta. 1423+87.46	TO 1424+24.96	Inside Shoulder
1,900 TOT	IAL		1	Sta. 1632+04.22	TO 1632+41.72	Inside Shoulder
				OTAL		
00260 <u>TEMPORARY PAVE</u>	EMENT MARKING - LINE 12"					
FOOT	LOCATION	REMARKS	72000100 <u>SIGN PANEL -</u>	TYPE 1		
Stage 1						
<u>WB (NB)</u>			<u>SQ_FT</u>	LOCATION	OFFSET (FT)	<u>REMARKS</u>
	Sta. 1274+96.05 TO 1277+61.37	IL 81 Exit - White Gore Diagonal Stripes	<u>EB (SB) Rest</u>			
<u>EB (SB)</u>		or extra minute cover bragenar coverpes	1.50		34.88 RT	Reserved Parking
	Sta. 1219+56.46 TO 1221+41.00	IL 81 Exit - White Gore Diagonal Stripes		Sta. 15+10.75	34.88 RT	\$250 FINE
133 TOT			2 T	OTAL		
			72400100 REMOVE SIGN	PANEL ASSEMBLY -	TYPE A	
00100 <u>TEMPORARY CONC</u>	CRETE BARRIER		72400100 <u>KLMOVE STON</u>	I AIVEE ASSEMBLE 1 -	<u> </u>	
<u>FOOT</u>	LOCATION	REMARKS	<u>EACH</u>	LOCATION	OFFSET (FT)	<u>REMARKS</u>
EB (SB)			<u>EB (SB) Rest</u>			
	Sta. 1220+40.90 TO 1669+13.97			Sta. 15+10.75	32.51 RT	Reserved Parking Si
44,875.0 TOT	TAL		1T	OTAL		
			72501000 <u>TERMINAL MAR</u>	VED DIBECT ADDI	IED	
00200 <u>RELOCATE TEMPC</u>	ORARY CONCRETE BARRIER		,2301000 TENMINAL MAR	NEN - DINECT AFPE	ILD	
FOOT	LOCATION	DEMARKS	<u>EACH</u>	LOCATION	<u>REMARKS</u>	
<u>FOOT</u>	LOCATION	REMARKS	WB (NB)			
<u>WB (NB)</u>	Cto 1005:70 En TO 1660:00 00		1	Sta. 1344+52.43	Outside Shou	lder
	Sta. 1285+78.50 TO 1669+83.29		1	Sta. 1374+40.49	Outside Shou	lder
38,412.5TOT	IAL		1	Sta. 1375+02.99	Inside Shoul	der
			1	Sta. 1426+38.61	Outside Shou	lder
			1	Sta. 1427+13.64	Inside Shoul	der
	<u>, </u>					Text.
USER NAME	DESIGNED - DRAWN -	REVISED - STATE OF ILL	INOIS	SCHEDII	LE OF QUANTITIES	F.A.I. SE

MODEL: Default

1 Sta. 1481+05.16	Outside Shoulder	3,376.00	Sta. 1380+41.00 TO 1414+17.0	1-White Solid Outside Edge Line
1 Sta. 1534+53.99	Outside Shoulder	3,376.00	Sta. 1380+41.00 TO 1414+17.00	1-Yellow Solid Inside Edge Line
1 Sta. 1580+11.74	Outside Shoulder	18,940.00	Sta. 1432+50.00 TO 1621+90.00	1-White Solid Outside Edge Line
1 Sta. 1606+87.31	Outside Shoulder	18,940.00	Sta. 1432+50.00 TO 1621+90.00	1-Yellow Solid Inside Edge Line
1 Sta. 1607+26.00	Inside Shoulder	50.00	Sta. 1548+04.68 TO 1550+04.68	
1 Sta. 1634+44.02	Outside Shoulder	3,180.00	Sta. 1640+76.00 TO 1672+56.00	·
1 Sta. 1635+18.97	Inside Shoulder	3,180.00	Sta. 1640+76.00 TO 1672+56.00	1-Yellow Solid Inside Edge Line
EB (SB)		EB (SB)		
1 Sta. 1320+14.13	Outside Shoulder	184.54	Sta. 1219+56.46 TO 1221+41.00	1-Yellow Solid Inside Edge Line
1 Sta. 1366+98.57	Inside Shoulder	7,595.00	Sta. 1285+65.00 TO 1361+60.00	1-White Solid Outside Edge Line
1 Sta. 1367+86.01	Outside Shoulder	7,595.00	Sta. 1285+65.00 TO 1361+60.00	1-Yellow Solid Inside Edge Line
1 Sta. 1418+95.00	Outside Shoulder	3,383.00	Sta. 1380+46.00 TO 1414+29.00	_
1 Sta 1419+47.63	Inside Shoulder	3,383.00	Sta. 1380+46.00 TO 1414+29.00	· · · · · · · · · · · · · · · · · · ·
1 Sta. 1466+57.53	Outside Shoulder	18,976.00	Sta. 1432+34.00 TO 1622+10.00	j
				j
1 Sta. 1515+18.42	Inside Shoulder	18,976.00	Sta. 1432+34.00 TO 1622+10.00	-
1 Sta. 1527+99.01	Outside Shoulder	3,207.00	Sta. 1640+49.00 TO 1672+56.00	3
1 Sta. 1562+24.00	Outside Shoulder	3,207.00	Sta. 1640+49.00 TO 1672+56.00	1-Yellow Solid Inside Edge Line
1 Sta. 1590+23.84	Inside Shoulder	WB (NB) Rest	<u>Area</u>	
1 Sta. 1591+35.86	Outside Shoulder	435.05	Sta. 6+68.10 TO 11+03.15	1-White Solid Outside Edge Line
1 Sta. 1616+55.03	Outside Shoulder	435.05	Sta. 6+68.10 TO 11+03.15	1-Yellow Solid Inside Edge Line
1 Sta. 1627+65.54	Outside Shoulder	108.48	Sta. 11+03.15 TO 12+11.98	1-White Solid Outside Edge Line
	Outside Shoulder			·
25 TOTAL		926.54	Sta. 11+03.15 TO 20+54.6	1-Yellow Solid Inside Edge Line
		245.37	Sta. 11+78.82 TO 14+31.91	1-White Solid Outside Edge Line
		81.22	Sta. 11+77.82 TO 12+71.38	1-Yellow Solid Inside Edge Line
72800100 TELESCOPING STEEL SIGN SUPPORT		270.00	Sta. 12+36.68 TO 13+39.33	1-White Solid Line- 27' Parking Stalls
		286.00	Sta. 12+94.04 TO 14+08.14	1-White Solid Line- 26' Parking Stalls
<u>FOOT</u> <u>LOCATION</u>	OFFSET (FT) REMARKS	158.15	Sta. 13+50.91 TO 14+20.18	1-Yellow Solid Line- No Parking Zone
EB (SB) Rest Area		110.19	Sta. 14+18.34 TO 15+30.76	1-Yellow Solid Inside Edge Line
	24 00 DT Decerved Darking Cian		Sta. 14+20.18 TO 20+54.55	1-White Solid Outside Edge Line
12.00 Sta. 15+10.75	34.88 RT Reserved Parking Sign			-
12 TOTAL		339.71	Sta. 14+29.44 TO 15+74.85	1-Yellow Solid Line- No Parking Zone
		1,080.00	Sta. 15+16.32 TO 17+82.74	1-White Solid Line- 90' Parking Stalls
		201.24	Sta. 17+81.03 TO 19+82.32	1-White Solid Outside Edge Line
78000100 THERMOPLASTIC PAVEMENT MARKING	- LETTERS AND SYMBOLS	422.28	Sta. 18+05.37 TO 18+99.57	2-Yellow Solid Line- Painted Median
		229.87	Sta. 20+54.55 TO 22+84.42	1-White Solid Outside Edge Line
<u>SQ_FT</u> <u>LOCATION</u>	OFFSET (FT) REMARKS	229.87	Sta. 20+54.55 TO 22+84.42	1-Yellow Solid Inside Edge Line
5 WB (NB) Rest Area		EB (SB) Rest		
3.10 Sta. 13+78.48	9.42 RT White Handicap Symbol	528.38	Sta. 6+83.04 TO 12+11.42	1-White Solid Outside Edge Line
원	· · ·	528.38	Sta. 6+83.04 TO 12+11.42	1-Yellow Solid Inside Edge Line
3.10 Sta. 14+05.72	9.26 RT White Handicap Symbol			j j
3.10 Sta. 15+08.02	58.45 LT White Handicap Symbol		Sta. 12+11.42 TO 13+20.08	1-White Solid Outside Edge Line
3.10 Sta. 15+54.94	60.85 LT White Handicap Symbol	921.93	Sta. 12+11.42 TO 21+61.22	1-Yellow Solid Inside Edge Line
EB (SB) Rest Area		245.96	Sta. 12+78.14 TO 15+31.98	1-White Solid Outside Edge Line
3.10 Sta. 14+80.43	12.33 RT White Handicap Symbol	78.62	Sta 12+78 14 TO 13+68 06	1-Yellow Solid Inside Edge Line
3.10 Sta. 15+01.16	12.25 RT White Handicap Symbol		Sta. 13+37.27 TO 14+39.57	1-White Solid Line- 27' Parking Stalls
3.10 Sta. 16+10.72	57.31 LT White Handicap Symbol	286.00	Sta. 13+94.93 TO 15+08.89	1-White Solid Line- 26' Parking Stalls
3.10 Sta. 16+49.55	66.99 LT White Handicap Symbol		Sta. 14+51.09 TO 15+15.06	1-Yellow Solid Line- No Parking Zone
	oo.aa Ei wiiite Halluicap Symbol	677.67		1-White Solid Outside Edge Line
្នី 25 TOTAL				-
itrict		109.28	Sta. 15+20.40 TO 16+32.96	1-Yellow Solid Inside Edge Line
es(D):		333.17	Sta. 15+52.73 TO 16+75.24	1-Yellow Solid Line- No Parking Zone
ੈਂ 78000200 <u>THERMOPLASTIC PAVEMENT MARKING</u>	<u>- LINE 4"</u>	1,080.00	Sta. 16+19.15 TO 18+83.13	1-White Solid Line- 90' Parking Stalls
<u>Toda</u>		422.28	Sta. 19+05.75 TO 19+99.26	2-Yellow Solid Line- Painted Median
FOOT LOCATION	<u>REMARKS</u>	189.63	Sta. 19+08.06 TO 20+97.74	1-White Solid Outside Edge Line
WB (NB)	··-	237.54	Sta. 21+61.22 TO 23+98.76	1-White Solid Outside Edge Line
2,208.39 Sta. 1222+89.65 T	ΓΟ 1244+98.04 1-White Solid Outsid		Sta. 21+61.22 TO 23+98.76	1-Yellow Solid Inside Edge Line
<u> </u>				I Terrow Sorra Instac Eage Eine
13,696.40 Sta.1224+68.60 T		3	UTAL	
50.00 Sta. 1249+84.38 T	•			
01 0 044 67 04 1054 04 00 7	ΓΟ 1274+96.05 1-White Solid Outside	Edge Line		
हूँ 2,311.67 Sta.1251+84.38 T	FO 1361,65 OO 1 White Colid Outside	Edge Line		
2,311.6/ Sta.1251+84.38 I 8,099.92 Sta.1280+65.08 T	ΓΟ 1361+65.00 1-White Solid Outside	Eage Eine		·
8,099.92 Sta.1280+65.08 T		Tage Time		F.A.I I ITOTALISHEET
8,099.92 Sta.1280+65.08 T	SIGNED - REVISED - AWN - REVISED -	-	SCHEDULE OF DUANTITU	F.A.I. SECTION COUNTY TOTAL SHEET NO.
8,099.92 Sta.1280+65.08 T	SIGNED - REVISED -	STATE OF ILLINOIS DEPARTMENT OF TRANSPORTATION	SCHEDULE OF QUANTITII	74 (37-3,4)RS-2 HENRY 142 42
8,099.92 Sta.1280+65.08 T	REVISED - REVISED -	STATE OF ILLINOIS	SCHEDULE OF QUANTITIES SCALE: SHEET 8 OF 13 SHEETS STA.	

	PAVEMENT MARKING - LINE 6"				
	1001716	251112145			
<u>FOOT</u>	LOCATION	REMARKS			
<u>WB (NB)</u>	C. 1220.16 F2 T0 1205.65 00	1 111 1 1 1 1 1 1 1 1 1 1 1 1 1 1 1 1 1			
1,637.12	Sta. 1220+16.53 TO 1285+65.00	1-White Centerline Skip Dash	OA MODIETES USES	THANK DAVEMENT MADILING	
676.68	Sta. 1672+56.00 TO 1699+62.73	1-White Centerline Skip Dash 7800900	U4 MODIFIED URE	THANE PAVEMENT MARKING - LINE 4"	
<u>EB (SB)</u> 4,156.04	Sta. 1195+35.83 TO 1361+60.00	1-White Centerline Skip Dash	FOOT	LOCATION	REMARKS
		·	<u>FOOT</u>	LOCATION	REMARKS
845.75 4,744.00	Sta. 1380+46.00 TO 1414+29.00 Sta. 1432+34.00 TO 1622+10.00	1-White Centerline Skip Dash 1-White Centerline Skip Dash	<u>WB (NB)</u> 3,752.00	Sta. 1361+65.00 TO 1380+41.00	1-White Solid Outside Edge Line, 2 Coats
	Sta. 1640+49.00 TO 1672+56.00	1-White Centerline Skip Dash	3,752.00	Sta. 1361+65.00 TO 1380+41.00 Sta. 1361+65.00 TO 1380+41.00	•
801.75 12,862TC		1-white Centerline Skip Dash	3,752.00	Sta. 1301+63.00 TO 1300+41.00 Sta. 1414+17.00 TO 1432+50.00	1-Yellow Solid Inside Edge Line, 2 Coats 1-White Solid Outside Edge Line, 2 Coats
12,00210	TAL		3,666.00	Sta. 1414+17.00 TO 1432+50.00 Sta. 1414+17.00 TO 1432+50.00	1-Yellow Solid Inside Edge Line, 2 Coats
			3,772.00	Sta. 1621+90.00 TO 1640+76.00	1-White Solid Outside Edge Line, 2 Coats
NANSAA THERMODIASTIC	C PAVEMENT MARKING - LINE 8"		3,772.00	Sta. 1621+90.00 TO 1640+76.00	1-Yellow Solid Inside Edge Line, 2 Coats
000300 THERMOFLASTIC	Z FAVEMENT MARKING - LINE 8		EB (SB)	3ta. 1021+90.00 10 1040+70.00	1-Terrow Sorra Instac Lage Line, 2 Coats
<u> FOOT</u>	LOCATION	REMARKS	3,772.00	Sta. 1361+60.00 TO 1380+46.00	1-White Solid Outside Edge Line, 2 Coats
<u> </u>	LOCALION	IVEN-WINES	3,772.00	Sta. 1361+60.00 TO 1380+46.00	1-Yellow Solid Inside Edge Line, 2 Coats
<u>WB (NB)</u> 50.00	Sta. 1249+84.38 TO 1251+84.38	1-White Outside Skip Dash	3,772.00	Sta. 1414+29.00 TO 1432+34.00	1-White Solid Outside Edge Line, 2 Coats
756.24	Sta. 1274+96.05 TO 1278+74.17	IL 81 Exit - 2-White Outside Gore Stripe	3,610.00	Sta. 1414+29.00 TO 1432+34.00	1-Yellow Solid Inside Edge Line, 2 Coats
50.00	Sta. 1274+90.03 TO 1278+74.17 Sta. 1548+04.68 TO 1550+04.68	1-White Outside Skip Dash	3,678.00	Sta. 1622+10.00 TO 1640+49.00	1-White Solid Outside Edge Line, 2 Coats
735.84	Sta. 1540+04.00 TO 1550+04.00 Sta. 1568+43.23 TO 1572+11.15	Rest Area Exit - 2-White Outside Gore Stripe	3,678.00	Sta. 1622+10.00 TO 1640+49.00	1-Yellow Solid Inside Edge Line, 2 Coats
509.98	Sta. 1686+29.50 TO 1688+84.49	IL 17 Entrance - 2-White Outside Gore Stripe	44,500 TO		1 . c c do . r. a . r. a . r. a . c c c c
EB (SB)	3.3. 1000,25.50 10 1000,04.45	12 17 Energines 2 white outside doile stripe	77,30010	OTAL .	
713.90	Sta. 1477+27.04 TO 1480+83.99	Rest Area Exit - 2-White Outside Gore Stripe			
50.00	Sta. 1500+04.83 TO 1502+04.83	·	06 MODIFIED URF	THANE PAVEMENT MARKING - LINE 6"	
2,866 TO		700000			
_, , _			<u>FOOT</u>	LOCATION	REMARKS
			WB (NB)		
00600 <u>THERMOPLASTIC</u>	PAVEMENT MARKING - LINE 12"		938.00	Sta. 1361+65.00 TO 1380+41.00	1-White Centerline Skip Dash, 2 Coats
			916.50	Sta. 1414+17.00 TO 1432+50.00	1-White Centerline Skip Dash, 2 Coats
<u>FOOT</u>	LOCATION	REMARKS	943.00	Sta. 1621+90.00 TO 1640+76.00	1-White Centerline Skip Dash, 2 Coats
WB (NB)			EB (SB)		
182.69	Sta. 1274+96.05 TO 1278+74.17	IL 81 Exit - White Gore Diagonal Stripes	943.00	Sta. 1361+60.00 TO 1380+46.00	1-White Centerline Skip Dash, 2 Coats
176.48	Sta. 1568+43.23 TO 1572+11.15	Rest Area Exit - White Gore Diagonal Stripes		Sta. 1414+29.00 TO 1432+34.00	1-White Centerline Skip Dash, 2 Coats
EB (SB)					1-White Centerline Skip Dash, 2 Coats
	Sta. 1477+27.04 TO 1480+83.99	Rest Area Exit - White Gore Diagonal Stripes	5,563T0	OTAL	
WB (NB) Rest		V.I. N. B. I			
144.87	Sta. 13+50.91 TO 14+20.18	Yellow No Parking Zone Diagonal Stripes			
278.42	Sta. 14+29.44 TO 15+74.85	Yellow No Parking Zone Diagonal Stripes 781001	00 RAISED REFLEC	CTIVE PAVEMENT MARKER	
272.99	Sta. 18+05.37 TO 18+99.57	Yellow Painted Median Diagonal Stripes		1.0017121	2514246
EB (SB) Rest		V.I. N. B. I	EACH	LOCATION	REMARKS
	Sta. 14+51.09 TO 15+15.06	Yellow No Parking Zone Diagonal Stripes	<u>WB (NB)</u>		
125.82	C+= 15,50 70 TO 10:35 01	V-11 N- D1 7 D C:		C. 1330-16 E3 TO 1533 33 EE	
274.62	Sta. 15+52.73 TO 16+75.24	Yellow No Parking Zone Diagonal Stripes	600	Sta. 1220+16.53 TO 1699+62.73	Crystal Centerline Skip Dash
274.62 271.53	Sta. 19+05.75 TO 19+99.26	Yellow No Parking Zone Diagonal Stripes Yellow Painted Median Diagonal Stripes	600 20	Sta. 1274+96.05 TO 1278+74.17	IL 81 Exit - 2 Crystal outside gore stripes
274.62	Sta. 19+05.75 TO 19+99.26	· · · · · · · · · · · · · · · · · · ·	20 5	Sta. 1274+96.05 TO 1278+74.17 Sta. 1280+65.08 TO 1281+58.37	IL 81 Exit - 2 Crystal outside gore stripes Crystal outside shoulder
274.62 271.53	Sta. 19+05.75 TO 19+99.26	· · · · · · · · · · · · · · · · · · ·	20 5 20	Sta. 1274+96.05 TO 1278+74.17 Sta. 1280+65.08 TO 1281+58.37 Sta. 1568+43.23 TO 1572+11.15	IL 81 Exit - 2 Crystal outside gore stripes Crystal outside shoulder Rest Area Exit - 2 Crystal outside gore strip
274.62 271.53 1,908 TC	Sta. 19+05.75 TO 19+99.26 DTAL	Yellow Painted Median Diagonal Stripes	20 5 20 33	Sta. 1274+96.05 TO 1278+74.17 Sta. 1280+65.08 TO 1281+58.37	IL 81 Exit - 2 Crystal outside gore stripes Crystal outside shoulder
274.62 271.53 1,908 TC	Sta. 19+05.75 TO 19+99.26	Yellow Painted Median Diagonal Stripes	20 5 20 33 <u>EB (SB)</u>	Sta. 1274+96.05 TO 1278+74.17 Sta. 1280+65.08 TO 1281+58.37 Sta. 1568+43.23 TO 1572+11.15 Sta. 1568+43.23 TO 1574+87.55	IL 81 Exit - 2 Crystal outside gore stripes Crystal outside shoulder Rest Area Exit - 2 Crystal outside gore strip Crystal outside shoulder
274.62 271.53 1,908 TC	Sta. 19+05.75 TO 19+99.26 OTAL ASTIC PAVEMENT MARKING, TYPE B -	Yellow Painted Median Diagonal Stripes LINE 6"	20 5 20 33 <u>EB (SB)</u> 597	Sta. 1274+96.05 TO 1278+74.17 Sta. 1280+65.08 TO 1281+58.37 Sta. 1568+43.23 TO 1572+11.15 Sta. 1568+43.23 TO 1574+87.55 Sta. 1195+35.83 TO 1672+56.00	IL 81 Exit - 2 Crystal outside gore stripes Crystal outside shoulder Rest Area Exit - 2 Crystal outside gore strip Crystal outside shoulder Crystal Centerline Skip Dash
274.62 271.53 1,908 TO 03130 PREFORMED PLA FOOT	Sta. 19+05.75 TO 19+99.26 DTAL	Yellow Painted Median Diagonal Stripes	20 5 20 33 <u>EB (SB)</u> 597 33	Sta. 1274+96.05 TO 1278+74.17 Sta. 1280+65.08 TO 1281+58.37 Sta. 1568+43.23 TO 1572+11.15 Sta. 1568+43.23 TO 1574+87.55 Sta. 1195+35.83 TO 1672+56.00 Sta. 1474+30.74 TO 1480+83.99	IL 81 Exit - 2 Crystal outside gore stripes Crystal outside shoulder Rest Area Exit - 2 Crystal outside gore strip Crystal outside shoulder Crystal Centerline Skip Dash Crystal outside shoulder
274.62 271.53 1,908 TC 03130 PREFORMED PLA FOOT WB (NB)	Sta. 19+05.75 TO 19+99.26 OTAL ASTIC PAVEMENT MARKING, TYPE B - LOCATION	Yellow Painted Median Diagonal Stripes LINE 6" REMARKS	20 5 20 33 <u>EB (SB)</u> 597 33 18	Sta. 1274+96.05 TO 1278+74.17 Sta. 1280+65.08 TO 1281+58.37 Sta. 1568+43.23 TO 1572+11.15 Sta. 1568+43.23 TO 1574+87.55 Sta. 1195+35.83 TO 1672+56.00 Sta. 1474+30.74 TO 1480+83.99 Sta. 1477+27.04 TO 1480+83.99	IL 81 Exit - 2 Crystal outside gore stripes Crystal outside shoulder Rest Area Exit - 2 Crystal outside gore strip Crystal outside shoulder Crystal Centerline Skip Dash Crystal outside shoulder
274.62 271.53 1,908 TO 03130 PREFORMED PLA FOOT WB (NB) 1,900.00	Sta. 19+05.75 TO 19+99.26 OTAL ASTIC PAVEMENT MARKING, TYPE B - LOCATION Sta. 1285+65.00 TO 1361+65.00	Yellow Painted Median Diagonal Stripes LINE 6" REMARKS 1-White Centerline Skip Dash	20 5 20 33 <u>EB (SB)</u> 597 33 18 WB (NB) Rest	Sta. 1274+96.05 TO 1278+74.17 Sta. 1280+65.08 TO 1281+58.37 Sta. 1568+43.23 TO 1572+11.15 Sta. 1568+43.23 TO 1574+87.55 Sta. 1195+35.83 TO 1672+56.00 Sta. 1474+30.74 TO 1480+83.99 Sta. 1477+27.04 TO 1480+83.99 **Area*	IL 81 Exit - 2 Crystal outside gore stripes Crystal outside shoulder Rest Area Exit - 2 Crystal outside gore strip Crystal outside shoulder Crystal Centerline Skip Dash Crystal outside shoulder Rest Area Exit - 2 Crystal outside gore strip
274.62 271.53 1,908 TC 03130 PREFORMED PLA FOOT WB (NB) 1,900.00 844.00	Sta. 19+05.75 TO 19+99.26 OTAL ASTIC PAVEMENT MARKING, TYPE B - LOCATION Sta. 1285+65.00 TO 1361+65.00 Sta. 1380+41.00 TO 1414+17.00	Yellow Painted Median Diagonal Stripes LINE 6" REMARKS 1-White Centerline Skip Dash 1-White Centerline Skip Dash	20 5 20 33 <u>EB (SB)</u> 597 33 18 <u>WB (NB) Rest</u>	Sta. 1274+96.05 TO 1278+74.17 Sta. 1280+65.08 TO 1281+58.37 Sta. 1568+43.23 TO 1572+11.15 Sta. 1568+43.23 TO 1574+87.55 Sta. 1195+35.83 TO 1672+56.00 Sta. 1474+30.74 TO 1480+83.99 Sta. 1477+27.04 TO 1480+83.99 Sta. 6+68.10 TO 8+78.66	IL 81 Exit - 2 Crystal outside gore stripes Crystal outside shoulder Rest Area Exit - 2 Crystal outside gore strip Crystal outside shoulder Crystal Centerline Skip Dash Crystal outside shoulder
274.62 271.53 1,908 TC 03130 PREFORMED PLA FOOT WB (NB) 1,900.00 844.00 4,735.00	Sta. 19+05.75 TO 19+99.26 OTAL ASTIC PAVEMENT MARKING, TYPE B - LOCATION Sta. 1285+65.00 TO 1361+65.00 Sta. 1380+41.00 TO 1414+17.00 Sta. 1432+50.00 TO 1621+90.00	Yellow Painted Median Diagonal Stripes LINE 6" REMARKS 1-White Centerline Skip Dash 1-White Centerline Skip Dash 1-White Centerline Skip Dash	20 5 20 33 <u>EB (SB)</u> 597 33 18 <u>WB (NB) Rest</u> 6 EB (SB) Rest	Sta. 1274+96.05 TO 1278+74.17 Sta. 1280+65.08 TO 1281+58.37 Sta. 1568+43.23 TO 1572+11.15 Sta. 1568+43.23 TO 1574+87.55 Sta. 1195+35.83 TO 1672+56.00 Sta. 1474+30.74 TO 1480+83.99 Sta. 1477+27.04 TO 1480+83.99 **CArea Sta. 6+68.10 TO 8+78.66 **CArea	IL 81 Exit - 2 Crystal outside gore stripes Crystal outside shoulder Rest Area Exit - 2 Crystal outside gore strip Crystal outside shoulder Crystal Centerline Skip Dash Crystal outside shoulder Rest Area Exit - 2 Crystal outside gore strip Amber inside shoulder
274.62 271.53 1,908 TO 03130 PREFORMED PLA FOOT WB (NB) 1,900.00 844.00 4,735.00 795.00	Sta. 19+05.75 TO 19+99.26 OTAL ASTIC PAVEMENT MARKING, TYPE B - LOCATION Sta. 1285+65.00 TO 1361+65.00 Sta. 1380+41.00 TO 1414+17.00 Sta. 1432+50.00 TO 1621+90.00 Sta. 1640+76.00 TO 1672+56.00	Yellow Painted Median Diagonal Stripes LINE 6" REMARKS 1-White Centerline Skip Dash 1-White Centerline Skip Dash	20 5 20 33 <u>EB (SB)</u> 597 33 18 WB (NB) Rest 6 EB (SB) Rest	Sta. 1274+96.05 TO 1278+74.17 Sta. 1280+65.08 TO 1281+58.37 Sta. 1568+43.23 TO 1572+11.15 Sta. 1568+43.23 TO 1574+87.55 Sta. 1195+35.83 TO 1672+56.00 Sta. 1474+30.74 TO 1480+83.99 Sta. 1477+27.04 TO 1480+83.99 Sta. 6+68.10 TO 8+78.66 Area Sta. 6+83.04 TO 9+01.40	IL 81 Exit - 2 Crystal outside gore stripes Crystal outside shoulder Rest Area Exit - 2 Crystal outside gore strip Crystal outside shoulder Crystal Centerline Skip Dash Crystal outside shoulder Rest Area Exit - 2 Crystal outside gore strip
274.62 271.53 1,908 TC 203130 PREFORMED PLA FOOT WB (NB) 1,900.00 844.00 4,735.00 795.00 8,274 TC	Sta. 19+05.75 TO 19+99.26 OTAL ASTIC PAVEMENT MARKING, TYPE B - LOCATION Sta. 1285+65.00 TO 1361+65.00 Sta. 1380+41.00 TO 1414+17.00 Sta. 1432+50.00 TO 1621+90.00 Sta. 1640+76.00 TO 1672+56.00 OTAL	Yellow Painted Median Diagonal Stripes LINE 6" REMARKS 1-White Centerline Skip Dash	20 5 20 33 <u>EB (SB)</u> 597 33 18 <u>WB (NB) Rest</u> 6 EB (SB) Rest	Sta. 1274+96.05 TO 1278+74.17 Sta. 1280+65.08 TO 1281+58.37 Sta. 1568+43.23 TO 1572+11.15 Sta. 1568+43.23 TO 1574+87.55 Sta. 1195+35.83 TO 1672+56.00 Sta. 1474+30.74 TO 1480+83.99 Sta. 1477+27.04 TO 1480+83.99 Sta. 6+68.10 TO 8+78.66 Area Sta. 6+83.04 TO 9+01.40	IL 81 Exit - 2 Crystal outside gore stripes Crystal outside shoulder Rest Area Exit - 2 Crystal outside gore strip Crystal outside shoulder Crystal Centerline Skip Dash Crystal outside shoulder Rest Area Exit - 2 Crystal outside gore strip Amber inside shoulder Amber inside shoulder
274.62 271.53 1,908 TC 203130 PREFORMED PLA FOOT WB (NB) 1,900.00 844.00 4,735.00 795.00 8,274 TC	Sta. 19+05.75 TO 19+99.26 OTAL ASTIC PAVEMENT MARKING, TYPE B - LOCATION Sta. 1285+65.00 TO 1361+65.00 Sta. 1380+41.00 TO 1414+17.00 Sta. 1432+50.00 TO 1621+90.00 Sta. 1640+76.00 TO 1672+56.00	Yellow Painted Median Diagonal Stripes LINE 6" REMARKS 1-White Centerline Skip Dash 1-White Centerline Skip Dash 1-White Centerline Skip Dash	20 5 20 33 EB (SB) 597 33 18 WB (NB) Rest 6 EB (SB) Rest 6 1,338 TO	Sta. 1274+96.05 TO 1278+74.17 Sta. 1280+65.08 TO 1281+58.37 Sta. 1568+43.23 TO 1572+11.15 Sta. 1568+43.23 TO 1574+87.55 Sta. 1195+35.83 TO 1672+56.00 Sta. 1474+30.74 TO 1480+83.99 Sta. 1477+27.04 TO 1480+83.99 Sta. 6+68.10 TO 8+78.66 Area Sta. 6+83.04 TO 9+01.40	IL 81 Exit - 2 Crystal outside gore stripes Crystal outside shoulder Rest Area Exit - 2 Crystal outside gore strip Crystal outside shoulder Crystal Centerline Skip Dash Crystal outside shoulder Rest Area Exit - 2 Crystal outside gore strip Amber inside shoulder Amber inside shoulder Amber inside shoulder

78100200 <u>TEMPORARY</u>	RAISED REFLECTIVE PA	VEMENT MARKER		78300200 RAISED REFLE	CTIVE PAVEMENT MARI	KER REMOVAL			
EACH	LOCATION		REMARKS	EACH	LOCATION				
Stage 1				WB (NB)	C+-1220-1C F2	TO1000102 72	Carretal Cambauli	na Chin Danh	
EB (SB)	37 Sta. 1219+56.54	TO 1226190 20	Crystal outside should	600 r 20	Sta1220+16.53 Sta1274+96.05	TO1699+62.73 TO1278+74.17	Crystal Centerli	rystal outside gore	ctrinoc
			,	5	Sta1274+90.03	TO1278+74.17	Crystal outside		stripes
			Amber inside shoulder Crystal outside should				•	2 Crystal outside	goro strings
	9 Sta. 1661+36.65 9 Sta. 1661+36.65		Amber inside shoulder	r 20 33	Sta1568+43.23 Sta1568+43.23	TO1572+11.15 TO1574+87.55	Crystal outside	•	gore stripes
_	19 5ta, 1001+30,03	10 1009+14.07	Amber inside shoulder	EB (SB)	3(a1)00+43,23	1013/4+6/.33	Crystar outside	SilouTuer	
<u>Stage 2</u> WB (NB)				597	Sta1195+35.83	TO1672+56.00	Crystal Centerli	na Skin Dash	
	66 Sta. 1285+78.37	TO 1202+9/ 0/	Crystal outside should		Sta1199+39.09	TO1480+83.99	Crystal outside		
	66 Sta. 1285+78.37		Amber inside shoulder	18	Sta1474+30.74 Sta1477+27.04	TO1480+83.99		2 Crystal outside	nore strines
_	0 Sta. 1203+70.37		Crystal outside should			101400103.33	Nest Area Exit	2 Crystar outstac	gore stripes
	0 Sta. 1661+20.74		Amber inside shoulder	6	Sta6+68.10	TO8+78.66	Amber inside sho	ulder	
	<u>0</u> 4 TOTAL	10 1003111.07	, who critistiae shoulder	EB (SB) Rest		100170100	7111501 11151 40 5110		
30	TTOTAL			6	Sta6+83.04	TO9+01.40	Amber inside sho	ulder	
78200005 GUARDRAIL	REFLECTORS, TYPE A			- 71					
<u>EACH</u> <u>WB (NB</u>)	LOCATION		REMARKS	X0322288 MEDIAN CLOSU	RE				
	9 Sta. 1326+89.93	TO 1344+52.43	Outside Shoulder	EACH	LOCATION	REMARKS			
	4 Sta. 1371+78.00		Outside Shoulder	1	Sta. 1223+00.00		ng at existing cros	sover	
	5 Sta. 1371+78.00	TO 1375+02.99	Inside Shoulder	1	Sta. 1663+73.99	New crossove			
	4 Sta. 1423+88.62	TO 1426+38.61	Outside Shoulder		DTAL				
	5 Sta. 1423+88.62	TO 1427+13.64	Inside Shoulder						
	6 Sta. 1473+25.97	TO 1481+05.16	Outside Shoulder						
	7 Sta. 1525+79.07	TO 1534+53.99	Outside Shoulder	X0322936 REMOVE EXIST	NG FLARED END SEC	TION			
	8 Sta. 1566+76.23	TO 1579+01.00	Outside Shoulder						
	8 Sta. 1593+87.59	TO 1607+26.00	Inside Shoulder	EACH	LOCATION	OFFSET (FT)	<u>REMARKS</u>		
	7 Sta. 1596+88.50	TO 1608+87.31	Outside Shoulder	1	Sta. 1539+86.96	100.33 LT	Salvage the grat	e for reuse	
	8 Sta. 1617+21.79	TO 1630+59.00	Inside Shoulder		DTAL				
	8 Sta. 1617+70.48	TO 1630+59.00	Outside Shoulder						
	4 Sta. 1631+94.00	TO 1634+44.02	Outside Shoulder						
	5 Sta. 1631+94.00	TO 1635+18.97	Inside Shoulder	X0324589 <u>PIPE UNDERDR</u>	AIN OUTLET EXTENSION	<u>ON FOR 4" PIPE</u>			
EB (SB)									
1	0 Sta. 1320+14.13	TO 1340+23.82	Outside Shoulder	<u>EACH</u>	LOCATION		<u>REMARKS</u>		
	5 Sta. 1366+98.57	TO 1370+36.00	Inside Shoulder	WB (NB)					
	4 Sta. 1367+86.01	TO 1370+36.00	Outside Shoulder	35	Sta. 1285+65.00	TO 1672+56.00	If Needed		
	5 Sta. 1418+95.00	TO 1422+70.00	Outside Shoulder	EB (SB)					
	5 Sta. 1419+47.63		Inside Shoulder	35	Sta. 1285+65.00	TO 1672+56.00	If Needed		
	8 Sta. 1466+57.53		Outside Shoulder	70 T	DTAL				
	6 Sta. 1527+99.01		Outside Shoulder						
	8 Sta. 1562+24.00		Outside Shoulder						
	7 Sta. 1590+23.84		Inside Shoulder	X0326650 <u>FILLING EXIS</u>	TING RUMBLE STRIP				
	7 Sta. 1591+35.86		Outside Shoulder						
	8 Sta. 1615+18.42		Inside Shoulder	<u>FOOT</u>	LOCATION		<u>REMARKS</u>		
	6 Sta. 1616+55.03		Outside Shoulder	<u>Stage 1</u>					
	4 Sta. 1627+65.54		Outside Shoulder	WB (NB)					
	<u>4</u> Sta. 1632+06.11	10 1634+68.79	Inside Shoulder	2,208.39	Sta 1222+89 65		Outside Shoulder		
17	'5 TOTAL			177.00	Sta. 1224+68.60		Inside Shoulder		
				2,311.46	Sta. 1251+84.38		Outside Shoulder		
				8,970.99	Sta 1280+65 08		Outside Shoulder		
				5,092.85	Sta. 1371+78.32	IO 1422+71.17	Outside Shoulder		
	USER NAME = bartonrw	DESIGNED -	REVISED -					F.A.I. SECTION	COUNTY TOTAL S
	USER NAME = bartonrw PLOT SCALE = 100.0000 ' / in.	DESIGNED - DRAWN - CHECKED -	REVISED - REVISED - REVISED -	STATE OF ILLINOIS DEPARTMENT OF TRANSPORTATION		SCHEDULE OF QUA	NTITIES	F.A.I. SECTION RTE. 74 (37-3,4)RS-2	COUNTY TOTAL SHEETS HENRY 142 CONTRACT NO. 64C

	USER NAME = bartonrw	DESIGNED -	REVISED -	!		F.A.I. RTE. SECTION COUNTY TOTAL SHEETS NO.
						Trans Curr
26,300	TOTAL			4,305.81	Sta. 1226+80.30 TO 1291+39.01	2-Yellow Solid Inside Edge Line
29.63	_	TO 1663+24.72	1-Yellow Solid Inside Edge Line	1,211.83	Sta. 1226+80.30 TO 1244+98.04	5
84.78			1-White Centerline Skip Dash	130.22	Sta. 1222+89.65 TO 1226+80.30	3
EB (SB)				221.26	Sta. 1220+16.53 TO 1226+80.30	3
69.84	Sta. 1667+04.55	TO 1669+14.07	1-Yellow Solid Inside Edge Line	WB (NB)		
<u>WB (NB)</u>				<u> After Stage</u>	<u>1</u>	
<u>Stage 2</u>				<u>SQ_FT</u>	LOCATION	REMARKS
12.50	Sta. 1669+14.07	TO 1670+14.07	1-White Centerline Skip Dash			
69.84	Sta. 1667+04.55	TO 1669+14.07	1-Yellow Solid Inside Edge Line	X7030005 <u>TEMPORARY PA</u>	VEMENT MARKING REMOVAL	
EB (SB)						
749.57	Sta. 1640+76.00	TO 1663+24.72	1-Yellow Solid Inside Edge Line			
791.60	Sta. 1640+76.00	TO 1664+50.81	1-White Solid Outside Edge Line	3 T	OTAL	
397.50	Sta. 1640+76.00	TO 1672+56.00	1-White Centerline Skip Dash	1	Sta. 15+06.61 22.5 RT	
161.10	Sta. 1568+43.23	TO 1572+11.15	IL 81 Exit - White Gore Diagonal Stripes	1	Sta. 14+87.70 22.8 RT	
490.56			IL 81 Exit - 2-White Outside Gore Stripe	<u>EB (SB) Rest</u>	Area	
2,395.1		TO 1621+90.00	1-White Solid Outside Edge Line		Sta. 12+46.03 24.6 RT	
33.33			1-White Outside Skip Dash	<u>WB (NB) Rest</u>		
6,313.33			1-Yellow Solid Inside Edge Line	<u>EACH</u>	LOCATION OFFSET (F)	REMARKS
3,601.54			1-White Solid Outside Edge Line	<u></u>		
	Sta. 1330+41.00		1-White Centerline Skip Dash	X6024503 INLETS TO BF	ADJUSTED WITH NEW FRAME AND GRA	TE (SPECIAL)
1,143.00			1-Yellow Solid Inside Edge Line			
1,143.00			1-White Solid Outside Edge Line	11,3511	OIAL	
428.63			1-Yellow Solld Inside Edge Line 1-White Centerline Skip Dash	11,331T		1 willte centerrine akih nasil
2,533.33			1-Yellow Solid Inside Edge Line	408.13	Sta. 1253+00.00 TO 1285+65.00	1-White Centerline Skip Dash
2,533.33			1-White Solid Outside Edge Line	EB (SB)	3:4. 1000/25.50 10 1000/04.49	12 17 Entrance 2 milite outside dore stripe
<u>wb (Nb)</u> 950.00	Sta. 1285+65.00	TO 1361+65 00	1-White Centerline Skip Dash	339.99	Sta. 1686+29.50 TO 1688+84.49	·
<u>Stage 1</u> WB (NB)				<u>WB (NB)</u> 292.09	Sta. 1676+26.04 TO 1699+62.73	1-White Centerline Skip Dash
Stage 1	LOCATION		REMARKS	<u>Stage 2</u> WR (NR)		
SO ET			DEMADKC	61.51 Stage 2	J.a. 1219∓30.40 ∪ 1221+41.00	1-Terrow Sorra Instae Eage Line
PAVEMENT M	ANNING KEMUVAL - GRI	און ד חאו			Sta. 1195+35.83 TO 1246+07.70 Sta. 1219+56.46 TO 1221+41.00	·
DAMENT M	ARKING REMOVAL - GRI	ND I NG		633.98	Sta. 1195+35.83 TO 1246+07.70	1-White Centerline Skip Dash
				46.26 <u>EB (SB)</u>	3.a. 10/2+30.00 10 16/6+26.04	1-white centerrine Skip Dash
48,/66	TOTAL			628.67 46.26	Sta. 1621+90.00 TO 1640+76.00 Sta. 1672+56.00 TO 1676+26.04	
215 14 48,766	_	10 1004+50.98	Outside Shoulder	628.67	Sta. 1621+90.00 TO 1640+76.00 Sta. 1621+90.00 TO 1640+76.00	
				235.75 628.67	Sta. 1621+90.00 TO 1640+76.00 Sta. 1621+90.00 TO 1640+76.00	
845.50 88.88			Outside Shoulder Inside Shoulder	593.33 235.75	Sta. 1414+70.00 TO 1432+50.00	3
857.79			Outside Shoulder	593.33	Sta. 1414+70.00 TO 1432+50.00	5
845.13			Outside Shoulder	222.50	Sta. 1414+70.00 TO 1432+50.00	·
842.17			Outside Shoulder	625.33	Sta. 1361+65.00 TO 1380+41.00	3
867.68			Outside Shoulder	625.33	Sta. 1361+65.00 TO 1380+41.00	-
876.07			Outside Shoulder	234.50	Sta. 1361+65.00 TO 1380+41.00	
EB (SB)	1261.60.00	TO 1270:26 07		166.64	Sta. 1280+65.08 TO 1285+65.00	<u> </u>
209.52	Sta. 1667+04.55	TO 1669+14.07	Inside Shoulder	504.16	Sta. 1274+96.05 TO 1278+74.17	·
217.27			Inside Shoulder	770.56	Sta. 1251+84.38 TO 1274+96.05	3
WB (NB)				133.33	Sta. 1249+84.38 TO 1251+84.38	·
Stage 2				2,032.13	Sta. 1224+68.60 TO 1285+65.00	
209.52	Sta. 1667+04.55	TO 1669+14.07	Inside Shoulder	736.13	Sta. 1222+89.65 TO 1244+98.04	
184.46			Inside Shoulder	818.56	Sta. 1220+16.53 TO 1285+65.00	·
EB (SB)				WB (NB)		
3,256.29	Sta. 1631+94.52	TO 1664+50.81	Outside Shoulder	<u>Stage 1</u>		
187.50			Inside Shoulder	<u>SQ_FT</u>	LOCATION	<u>REMARKS</u>
5,847.85	Sta. 1572+10.49	TO 1630+58.34	Outside Shoulder			

MODEL: Default FILE NAME: pw://planroom.de

PLOT SCALE = 100.0000 ' / in.

PLOT DATE = May-06-2019 08:11:06 AM

CHECKED -

DATE

REVISED -

SCALE:

	SER NAME = bartonrw	DESIGNED -	REVISED -					F.A.I. RTE.	SECTION
	1 Sta. 1419+46.17	TO 1419+96.17	Inside Shoulder						
	1 Sta. 1367+11.00	TO 1367+61.00	Inside Shoulder						
<u>WB (NB)</u>	INSIDE SHOULDE	B	_		-,				- 3 -
<u>EACH</u>	LOCATION		<u>REMARKS</u>		3,207.00		TO 1672+56.00	1-Yellow Solid Inside	_
					3,207.00		TO 1672+56.00	1-White Solid Outside	
TEMPORARY	TRAFFIC BARRIER TER	MINAL, TYPE 1. SI	PECIAL (TANGENT)		18,976.00		TO 1622+10.00	1-Yellow Solid Inside	_
					18,976.00		TO 1414+29.00 TO 1622+10.00	1-White Solid Outside	_
00,57	JIOIAL				3,383.00		TO 1414+29.00	1-Yellow Solid Inside	_
	75 TOTAL	10 10/2130.00	1 10110W 30110 111310	ac Lage Line	7,393.00 3,383.00		TO 1361+60.00	1-Yellow Solid Inside 1-White Solid Outside	
340.0		TO 1672+56.00	1-Yellow Solid Insid	-	7,595.00 7,595.00		TO 1361+60.00 TO 1361+60.00		3
340.0		TO 1672+56.00	1-White Solid Outsid	•				1-Yellow Solid Inside 1-White Solid Outside	_
127.5		TO 1672+56.00	1-White Centerline S	Skin Dash	<u>EB (SB)</u> 184.54	Sta 1210:56 46	TO 1221+41.00	1-Yallow Solid Incide	2 Edgo !
EB (SB)		10 10/2+30,00	T-ICLIOM DOLLO IUSIO	ac Lage Line	3,180.00	5 t a 1 0 4 U + 7 b . 0 U	TO 1672+56.00	1-Yellow Solid Inside	. ⊏uge L
340.0		TO 1672+56.00	1-Yellow Solid Insid	•	3,180.00		TO 1672+56.00	1-White Solid Outside	
340.0		TO 1672+56.00	1-White Solid Outsid		50.00		TO 1550+04.68	1-White Outside Skip	
191.5		TO 1672+56.00	1-White Centerline S	•	18,940.00		TO 1621+90.00	1-Yellow Solid Inside	_
191.3		TO 1291+39.00	1-Yellow Solid Insid	=	18,940.00		TO 1621+90.00	1-White Solid Outside	
191.3		TO 1291+39.00	1-White Solid Outsid					1-Yellow Solid Inside	_
<u>wb (Nb)</u> 71.7	75 - Sta 1285±65 00	TO 1291+39.00	1-White Centerline S	Skin Dash	3,376.00		TO 1414+17.00		_
WB (NB)	<u>. Jeage</u>				8,099.92 3,376.00		TO 1361+65.00	1-White Solid Outside	_
After Pos		10 1003-03,30	I ICTION SOLIG THEFT	ac Lage Line	2,311.67 8,099.92		TO 1274+96.05 TO 1361+65.00	<pre>1-White Solid Outside 1-White Solid Outside</pre>	_
287.6		TO 1669+83.56	1-White Solid Outsion 1-Yellow Solid Inside		50.00		TO 1251+84.38	1-White Outside Skip	
24,551.1 110.0		TO 1661+20.77 TO 1664+50.98	2-Yellow Solid Insid		13,696.40		TO 1361+65.00	1-Yellow Solid Inside	_
24,551.1		TO 1661+20.77	2-White Solid Outsid		2,208.39		TO 1244+98.04	1-White Solid Outside	_
147.9		TO 1292+94.04	1-White Solid Outsid	=	<u>WB (NB)</u>	C+- 1222:00	TO 1244.00 04	1 White Collins	
					<u>FOOT</u>	LOCATION		<u>REMARKS</u>	
<u>EB (SB)</u> 1,331.3	25 Sta 1252100 00	TO 1292+94.04	1-Yellow Solid Insid	do Edgo Lino	FOOT	LOCATION		DEMARKS	
346.1	.4 Sta. 1689+24.32	TO 1699+62.73	1-White Solid Outsid	ue Euge Line	X7830070 GROOVING FOR	RECESSED PAVEMEN	I MARKING 5"		
26.5 346.1			3-White Solid Outsid	=	V7020070 CDOCVING 500	DECECCED DAYS	E MADIZING E"		
630.5		TO 1688+84.49		White Outside Gore Str	ıhe				
			1-Yellow Solid Insid		25 T(JIAL			
921.2 264.4		TO 1688+84.49	1-White Solid Outsid		3.10	Sta. 16+49.55	66.99 LT	White Handicap Symbol	
243.0 921.2		TO 1292+94.04		9	3.10	Sta. 16+10.72	57.31 LT	White Handicap Symbol	
		TO 1292+94.04 TO 1292+94.04	1-Yellow Solid Insid		3.10	Sta. 15+01.16	12.25 RT	White Handican Symbol	
<u>WB (NB)</u> 276.3	25 Sta 1294165 00	TO 1292+94.04	1-White Solid Outsid	de Edge Line	3.10	Sta.14+80.43	12.33 RT	White Handicap Symbol	
	<u>ge 2</u>				EB (SB) Rest		12 22 DT	White Headine Combal	
After Sta		10 1009-14.0/	T-ICLIOM SOLIG INST	ac Lage Line		Sta.15+54.94	0U.05 LI	White Handicap Symbol	
292.4		TO 1669+14.07	1-Yellow Solid Insid	•	3.10		60.85 LT		
292.4		TO 1670+14.07	1-White Solid Outsid		3.10	Sta. 14+03.72 Sta. 15+08.02	9.26 KT 58.45 LT	White Handicap Symbol	
844.4		TO 1252+13.49	1-White Solid Outsid		3.10	Sta. 13+78.48 Sta. 14+05.72	9.42 KT 9.26 RT	White Handicap Symbol	
359.5		TO 1226+80.30	2-White Solid Outsid	=	<u>WB (NB) Rest</u> 3.10	Sta. 13+78.48	9.42 RT	White Handicap Symbol	
92.3		TO 1221+41.00		Gore Diagonal Stripes	<u>SQ FT</u> <u>WB (NB) Rest</u>	LOCATION	OFFSET (FT)	<u>REMARKS</u>	
241.2 246.0		TO 1226+80.30 TO 1221+41.00	1-Yellow Solid Insid	e Outside Gore Stripe	CO 57	LOCATION	OFFCET (FT)	DEMARKS	
868.3		TO 1221+41.00	1-White Solid Outsid	•	X7830060 GROOVING FOR	RECESSED PAVEMEN	I MARKING, LETTER	S AND SYMBOLS	
EB (SB)	00 C+- 110F+2F 02	TO 1221-41 00	1 White Collid Outsid	do Edua Lina	V7020060 CD00VING F0D	DECECCED DAYEMENT	- MADICANO	S. AND. SYMBOLS	
510.2	28 Sta. 1660+95.20	TO 1676+26.04	1-Yellow Solid Insid	de Edge Line					
118.5		TO 1664+50.81	1-White Solid Outsid		8 TC	OTAL			
715.9		TO 1291+39.01	2-White Solid Outsid	_	1	Sta. 1636+54.22	TO 1637+04.22	Inside Shoulder	
39.8		TO 1277+61.37		Gore Diagonal Stripes	1	Sta. 1604+16.50		Inside Shoulder	
353.7		TO 1277+61.37		e Outside Gore Stripe	1	Sta. 1426+49.96		Inside Shoulder	
189.6		TO 1280+65.08	1-White Solid Outsid	3	1	Sta. 1374+29.31		Inside Shoulder	
1,541.1		TO 1274+96.05	2-White Solid Outsid		EB (SB)	INSIDE SHOULDER			
			·	•	<u>*</u>			marae andaraer	
33.3	33 Sta 1249+84 38	TO 1251+84 38	1-White Outside Skip	n Dach	1	Sta. 1614+09.29	TO 1614+59.29	Inside Shoulder	

MODEL: Default

STATE OF ILLINOIS
DEPARTMENT OF TRANSPORTATION

REVISED -

REVISED -

REVISED -

DRAWN -

CHECKED -

DATE

PLOT DATE = May-06-2019 08:11:25 AM

 SCHEDULE OF QUANTITIES
 RTE. RTE. RTE. 74

 SCALE:
 SHEET 12 OF 13 SHEETS STA. TO STA.
 TO STA.

WB (NB) Rest	Area		
435.05	Sta6+68.10	TO 11+03.15	1-White Solid Outside Edge Line
435.05	Sta6+68.10	TO 11+03.15	1-Yellow Solid Inside Edge Line
108.48	Sta11+03.15	TO 12+11.98	1-White Solid Outside Edge Line
926.54	Sta11+03.15	TO 20+54.55	1-Yellow Solid Inside Edge Line
245.37	Sta11+78.82	TO 14+31.91	1-White Solid Outside Edge Line
81.22	Sta11+77.82	TO 12+71.38	1-Yellow Solid Inside Edge Line
270.00	Sta12+36.68	TO 13+39.33	1-White Solid Line- 27' Parking Stalls
286.00	Sta12+94.04	TO 14+08.14	1-White Solid Line- 26' Parking Stalls
158.15	Sta13+50.91	TO 14+20.18	1-Yellow Solid Line- No Parking Zone
110.19	Sta14+18.34	TO 15+30.76	1-Yellow Solid Inside Edge Line
663.24	Sta14+20.18	TO 20+54.55	1-White Solid Outside Edge Line
339.71	Sta14+29.44	TO 15+74.85	1-Yellow Solid Line- No Parking Zone
1,080.00	Sta15+16.32	TO 17+82.74	1-White Solid Line- 90' Parking Stalls
201.24	Sta 17+81.03	TO 19+82.32	1-White Solid Outside Edge Line
422.28	Sta 18+05.37	TO 18+99.57	2-Yellow Solid Line- Painted Median
229.87	Sta 20+54.55	TO 22+84.42	1-White Solid Outside Edge Line
229.87	Sta 20+54.55	TO 22+84.42	1-Yellow Solid Inside Edge Line
<u>EB (SB) Rest</u>	<u>Ar e a</u>		
528.38	Sta6+83.04	TO 12+11.42	1-White Solid Outside Edge Line
528.38	Sta6+83.04	TO 12+11.42	1-Yellow Solid Inside Edge Line
108.75	Sta12+11.42	TO 13+20.08	1-White Solid Outside Edge Line
921.93	Sta 12+11 . 42	TO 21+61.22	1-Yellow Solid Inside Edge Line
245.96	Sta 12+78.14	TO 15+31.98	1-White Solid Outside Edge Line
78.62	Sta 12+78.14	TO 13+68.06	1-Yellow Solid Inside Edge Line
270.00	Sta13+37.27	TO 14+39.57	1-White Solid Line- 27' Parking Stalls
286.00	Sta13+94.93	TO 15+08.89	1-White Solid Line- 26' Parking Stalls
155.71	Sta14+51.09	TO 15+15.06	1-Yellow Solid Line- No Parking Zone
677.67	Sta 15+15.06	TO 21+61.22	1-White Solid Outside Edge Line
109.28	Sta 15+20.40	TO 16+32.96	1-Yellow Solid Inside Edge Line
333.17	Sta 15+52.73	TO 16+75.24	1-Yellow Solid Line- No Parking Zone
1,080.00	Sta 16+19.15	TO 18+83.13	1-White Solid Line- 90' Parking Stalls
422.28	Sta 19+05.75	TO 19+99.26	2-Yellow Solid Line- Painted Median
189.63	Sta19+08.06	TO 20+97.74	1-White Solid Outside Edge Line
237.54	Sta 21+61.22	TO 23+98.76	1-White Solid Outside Edge Line
237.54	Sta 21+61.22	TO 23+98.76	1-Yellow Solid Inside Edge Line
156,549 TO	TAL		

X7830074 GROOVING FOR RECESSED PAVEMENT MARKING 7"

<u>FOOT</u>	LOCATION		<u>REMARKS</u>	
WB (NB)				
1,637.12	Sta1220+16.53	TO1285+65.00	1-White Centerline	e Skip Dash
676.68	Sta 1672+56.00	TO1699+62.73	1-White Centerline	e Skip Dash
<u>EB (SB)</u>				
4,156.04	Sta1195+35.83	TO1361+60.00	1-White Centerline	Skip Dash
845.75	Sta1380+46.00	TO1414+29.00	1-White Centerline	e Skip Dash
4,744.00	Sta1432+34.00	TO1622+10.00	1-White Centerline	e Skip Dash
801.75	Sta1640+49.00	TO1672+56.00	1-White Centerline	Skip Dash
12,862 TO	TAL			

X7830076 GROOVING FOR RECESSED PAVEMENT MARKING 9"

<u>FOOT</u>	<u>LOCATION</u>		<u>REMARKS</u>
WB (NB)			
50.00	Sta1249+84.38	TO 1251+84.38	1-White Outside Skip Dash
756.24	Sta1274+96.05	TO 1278+74.17	IL 81 Exit - 2-White Outside Gore Stripe
50.00	Sta1548+04.68	TO 1550+04.68	1-White Outside Skip Dash
735.84	Sta1568+43.23	TO 1572+11.15	Rest Area Exit - 2-White Outside Gore Stripe
509.98	Sta1686+29.50	TO 1688+84.49	IL 17 Entrance - 2-White Outside Gore Stripe
EB (SB)			
713.90	Sta1477+27.04	TO 1480+83.99	Rest Area Exit - 2-White Outside Gore Stripe
50.00	Sta1500+04.83	TO 1502+04.83	1-White Outside Skip Dash
2 , 866 TOT	AL		

X7830078 GROOVING FOR RECESSED PAVEMENT MARKING 13"

<u>FOOT</u>	LOCATION		<u>REMARKS</u>
WB (NB)			
182.69	Sta 1274+96.05	TO 1278+74.17	IL 81 Exit - White Gore Diagonal Stripes
176.48	Sta 1568+43.23	TO 1572+11.15	Rest Area Exit - White Gore Diagonal Stripes
EB (SB)			
180.31	Sta 1477+27.04	TO 1480+83.99	Rest Area Exit - White Gore Diagonal Stripes
WB (NB) Rest	<u>Area</u>		
144.87	Sta 13+50.91	TO 14+20.18	Yellow No Parking Zone Diagonal Stripes
278.42	Sta 14+29.44	TO 15+74.85	Yellow No Parking Zone Diagonal Stripes
272.99	Sta 18+05.37	TO 18+99.57	Yellow Painted Median Diagonal Stripes
EB (SB) Rest	<u>Area</u>		
125.82	Sta 14+51.09	TO 15+15.06	Yellow No Parking Zone Diagonal Stripes
274.62	Sta 15+52.73	TO 16+75.24	Yellow No Parking Zone Diagonal Stripes
271.53	Sta 19+05.75	TO 19+99.26	Yellow Painted Median Diagonal Stripes
1,908 TO	ΓAL		

SLOTTED DRAIN 24" WITH VARIABLE SLOT

<u>FOOT</u>	LOCATION		OFFSET (FT)	<u>REMARKS</u>
162.65	Sta. 1664+33.31	TO 1665+95.96	0	
162 TO	T A I			

STATE OF ILLINOIS
DEPARTMENT OF TRANSPORTATION

		2020	00100															21101	.615	
STATION		EARTH EX	XCAVATION		EARTH	EXC ADJ FC	R SHRIKAGE	(25%)		EMBAN	KMENT			EARTHWORK	BALANCE*		TOPSO	IL FURNISH	AND PLACE	i , 4"
STATION		NB	S	В	N	В	S	В	N	В	5	SB	N	IB	S	SB	NE	3	S	SB
	OUTSIDE	INSIDE	INSIDE	OUTSIDE	OUTSIDE	INSIDE	INSIDE	OUTSIDE	OUTSIDE	INSIDE	INSIDE	OUTSIDE	OUTSIDE	INSIDE	INSIDE	OUTSIDE	OUTSIDE	INSIDE	INSIDE	OUTSIDE
I - 74	CU YD	CU YD	CU YD	CU YD	CU YD	CU YD	CU YD	CU YD	CU YD	CU YD	CU YD	CU YD	CU YD	CU YD	CU YD	CU YD	SQ YD	SQ YD	SQ YD	SQ YD
STA 1285+50.00 - STA 1295+00.00	0	828.93	1,030.35	0	0	621.69	772.76	0	0	434.11	558.00	0	0	187.58	214.76	0	0	1,383.44	1,581.67	0
STA 1285+65.00 - STA 1361+60.00	0	374.12	374.12	0	0	280.59	280.59	0	0	0	0	0	0	280.59	280.59	0	0	0	0	0
STA 1319+50.00 - STA 1345+00.00	177.06	0	0	188.81	132.79	0	0	141.61	98.15	0	0	53.93	34.64	0	0	87.69	3,474.72	0	0	2,285.11
STA 1366+50.00 - STA 1370+50.00	0	0	31.48	20.26	0	0	23.61	15.19	0	0	0	2.26	0	0	23.61	12.94	0	0	112.44	139.89
STA 1372+00.00 - STA 1375+50.00	23.70	31.20	0	0	17.78	23.40	0	0	0.22	0	0	0	17.56	23.40	0	0	174.83	77.61	0	0
STA 1380+41.00 - STA 1414+29.00	0	166.89	166.89	0	0	125.17	125.17	0	0	0	0	0	0	125.17	125.17	0	0	0	0	0
STA 1418+50.00 - STA 1423+00.00	0	0	40.74	40.07	0	0	30.56	30.06	0	0	0	0.63	0	0	30.56	29.43	0	0	72.56	238.83
STA 1424+00.00 - STA 1427+50.00	20.50	35.52	0	0	15.38	26.64	0	0	0.26	0	0	0	15.12	26.64	0	0	133.67	68.72	0	0
STA 1432+50.00 - STA 1622+10.00	0	933.96	933.96	0	0	700.47	700.47	0	0	0	0	0	0	700.47	700.47	0	0	0	0	0
STA 1466+00.00 - STA 1481+50.00	84.09	0	0	117.48	63.07	0	0	88.11	11.04	0	0	87.69	52.03	0	0	0.43	726.61	0	0	2,074.44
STA 1525+50.00 - STA 1535+00.00	89.22	0	0	54.91	66.92	0	0	41.18	112.13	0.93	0.93	44.18	-45.21	-0.93	-0.93	-3.00	1,926.17	13.89	13.89	1,169.33
STA 1561+50.00 - STA 1580+50.00	105.44	0	0	100.52	30.68	0	0	59.68	44.30	0	0	14.17	-13.62	0	0	45.51	822.78	0	0	731.50
STA 1589+50.00 - STA 1608+00.00	77.07	134.50	133.20	104.24	50.13	100.88	99.90	78.18	46.72	7.11	0.02	30.11	3.41	93.76	99.88	48.07	929.56	1,119.44	544.94	1,297.22
STA 1614+50.00 - STA 1630+50.00	107.15	134.31	185.50	96.56	80.36	100.74	139.13	72.42	100.63	7.94	2.04	72.78	-20.27	92.79	137.09	-0.36	1,572.33	1,115.44	1,023.22	1,295.11
STA 1632+00.00 - STA 1636+00.00	28.30	41.41	26.24	0	21.22	31.06	19.68	0	0.74	0	0	0	20.48	31.06	19.68	0	206.00	182.67	10.44	0
STA 1640+49.00 - STA 1672+56.00	0	157.97	157.97	0	0	118.48	118.48	0	0	0	0	0	0	118.48	118.48	0	0	0	0	0
STA 1660+00.00 - STA 1669+50.00	0	576.12	620.63	0	0	432.09	465.47	0	0	267.52	208.43	0	0	164.57	257.05	0	0	1173.33	1072.61	0
WB/NB REST AREA		<u> </u>																		
STA 10+78.00 - STA 20+80.00	3.48	17.63	0	0	2.61	13.22	0	0	0	0	0	0	2.61	13.22	0	0	53.78	295.00	0	0
EB/SB REST AREA																				
STA 11+86.00 - STA 21+86.00	0	0	18.55	4.48	0	0	13.91	3.36	0	0	0	0	0	0	13.91	3.36	0	0	278.08	87.33
STA 14+37.09 - STA 19+09.41	0	0	46.71	0	0	0	35.03	0	0	0	0	0	0	0	35.03	0	0	0	0	0
STA 18+94.44 - STA 19+81.14	0	0	0	16.81	0	0	0	12.61	0	0	0	0	0	0	0	12.61	0	0	0	0
SUB-TOTAL	716.02	3,432.56	3,766.35	744.14	480.94	2,574.42	2,824.76	542.40	414.19	717.61	769.41	305.74	66.75	1,856.81	2,055.35	236.66	10,020.44	5,429.56	4,709.86	9,318.7
TOTAL		8,1	660			6,	425			2,	210			4,:	220			29,4	1 79	

		2500	0210			2500	0400			2500	0500			2500	00600			2500	0750	
STATION		SEEDING,	CLASS 2A		NITR	OGEN FERTI	LIZER NUTI	RIENT	PHOSP	HORUS FERT	ILIZER NUT	TRIENT	POTAS	SSIUM FERT	ILIZER NUT	RIENT	MOW I NG			
STATION	N	IB	S	SB .	N	В	9	5B	N	В	S	SB	NB		SB		NB		SB	
	OUTSIDE	INSIDE	INSIDE	OUTSIDE	OUTSIDE	INSIDE	INSIDE	OUTSIDE	OUTSIDE	INSIDE	INSIDE	OUTSIDE	OUTSIDE	INSIDE	INSIDE	OUTSIDE	OUTSIDE	INSIDE	INSIDE	OUTSIDE
I - 74	ACRE	ACRE	ACRE	ACRE	POUND	POUND	POUND	POUND	POUND	POUND	POUND	POUND	POUND	POUND	POUND	POUND	ACRE	ACRE	ACRE	ACRE
STA 1285+50.00 - STA 1295+00.00	0	0.286	0.327	0	0	25.73	29.41	0	0	25.73	29.41	0	0	25.73	29.41	0	0	0.286	0.327	0
STA 1285+65.00 - STA 1361+60.00	0	0	0	0	0	0	0	0	0	0	0	0	0	0	0	0	0	0	0	0
STA 1319+50.00 - STA 1345+00.00	0.718	0	0	0.472	64.61	0	0	42.49	64.61	0	0	42.49	64.61	0	0	42.49	0.115	0	0	0.154
STA 1366+50.00 - STA 1370+50.00	0	0	0.023	0.029	0	0	2.09	2.60	0	0	2.09	2.60	0	0	2.09	2.60	0	0	0.023	0.029
STA 1372+00.00 - STA 1375+50.00	0.036	0.016	0	0	3.25	1.44	0	0	3.25	1.44	0	0	3.25	1.44	0	0	0.026	0.016	0	0
STA 1380+41.00 - STA 1414+29.00	0	0	0	0	0	0	0	0	0	0	0	0	0	0	0	0	0	0	0	0
STA 1418+50.00 - STA 1423+00.00	0	0	0.015	0.049	0	0	1.35	4.44	0	0	1.35	4.44	0	0	1.35	4.44	0	0	0.015	0.049
STA 1424+00.00 - STA 1427+50.00	0.028	0.014	0	0	2.49	1.28	0	0	2.49	1.28	0	0	2.49	1.28	0	0	0.028	0.014	0	0
STA 1432+50.00 - STA 1622+10.00	0	0	0	0	0	0	0	0	0	0	0	0	0	0	0	0	0	0	0	0
STA 1466+00.00 - STA 1481+50.00	0.150	0	0	0.429	13.51	0	0	38.57	13.51	0	0	38.57	13.51	0	0	38.57	0.039	0	0	0.326
STA 1525+50.00 - STA 1535+00.00	0.398	0.003	0.003	0.242	35.82	0.26	0.26	21.74	35.82	0.26	0.26	21.74	35.82	0.26	0.26	21.74	0.384	0.003	0.003	0.213
STA 1561+50.00 - STA 1580+50.00	0.170	0	0	0.151	15.30	0	0	13.60	15.30	0	0	13.60	15.30	0	0	13.60	0.148	0	0	0.073
STA 1589+50.00 - STA 1608+00.00	0.192	0.231	0.113	0.268	17.29	20.82	10.13	24.12	17.29	20.82	10.13	24.12	17.29	20.82	10.13	24.12	0.089	0.073	0.071	0.107
STA 1614+50.00 - STA 1630+50.00	0.325	0.230	0.211	0.268	29.24	20.74	19.03	24.08	29.24	20.74	19.03	24.08	29.24	20.74	19.03	24.08	0.034	0.106	0.155	0.127
STA 1632+00.00 - STA 1636+00.00	0.043	0.038	0.002	0	3.83	3.40	0.19	0	3.83	3.40	0.19	0	3.83	3.40	0.19	0	0.043	0.038	0.002	0
STA 1640+49.00 - STA 1672+56.00	0	0	0	0	0	0	0	0	0	0	0	0	0	0	0	0	0	0	0	0
STA 1660+00.00 - STA 1669+50.00	0	0.242	0.222	0	0	21.82	19.95	0	0	21.82	19.95	0	0	21.82	19.95	0	0	0.242	0.222	0
WB/NB REST AREA																				
STA 10+78.00 - STA 20+80.00	0.011	0.061	0	0	1.00	5.49	0	0	1.00	5.49	0	0	1.00	5.49	0	0	0.011	0.061	0	0
EB/SB REST AREA																				
STA 11+86.00 - STA 21+86.00	0	0	0.057	0.018	0	0	5.17	1.62	0	0	5.17	1.62	0	0	5.17	1.62	0	0	0.057	0.018
STA 14+37.09 - STA 19+09.41	0	0	0	0	0	0	0	0	0	0	0	0	0	0	0	0	0	0	0	0
STA 18+94.44 - STA 19+81.14	0	0	0	0	0	0	0	0	0	0	0	0	0	0	0	0	0	0	0	0
SUB - TOTAL	2.070	1.122	0.973	1.925	186.33	100.96	87.58	173.28	186.33	100.96	87.58	173.28	186.33	100.96	87.58	173.28	0.916	0.839	0.875	1.096
TOTAL		6.	25			5.	49			5	49			5	49			3.	75	

USER NAME = bartonrw

DESIGNED -REVISED -DRAWN -REVISED -CHECKED -REVISED -PLOT DATE = May-06-2019 08:12:11 AM DATE REVISED -

STATE OF ILLINOIS DEPARTMENT OF TRANSPORTATION

SCALE:

_						F.A.I. RTE.	SECTION		COUNTY	TOTAL SHEETS	SHEET NO.
E,	ARTH E	XCA	VATION	SCHEDULE		74	(37-3,4)RS-2		HENRY	142	48
									CONTRACT	NO. 64	4C06
CHEET	1 OF	2	CHEETC	CTA	TO STA		TI LINIOTE	EED AL	D. DDOJECT		

		2510	0630			2510	0900			2800	00250	
CTATION.	EF	ROSION CON-	TROL BLANK	ET	Т	URF REINFO	RCEMENT MA	Α Τ	TEMP	EROSION C	ONTROL SEE	DING
STATION	N	В	S	В	N	В	SB		NB		SB	
	OUTSIDE	INSIDE	INSIDE	OUTSIDE	OUTSIDE	INSIDE	INSIDE	OUTSIDE	OUTSIDE	INSIDE	INSIDE	OUTSIDE
I - 74	SQ YD	SQ YD	SQ YD	SQ YD	SQ YD	SQ YD	SQ YD	SQ YD	POUND	POUND	POUND	POUND
STA 1285+50.00 - STA 1295+00.00	0	1,383.44	1,581.67	0	0	0	0	0	0	343.00	392.15	0
STA 1285+65.00 - STA 1361+60.00	0	0	0	0	0	0	0	0	0	0	0	0
STA 1319+50.00 - STA 1345+00.00	554.88	0	0	672.29	2,919.85	0	0	1,576.96	861.50	0	0	566.56
STA 1366+50.00 - STA 1370+50.00	0	0	112.44	139.89	0	0	0	0	0	0	27.88	34.68
STA 1372+00.00 - STA 1375+50.00	124.36	77.61	0	0	50.47	0	0	0	43.35	19.24	0	0
STA 1380+41.00 - STA 1414+29.00	0	0	0	0	0	0	0	0	0	0	0	0
STA 1418+50.00 - STA 1423+00.00	0	0	72.56	238.83	0	0	0	0	0	0	17.99	59.21
STA 1424+00.00 - STA 1427+50.00	133.67	68.72	0	0	0	0	0	0	33.14	17.04	0	0
STA 1432+50.00 - STA 1622+10.00	0	0	0	0	0	0	0	0	0	0	0	0
STA 1466+00.00 - STA 1481+50.00	190.33	0	0	1,481.53	536.28	0	0	592.92	180.15	0	0	514.33
STA 1525+50.00 - STA 1535+00.00	1,555.49	13.89	13.89	1,030.67	303.18	0	0	138.67	477.56	3.44	3.44	289.92
STA 1561+50.00 - STA 1580+50.00	715.39	0	0	353.76	107.39	0	0	377.74	203.99	0	0	181.36
STA 1589+50.00 - STA 1608+00.00	433.08	354.51	342.00	516.78	496.47	764.93	202.94	763.08	230.47	277.55	135.11	321.63
STA 1614+50.00 - STA 1630+50.00	165.00	513.75	749.19	615.61	1,407.33	593.83	274.03	669.03	389.83	276.56	253.69	321.10
STA 1632+00.00 - STA 1636+00.00	206.00	182.67	10.44	0	0	0	0	0	51.07	45.29	2.59	0
STA 1640+49.00 - STA 1672+56.00	0	0	0	0	0	0	0	0	0	0	0	0
STA 1660+00.00 - STA 1669+50.00	0	1173.33	1072.61	0	0	0	0	0	0	290.91	265.94	0
WB/NB REST AREA												
STA 10+78.00 - STA 20+80.00	53.78	295.00	0	0	0	0	0	0	13.33	73.14	0	0
EB/SB REST AREA												
STA 11+86.00 - STA 21+86.00	0	0	278.08	87.33	0	0	0	0	0	0	68.95	21.65
STA 14+37.09 - STA 19+09.41	0	0	0	0	0	0	0	0	0	0	0	0
STA 18+94.44 - STA 19+81.14	0	0	0	0	0	0	0	0	0	0	0	0
SUB-TOTAL	4,131.97	4,062.93	4,232.89	5,136.69	5,820.97	1,358.76	476.97	4,118.39	2,484.41	1,346.17	1,167.73	2,310.44
TOTAL		17,	565	·		11,	776	•		7.:	309	

NOTE:

- 1) WHEN PROPOSED SLOPE IS STEEPER THAN 3:1, USE TURF REINFORCEMENT MAT. OTHERWISE USE EROSION CONTROL BLANKET
- 2) DO NOT MOW PROPOSED SLOPES GREATER THAN 1:2.5

USER NAME = bartonrw	DESIGNED -	REVISED -
	DRAWN -	REVISED -
PLOT SCALE = 100.0000 ' / in.	CHECKED -	REVISED -
PLOT DATE = May-06-2019 08:12:36 AM	DATE -	REVISED -

STATE OF ILLINOIS DEPARTMENT OF TRANSPORTATION

	. =>//					F.A.I. RTE.	SECTION		COUNTY	TOTAL SHEETS	SHEET NO.
EAKIF	1 EX	JΑV	AHUN	SCHEDULE		74	(37-3,4)RS-2	2	HENRY	142	49
									CONTRACT	NO. 64	1C06
SHEET 2	OF	2	SHEETS	STA.	TO STA.		ILLING	DIS FED. AI	D PROJECT		

								40600295	40600847	40603310	40603545	44000169	48100100	48203009	X4400196	Z0033700
								POLY	POLY LEV	HMA	POLY HMA	HMA SURF	AGG SHOLDRS	HMA	HMA SURF	LONG. JOINT
				WIDTH		ARE	ĒΑ	BIT MAT	BIND (MM)	SURF. CSE.	SURF. CSE.	REM 5"	TYPE A	SHLDRS	REM, SP	SEALANT
CTATIONING	DEMARKS	LENGTH	AAA TAH TAH	SHOU	LDER	NAA TAU TAUF	CHOULDED	(TACK COAT)	IL 9.5FG, N90	MIX "C", N50	MIX "D", N90		8"	3"	(6" WIDE)	(SURF & BIN
STATIONING	REMARKS		MAINLINE	OUTSIDE	INSIDE	MAINLINE	SHOULDER		1 "	2 "	4 "		(2' WIDE)			(2x)
		Foot	Foot	Foot	Foot	SQ YD	SQ YD	POUND	TON	TON	TON	SQ YD	TON	SQ YD	SQ YD	FOOT
WESTBOUND (NB)																
STA 1285+65.00 - 1361+65.00	Extra 6" Width on both HMA Surface lifts and Tack Coats along edge lines	7,600.00	24	10	4	20,266.67	11,822.22	29,260.00	1,418.67	1,324.09	4,728.89	32,088.89	769.38	11,822.22	844.44	15,200.00
STA 1361+65.00 - 1380+41.00	PAVING GAP															
STA 1380+41.00 - 1414+17.00	Extra 6" Width on both HMA Surface lifts and Tack Coats along edge lines	3,376.00	24	10	4	9,002.67	5,251.56	12,997.60	630.19	588.17	2,100.62	14,254.22	341.77	5,251.56	375.11	6,752.00
STA 1414+17.00 - 1432+50.00	PAVING GAP															
STA 1432+50.00 - 1540+54.62	Extra 6" Width on both HMA Surface lifts and Tack Coats along edge lines	10,804.62	24	10	4	28,812.32	16,807.19	41,597.79	2,016.86	1,882.40	6,722.87	45,619.51	1,093.80	16,807.19	1,200.51	21,609.24
STA 1540+54.62 - 1550+04.68	1' - 20' AUX LANE Extra 6" Width on both HMA Surface lifts and Tack Coats along edge lines	950.06	25 - 44	10	4	3,641.90	1,477.87	4,679.05	254.93	165.52	851.25	5,119.77	96.18	1,477.87	158.34	1,900.12
STA 1550+04.68 - 1552+99.88	6' - 20' GORE, 14 - 16' RAMP Extra 6" Width on both HMA Surface lifts and Tack Coats along edge lines	295.20	44 - 60	10	4	1,705.60	459.20	1,977.84	119.39	51.43	396.75	2,164.80	29.88	459.20	65.60	590.40
STA 1552+99.88 - 1568+43.23	Extra 6" Width on both HMA Surface lifts and Tack Coats along edge lines	1,543.35	24	10	4	4,115.60	2,400.77	5,941.90	288.09	268.89	960.31	6,516.37	156.24	2,400.77	171.48	3,086.70
STA 1568+43.23 - 1572+10.49	0' - 20' GORE, 16' RAMP Extra 6" Width on both HMA Surface lifts and Tack Coats along edge lines	367.26	40 - 60	10	4	2,040.33	571.29	2,387.19	142.82	63.98	493.60	2,611.63	37.18	571.29	81.61	734.52
STA 1572+10.49 - 1574+87.55	1' - 16' AUX LANE Extra 6" Width on both HMA Surface lifts and Tack Coats along edge lines	277.06	25 - 40	10	4	1,000.49	430.98	1,309.11	70.03	48.27	248.25	1,431.48	28.05	430.98	46.18	554.12
STA 1574+87.55 - 1621+90.00	Extra 6" Width on both HMA Surface lifts and Tack Coats along edge lines	4,702.45	24	10	4	12,539.87	7,314.92	18,104.43	877.79	819.27	2,925.97	19,854.79	476.05	7,314.92	522.49	9,404.90
STA 1621+90.00 - 1640+76.00	PAVING GAP															
STA 1640+76.00 1672+56.00	Extra 6" Width on both HMA Surface lifts and Tack Coats along edge lines	3,180.00	24	10	4	8,480.00	4,946.67	12,243.00	593.60	554.03	1,978.67	13,426.67	321.93	4,946.67	353.33	6,360.00
			1	1	1	1	SUB - TOTAL	130,497.90	6,412.38	5,766.06	21,407.17	143,088.11	3,350.46	51,482.67	3,819.11	66,192.00
			· · · · · · · · · · · · · · · · · · ·				TOTAL	266,054	12,837	15,318	42,853	286,438	7,000	103,067	9,346	132,514

MODEL: Default

STATE OF ILLINOIS DEPARTMENT OF TRANSPORTATION

SCALE:

								40600295	40600847	40603310	40603545	44000169	48100100	48203009	X4400196	Z0033700
								POLY	POLY LEV	HMA	POLY HMA	HMA SURF	AGG SHOLDRS	HMA	HMA SURF	LONG. JOINT
				WIDTH		А	REA	BIT MAT	BIND (MM)	SURF. CSE.	SURF. CSE.	REM 5"	TYPE A	SHLDRS	REM, SP	SEALANT
STATIONING	REMARKS	LENGTH	MAINLINE	SHOUI		MAINLINE	SHOULDER	(TACK COAT)	IL 9.5FG, N90	MIX "C", N50	MIX "D", N90)	8"	3 "	(6" WIDE)	(SURF & BIND)
STATIONING	KLIMAKKS		MATNETNE	OUTSIDE	INSIDE	MATNETINE	SHOOLDEN		1 "	2"	4"		(2' WIDE)			(2x)
		Foot	Foot	Foot	Foot	SQ YD	SQ YD	POUND	TON	TON	TON	SQ YD	TON	SQ YD	SQ YD	FOOT
EASTBOUND (SB)																
STA 1285+65.00 - 1361+60.00	Extra 6" Width on both HMA Surface lifts and Tack Coats along edge lines	7,595.00	24	10	4	20,253.33	3 11,814.44	29,240.75	1,417.73	1,323.22	4,725.78	32,067.78	768.88	11,814.44	1,265.83	15,190.00
STA 1361+60.00 - 1380+46.00	PAVING GAP															
STA 1380+46.00 - 1414+29.00	Extra 6" Width on both HMA Surface lifts and Tack Coats along edge lines	3,383.00	24	10	4	9,021.33	5,262.44	13,024.55	631.49	589.39	2,104.98	14,283.78	342.48	5,262.44	563.83	6,766.00
STA 1414+29.00 - 1432+34.00	PAVING GAP															
STA 1432+34.00 - 1474+30.74	Extra 6" Width on both HMA Surface lifts and Tack Coats along edge lines	4,196.74	24	10	4	11,191.31	6,528.26	16,157.45	783.39	731.17	2,611.30	17,719.57	424.86	6,528.26	699.46	8,393.48
STA 1474+30.74 - 1477+27.04	1' - 16' AUX LANE Extra 6" Width on both HMA Surface lifts and Tack Coats along edge lines	296.30	25 - 40	10	4	1,069.97	460.91	1,429.65	74.90	51.62	265.48	1,530.88	30.00	460.91	49.38	592.60
STA 1477+27.04 - 1480+83.99	0' - 20' GORE, 16' RAMP Extra 6" Width on both HMA Surface lifts and Tack Coats along edge lines	356.95	40 - 60	10	4	1,983.06	555.26	2,355.87	138.81	62.19	479.74	2,538.31	36.14	555.26	59.49	713.90
STA 1480+83.99 - 1497+09.86	Extra 6" Width on both HMA Surface lifts and Tack Coats along edge lines	1,625.87	24	10	4	4,335.65	2,529.13	6,259.60	303.50	283.26	1,011.65	6,864.78	164.59	2,529.13	270.98	3,251.74
STA 1497+09.86 - 1500+04.83	6' - 20' GORE, 14 - 16' RAMP Extra 6" Width on both HMA Surface lifts and Tack Coats along edge lines	294.97	44 - 60	10	4	1,704.27	458.84	1,946.80	119.30	51.39	396.44	2,163.11	29.86	458.84	49.16	589.94
STA 1500+04.83 - 1509+54.55	1' - 20' AUX LANE Extra 6" Width on both HMA Surface lifts and Tack Coats along edge lines	949.72	25 - 44	10	4	3,640.59	1,477.34	4,582.40	254.84	165.46	850.95	5,117.94	96.14	1,477.34	158.29	1,899.44
STA 1509+54.55 - 1622+10.00	Extra 6" Width on both HMA Surface lifts and Tack Coats along edge lines	11,255.45	24	10	4	30,014.53	3 17,508.48	43,333.48	2,101.02	1,960.95	7,003.39	47,523.01	1,139.44	17,508.48	1,875.91	22,510.90
STA 1622+10.00 - 1640+49.00	PAVING GAP															
STA 1640+49.00 - 1672+56.00	Extra 6" Width on both HMA Surface lifts and Tack Coats along edge lines	3,207.00	24	10	4	8,552.00	4,988.67	12,346.95	598.64	558.73	1,995.47	13,540.67	324.66	4,988.67	534.50	6,414.00
			•	•		•	SUB - TOTAI	130,677.50	6,423.62	5,777.38	21,445.19	143,349.83	3,357.04	51,583.78	5,526.83	66,322.00
							TOTAI	266,054	12,837	15,318	42,853	286,438	7,000	103,067	9,346	132,514

MODEL: Default
FILE NAME: pw:\\nlangeround

STATE OF ILLINOIS
DEPARTMENT OF TRANSPORTATION

SCALE:

					[40600275	40600295	40603310	48100100	48203021	Z0027800
						BIT MAT	POLY	+0003310 HMA	AGG SHOLDRS	HMA	GEOTECH
			WID	TH		(PRIME COAT)	BIT MAT	SURF. CSE.	TYPE A	SHLDRS	FABRIC
		LENGTH	SHOUL		AREA	(111112 35,117	(TACK COAT)	MIX "C", N50	8"	6"	.,,,,,,,,,
STATIONING	REMARKS	22.70	OUTSIDE	INSIDE	7.11.27.		(171611 66711)	2"		Ü	
		Foot	Foot	Foot	SO YD	POUND	POUND	TON	TON	SO YD	SQ YD
WESTBOUND (NB)					,					`	,
STA. 1326+86.93 - 1344+86.43		1,799.50	4		799.78		359.90	89.58		799.78	
STA. 1371+93.63 - 1374+74.49		280.86	4		124.83		56.17	13.98		124.83	
STA. 1371+93.63 - 1375+36.99		343.36		4	152.60		68.67	17.09		152.60	
STA. 1424+04.25 - 1426+72.61		268.36	4		119.27		53.67	13.36		119.27	
STA. 1424+04.25 - 1427+47.64		343.39		4	152.62		68.68	17.09		152.62	
STA. 1473+22.97 - 1481+39.16		816.19	4		362.75		163.24	40.63		362.75	
STA. 1525+76.07 - 1534+87.99		911.92	4		405.30		182.38	45.39		405.30	
STA. 1566+73.23 - 1566+85.43		12.20	4		5.42		2.44	0.61		5.42	
STA. 1566+85.43 - 1575+74.54		889.11	3 - 4		345.77	2,766.12			157.52		345.77
STA. 1575+74.54 - 1580+45.74		471.20	4		209.42		94.24	23.46		209.42	
STA. 1593+84.59 - 1607+60.00		1,375.41		4	611.29		275.08	68.46		611.29	
STA. 1596+85.50 - 1599+53.86		268.36	4		119.27		53.67	13.36		119.27	
STA. 1599+53.86 - 1602+56.80		302.94	3		100.98	807.84			46.00		100.98
STA. 1602+56.80 - 1607+21.31		464.51	4		206.45		92.90	23.12		206.45	
STA. 1617+18.79 - 1630+58.66		1,339.87		4	595.50		267.97	66.70		595.50	
STA. 1617+67.48 - 1630+60.50		1,293.02	4		574.68		258.60	64.36		574.68	
STA. 1632+09.63 - 1634+78.02		268.39	4		119.28		53.68	13.36		119.28	
STA. 1632+09.63 - 1635+52.97		343.34		4	152.60		68.67	17.09		152.60	
EASTBOUND (SB)											
STA. 1319+80.13 - 1340+26.82		2,046.69	4		909.64		409.34	101.88		909.64	
STA. 1366+64.57 - 1370+20.37		355.80		4	158.13		71.16	17.71		158.13	
STA. 1367+52.01 - 1370+20.37		268.36	4		119.27		53.67	13.36		119.27	
STA. 1418+61.00 - 1422+54.37		393.37	4		174.83		78.67	19.58		174.83	
STA. 1419+13.63 - 1422+54.37		340.74		4	151.44		68.15	16.96		151.44	
STA 1466+23.53 - 1480+14.52		1,390.99	4		618.22		278.20	69.24		618.22	
STA. 1527+65.01 - 1532+64.50		499.49	4		222.00		99.90	24.86		222.00	
STA. 1561+90.00 - 1567+37.93		547.93	4		243.52		109.59	27.27		243.52	
STA. 1567+37.93 - 1572+36.62		498.69	3 - 4		193.94	1,551.48			88.35		193.94
STA. 1572+36.62 - 1574+77.00		240.38	4		106.84		48.08	11.97		106.84	
STA. 1589+89.84 - 1602+14.32		1,224.48		4	544.21		244.90	60.95		544.21	
STA. 1591+01.86 - 1602+26.36		1,124.50	4		499.78		224.90	55.98		499.78	
STA. 1614+84.42 - 1630+54.83		1,570.41		4	697.96		314.08	78.17		697.96	
STA. 1616+21.03 - 1623+81.73		760.70	4		338.09		152.14	37.87		338.09	
STA. 1627+31.54 - 1630+49.37		317.83	4		141.26		63.57	15.82		141.26	
STA. 1632+06.55 - 1634+71.79		265.24		4	117.88		53.05	13.20		117.88	
				S	UB - TOTAL	5,125.44	4,389.36	1,092.46	291.87	9,754.13	640.68
					TOTAL	0.113	266.054	15 310	7.000	10 030	6.41
					TOTAL	8,112	266,054	15,318	7,000	10,839	641

USER NAME = bartonrw	DESIGNED -	REVISED -
	DRAWN -	REVISED -
PLOT SCALE = 100.0000 ' / in.	CHECKED -	REVISED -
PLOT DATE = May-06-2019 08:13:38 AM	DATE -	REVISED -

		H	IMA	SCHED	ULE		F.A.I. RTE	SECTION	COUNTY	TOTAL SHEETS	SHEET NO.
			CH	ARDRAI			74	(37-3,4)RS-2	HENRY	142	52
			uu	חוטוותו	L .				CONTRACT	NO. 64	4C06
SCALE:	SHEET 3	OF	4	SHEETS	STA.	TO STA.		ILLINOIS FED	. AID PROJECT		

OOT/Documents\IDOT Offices\District 2\Projects\P202906\CADData\CADsheets\P202906-

								40600290	4060	0627		40603310		44000162	44004250	48203029	X4401198
								BIT MAT	LEVE	LING		HMA			PAVED	HMA	HMA SURF
				WIDTH		AR	EA	(TACK	BIND	(MM)		SURF. CSE		HMA SURF	SHLDR	SHLDRS	REM, VD
STATIONING	REMARKS	LENGTH	MAINLINE	SHOUL	.DER	MAINLINE	CHOLL DED	COAT)	IL 9.5	FG, N50		MIX "C", N	150	REM 3.25"	REMOVAL	8"	1
STATIONING	REMARKS		MATNLTNE	OUTSIDE	INSIDE	MAINLINE	SHOOLDER		1.75"	Variable	1.5"	2 "	Variable				1
		Foot	Foot	Foot	Foot	SQ YD	SQ YD	POUND	TON	TON	TON	TON	TON	SQ YD	SQ YD	SQ YD	SQ YD
WESTBOUND (NB)																	
STA 06+68.10 - 09+37.50	RAMP	269.40	16	10	4	478.93	419.07	606.15	100.58		75.43			898.00			
STA 09+37.50 - 10+78.15	RAMP	140.65	16	10	4	250.04	218.79	316.46	52.51		39.38						468.83
STA 10+78 15 - 11+03 15	RAMP	25.00	16	10	4	44.44	38.89	56.25	9.33				8.17				83.33
STA 11+03.15 - 20+54.55	REST AREA OVERLAY					8,830.17	186.81	6,086.46	1,009.90			1,009.90					
STA 11+03.15 - 20+54.55	REST AREA SHLDR RECON	951.40			4		422.84	190.28	47.36			47.36			422.84	422.84	
STA 20+54.55 - 20+79.55	RAMP	25.00	16	10	4	44.44	38.89	56.25	9.33				8.17				83.33
STA 20+79.55 - 22+20.50	RAMP	140.95	16	10	4	250.58	219.26	317.14	52.62		39.47						469.83
STA 22+20.50 - 22+84.42	RAMP	63.92	16	10	4	113.64	99.43	143.82	23.86		17.90			213.07			
EASTBOUND (SB)																	
STA 06+83.04 - 07+53.50	RAMP	70.46	16	10	4	125.26	109.60	158.54		16.44			39.46				234.87
STA 07+53.50 - 07+70.54	RAMP	17.04	16	10	4	30.29	26.51	38.34		5.17			5.57	56.80			
STA 07+70.54 - 10+98.00	RAMP	327.46	16	10	4	582.15	509.38	736.79	122.25		91.69			1,091.53			
STA 10+98.00 - 11+86.42	RAMP	88.42	16	10	4	157.19	137.54	198.95	33.01		24.76						294.73
STA 11+86.42 - 12+11.42	RAMP	25.00	16	10	4	44.44	38.89	56.25	9.33				8.17				83.33
STA 12+11.42 - 21+61.22	REST AREA OVERLAY					8,814.11	276.23	4,090.65	1,018.12			1,018.12					
STA 12+11.42 - 14+37.09	REST AREA SHLDR RECON	225.67			4		100.30	45.13	11.23			11.23			100.30	100.30	
STA 14+37.09 - 19+04.41	REST AREA SHLDR RECON	467.32			4		207.70	93.46	23.26			23.26				207.70	
STA 19+04.41 - 21+61.22	REST AREA SHLDR RECON	256.81			4		114.14	51.36	12.78			12.78			114.14	114.14	
STA 21+61.22 - 21+86.22	RAMP	25.00	16	10	4	44.44	38.89	56.25	9.33				8.17				83.33
STA 21+86.22 - 22+74.00	RAMP	87.78	16	10	4	156.05	136.55	197.51	32.77		24.58						292.60
STA 22+74.00 - 23+11.26	RAMP	37.26	16	10	4	66.24	57.96	83.84	13.91		10.43			124.20			
STA 23+11.26 - 23+28.50	RAMP	17.24	16	10	4	30.65	26.82	38.79		5.23			5.63	57.47			
STA 23+28.50 - 23+98.76	RAMP	70.26	16	10	4	124.91	109.29	158.09		26.23			39.35				234.20
			•				SUB - TOTAL	13,776.74	2,591.50	53.07	323.64	2,122.66	122.67	2,441.07	637.28	844.98	2,328.40
							TOTAL	14,159	2,0	645		15,318		2,442	1,707	845	2,329

			30300112	40600275	40600290	40600295	40600829	40603085	4060	03310	40603340	42000501	44000100	44004250	44000159	48203021	Z0028415
			AGG	BIT MAT	BIT MAT	POLY	POLY LEV	HMA BINDER	Н	MA	HMA	PCC PVMT		PAVED		HMA	GEOTECH
			SUBGRADE	(PRIME	(TACK	BIT MAT	BIND (MM)	CSE,	SURF	CSE	SURF. CSE.	10"	PVMT	SHLDR	HMA SURF	SHLDRS	REINF
STATIONING	 REMARKS	AREA	IMPRVMNT	COAT)	COAT)	(TACK	IL 9.5FG,	IL 19.0,	MIX "C	C", N50	MIX "D", N70	(JOINTED)	REMOVAL	REMOVAL	REM 2.5"	6"	
STATIONING	REMARKS		12"			COAT)	N50, 1"	N70, 8"	1.5"	2 "	1.5"						
		SQ YD	SQ YD	POUND	POUND	POUND	TON	TON	TON	TON		SQ YD	SQ YD	SQ YD	SQ YD	SQ YD	SQ YD
STA.1285+78.37 - 1294+85.92	CROSSOVER (AGG SUBGRADE)	1,454.78	1,454.78							26.38				235.54		235.54	
STA.1285+78.37 - 1294+85.92	CROSSOVER (HMA PAVEMENT)	1,327.28		2,986.38				594.62			250.86		1,327.28				1,327.28
STA.1306+00.00	U-TURN AREA	286.78				193.58	16.06		24.09						286.78		
STA.1458+00.00	U-TURN AREA	216.44				146.10	12.12		18.18						216.44		
STA.1524+71.00	U-TURN AREA	220.89				149.10	12.37		18.55						220.89		
STA.1664+00.00	U-TURN AREA	220.67											220.67				
STA.1660+45.84 - 1669+83.43	CROSSOVER (AGG SUBGRADE)	3,256.22	3,256.22														
STA.1660+45.84 - 1669+83.43	CROSSOVER (PCC PAVEMENT)	3,082.84										3,082.84					2,708.59
STA.1660+45.84 - 1669+83.43	CROSSOVER (SHOULDERS)	849.11			382.10					95.10				833.41		849.11	
		SUB - TOTAL	4,711.00	2,986.38	382.10	488.78	40.55	594.62	60.83	121.48	250.86	3,082.84	1,547.95	1,068.95	724.11	1,084.65	4,035.87
		TOTAL	4,711	8,112	14,159	266,054	41	595	15	, 318	251	3,083	1,548	1,707	725	10,839	4,891

STATE OF ILLINOIS DEPARTMENT OF TRANSPORTATION

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BAR SPACING: 6 1/4" IN AREAS WITH HMA OVERLAY 163mm IN AREAS WITHOUT HMA OVERLAY

 USER NAME
 = bartonrw
 DESIGNED REVISED

 DRAWN REVISED

 PLOT SCALE
 = 100.0000 ' / in.
 CHECKED REVISED

 PLOT DATE
 = May-06-2019 08:14:14 AM
 DATE REVISED

STATE OF ILLINOIS DEPARTMENT OF TRANSPORTATION

PATCHING SCHEDULE

SCALE: SHEET 1 OF 3 SHEETS STA.

TO STA.

F.A.I. SECTION COUNTY TOTAL SHEETS NO.

74 (37-3,4)RS-2 HENRY 142 54

CONTRACT NO. 64C06

			WID	TU	30300106 AGG SUBG	44200529 CLASS A	44200533 CLASS A	44200535 CLASS A	44213000 PATCH REIN-	44213200 SAW CUTS	44213204 TIE BARS,	Z00284 GEOTEC
		LENGTH	MAIN		IMPR, 6"	PATCHES,	PATCHES,	PATCHES,	FORECEMENT	(4W+2L)	3/4"	REINF
STATIONING	REMARKS	LENGIH	OUTSIDE		(20%)		TY III, 8 IN		FORECEMENT	(4W+2L)	3/4	(20%)
		FOOT	FOOT	FOOT	SQ YD	SQ YD	SQ YD	SQ YD	SQ YD	FOOT	EACH	SQ YD
STA 1292+27.98 - 1292+35.98	WB (NB)	8	12	12	4.27	21.33	34 15	30 15	21.33	104	EACH	4.27
STA. 1292+84.69 - 1292+94.69	WB (NB)	10		12	2.67	13.33			13.33	58		2.67
STA. 1311+63.58 - 1311+81.58	WB (NB)	18	12		4.80		24.00		24.00	66		4.80
STA. 1314+51.42 - 1314+59.42	WB (NB)	8	12		2.13	10.67			10.67	56		2.13
STA. 1331+72.53 - 1331+82.53	WB (NB)	10	12	12	5.33	26.67			26.67	106		5.33
STA. 1339+30.71 - 1339+36.71	WB (NB)	6		12	1.60	8.00			8.00	54		1.60
STA 1353+92 14 - 1354+14.14	WB (NB)	22	12	12	11.73			58.67	58.67	118	10	11.73
STA. 1389+14.54 - 1389+20.54	WB (NB)	6	12		1.60	8.00			8.00	54		1.60
STA 1395+53 43 - 1395+59 43	WB (NB)	6	12		1.60	8.00			8.00	54		1.60
STA. 1410+74.56 - 1410+88.56	WB (NB)	14	12	12	7.47		37.33		37.33	110		7.47
STA. 1433+91.85 - 1434+03.85	WB (NB)	12	12	12	6.40		32.00		32.00	108		6.40
STA. 1466+61.01 - 1466+69.01	WB (NB)	8	12		2.13	10.67			10.67	56		2.13
STA. 1500+06.08 - 1500+12.08	WB (NB)	6		12	1.60	8.00			8.00	54		1.60
STA 1621+55.48 - 1621+63.48	WB (NB)	8	12	12	4.27	21.33			21.33	104		4.27
STA 1641+61.57 - 1641+69.57	WB (NB)	8 10	1.2	12	2.13	10.67			10.67	56		2.13
STA. 1645+15.39 - 1645+25.39 STA. 1651+26.62 - 1651+32.62	WB (NB)	6	12	12 12	5.33 1.60	26.67			26.67	106 54		5.33
STA. 1651+26.62 - 1651+32.62 STA. 1654+86.45 - 1655+16.45	WB (NB)	30	12	12	16.00	8.00		80.00	8.00	126	14	16.00
51W. 1001-100.40 - 1001-10.45	MD (IND)	0.0	14	1 4	10.00			30.00	30.00	120	1 +	10.00
STA. 1288+08.12 - 1288+22.12	EB (SB)	14	12	12	7.47		37.33		37.33	110		7.47
STA 1293+76.74 - 1293+84.74	EB (SB)	8		12	2.13	10.67	57.55		10.67	56		2.13
STA 1300+70.30 - 1300+76.30	EB (SB)	6	12		1.60	8.00			8.00	54		1.60
STA 1319+03.69 - 1319+31.69	EB (SB)	28	12	12	14.93			74.67	74.67	124	13	14.93
STA. 1322+07.84 - 1322+17.84	EB (SB)	10	12	12	5.33	26.67			26.67	106		5.33
STA. 1324+32.24 - 1324+38.24	EB (SB)	6		12	1.60	8.00			8.00	54		1.60
STA. 1355+71.86 - 1355+77.86	EB (SB)	6		12	1.60	8.00			8.00	54		1.60
STA. 1359+02.61 - 1359+10.61	EB (SB)	8		12	2.13	10.67			10.67	56		2.13
STA. 1359+18.56 - 1359+24.56	EB (SB)	6	12		1.60	8.00			8.00	54		1.60
STA. 1359+93.03 - 1360+05.03	EB (SB)	12	12		3.20		16.00		16.00	60		3.20
STA. 1360+96.70 - 1361+10.70	EB (SB)	14	12	12	7.47		37.33		37.33	110		7.47
STA. 1381+73.02 - 1381+98.02	EB (SB)	25	12	12	13.33			66.67	66.67	121	12	13.33
STA. 1382+71.13 - 1382+77.13	EB (SB)	6	12		1.60	8.00			8.00	54		1.60
STA. 1386+67.02 - 1386+73.02	EB (SB)	6	12	12	3.20	16.00			16.00	102		3.20
STA. 1387+26.55 - 1387+32.55	EB (SB)	6		12	1.60	8.00			8.00	54		1.60
STA 1390+03.50 - 1390+09.50	EB (SB)	6	4.0	12	1.60	8.00		F2 22	8.00	54		1.60
STA 1392+50.67 - 1392+70.67	EB (SB)	20	12	12	10.67	21 22		53.33	53.33	116	9	10.67
STA 1395+61.27 - 1395+69.27	EB (SB)	8	12	12	4.27	21.33	16.00		21.33	104		4.27
STA. 1396+48.86 - 1396+60.86 STA. 1401+89.62 - 1401+97.62	EB (SB)	12 8	12	12 12	3.20 4.27	21 22	16.00		16.00 21.33	104		3.20 4.27
STA. 1401+69.62 - 1401+97.62 STA. 1407+09.13 - 1407+19.13	EB (SB)	10	12	12	5.33	21 33			26.67	104		5.33
STA. 1411+96.82 - 1412+04.82	EB (SB)	8	12	12	4.27	21.33			21.33	104		4.27
STA 1412+64.19 - 1412+74.19	EB (SB)	10	12	12	2.67	13.33			13.33	58		2.67
STA 1413+76.70 - 1413+82.70	EB (SB)	6	12	12	1.60	8.00			8.00	54		1.60
STA 1434+99 02 - 1435+13.02	EB (SB)	14	12	12	7.47	0.00	37.33		37.33	110		7.47
STA. 1437+67.65 - 1437+75.65	EB (SB)	8	12	12	4.27	21.33			21.33	104		4.27
STA. 1448+60.93 - 1448+72.93	EB (SB)	12	12		3.20		16.00		16.00	60		3.20
STA. 1468+77.54 - 1468+83.54	EB (SB)	6	12		1.60	8.00			8.00	54		1.60
STA. 1481+03.64 - 1481+09.64	EB (SB)	6	12		1.60	8.00			8.00	54		1.60
STA. 1482+48.49 - 1482+64.49	EB (SB)	16	12	12	8.53		42.67		42.67	112		8.53
STA. 1486+79.59 - 1486+85.59	EB (SB)	6	12		1.60	8.00			8.00	54		1.60
STA 1500+10.40 - 1500+16.40	EB (SB)	6		12	1.60	8.00			8.00	54		1.60
STA 1503+52.17 - 1503+58.17	EB (SB)	6	12	12	3.20	16.00			16.00	102	-	3.20
STA. 1513+31.04 - 1513+49.04	EB (SB)	18	12	12	9.60		48.00		48.00	114		9.60
STA. 1534+20.15 - 1534+28.15	EB (SB)	8		12	2.13	10.67			10.67	56		2.13
STA. 1539+20.04 - 1539+28.04	EB (SB)	8	12	12	4.27	21.33			21.33	104		4.27
STA. 1543+26.62 - 1543+34.62	EB (SB)	8	12	12	4.27	21.33			21.33	104		4.27
STA 1609+89.50 - 1609+95.50	EB (SB)	6	12	12	3.20	16.00			16.00	102		3.20
STA. 1621+70.82 - 1621+76.82	EB (SB)	6		12	1.60	8.00			8.00	54		1.60
STA 1642+83.73 - 1642+91.73	EB (SB)	8		12	2.13	10.67			10.67	56		2.13
STA. 1651+69.07 - 1651+75.07 STA. 1654+65.35 - 1654+73.35	EB (SB)	6	1.2	12	1.60	8.00			8.00	54		1.60
- 10 105/1±05 35 165/1±/3 35	EB (SB)	8	12	12	4.27 5.33	21 33			21.33	104		4.27 5.33
	ED /CD	1 1 0										
STA. 1657+03.18 - 1657+13.18	EB (SB)	10	12	12 - TOTAL	260.80	626.67	344.00	333.33	1,304.00	4,931	58	260.8

BAR SPACING: 6 1/4" IN AREAS WITH HMA OVERLAY 163mm IN AREAS WITHOUT HMA OVERLAY

USER NAME = bartonrw DESIGNED -REVISED -DRAWN -REVISED -REVISED -CHECKED -PLOT DATE = May-06-2019 08:14:39 AM DATE REVISED -

STATE OF ILLINOIS **DEPARTMENT OF TRANSPORTATION**

PATCHING SCHEDULE SCALE: SHEET 2 OF 3 SHEETS STA. TO STA.

COUNTY TOTAL SHEET NO.
HENRY 142 55 SECTION 74 (37-3,4)RS-2 CONTRACT NO. 64C06

				30300106	44200050	44200934	44200942	44200944	44201298	44213200	44213204	Z0028415
				AGG SUBG	WLEDED	CLASS B	CLASS B	CLASS B	DOWEL BARS	SAW CUTS	TIE BARS,	GEOTECH
STATIONING	REMARKS	LENGTH	WIDTH	IMPR, 6"	WIRE REIN-	PATCHES	PATCHES	PATCHES	1 1/4"	(4W+2L)	3 / 4 "	REINF
STATIONING	REMARKS			(20%)	FORCEMENT	TY II, 8 IN	TY III, 8 IN	TY IV, 8 IN				(20%)
		FOOT	FOOT	SQ YD	SQ YD	SQ YD	SQ YD	SQ YD	EACH	FOOT	EACH	SQ YD
STA 111+14.85 - 111+94.85	WB (NB) REST AREA TRUCK LANE	80.00	16	28.44	142.22			142.22	28	224	39	28.44
STA 11+86.34 - 12+84.34	WB (NB) REST AREA TRUCK LANE	98.00	16	34.84	174.22			174.22	28	260	48	34.84
STA 13+30.87 - 14+48.87	WB (NB) REST AREA TRUCK LANE	118.00	16	41.96	209.78			209.78	28	300	58	41.96
STA 13+63.88 - 13+71.88	WB (NB) REST AREA CAR PARKING LOT (RT)	8.00	33	5.87	29.33			29.33	62	148		5.87
STA 14+10.34 - 14+50.34	WB (NB) REST AREA CAR LANE	40.00	22	19.56	97.78			97.78	40	168	19	19.56
STA 15+80.09 - 16+14.09	WB (NB) REST AREA TRUCK LANE	34.00	8	6.04	30.22			30.22	12	100	16	6.04
STA 19+02.11 - 20+57.11	WB (NB) REST AREA CAR LANE	155.00	22	75.78	378.89			378.89	40	398	77	75.78
STA 12+12.68 - 12+82.68	EB (SB) REST AREA TRUCK LANE	70.00	16	24.89	124.44			124.44	28	204	34	24.89
STA 13+25.26 - 13+33.26	EB (SB) REST AREA CAR LANE	8.00	22	3.91	19.56		19.56		40	104		3.91
STA 13+69.54 - 14+73.54	EB (SB) REST AREA TRUCK LANE	104.00	16	36.98	184.89			184.89	28	272	51	36.98
STA 14+35.09 - 14+43.09	EB (SB) REST AREA CAR PARKING LOT (RT)	8.00	33	5.87	29.33			29.33	62	148		5.87
STA 14+60.31 - 14+68.31	EB (SB) REST AREA CAR PARKING LOT (RT)	8.00	33	5.87	29.33			29.33	62	148		5.87
STA 14+91.09 - 15+51.09	EB (SB) REST AREA TRUCK LANE	60.00	16	21.33	106.67			106.67	28	184	29	21.33
STA 14+98.15 - 15+12.23	EB (SB) REST AREA CAR PARKING LOT (RT)	14.08	22	3.21	16.06		16.06		20	40.75		3.21
STA 15+32.86 - 15+40.86	EB (SB) REST AREA CAR LANE	8.00	22	3.91	19.56		19.56		40	104		3.91
STA 15+40.59 - 15+56.59	EB (SB) REST AREA TRUCK LANE	16.00	6	2.13		10.67			8	56		2.13
STA 17+44.46 - 17+52.46	EB (SB) REST AREA CAR LANE	8.00	22	3.91	19.56		19.56		40	104		3.91
STA 18+74.81 - 18+82.81	EB (SB) REST AREA CAR LANE	8.00	22	3.91	19.56		19.56		40	104		3.91
STA 19+75.22 - 19+83.22	EB (SB) REST AREA CAR LANE	8.00	22	3.91	19.56		19.56		40	104		3.91
STA 20+21.88 - 20+29.88	EB (SB) REST AREA DUMP STATION	8.00	22	3.91	19.56		19.56		40	104		3.91
STA 20+29.16 - 21+47.16	EB (SB) REST AREA CAR LANE	118.00	22	57.69	288.44			288.44	40	324	58	57.69
		SUB-	TOTAL	393.92	1,958.95	10.67	133.40	1,825.56	754.00	3,598.75	429.00	393.92
			TOTAL	855	1,959	11	134	1,826	754	9,312	499	4,891

					30300106	44200610	44200612	44200614	44213000	44213200	44213204	Z0028415
			WID	TH	AGG SUBG	CLASS A	CLASS A	CLASS A	PATCH REIN-	SAW CUTS	TIE BARS,	GEOTECH
STATIONING	REMARKS	LENGTH	MAINI	_ I NE	IMPR, 6"	PATCHES	PATCHES	PATCHES	FORECEMENT	(4W+2L)	3/4"	REINF
STATIONING	REMARKS		OUTSIDE	INSIDE	(20%)	TY II, 13 IN	TY III, 13 IN	TY IV, 13 IN				(20%)
	FOOT FOOT FOOT .21 WB (NB) 12 12 12				SQ YD	SQ YD	SQ YD	SQ YD	SQ YD	FOOT	EACH	SQ YD
STA. 1661+13.21 - 1661+25.21	WB (NB)	12	12	12	6.40		32.00		32.00	108		6.40
STA. 1666+16.50 - 1666+31.50	WB (NB)	15	12	12	8.00		40.00		40.00	111		8.00
STA. 1669+80.18 - 1670+05.18	WB (NB)	25	12	12	13.33			66.67	66.67	121	12	13.33
STA. 1665+93.25 - 1665+99.25	EB (SB)	6	12	12	3.20	16.00			16.00	102		3.20
STA. 1676+68.43 - 1676+78.43	EB (SB)	10	12	12	5.33	26.67			26.67	106		5.33
			SUB -	TOTAL	36.27	42.67	72.00	66.67	181.33	548	12	36.27
				TOTAL	855	43	72	67	1,542	9,312	499	4,891

					30300106	44200553	44200557	44213000	44213200	44213204	Z0028415
			WID	TH	AGG SUBG	CLASS A	CLASS A	PATCH REIN-	SAW CUTS	TIE BARS,	GEOTECH
STATIONING	REMARKS	LENGTH	MAINI	INE	IMPR, 6"	PATCHES	PATCHES	FORECEMENT	(4W+2L)	3 / 4 "	REINF
STATIONING	REMARKS		OUTSIDE	INSIDE	(20%)	TY II, 10 IN	TY III, 10 IN				(20%)
		FOOT	FOOT	FOOT	SQ YD	SQ YD	SQ YD	SQ YD	FOOT	EACH	SQ YD
STA. 1379+53.34 - 1379+65.34	WB (NB)	12	12		3.20		16.00	16.00	60		3.20
STA. 1380+23.32 - 1380+29.32	WB (NB)	6	12		1.60	8.00		8.00	54		1.60
STA. 1427+52.52 - 1427+66.52	WB (NB)	14	12		3.73		18.67	18.67	62		3.73
STA. 1428+21.65 - 1428+31.65	WB (NB)	10	12		2.67	13.33		13.33	58		2.67
			SUB -	TOTAL	11.20	21.33	34.67	56.00	234	0	11.20
				TOTAL	855	22	35	1,542	9,312	499	4,891

			WID	TH	AGG SUBG	CLASS D	CLASS D	CLASS D	CLASS D	GEOTECH
		LENGTH	SHOUL		IMPR, 6"	PATCHES,	PATCHES,	PATCHES,	PATCHES,	REINF
STATIONING	REMARKS		OUTSIDE	INSIDE	(20%)			TY III, 7 IN	1	
		FOOT	FOOT	FOOT	SQ YD	SQ YD	SQ YD	SQ YD	SQ YD	SQ YD
STA. 1292+27.98 - 1292+35.98	WB (NB)	8		4	0.71	3.56	,	,		0.71
STA. 1314+51.42 - 1314+59.42	WB (NB)	8	10		1.78		8.89			1.78
STA. 1331+72.53 - 1331+82.53	WB (NB)	10	10	4	3.11	4.44	11.11			3.11
STA. 1339+30.71 - 1339+36.71	WB (NB)	6		4	0.53	2.67				0.53
STA. 1353+92.14 - 1354+14.14	WB (NB)	22	10	4	6.84		9.78	24.44		6.84
STA. 1410+74.56 - 1410+88.56	WB (NB)	14	10	4	4.36		6.22	15.56		4.36
STA. 1433+91.85 - 1434+03.85	WB (NB)	12	10	4	3.73		18.67			3.73
STA. 1466+61.01 - 1466+69.01	WB (NB)	8	10		1.78		8.89			1.78
STA. 1500+06.08 - 1500+12.08	WB (NB)	6		4	0.53	2.67				0.53
STA. 1621+55.48 - 1621+63.48	WB (NB)	8	10	4	2.49	3.56	8.89			2.49
STA. 1641+61.57 - 1641+69.57	WB (NB)	8		4	0.71	3.56				0.71
STA. 1645+15.39 - 1645+25.39	WB (NB)	10	10	4	3.11	4.44	11.11			3.11
STA. 1651+26.62 - 1651+32.62	WB (NB)	6		4	0.53	2.67				0.53
STA. 1654+86.45 - 1655+16.45	WB (NB)	30	10	4	9.33		13.33		33.33	9.33
STA. 1661+13.21 - 1661+25.21	WB (NB)	12	10		2.67		13.33		1	2.67
	- (57									,
STA. 1288+08.12 - 1288+22.12	EB (SB)	14	10	4	4.36		6.22	15.56	1	4.36
STA. 1300+70.30 - 1300+76.30	EB (SB)	6	10		1.33		6.67			1.33
STA 1319+03.69 - 1319+31.69	EB (SB)	28	10	4	8.71		12.44		31.11	8.71
STA 1322+07.84 - 1322+17.84	EB (SB)	10	10	4	3.11	4.44	11 11			3.11
STA 1355+71.86 - 1355+77.86	EB (SB)	6	- 10	4	0.53	2.67	11111			0.53
STA. 1360+96.70 - 1361+10.70	EB (SB)	14	10	4	4.36	2.07	6.22	15.56		4.36
STA. 1381+73.02 - 1381+98.02	EB (SB)	25	10	4	7.78		11.11	13.33	27.78	7.78
STA. 1386+67.02 - 1386+73.02	EB (SB)	6	10	4	1.87	2.67	6 67		27.70	1.87
STA 1387+26.55 - 1387+32.55	EB (SB)	6	- 10	4	0.53	2.67	0.07			0.53
STA. 1390+03.50 - 1390+09.50	EB (SB)	6		4	0.53	2.67				0.53
STA. 1392+50.67 - 1392+70.67	EB (SB)	20		4	1.78	2.07	8.89			1.78
STA. 1395+61.27 - 1395+69.27	EB (SB)	8		4	0.71	3.56	0.03			0.71
STA. 1401+89.62 - 1401+97.62	EB (SB)	8	10	4	2.49	3.56	8.89			2.49
STA. 1411+96.82 1412+04.82	EB (SB)	8	10	4	0.71	3.56	0.03			0.71
STA. 1413+76.70 - 1413+82.70	EB (SB)	6		4	0.53	2.67				0.53
STA. 1434+99.02 - 1435+13.02	EB (SB)	14	10	4	4.36	2.07	6.22	15.56		4.36
STA. 1437+67.65 - 1437+75.65	EB (SB)	8	10	4	2.49	3.56	8.89	13.30	+	2.49
STA. 1468+77.54 - 1468+83.54	EB (SB)	6	10	7	1.33	3.30	6.67		+	1.33
STA. 1482+48.49 - 1482+64.49	EB (SB)	16	10	4	4.98		7.11	17.78		4.98
STA. 1503+52.17 - 1503+58.17	EB (SB)	6	10	4	1.87	2.67	6.67	17.70		1.87
STA. 1513+31.04 - 1513+49.04	EB (SB)	18	10	4	5.60	2.07	8.00	20.00		5.60
STA. 1513+51.04 - 1513+49.04 STA. 1539+20.04 - 1539+28.04	EB (SB)	8	10	4	2.49	3.56	8.89	20.00	+	2.49
STA. 1543+26.62 - 1543+34.62	EB (SB)	8	10	4	0.71	3.56	0.03			0.71
STA. 1609+89.50 - 1609+95.50	EB (SB)	6	10	4	1.87	2.67	6.67			1.87
STA. 1621+70.82 - 1621+76.82	EB (SB)	6	10	4	0.53	2.67	0.07		+	0.53
STA. 1642+83.73 - 1642+91.73	EB (SB)	8		4	0.33	3.56			+	0.33
	EB (SB)		10	-	1.33	3.50	6.67			1.33
STA. 1642+93.63 - 1643+01.63 STA. 1651+69.07 - 1651+75.07	EB (SB)	6	10	4	0.53	2.67	0.07		+	0.53
STA. 1651+69.07 - 1651+73.07 STA. 1654+65.35 - 1654+73.35	EB (SB)	8	10	4	2.49	3.56	8.89		+	2.49
STA. 1657+03.18 - 1657+13.18	EB (SB)	10	10	4	3.11	4.44	11.11		+	3.11
	EB (SB)	6	10	-	1.33	7.44	6.67		+	1.33
	LD (3D)	Ų		L TOTAL	117.29	88.89	280.89	124.44	92.22	117.29
STA. 1665+93.25 - 1665+99.25							. 200.09	1/4 44	1 74.44	1 11/.29
51A. 1005+95.25 - 1005+99.25			SUB -	TOTAL	117.29	00.03				
STA. 1005+95.25 - 1005+99.25			SUB -	TOTAL	855	89	281	125	93	4,891


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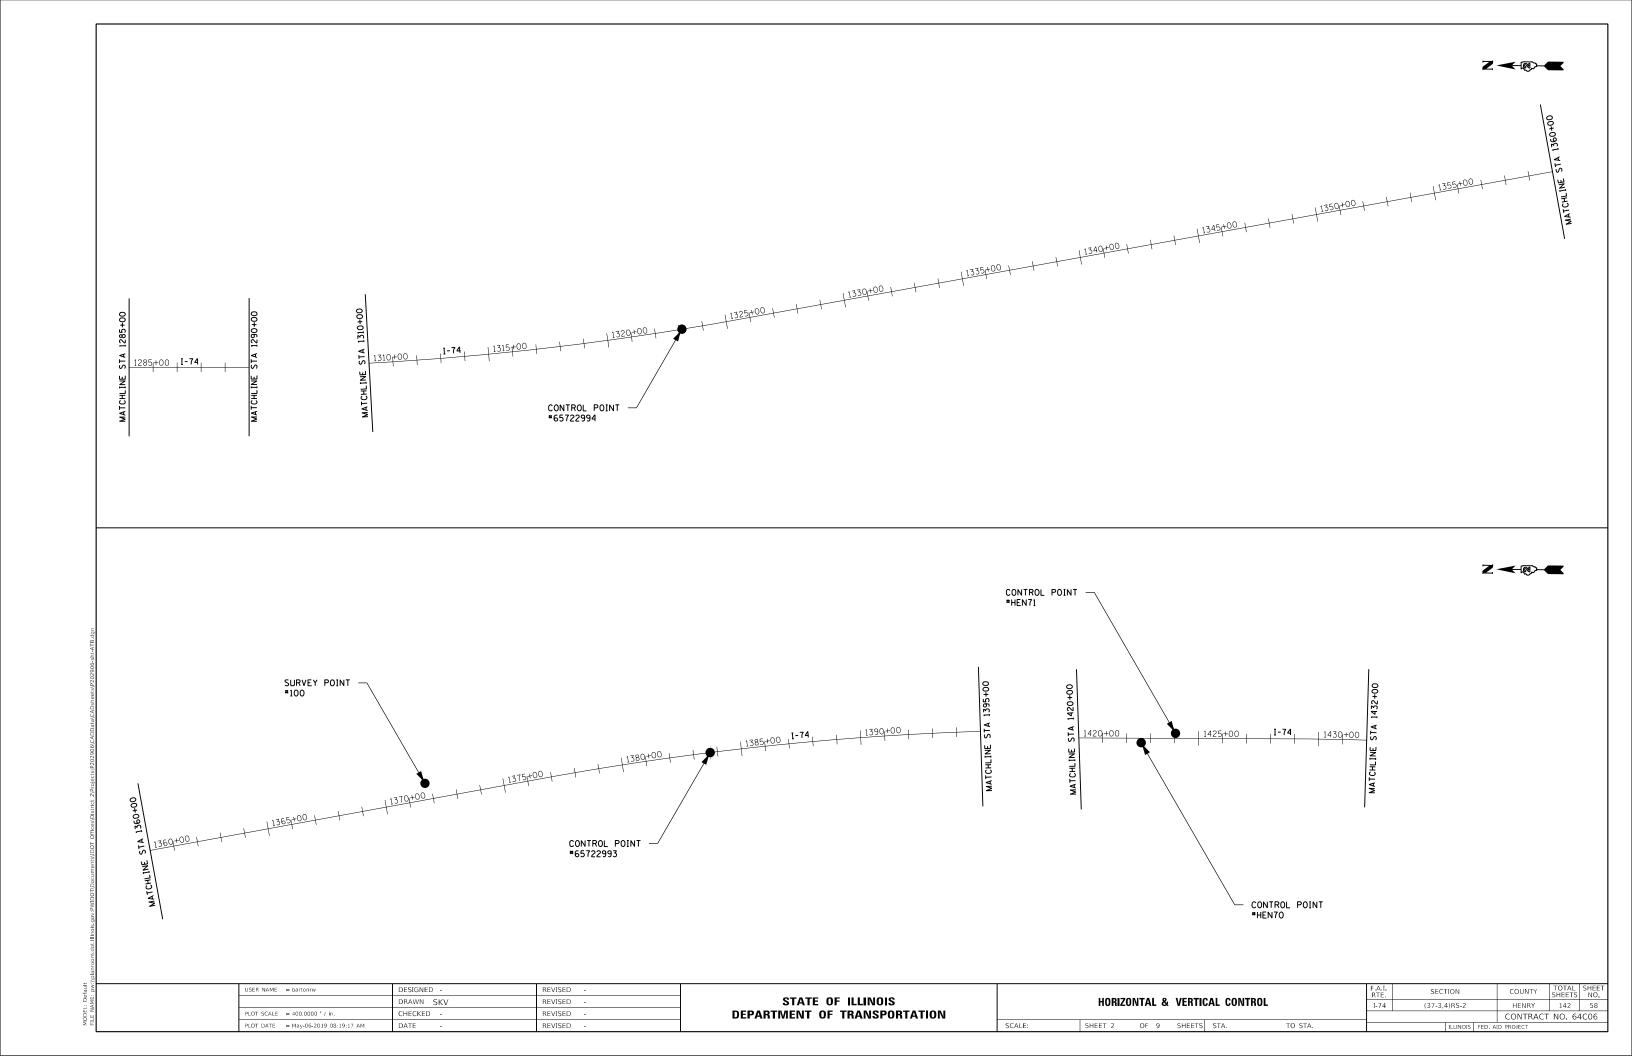
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				WI	DTH		AGG SUBG	CLASS D	CLASS D	CLASS D	CLASS D	GEOTECH
STATIONING	REMARKS	LENGTH	MAINI	LINE	SHOUL	_DER	IMPR, 6"	PATCHES,	PATCHES,	PATCHES,	PATCHES,	REINF
STATIONING	REMARKS		OUTSIDE	INSIDE	OUTSIDE	INSIDE	(20%)	TY I, 12 IN	TY II, 12 IN	TY III, 12 IN	TY IV, 12 IN	(20%)
		FOOT	FOOT	FOOT			SQ YD	SQ YD	SQ YD	SQ YD	SQ YD	SQ YD
STA. 1513+55.49 - 1513+67.49	WB (NB)	12	12	12			6.40			32.00		6.40
STA. 1513+55.49 - 1513+67.49	WB (NB)	12			10	4	3.73		18.67			3.73
STA. 1617+58.72 - 1617+70.72	WB (NB)	12	12	12		4	7.47		5.33	32.00		7.47
STA. 1661+13.21 - 1661+25.21	WB (NB)	12				4	1.07		5.33			1.07
STA. 1666+16.50 - 1666+31.50	WB (NB)	15			10	4	4.67		6.67	16.67		4.67
STA. 1669+80.18 - 1670+05.18	WB (NB)	25			10	4	7.78		11.11		27.78	7.78
STA. 1665+93.25 - 1665+99.25	EB (SB)	6				4	0.53	2.67				0.53
STA. 1676+68.43 - 1676+78.43	EB (SB)	10			10	4	3.11	4.44	11.11			3.11
					SUB-	TOTAL	34.76	7.11	58.22	80.67	27.78	34.76
		•		·		·						
						TOTAL	855	8	59	81	28	4,891


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	DRAWN -	REVISED -
PLOT SCALE = 100.0000 ' / in.	CHECKED -	REVISED -
PLOT DATE = May-06-2019 08:14:57 AM	DATE -	REVISED -


STATE OF ILLINOIS DEPARTMENT OF TRANSPORTATION

							F.A.I. RTE	SECT	TION		COUNTY	TOTAL SHEETS	SHEET NO.	ĺ
	PATCHING SCHEDULE								4)RS-2		HENRY	142	56	ı
											CONTRACT	NO. 64	4C06	ı
SCALE: SHEET 3 OF 3 SHEETS STA. TO STA.									ILLINOIS	FED. AI	D PROJECT			



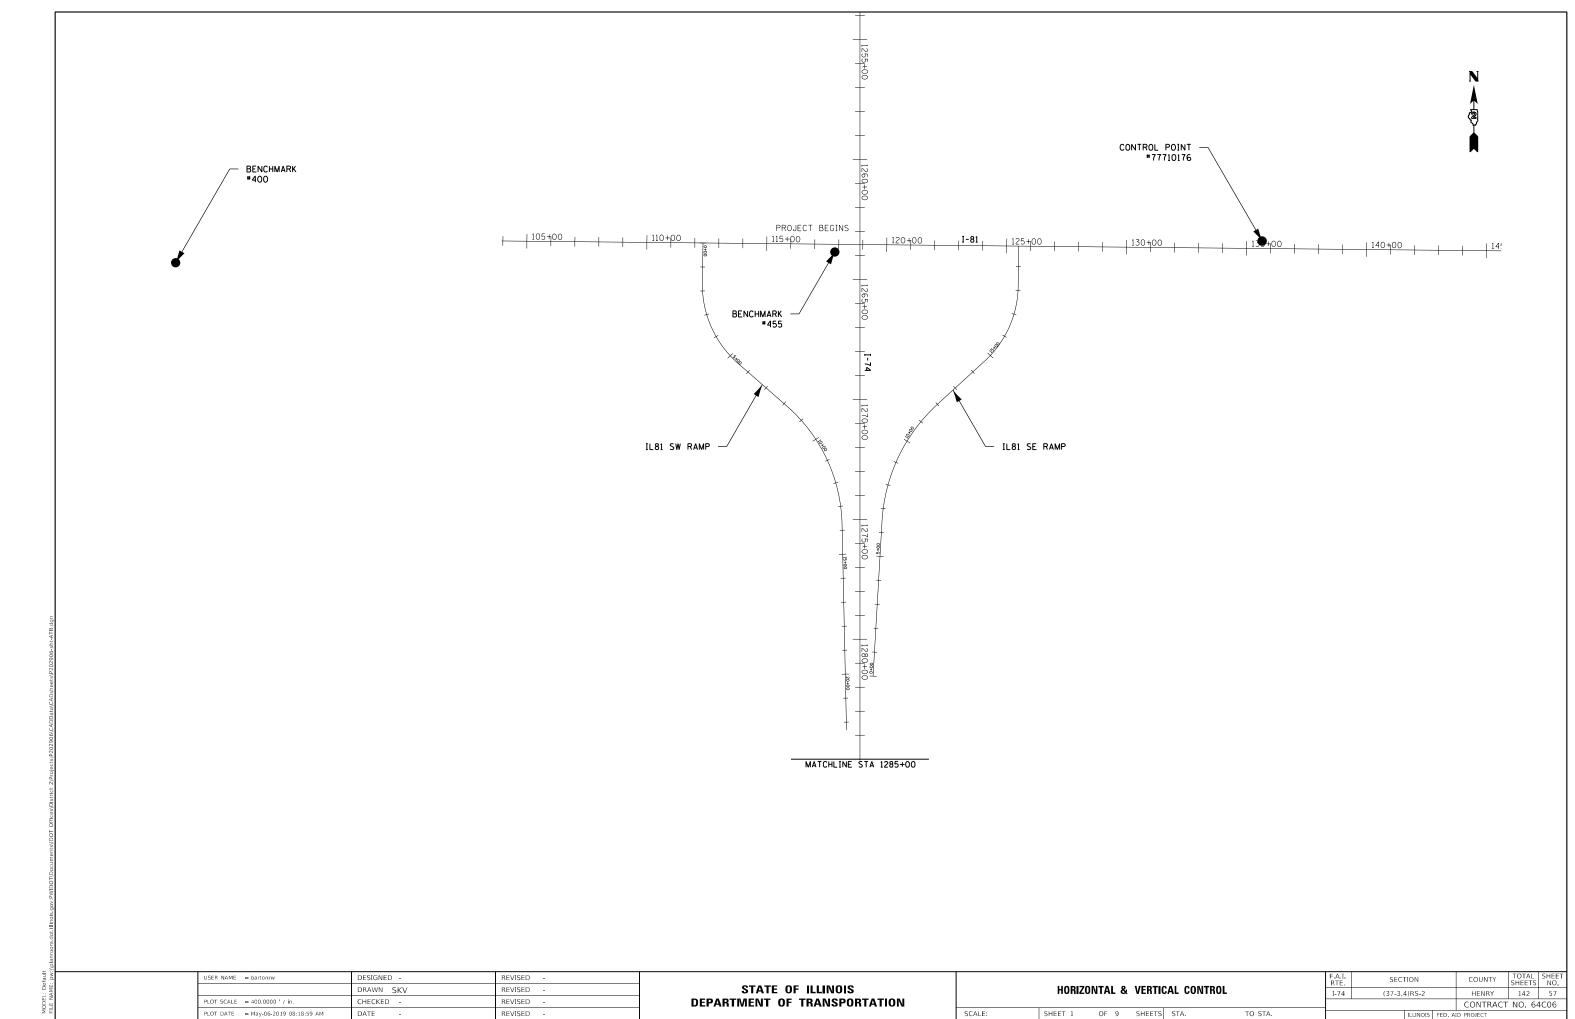

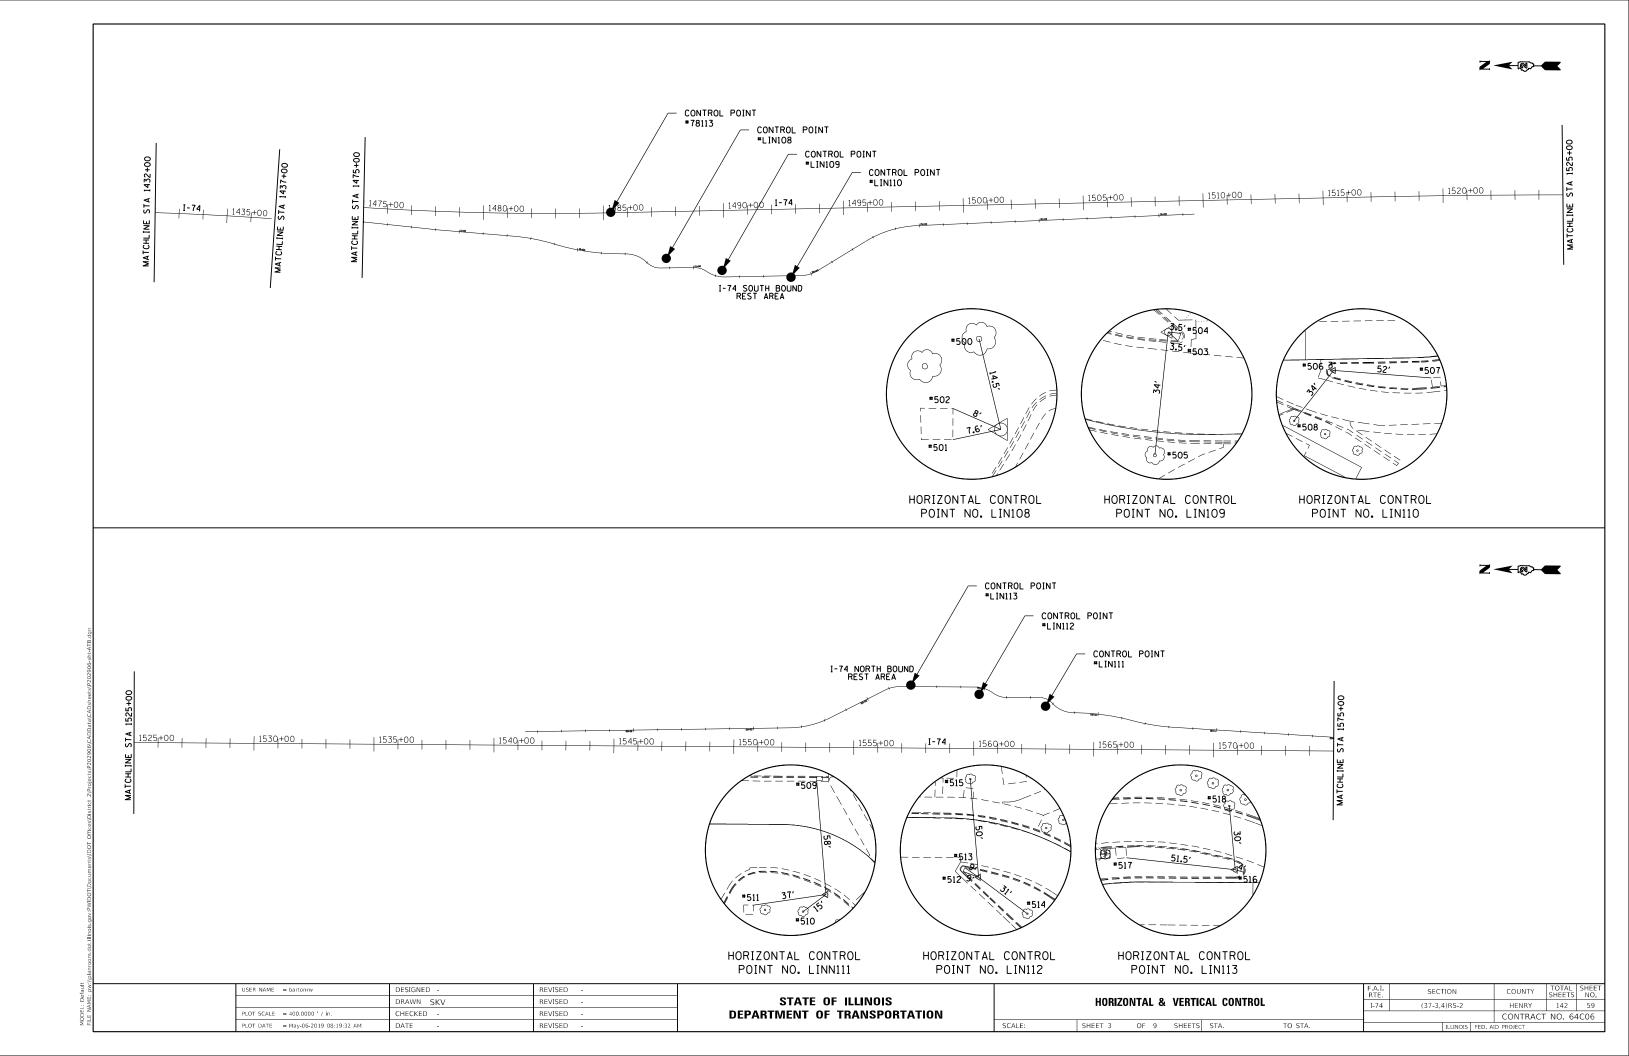

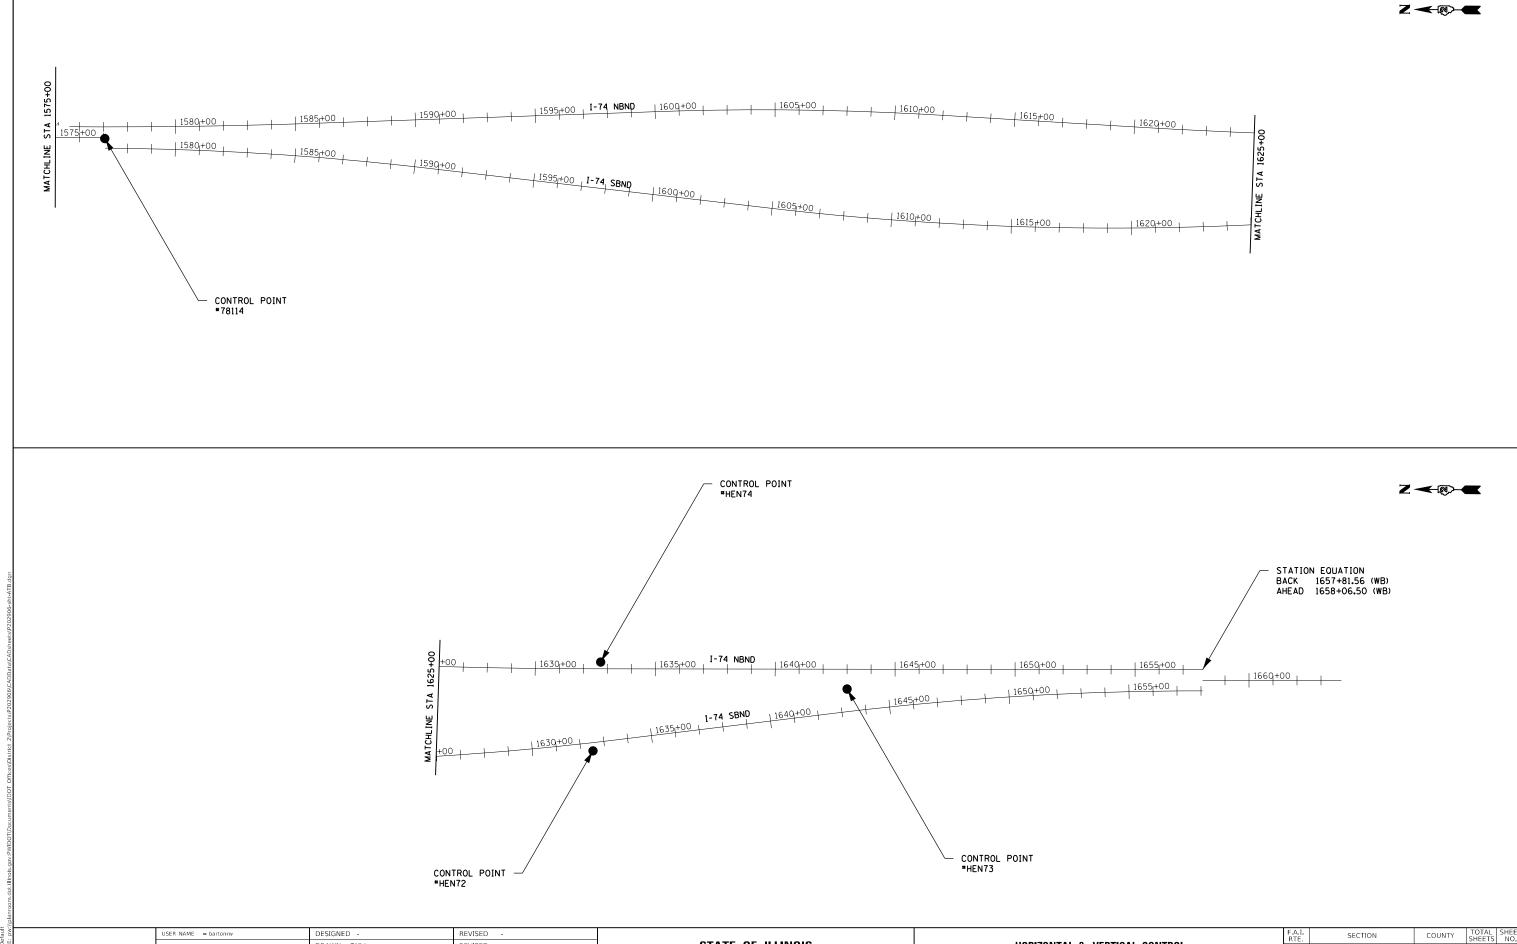

DRAWN SKV STATE OF ILLINOIS REVISED -CHECKED -**DEPARTMENT OF TRANSPORTATION** REVISED -PLOT DATE = May-06-2019 08:19:45 AM DATE REVISED -

SCALE:

HORIZONTAL & VERTICAL CONTROL SHEET 4 OF 9 SHEETS STA. TO STA.

COUNTY TOTAL SHEET NO.
HENRY 142 60
CONTRACT NO. 64C06 I-74 (37-3,4)RS-2

				REFERENCE	TIES					
POINT	NORTH	EAST	CHAIN	STATION	OFFSET	DESCRIPTION				
500	1663549.1900	2250967.8080	EBRESTAREA	13+84.64	53.8425' LT	TREE DECIDUOUS				
501	1663553.4569	2250952.2374	EBRESTAREA	13+80.30	38.2916' LT	MISC. CONCRETE SLAB, CORNER				
502	1663553,3763	2250957,0904	EBRESTAREA	13+80.41	43.1442' LT	MISC. CONCRETE SLAB, CORNER				
503	1663311.6123	2250898.7851	EBRESTAREA	16+28.55	25.0902' LT	BACK OF CURB LEFT				
504	1663310.7910	2250900.8670	EBRESTAREA	16+29.37	27.2299' LT	BACK OF CURB LEFT				
505	1663318.2320	2250867.9010	EBRESTAREA	16+24.65	6.2915' RT	TREE DECIDUOUS				
506	1663030.4340	2250870.3380	EBRESTAREA	19+11.75	5.0076' RT	BACK OF CURB LEFT				
507	1662975.3940	2250864.8500	EBRESTAREA	19+66.06	11.1865' RT	MISC. CONCRETE SLAB, CORNER				
508	1663048.7010	2250842.7250	EBRESTAREA	18+93.28	32.486' RT	TREE DECIDUOUS				
				REFERENCE	TIES					
POINT	NORTH	EAST	CHAIN	STATION	OFFSET	DESCRIPTION				
509	1656010.4650	2251362.3460	WBRESTAREA	12+46.83	24.2547' RT	CATCH BASIN PEREMITER, CORNER				
510	1656017.7830	2251295.4980	WBRESTAREA	12+30.61	41.9709' LT	TREE DECIDUOUS				
511	1656042.9790	2251298.9330	WBRESTAREA	12+74.03	41.2128' LT	MISC. CONCRETE SLAB, CORNER				
512	1656290,4220	2251358,3630	WBRESTAREA	15+28.66	26.8519' LT	BACK OF CURB RIGHT, CORNER				
513	1656289.5610	2251360.3340	WBRESTAREA	15+27.87	24.7979' LT	BACK OF CURB RIGHT, CORNER				
514	1656257.8070	2251336.6230	WBRESTAREA	14+78.43	38.2404' LT	TREE DECIDUOUS				
515	1656286.4490	2251405.4340	WBRESTAREA	15+29.62	20.3776' RT	TREE DECIDUOUS				
516	1656563.1550	2251394.3920	WBRESTAREA	18+04.40	5.1065' RT	BACK OF CURB RIGHT				
517	1656618.2530	2251401.3340	WBRESTAREA	18+59.00	11.5191' RT	MISC. CONCRETE SLAB, CORNER				
518	1656569.6920	2251425.3350	WBRESTAREA	18+11.34	35.9605' RT	TREE DECIDUOUS				

				SURVEY	WORK POIN	NTS					
POINT	NORTH	EAST	ELEVATION	CHAIN	STATION	OFFSET	DESCRIPTION				
100	1675089.8498	2251561.4503	684.6155	174	1371+77.00	68.3715' LT	DISK, HEADWALL				
	SURVEY WORK POINTS										
POINT NORTH EAST ELEVATION CHAIN STATION OFFSET DESCRIPTION											
LIN108	1663546.0050	2250953.7380	798.1166	EBRESTAREA	13+87.76	39.7581 LT	TOPO SURVEY POINT, PIN				
LIN109	1663314.2490	2250901.3020	795.3973	EBRESTAREA	16+24.96	27.345' LT	TOPO SURVEY POINT, PIN				
LIN110	1663027.3740	2250869.3880	792.5528	EBRESTAREA	19+14.80	5.98' RT	TOPO SURVEY POINT, PIN				
				SURVEY	WORK POIN	NTS					
POINT	NORTH	EAST	ELEVATION	CHAIN	STATION	OFFSET	DESCRIPTION				
LIN111	1656006.1230	2251304.1200	784.6304	WBRESTAREA	12+18.68	28.6071' LT	TOPO SURVEY POINT, PIN				
LIN112	1656282.5320	2251355.3950	784.6380	WBRESTAREA	15+18.22	28.6312' LT	TOPO SURVEY POINT, PIN				
LIN113	1656567.0740	2251395.3540	782.9088	WBRESTAREA	18+08.33	6.0167' RT	TOPO SURVEY POINT, PIN				

	BENCH MARKS										
POINT	NORTH	EAST	ELEVATION	CHAIN	STATION	OFFSET	DESCRIPTION				
400	1685782.4083	2247738.5532	757.7419	174	1264+30.6459	2852.4009' RT	VERTICAL CONTROL STATION, CHISELED SQUARE				
455	1685795.5113	2250486.3620	762.9273	174	1263+85.7784	104.9272' RT	VERTICAL CONTROL STATION, DISK				

	CURVE POINT NUMBERS										
CHAIN	CURVE	ΡΙ	CC	PC	PT						
174	02906320	2906320	2906321	2906322	2906323						
174	02906330	2906330	2906331	2906332	2906333						
174	02906340	2906340	2906341	2906342	2906343						
174	00298200	0298200	298201	298202	298203						
174	00298210	0298210	298211	298212	298213						
174	00298220	0298220	298221	298222	298223						

CURVE POINT NUMBERS									
CHAIN	CURVE	PI	CC	PC	PT				
I74NBND	00298260	0298260	298261	298262	298263				
I74NBND	00298270	0298270	298271	298272	298273				
I74NBND	00298280	0298280	298281	298282	298283				

CURVE POINT NUMBERS									
CHAIN	CURVE	PI	CC	PC	PT				
I74SBND	00298230	0298230	298231	298232	298233				
I74SBND	00298240	0298240	298241	298242	298243				
I74SBND	00298250	0298250	298251	298252	298253				

	CURVE POINT NUMBERS									
CHAIN	CURVE	PI	CC	PC	PT					
EBRESTAREA	EBRA200	BRA200	1	2	3					
EBRESTAREA	EBRA210	BRA210	1	2	3					
EBRESTAREA	EBRA220	BRA220	1	2	3					
EBRESTAREA	EBRA230	BRA230	1	2	3					
EBRESTAREA	EBRA240	BRA240	1	2	3					
EBRESTAREA	EBRA250	BRA250	1	2	3					
EBRESTAREA	EBRA260	BRA260	1	2	3					
EBRESTAREA	EBRA270	BRA270	1	2	3					

	CURVE POINT NUMBERS									
CHAIN	CURVE	PI	CC	PC	PT					
WBRESTAREA	WBRA200	BRA200	1	2	3					
WBRESTAREA	WBRA210	BRA210	1	2	3					
WBRESTAREA	WBRA220	BRA220	1	2	3					
WBRESTAREA	WBRA230	BRA230	1	2	3					
WBRESTAREA	WBRA240	BRA240	1	2	3					
WBRESTAREA	WBRA250	BRA250	1	2	3					
WBRESTAREA	WBRA260	BRA260	1	2	3					
WBRESTAREA	WBRA270	BRA270	1	2	3					

USER NAME = bartonrw	DESIGNED -	REVISED -
	DRAWN SKV	REVISED -
PLOT SCALE = 1000.0000 ' / in.	CHECKED -	REVISED -
PLOT DATE = May-06-2019 08:20:03 AM	DATE -	REVISED -

STATE OF ILLINOIS
DEPARTMENT OF TRANSPORTATION

SCALE:

		\/=D=1			F./ R	A.I. RTE	SECTION		COUNTY	TOTAL SHEETS	SHEET NO.
HORIZONTAL & VERTICAL CONTROL						I-74	(37-3,4)RS-2		HENRY	142	61
									CONTRACT	NO. 64	1C06
SHEET 5	OF 9	SHEETS	STA.	TO STA.			ILLINOIS	FED. AI	D PROJECT		

Beginning chain I74 description

Curve Data

Curve 02906320

P.I. Station 1210+80.5278 N 1,691,099.7471 E 2,250,652.6205

Delta = 3° 13' 19.0383'' (RT) Degree = 0° 09' 13.1709"

Tangent = 1,048.6901Length = 2,096.8274

Radius = 37,287.7200'External = 14.7439'

Long Chord = 2,096.5511'

Mid. Ord. = 14.7381

P.C. Station 1200+31.8377 N 1,692,147.3910 E 2,250,605.7896 P.T. Station 1221+28.6651 N 1,690,051.1272 E 2,250,640.4955

C.C. N 1,690,482.2501 E 2,213,355.2679

Course from PT 02906320 to PC 02906330 180° 39' 44.5277" Dist 8,201.9886'

Curve Data

Curve 02906330 P.I. Station 1314+36.1939 N 1,680,744.2203 E 2,250,532.8955

Delta = $10^{\circ} 17' 26.1439'' (LT)$ Degree = 0° 27' 59.9955"

Tangent = 1,105.5402Length = 2,205.1335'

Radius = 12,277.7000'

External = 49.6735'Long Chord = 2,202.1709

Mid. Ord. = 49.4733'

P.C. Station 1303+30.6537 N 1,681,849.6866 E 2,250,545.6784

P.T. Station 1325+35.7872 N 1,679,654.2526 E 2,250,717.7995

C.C. N 1,681,707.7249 E 2,262,822.5576

Course from PT 02906330 to PC 02906340 170° 22' 19.3355" Dist 5,139.0153'

Curve Data

Curve 02906340

P.I. Station 1388+04.7327 N 1,673,473.6083 E 2,251,766.2813

Delta = $10^{\circ} 30' 58.9051'' (RT)$

Degree = 0° 27' 59.9955"

Tangent = 1,129.9301

Length = 2,253.5123'

Radius = 12,277.7000

External = 51.8847

Long Chord = 2,250.3504

Mid. Ord. = 51.6664'

P.C. Station 1376+74.8026 N 1.674.587.6227 E 2.251.577.2995

P.T. Station 1399+28.3149 N 1,672,343.8140 E 2,251,748.7630

C.C. N 1,672,534.1662 E 2,239,472.5387

Course from PT 02906340 to PC 00298200 180° 53' 17.9562" Dist 2,950.8826'

Curve Data

Curve 00298200

P.I. Station 1436+40.3399 N 1,668,632.2352 E 2,251,691.2137

Delta = 7° 05' 41.6262" (RT)

Degree = 0° 27' 59.9955'

Tangent = 761.1423

Length = 1,520.3390'Radius = 12,277.7000'

External = 23.5705

Long Chord = 1,519.3678

Mid. Ord. = 23.5253'

P.C. Station 1428+79.1975 N 1,669,393.2861 E 2,251,703.0139

P.T. Station 1443+99.5365 N 1,667,878.4692 E 2,251,585.5041

C.C. N 1,669,583.6314 E 2,239,426.7895

Course from PT 00298200 to PC 00298210 187° 58' 59.5476" Dist 2,306.8573'

USER NAME = bartonrw DESIGNED -REVISED -DRAWN SKV REVISED PLOT SCALE = 1000.0000 ' / in. CHECKED -REVISED PLOT DATE = May-06-2019 08:20:16 AM REVISED DATE

Curve Data

Curve 00298210

P.I. Station 1476+20.7306 N 1,664,688.4923 E 2,251,138.1354

Delta = 8° 31' 05.0292" (LT) Degree = 0° 27' 59.9955"

Tangent = 914.3368'

Length = 1,825.3043Radius = 12,277.7000'

External = 33.9989'

Long Chord = 1,823.6237Mid. Ord. = 33.9050'

P.C. Station 1467+06.3938 N 1,665,593.9681 E 2,251,265.1211

P.T. Station 1485+31.6981 N 1,663,774.1953 E 2,251,146.6706

C.C. N 1,663,888.8060 E 2,263,423.8357

Course from PT 00298210 to PC 00298220 179° 27' 54.5185" Dist 3,134.8674'

Curve Data

Curve 00298220 P.I. Station 1521+49.1367 N 1,660,156.9143 E 2,251,180.4389

Delta = 1° 17' 12.4887" (RT)

Degree = 0° 07' 59.9999"

Tangent = 482.5713

Length = 965.1019

Radius = 42,971.8400'

External = 2.7095'

Long Chord = 965.0817

Mid. Ord. = 2.7094'

P.C. Station 1516+66.5654 N 1,660,639.4645 E 2,251,175.9342

P.T. Station 1526+31.6674 N 1,659,674.3846 E 2,251,174.1058

C.C. N 1,660,238.3283 E 2,208,205.9665

Course from PT 00298220 to I7437 180° 45' 06.9871" Dist 5,075.8952'

Point I7437 N 1,654,598.9265 E 2,251,107.4925 Sta 1577+07.5626

Ending chain I74 description

07475 05 111111010							F.A.I. RTE	SECT	ION	COUNTY	TOTAL SHEETS	SHEET NO.
STATE OF ILLINOIS	HORIZONTAL & VERTICAL CONTROL					I-74	(37-3,4	I)RS-2	HENRY	142	62	
DEPARTMENT OF TRANSPORTATION										CONTRAC	NO. 64	1C06
	SCALE:	SHEET 6	OF 9	SHEETS	STA.	TO STA.			ILLINOIS FI	ED. AID PROJECT		

Chain I74NBND contains: CUR 00298260 CUR 00298270 CUR 00298280 A0021013

Beginning chain I74NBND description

Curve Data

*_____

Curve 00298260
P.I. Station 1580+46.1271 N 1,654,259.8137 E 2,251,147.0451
Delta = 2° 21' 02.1611" (LT)
Degree = 0° 14' 27.0757"
Tangent = 488.0398'
Length = 975.9426'
Radius = 23,788.5589'
External = 5.0057'
Long Chord = 975.8742'
Mid. Ord. = 5.0047'
P.C. Station 1575+58.0873 N 1,654,747.8114 E 2,251,153.4499

P.T. Station 1585+34.0299 N 1,653,771.9639 E 2,251,160.6605 C.C. N 1,654,435.6211 E 2,274,939.9602

Course from PT 00298260 to PC 00298270 178° 24' 04.8434" Dist 1,490.7049'

Curve Data

Curve 00298270
P.I. Station 1606+00.9645 N 1,651,705.8338 E 2,251,218.3242
Delta = 5° 22' 27.0693" (RT)
Degree = 0° 27' 59.9955"
Tangent = 576.2297'
Length = 1,151.6144'
Radius = 12,277.7000'
External = 13.5147'
Long Chord = 1,151.1922'
Mid. Ord. = 13.4998'

Mid. Ord. = 13.4998'

P.C. Station 1600+24.7348 N 1,652,281.8392 E 2,251,202.2484

P.T. Station 1611+76.3492 N 1,651,130.8547 E 2,251,180.3808

C.C. N 1,651,939.3139 E 2,238,929.3273

Course from PT 00298270 to PC 00298280 183° 46' 31.9127" Dist 875.8793'

Curve Data

Curve 00298280
P.I. Station 1626+38.0365 N 1,649,672.3397 E 2,251,084.1319
Delta = 3° 01' 27.5415" (LT)
Degree = 0° 15' 29.4914"
Tangent = 585.8080'
Length = 1,171.3439'
Radius = 22,191.1465'
External = 7.7308'
Long Chord = 1,171.2080'
Mid. Ord. = 7.7281'
P.C. Station 1620+52.2285 N 1,650,256.8763 E 2,251,122.7061
P.T. Station 1632+23.5724 N 1,649,086.5821 E 2,251,076.4515
C.C. N 1,648,795.6387 E 2,273,265.6907

Course from PT 00298280 to A0021013 180° 45' 04.3712" Dist 2,558.3682'

Point A0021013 N 1,646,528.4338 E 2,251,042.9093 Sta 1657+81.9406

Ending chain I74NBND description

Chain I74SBND contains: CUR 00298230 CUR 00298240 CUR 00298250

Beginning chain I74SBND description

Curve Data

Curve 00298230 P.I. Station 1583+74.7998 N 1,653,932.3241 E 2,251,054.7393

Delta = 6° 14' 53.7492" (RT) Degree = 0° 28' 07.2613" Tangent = 667.2371' Length = 1,333.1515' Radius = 12,224.8289'

External = 18.1955' Long Chord = 1,332.4910' Mid. Ord. = 18.1685'

P.C. Station 1577+07.5627 N 1,654,599.5038 E 2,251,063.4958 P.T. Station 1590+40.7142 N 1,653,270.0607 E 2,250,973.4211 C.C. N 1,654,759.9367 E 2,238,839.7197

Course from PT 00298230 to PC 00298240 187° 00' 00.7487" Dist 1,456.5414'

Curve Data

Curve 00298240 P.I. Station 1619+26.1310 N 1,650,406.1527 E 2,250,621.7669

Delta = 13° 16' 35.0761" (LT)
Degree = 0° 27' 59.9955"
Tangent = 1,428.8754'
Length = 2,844.9526'
Radius = 12,277.7000'
External = 82.8664'
Long Chord = 2,838.5922'
Mid. Ord. = 82.3109'

P.C. Station 1604+97.2556 N 1,651,824.3769 E 2,250,795.9082 P.T. Station 1633+42.2082 N 1,648,985.8413 E 2,250,777.9736 C.C. N 1,650,328.0574 E 2,262,982.0866

Course from PT 00298240 to PC 00298250 173° 43' 25.6726" Dist 952.5510'

Curve Data

Curve 00298250 P.I. Station 1650+51.5767 N 1,647,286.7180 E 2,250,964.8443

Delta = 7° 01' 38.7074" (RT) Degree = 0° 27' 53.4860" Tangent = 756.8175' Length = 1,511.7370' Radius = 12,325.4573' External = 23.2135' Long Chord = 1,510.7896' Mid. Ord. = 23.1699'

P.C. Station 1642+94.7592 N 1,648,038.9995 E 2,250,882.1079 P.T. Station 1658+06.4962 N 1,646,529.9656 E 2,250,954.9218

SCALE:

C.C. N 1,646,691.5625 E 2,238,630.5239

Ending chain I74SBND description

 USER NAME
 = bartonrw
 DESIGNED
 REVISED

 DRAWN
 SKV
 REVISED

 PLOT SCALE
 = 1000.0000 ° / in.
 CHECKED
 REVISED

 PLOT DATE
 = May-06-2019 08:20:33 AM
 DATE
 REVISED

STATE OF ILLINOIS DEPARTMENT OF TRANSPORTATION

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Chain EBRESTAREA contains:
EBRA1000 EBRA1001 CUR EBRA200 CUR EBRA210 CUR EBRA220 CUR EBRA230 CUR EBRA240 -
CUR EBRA250 CUR EBRA260 CUR EBRA270 EBRA1002
Beginning chain EBRESTAREA description
_____
Point EBRA1000 N 1,664,904.4245 E 2,251,132.3255 Sta 0+00.0000
Course from EBRA1000 to EBRA1001 186° 48' 17.9334" Dist 412.8929'
Point EBRA1001 N 1,664,494.4403 E 2,251,083.4017 Sta 4+12.8929
Course from EBRA1001 to PC EBRA200 185° 24' 57.0168" Dist 311.9699'
                 Curve Data
Curve EBRA200
P.I. Station 8+13.4710 N 1,664,095.6505 E 2,251,045.5937
Delta = 12° 14' 14.5683" (RT)
Degree = 6^{\circ} 55' 54.1281"
Tangent = 88.6082'
Length = 176.5422'
Radius = 826.5759
External = 4.7358'
Long Chord = 176.2068
Mid. Ord. = 4.7088'
P.C. Station 7+24.8628 N 1,664,183.8631 E 2,251,053.9569
P.T. Station 9+01.4050 N 1,664,011.2149 E 2,251,018.7229
C.C. N 1,664,261.8782 E 2,250,231.0709
                 Curve Data
Curve EBRA210
P.I. Station 10+37.1907 N 1,663,881.8234 E 2,250,977.5452
Delta = 16^{\circ} 42' 35.7564'' (LT)
Degree = 6^{\circ} 11' 49.3440"
Tangent = 135.7857
Length = 269.6438
Radius = 924.5669
External = 9.9178
Long Chord = 268.6892'
Mid_{0} Ord_{0} = 9.8126'
P.C. Station 9+01.4050 N 1,664,011.2149 E 2,251,018.7229
P.T. Station 11+71.0488 N 1,663,746.0561 E 2,250,975.3098
C.C. N 1.663.730.8353 E 2.251.899.7513
Course from PT EBRA210 to PC EBRA220 180° 56' 35.8287" Dist 32.7030'
                 Curve Data
Curve EBRA220
P.I. Station 12+54.2318 N 1,663,662.8843 E 2,250,973.9403
Delta = 44^{\circ} 33' 58.7016'' (RT)
Degree = 46^{\circ} 30' 41.2688"
Tangent = 50.4801'
Length = 95.8179'
Radius = 123 1864
External = 9.9418'
Long Chord = 93.4206
Mid. Ord. = 9.1994'
P.C. Station 12+03.7517 N 1,663,713.3576 E 2,250,974.7714
P.T. Station 12+99.5696 N 1,663,627.5084 E 2,250,937.9295
C.C. N 1,663,715.3856 E 2,250,851.6017
                 Curve Data
Curve EBRA230
P.I. Station 13+33.5132 N 1,663,603.7211 E 2,250,913.7152
Delta = 45^{\circ} 46' 18.8623'' (LT)
Degree = 71^{\circ} 15' 14.7361"
Tangent = 33.9435'
Length = 64.2376
Radius = 80.4105
External = 6.8707
Long Chord = 62.5430
Mid. Ord. = 6.3299'
P.C. Station 12+99.5697 N 1,663,627.5084 E 2,250,937.9294
P.T. Station 13+63.8073 N 1,663,569.7780 E 2,250,913.8706
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Curve Data Curve EBRA240 P.I. Station 15+31.2372 N 1,663,402.3498 E 2,250,914.6372 Delta = $35^{\circ} 49' 53.5212"$ (RT) Degree = 62° 46' 57.4172" Tangent = 29.5041'Length = 57.0724Radius = 91.2606'External = 4.6508' Long Chord = 56.1469' Mid. Ord. = 4.4252P.C. Station 15+01.7331 N 1,663,431.8536 E 2,250,914.5021 P.T. Station 15+58.8055 N 1,663,378.3507 E 2,250,897.4750 C.C. N 1,663,431.4357 E 2,250,823.2425 Curve Data Curve EBRA250 P.I. Station 16+00.8031 N 1,663,344.1893 E 2,250,873.0456 Delta = $35^{\circ} 59' 21.2772"$ (LT) Degree = 44° 18' 48.3859" Tangent = 41.9976Length = 81.2152'Radius = 129.2966External = 6.6497Long Chord = 79.8866 Mid. Ord. = 6.3245P.C. Station 15+58.8055 N 1,663,378.3507 E 2,250,897.4750 P.T. Station 16+40.0207 N 1,663,302.1928 E 2,250,873.3535 C.C. N 1,663,303.1407 E 2,251,002.6466 Course from PT EBRA250 to PC EBRA260 179° 34' 47.9121" Dist 317.5273' Curve Data Curve EBRA260 P.I. Station 19+94.5493 N 1,662,947.6738 E 2,250,875.9524 Delta = $30^{\circ} 24' 17.6313"$ (LT) Degree = 42° 04' 42.5845" Tangent = 37.0012Length = 72.2576Radius = 136.1640External = 4.9378' Long Chord = 71.4127Mid. Ord. = 4.7650P.C. Station 19+57.5481 N 1,662,984.6740 E 2,250,875.6812 P.T. Station 20+29.8056 N 1,662,915.8995 E 2,250,894.9125 C.C. N 1,662,985.6722 E 2,251,011.8416 Course from PT EBRA260 to PC EBRA270 149° 10' 30.2808" Dist 235.6217' Curve Data Curve EBRA270 P.I. Station 23+81.0685 N 1,662,614.2571 E 2,251,074.9053 Delta = 29° 06' 10.9656" (RT) Degree = $12^{\circ} 51' 39.8367"$ Tangent = 115.6411'Length = 226.2880Radius = 445.4979'External = 14.7642'Long Chord = 223.8632'Mid. Ord. = 14.2906P.C. Station 22+65.4274 N 1,662,713.5624 E 2,251,015.6489 P.T. Station 24+91.7153 N 1,662,498.6682 E 2,251,078.3801 C.C. N 1,662,485.2820 E 2,250,633.0833 Course from PT EBRA270 to EBRA1002 178° 16' 41.2464" Dist 1,156.0751' Point EBRA1002 N 1.661.343.1151 E 2.251.113.1177 Sta 36+47.7904

SCALE:

Ending chain EBRESTAREA description

USER NAME = bartonrw	DESIGNED -	REVISED -
	DRAWN SKV	REVISED -
PLOT SCALE = 1000.0000 ' / in.	CHECKED -	REVISED -
	0.100	0.00.40.00

Course from PT EBRA230 to PC EBRA240 179° 44' 15.6681" Dist 137.9259'

C.C. N 1,663,570.1461 E 2,250,994.2803

STATE OF ILLINOIS
DEPARTMENT OF TRANSPORTATION

		\/EDZI			F.A.I. RTE.	SECTION		COUNTY	TOTAL SHEETS	SHEET NO.
HORIZONTAL & VERTICAL CONTROL					I-74	(37-3,4)RS-2	HENRY	142	64	
								CONTRACT	F NO. 64	IC06
SHEET 8	OF 9	SHEETS	STA.	TO STA.		ILLING	IS FED. A	ID PROJECT		

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Chain WBRESTAREA contains:
WBRA1000 CUR WBRA200 CUR WBRA210 CUR WBRA220 CUR WBRA230 CUR WBRA240 CUR WBRA2-
50 CUR WBRA260 CUR WBRA270 WBRA1001
Beginning chain WBRESTAREA description
Point WBRA1000 N 1,654,794.2481 E 2,251,166.2261 Sta 0+00.0000
Course from WBRA1000 to PC WBRA200 3° 56' 35.2752" Dist 687.7775'
                  Curve Data
Curve WBRA200
P.I. Station 7+60.3155 N 1,655,552.7638 E 2,251,218.5102
Delta = 10^{\circ} 18' 32.6376" (RT)
Degree = 7^{\circ} 07' 30.7526"
Tangent = 72.5380'
Length = 144.6844'
Radius = 804.1277'
External = 3.2651
Long Chord = 144.4893
Mid. Ord. = 3.2519
P.C. Station 6+87 7775 N 1,655,480 3975 E 2,251,213 5220
P.T. Station 8+32.4619 N 1,655,623.0692 E 2,251,236.3683
C.C. N 1,655,425.1006 E 2,252,015.7462
Course from PT WBRA200 to PC WBRA210 14° 15' 07.9128" Dist 46.2023'
                  Curve Data
Curve WBRA210
P.I. Station 9+74.9640 N 1,655,761.1852 E 2,251,271.4510
Delta = 12° 03' 17.0407" (LT)
Degree = 6^{\circ} 16' 55.7463"
Tangent = 96.2998'
Length = 191.8886'
Radius = 912.0407
External = 5.0699
Long Chord = 191.5349'
Mid. Ord. = 5.0419
P.C. Station 8+78.6642 N 1,655,667.8494 E 2,251,247.7429
P.T. Station 10+70.5528 N 1,655,857.4142 E 2,251,275.1435
C.C. N 1,655,892.3851 E 2,250,363.7735
Course from PT WBRA210 to PC WBRA220 2° 11' 50.8721" Dist 35.7437'
                  Curve Data
Curve WBRA220
P.I. Station 11+57.2605 N 1,655,944.0581 E 2,251,278.4682
Delta = 46^{\circ} 30' 43.7788" (RT)
Degree = 48° 18' 55.1021"
Tangent = 50.9640
Length = 96.2680'
Radius = 118.5872
External = 10.4874
Long Chord = 93.6463'
Mid. Ord. = 9.6353
P.C. Station 11+06.2965 N 1,655,893.1316 E 2,251,276.5140
P.T. Station 12+02.5644 N 1,655,977.6880 E 2,251,316.7612
C.C. N 1,655,888 5845 E 2,251,395 0140
                  Curve Data
Curve WBRA230
P.I. Station 12+32.8724 N 1,655,997.6874 E 2,251,339.5338
Delta = 47^{\circ} 55' 50.2982" (LT)
Degree = 84° 01' 53.3674"
Tangent = 30.3079'
Length = 57.0389
Radius = 68.1837'
External = 6.4326
Long Chord = 55.3902'
Mid. Ord. = 5.8780
P.C. Station 12+02.5645 N 1,655,977.6880 E 2,251,316.7612
P.T. Station 12+59.6034 N 1,656,027.9925 E 2,251,339.9459
C.C. N 1,656,028.9195 E 2,251,271.7685
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Curve Data Curve WBRA240 P.I. Station 14+31.3162 N 1,656,199.6895 E 2,251,342.2804 Delta = $35^{\circ} 58' 43.9658"$ (RT) Degree = 63° 58' 15.2899" Tangent = 29.0833'Length = 56.2426'Radius = 89.5654' External = 4.6036Long Chord = 55.3230' Mid. Ord. = 4.3785P.C. Station 14+02.2329 N 1,656,170.6089 E 2,251,341.8850 P.T. Station 14+58.4755 N 1,656,222.9902 E 2,251,359.6848 C.C. N 1,656,169.3912 E 2,251,431.4420 Curve Data Curve WBRA250 P.I. Station 15+01.1851 N 1,656,257.2079 E 2,251,385.2437 Delta = $36^{\circ} 00' 03.8808"$ (LT) Degree = $43^{\circ} 35' 24.0720"$ Tangent = 42.7096'Length = 82.5902'Radius = 131.4424'External = 6.7647Long Chord = 81.2382Mid. Ord. = 6.4336P.C. Station 14+58.4755 N 1,656,222.9902 E 2,251,359.6848 P.T. Station 15+41.0657 N 1,656,299.9138 E 2,251,385.8078 C.C. N 1,656,301.6499 E 2,251,254.3769 Course from PT WBRA250 to PC WBRA260 0° 45' 24.4377" Dist 310.7001' Curve Data Curve WBRA260 P.I. Station 18+86.1926 N 1,656,645.0106 E 2,251,390.3663 Delta = 27° 13' 29.4475" (LT) Degree = 40° 18' 04.7949" Tangent = 34.4268'Length = 67.5532Radius = 142.1685External = 4.1089

Long Chord = 66.9195Mid. Ord. = 3.9935P.C. Station 18+51.7658 N 1,656,610.5868 E 2,251,389.9116 P.T. Station 19+19.3190 N 1,656,675.8289 E 2,251,375.0223 C.C. N 1,656,612.4646 E 2,251,247.7555

Course from PT WBRA260 to PC WBRA270 333° 31' 54.9901" Dist 252.8953'

Curve Data

Curve WBRA270 P.I. Station 22+64.0338 N 1,656,984.4117 E 2,251,221.3833 Delta = 25° 58' 27.3191" (RT) Degree = 14° 23' 29.4466" Tangent = 91.8195'Length = 180.4831Radius = 398.1220External = 10.4511'Long Chord = 178.9416'Mid. Ord. = 10.1837P.C. Station 21+72.2143 N 1,656,902.2165 E 2,251,262.3071 P.T. Station 23+52.6975 N 1,657,076.2278 E 2,251,220.5920 C.C. N 1,657,079.6590 E 2,251,618.6992

Course from PT WBRA270 to WBRA1001 359° 30' 22.3092" Dist 1,099.2632'

Point WBRA1001 N 1,658,175.4502 E 2,251,211.1181 Sta 34+51.9607

SCALE:


Ending chain WBRESTAREA description

Course from PT WBRA230 to PC WBRA240 0° 46' 44.3527" Dist 142.6295'

USER NAME = bartonrw	DESIGNED -	REVISED -
	DRAWN SKV	REVISED -
PLOT SCALE = 1000.0000 ' / in.	CHECKED -	REVISED -
PLOT DATE = May-06-2019 08:21:03 AM	DATE -	REVISED -

STATE OF ILLINOIS **DEPARTMENT OF TRANSPORTATION**

		\/EDZI		01	F.A.I. RTE.	SECTION	COUNTY	TOTAL SHEETS	SHEET NO.
HORIZONTAL & VERTICAL CONTROL					I-74	(37-3,4)RS-2	HENRY	142	65
							CONTRACT	NO. 64	1C06
SHEET 9	OF 9	SHEETS	STA.	TO STA.		ILLINOIS FED. A	ID PROJECT		

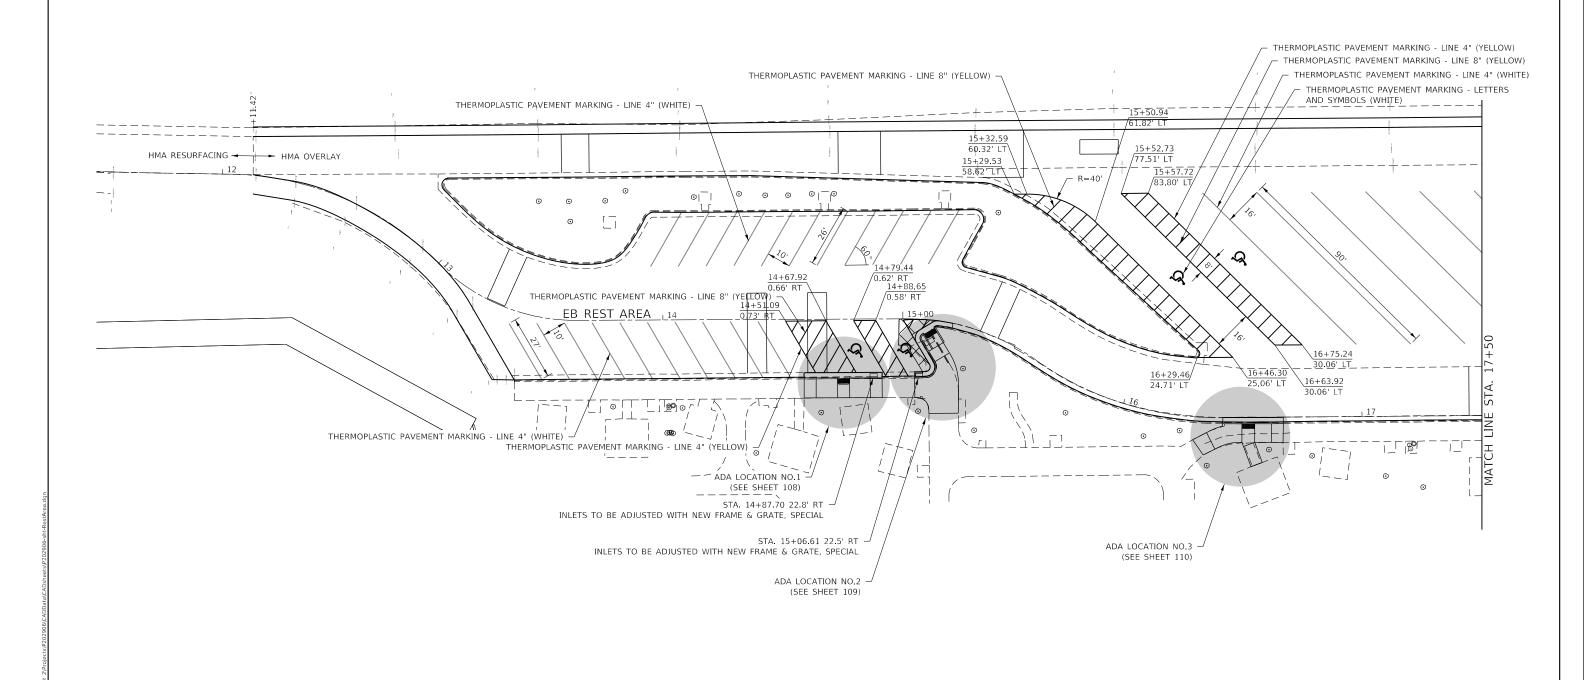


NOTE: NO HEAVY EQUIPMENT IS ALLOWED IN THE DITCHES ALONG 1-74 THROUGH THE REST AREAS DUE TO THE PRESENCE OF WATER MAINS AND SANITARY SEWERS.

COUNTY

HENRY 142 66
CONTRACT NO. 64C06


USER NAME = bartonrw	DESIGNED -	REVISED -			PLAN SHEETS			F.A.I. RTF	SECTION	
	DRAWN -	REVISED -	STATE OF ILLINOIS		EASTBOUND RES			74	(37-3,4) RS-2	_
PLOT SCALE = 40.0000 ' / in.	CHECKED -	REVISED -	DEPARTMENT OF TRANSPORTATION		EASTROUND RES	I AREA		-		_
PLOT DATE = May-06-2019 08:22:09 AM	DATE -	REVISED -		SCALE:	SHEET 1 OF 4 SHEETS	STA.	TO STA.		ILLINOIS	FF

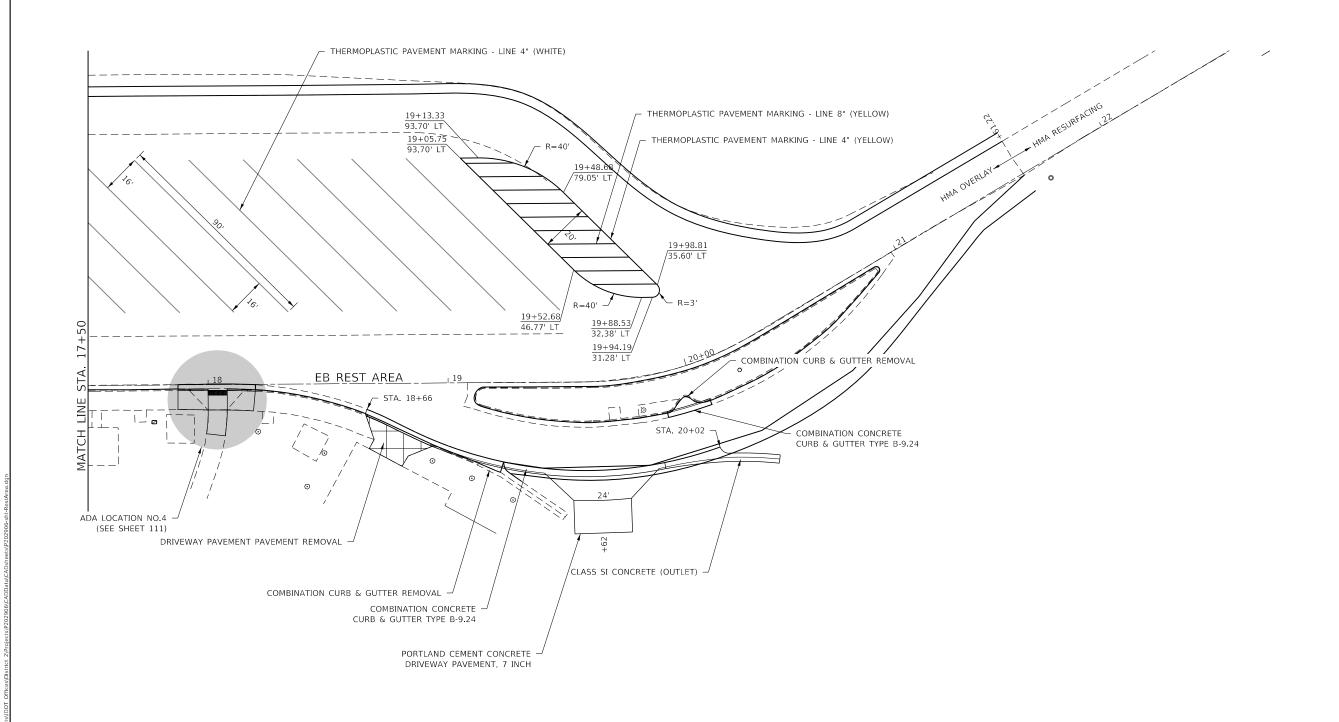

NOTE: NO HEAVY EQUIPMENT IS ALLOWED IN THE DITCHES ALONG 1-74 THROUGH THE REST AREAS DUE TO THE PRESENCE OF WATER MAINS AND SANITARY SEWERS.


USER NAME = bartonrw	DESIGNED -	REVISED -			PLAN SHEETS		F.A. I. RTF	SECTION	COUNTY	TOTAL SHEET
	DRAWN -	REVISED -	STATE OF ILLINOIS				74	(37-3,4) RS-2	HENRY	142 67
PLOT SCALE = 40.0000 ' / in.	CHECKED -	REVISED -	DEPARTMENT OF TRANSPORTATION		EASTBOUND REST AREA				CONTRAC	T NO. 64C06
PLOT DATE = May-06-2019 08:22:45 AM	DATE -	REVISED -		SCALE:	SHEET 2 OF 4 SHEETS STA.	TO STA.		ILLINOIS FED. A	AID PROJECT	



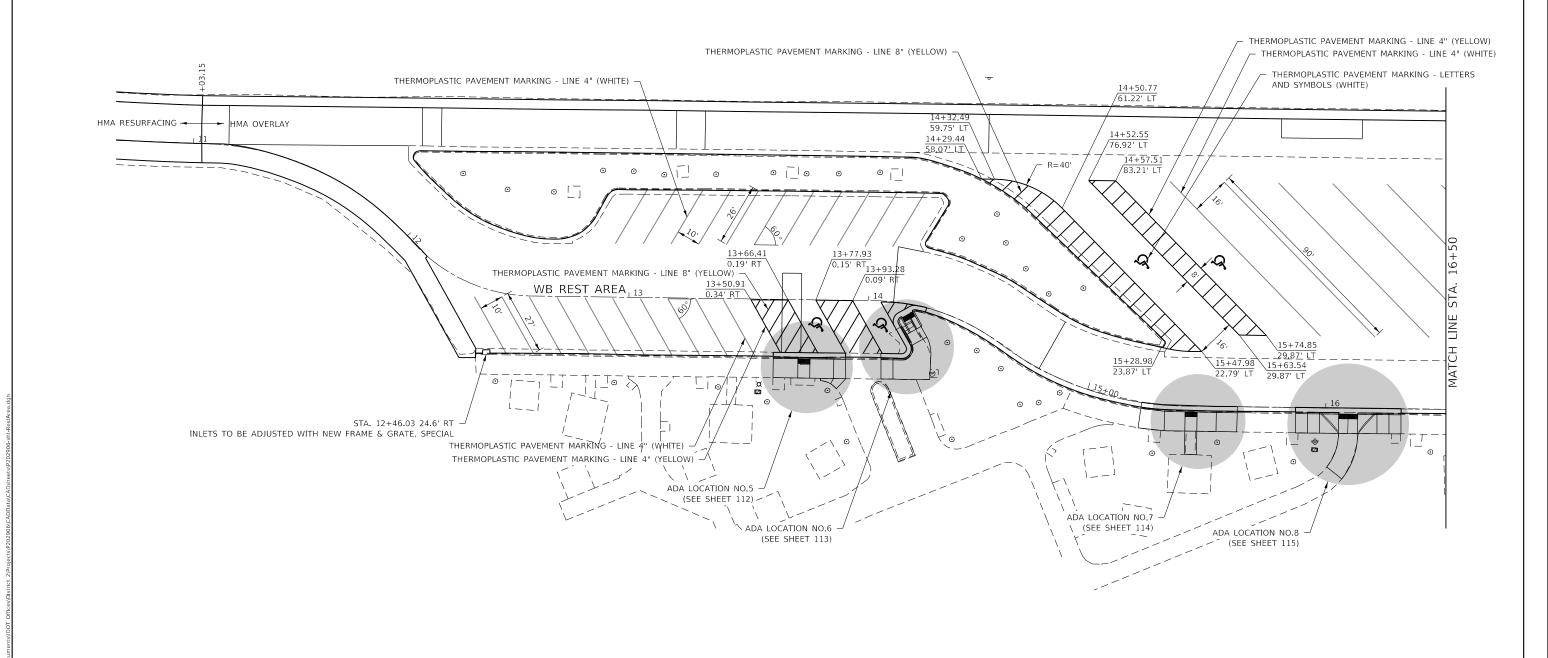

NOTE: NO HEAVY EQUIPMENT IS ALLOWED IN THE DITCHES ALONG 1-74 THROUGH THE REST AREAS DUE TO THE PRESENCE OF WATER MAINS AND SANITARY SEWERS.

USER NAME = bartonrw	DESIGNED -	REVISED -			PLAN SHE	FTS		F.A. I. RTF	SECTION	COUNTY	TOTAL S	SHEET
	DRAWN -	REVISED -	STATE OF ILLINOIS					74	(37-3.4) BS-2	HENRY	142	68
PLOT SCALE = 40.0000 ' / in.	CHECKED -	REVISED -	DEPARTMENT OF TRANSPORTATION		WESTBOUND RE	SI AKEA			(2 : 2 / 1 / 1 / 2	CONTRACT	F NO. 640	C06
PLOT DATE = May-06-2019 08:23:02 AM	DATE -	REVISED -		SCALE:	SHEET 3 OF 4 SHEETS	STA.	TO STA.		ILLINOIS	FED. AID PROJECT		

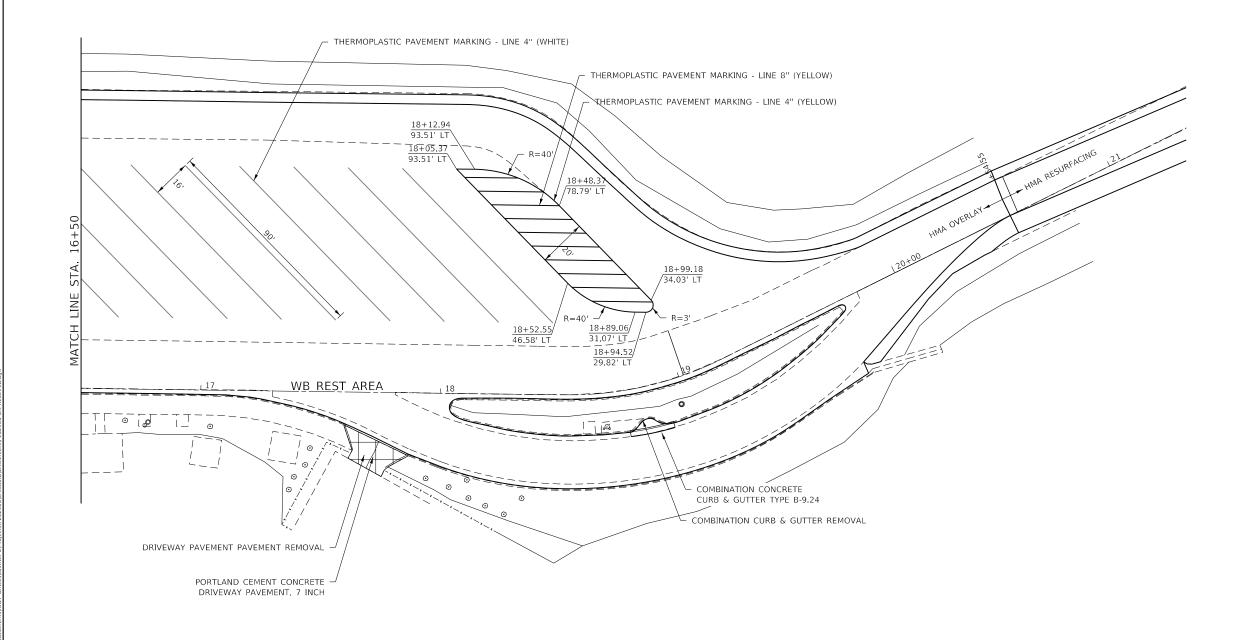

NOTE: NO HEAVY EQUIPMENT IS ALLOWED IN THE DITCHES ALONG I-74 THROUGH THE REST AREAS DUE TO THE PRESENCE OF WATER MAINS AND SANITARY SEWERS.

USER NAME = bartonrw	DESIGNED -	REVISED -		PLAN SHEETS			F.A.I.	SECTION	COUNTY	TOTAL	SHEET			
	DRAWN -	REVISED -	STATE OF ILLINOIS		10					74	(37-3.4) RS-2	HENRY	142	69
PLOT SCALE = 40.0000 ' / in.	CHECKED -	REVISED -	DEPARTMENT OF TRANSPORTATION		V	VESTBOU	IND RE	OI AKEA				CONTRACT	T NO. 6	4C06
PLOT DATE = May-06-2019 08:23:18 AM	DATE -	REVISED -		SCALE:	SHEET 4	OF 4	SHEETS	STA.	TO STA.		ILLINOIS FE	D. AID PROJECT		

STAGING NOTES


- 1) EXISTING CABLE MEDIAN CROSSOVER CLOSURE REMOVAL WILL NOT BE PAID FOR SEPERATELY BUT SHALL BE INDCULDED IN THE COST OF TRAFFIC CONTROL.
- 2) SEE STANDARD 701400 FOR APPROACH TO LANE CLOSURE.
- 3) SEE STANDARD 701416 FOR LANE CLOSURE WITH CROSSOVER AND BARRIER.
- 4) BARRIER WALL OFFESTS ARE TO CENTERLINE OF THE WALL.
- 5) FOR ALL SIGNING AND APPURTENACES NOT COVERED BY A TRAFFIC CONTROL STANDARD SHALL BE CONSIDERED INCIDENTAL TO PAY ITEM TRAFFIC CONTROL AND PROTECTION, 701416.
- 6) FOR PATCHES IN MILLED AREAS, THE PAVEMENT SHALL BE MILLED PRIOR TO PATCHING.
- 7) AFTER STAGE 1 IS COMPLETED, RESTORE PERMANENT PAVEMENT MARKINGS REMOVED FOR THIS STAGE AT LOCATIONS OUTSIDE THE PROJECT LIMITS NOT INCLUDED WITHIN THE LIMITS OF STAGE 2.
- 8) AFTER STAGE 2, INSTALL ALL PERMANENT PAVEMENT MARKINGS EXCEPT AT LOCATIONS WITH RESURFACING TO BE COMPLETED UNDER FLAGGERS OR STANDARD LANE CLOSURES.
- 9) DO NOT INSTALL RUMBLE STRIPS UNTIL AFTER STAGE 2 IS COMPLETED.
- 10) COMBINATION CURB AND GUTTER AND SIDEWALKS SHALL BE INSTALLED PRIOR TO OVERLAYING THE REST AREA PAVEMENT.
- 11) REST AREAS ARE TO REMAIN CLOSED FOR THE DURATION OF THE PROJECT.

USER NAME = bartonrw	DESIGNED -	REVISED -
	DRAWN -	REVISED -
PLOT SCALE = 8.0000 ' / in.	CHECKED -	REVISED -
PLOT DATE = May-06-2019 08:24:05 AM	DATE -	REVISED -


SCALE:

STAGING NOTES						F.A.I. RTE	F.A.I. SECTION			COUNTY	TOTAL SHEETS	SHEE NO.		
							74	(37-3,	4)RS-2		HENRY	142	70	
												CONTRACT	NO. 6	4C06
	SHEET	1	OF	1	SHEETS	STA.	TO STA.			AID PROJECT				

STA. 1195+36 TO STA. 1219+56

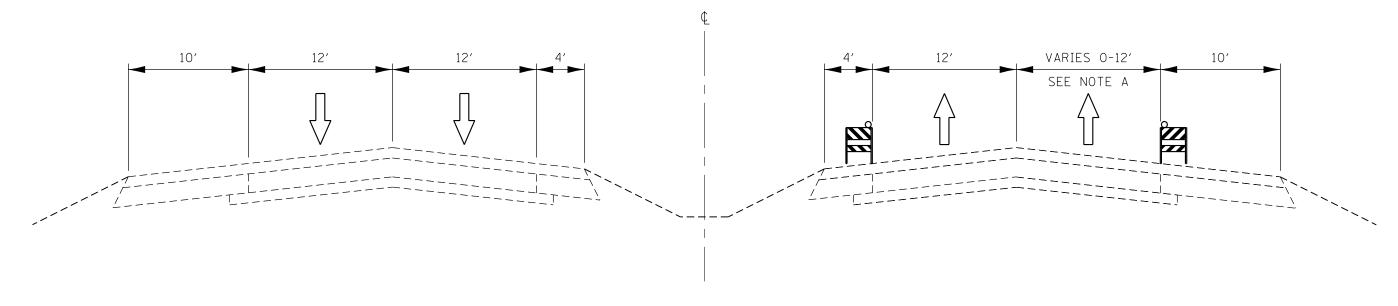

STA. 1219+56 TO STA. 1226+80

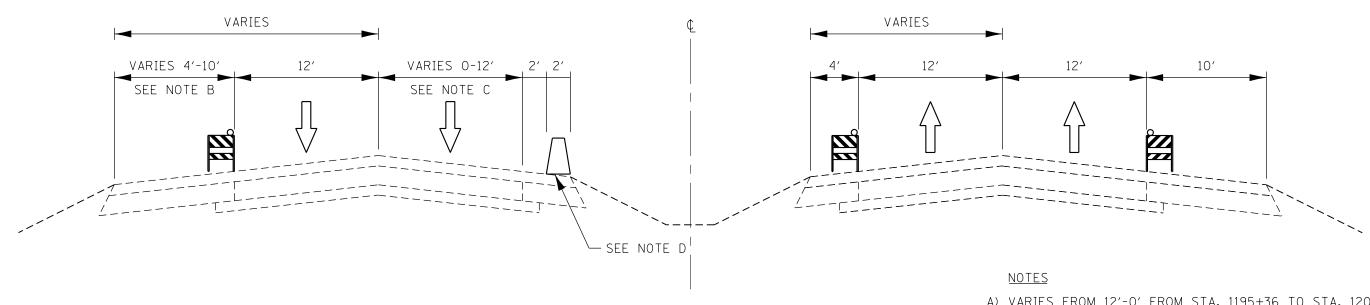

- A) VARIES FROM 12'-0' FROM STA. 1195+36 TO STA. 1205+36 VARIES FROM 0'-12' FROM STA. 1215+36 TO STA. 1219+56
- B) VARIES FROM 10'-4' FROM STA. 1222+90 TO STA. 1225+00
- C) VARIES FROM 12'-0' FROM STA. 1220+17 TO STA. 1222+90
- D) TEMP. CONC. BARRIER WALL BEGINS AT STA. 1220+41

USER NAME = bartonrw	DESIGNED -	REVISED -		STAGING TYPICALS			F.A.I. RTF	SECTION	COUNTY	TOTAL	SHEET
	DRAWN -	REVISED -	STATE OF ILLINOIS DEPARTMENT OF TRANSPORTATION	STAGE 1			74	(37-3, 4)RS-2	HENRY	142	71
PLOT SCALE = 8.0000 ' / in.	CHECKED -	REVISED -							CONTRACT	ONTRACT NO. 64C0	
PLOT DATE = May-06-2019 08:24:27 AM	DATE -	REVISED -		SCALE:	SHEET 1 OF 6 SHEETS STA. TO STA.		ILLINOIS FED. AID PROJECT				

STA. 1226+80 TO STA. 1285+65 SEE NOTE A STA. 1285+65 TO STA. 1661+37 12′ 12′ WORK ZONE SEE NOTE B <u>NOTES</u> A) EXIT LANE ENDS AT STA. 1252+13 B) WORK ZONE ENDS AT STA. 1662+36 DESIGNED -STAGING TYPICALS STATE OF ILLINOIS DEPARTMENT OF TRANSPORTATION

HENRY 142 72

CONTRACT NO. 64C06

(37-3, 4)RS-2

STAGE 1

SHEET 2 OF 6 SHEETS STA.

DRAWN -


CHECKED -

LOT DATE = May-06-2019 08:24:42 AM

REVISED -

REVISED -

STA. 1661+37 TO STA. 1676+26

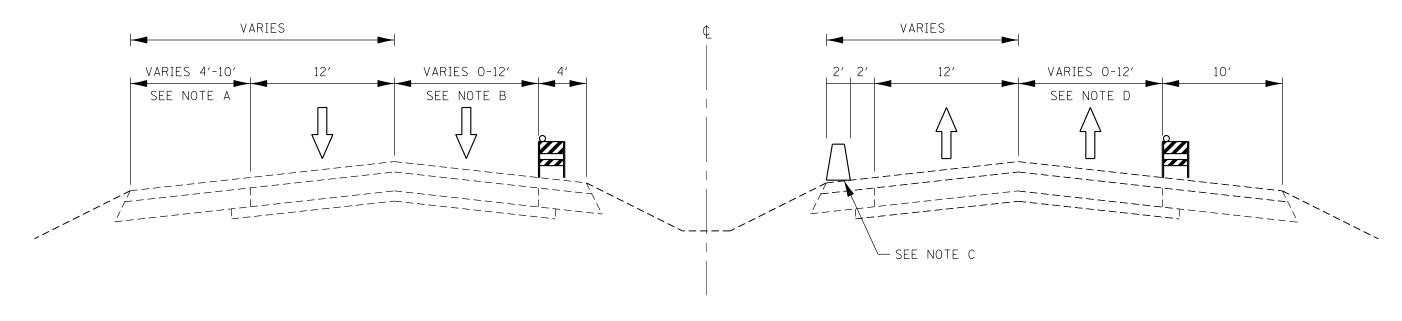


<u>NOTES</u>


- A) VARIES FROM 4'-10' FROM STA. 1662+41 TO STA. 1664+51
- B) VARIES FROM 0'-12' FROM STA. 1666+26 TO STA. 1676+26
- C) TEMP CONC. BARRIER WALL ENDS AT STA. 1669+14
- D) VARIES FROM 0'-12' FROM STA. 1669+14 TO STA. 1670+14

USER NAME = bartonrw	DESIGNED -	REVISED -				STAGIN	IG TYPICALS		F.A.I. RTF.	SECTION	COUNTY
	DRAWN -	REVISED -	STATE OF ILLINOIS				TAGE 1		74	(37-3, 4)RS-2	HENRY
PLOT SCALE = 8.0000 ' / in.	CHECKED -	REVISED -	DEPARTMENT OF TRANSPORTATION			<u> </u>	IAGE I				CONTRACT
PLOT DATE = May-06-2019 08:24:56 AM	DATE -	REVISED -		SCALE:	SHEET 3	OF 6	SHEETS STA.	TO STA.		ILLINOIS FI	.D. AID PROJECT

STA. 1253+00 TO STA. 1285+65

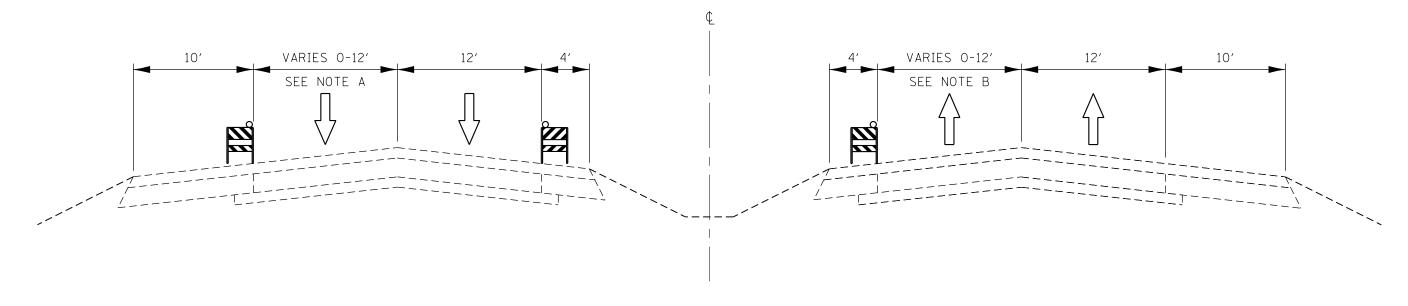


STA. 1285+65 TO STA. 1294+86

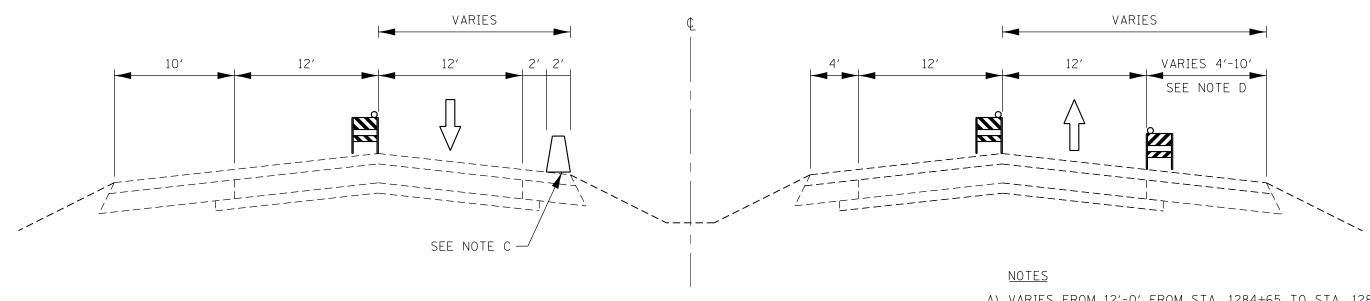


- A) VARIES FROM 12'-0' FROM STA. 1284+65 TO STA. 1285+65
- B) VARIES FROM 12'-0' FROM STA. 1253+00 TO STA. 1263+00
- C) TEMP CONC. BARRIER WALL BEGINS AT STA. 1285+79
- D) VARIES FROM 10'-4' FROM STA. 1288+50 TO STA. 1290+60

USER NAME = bartonrw	DESIGNED -	REVISED -			STAGING TYPICALS		F.A.I. RTF	SECTION	COUNTY	TOTAL SH	HEET
	DRAWN -	REVISED -	STATE OF ILLINOIS				74	(37-3, 4)RS-2	HENRY	142	74
PLOT SCALE = 8.0000 ' / in.	CHECKED -	REVISED -	DEPARTMENT OF TRANSPORTATION		STAGE 2				CONTRAC	T NO. 64C	.06
PLOT DATE = May-06-2019 08:25:16 AM	DATE -	REVISED -		SCALE:	SHEET 4 OF 6 SHEETS STA.	TO STA.		ILLINOIS FED. A	ID PROJECT		

STA. 1294+86 TO STA. 1661+21

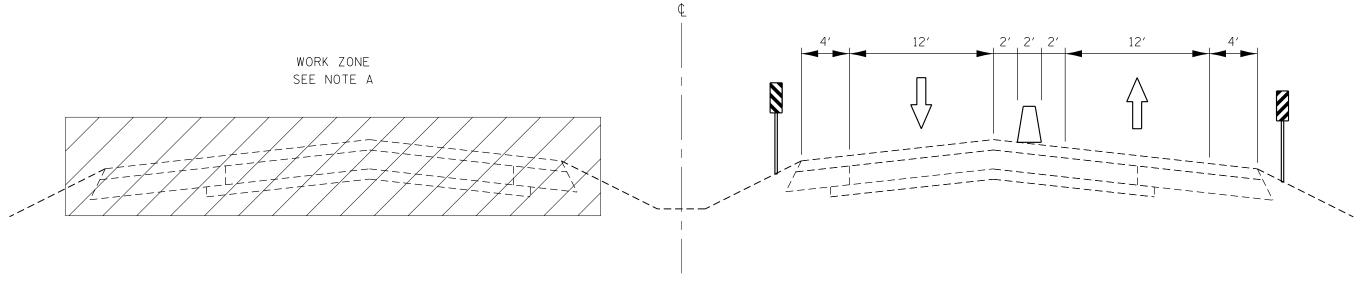


STA. 1661+21 TO STA. 1669+14

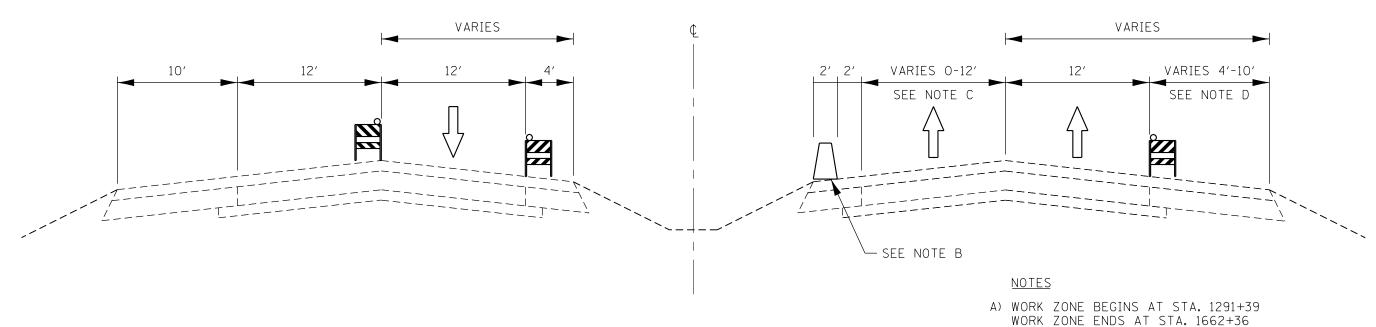

- B) TEMP CONC. BARRIER WALL ENDS AT STA. 1669+83
- C) VARIES FROM 0'-12' FROM STA. 1664+51 TO STA. 1669+84
- C) VARIES FRUM U =12 FRUM STA. 1004+31 TU STA. 1003+04
- D) VARIES FROM 4'-10' FROM STA. 1662+41 TO STA. 1664+51

USER NAME = bartonrw	DESIGNED -	REVISED -				SI	TAGIN	TYP	PICALS		F.A.I. RTF		SECTION	COUNTY	TOTA	AL SHE	.ET O.
	DRAWN -	REVISED -	STATE OF ILLINOIS			•					74	(3	7-3. 4)RS-2	HENRY	142	2 7	5
PLOT SCALE = 8.0000 ' / in.	CHECKED -	REVISED -	DEPARTMENT OF TRANSPORTATION				51	AGE 2	2			,-	, .,	CONTRA	CT NO.	64C06	ā
PLOT DATE = May-06-2019 08:25:31 AM	DATE -	REVISED -		SCALE:	SHEET 5	OI	F 6	SHEETS	STA.	TO STA.			ILLINOIS FED. AI	PROJECT			

STA. 1669+14 TO STA. 1699+63

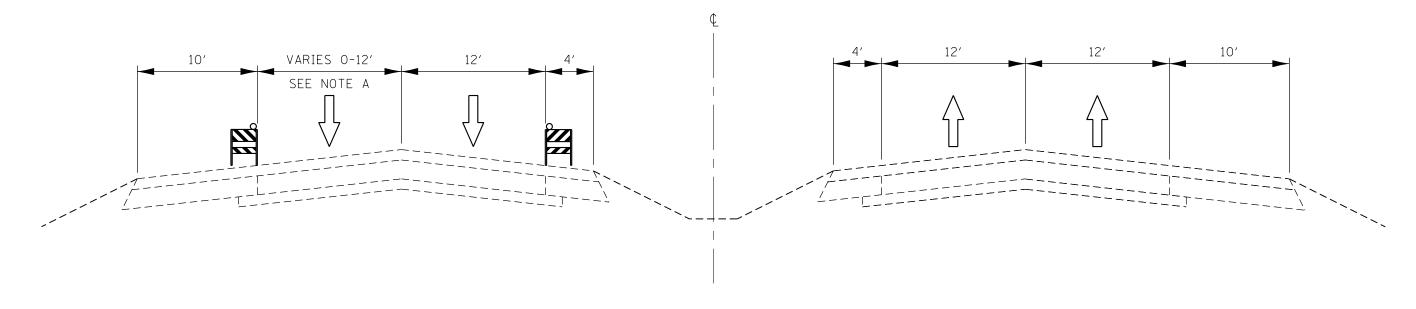



<u>NOTES</u>


A) VARIES FROM 0'-12' FROM STA. 1689+63 TO STA. 1699+63

USER NAME = bartonrw	DESIGNED -	REVISED -
	DRAWN -	REVISED -
PLOT SCALE = 8.0000 ' / in.	CHECKED -	REVISED -
PLOT DATE = May-06-2019 08:25:46 AM	DATE -	REVISED -


STATE OF ILLINOIS DEPARTMENT OF TRANSPORTATION

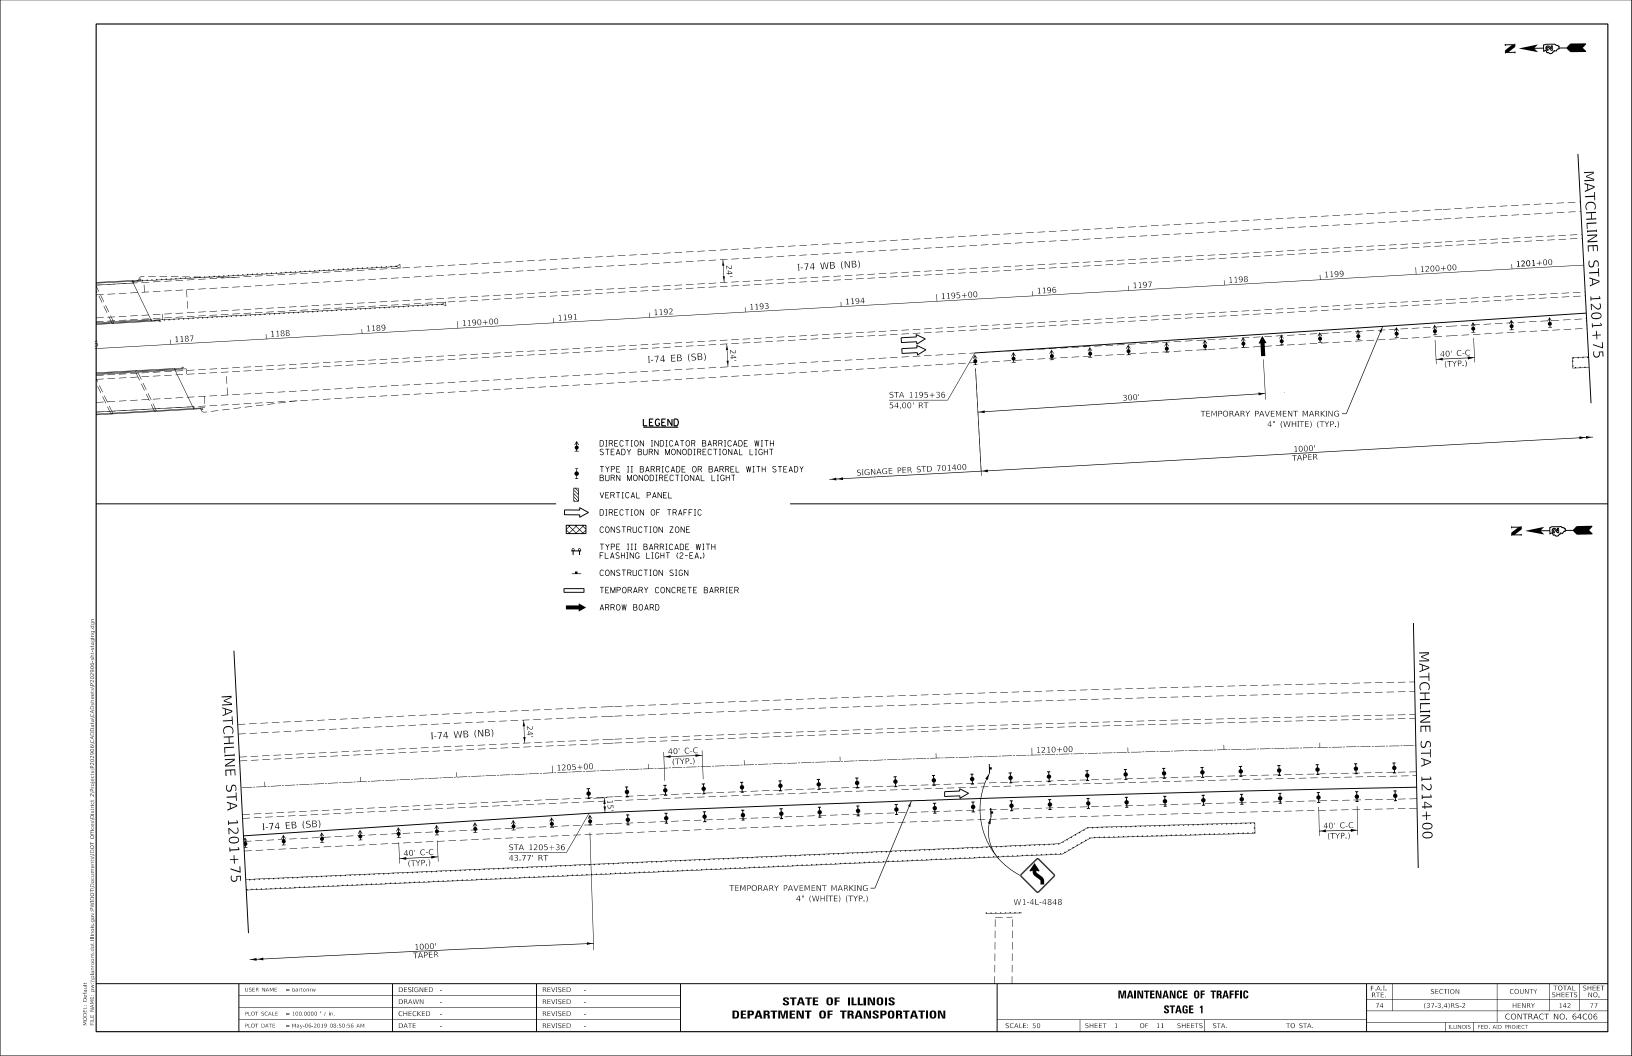

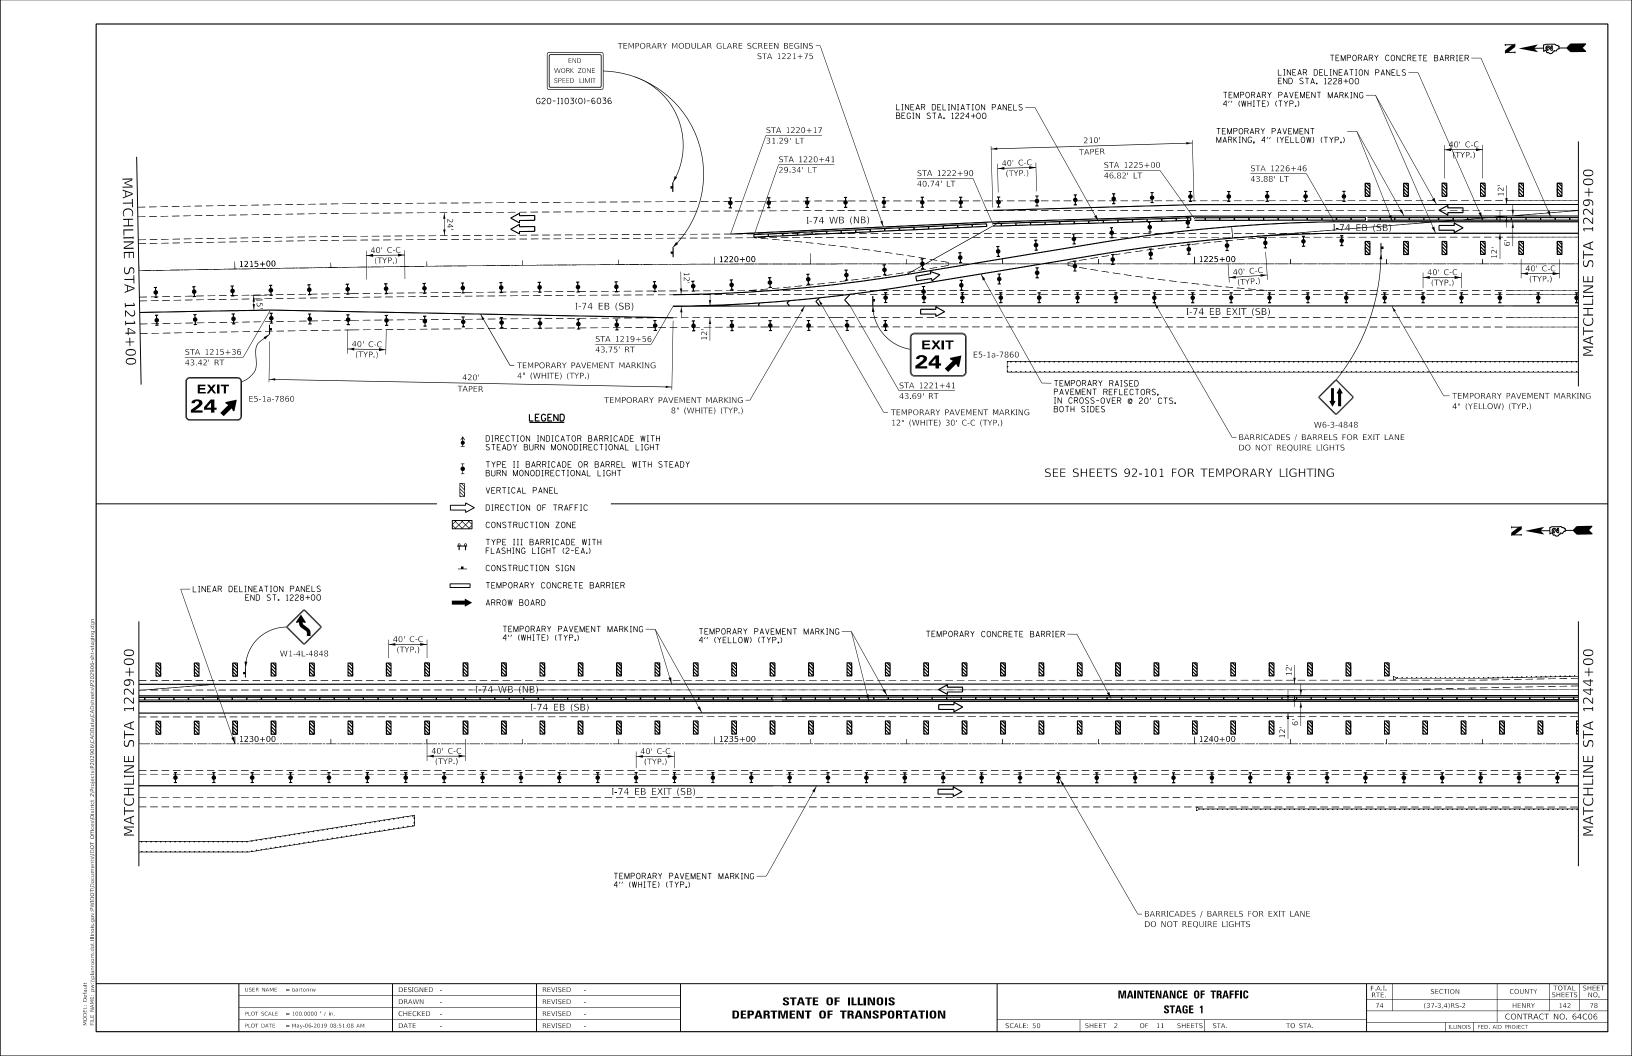

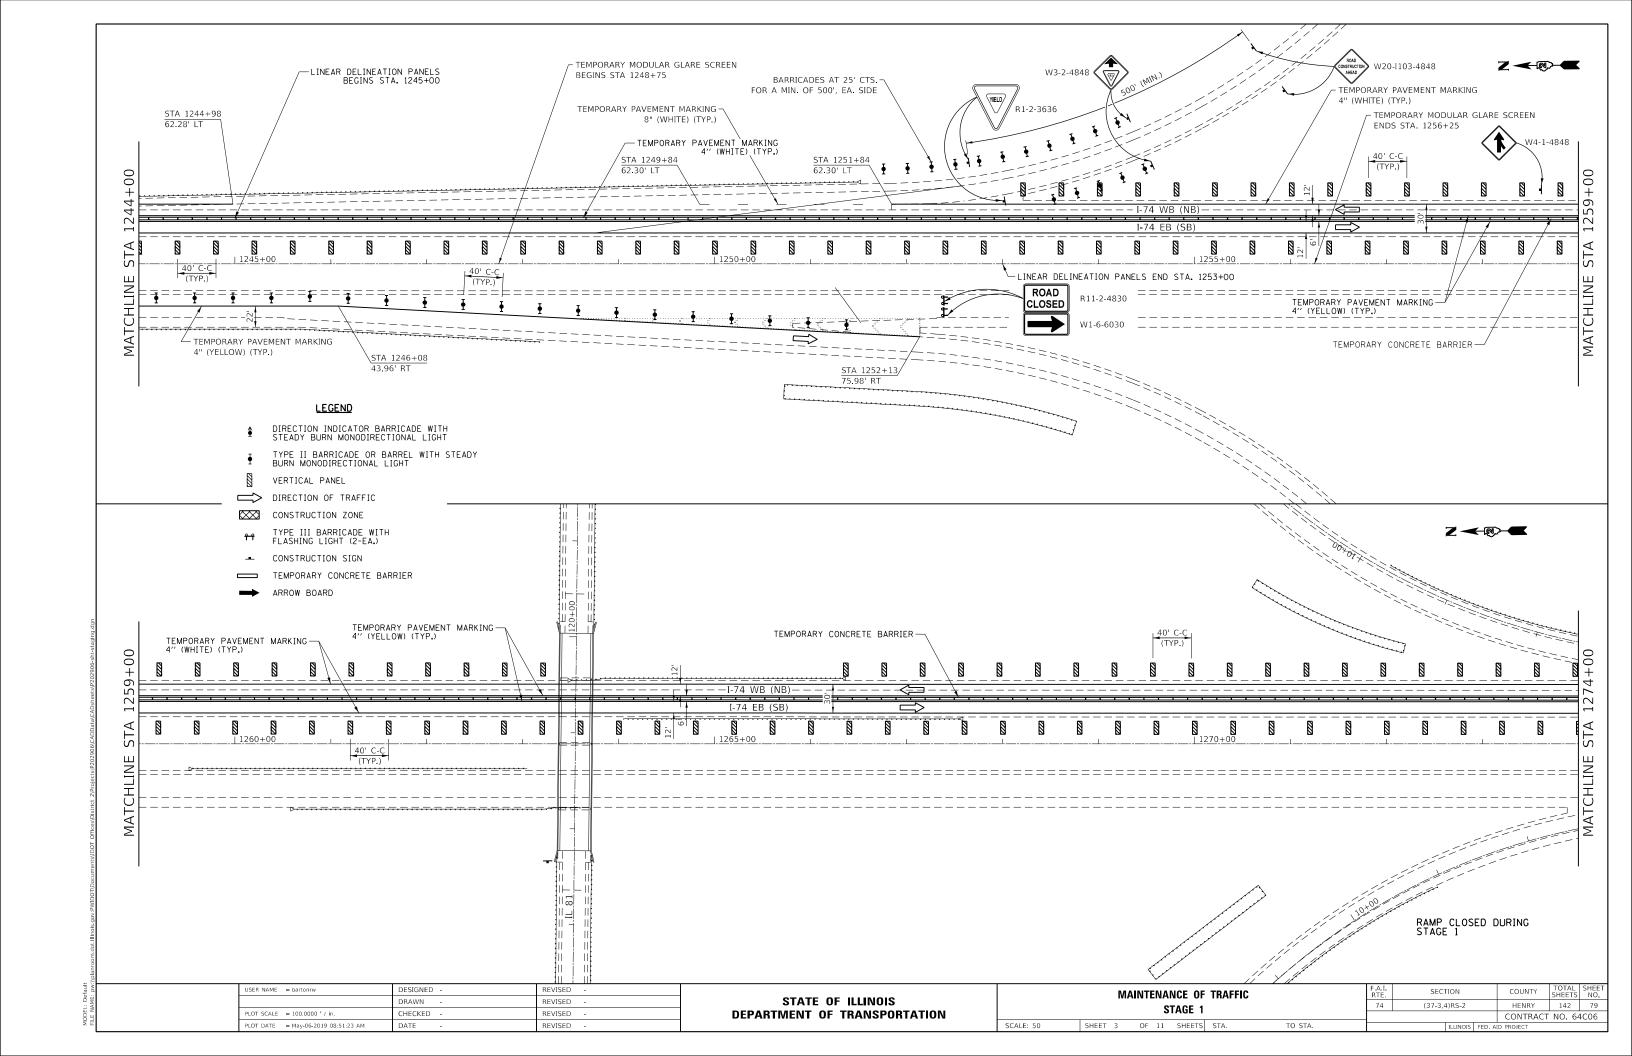


 $Z \leftarrow \mathbb{R} \rightarrow \mathbb{Z}$

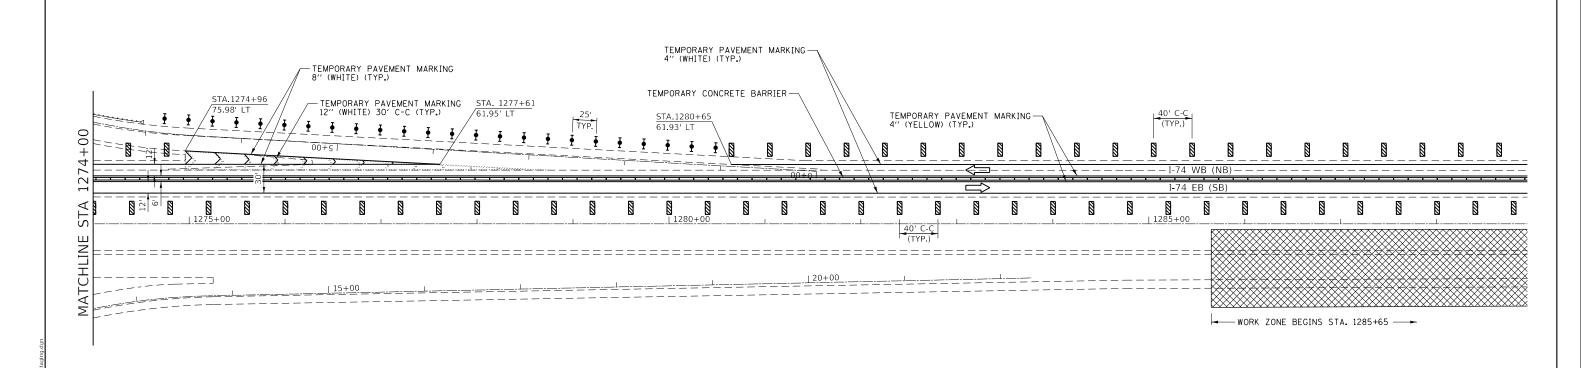



LEGEND


- DIRECTION INDICATOR BARRICADE WITH STEADY BURN MONODIRECTIONAL LIGHT
- TYPE II BARRICADE OR BARREL WITH STEADY BURN MONODIRECTIONAL LIGHT
- VERTICAL PANEL
- DIRECTION OF TRAFFIC
 - CONSTRUCTION ZONE
 - TYPE III BARRICADE WITH FLASHING LIGHT (2-EA.)
 - CONSTRUCTION SIGN
- TEMPORARY CONCRETE BARRIER
 - ARROW BOARD


USER NAME = bartonrw	DESIGNED -	REVISED -		MAINTENANCE OF TRAFFIC		F.A.I. RTE	SECTION	COUNTY	TOTAL SHEET
	DRAWN -	REVISED -	STATE OF ILLINOIS		ŀ	74	(37-3.4)RS-2	HENRY	142 80
PLOT SCALE = 100.0000 ' / in.	CHECKED -	REVISED -	DEPARTMENT OF TRANSPORTATION	STAGE 1			(=- = / - / = =	CONTRAC	T NO. 64C06
PLOT DATE = May-06-2019 08:51:38 AM	DATE -	REVISED -		SCALE: 1"=100' SHEET 4 OF 11 SHEETS STA. 1274+00 TO STA.	1288+00		ILLINOIS FED. A	ID PROJECT	

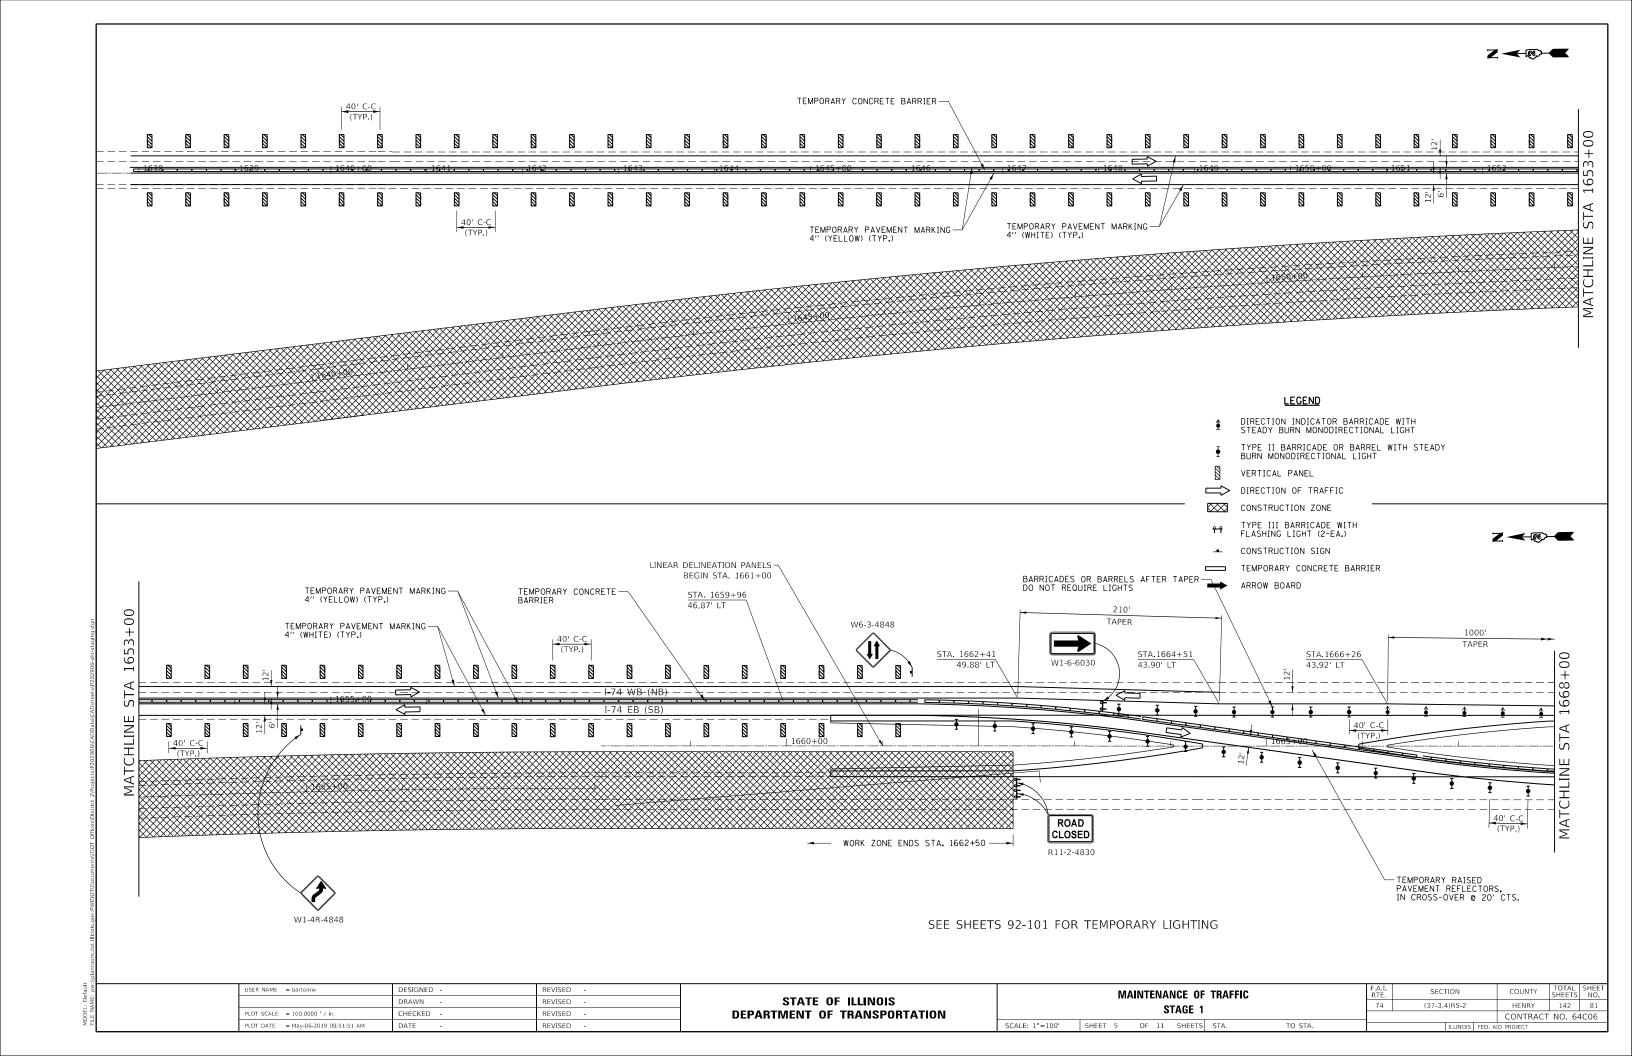


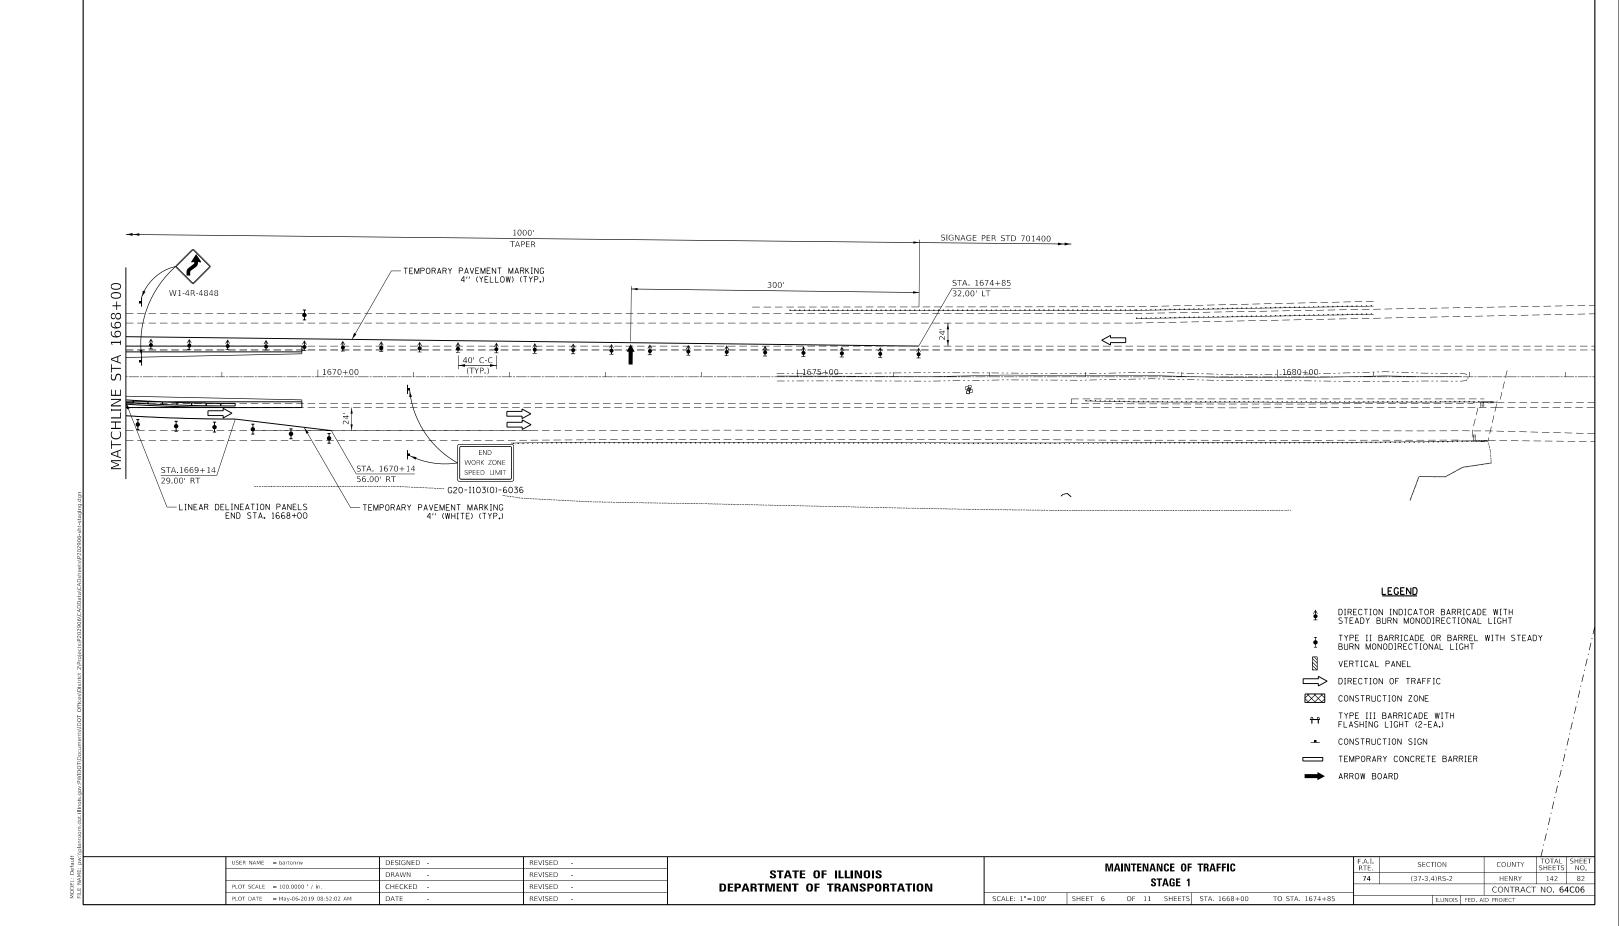


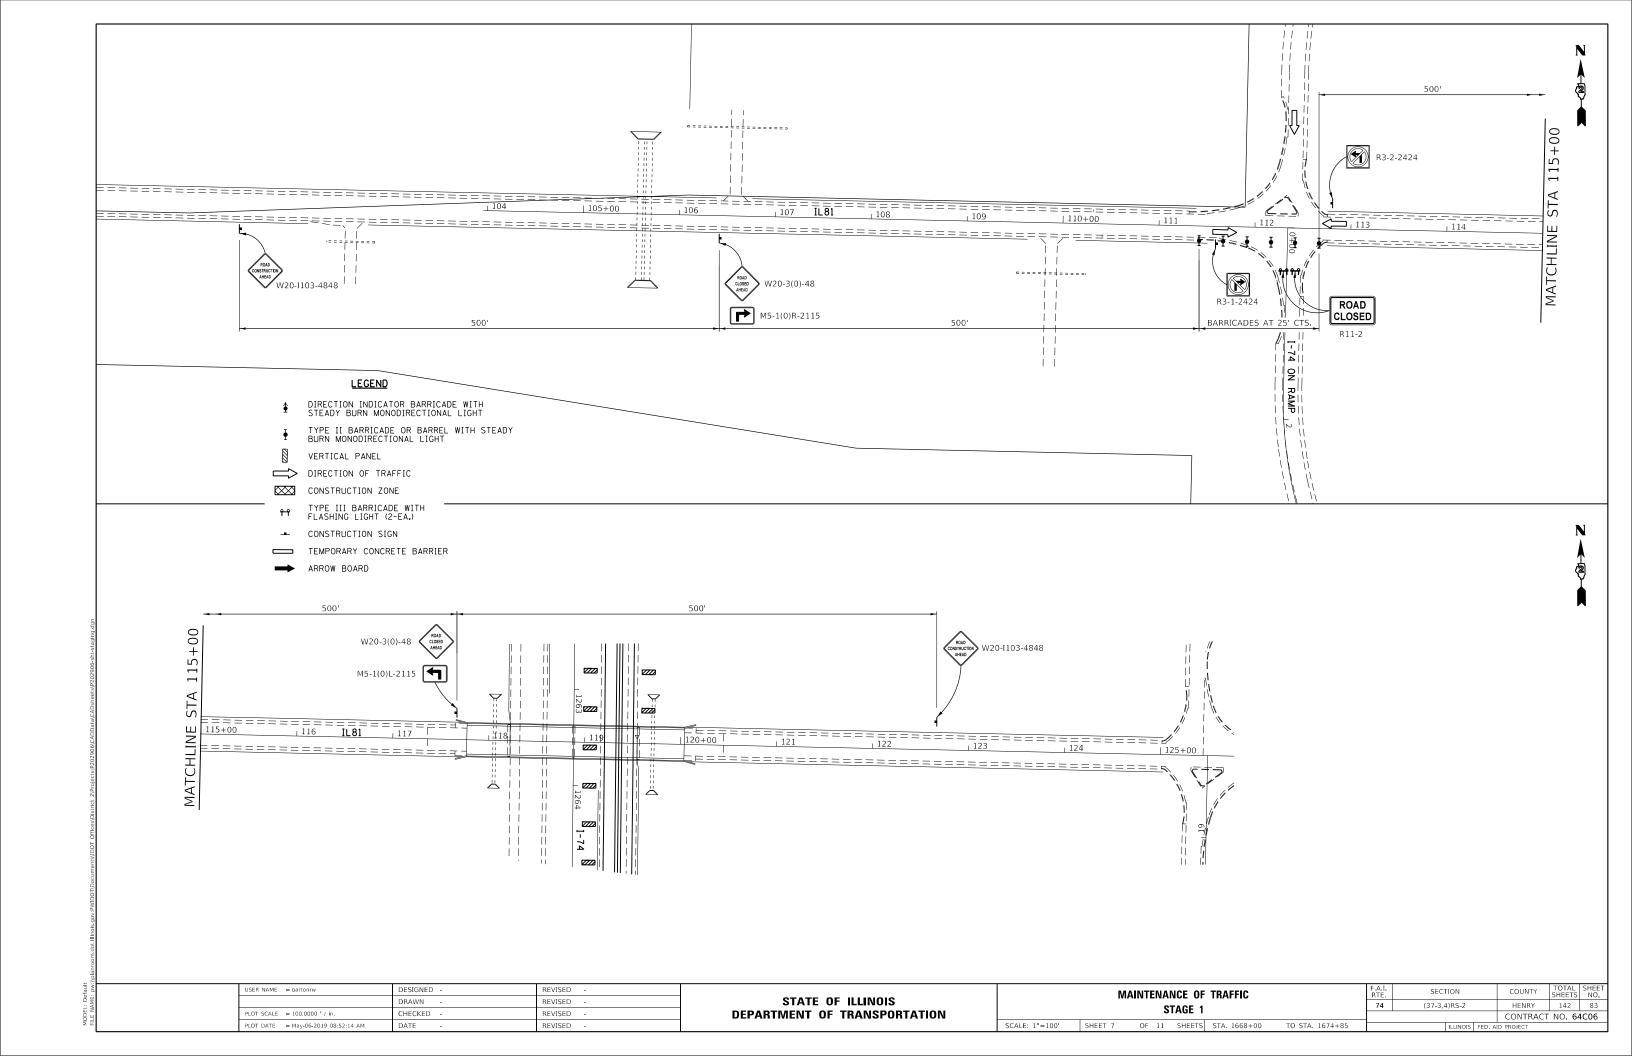


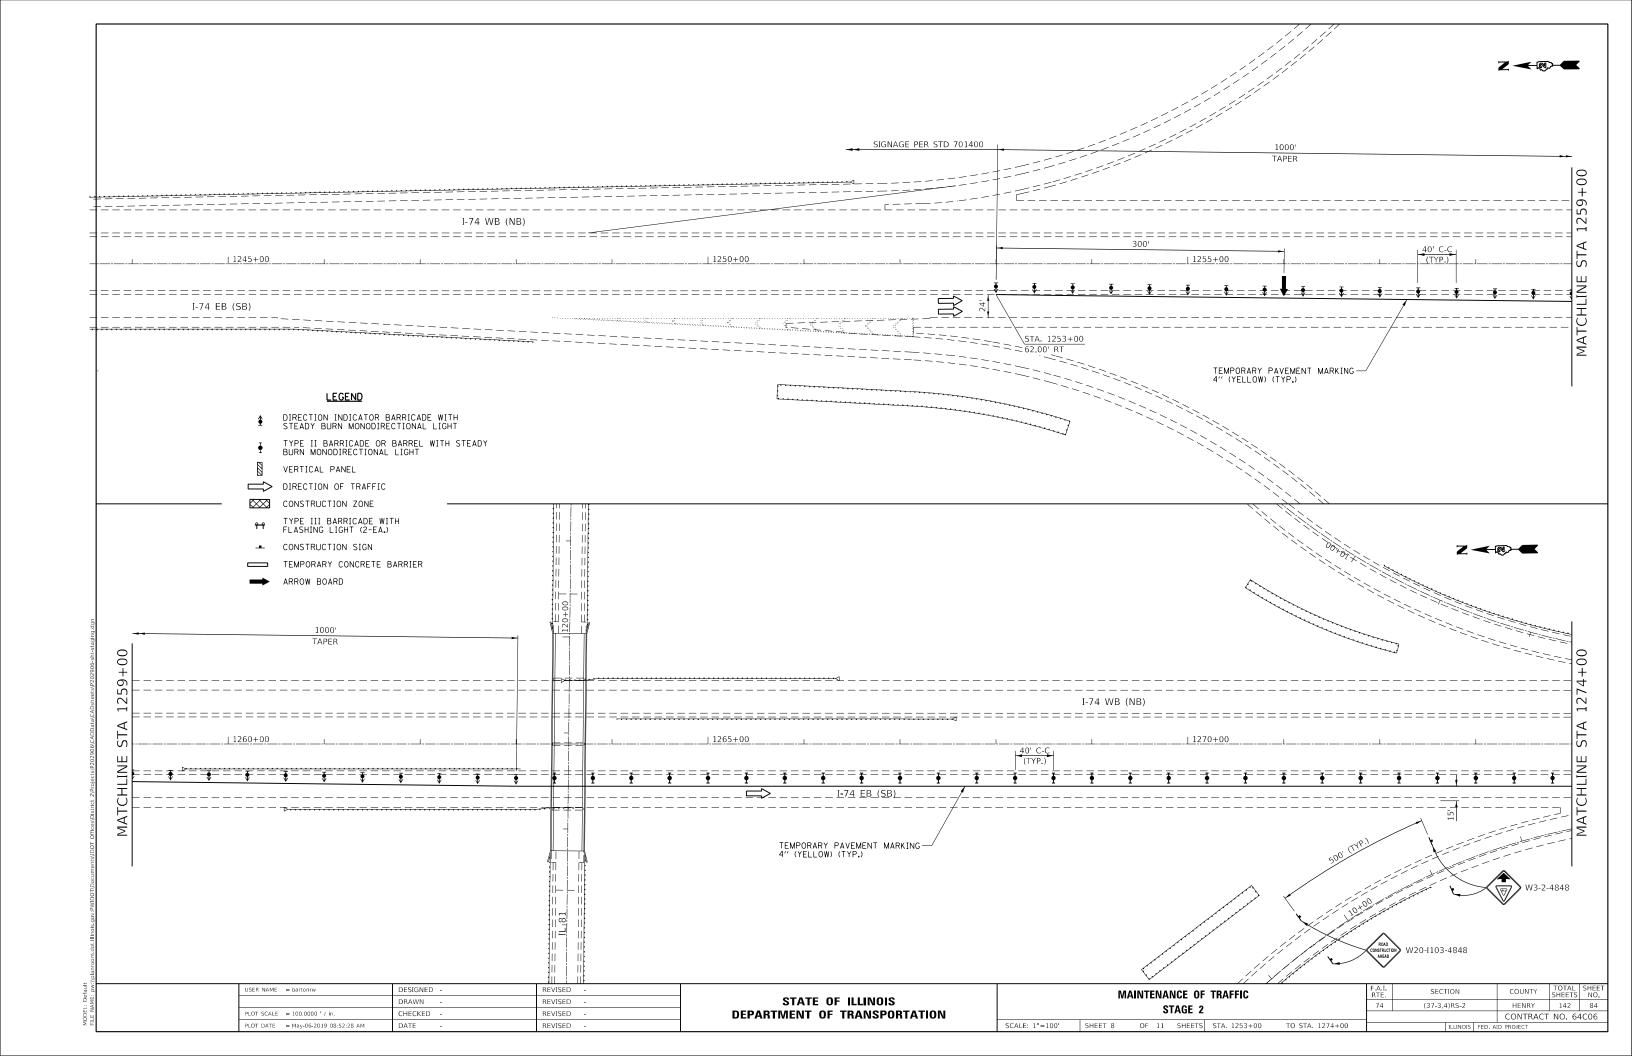


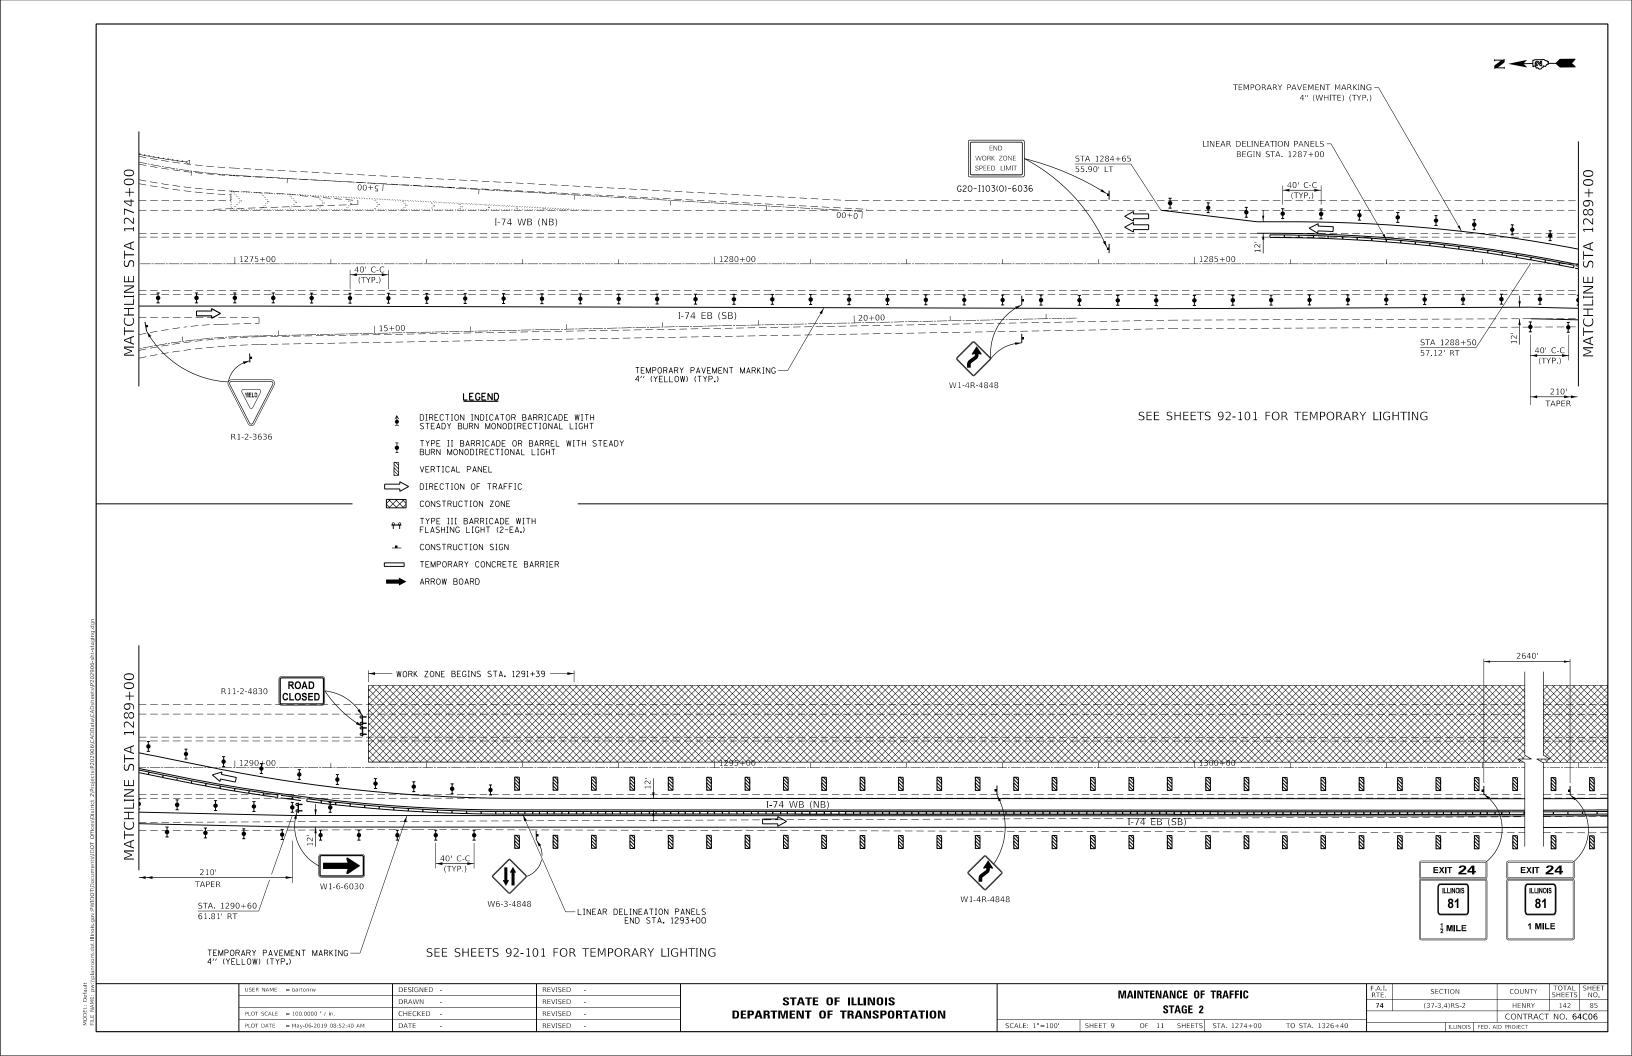

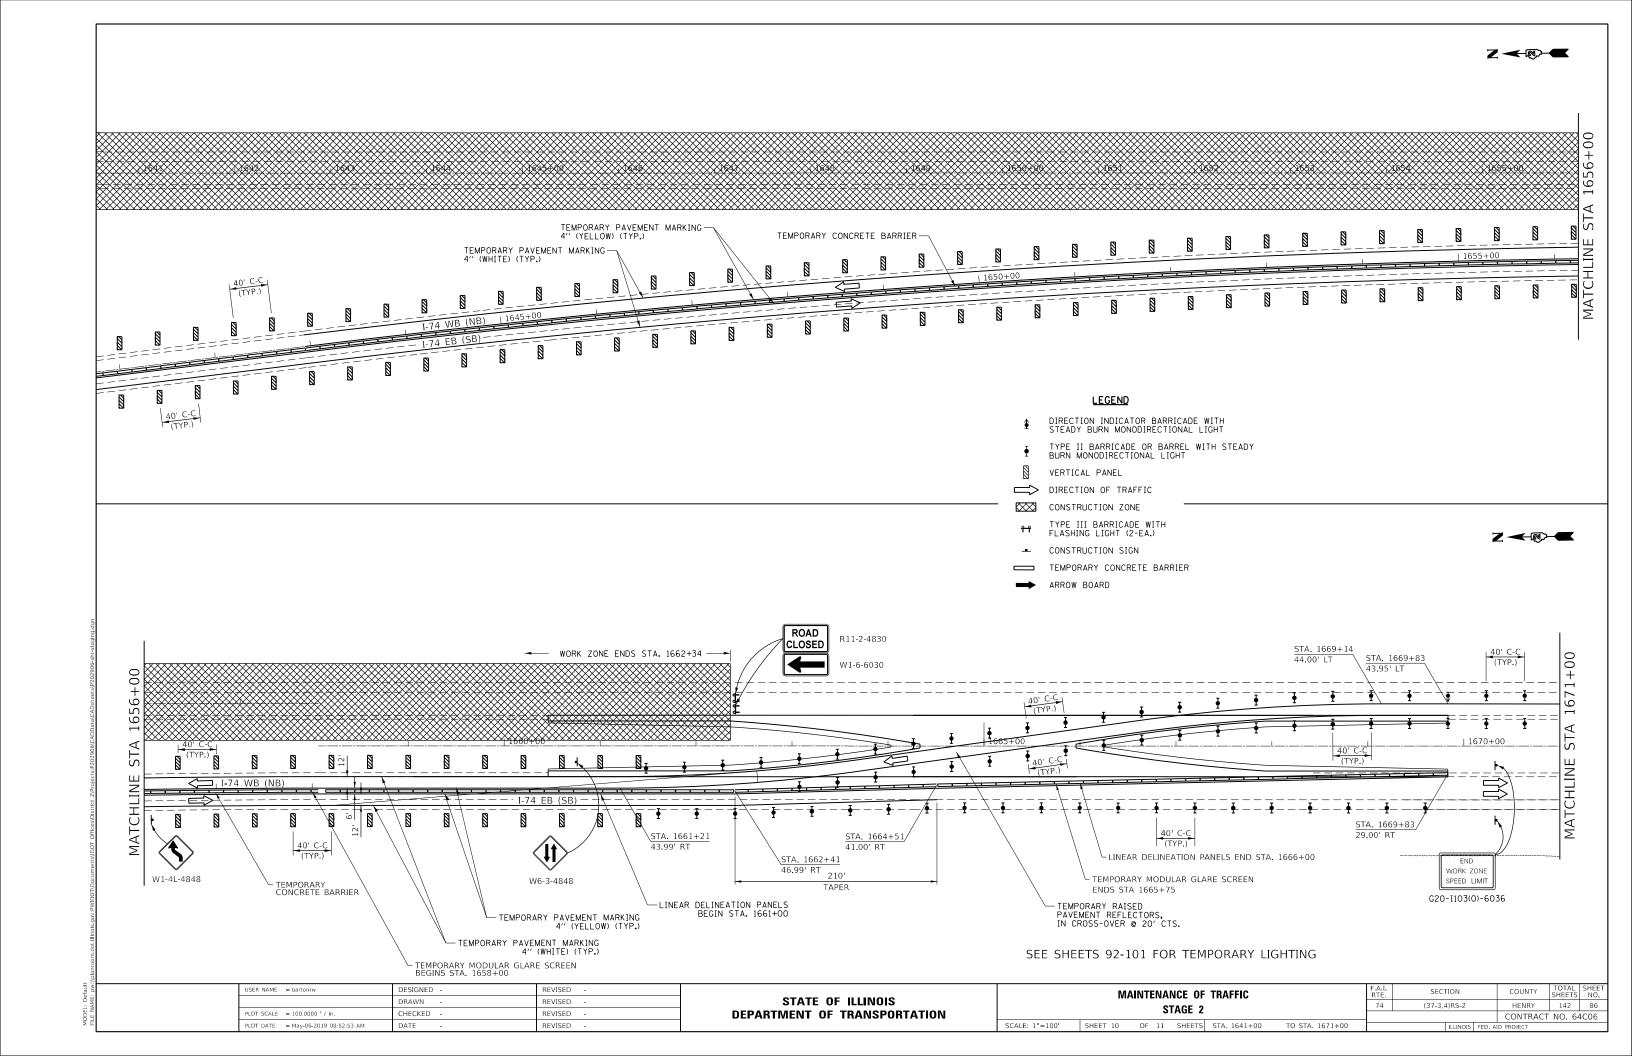

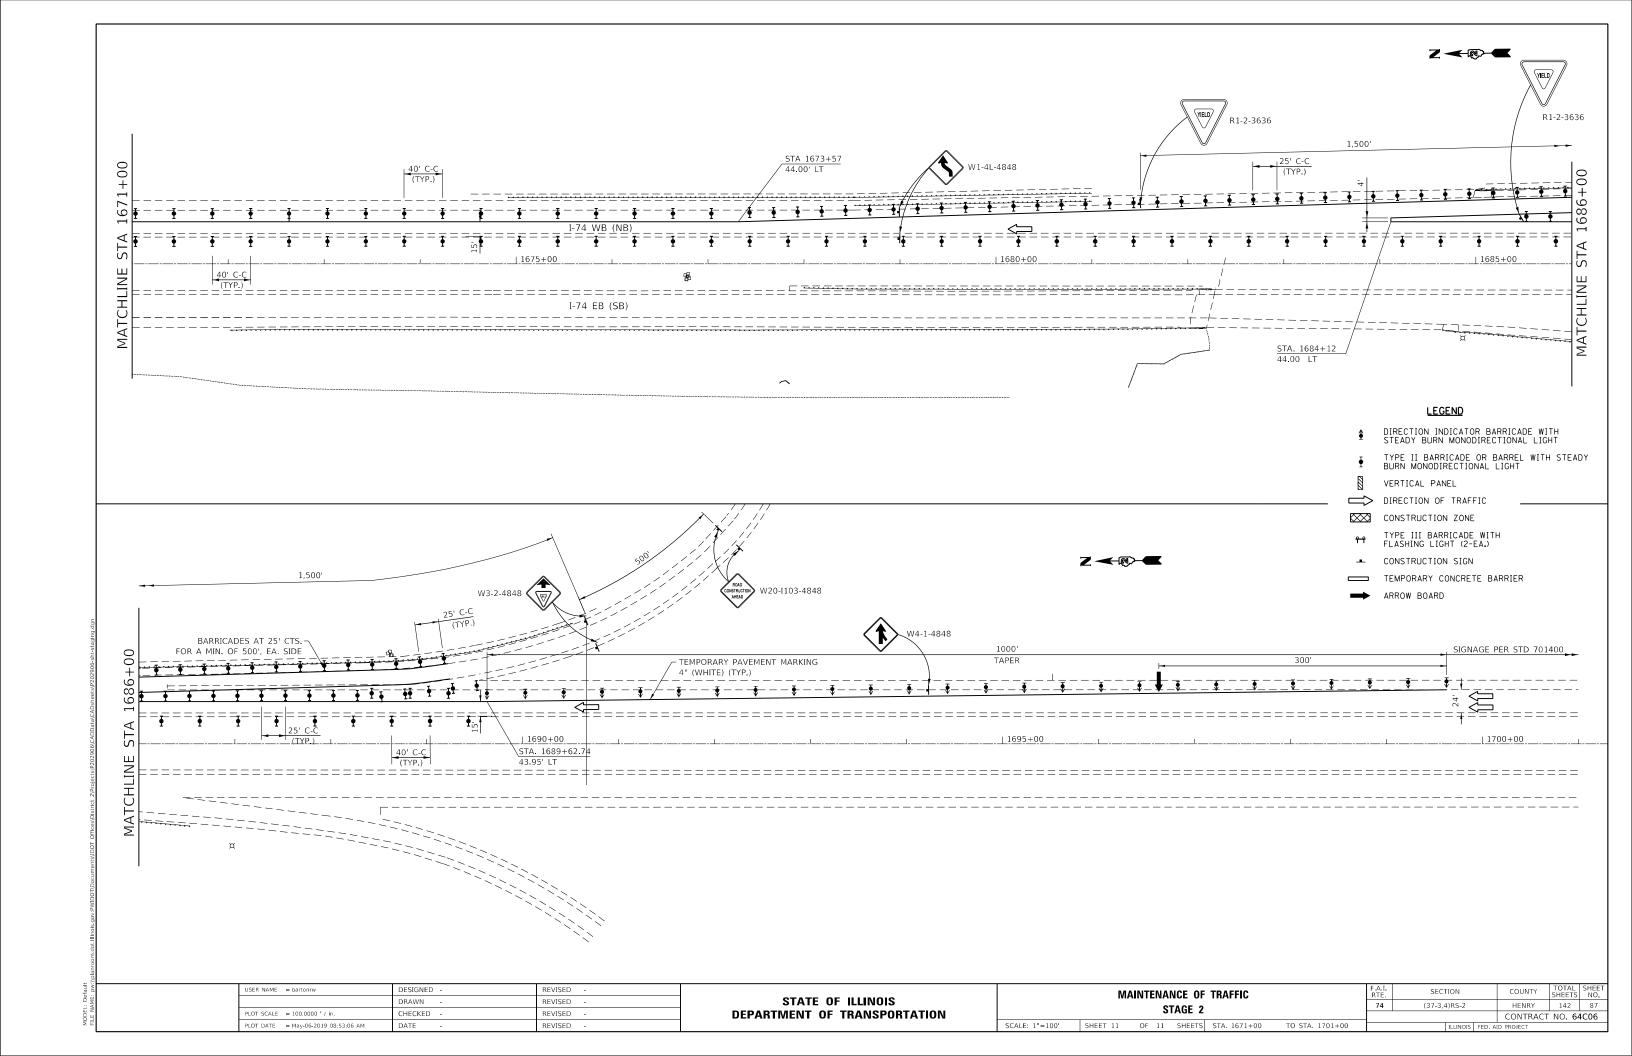


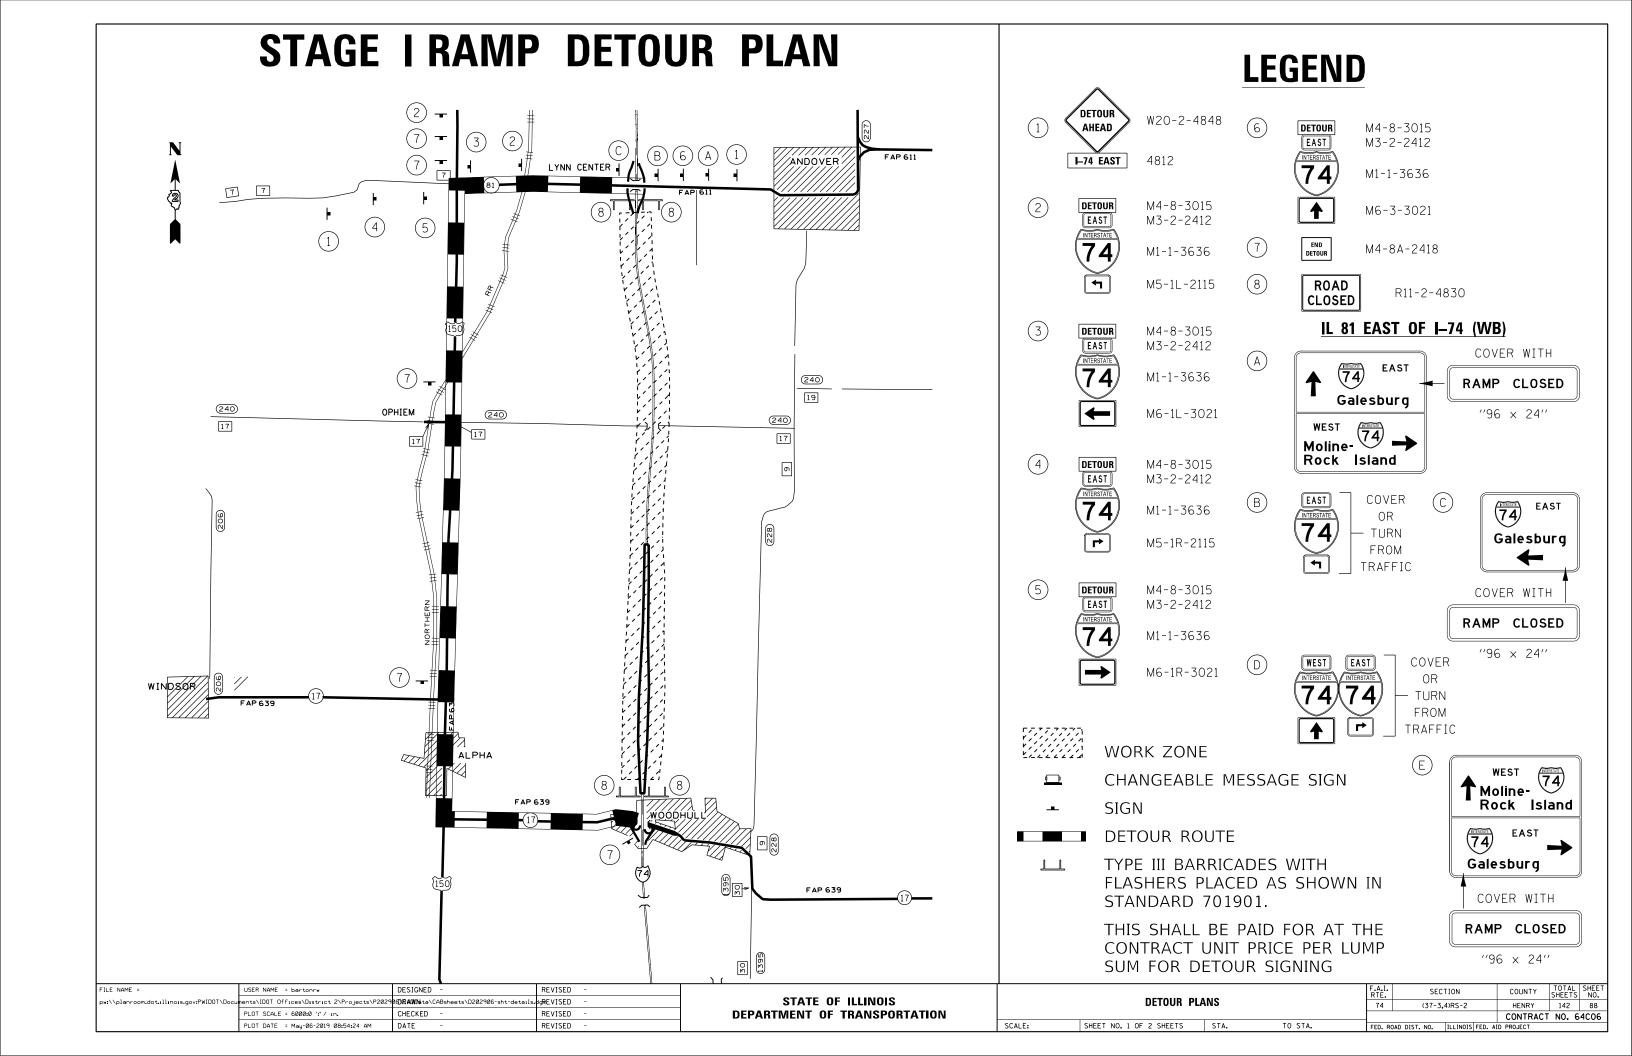

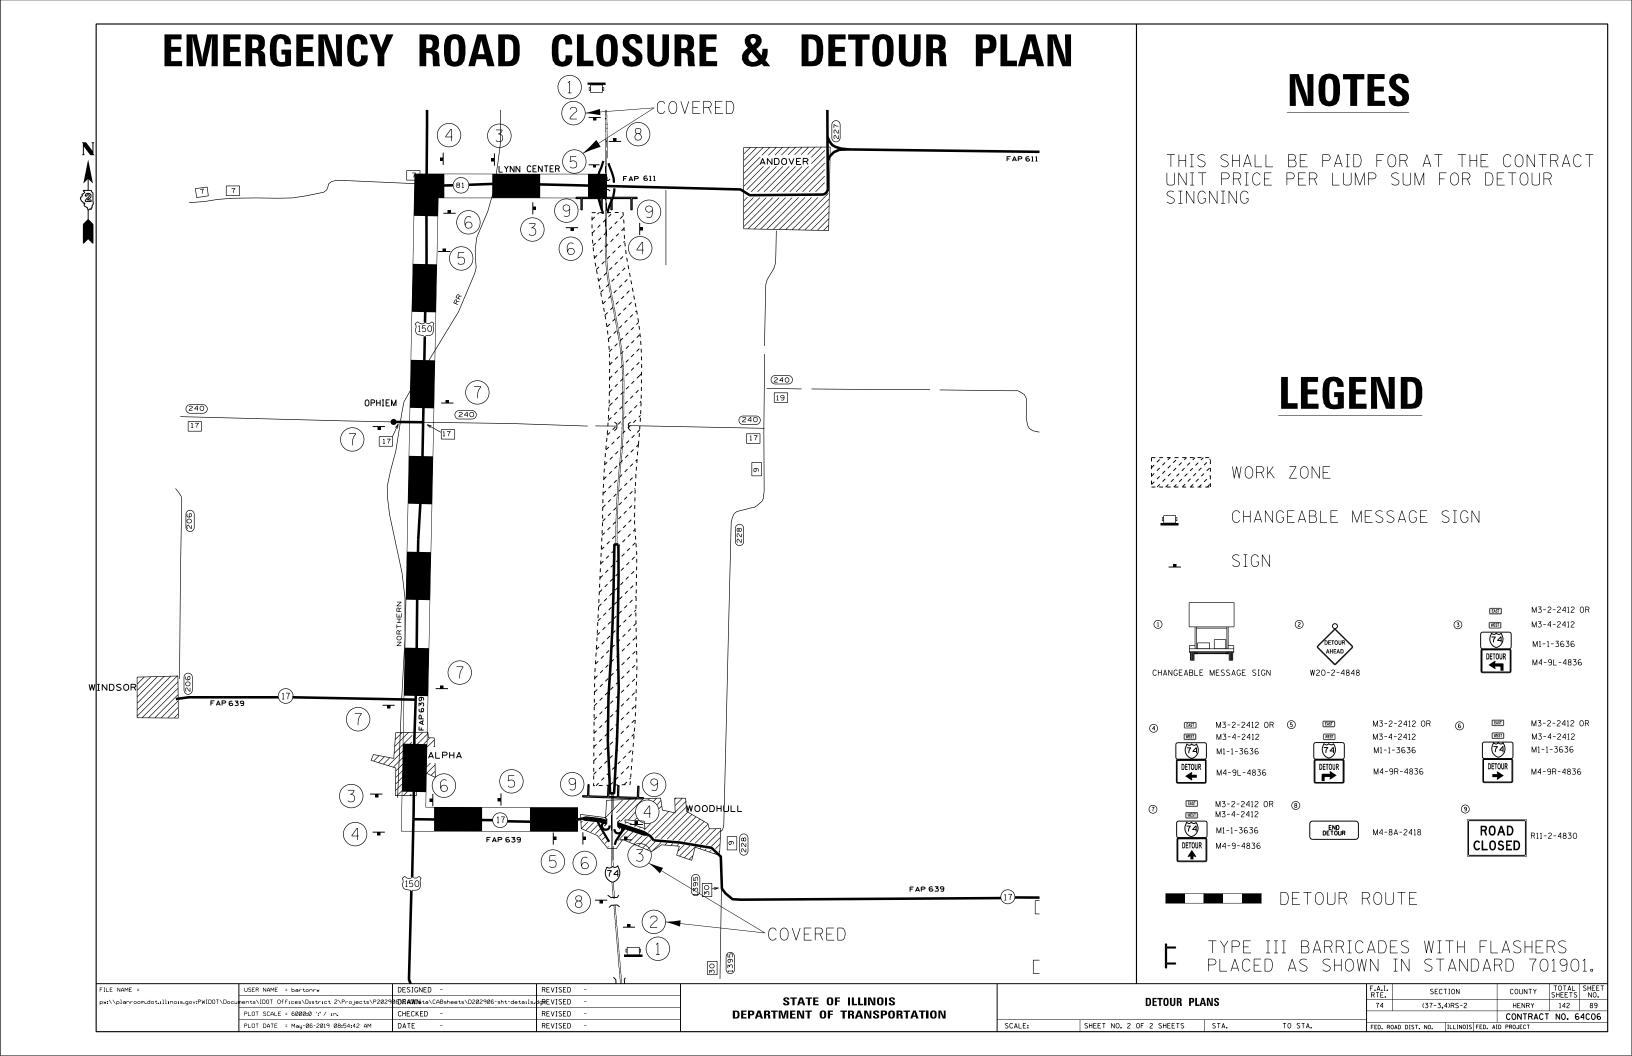

COUNTY

HENRY 142 90 CONTRACT NO. 64C06

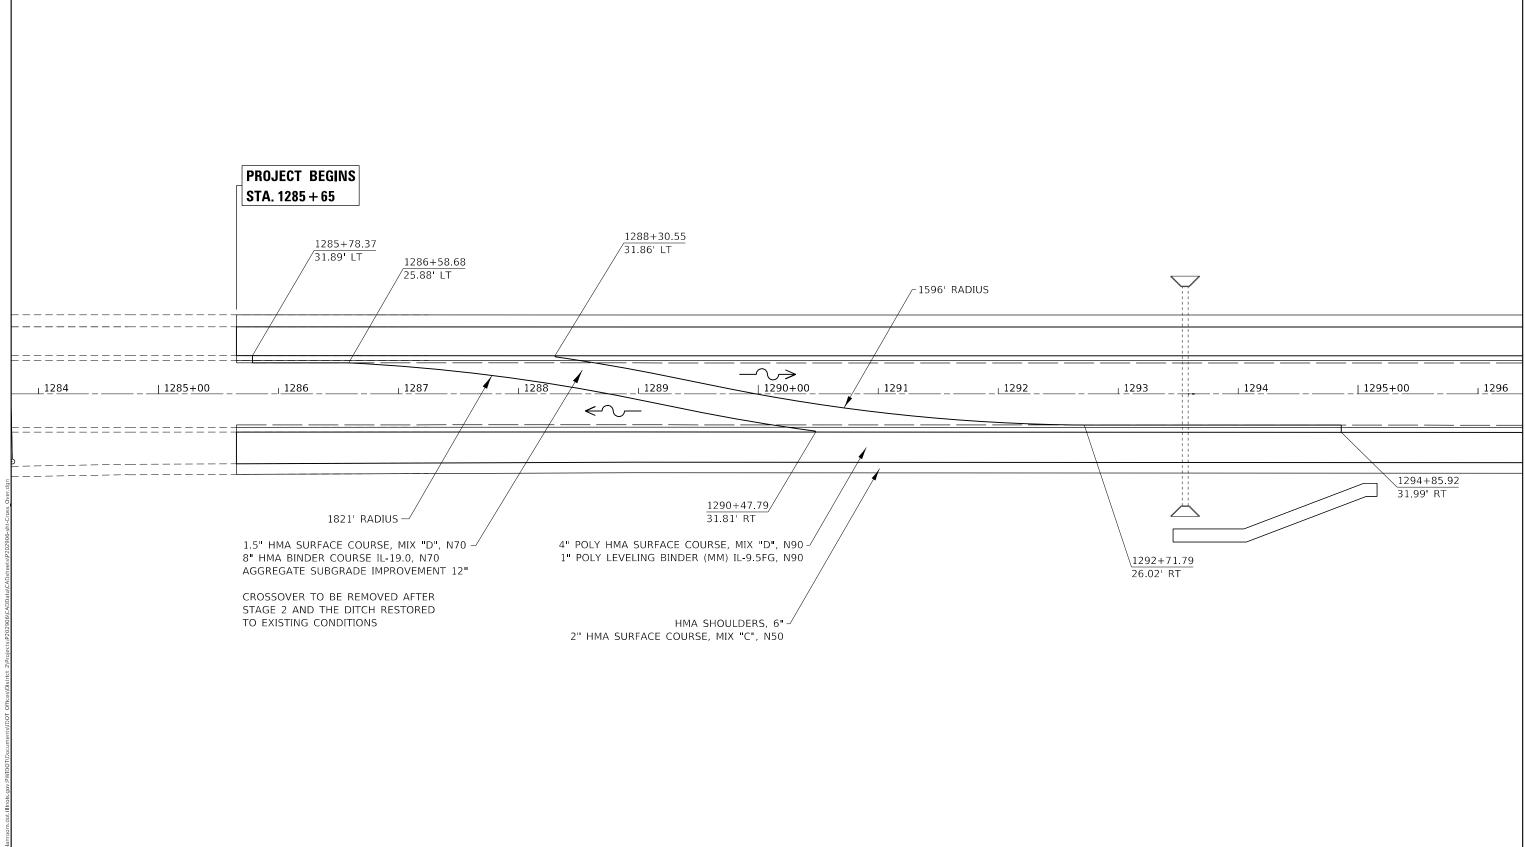

MODEL Dodust

USER NAME = bartonrw

PLOT SCALE = 80.0000 ' / in.

PLOT DATE = May-06-2019 08:55:56 AM

DESIGNED -

DRAWN

CHECKED -

DATE

REVISED -

REVISED -

REVISED -

REVISED -

STATE OF ILLINOIS
DEPARTMENT OF TRANSPORTATION


CROSSOVER DETAILS
NORTH TEMPORARY CROSSOVER

SHEET 1 OF 2 SHEETS STA. TO STA. | ILLINOIS FED.

CONTRACT NO. 64C06

SHEET 2 OF 2 SHEETS STA.

TO STA.

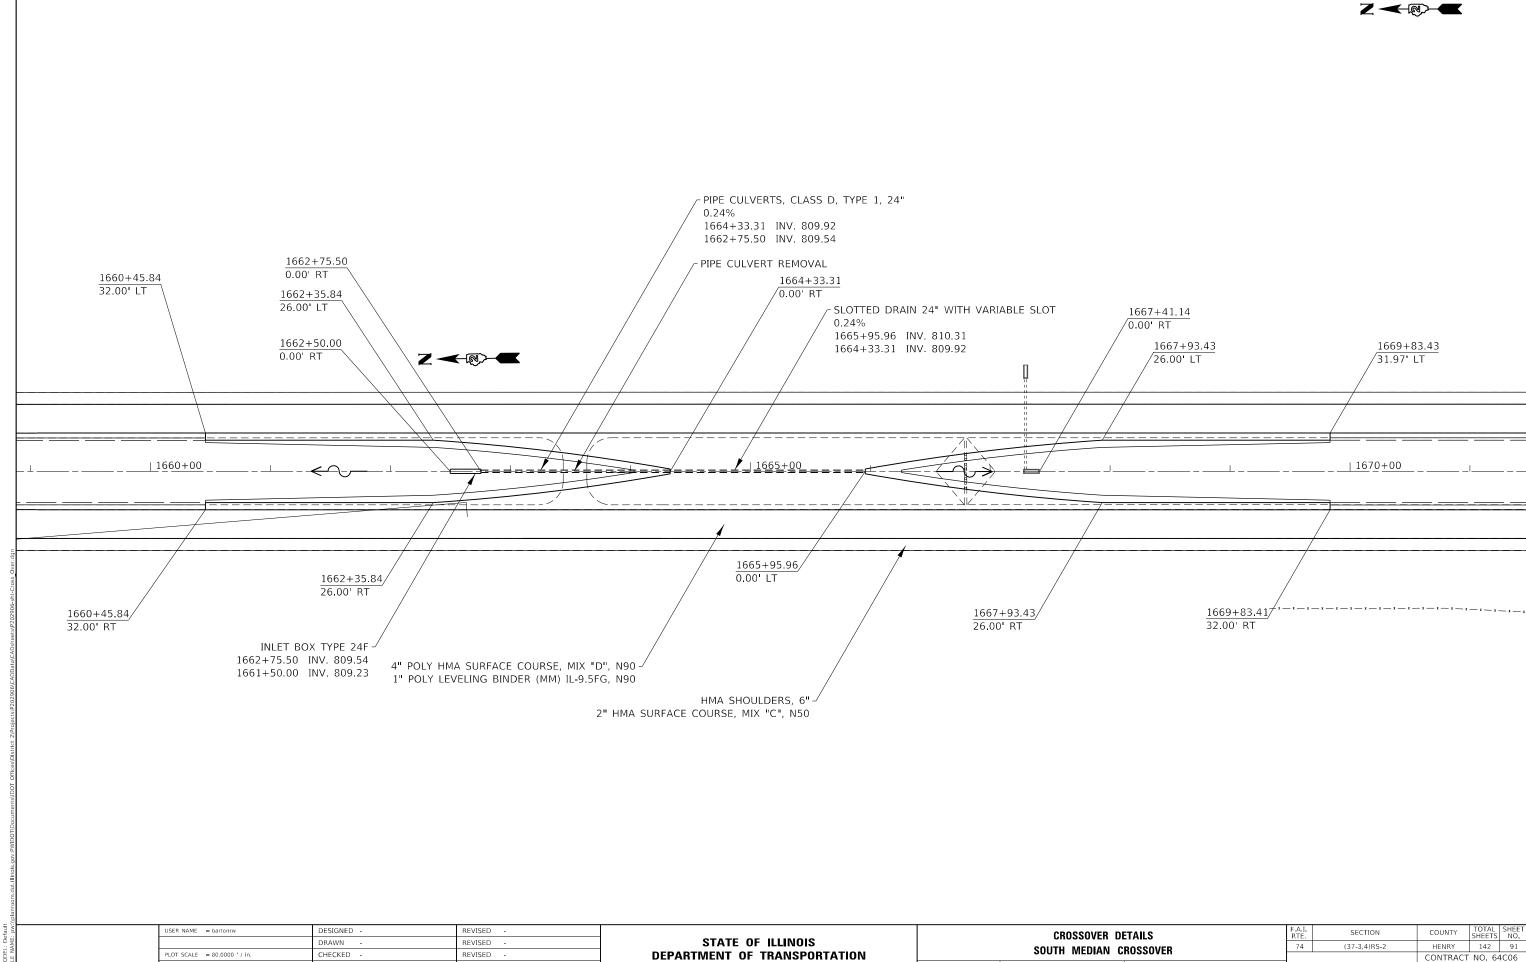

PLOT DATE = May-06-2019 11:32:42 AM

DATE

LEGEND

--- EXISTING SERVICE

→ PROPOSED SERVICE

PROPOSED TEMPORARY LIGHTING CONTROLLER

EXISTING LIGHT TOWER

PROPOSED TEMPORARY LIGHTING UNIT, 50 FT WOOD POLE, CLASS 3, WITH LUMINAIRE, LED, ROADWAY, OUTPUT DESIGNATION H, 40' M.H.

→ GUY WIRE ANCHOR

- A - PROPOSED AERIAL CABLE, SIZED AS NOTED

- — - PROPOSED DIRECT BURIED CABLE, SIZED AS NOTED

PROPOSED COILABLE NONMETALLIC CONDUIT 2" DIA.
LENTH AS NOTED

EXISTING UTILITY POLE

- EXISTING UTILITY POLE WITH TRANSFORMER

CONDUCTOR SCHEDULE

(1) AERIAL CABLE 2-1C NO. 4 WITH MESSENGER WIRE

(2) AERIAL CABLE 2-1C NO. 6 WITH MESSENGER WIRE

UNDERGROUND ELECTRIC CABLE, ALUMINUM, 600V, 2-1C NO. 6, 1/C NO. 8 GROUND (XLP-TYPE USE) DIRECT BURIED

UNDERGROUND ELECTRIC CABLE, ALUMINUM, 600V, 2-1C NO. 8, 1/C NO. 10 GROUND (XLP-TYPE USE) DIRECT BURIED

Luminaire Performance Table

Project

Date	Contract Number	Section Num	nber	County	
05/02/19	64006	N/A		Henry	
Marked Route No	umber		Municipality		
I-74			N/A		

Roadway

Lane Width	*of Lanes	Median Width	I.E.S Surface Classification	0-Zero Value	
12	2	N/A	R3	0.07	

Structure

			Number of Luminaires
Mounting Height	Arm Length	Set Back	(Highmast & Sign Lighting Only)
40 FT	1 FT	30 FT	N/A

Luminaire

Description		I.E.S. Later	al Distribution	I.E.S.	Vertical Distribution
ROADWAY, OUTPUT DESIGNATION H		TYPE III		MEDI	UM
Total Light Loss Factor (LLF) BU(IG Rating		Shields		Dimming Protocol
0.684	J = 0		N/A		0-10V

Layout

Spacing (to Nearest	5 Ft:	Configuration	(Opposite,	Staggered,	1	Sided,	or	Median)
200 FT		SINGLE SIDED						

Performance

Average Illuminance, E _{AVE} (fc)		Uniformity Ratio, E AVE/EMI	N .	
N/A		N/A		
Average Luminance, L _{AVE} (cd/m ²)	Unifor	mity Ratio, L _{AVE} /L _{MIN}	Uniformity Ratio, L MAX/LMIN	Veiling Luminance Ratio, L _V /L _{MIN}
0.4	3.5:1		6.0:1	0.3:1

Light Tresspass


SCALE:


Distance to ROW (behind pole)	Max. Horizontal Illuminance at ROW, E	Max. Vertical Illuminance at ROW, E
N/A	N/A	N/A

Notes

- Set Back is from Edge of Pavement (white line) except for sign luminaires when it is vertical and horizontal distance from the sign to the luminaire.
- 2. Lighting calculations shall be performed with all luminaires oriented toward and perpendicular to roadway.
- 3. Total Light Loss Factor (LLF) = the product of "Lumen Maintenance" (LLD) = 0.9, "Dirt Depreciation" (LDD) = 0.8, and "Equipment Factors" (EF) = 0.95.
- 4. Performance requirements shall be the minimum acceptable standards of photometric performance for the luminaire, based on the given conditions above.

Ε1

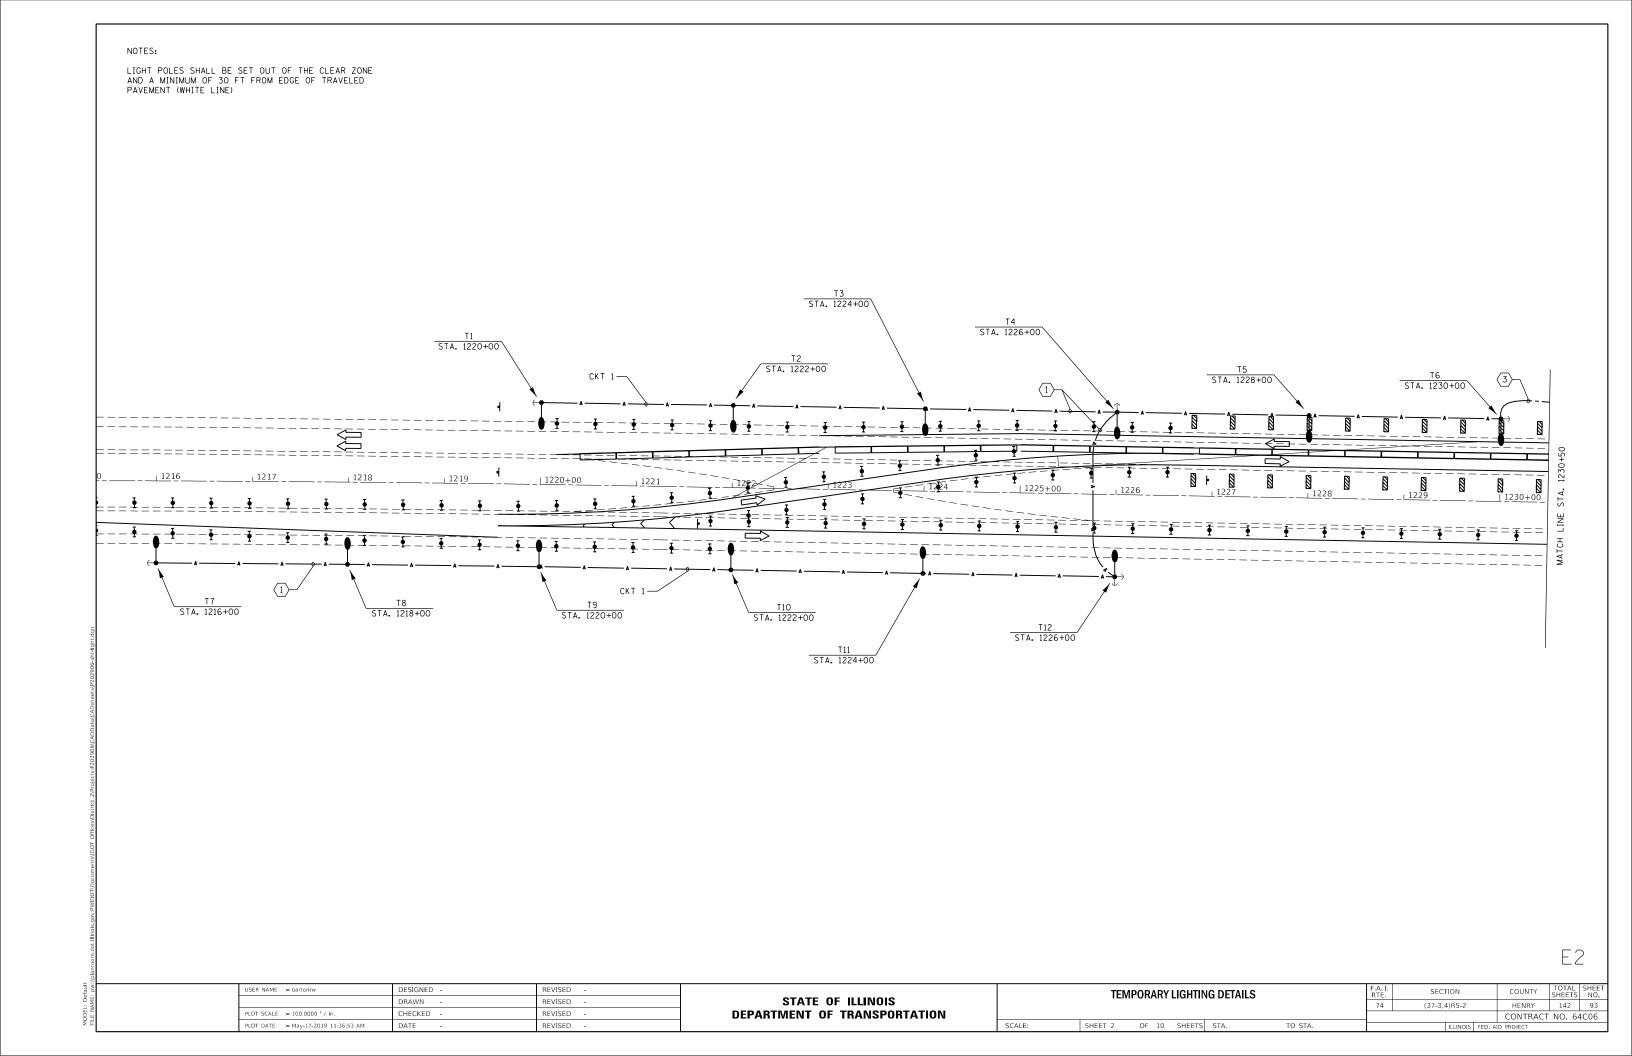

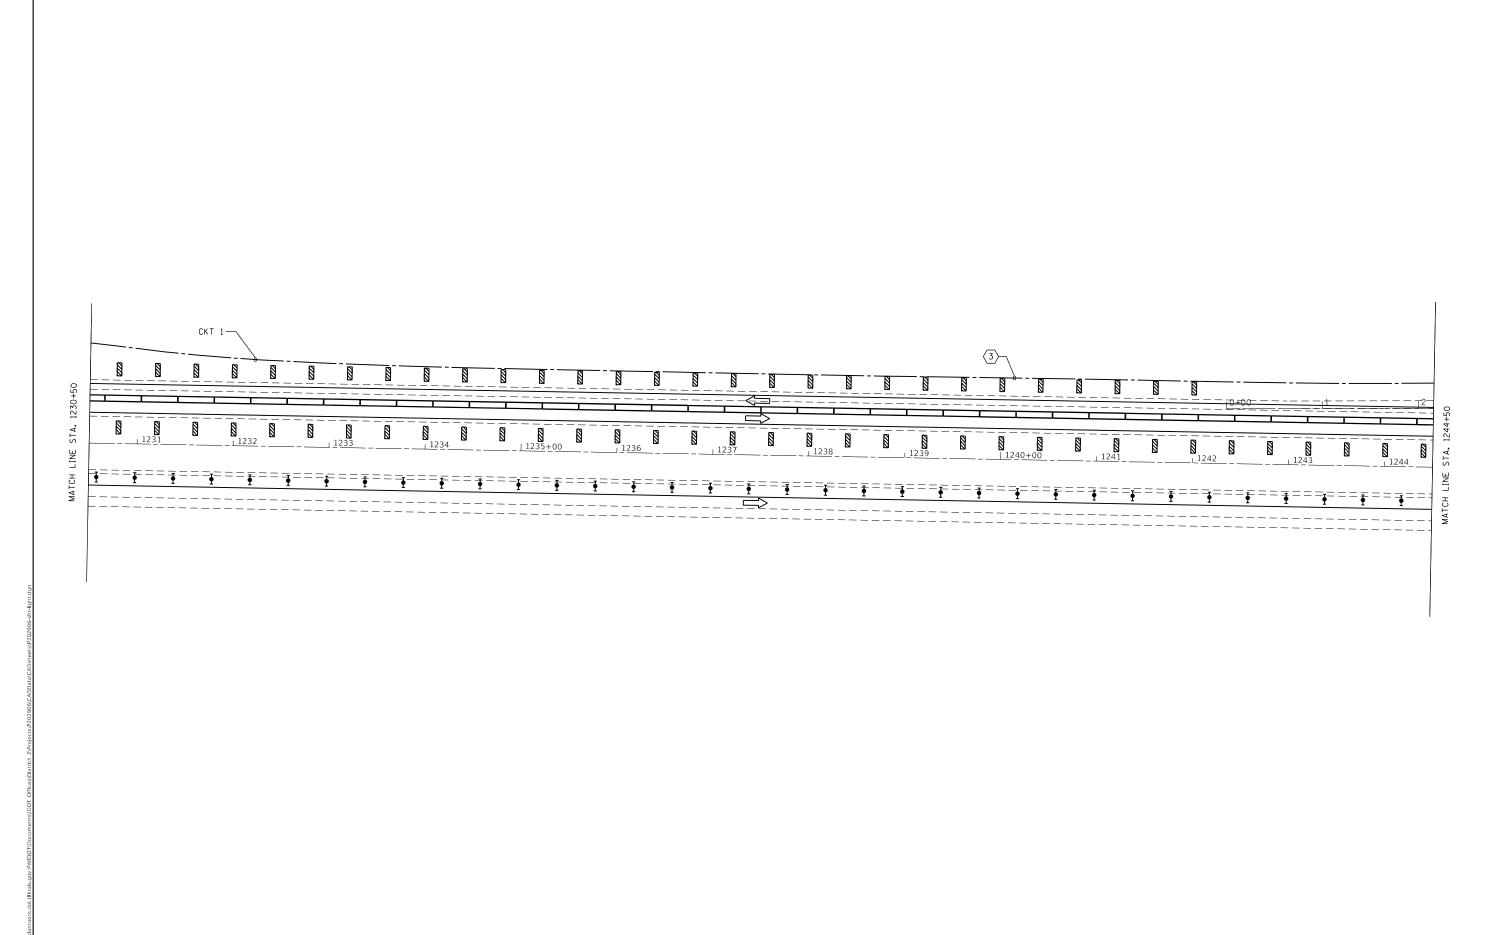

STATE OF ILLINOIS

DEPARTMENT OF TRANSPORTATION

DESIGNED -

DRAWN -

CHECKED -

DATE

PLOT DATE = May-17-2019 11:37:12 AM

REVISED -

REVISED -

REVISED -

COUNTY TOTAL SHEET NO.
HENRY 142 94

CONTRACT NO. 64C06

SECTION

(37-3,4)RS-2

TEMPORARY LIGHTING DETAILS

SHEET 3 OF 10 SHEETS STA.

