07-29-2016 LETTING ITEM 010

STATE OF ILLINOIS DEPARTMENT OF TRANSPORTATION

FOR INDEX OF SHEETS, SEE SHEET NO. 2

THIS PROJECT IS LOCATED IN THE CITY OF DARIEN

TRAFFIC DATA:

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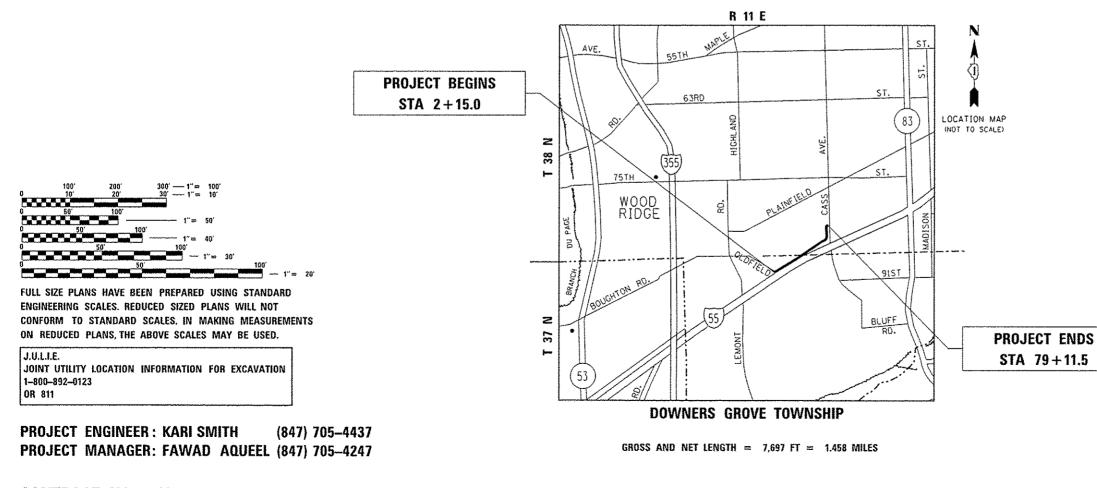
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ADT 5,700 | YEAR 2012 SPEED LIMIT: OLDFIELD RD TO BAILEY RD - 40 MPH (POSTED) BAILEY RD TO CASS AVE - 35 MPH (POSTED)


PROPOSED HIGHWAY PLANS

FAI 55: I–55 NORTH FRONTAGE ROAD OLDFIELD ROAD TO CASS AVENUE SECTION: 2014–063–RS&T PROJECT: ACI-0055(456) RESURFACING (3P), PEDESTRIAN RAMPS, DRAINAGE DuPAGE COUNTY

C-91-045-15




CONTRACT NO. 60Y98

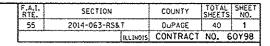



D-91-045-15

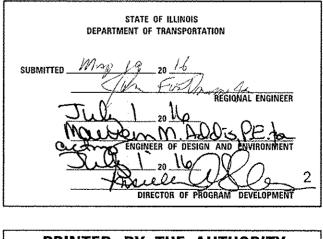

PRINTED BY THE AUTHORITY OF THE STATE OF ILLINOIS

INDEX OF SHEETS

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- 7 SCHEDULE OF OUANTITIES
- 8 TYPICAL SECTIONS
- 9-11 ROADWAY AND PAVEMENT MARKING PLAN
- 12-16 CURB RAMPS FOR SIDEWALKS PLANS
- 17-28 DRAINAGE IMPROVMENT PLANS (GENERAL NOTES, DETAILS, PLAN & PROFILE, EROSION CONTROL, CROSS SECTIONS)
- 29 DETECTOR LOOP REPLACEMENT PLAN
- 30 BD-01: DRIVEWAY DETAILS DISTANCE BETWEEN R.O.W. AND FACE OF CURB OR EDGE OF SHOULDER GREATER THAN OR EQUAL TO 15' (4.5 M)
- 31 BO-08: DETAILS FOR FRAMES AND LIDS ADJUSTMENT WITH MILLING
- 32 BD-22: PAVEMENT PATCHING FOR HMA SURFACED PAVEMENT
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- 35 TC-10: TRAFFIC CONTROL AND PROTECTION FOR SIDE ROADS, INTERSECTIONS AND DRIVEWAYS
- 36 TC-11: TYPICAL APPLICATIONS: RAISED REFLECTIVE PAVEMENT MARKERS (SNOW-PLOW RESISTANT)
- 37 TC-13: DISTRICT ONE TYPICAL PAVEMENT MARKINGS
- 38 TC-16: PAVEMENT MARKING LETTERS AND SYMBOLS FOR TRAFFIC STAGING
- 39 TC-22: ARTERIAL ROAD INFORMATION SIGN
- 40 TS-07: DISTRICT 1 DETECTOR LOOP INSTALLATION DETAILS FOR ROADWAY RESURFACING

STATE STANDARDS

STANDARD NO.	DESCRIPTION
000001-06	STANDARD SYMBOLS, ABBREVIATIONS AND PATTERNS
280001-07	TEMPORARY EROSION CONTROL SYSTEMS
424001-08	PERPENDICULAR CURB RAMPS FOR SIDEWALKS
424006-02	DIAGONAL CURB RAMPS FOR SIDEWALKS
424011-02	CORNER PARALLEL CURB RAMPS FOR SIDEWALKS
424016-02	MID-BLOCK CURB RAMPS FOR SIDEWALKS
424021-03	DEPRESSED CORNER FOR SIDEWALKS
424026-01	ENTRANCE / ALLEY PEDESTRIAN CROSSINGS
442201-03	CLASS C AND D PATCHES
542301-03	PRECAST REINFORCED CONCRETE FLARED END SECTION
542306-03	PRECAST REINFORCED CONCRETE ELLIPTICAL FLARED END SECTION
542546-01	FLUSH INLET BOX FOR MEDIAN

STATE STANDARDS (CONTINUED)

STAND	ARD NO.	DESCRIPTION		11.	ONE (1) FOOT TR WORK TO EXISTI BE PAID FOR AT
	001-06 CONCRETE 001-02 CHAIN LINK	CURB TYPE B AND COMBINATION CONC	RETE CURB AND GUTTER	12.	DRAINAGE ADJUS BY THE ENGINEE
7010	06-05 OFF-ROAD	PERATIONS, 2L. 2W. 15' TO 24" FROM MOVING OPERATIONS, 2L. 2W. DAY ONL		13.	EXISTING BROKE CONTRACTOR AND FRAMES AND LID SPECIFICATIONS
7013	06-03 LANE CLOS	JRE, 2L, 2W, SHORT TIME OPERATIONS JRE, 2L, 2W, SLOW MOVING OPERATION JRE, 2L, 2W, MOVING OPERATIONS - D	NS DAY ONLY, FOR SPEEDS > 45 MPH		WHEN MILLED PA BETWEEN PASSES THE SPEED LIMI WITH WRITTEN A OF 3 INCHES MA
		JRE, 2L, 2W, WORK AREAS IN SERIES. E CLOSURE, 2L, 2W, UNDIVIDED	FOR SPEEDS > 45 MPH	15.	BUTT JOINTS WI MEETS EXISTING DETAILS" SHEET
		E CLOSURE, MULTILANE INTERSECTION CORNER OR CROSSWALK CLOSURE		16.	THE RESIDENT E VIA E-MAIL AT I OF PERMANENT F
7200	106-04 SIGN PANEI	WITROL DEVICES . ERECTION DETAILS G STEEL SIGN SUPPORT		17.	BEFORE BEGINNIN FUTURE REFEREN PAVEMENT MARKE STRIPING. EXAC THE RESIDENT E
7290	01-01 APPLICATIO	NS OF TYPES A & B METAL POSTS (F	OR SIGNS & MARKERS)	18.	ANY PAVEMENT I MILLING AND RE REPLACED AND F
				19.	PAVEMENT MARK ON ALL FINAL S BE INCLUDED IN
				20.	FULL DEPTH SAV STANDARD SPECI INCLUDED IN TH
				21.	ALL PROPOSED S SHALL BE PAID
		GENERAL NOTES		22.	WHEN EXISTING IT SHALL BE RE
1.	(800) 892-0123 OR 8	Y EXCAVATION, THE CONTRACTOR SHA 11 FOR FIELD LOCATIONS OF BURIED (48 HOUR NOTIFICATION REQUIRED)		23.	THE CONTRACTOR EXISTING ITEMS ANY DAMAGE DON THE CONTRACTOR
	COMPANIES AND THE FRAMES AND CRATES	ADJUSTMENT OF PRIVATE UTILITIES	WITHIN THE LIMITS OF THE	24.	LANDSCAPED ARE 18-INCH WIDE ST PLACE, 4-INCH" THE RESIDENT E
	CONTRACT. THE CONTRACTOR SH AT (847) 705-4470 A	. BE DONE BY THEIR RESPECTIVE OWN ALL CONTACT DISTRICT ONE ARTERIAL MINIMUM OF 72 HOURS IN ADVANCE	TRAFFIC CONTROL SUPERVISOR OF BEGINNING WORK.	25.	ANY LOOSE MATH STRUCTURES. WH REMOVED AT THE THE IMPROVEMEN DEBRIS. THIS W
5.		L NOT BE ALLOWED TO SET UP A YA WITHOUT THE WRITTEN PERMISSION (26.	CONSIDERED AS
6.	APPROVED IN WRITIN SPECIFICATIONS, OVE	TIONS WARRANT EXTENDED LANE CLOS C BY THE RESIDENT ENGINEER OR AS RNIGHT CLOSURES SHALL NOT BE ALL DAYTIME MILLING AND RESURFACING	PROVIDED FOR IN THE CONTRACT OWED FOR REHABILITATION		CONTINUOUSLY N LOCATIONS. SEE
7.	PATCHING. IT SHALL BE THE CO	NTRACTOR'S RESPONSIBILITY TO VERI IN THE FIELD PRIOR TO CONSTRUCT	FY ALL DIMENSIONS AND		LOOPS DAMAGED
8.		S FOR CONSTRUCTION DIMENSIONS.			
0	THE CONTRACTOR SH	ALL RE REQUIRED TO PROVIDE ACCESS	TO ABUTTING PROPERTY		

- 9. THE CONTRACTOR SHALL BE REQUIRED TO PROVIDE ACCESS TO ABUTTING PROPERTY AT ALL TIMES DURING THE CONSTRUCTION OF THIS PROJECT.
- 10. ALL PAVEMENT PATCHING LOCATIONS WILL BE DETERMINED IN THE FIELD BY THE RESIDENT ENGINEER/TECHNICIAN.

FILE NAME =	USER NAME + Valishkovvv	DESIGNED -	REVISED -		1_55 N	NORTH FROM	TAGE BO		RD TO CASS AVE	F.A. I. RTE.	SECTION	COUNTY	TOTAL SHEE SHEETS NO.
pm//1L084E8IDINTES.1131noss.goviPXIDDT/Do	unente/1007 Offices/District 1/Projects/0184	5BR\$#09=ta\Design\0184515-eht-gennote.d	REVISED -	STATE OF ILLINOIS	}				GENERAL NOTES	55	2014-063-RS&T	DUPACE	40 2
	PLOT \$CALE . 100,0000 ' / in.	CHECKED -	REVISED -	DEPARTMENT OF TRANSPORTATION	11457			·····			·	CONTRACT	NO. 60Y98
Default	PLOT DATE = 5/20/2016	DATE -	REVISED -		SCALE:	SHEET	OF	SHEETS STA.	TO STA,		ILLINOIS FED,	AID PROJECT	
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GENERAL NOTES (CONTINUED)

ONE (1) FOOT TRANSITIONS SHALL BE USED TO MATCH PROPOSED CURB AND GUTTER ITEMS OF WORK TO EXISTING CURB AND CUTTER, UNLESS OTHERWISE SHOWN. THE TRANSITIONS SHALL BE PAID FOR AT THE CONTRACT UNIT PRICE FOR THE PROPOSED ITEMS OF WORK SPECIFIED.

JSTMENT OR RECONSTRUCTION LOCATIONS WILL BE DETERMINED IN THE FIELD EER.

KEN FRAMES AND LIDS SHALL BE REMOVED AND DISPOSED OF BY THE AND SHALL BE REPLACED AS DIRECTED BY THE ENGINEER. REPLACEMENT .IDS WILL BE PAID FOR ACCORDING TO ARTICLE 109.04 OF THE STANDARD AS UNLESS A SEPARATE PAY ITEM HAS BEEN PROVIDED.

PAVEMENT IS OPEN TO TRAFFIC, THE MAXIMUM CRADE DIFFERENTIAL ES OF THE MILLING MACHINE SHALL NOT EXCEED 1/2 INCHES WHERE MIT IS 45 MPH OR LESS, AND 1 INCH WHERE THE SPEED LIMIT IS OVER 45 MPH. APPROVAL FROM THE RESIDENT ENGINEER, A MAXIMUM GRADE DIFFERENTIAL MAY BE ALLOWED IF THE EDGE OF THE MILLING IS SLOPED A MINIMUM OF 1V:3H.

WILL BE INSTALLED AT THE ENDS OF RESURFACING (WHERE RESURFACING NG PAVEMENT) IN ACCORDANCE WITH THE "BUTT JOINT AND HMA TAPER ET INCLUDED IN THE PLANS, UNLESS OTHERWISE SPECIFIED.

ENGINEER SHALL CONTACT ERIC CAMPOS, AREA TRAFFIC FIELD ENGINEER ERIC.CAMPOSQILLINOIS.COV, A MINIMUM OF 2 WEEKS PRIOR TO PLACEMENT PAVEMENT MARKINGS.

VING ANY WORK, THE CONTRACTOR SHALL RETAIN AND RECORD FOR ENCE, ALL EXISTING PAVEMENT MARKING LINES (AND RAISED REFLECTIVE KKERS) IN ORDER THAT THESE LOCATIONS CAN BE RE-ESTABLISHED FOR ACT LOCATIONS OF ALL PAVEMENT MARKINGS SHALL BE AS DIRECTED BY ENGINEER.

MARKINGS AND RAISED REFLECTIVE PAVEMENT MARKERS OBLITERATED BY RESURFACING OPERATIONS ON SIDE STREETS AND ENTRANCES SHALL BE PAID FOR IN KIND.

REING TAPE, TYPE III SHALL BE USED FOR SHORT TERM PAVEMENT MARKINGS SURFACES. THE COST OF THE PAVEMENT MARKING TAPE, TYPE III SHALL IN THE COST OF SHORT TERM PAVEMENT MARKING.

AWOUT OF REMOVAL ITEMS AS NOTED ON THE PLANS, SPECIFIED IN THE CIFICATIONS, OR AS REQUIRED BY THE RESIDENT ENGINEER SHALL BE THE COST OF THE ITEM BEING REMOVED.

SIDE CURB QUANTITIES ARE INCLUDED IN THE "PCC SIDEWALK 5 IN" AND AS SUCH.

S SIDEWALK IS TO BE REMOVED WITHOUT PROPOSED SIDEWALK REPLACEMENT, REPLACED WITH TOPSOIL AND SOD.

TOR SHALL USE CARE IN GRADING OR EXCAVATING NEAR ANY AND ALL AS THAT WILL NOT BE REMOVED INCLUDING PREVIOUSLY SEEDED AREAS. DONE TO EXISTING ITEMS BY THE CONTRACTOR SHALL BE REPAIRED AT DOR'S OWN EXPENSE TO THE SATISFACTION OF THE ENDINCER.

REAS AFFECTED BY SIDEWALK CONSTRUCTION SHALL BE RESTORED WITH STRIP OF "SODDING, SALT TOLERANT" AND "TOPSOIL FURNISH AND "INSTALLED FROM THE BACK OF THE SIDEWALK, OR AS DETERMINED BY ENGINEER/TECHNICIAN.

ITERIAL DEPOSITED IN THE FLOW LINE OF CURB OR DRAINAGE WHICH OBSTRUCTS THE NATURAL FLOW OF WATER, SHALL BE THE CLOSE OF EACH WORKING DAY. PRIOR TO ACCEPTANCE OF ENT, ALL DRAINAGE STRUCTURES SHALL BE FREE OF DIRT AND WORK WILL NOT BE PAID FOR SEPARATELY BUT SHALL BE S INCIDENTAL.

CONTRACTOR IS REQUIRED TO HIRE AN ENVIRONMENT FIRM TO MONITOR FOR WORKER SAFETY AND SDIL CONTAMINATION AT SEVERAL E SPECIAL PROVISION AND SUPPLEMENTAL SPECIFICATIONS FOR DETAILS.

FOR SHALL BE RESPONSIBLE FOR THE REPLACEMENT OF ANY DETECTOR DURING CONSTRUCTION.

			URBAN	[ŕ	ONSTRUC	TION TYPE	CODE	T	T				-
	SUMMARY OF QUANTITIES	·····	-	0005	0044						SUMMA	RY OF QUANTITIES	1	-
CODE NO	ITEM	UNIT	TOTAL QUANTITIES	80% FED 20% STATE	80% FED 20% STATE					CODE NO		ITEM	UNIT	
X1200095	GRATING FOR CONCRETE FLARED END SECTION	EACH	4		4					28000305	TEMPORARY D	ITCH CHECKS	FOOT	-
	18 ''													
										28000400	PERIMETER E	ROSION BARRIER	FOOT	
X1200076	GRATING FOR CONCRETE FLARED END SECTION	EACH	1		1									_
	21"									28000510	INLET FILTE	RS	EACH	_
										[· · · ·		
20101000	TEMPORARY FENCE	FOOT	80		80					28100107	STONE RIPRA	P. CLASS A4	SO YD	_
														_
20200100	EARTH EXCAVATION	CU YD	189	15	174					28200200	FILTER FABR	IC	SQ YD	
20800150	TRENCH BACKF [LL	CU YD	36		36	*				35501308	HOT-MIX ASPI	HALT BASE COURSE, 6"	SQ YD	_
														-
21101505	TOPSOIL EXCAVATION AND PLACEMENT	CU YD	50		50					40600290	BITUMINOUS N	MATERIALS (TACK COAT)	POUND	
														-
21101615	TOPSOIL FURNISH AND PLACE, 4"	SO YO	329	96	233	-				40600400	MIXTURE FOR	CRACKS, JOINTS, AND	TON	
											FLANGEWAYS			
21400100	GRADING AND SHAPING DITCHES	FOOT	450		450									1
										40600827		LEVELING BINDER (MACHINE	TON	_
25000210	SEEDING, CLASS 2A	ACRE	0.14		0.14						METHOD), (L-	-4.75, N50		-
25000400	NITROGEN FERTILIZER NUTRIENT	POUND	15	2.3	12.7					40600982	HOT-MIX ASP	IALT SURFACE REMOVAL - BUTT	SO YD	
											JOINT			
25000500	PHOSPHORUS FERTILIZER NUTRIENT	POUND	15	2, 3	12.7				+					_
										40603340	HOT-MIX ASPI	HALT SURFACE COURSE, MIX	TON	
25000600	POTASSIUM FERTILIZER NUTRIENT	POLIND	15	2.3	12.7						"0", N70			
					.									
25100630	EROSION CONTROL BLANKET	SQ YD	682		682					42001300	PROTECTIVE (COAT	SQ YD	-
25200110	SODDING, SALT TOLERANT	SO YD	106	106						42400200	PORTI AND CEN	ENT CONCRETE SIDEWALK 5 INCH	SO FT	
25200200	SUPPLEMENTAL WATERING	UNIT	8	5	3					ß				
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			URBAN	1	~	ONSTRUCTION TYPE COD	)£				URBAN	<b>`</b>		NSTRUCTION TYPE	CODE	·····
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CODE NO	ITEM	UNIT	TOTAL	80% FED	80% FED			CODE NO	ITEM	UNIT	TOTAL	80% FED	80% FED			-
42400800	DETECTABLE WARNINGS	SO FT	142	142				54214713	PRECAST REINFORCED CONCRETE FLARED END	EACH	2		2			
			-						SECTIONS - ELLIPTICAL, EOUIVALENT			-				
44000155	HOT-MIX ASPHALT SURFACE REMOVAL, 1 1/2"	50 YD	5410	5410					ROUND-SIZE 18"							
								54244405	FLUSH INLET BOX FOR MEDIAN, STANDARD	EACH	1		1			
44000158	HOT-MIX ASPHALT SURFACE REMOVAL. 2 1/4"	SQ YD	22390	22390					542546							
								542A0223	PIPE CULVERTS, CLASS A, TYPE I 18"	FOOT	80		80			
44000200	DRIVEWAY PAVEMENT REMOVAL	SO YD	37		37											
								542A0226	PIPE CULVERTS, CLASS A, TYPE 1 21"	FOOT	75		75			
44000600	SIDEWALK REMOVAL	SO FT	1445	1445				54245473	PIPE CULVERTS, CLASS A, TYPE 1	FOOT	30		30			
44201735	CLASS D PATCHES. TYPE IV. ? INCH	SO YD	178		178			54245473	EQUIVALENT ROUND-SIZE 18"	FOQI	30		30			
		50.10														
44201823	CLASS D PATCHES, TYPE I, 15 INCH	50 YD	10	10				55100700	STORM SEWER REMOVAL 15"	FOOT	22		22			
44201827	CLASS D PATCHES. TYPE []. 15 INCH	SO YD	20	20				55100900	STORM SEWER REMOVAL 18"	FOOT	61		61			
44201831	CLASS D PATCHES, TYPE III. 15 INCH	SO YD	25	25				60250200	CATCH BASINS TO BE ADJUSTED	EACH	1	L				
14201833	CLASS D PATCHES, TYPE IV. 15 INCH	SQ YD	1103	1103				60255500	MANHOLES TO BE ADJUSTED	EACH	3		3			
48102100	AGGREGATE WEDGE SHOULDER, TYPE B	TON	16	16				60260100	INLETS TO BE ADJUSTED	EACH	2	2				
	· · · · · · · · · · · · · · · · · · ·	-													-	
54213663	PRECAST REINFORCED CONCRETE FLARED END	EACH	2		2			60265700	VALVE VAULTS TO BE ADJUSTED	EACH	1	l		· · · · · · · · · · · · · · · · · · ·		
	SECTIONS 18"							-							*	
54213666	PRECAST REINFORCED CONCRETE FLARED END	EACH	1					66400205	CHAIN LINK FENCE. 5'	FOOT	40		40			
000L13F5	SECTIONS 21"		1		1			* 66900200	NON-SPECIAL WASTE DISPOSAL	CU YD	200	25	175			
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								* 66900450 년	SPECIAL WASTE PLANS AND REPORTS	LSUM	1	0.1	0.9	* =	SPECIALTY	
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CODE NO	ITEM	UNIT	TOTAL QUANTITIES	80% FED	80% FED			Anna franciska franci	CODE NO		ІТЕМ	UNIT	TOTAL QUANTITIES	80% FED	80% FED	-			
66900530	SOIL DISPOSAL ANALYSIS	EACH	3	2	1				70300260	TEMPORARY P	AVEMENT MARKING - LINE 12"	FOOT	1050	1050					
67000400	ENGINEER'S FIELD OFFICE, TYPE A	CAL NO	6	5	1				70300280	TEMPORARY P	AVEMENT MARKING - LINE 24"	FOOT	140	140		- - - -			
67100100	MOBILIZATION	LSUM	1	0.8	0.2				<b>*</b> 72400500	RELOCATE SI	GN PANEL ASSEMBLY - TYPE A	EACH	2		2				
70100460	TRAFFIC CONTROL AND PROTECTION,	LSUM	1						* 78000100	THERMOPLAST	IC PAVEMENT MARKING -	SQ FT	40	40					
	STANDARD 701306								-	LETTERS AND	SYMBOLS						-		
70100600	TRAFFIC CONTROL AND PROTECTION,	LSUM	1	1					* 78000200	THERMOPLAST	IC PAVEMENT MARKING - LINE 4"	FOOT	23300	23300		·		-	-
	STANDARD 701336			-												 			-
						· · · ·													
70102620	TRAFFIC CONTROL AND PROTECTION,	LSUM	ŧ	0.8	0.2				* 78000400	THERMOPLAST	IC PAVEMENT MARKING - LINE 6"	FOOT	255	255					
	STANDARD 701501																		
70102635	TRAFFIC CONTROL AND PROTECTION,	LSUM	1	l.				****	* 78000600	THERMOPLAST	IC PAVEMENT MARKING - LINE 12."	FOOT	1050	1050		-			
	STANDARD 701701																		_
70102640	TRAFFIC CONTROL AND PROTECTION.	LSUM		0.8	0.2				* 78000650	THERMORI AST	IC PAVEMENT MARKING - LINE 24"	FOOT	140	140		· · · · · · · · ·			_
	STANDARD 701801																		
70300100	SHORT TERM PAVEMENT MARKING	FOOT	4900	4900					* 78100100	RAISED REFLI	CTIVE PAVEMENT MARKER	EACH	190	190					
70300150	SHORT TERM PAVEMENT MARKING REMOVAL	SO F.T	1640	1640					78300200		CTIVE PAVEMENT MARKER REMOVAL	EACH	180	180		•			
10300130	SHORT TERM TATEMENT MARKING REMOTAL		1040											100					-
70300210	TEMPORARY PAVEMENT MARKING LETTERS AND	SO FT	40	40															
	SYMBOLS								* 85000200	MAINTENANCE	OF EXISTING TRAFFIC SIGNAL	EACH	1	l I					
70300220	TEMPORARY PAVEMENT MARKING - LINE 4"	FOOT	23300	23300						INSTALLATIO	ł				-				
					-				* 88600600	3600600 DETECTOR LOOP REPLACEMENT		FOOT	156	156		·····		<u> </u>	
70300240	TEMPORARY PAVEMENT MARKING - LINE 6"	FOOT	255	255					D D							· · · · · · · · · · · · · · · · · · ·	* =	SPECIALTY	¥ 171
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ſ		SUMMARY OF QUANTITIES			0005	0044	CONSTRUCT	ION TYPE	CODE	1		SUMMARY OF QUANTITIES			0005	C 0044	ONSTRUCT	ION TYPE C	ODE	
	CODE NO	ITEM	UNIT	TOTAL QUANTITIES	80% FED 20% STATE	80% FED 20% STATE	41 14 1 14 14 14 14 14 14 14 14 14 14 14				CODE NO	ITEM	UNIT	TOTAL	80% FED 20% STATE	80% FED 20% STATE				
	89502376	REBUILD EXISTING HANDHOLE	EACH	1	L.												· · · · · · · · · · · · · · · · · · ·			
	x0322936	REMOVE EXISTING FLARED END SECTION	EACH	4		4														
	X2020110	GRADING AND SHAPING SHOULDERS	UNIT	8	8															
	X4021000	TEMPORARY ACCESS (PRIVATE ENTRANCE)	ЕАСН	l								· · · · · · · · · · · · · · · · · · ·								
	X5537800	STORM SEWERS TO BE CLEANED 12"	FOOT	80	80						· · · · · · · · · · · · · · · · · · ·						- - - - -			
	x6030310	FRAMES AND LIDS TO BE ADJUSTED (SPECIAL)	EACH	2	2				· · ·											
																	: : : : :			
	Z0004562	COMBINATION CONCRETE CURB AND GUTTER	FOOT	135	135												· · · · · · · · · · · · · · · · · · ·			
	Z001 3798	CONSTRUCTION LAYOUT	LSUM	1		1											- - - -			
	Z0018500	DRAINAGE STRUCTURES TO BE CLEANED	EACH	2	2															
	20022800	FENCE REMOVAL	FOOT	40		40		 				· · · · · · · · · · · · · · · · · · ·								
	20030850	TEMPORARY INFORMATION SIGNING	50 FT	52	52															
																	· · · · · · · · · · · · · · · · · · ·			
		· · · · · · · · · · · · · · · · · · ·														∧ = <b>∧</b>	ON-PARTIC	* = S IPATING WOF	PECIALTY	ITEMS STATE:
	I FILE NAME : PRINCOBAEDIONATECH	ind/s.gov/PMIDDT-Document/SUDD 07770550731713 NProjects DD4555CADD35D0455984 PLOT SCALE + 100,0000 '/ In. CHE	I I SIGNED - KAONO - ICKED - TE -		REVISED REVISED REVISED REVISED	*	1	   		TATE OF ENT OF T	ILLINOIS RANSPORTATION	I-55 NORTH FRONTAGE I SUMMA SCALE: SHEET NO. OF	RY OF QUANTI	TIES	ASS AVE	F.A.I. RTE. 55	SEC 2014-00	TION 3-RS&T	COUNTY S	TOTAL SHEET HEETS NO. 40 6


								25200110	25200200	42001300				60250200				00002010	Z0004562
CROSS STREET OL	DUADRANT	RAMP	EARTH EXCAVATION	TOPSOIL FURNISH AND PLACE, 4"	NITROGEN FERTILIZER NUTRIENT	PHOSPHORUS FERTILIZER NUTRIENT	POTASSIUM FERTILIZER NUTRIENT	SODDING, SALT TOLERANT	SUPPLEMENTAL WATERING	PROTECTIVE COAT	PORTLAND CEMENT CONCRETE SIDEWALK. 5 INCH	DETECTABLE WARNINGS	SIDEWALK REMOVAL	CATCH BASINS TO BE ADJUSTED	INLETS TO BE ADJUSTED	VALVE VAULTS TO BE ADJUSTED	MAINTENANCE OF EXISTING TRAFFIC SIGNAL INSTALLATION	REBUILD EXISTING HANDHOLE	COMBINATION CONCRETE CURB AND GUTTER REMOVAL AND REPLACEMENT
			CU YD	SQ YD	POUND	POUND	POUND	SQ YD	UNIT	SQ YD	SQ FT	SQ FT	SQ FT	EACH	EACH	EACH	EACH	EACH	FOOT
OLDFIELD ROAD	NE		2.31	15.0	0.3	0.3	0.3	16.5	0.7	25	225	10	225			1			0
CARLISLE COURT	NW		1.5	10.0	0.2	0.2	0.2	11.0	0.5	32	150	10	150						10
CARLISLE COURT	NE		0.5	3.3	0.1	0.1	0.1	3.7	0.2	21	50	10	50						10
CARRIAGE GREEN DRIVE	NW		1.0	6.7	0.1	0.1	0.1	7.3	0.3	27	100	10	100		1				10
CARRIAGE GREEN DRIVE	NE		1.0	6.7	0.1	0.1	0.1	7.3	0.3	27	100	10	100		1				10
CURB RAMP AT STA 38+50			1.3	8.3	0.2	0.2	0.2	9.2	0.4	30	125	10	125						10
CURB RAMP AT STA 44+70			1.3	8.3	0.2	0.2	0.2	9.2	0.4	30	125	10	125						10
EVERGREEN LANE	NW		1.0	6.7	0.1	0.1	0.1	7.3	0.3	27	100	10	100						10
EVERGREEN LANE	NE		0.5	3.3	0.1	0.1	0.1	3.7	0.2	21	50	10	50	1					10
BAILEY ROAD	NW		0.9	5.7	0.1	0.1	0.1	6.2	0.3	22	85	8	85						8
BAILEY ROAD	NE		1.1	7.5	0.2	0.2	0.2	8.3	0.4	28	113	10	113						10
BAILEY ROAD	SW	NORTH	QUANTITIES	S ARE COMB	INED WITH	THE RAMP	BELOW												
BAILEY ROAD	SW	EAST	0.6	4.3	0.1	0.1	0.1	4.7	0.2	32	64	16	64						16
BAILEY ROAD	SE		0.6	3.7	0.1	0.1	0.1	4.1	0.2	19	56	8	56						8
CASS AVENUE	NW		1.0	6.7	0.1	0.1	0.1	7.3	0.3	27	100	10	100				1	1	10
SUB-TOTAL =			14.4	96.2	2.0	2.0	2.0	105.8	4.8	369.3	1442.5	142.0	1442.5	1	2	1	1	1	132.0
DRAINAGE IMPROVEMENT			174.0	233.0	12.7	12.7	12.7		3.4										

AMOUNT OF SURPLUS MATERIAL RESULTING FROM GRADING AND SHAPING THE SUBGRADE DUE TO PROPOSED SIDEWALK ELEVATION CHANGE. DOES NOT INCLUDE TOPSOIL (TYP FOR ALL PROPOSED CURB RAMPS)

	44201735	44201823	44201827	44201831	44201833
LOCATION 2	CLASS D PATCHES, TYPE IV, 7 INCH	CLASS D PATCHES. TYPE I. 15 INCH	CLASS D PATCHES. TYPE II. 15 INCH	CLASS D PATCHES, TYPE III, 15 INCH	CLASS D PATCHES. TYPE IV. 15 INCH
	SQ YD	SQ YD	SQ YD	SQ YD	SQ YD
EASTBOUND		10	20	25	590
WESTBOUND		0	0	0	175
NORTH SIDE OF BAILY RD					40
NORTH SIDE OF EVERGREEN LN					89
SOUTH SIDE OF EVERGREEN LN					111
SOUTH SIDE OF CARRIAGE GREEN DR					98
DRAINAGE IMPROVEMENTS	178				
TOTAL =	178	10	20	25	1103

E ALL PAVEMENT PATCHING LOCATIONS WILL BE DETERMINED IN THE FIELD BY THE RESIDENT ENGINEER/TECHNICIAN.

FILE NAME =	USER NAME = Velichkovvv	DESIGNED -	REVISED -		L_55 NO		TAGE BO	ח _ ח		TO CASS AVE	F.A.I. RTF	SECTION	COUNTY	TOTAL SHEET
pw:\\IL084EBIDINTEG.1llinois.gov:PWIDOT\Do	cuments\IDOT Offices\District 1\Projects\D104	513RGANDOata\Design\D104515-sht-schedule.d	nREVISED -	STATE OF ILLINOIS	1-55 110					TO CASS AVE	55	2014-063-RS&T	DuPAGE	40 7
	PLOT SCALE = 100.0000 ' / in.	CHECKED -	REVISED -	DEPARTMENT OF TRANSPORTATION	SCHEDULE OF QUANTITIES								CONTRACT	NO. 60Y98
Default	PLOT DATE = 5/20/2016	DATE -	REVISED -		SCALE: SHEET OF SHEETS STA. TO					TO STA.		ILLINOIS FED. /	ID PROJECT	

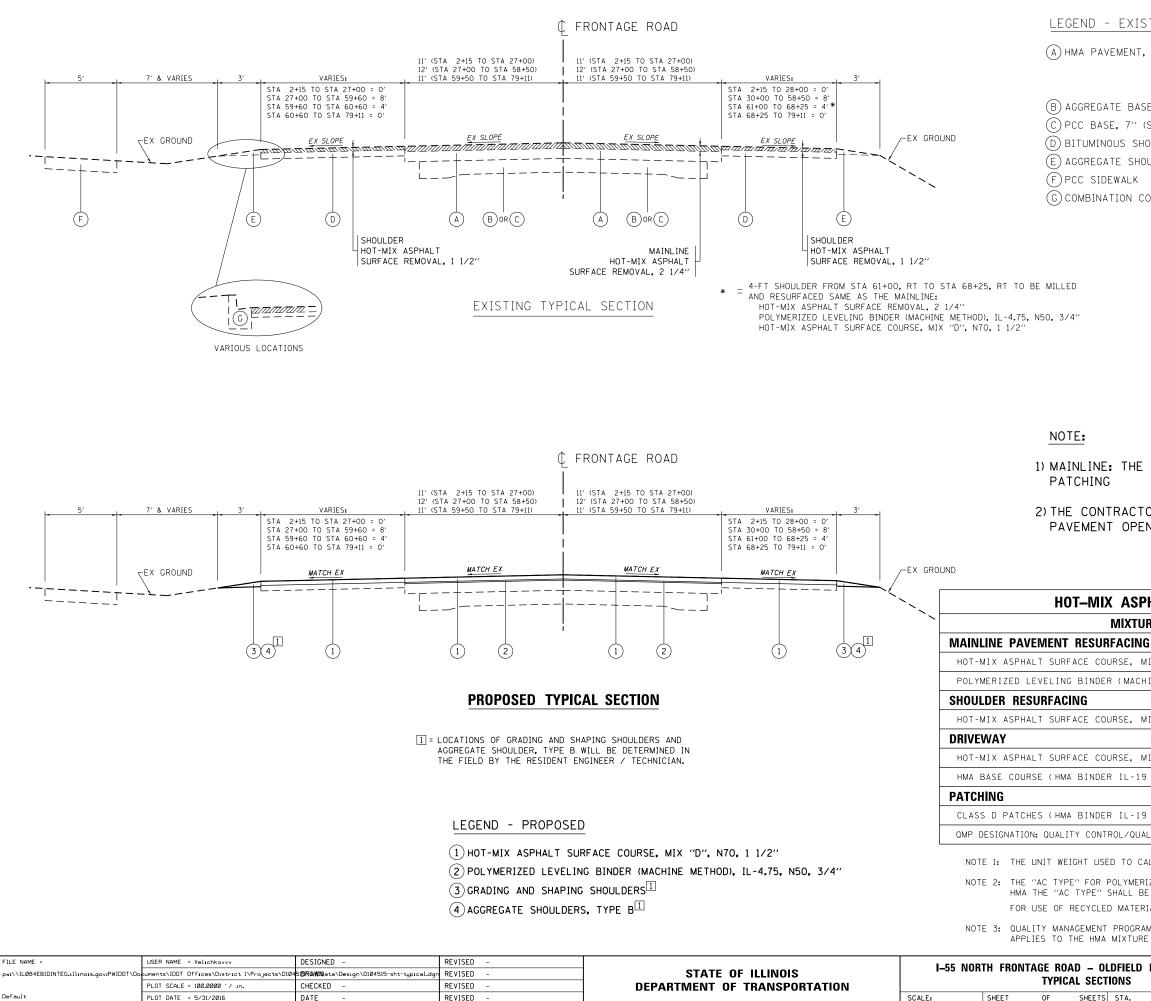

PLOT DATE = 5/31/2016

DATE

REVISED

### LEGEND - EXISTING

(A) HMA PAVEMENT, THICKNESS VARIES: STA 10+00 TO STA 53+00: 6.5" - 8" STA 65+00 TO STA 78+00: 15" - 16" (B) AGGREGATE BASE, 7" (STA 3+50.5 TO STA 31+00, STA 54+00 TO STA 79+11.5) (C) PCC BASE, 7" (STA 32+00 TO STA 53+00) (D) BITUMINOUS SHOULDER, THICKNESS UNKNOWN (E) AGGREGATE SHOULDER (G) COMBINATION CONCRETE CURB AND GUTTER

1) MAINLINE: THE CONTRACTOR SHALL MILL FIRST BEFORE

2) THE CONTRACTOR SHALL COMPLETE THE DRAINAGE IMPROVEMENT PAVEMENT OPENING AND PATCHING BEFORE THE RESURFACING.

IX ASPHALT MIXTURE REQUIREMENTS		
MIXTURE TYPE	AIR VOIDS @ Ndes	QMP
JRFACING		
OURSE, MIX "D", N70 (IL 9.5 mm)	4%. AT 70 GYR.	QCP
ER (MACHINE METHOD), IL-4.75, N50	3.5% AT 50 GYR.	QCP
OURSE, MIX "D", N70 (IL 9.5 mm)	4%. AT 70 GYR.	QCP
OURSE, MIX "D", N70 (IL 9.5 mm); 2"	4%. AT 70 GYR.	QCP
ER IL-19 mm); 6"	4% AT 50 GYR.	QC/QA
ER IL-19 mm)	4% AT 70 GYR.	QC/QA
NTROL/QUALITY ASSURANCE (QC/QA); QUALITY CONTROL F	DR PERFORMANCE (QCP)	
SED TO CALCULATE ALL HMA SURFACE MIXTURE QUANTITI	ES IS 112 LBS/SQ YD/	IN

NOTE 2: THE "AC TYPE" FOR POLYMERIZED HMA MIXES SHALL BE "SBS/SBR PG 76-22" AND FOR NON-POLYMERIZED HMA THE "AC TYPE" SHALL BE "PG 64-22" UNLESS MODIFIED BY DISTRICT ONE SPECIAL PROVISIONS. FOR USE OF RECYCLED MATERIALS SEE SPECIAL PROVISIONS.


NOTE 3: QUALITY MANAGEMENT PROGRAM (QMP) IDNTIFIES THE PARTICULAR QUALITY CONTROL SPECIFICATION THAT

55 2014-063-RS&T DuPAGE 40	OLDFIELD RD TO CASS AVE		F.A.I. RTE.	SECTION	COUNTY	TOTAL SHEETS	SHEET NO.			
			55	2014-063-RS&T	DuPAGE	40	8			
CONTRACT NO. 601			0110					CONTRACT	NO. 6	50Y98
ILLINOIS FED. AID PROJECT	'S ST	s s	STA.	TO STA.			ILLINOIS FED. A	ID PROJECT		

SHEETS


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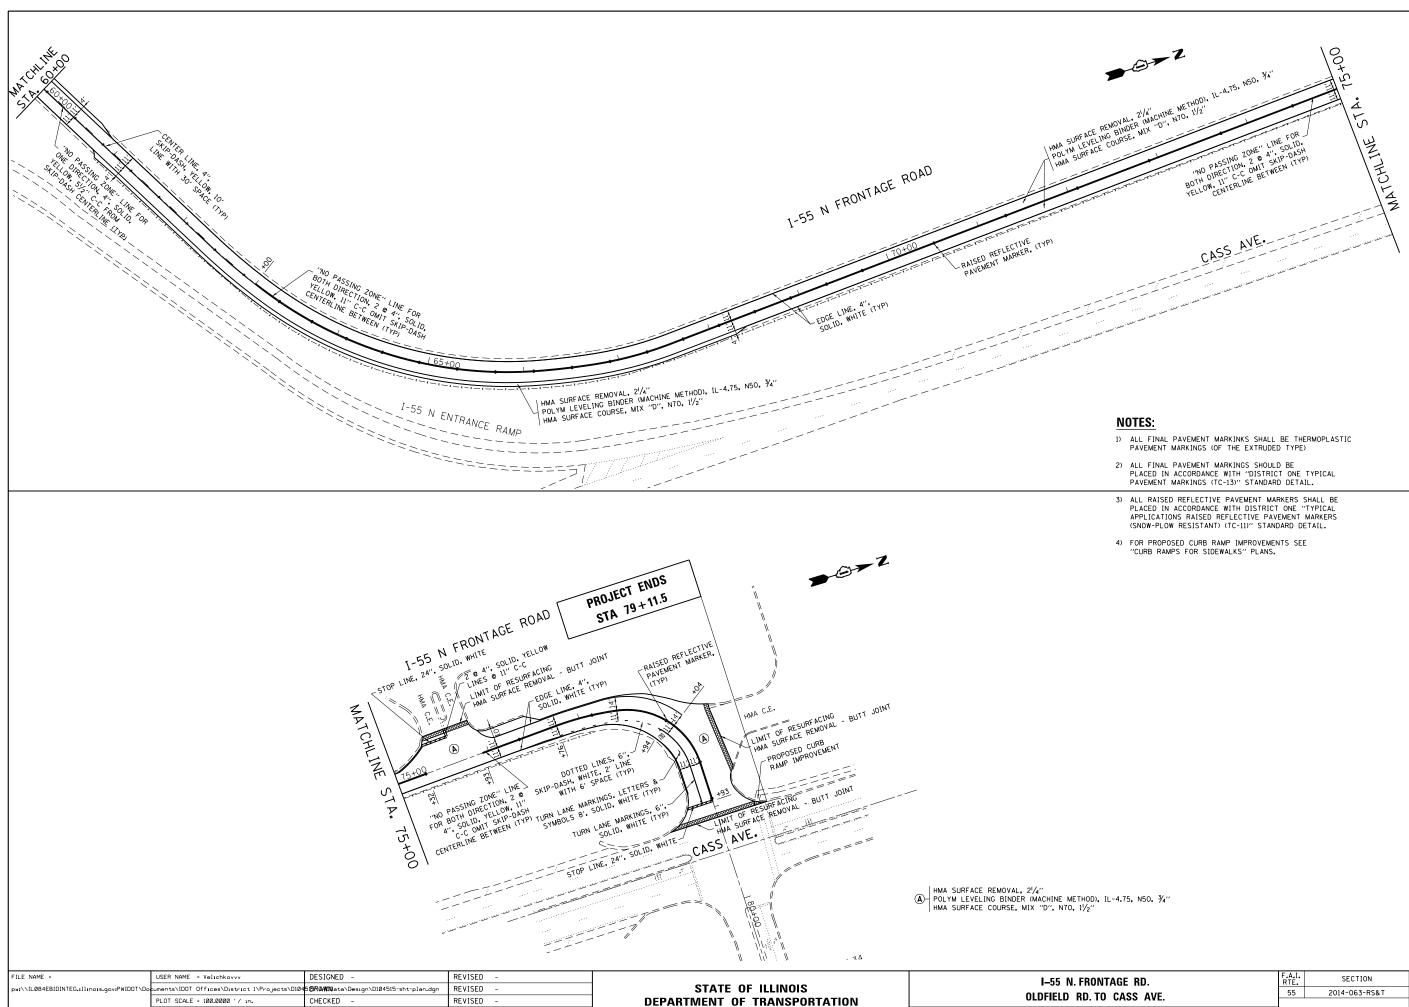
SHEET



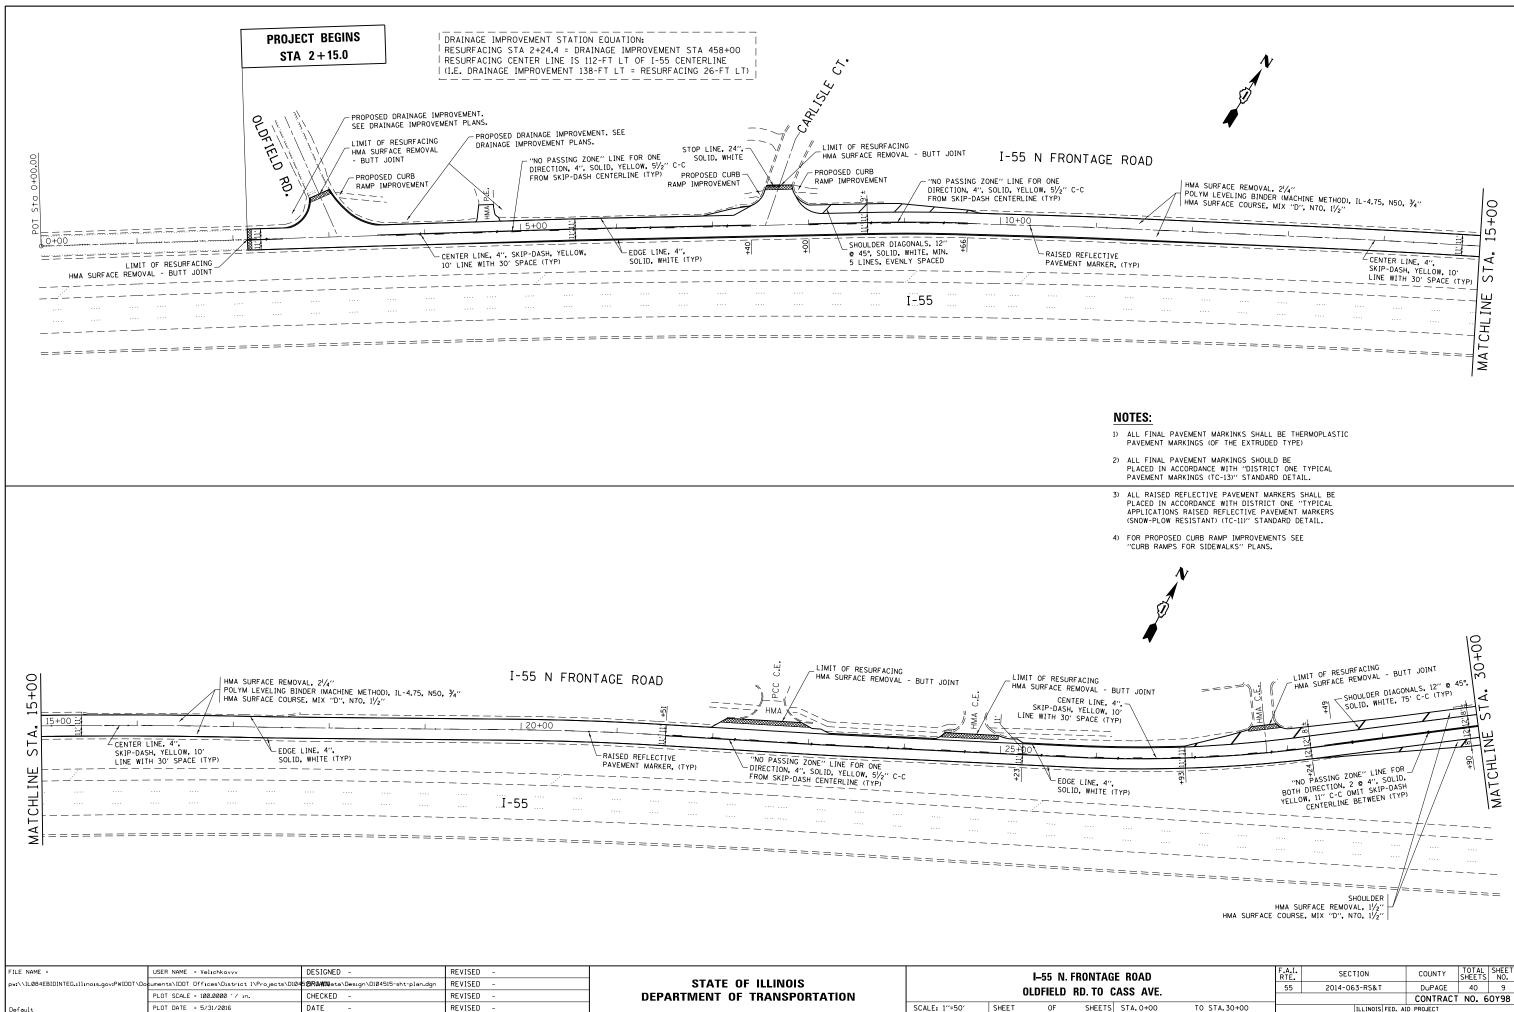

AGE ROAD	F.A.I. RTE.	SECTION	COUNTY	TOTAL SHEETS	SHEET NO.
CASS AVE.		2014-063-RS&T	DuPAGE	40	9
CA33 AVL.		CONTRACT	NO. 6	0Y98	
TS STA.0+00 TO STA.30+00	ILLINOIS FED. AID PROJECT				



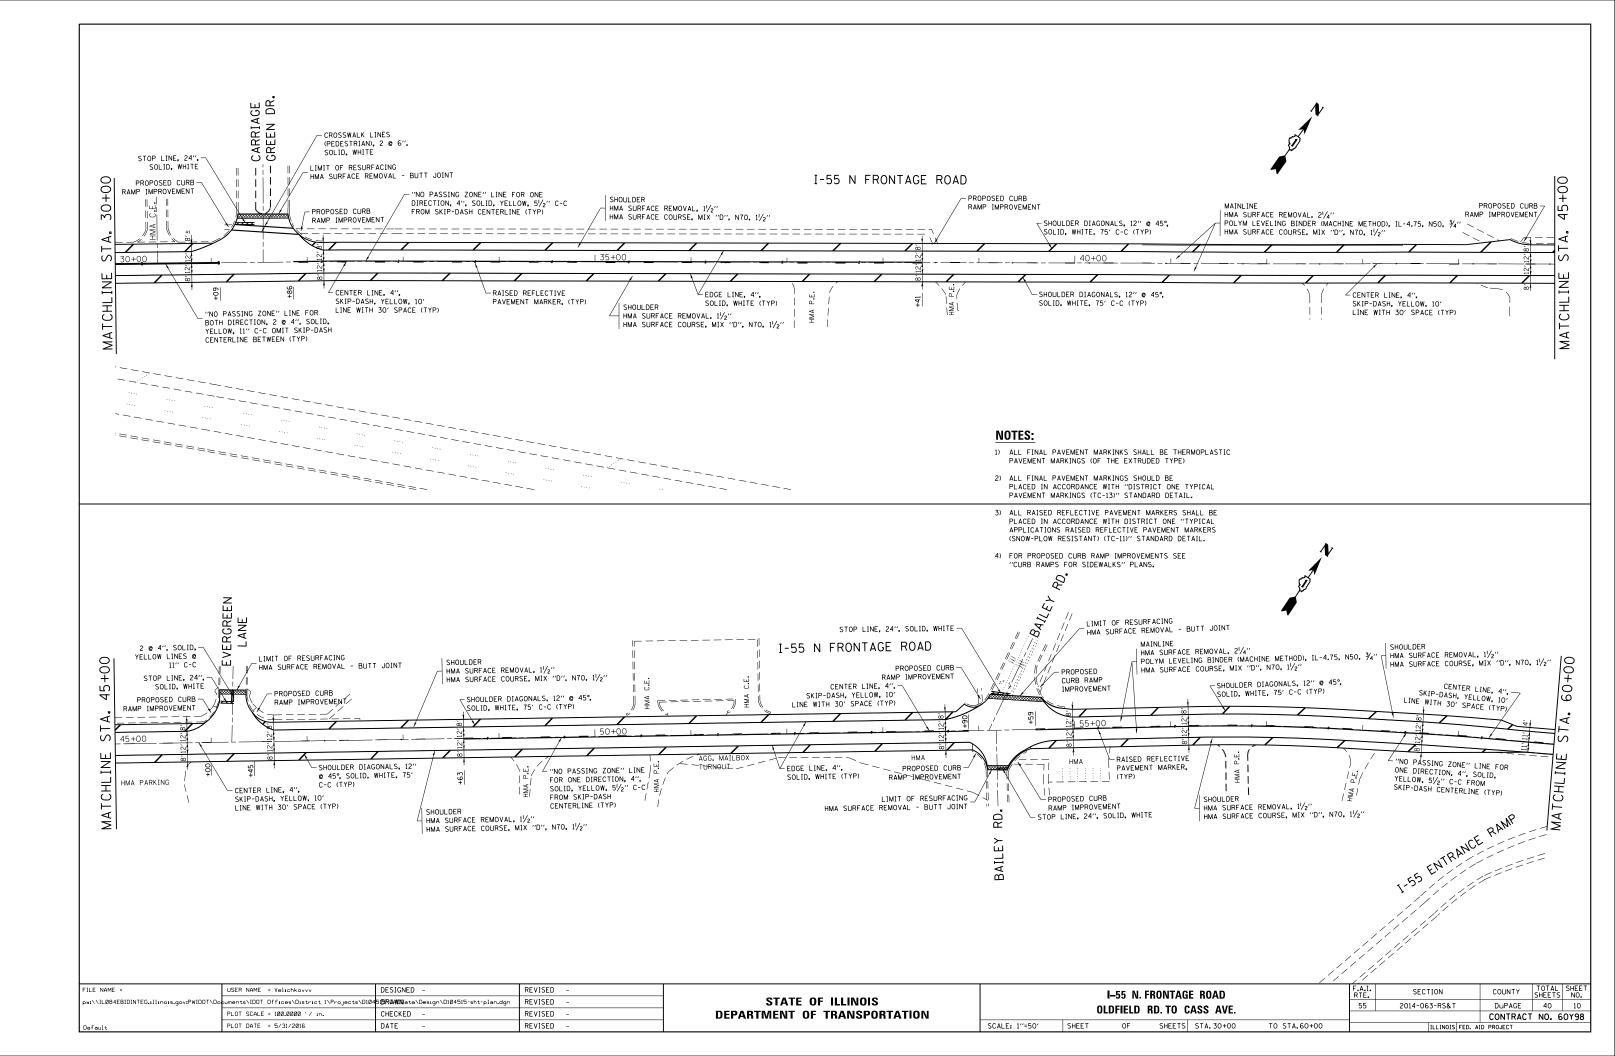

REVISED


PLOT DATE = 5/31/2016

DATE


SCALE: 1"=50' SHEET


OF SHEET


TAGE RD. CASS AVE.		F.A.I. RTE.	SECTION	COUNTY	TOTAL SHEETS	SHEET NO.	
		55	2014-063-RS&T	DuPAGE	40	11	
CA33 AVE.					CONTRACT	NO. 6	0Y98
ΤS	STA. 60+00	TO STA.81+02.34		ILLINOIS FED. AI	D PROJECT		

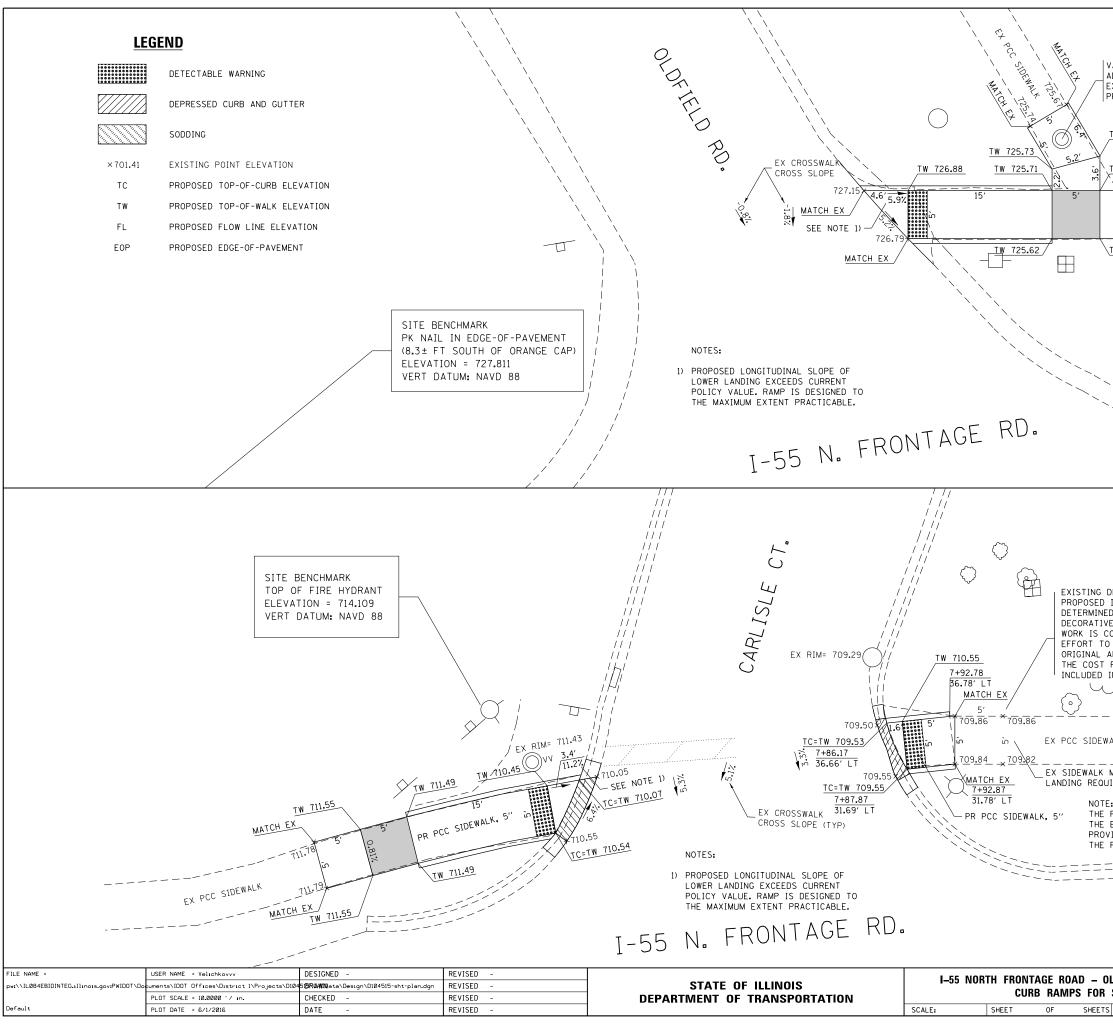


		un,			
		-44			
VALVE VAULT TO BE		<b>N</b>	Ç		
ADJUSTED - IF REQUIRED EX RIM= 725.71		1	ζ.		
PR RIM= 725.70±		Ş9	q		
TW 725.65					
TW 705 C7 TW 704 40					
<u>TW 725.63</u> <u>TW 724.46</u>	MA	TCH EX			
15'	5' 724	43			
PR PCC SIDEWALK, 5"	2	EX PCC SIDEWAL	к		
	724	.34			
<u>TW 725.58</u> <u>TW 724.41</u>	MA	TCH EX			
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		June 199			
		4			
DECORATIVE STONES IN CONFLIC IMPROVEMENTS SHALL BE TEMP		ATED AS			
D BY THE RESIDENT ENGINEER . E STONES SHALL BE REINSTALL					
COMPLETED. THE CONTRACTOR SHOLD RESTORE THE DECORATIVE STO	ALL MAKE E	'ERY			
APPEARANCE.					
FOR RELOCATION AND REINSTAL IN THE CONTRACT BID PRICES F					
Maria and a second			N	_	
		SCAPING TIMBERS			
ALK					
 MEETS_UPPER					
JIREMENTS					
PROPOSED RAMP LOCATION DOE:	S NOT MATCH				
EXISTING RAMP LOCATION EXAC	TLY. USE				
/IDED STATION AND OFFSET TO PROPOSED RAMP.	CONSTRUCT				
=======================================					
DLDFIELD RD TO CASS AVE	F.A.I. RTE.	SECTION	COUNTY	TOTAL SHEETS	
SIDEWALKS	55	2014-063-RS&T	DUPAGE CONTRACT	40 NO. 6	12 0Y98

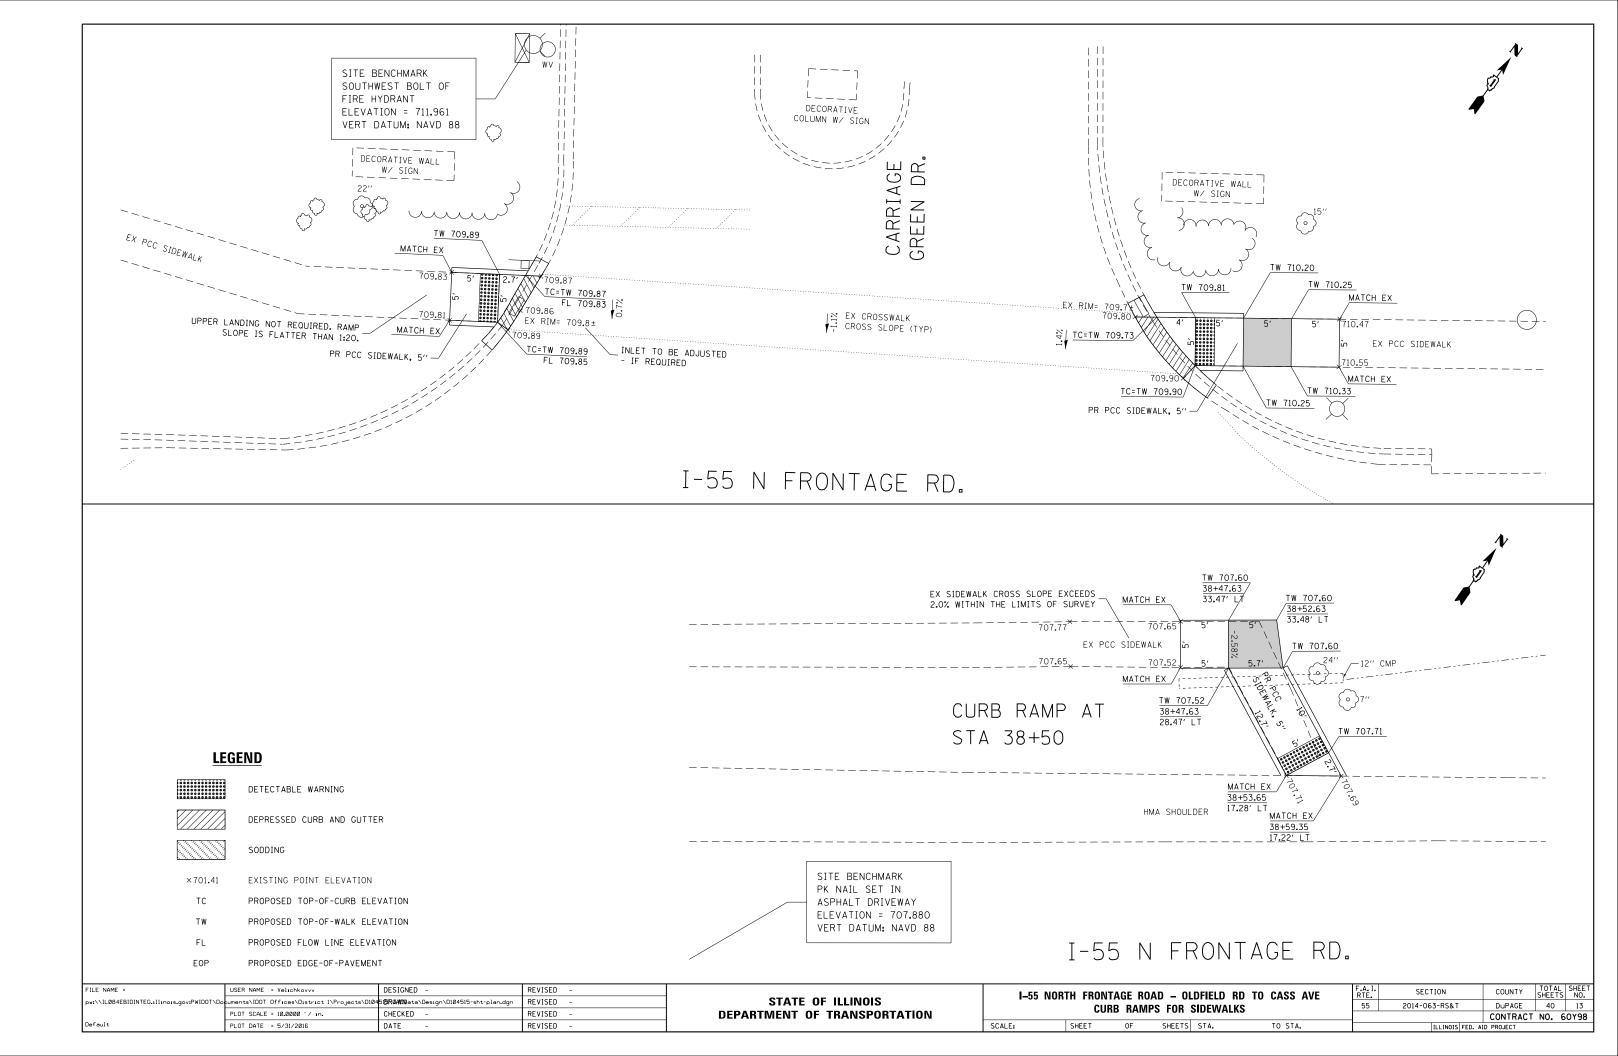


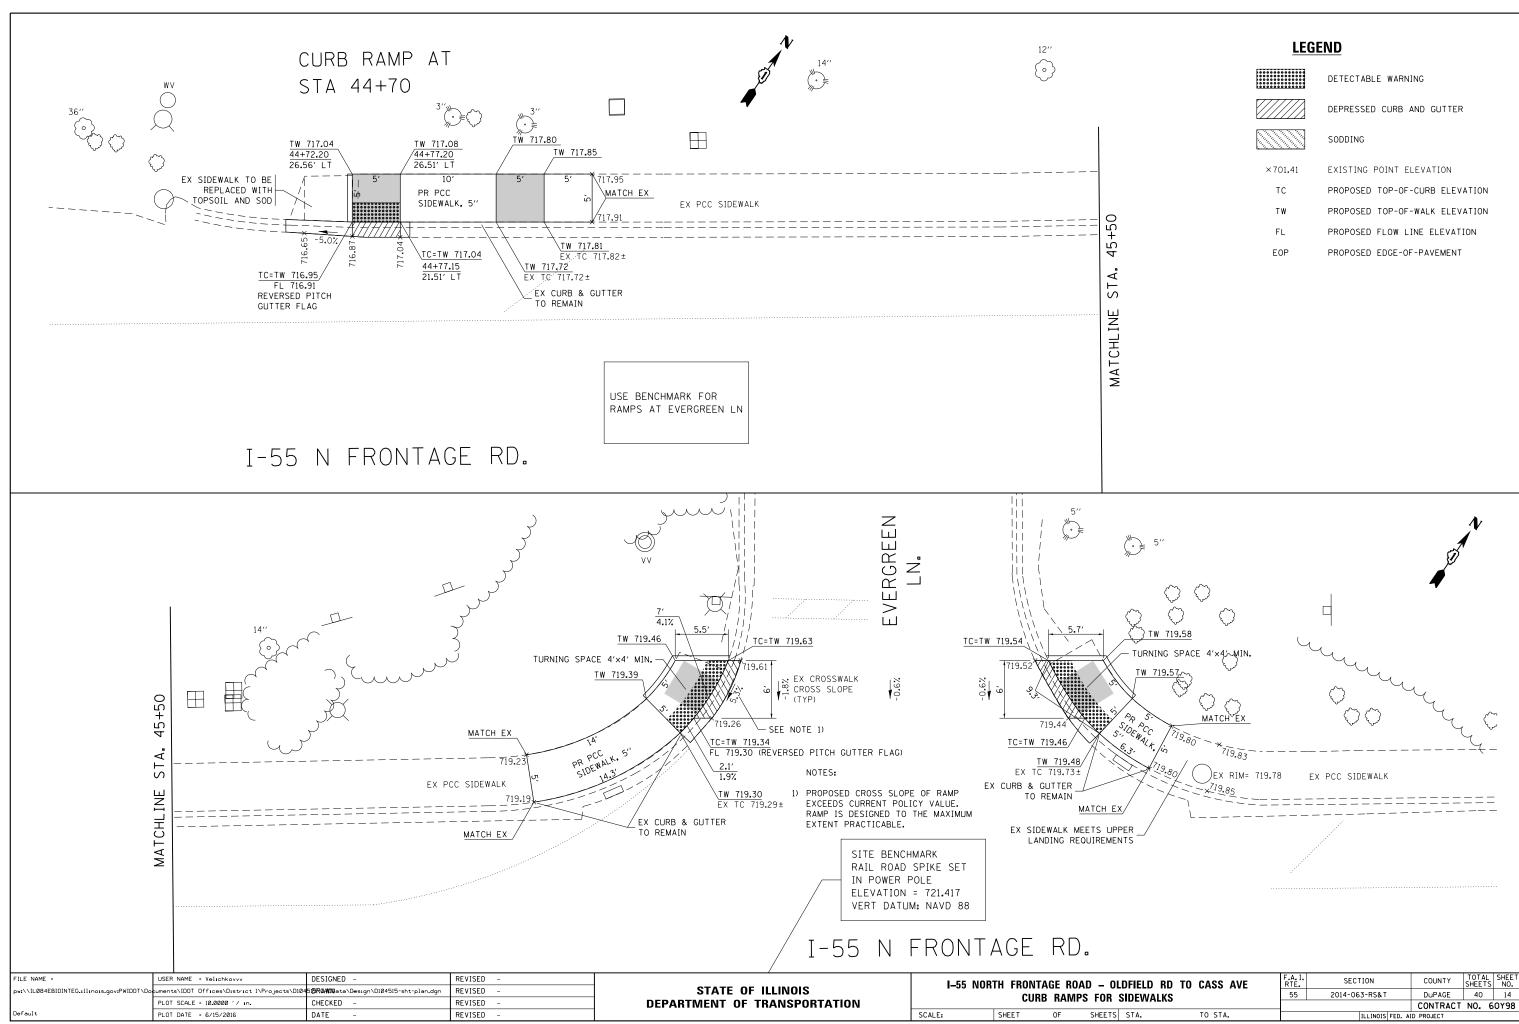

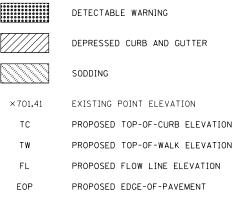

OLDFIELD RD TO CASS AVE	F.A.I. RTE.	SECTION	COUNTY	TOTAL SHEETS	SHEET NO.		
R SIDEWALKS		SIDFWALKS 55 2014-063-R		2014-063-RS&T	DuPAGE	40	14
			CONTRACT	NO. 6	50Y98		
S STA. TO STA.	ILLINOIS FED. AID PROJECT						

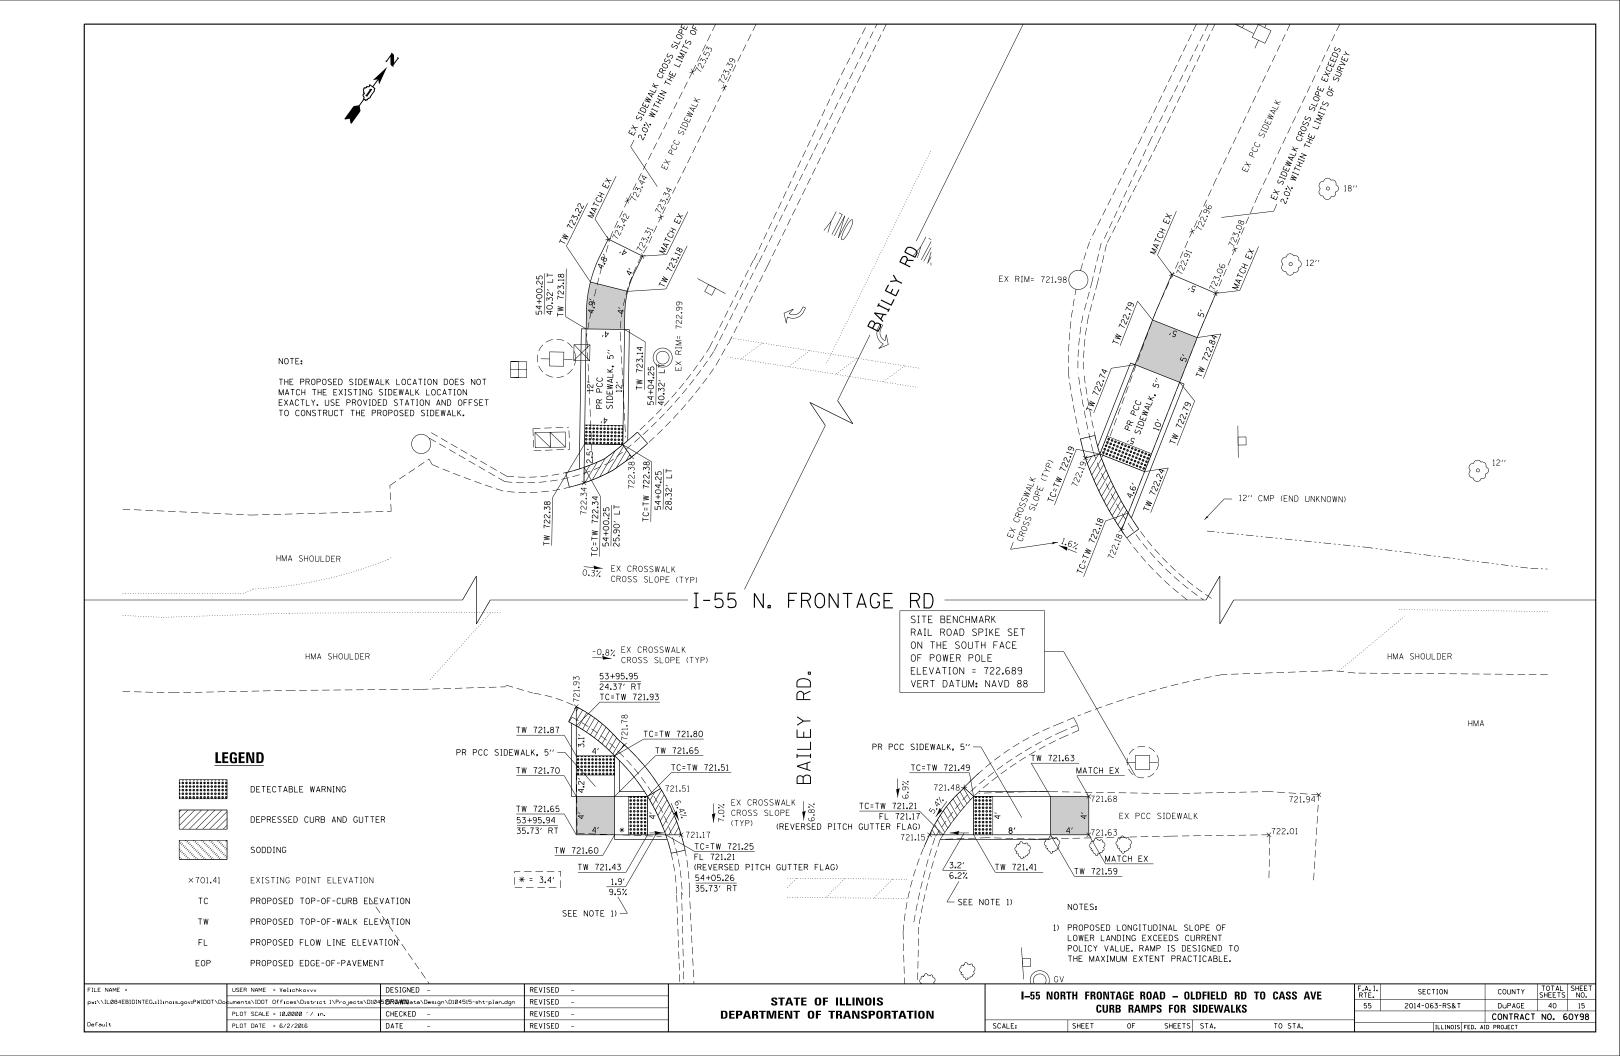

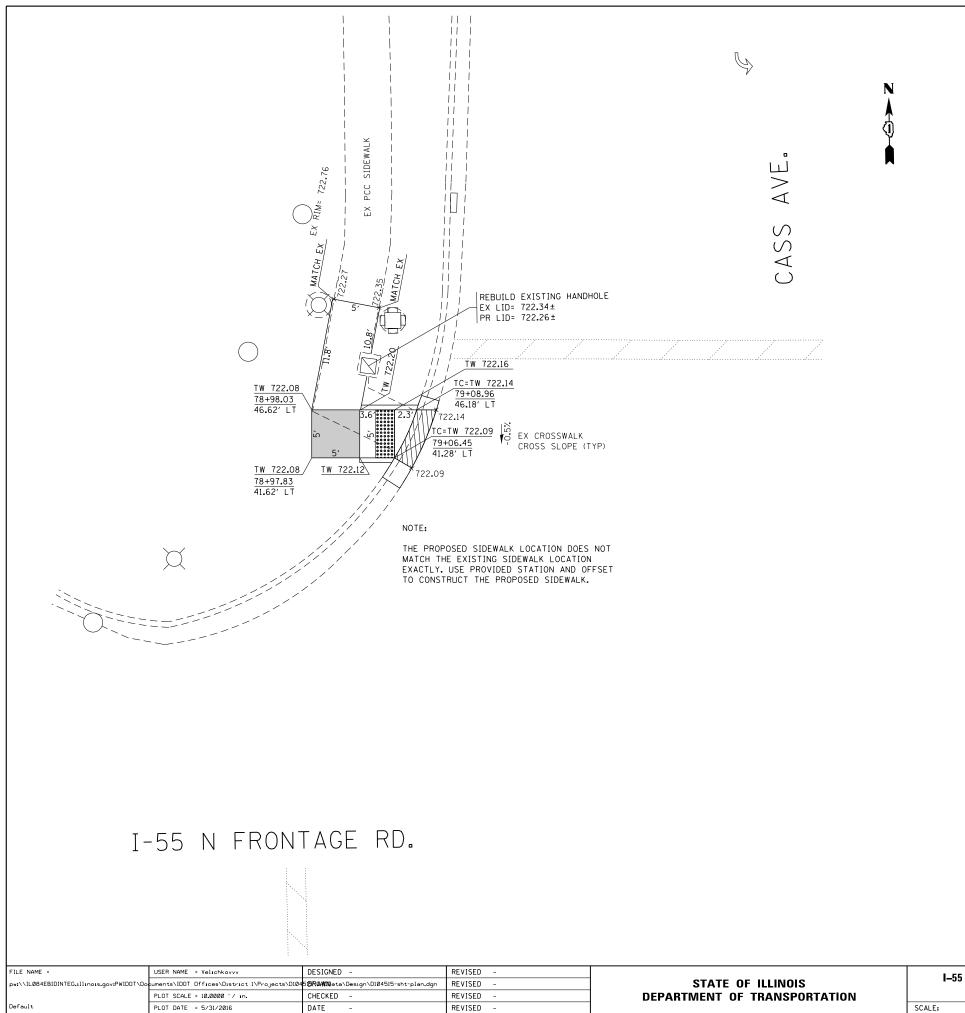

# **LEGEND**

	DETECTABLE WARNING
	DEPRESSED CURB AND GUTTER
	SODDING
×701.41	EXISTING POINT ELEVATION
TC	PROPOSED TOP-OF-CURB ELEVATION
ΤW	PROPOSED TOP-OF-WALK ELEVATION
FL	PROPOSED FLOW LINE ELEVATION
EOP	PROPOSED EDGE-OF-PAVEMENT

OLDFIELD RD TO CASS AVE		SECTI	[ON		COUNTY	TOTAL SHEETS	SHEET NO.
		2014-063	-RS&T		DuPAGE	40	16
OBEWAEKO					CONTRACT	NO. 6	50Y98
TS STA. TO STA.		I	LLINOIS	FED. AI	ID PROJECT		

# GENERAL NOTES

THE CONTRACTOR SHALL NOTIFY THE AGENCIES AND UTILITIES AT LEAST 10 DAYS PRIOR TO ANY CONSTRUCTION IN THE AREA AND SHALL COMPLY WITH ALL RESTRICTIONS FOR EQUIPMENT MOVEMENTS AND CLEARANCES IN REGARDS TO THEIR FACILITIES.

MAINTAINING DRAINAGE: IT SHALL BE THE CONTRACTOR'S RESPONSIBILITY TO MAINTAIN DRAINAGE FLOWS AT ALL TIMES DURING THE PERFORMANCE FOR THE WORK. THE CONTRACTOR SHALL SUPPLY A PLAN AS A SUBMITTAL REVIEW FOR EACH LOCATION PROVIDING A PLAN THAT WILL MAINTAIN FLOWS THAT MEET ALL LOCAL, STATE AND FEDERAL REGULATIONS AND NOT CAUSE ANY DAMAGES UPSTREAM OR TO ANY ADJACENT DRAINAGE WATERSHED. THE PLAN SHALL BE SEALED BY A REGISTERED PROFESSIONAL ENGINEER IN THE STATE OF ILLINOIS. THIS PLAN MUST BE SUBMITTED AT LEAST TWO WEEKS PRIOR TO THE START OF ANY CULVERT WORK. COST OF MAINTAINING DRAINAGE FLOWS SHALL BE INCIDENTAL TO THE CONTRACT.

CONTRACTOR SHALL NOT SCALE DIMENSIONS FROM THE CONTRACT PANS FOR CONSTRUCTION PURPOSES. SCALES, IF SHOWN, ARE FOR INFORMATION ONLY.

THE HORIZONTAL CONTROLS SHALL BE BASED ON STATE PLANE COORDINATES (NAD83). THE VERTICAL CONTROLS ARE BASED ON NORTH AMERICAN DATUM 1988 (NAVD88).

RESTORATION AREAS WILL INCLUDE ALL DISTURBED AREAS INCLUDING AREA FOR GRADING AND SHAPING DITCHES AND STABLIZING SLOPES AND THE STABILIZED CONSTRUCTION ENTRANCE WITH PLACING TOPSOIL, SEEDING CLASS 2A, NITROGEN FERTILIZER, POTASSIUM FERTILIZER, PHOSPHOROUS FERTILIZER AND EROSION CONTROL BLANKET. ITEMS LISTED ABOVE WILL BE PAID FOR SEPARATELY.

ANY CLEANING AND REMOVAL OF DEBRIS, SILT AND FOREIGN MATERIAL, VEGETATION, GRASS AND WEEDS ALONG THE DITCH LINE TO THE CULVERT OUTSIDE THE LIMITS OF CULVERT, WILL BE PAID UNDER GRADING AND SHAPING DITCHES.

BEFORE STARTING ANY EXCAVATION, THE CONTRACTOR SHALL CALL "J.U.L.I.E" AT 1-800-892-0123 FOR FIELD LOCATION OF BURIED ELECTRIC, TELEPHONE AND GAS FACILITIES AT LEAST 48 HOURS PRIOR TO BEGINNING CONSTRUCTION.

ALL INVERT ELEVATIONS FOR EXISTING AND PROPOSED PIPES, CULVERTS AND HEADWALLS TO BE CONSTRUCTED SHALL BE VERIFIED BY THE CONTRACTOR PRIOR TO CONSTRUCTION.

### CULVERT STRUCTURE GENERAL NOTES

PLAN DIMENSIONS AND DETAILS RELATIVE TO EXISTING STRUCTURE HAVE BEEN TAKEN FROM FIELD MEASUREMENTS. IT SHALL BE THE CONTRACTOR'S RESPONSIBILITY TO VERIFY SUCH DIMENSIONS AND DETAILS IN THE FIELD AND MAKE NECESSARY APPROVED ADJUSTMENTS PRIOR TO CONSTRUCTION OR ORDERING OF MATERIALS. SUCH VARIATIONS SHALL NOT BE JUSTIFICATION FOR SCHEDULING DELAYS OR CAUSE FOR ADDITIONAL COMPENSATION FOR A CHANGE IN THE SCOPE OF WORK. HOWEVER, THE CONTRACTOR WILL BE PAID FOR THE QUANTITY ACTUALLY FURNISHED AT THE UNIT PRICE FOR THE WORK.

THE REMOVAL AND DISPOSAL OF ALL EXISTING CONCRETE AND/OR METAL FLARED END SECTIONS AT LOCATIONS OF NEW END SECTION CONSTRUCTION SHALL BE INCLUDED IN THE COST OF "END SECTIONS" OR "CAST-IN-PLACE REINFORCED CONCRETE END SECTIONS" OF THE DIAMETER SPECIFIED.

ALL EXCAVATION AND BACKFILL REQUIRED FOR THE INSTALLATION OF NEW END SECTIONS SHALL BE INCLUDED IN THE COST OF "END SECTIONS" OR "CAST-IN-PLACE REINFORCED CONCRETE END SECTIONS" OF THE DIAMETER SPECIFIED.

UPON INSPECTION OF CULVERTS TO BE LINED, THE CONTRACTOR SHALL IDENTIFY ALL LATERAL CONNECTIONS AND SHALL INCORPORATE THESE CONNECTIONS INTO THE LINER IN SUCH A WAY AS TO CREATE A WATER TIGHT SEAL. THIS WORK SHALL INCLUDE LINING, EXTENDING, OR GROUTING THE LATERAL PIPE AS NECESSARY TO MAKE THE CONNECTION. THE COST OF THIS WORK SHALL BE INCLUDED IN THE COST OF INSERTION CULVERT LINER.

CULVERT LINERS SHALL BE INSTALLED ACCORDING TO THE IDOT STANDARD SPECIFICATIONS SECTION 543 AND THE SPECIAL PROVISION "INSERTION CULVERT LINER" AND SHALL BE PAID FOR AS INSERTION CULVERT LINER OF THE INDICATED MINIMUM INSIDE DIAMETER.

BEFORE ORDERING PIPE CULVERTS OR PIPE DRAINS, THE CONTRACTOR SHALL CONSULT THE ENGINEER FOR EXACT LENGTHS.

THE WORK REQUIRED TO CONNECT ANY SEWER TO AN EXISTING DRAINAGE STRUCTURE OR PIPE WILL NOT BE PAID FOR SEPARATELY, BUT SHALL BE CONSIDERED AS INCLUDED IN THE CONTRACT UNIT PRICE BID FOR THE SEWER ITEMS.

ABANDONED UNDERGROUND UTILITIES THAT CONFLICT WITH CONSTRUCTION SHALL BE DISPOSED OF OUTSIDE THE LIMITS OF THE RIGHT-OF-WAY ACCORDING TO ARTICLE 202.03 OF THE STANDARD SPECIFICATIONS AND AS DIRECTED BY THE ENGINEER. THIS WORK WILL NOT BE PAID FOR SEPARATELY BUT SHALL BE INCLUDED IN THE COST OF EARTH EXCAVATION.

ANY REFERENCE TO A STANDARD IN THESE PLANS SHALL BE INTERPRETED TO MEAN THE EDITION AS INDICATED BY THE SUBNUMBER SHOWN IN THE LIST OF STANDARDS OR THE COPY INCLUDED IN THESE PLANS.

THE CONTRACTOR SHALL CONTACT J.U.L.I E. AT LEAST 48 HOURS PRIOR TO EXCAVATION TO DETERMINE WHICH UTILITIES ARE WITHIN THE AREA.


ANY TURF AREAS OUTSIDE THE CONSTRUCTION SEEDING LIMITS WHICH ARE DISTURBED SHALL BE REPAIRED, RESEEDED AND COVERED WITH EROSION BLANKET TO THE STAISFACTION OF AND AS DIRECTED BY THE ENGINEER AT THE CONTRACTORS EXPENSE.


		DESIGNED -	GS	REVISED -	STATE OF ILLINOIS	I-55 FROI	NTAGE B		DLDFIELD RD. T	O CARLISLE CT.	F.A. RTE.	SECTION	COUNTY TOTAL SHEET SHEETS NO.
3100 Dundee Road, Suite 502, Northbrook, IL 60062   847.753.8020 office 847.753.8023 fax		DRAWN -	AF	REVISED -	DEPARTMENT OF TRANSPORTATION	GENERAL NOTES					55	2014-063-RS&T	DUPAGE 40 17
		CHECKED -	YO	REVISED -						_		CONTRACT NO. 60Y98	
Ltd.		DATE -	5/02/2016	REVISED -		SCALE:	SHEET	OF	SHEETS STA.	TO STA.		ILLINOIS FED. A	ID PROJECT


**DETAILS OF CONCRETE COLLAR** 

PIPE TO PIPE



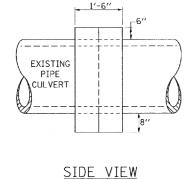


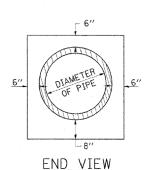

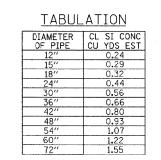

THE CONCRETE COLLAR SHALL BE PAID FOR AT THE CONTRACT UNIT PRICE PER CUBIC YARD FOR  $CONCRETE\ COLLAR,$  As shown on THE PLANS, WHICH PRICE SHALL INCLUDE THE REMOVAL OF SUCH PORTIONS THE EXISTING HEADWALLS AS MAY BE REQUIRED.

CLASS SI CONCRETE SHALL BE USED THROUGHOUT.

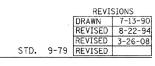

# **TEMPORARY DITCH CHECKS**

### PLACEMENT OF TEMPORARY DITCH CHECK IN DRAINAGE WAY

POINTS A SHOULD BE HIGHER THAN POINT B


SPACING BETWEEN TEMPORARY DITCH CHECKS

DITCH E


L = THE DISTANCE SUCH THAT POINTS A AND B ARE OF EQUAL ELEVATION

B = THE LOW POINT IN CENTER OF CHECK



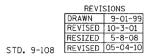



ls	I-55 FROM	NTAGE F	ROAD O	LDFIEL	F.A. RTE.	SECTION	COUNTY	TOTAL SHEETS	SHEET NO.		
			DRAIN	AGE DET	55	2014-063-RS&T	DUPAGE	40	18		
PORTATION			DIAN	NUL DL	AILU		_		CONTRACT	NO. 6	0Y98
SCALE: SHEET OF SHEETS STA. TO STA.						ILLINOIS FED. A	D PROJECT				

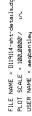



AEG 3100 Dundee Road, Suite 502, Northbrook, IL 60062 847 753 8020 office 847 753 8023 fax Ltd.

DESIGNED - GS REVISED STATE OF ILLINOIS DRAWN - AF REVISED **DEPARTMENT OF TRANSPO** CHECKED - YO REVISED DATE - 5/02/2016 REVISED

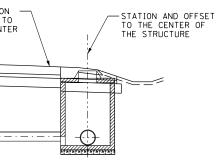


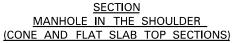

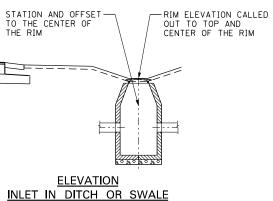

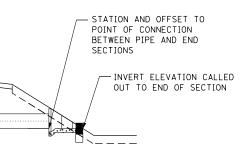

**ELEVATION** CONCRETE END SECTION

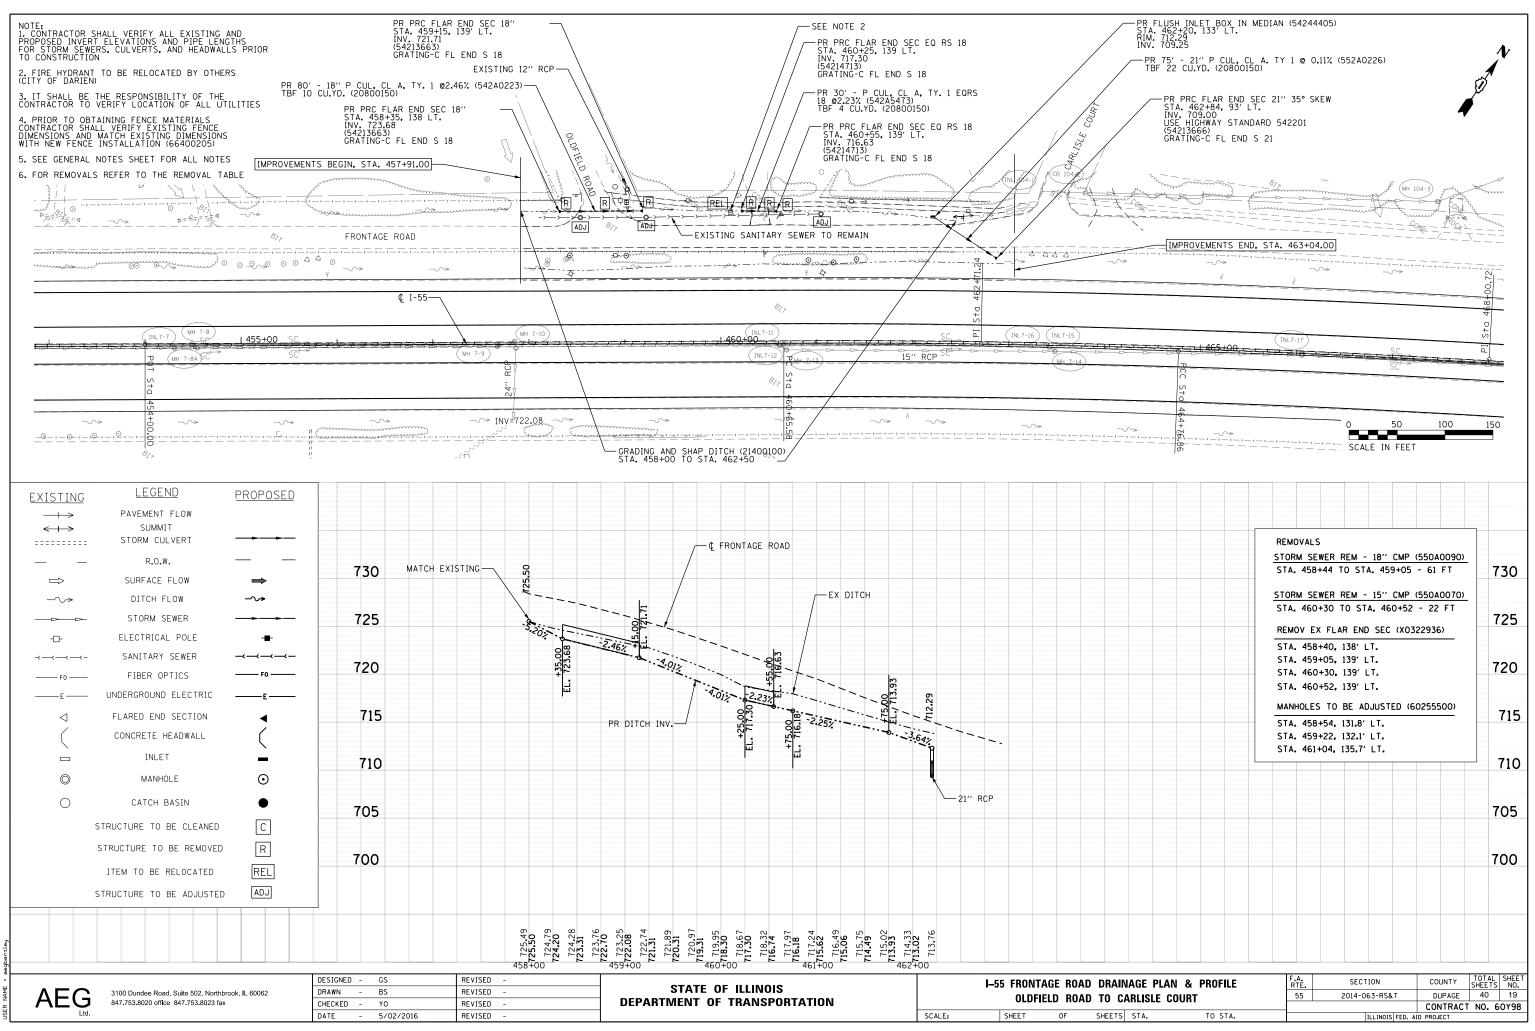

: NAME = D119114-sht-drain-6 Т SCALE = 100.0000 ′ / л.

# SOIL EROSION GENERAL NOTES

1. THE CONTRACTOR SHALL BE REQUIRED TO INSTALL AND MAINTAIN SILT FENCE AS INDICATED IN THE PLAN PRIOR TO BEGINNING ANY CONSTRUCTION ACTIVITIES WHICH WILL POTENTIALLY CREATE EROSION CONDITIONS.

2. EXISTING CULVERTS WITHIN THE DISTURBED LIMIT SHALL BE PROTECTED PRIOR TO ANY CONSTRUCTION ACTIVITIES COMMENCING UPSTREAM.

3. PERMANENT SEEDING/SODDING SHALL BE IMPLEMENTED ACCORDING TO THE PLAN IN CONJUNCTION WITH CONSTRUCTION STAGING.


4. THE CONTRACTOR SHALL MAKE INSPECTIONS A MINIMUM OF ONCE EVERY SEVEN DAYS OF THE FOLLOWING : 1) DISTURBED AREAS OF THE PROJECT SITE THAT HAVE NOT BEEN FULLY STABILIZED, 2) STRUCTURAL CONTROL MEASURES (SILT FENCE, ETC.) AND 3) LOCATIONS WHERE VEHICLES ENTER AND EXIT THE SITE. AN ADDITIONAL INSPECTION OF THE ITEMS LISTED ABOVE MUST BE MADE WITHIN TWENTY- FOUR (24) HOURS OF A 0.5-INCH OR GREATER RAINFALL OR EQUIVALENT SNOWFALL.

5. GRASS AREAS DISTURBED OR DAMAGED BY CONSTRUCTION ACTIVITIES SHALL BE RESTORED TO ORIGINAL CONDITIONS. GRASS AREAS SHALL BE SEEDED AND COVERED WITH EXCELSIOR BLANKET AS INDICATED ON THE PLANS OR IN THE SPECIAL PROVISIONS.

### 6. DUST CONTROL

(1) WHEN DUST BLOWING FROM CONSTRUCTION SITES MAY BECOME A TRAFFIC HAZARD OR A DANGER TO THE HEALTH OR COMFORT TO PERSONS DOWNWIND, IT SHALL BE CONTROLLED EITHER PERMANENTLY OR TEMPORARILY DEPENDING UPON THE STATE OF DEVELOPMENT OF THE SITE. DUST CONTROL MEASURES SHALL BE TAKEN WHEN REQUIRED BY THE GOVERNING AUTHORITY. (2) DUST PROBLEMS FROM ACTIVE CONSTRUCTION AREAS SHALL BE KEPT UNDER CONTROL BY MEANS OF WATERING DRY SURFACES AND/OR THE APPLICATION OF CALCIUM CHLORIDE. APPLICATION AND REPETITION RATES SHALL BE AS NECESSARY FOR EFFECTIVE CONTROL. (3) IN THE EVENT OF SEVERE DUST PROBLEMS, THE GOVERNING AUTHORITY MAY STOP SUCH DUST- PRODUCING ACTIVITIES UNTIL THE PROBLEM IS RESOLVED. (4) CONTRACTOR SHALL BE RESPONSIBLE TO TAKE NECESSARY MEASURES TO CONTROL DUST SO THERE WILL BE NO DUST PROBLEMS FOR ADJACENT RESIDENTS CAUSED BY CONSTRUCTION ACTIVITIES.

7. CONSTRUCTION ACTIVITIES SHALL BE SCHEDULED TO MINIMIZE THE TIME SOIL IS EXPOSED AND UNPROTECTED. IN NO CASE SHALL THE EXISTING VEGETATION BE DESTROYED, REMOVED, OR DISTURBED MORE THAN FOURTEEN (14) CALENDAR DAYS PRIOR TO THE INITIATION OF IMPROVEMENTS.

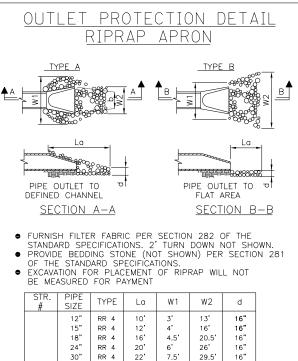

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AEG 847.753.8020 office 847.753.8023 fax	CHECKED - YO	REVISED
Ltd.	DATE - 5/02/2016	REVISED


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RR 4	20'	6'	26'	16"
RR 4	22'	7.5'	29.5'	16"
RR 4	24'	9'	33'	20"

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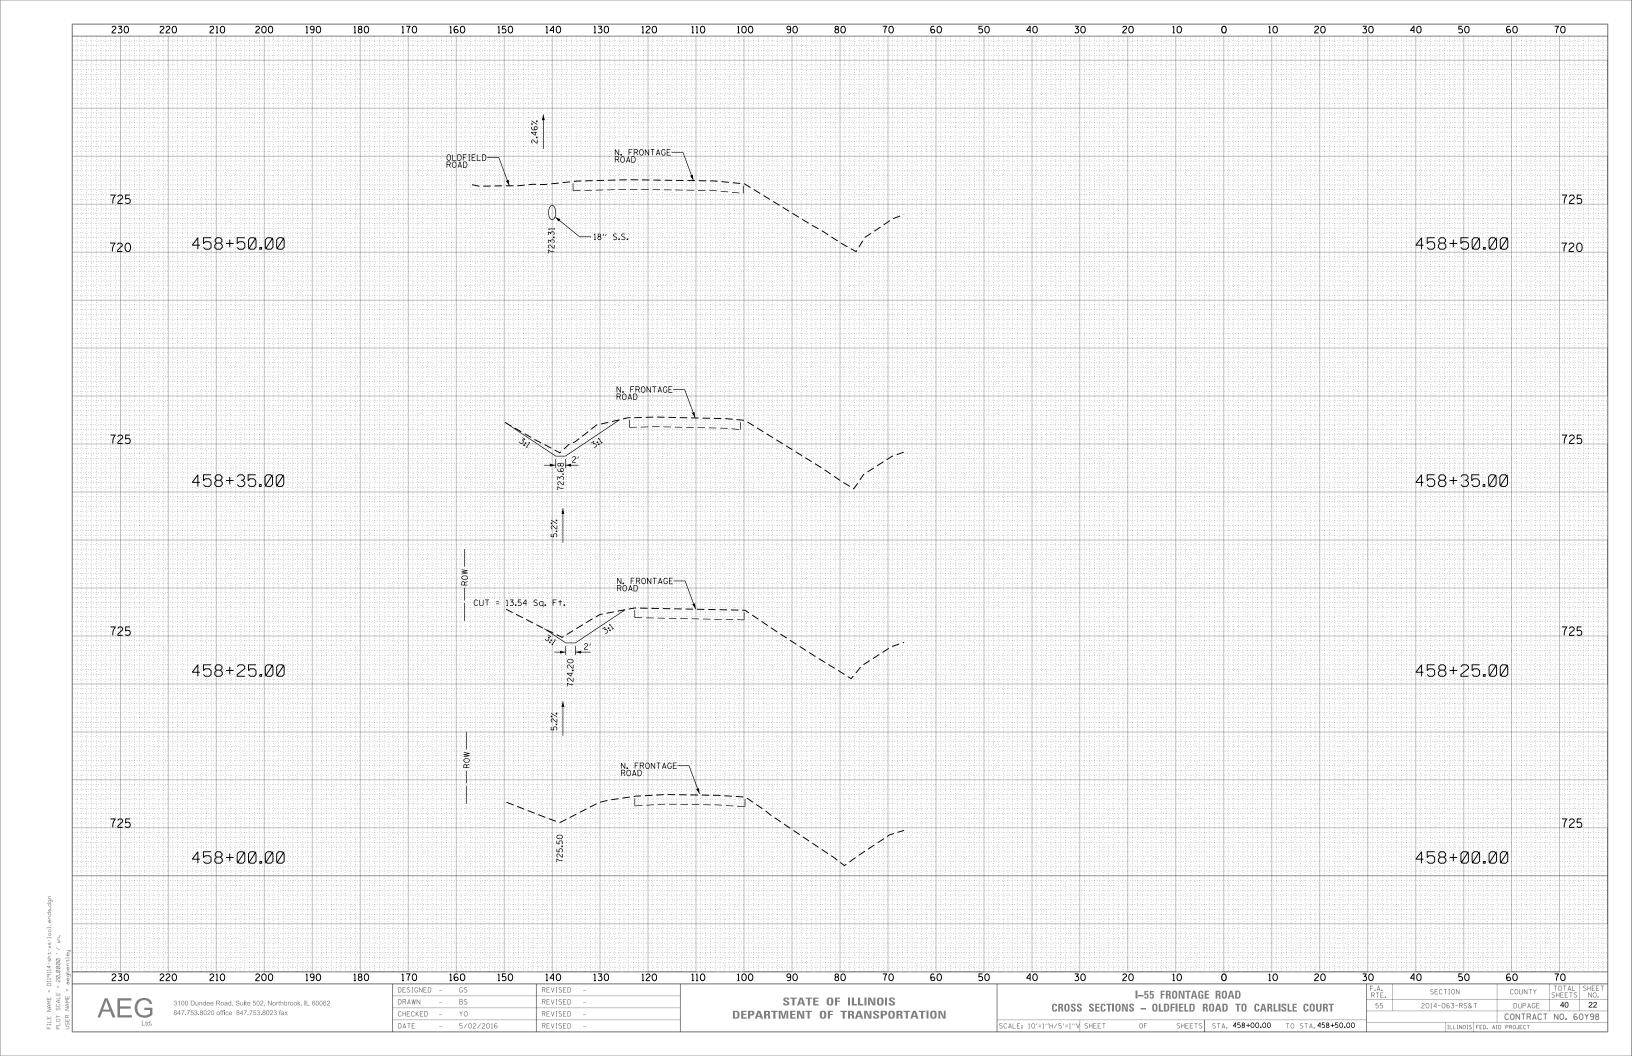
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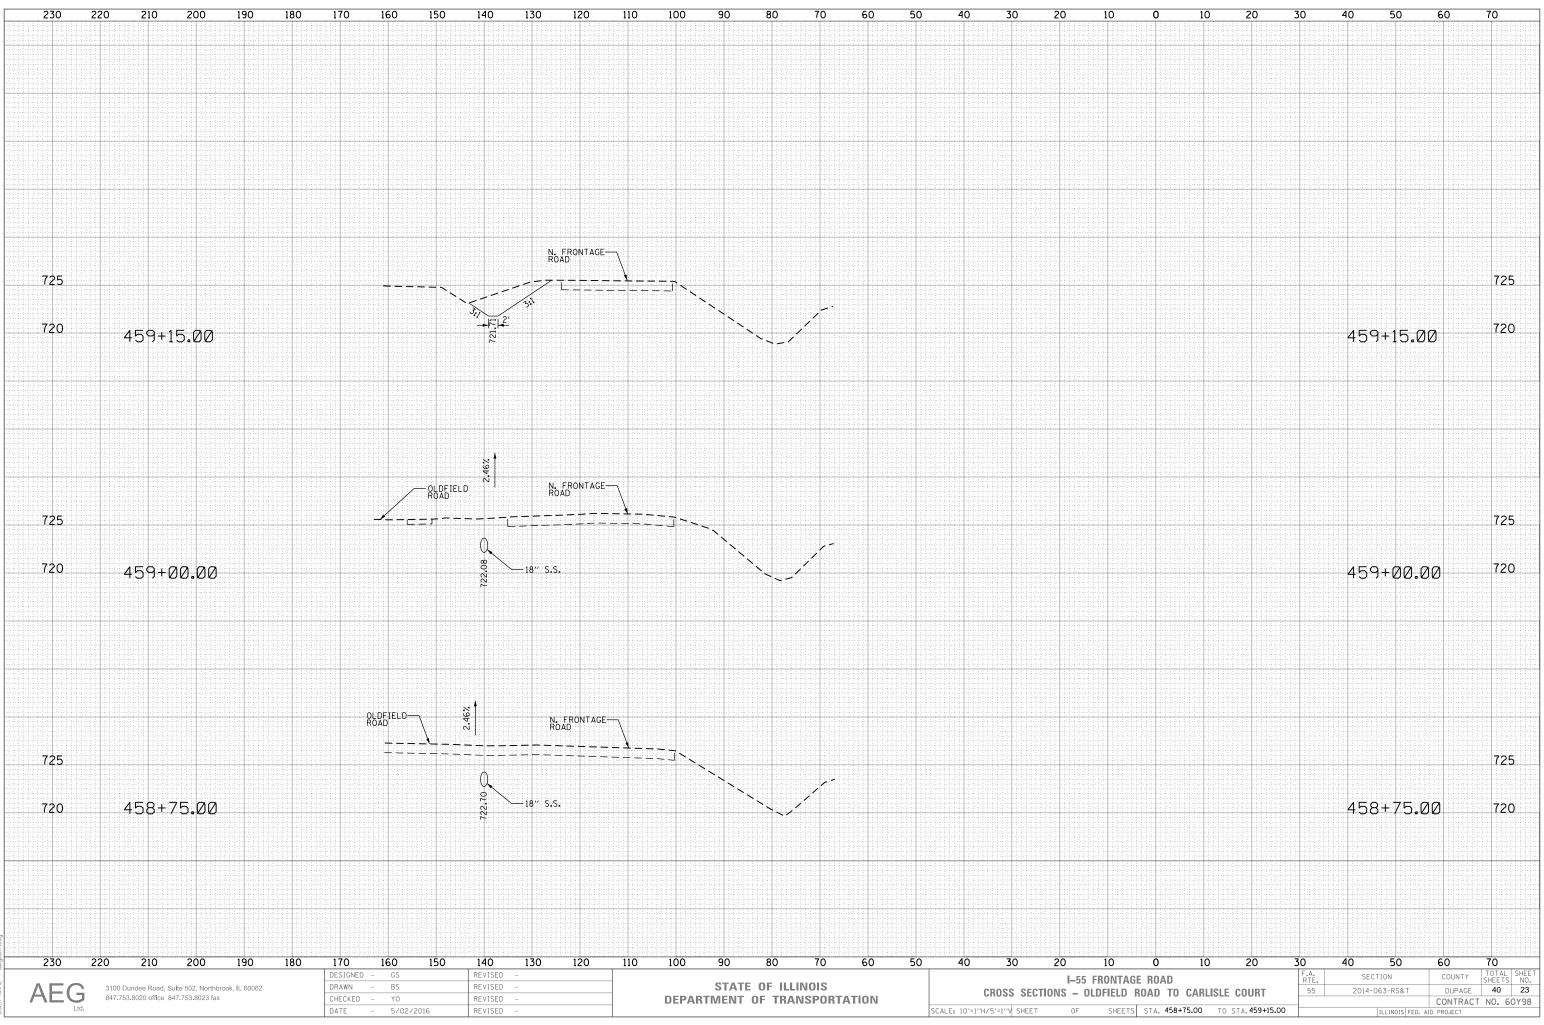
	AEG 3100 Dundee Road, Suite 502, Northbrook, IL 60062 847.753.8020 office 847.753.8023 fax	DESIGNED - GS DRAWN - AF	REVISED – REVISED –	STATE OF ILLINOIS	I–55 FRON			FIELD
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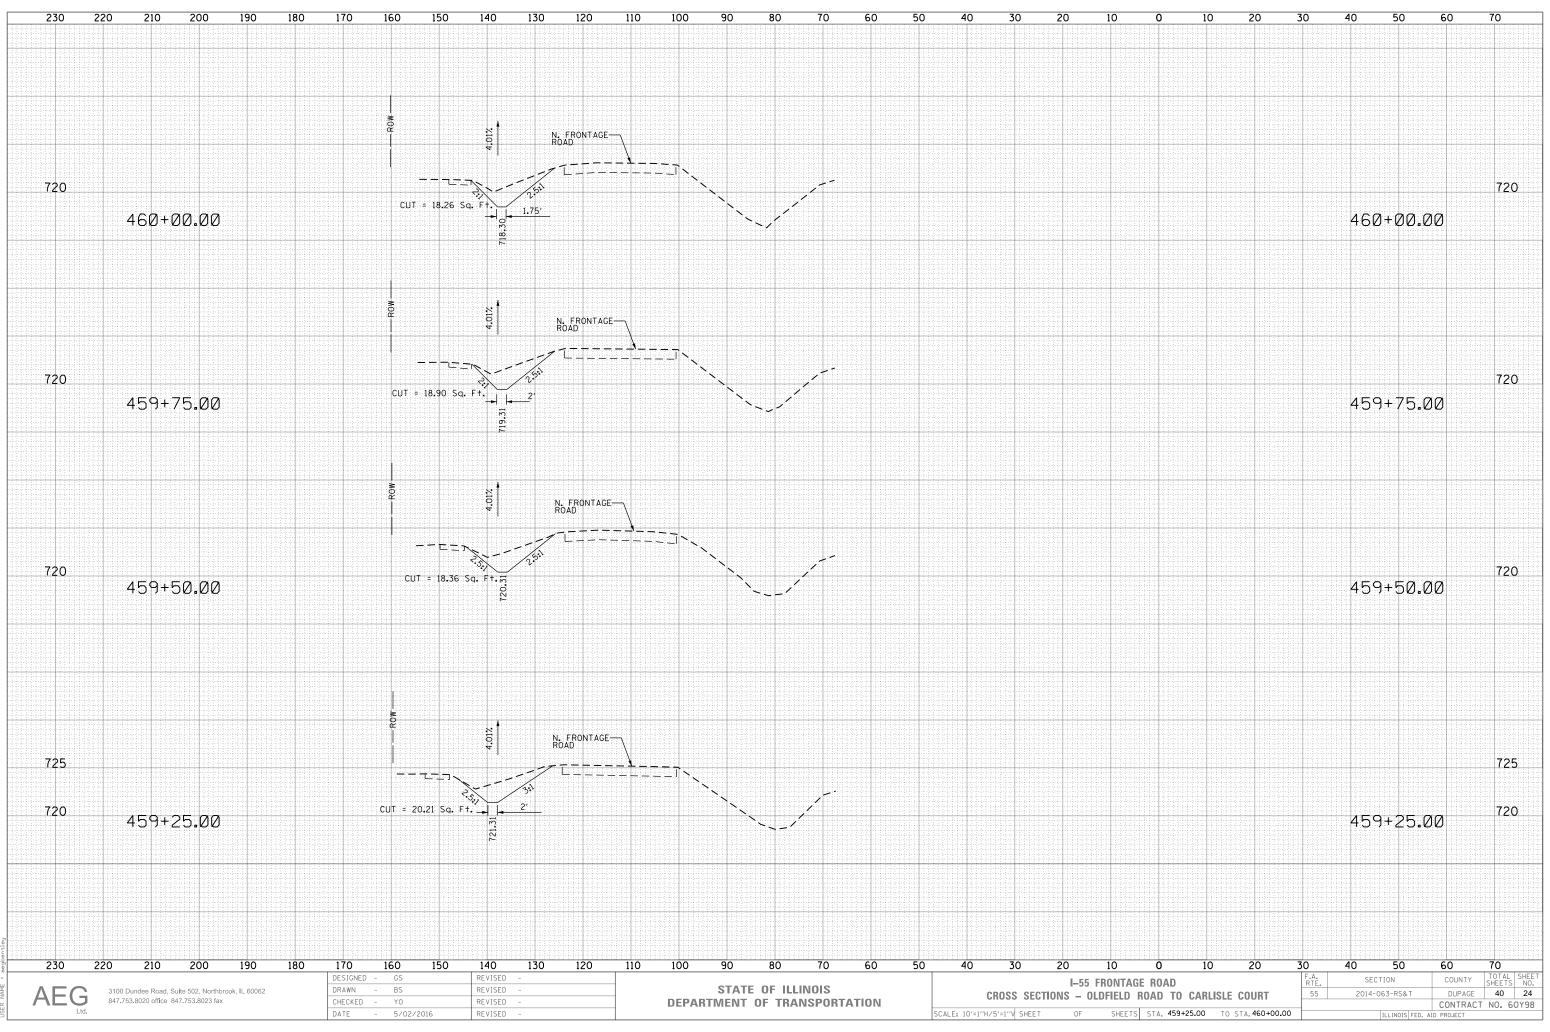
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OTE: THE LABELED SEEDING AREA HAS OVERED THE MAXIMUM POTENTIAL AREA HAT COULD BE DISTURBED. FOR THOSE REAS THAT ARE NOT DISTURBED BY ONSTRUCTION ACTIVITIES AND ONSTRUCTION ACTIVITIES AND S NOT NEEDED. IF THE CONSTRUCTION ACTIVITY IS CHEDULED TO CEASE FOR MORE THAN 15 ALENDAR DAYS, TEMPORARY EROSION ONTROL SEEDING SHALL BE APPLIED TO HE DISTURBED PERVIOUS AREA.	
EMPORARY SEEDING SHALL CONSIST OF OOT CLASS 7 SEED MIXTURE (100 B/ACRE) AND WOOD FIBER MULCH METHOD 2) CONTAINING A PRE- BLENDED HEMICAL TACKIFIER. , RELOCATE SIGN PANEL ASSEMBLY- YPE A (72400500)	

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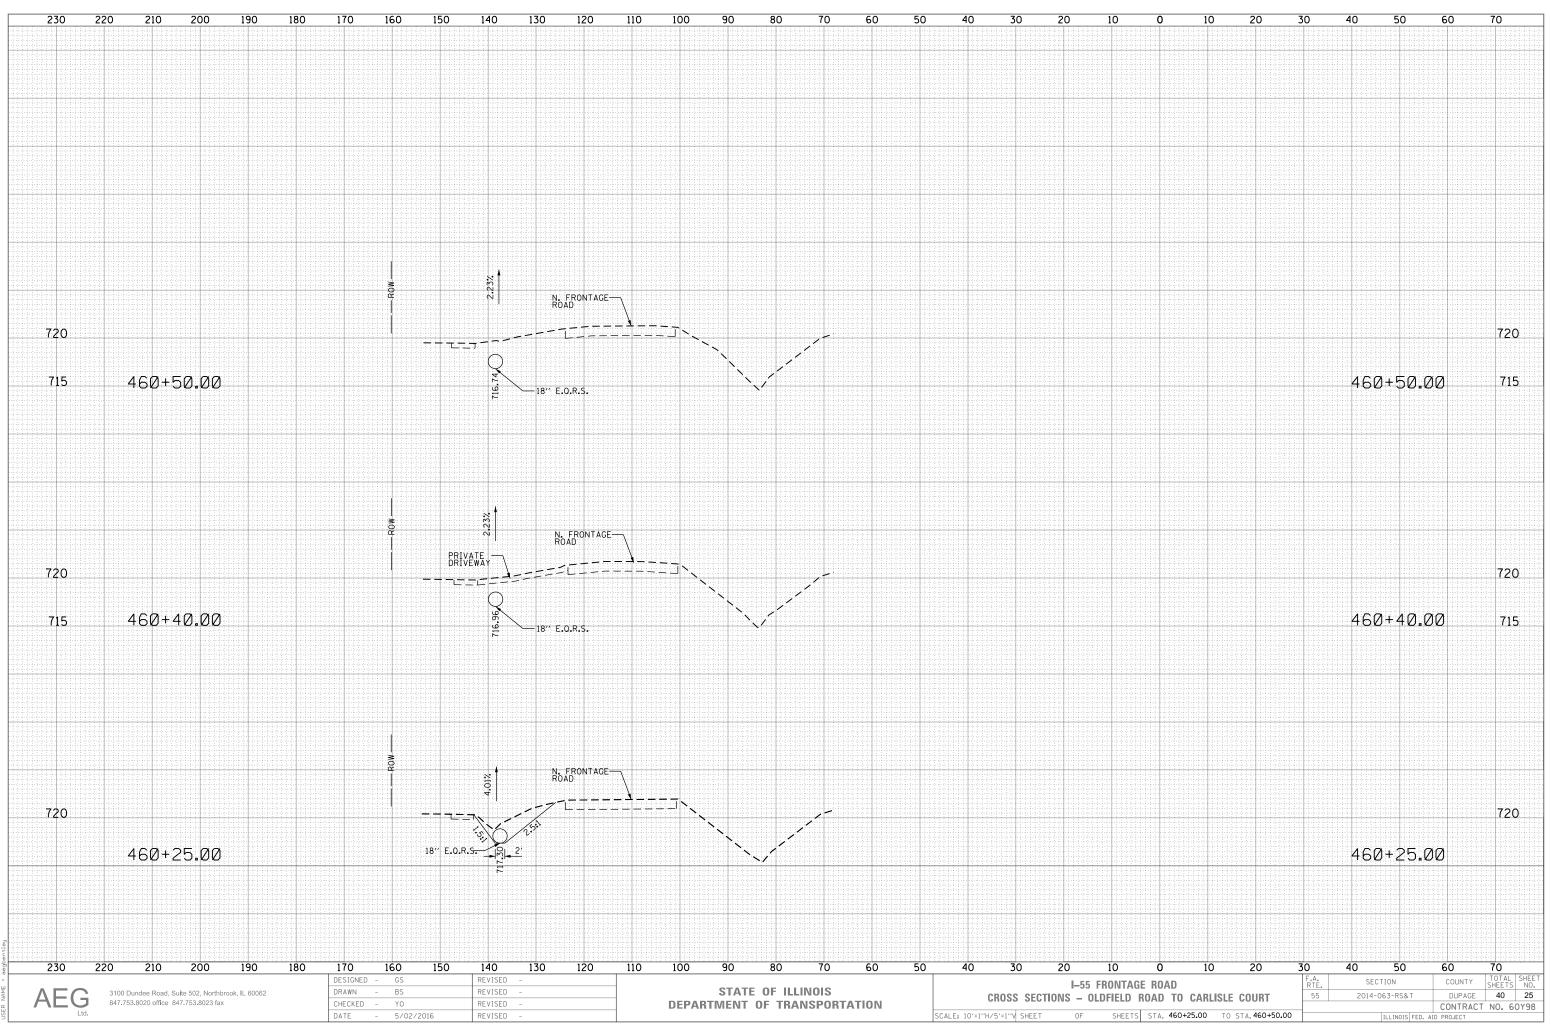
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, AND REMOVAL PLAN		55	2014-063-RS&T	DUPAGE	40	21	
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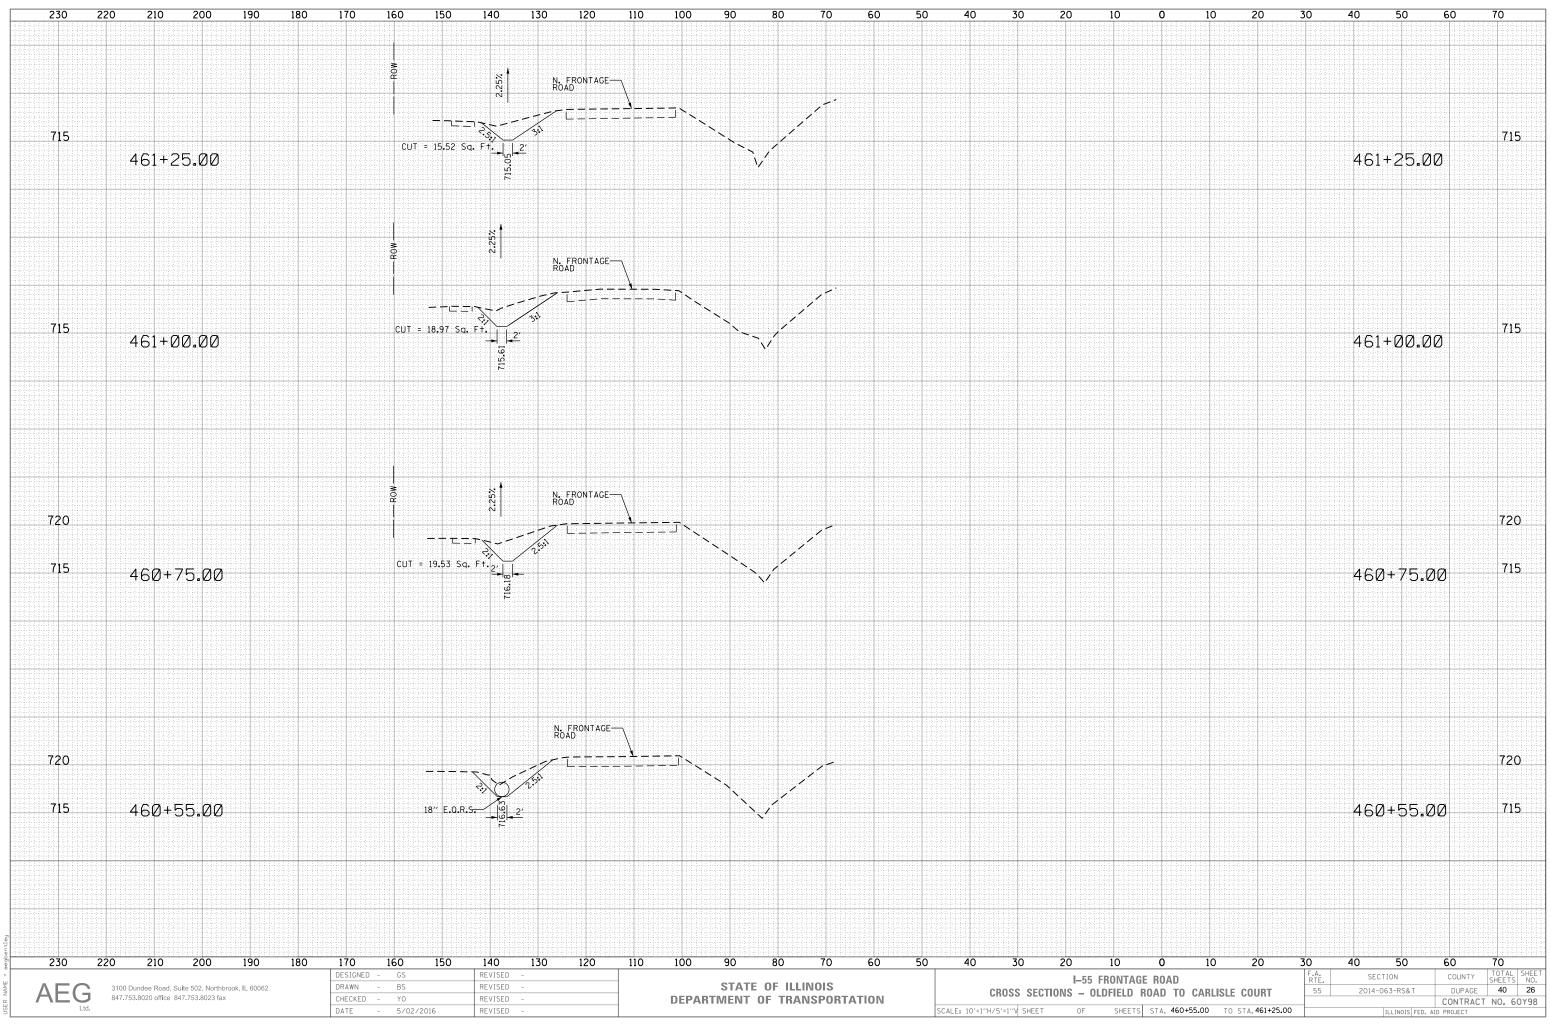




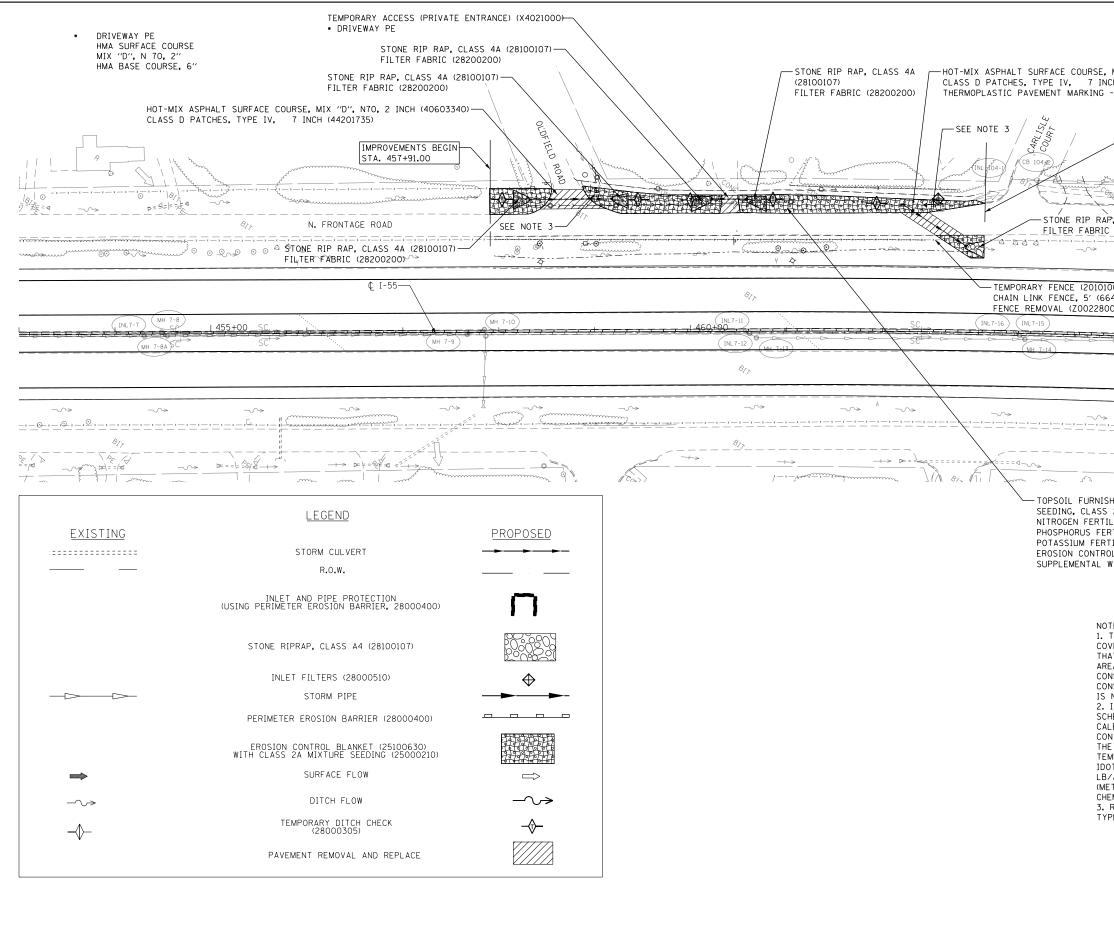


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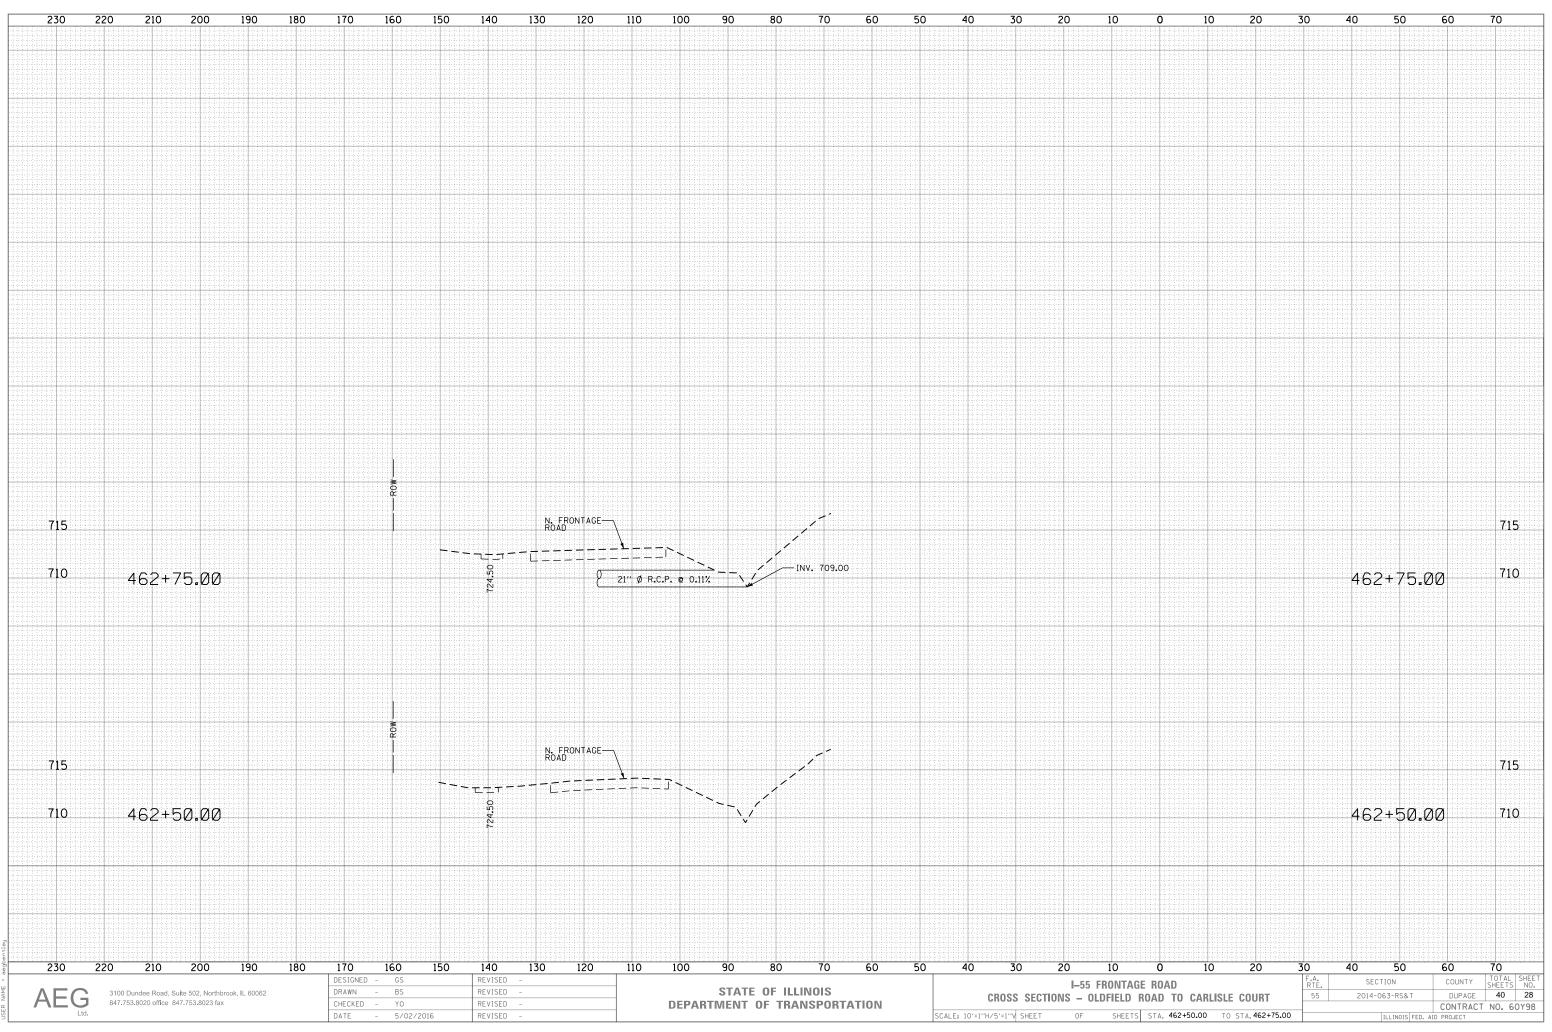





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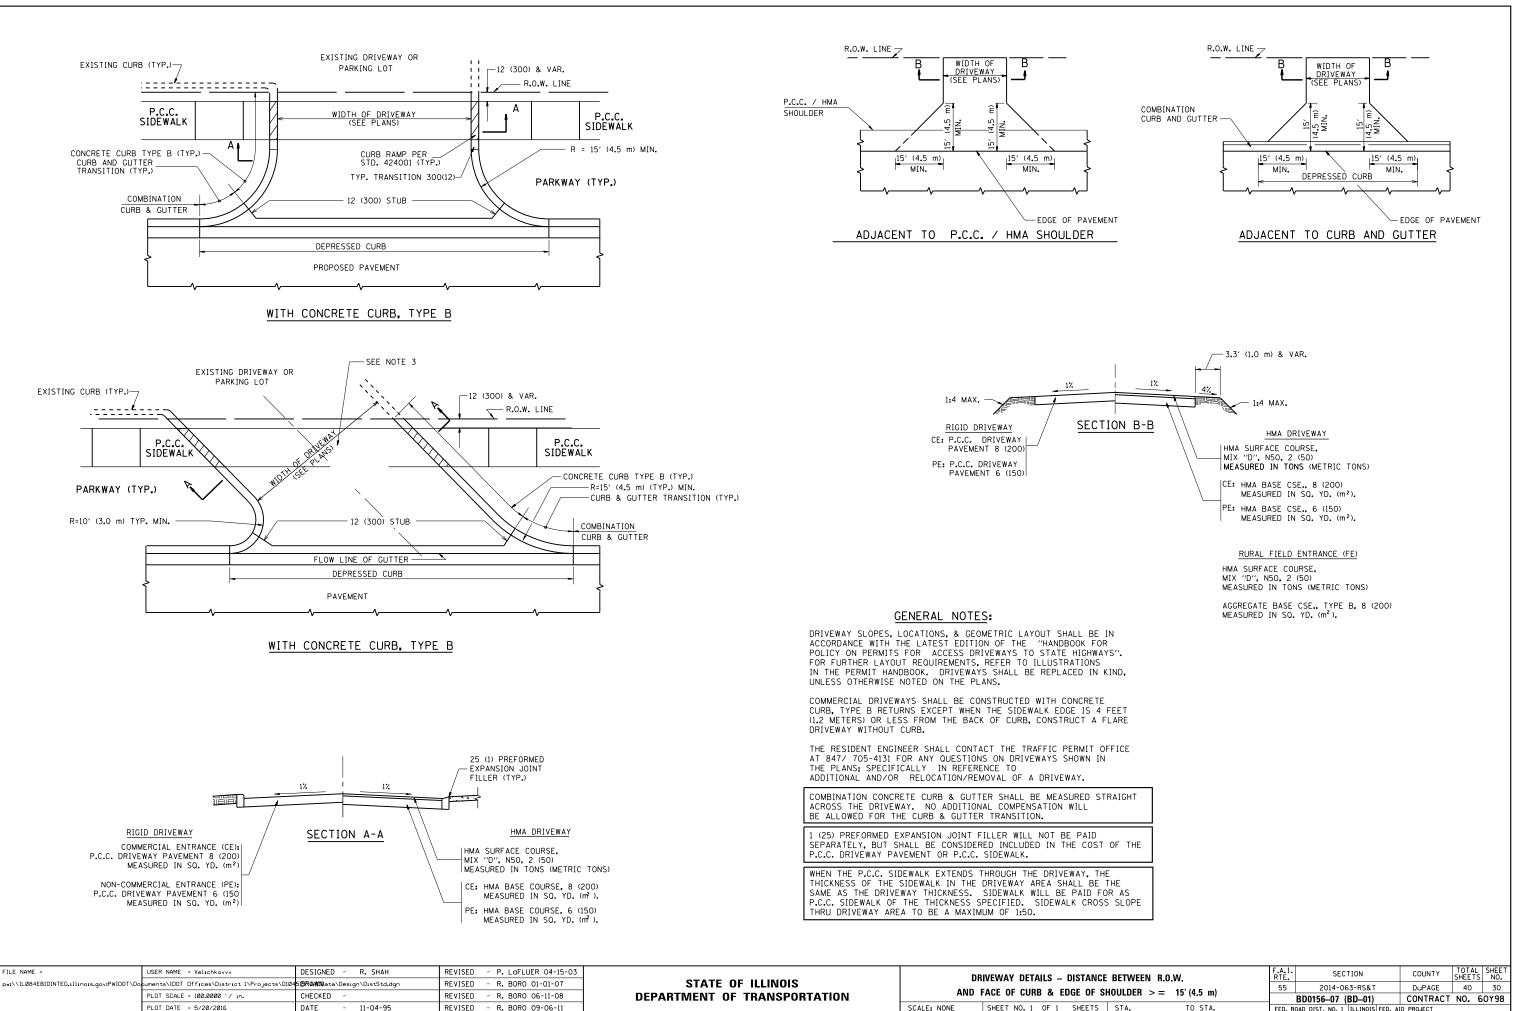



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WHEN STRUCTURES ARE TO BE ADJUSTED OR RECONSTRUCTED, THE LOWERING AND RAISING OF THE FRAMES AND LIDS WILL NOT BE PAID FOR SEPARATELY BUT WILL BE INCLUDED IN THE COST OF THE CORRESPONDING PAY ITEM.
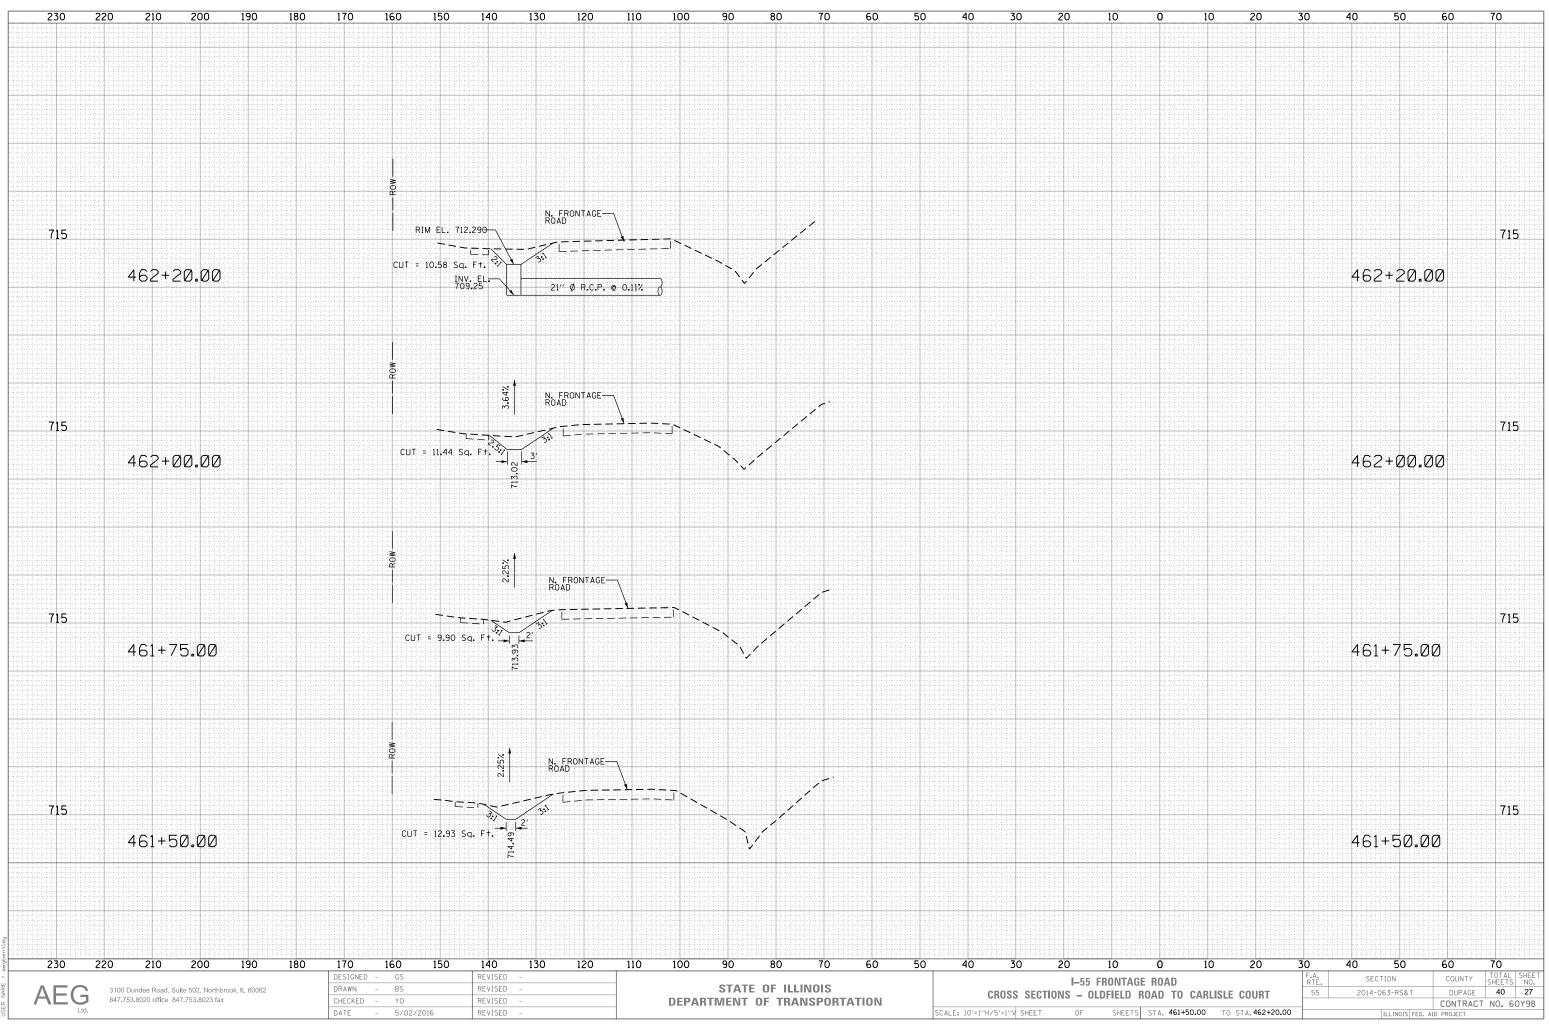
# DETAILS FOR FRAMES AND LIDS ADJUSTMENT WITH MILLING

FILE NAME	E =	USER NAME = Velichkovvv	DESIGNED - R. SHAH	REVISED - R. WIEDEMAN 05-14-04			DETAILS FOR	F.A.I. RTF	SECTION	COUNTY TOTAL SHEET
pw:\\IL084	4EBIDINTEG.1111no15.gov:PWIDOT\Doc	cuments\IDOT Offices\District 1\Projects\D104	513RAMINata\Design\DistStd.dgn	REVISED - R. BORO 01-01-07	STATE OF ILLINOIS			55 2	014-063-RS&T	DuPAGE 40 31
		PLOT SCALE = 100.0000 ' / in.	CHECKED -	REVISED - R. BORO 03-09-11	DEPARTMENT OF TRANSPORTATION		FRAMES AND LIDS ADJUSTMENT WITH MILLING	BD600	-03 (BD-8)	CONTRACT NO. 60Y98
		PLOT DATE = 5/20/2016	DATE - 10-25-94	REVISED - R. BORO 12-06-11		SCALE: NONE	SHEET NO. 1 OF 1 SHEETS STA. TO STA.	FED. ROAD DIST.	NO. 1 ILLINOIS FED. A	
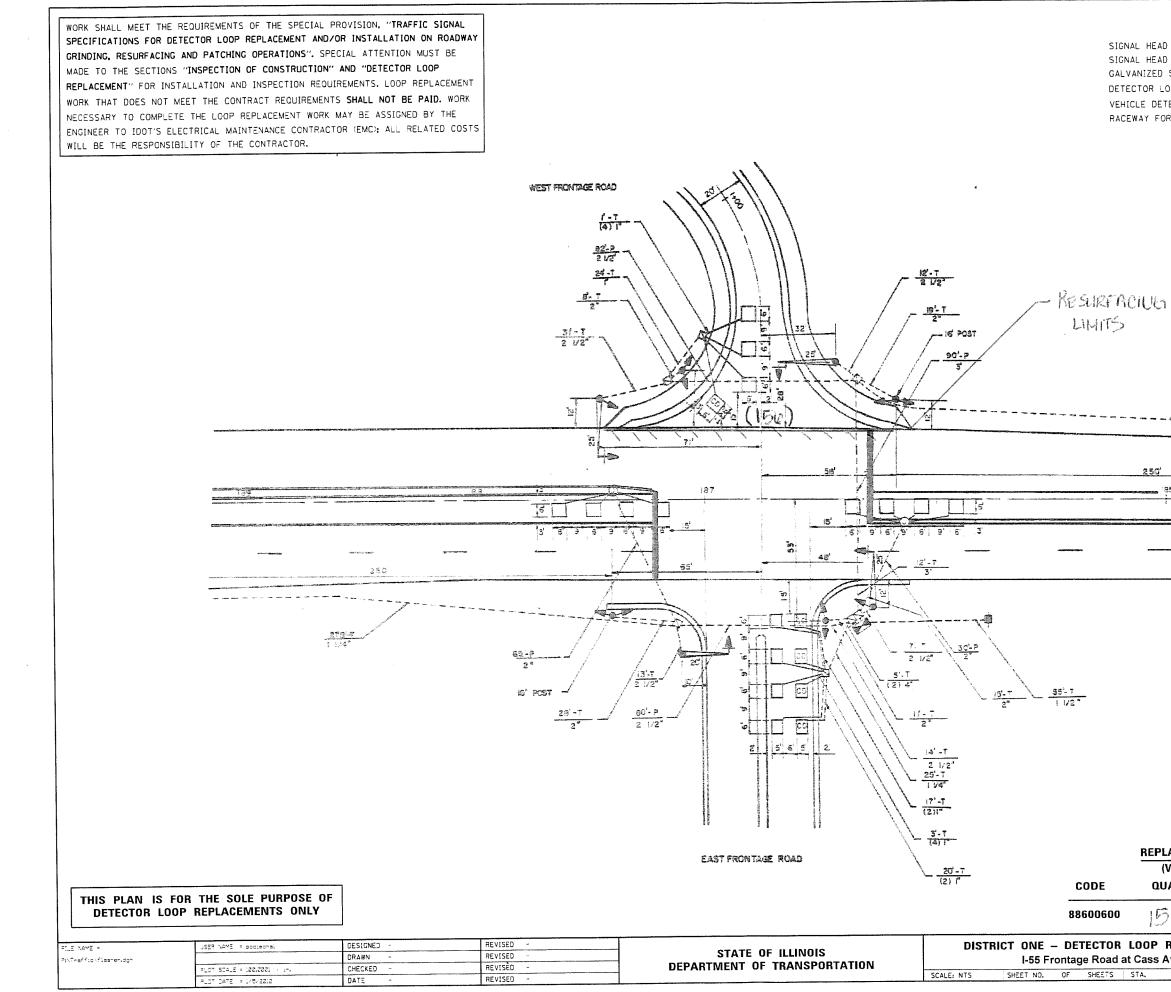
### CONSTRUCTION PROCEDURES

### STAGE 1 (BEFORE PAVEMENT MILLING)

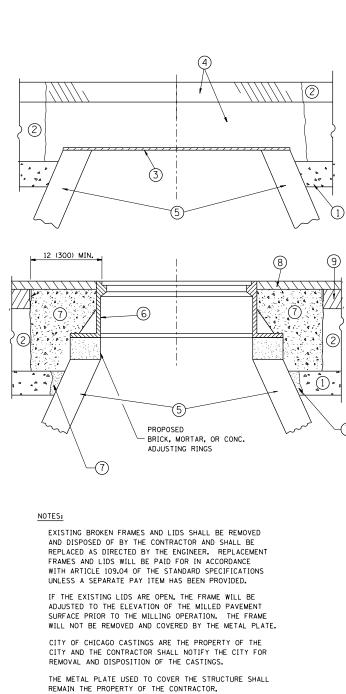- A) REMOVE A MINIMUM OF 12 (300) OF THE PAVEMENT FROM AROUND THE STRUCTURE. B) REMOVE THE EXISTING FRAME AND LID FROM THE STRUCTURE.
- C) COVER THE STRUCTURE OPENING WITH A 36 (900) DIAMETER METAL PLATE. D) BACKFILL WITH CRUSHED STONE AND A MINIMUM  $1^{\prime}_{2}$  (40)
- THICK HMA SURFACE MIX APPROVED BY THE ENGINEER.

### STAGE 2 (AFTER PAVEMENT MILLING)

- A) REMOVE THE HMA SURFACE MIX AND CRUSHED STONE.
- B) INSTALL THE FRAME AND LID; ADJUST THE FRAME TO ITS FINAL SURFACE ELEVATION.
- C) THE SURROUNDING SPACE SHALL BE FILLED WITH CLASS PP-1* CONCRETE TO THE ELEVATION OF THE SURFACE OF THE EXISTING BASE COURSE OR THE BINDER COURSE.
- * UNLESS OTHERWISE SPECIFIED IN THE PLANS.

THE PROCEDURE EXPLAINED ABOVE SHALL CONFORM TO THE APPLICABLE PORTIONS OF SECTIONS 353, 406, 602, AND 603 OF THE STANDARD SPECIFICATIONS EXCEPT THAT "THE CONTRACTOR SHALL ADJUST THE STRUCTURES TO THE FINISHED PAVEMENT ELEVATION NO MORE THAN 5 CALENDAR DAYS PRIOR TO PLACEMENT OF THE FINAL LIFT OF SURFACE UNLESS APPROVED BY THE ENGINEER."

### LEGEND

1	SUB-BASE GRANULAR MATERIAL	6 FRAME AND LID (SEE NOTES)
2	EXISTING PAVEMENT	(7) CLASS PP-1* CONCRETE
3	36 (900) DIAMETER METAL PLATE	(8) PROPOSED HMA SURFACE COURSE
4	PROPOSED CRUSHED STONE AND HMA SURFACE MIX	-
(5)	EXISTING STRUCTURE	9 PROPOSED HMA BINDER COURSE

(5) EXISTING STRUCTURE

### LOCATION OF STRUCTURES:


THE CONTRACTOR WILL BE REQUIRED TO KEEP A RECORD OF THE LOCATIONS OF THE BURIED STRUCTURES ACCORDING TO THE STATION AND DISTANCE LEFT OR RIGHT OF THE CENTERLINE OF PAVEMENT. UPON COMPLETION OF THE WORK, THE CONTRACTOR WILL DELIVER THE RECORD TO THE ENGINEER.

### BASIS OF PAYMENT:

REMOVING FRAMES AND LIDS ON DRAINAGE AND UTILITY STRUCTURES IN THE PAVEMENT PRIOR TO MILLING, AND ADJUSTING TO FINAL GRADE PRIOR TO PLACING THE SURFACE COURSE, WILL BE PAID FOR AT THE CONTRACT UNIT PRICE EACH FOR "FRAMES AND LIDS TO BE ADJUSTED (SPECIAL)."

THIS WORK WILL NOT BE PAID FOR WHEN DRAINAGE AND UTILITY STRUCTURES ARE SPECIFIED FOR PAYMENT AS STRUCTURE RECONSTRUCTION.

NEW FRAMES AND LIDS, WHEN SPECIFIED, WILL BE PAID FOR SEPARATELY.

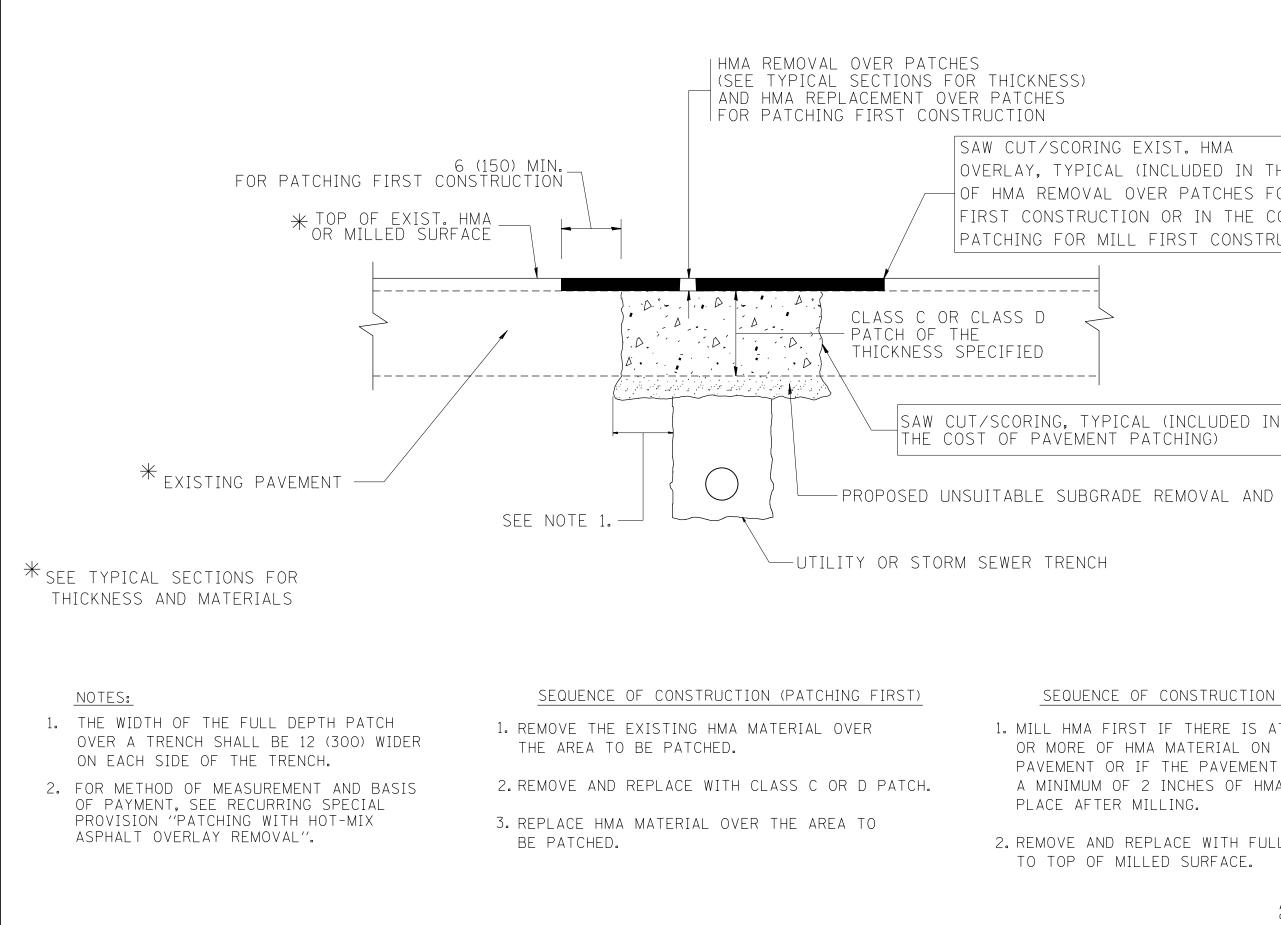

Ī	FILE NAME =	USER NAME = Velichkovvv	DESIGNED - R. SHAH	REVISED - A. ABBAS 04-27-98			PAVEMENT PATCHING FOR	F. R	A.I.	SECTION	COUNTY TOTAL SHEE
	pw:/\IL084EBIDINTEG.Illinois.gov:PWIDOT\Documents\IDOT Offices\District 1\Projects\D104 <b>513R0400</b> oto\Design\DistStd.dgn		REVISED - R. BORO 01-01-07			HMA SURFACED PAVEMENT			014-063-RS&T	DuPAGE 40 32	
		PLOT SCALE = 100.0000 '/ in.	CHECKED -	REVISED - R. BORO 09-04-07	DEPARTMENT OF TRANSPORTATION				BD400-	-04 (BD-22)	CONTRACT NO. 60Y98
L		PLOT DATE = 5/20/2016	DATE - 10-25-94	REVISED - K. ENG 10-27-08		SCALE: NONE	SHEET NO. 1 OF 1 SHEETS STA. TO S	STA. FE	ED. ROAD DIST.	NO. 1 ILLINOIS FE	AID PROJECT

OVERLAY, TYPICAL (INCLUDED IN THE COST OF HMA REMOVAL OVER PATCHES FOR PATCHING FIRST CONSTRUCTION OR IN THE COST OF PAVEMENT PATCHING FOR MILL FIRST CONSTRUCTION).


PROPOSED UNSUITABLE SUBGRADE REMOVAL AND REPLACEMENT

SEQUENCE OF CONSTRUCTION (MILLING FIRST)

1. MILL HMA FIRST IF THERE IS AT LEAST  $4\frac{1}{2}$  INCHES OR MORE OF HMA MATERIAL ON TOP OF THE EXISTING PAVEMENT OR IF THE PAVEMENT IS FULL DEPTH HMA. A MINIMUM OF 2 INCHES OF HMA MATERIAL SHALL BE IN

2. REMOVE AND REPLACE WITH FULL DEPTH CLASS D PATCHES TO TOP OF MILLED SURFACE.

> ALL DIMENSIONS ARE IN INCHES (MILLIMETERS) UNLESS OTHERWISE SHOWN.

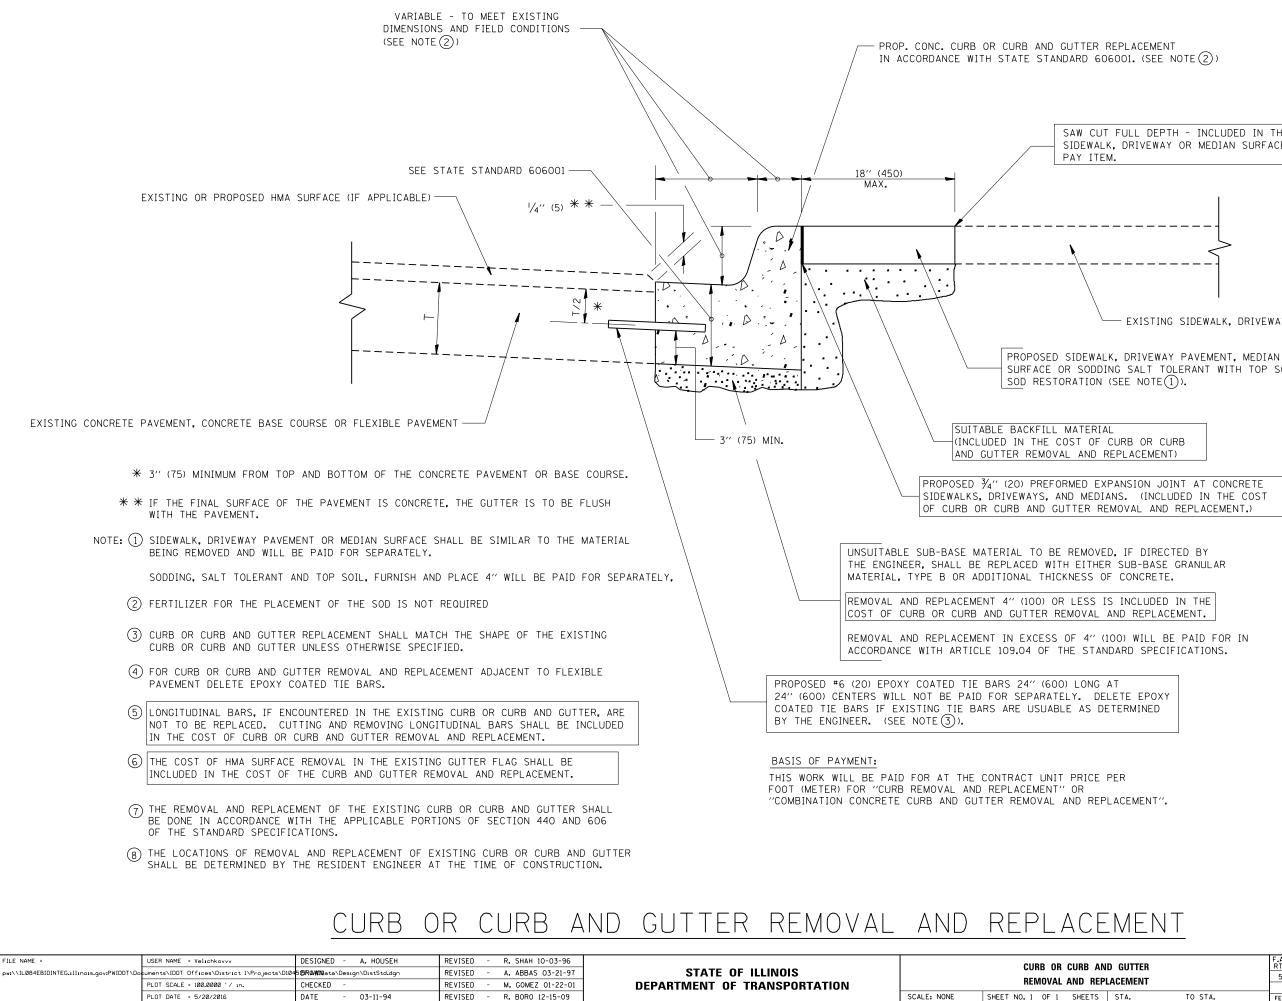


SAW CUT FULL DEPTH - INCLUDED IN THE COST OF SIDEWALK, DRIVEWAY OR MEDIAN SURFACE REMOVAL

EXISTING SIDEWALK, DRIVEWAY, MEDIAN SURFACE, SOD OR GROUND.

SURFACE OR SODDING SALT TOLERANT WITH TOP SOIL, 4" (100)

ALL DIMENSIONS ARE IN INCHES (MILLIMETERS) UNLESS OTHERWISE SHOWN.


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			BD600-06 (BD-24)	CONTRACT	NO. 6	0Y98	
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AND	F.A.I. RTE.	F.A.I. RTE. SECTION			COUNTY	TOTAL SHEETS	SHEET NO.
DETAILS		2014-06	53-RS&T		DuPAGE	40	34
		BD400-05	BD32		CONTRACT	NO. 6	50Y98
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TRAFFIC	CONTROL	AND	PROTE	CTION	FOR
O) ONE ROAD CONS AND FLAG MOUN OF THE MAIN R	A SPEED LIMIT OF RAWING AND AS DIF STRUCTION AHEAD S ITED ON IT APPRO3	40 MPH ( RECTED BY IGN 36 × KIMATELY	60 km/h) OR THE ENGINEE 36 (900×900 200' (60 m)	LESS AS ER: ) WITH A F IN ADVANCE	
THE CROSS SEC	TYPE I, TYPE II TION OF THE CLOS A SPEED LIMIT GRE DRAWING AND AS	ED PORTI	0N. N 40 MPH (6	0 km/h)	
	TRUCTION AHEAD S ED ON IT APPROXI OUTE.				A
	RTION OF THE MAI TYPE III BARRICA PORTION.				
	OAD LIES BETWEEN WORK ZONE, A SIN OF THE DOUBLE H	IGLE HEAD	ED ARROW (M		

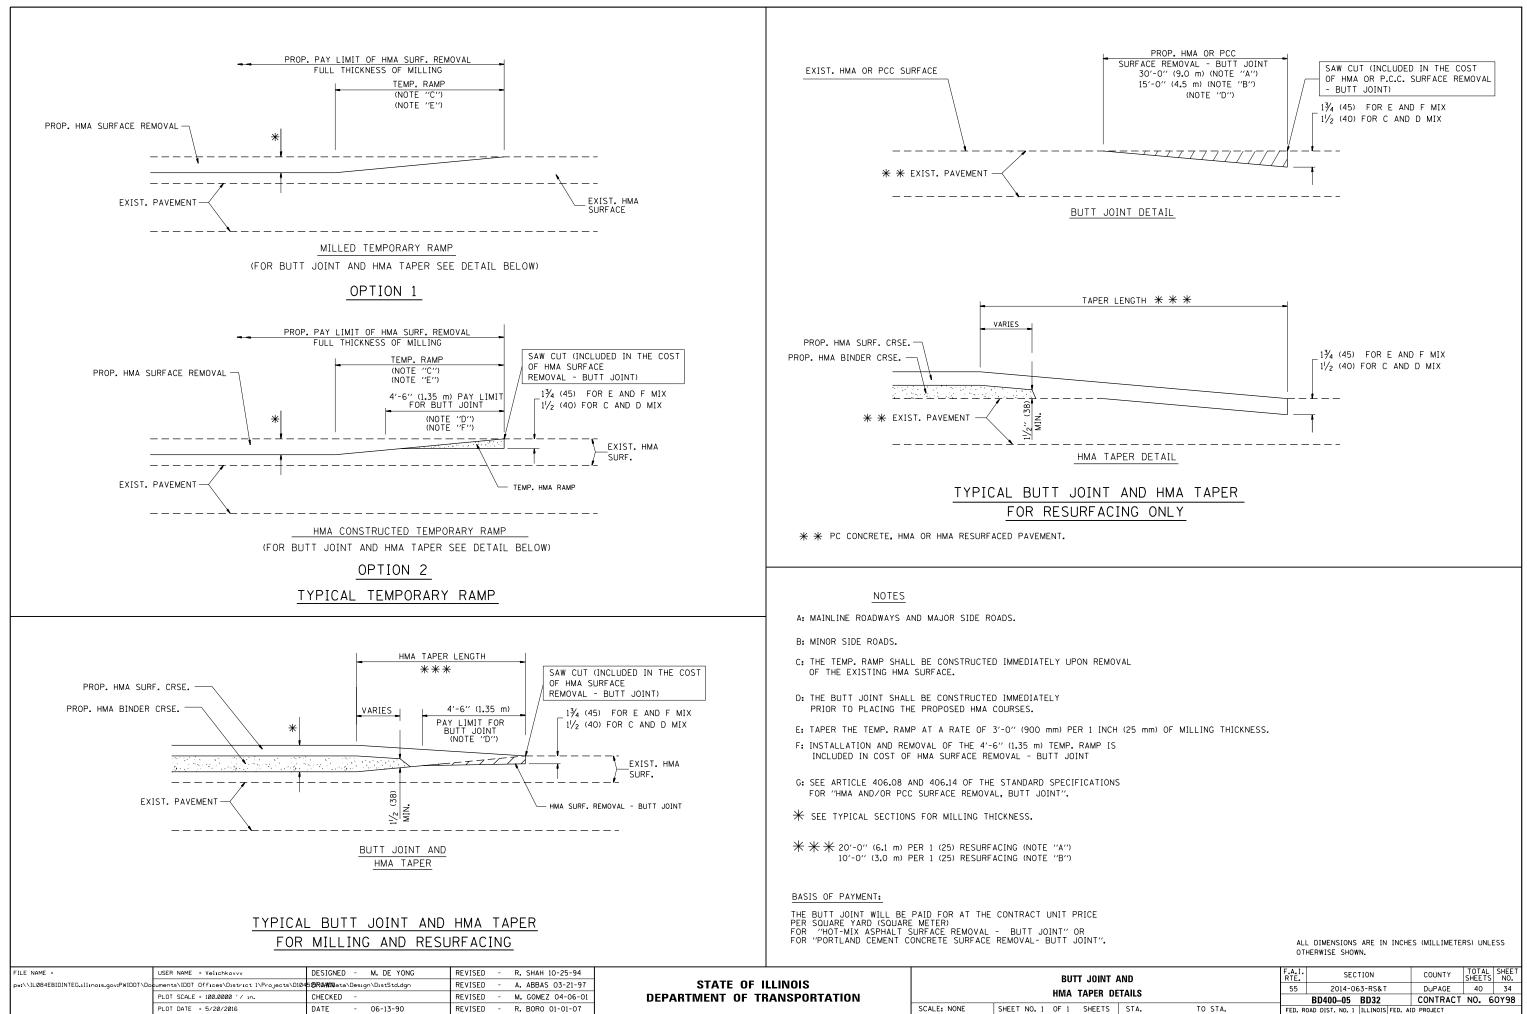FILE NAME =	USER NAME = Velichkovvv	DESIGNED - LHA	REVISED - J. OBERLE 10-18-95			TRAFFIC CONTROL AND PROTECTION FOR	F.A.I SECTION	COUNTY TOTAL SHEET
pw:\\ILØ84EBIDINTEG.1111no15.gov:PWIDOT\De	cuments\IDOT_Offices\District_I\Projects\D104	5 <b>13R0440</b> 0jata\Design\DistStd.dgn	REVISED - A. HOUSEH 03-06-96	STATE OF ILLINOIS			55 2014-063-RS&T	DuPAGE 40 35
	PLOT SCALE = 100.0000 ' / in.	CHECKED -	REVISED - A. HOUSEH 10-15-96	DEPARTMENT OF TRANSPORTATION	SIDE ROADS, INTERSECTIONS, AND DRIVEWAYS		TC-10	CONTRACT NO. 60Y98
	PLOT DATE = 5/20/2016	DATE - 06-89	REVISED -T. RAMMACHER 01-06-00		SCALE: NONE	SHEET NO. 1 OF 1 SHEETS STA. TO STA.		D. AID PROJECT




# SIDE ROADS, INTERSECTIONS, AND DRIVEWAYS

B. FOR A LANE CLOSURE ON A SIDE ROAD OR DRIVEWAY:
USE APPLICABLE PORTIONS OF THE TYPICAL APPLICATION OF TRAFFIC
CONTROL DEVICES (STD. 701501, STD. 701606 OR THE APPROPRIATE STANDARD).
THE SPACING OF SIGNS AND BARRICADES SHALL BE ADJUSTED FOR FIELD
CONDITIONS AS DIRECTED BY THE ENGINEER. THE DIRECTIONAL ARROW
SHALL BE COVERED OR REMOVED WHEN NO LONGER CONSISTENT WITH THE
SIDE ROAD LANE CLOSURE.

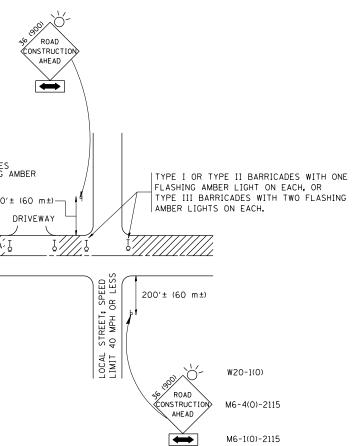
- C. ADVANCE WARNING SIGNS ARE TO BE OMITTED ON DRIVEWAY UNLESS OTHERWISE NOTED.
- D. THE TRAFFIC CONTROL AND PROTECTION FOR SIDE ROADS, INTERSECTIONS, AND DRIVEWAYS SHALL BE INCIDENTAL TO THE COST OF SPECIFIED TRAFFIC CONTROL STANDARDS OR ITEMS.


All dimensions are in millimeters (inches)	
unless otherwise shown.	

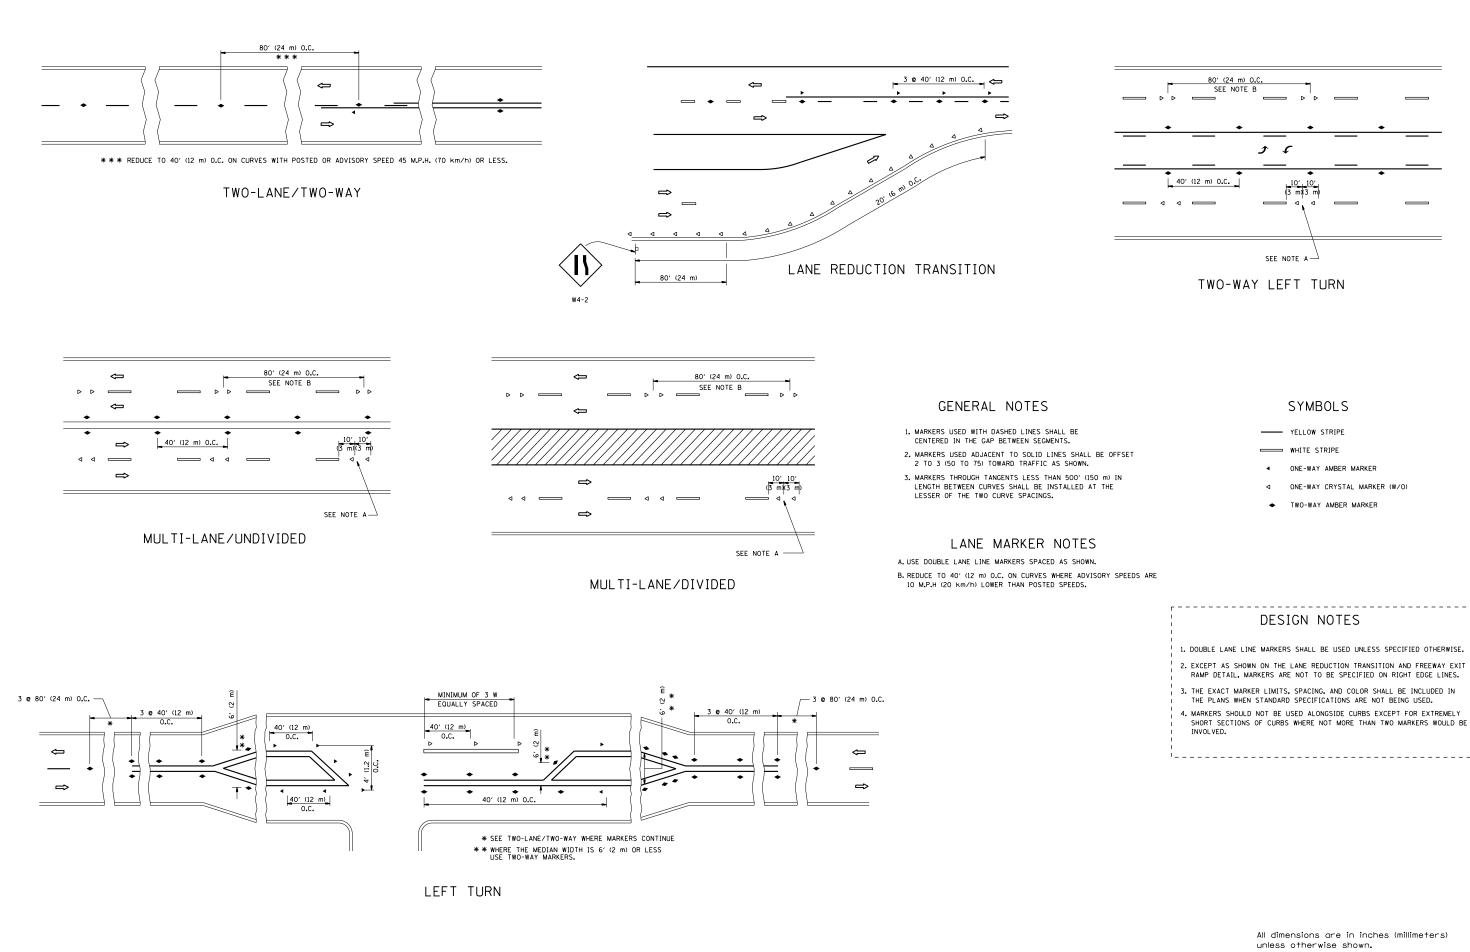

FILE NAME =	USER NAME = Velichkovvv	DESIGNED -	REVISED - T. RAMMACHER 09-19-94			TYPICAL APPLICATIONS	F.A.I. BIF	SECTION	COUNTY TOTAL SHEET
pw:\\ILØ84EBIDINTEG.1111no1s.gov:PWIDOT\Doc	uments\IDOT_Offices\District_1\Projects\D104	5 <b>13R(AWIN)</b> ata\Design\DistStd.dgn	REVISED - T. RAMMACHER 03-12-99	STATE OF ILLINOIS	RAISED REFLECTIVE PAVEMENT MARKERS (SNOW-PLOW RESISTANT)   SCALE: NONE SHEET NO. 1 OF 1 SHEETS STA. TO STA.		55	2014-063-RS&T	DuPAGE 40 36
	PLOT SCALE = 100.0000 ' / in.	CHECKED -	REVISED -T. RAMMACHER 01-06-00	DEPARTMENT OF TRANSPORTATION				TC-11	CONTRACT NO. 60Y98
	PLOT DATE = 5/20/2016	DATE -	REVISED - C. JUCIUS 09-09-09				FED. ROAD	DIST. NO. 1 ILLINOIS FED. A	AID PROJECT

4. MARKERS SHOULD NOT BE USED ALONGSIDE CURBS EXCEPT FOR EXTREMELY SHORT SECTIONS OF CURBS WHERE NOT MORE THAN TWO MARKERS WOULD BE INVOLVED.

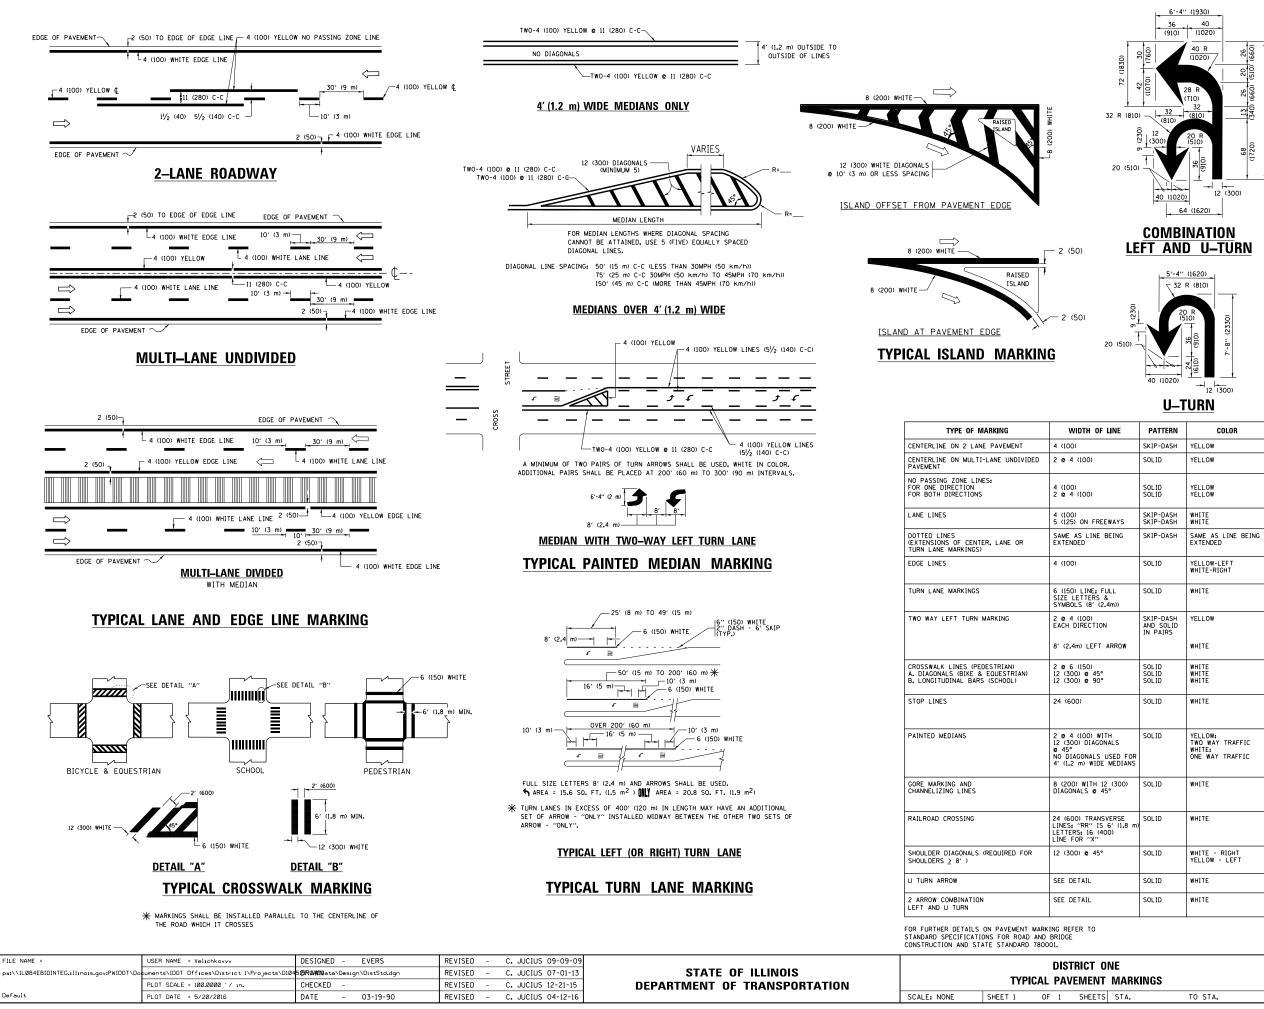

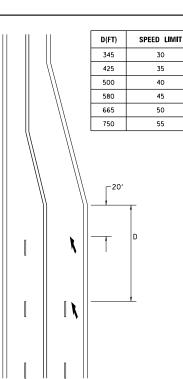


## LANE REDUCTION TRANSITION

# lane reduction arrows required at speeds of 45 MPH or greater or when specified in plans.

F LINE	PATTERN	COLOR	SPACING /REMARKS
	SKIP-DASH	YELLOW	10' (3 m) LINE WITH 30' (9 m) SPACE
	SOLID	YELLOW	11 (280) C-C
	SOLID SOLID	YELLOW YELLOW	5/2 (140) C-C FROM SKIP-DASH CENTERLINE 11 (280) C-C OMIT SKIP-DASH CENTERLINE BETWEEN
EEWAYS	SKIP-DASH SKIP-DASH	WHITE WHITE	10' (3 m) LINE WITH 30' (9 m) SPACE
BEING	SKIP-DASH	SAME AS LINE BEING EXTENDED	2' (600) LINE WITH 6' (1.8 m) SPACE
	SOLID	YELLOW-LEFT WHITE-RIGHT	OUTLINE MEDIANS IN YELLOW
FULL & 2.4m))	SOLID	WHITE	SEE TYPICAL TURN LANE MARKING DETAIL
ON ARROW	SKIP-DASH AND SOLID IN PAIRS	YELLOW	10' (3 m) LINE WITH 30' (9 m) SPACE FOR SKIP-DASH; 5½ (140) C-C BETWEEN SOLID LINE AND SKIP-DASH LINE SEE TYPICAL TWO-WAY LEFT TURN MARKING DETAIL
•	SOLID SOLID SOLID	WHITE WHITE WHITE	NOT LESS THAN 6' (1.8 m) APART 2' (600) APART 2' (600) APART SEE TYPICAL CROSSWALK MARKING DETAILS.
	SOLID	WHITE	PLACE 4' (1,2 m) IN ADVANCE OF AND PARALLEL TO CROSSWALK, IF PRESENT, OTHEWNISE, PLACE AT DESIRED STOPPING POINT. PARALLEL TO CROSSROAD CENTERLINE, WHERE POSSIBLE
ITH DNALS USED FOR E MEDIANS	SOLID	YELLOW: TWO WAY TRAFFIC WHITE: ONE WAY TRAFFIC	11 (280) C-C FOR THE DOUBLE LINE SEE TYPICAL PAINTED MEDIAN MARKING.
12 (300) 45°	SOLID	WHITE	DIAGONALS: 15' (4.5 m) C-C (LESS THAN 30MPH (50 km/h)) 20' (6 m) C-C 30MPH (50 km/h) TO 45MPH (70 km/h)) 30' (9 m) C-C (0VER 45MPH (70 km/h))
SVERSE 5 6' (1.8 m) 400)	SOLID	WHITE	SEE STATE STANDARD 780001 AREA OF: "R"=3.6 SO, FT. (0.33 m ² ) EACH "X"=54.0 SO, FT. (5.0 m ² )
•	SOLID	WHITE - RIGHT YELLOW - LEFT	50' (15 m) C-C (LESS THAN 30MPH (50 km/h)) 75' (25 m) C-C (30 MPH (50 km/h) TO 45MPH (70 km/h)) 150' (45 m) C-C (0VER 45MPH (70 km/h))
	SOLID	WHITE	16.3 SF
	SOLID	WHITE	30.4 SF
			1

All dimensions are in inches (millimeters) unless otherwise shown.

0	ONE			SECTION	COUNTY	TOTAL SHEETS	SHEET NO.
T MARKINGS		55	5 2014-063-RS&T DuPAGE 4			37	
	MAININGS			TC-13	CONTRACT	NO. 6	0Y98
٢S	STA.	TO STA.		ILLINOIS FED. AID PROJECT			

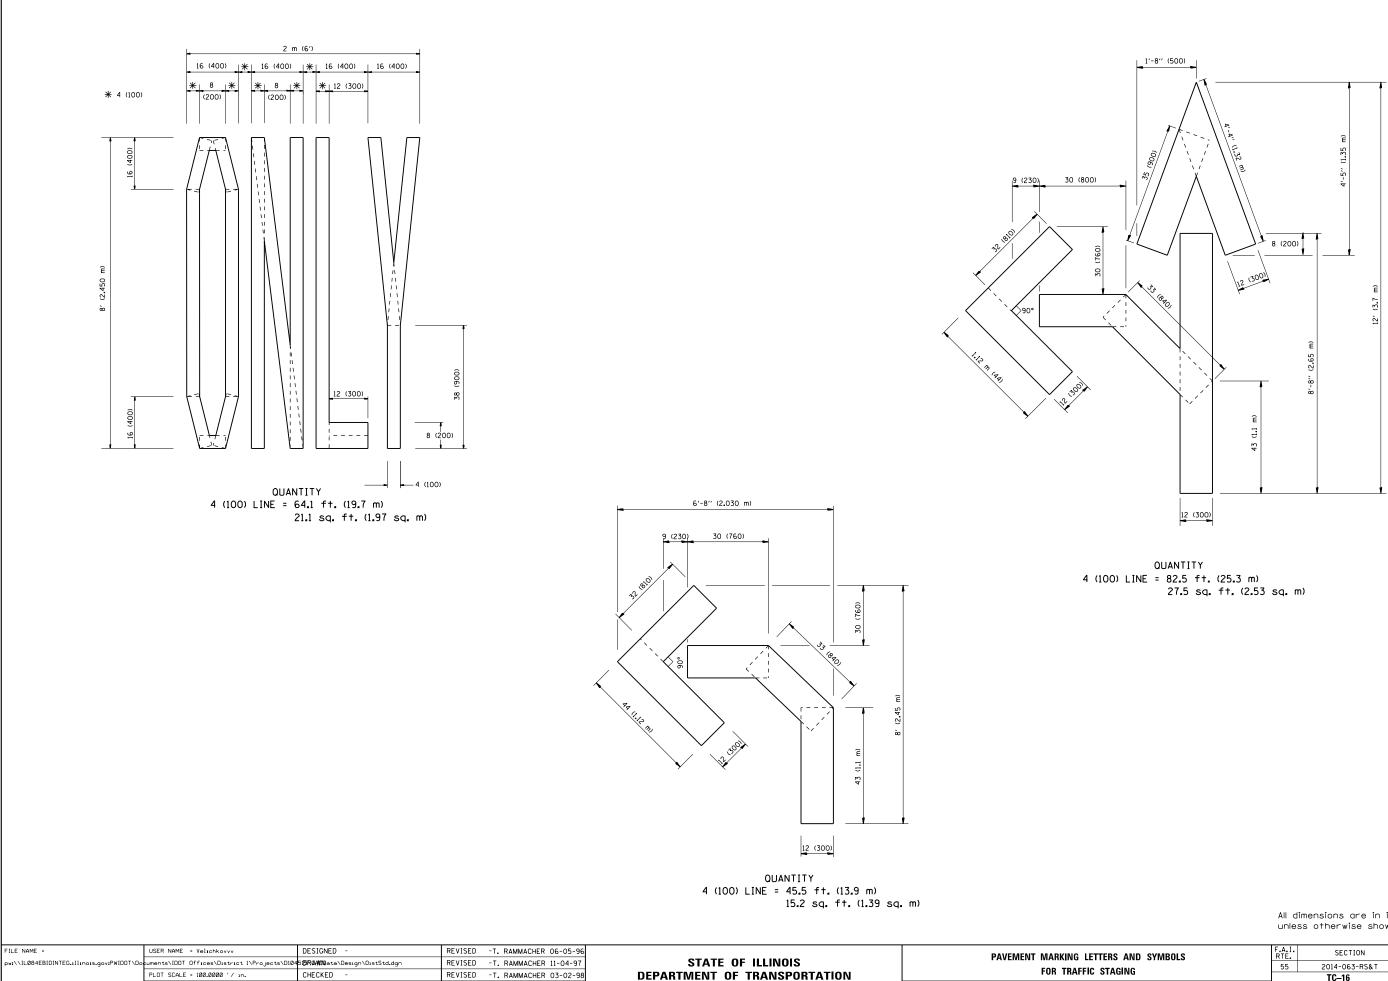

PLOT DATE = 5/20/2016


DATE - 09-18-94

REVISED - E. GOMEZ 08-28-00

SCALE: NONE SHEET NO. 1 OF 1 SHEETS

All dimensions are in inches (millimeters) unless otherwise shown.

EF	ERS AND SYMBOLS Staging			SECTION	COUNTY	TOTAL SHEETS	SHEET NO.
т				55 2014-063-RS&T			38
STAGING				TC-16	CONTRACT	NO. 6	0Y98
	STA.	TO STA.	FED. ROAD DIST. NO. 1 ILLINOIS FED. AID PROJECT				

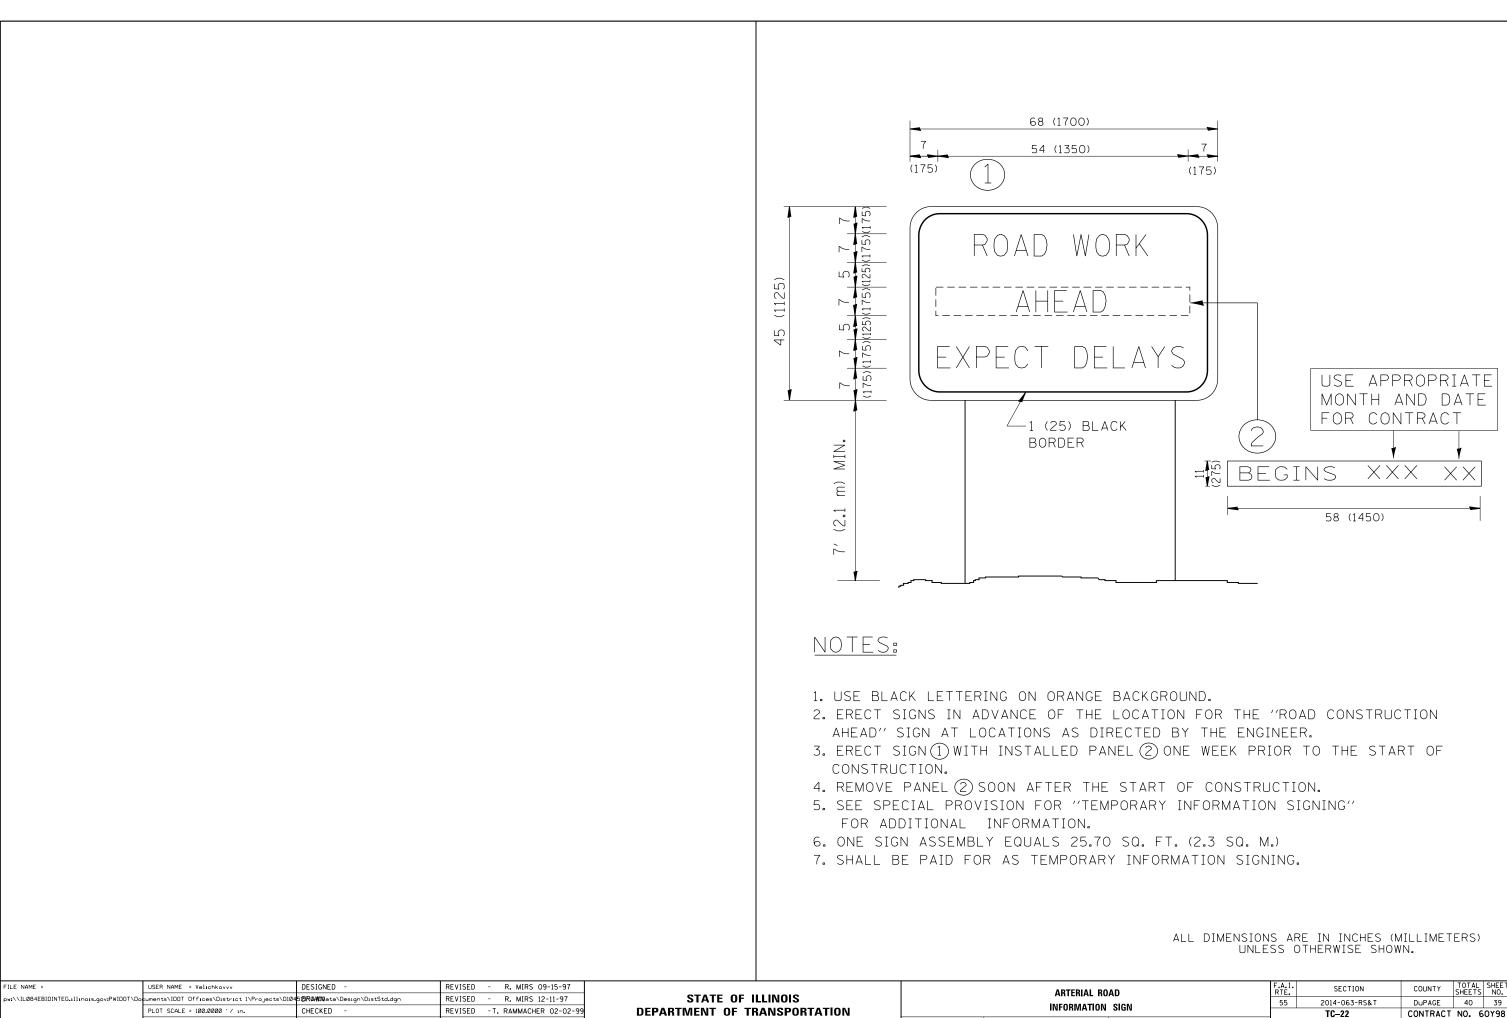


REVISED - C. JUCIUS 01-31-07

PLOT DATE = 5/20/2016

DATE

SPURIATION	JN				
	SCALE: NONE	SHEET NO. 1	OF 1	SHEETS	

ROAD N SIGN			F.A.I. RTE.	SECTION	COUNTY	TOTAL SHEETS	SHEET NO.	
			55	2014-063-RS&T	DuPAGE	40	39	
			TC-22		CONTRACT	NO. 6	60Y98	
	STA.	TO STA.	FED. ROAD DIST. NO. 1 ILLINOIS FED. AID PROJECT					

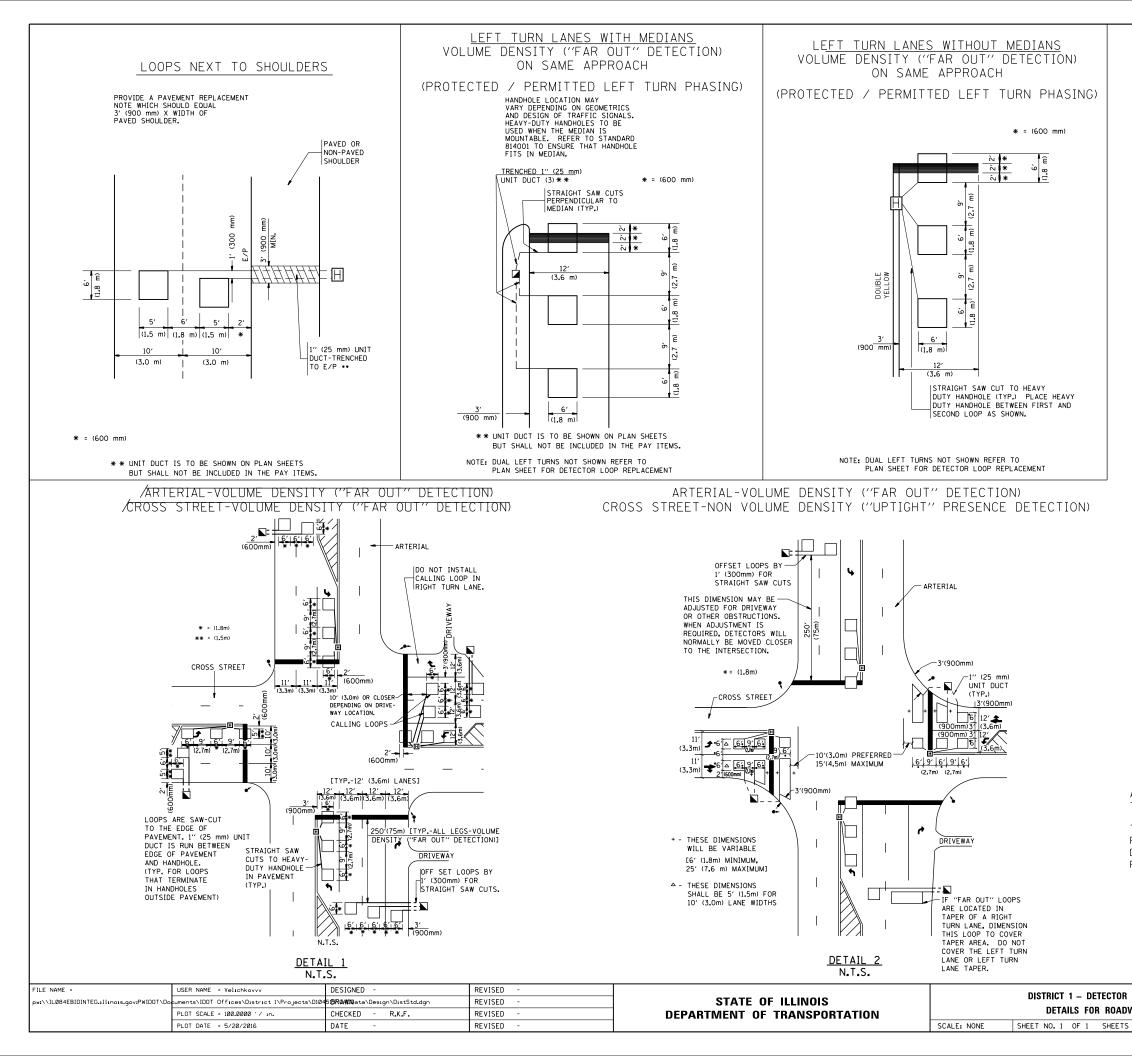

### NOTES:

### VEHICLES LOOP DETECTORS

- * ALL LEAD IN CABLE SHALL BE TWO CONDUCTOR NO. 14 TWISTED, SHIELDED.
- * EACH DETECTOR LOOP SHALL HAVE ITS OWN SAW CUT FROM THE LOOP TO THE EDGE OF PAVEMENT OR TO A HANDHOLE IN THE PAVEMENT.
- * EACH DETECTOR LOOP SHALL HAVE ITS OWN ONE INCH (25 mm) UNIT DUCT BETWEEN THE EDGE OF PAVEMENT AND THE FIRST HANDHOLE OR JUNCTION BOX. EACH UNIT DUCT RUN SHALL BE SHOWN ON THE PLANS BY THE DESIGNER, BUT SHALL NOT BE PAID FOR SEPARATLY. THIS ITEM IS INCIDENTAL TO THE PAY ITEM FOR DETECTOR LOOPS.
- * ONE DIMENSION OF <u>ALL</u> DETECTOR LOOPS SHALL BE SIX FEET (1.8 m)
- * EACH LANE OF NON-LOCKING, PRESENCE DETECTION AND EACH LANE OF A DOUBLE LEFT TURN LANE REQUIRES A SEPARATE INDUCTIVE LOOP DETECTOR AND LEAD IN CABLE.
- * WHEN NON-LOCKING, PRESENCE DETECTION IS USED, <u>MORE</u> THAN ONE LOOP PER LANE IS REQUIRED BEHIND THE STOP BAR (i.e. 1-1/2, 1-3/4, 2).
- * WHEN SYSTEM LOOPS ARE REQUIRED ON AN APPROACH OF AN INTERSECTION, THE LOOPS USED FOR VOLUME DENSITY AND INTERSECTION TIMING SHALL ALSO BE USED AS SYSTEM DETECTORS. <u>EACH</u> ONE OF THESE TYPE OF LOOPS REQUIRES A <u>SEPARATE</u> TWO CONDUCTOR NO. 14 TWISTED SHIELDED CABLE AND A <u>SEPARATE</u> INDUCTIVE LOOP DETECTOR WHEN NEW CONTROLLERS ARE UTILIZED. THE DESIGNER SHALL LABEL THESE TYPES OF LOOPS AS "INTERSECTION AND SAMPLING (SYSTEM) DETECTORS" ON THE SIGNAL LAYOUT, THE INTERCONNECT PLAN AND THE SYSTEM CABLE PLAN. WHEN AN EXISTING CONTROLLER IS UTILIZED FOR THIS TYPE OF DETECTION, THE PAY ITEM "INDUCTIVE LOOP DETECTOR WITH SYSTEM OUTPUT" SHOULD BE USED.

### PLACEMENT OF DETECTORS

THE FOLLOWING FIGURES REPRESENT THE MOST COMMON DETECTOR LOOP LOCATIONS AND SIZES. ADJUSTMENTS WILL BE NECESSARY FOR SPECIFIC GEOMETRIC CONSIDERATIONS.

LOCATIONS AND DEMENSIONS OF DETECTOR LOOPS ARE REQUIRED ON  $\underline{ALL}$  SIGNAL LAYOUT PLAN SHEETS.

"FAR OUT" DETECTION REFERS TO LOCKING, PRESENCE TYPE DETECTION LOCATED IN THRU LANES, RIGHT TURN LANES, AND RIGHT TURN LANE TAPER AREAS (IF APPLICABLE), USUALLY 250' (75 m) IN ADVANCE OF STOP BARS. "UPTIGHT" DETECTION REFERS TO NON-LOCKING PRESENCE TYPE DETECTION LOCATED IN ALL LANES AND 10'-15' (3.0 m-4.5 m) BEHIND THE CROSSING STREET'S EDGE OF PAVEMENT EXTENDED.

NOTE:

ALL DETAILS AND NOTES SHOWN ARE FROM THE I.D.O.T. DISTRICT 1 TRAFFIC SIGNAL DESIGN GUIDELINES DATED JANUARY 1995

THIS DRAWING HAS BEEN PREPARED TO ASSIST THE RESIDENT ENGINEER FOR ALL ROADWAY RESURFACING OR S.M.A.R.T. PROJECTS WHERE THE DIMENSIONS ARE NOT SHOWN ON THE PLANS AND THE FINAL LOCATIONS FOR CROSSWALKS OR STOP BARS ARE NOT DETERMINED.

LOOP INSTALLATION WAY RESURFACING			F.A.I. RTE.	SECTION	COUNTY	TOTAL SHEETS	SHEET NO.			
			55	2014-063-RS&T	DuPAGE	40	40			
				TS-07	CONTRACT	NO. 6	60Y98			
	STA.	TO STA.	FED. R	FED. ROAD DIST. NO. 1 ILLINOIS FED. AID PROJECT						