## LETTING ITEM NUMBER

6A


LETTING DATE

JULY 29, 2016

ITEM NO.	DESCRIPTION	UNIT	EST. QYT.	AS BUILT QTY.	
AR108108	1/C #8 5 KV UG CABLE	L.F.	1,360		
AR108158	1/C #8 5 KV UG CABLE IN UD	L.F.	12,170		
AR108258	2/C #8 5KV UG CABLE IN UD	L.F.	410		
AR108960	REMOVE CABLE	L.F.	9,720		
AR109902	REMOVE ELECTRICAL EQUIPMENT	L.S.	1		
AR110504	4-WAY CONCRETE ENCASED DUCT	L.F.	305		
AR110710	ELECTRICAL MANHOLE	EACH	1		
AR125442	TAXI GUIDANCE SIGN, 2 CHARACTER	EACH	4		
AR125443	TAXI GUIDANCE SIGN, 3 CHARACTER	EACH	5		
AR125444	TAXI GUIDANCE SIGN, 4 CHARACTER	EACH	2		
AR125446	TAXI GUIDANCE SIGN, 6 CHARACTER	EACH	1		
AR125447	TAXI GUIDANCE SIGN, 7 CHARACTER	EACH	2		
AR125511	MIRL, BASE MOUNTED-LED	EACH	47		
AR125546	MI THRESHOLD LIGHT BASE MTD-LED	EACH	12		
AR125561	RUNWAY DISTANCE REMAINING SIGN-LED	EACH	4		
AR125565	SPLICE CAN	EACH	1		
AR125901	REMOVE STAKE MOUNTED LIGHT	EACH	45		
AR125902	REMOVE BASE MOUNTED LIGHT	EACH	15		
AR125904	REMOVE TAXI GUIDANCE SIGN	EACH	14		
AR125905	REMOVE RWY DISTANCE REMAIN SIGN	EACH	4		
AR125942	ADJUST BASE MOUNTED LIGHT	EACH	15		
AR150510	ENGINEER'S FIELD OFFICE	L.S.	1		
AR150520	MOBILIZATION	L.S.	1		
AR150530	TRAFFIC MAINTENANCE	L.S.	1		
AR401610	BITUMINOUS SURFACE COURSE	TON	5,450		
AR401630	BITUMINOUS TEST SECTION	EACH	1		
AR401640	BITUMINOUS PAVEMENT GROOVING	S.Y.	32,500		
AR401650	BITUMINOUS PAVEMENT MILLING	S.Y.	43,300		
AR603510	BITUMINOUS TACK COAT	GAL.	6,500		
AR605540	CLEAN & SEAL JOINTS	L.F.	14,983		
AR620520	PAVEMENT MARKING-WATERBORNE	S.F.	25,150		
AR620525	PAVEMENT MARKING-BLACK BORDER	S.F.	1,800		
AR620900	PAVEMENT MARKING REMOVAL	S.F.	10,000		
AR801358	SPALL REPAIR	S.F.	25		
AR904510	SODDING	S.Y.	11,200		

# RUNWAY 11-29 REHABILITATION, ASSOCIATED EDGE LIGHTS AND GUIDANCE SIGN REPLACEMENT AT

# WILLIAMSON COUNTY REGIONAL AIRPORT MARION - HERRIN, WILLIAMSON COUNTY, ILLINOIS

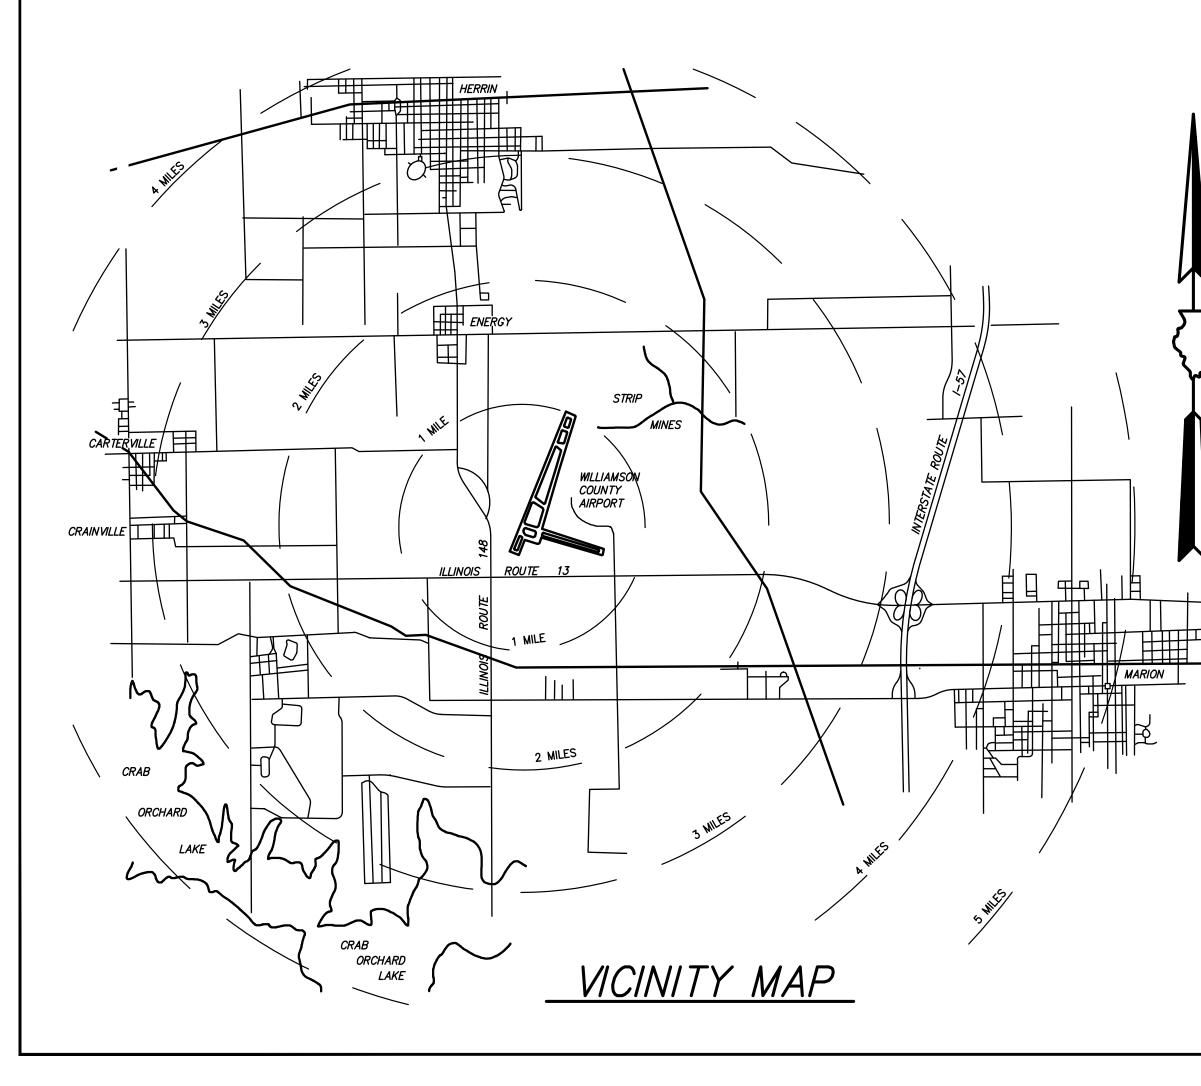

# **CONSTRUCTION PLANS**

# DATE : 6/17/2016

ILLINOIS PROJECT No. MWA-4480 A.I.P. PROJECT No. 3-17-0065-3316

## **BOARD MEMBERS**

CHAIRMAN :	BERNARD A. PAUL
MEMBERS :	JAVIER MUNIZ RICHARD PISONI ROBERT MEES MICHAEL TROOP
SECRETARY :	CRAIG PILLATSCH
AIRPORT MANAGER :	DOUGLAS KIMMEL



EXPIRES : NOVEMBER 30, 2017

PROJECT 15096

LETTING CONTRACT NUMBER

WI057


TOTAL SHEETS: 21


## INDEX OF SHEETS

1.	COVER
2.	SCOPE OF WORK
3–5.	SAFETY AND PHASING PLAN
6.	TYPICAL SECTIONS
7-9.	DEMOLITION PLAN
10-11.	OVERLAY PLAN
12-15.	ELECTRICAL PLANS
16–18.	ELECTRICAL NOTES AND DETAILS
19–20.	PAVEMENT MARKING PLANS
21.	PAVEMENT MARKING DETAILS


DUE TO THE ANTICIPATED TIMING OF CONTRACT AWARD AND POTENTIAL FOR INCLEMENT WEATHER, IT IS NOT EXPECTED THAT CONSTRUCTION WILL BEGIN BEFORE APRIL 2017.

PLANS PREPARED BY :	
CLARIDA & ZIEGLER ENGINEERING COMPANY P.O. Box 937, 410 North Court Street Marion, Illinois 62959	WILLIAMSON COUNTY AIRPORT AUTHORITY
REGISTERED PROFESSIONAL ENGINEER OF ILLINOIS NO. 053881	APPROVED CHAIRMAN DATE : 6/17/2016
SUBMITTED W. Juie Juin W. BRIAN ZIEGLER DATE : 6/17/2016	APPROVED Ling L Pellots SECRETARY DATE :

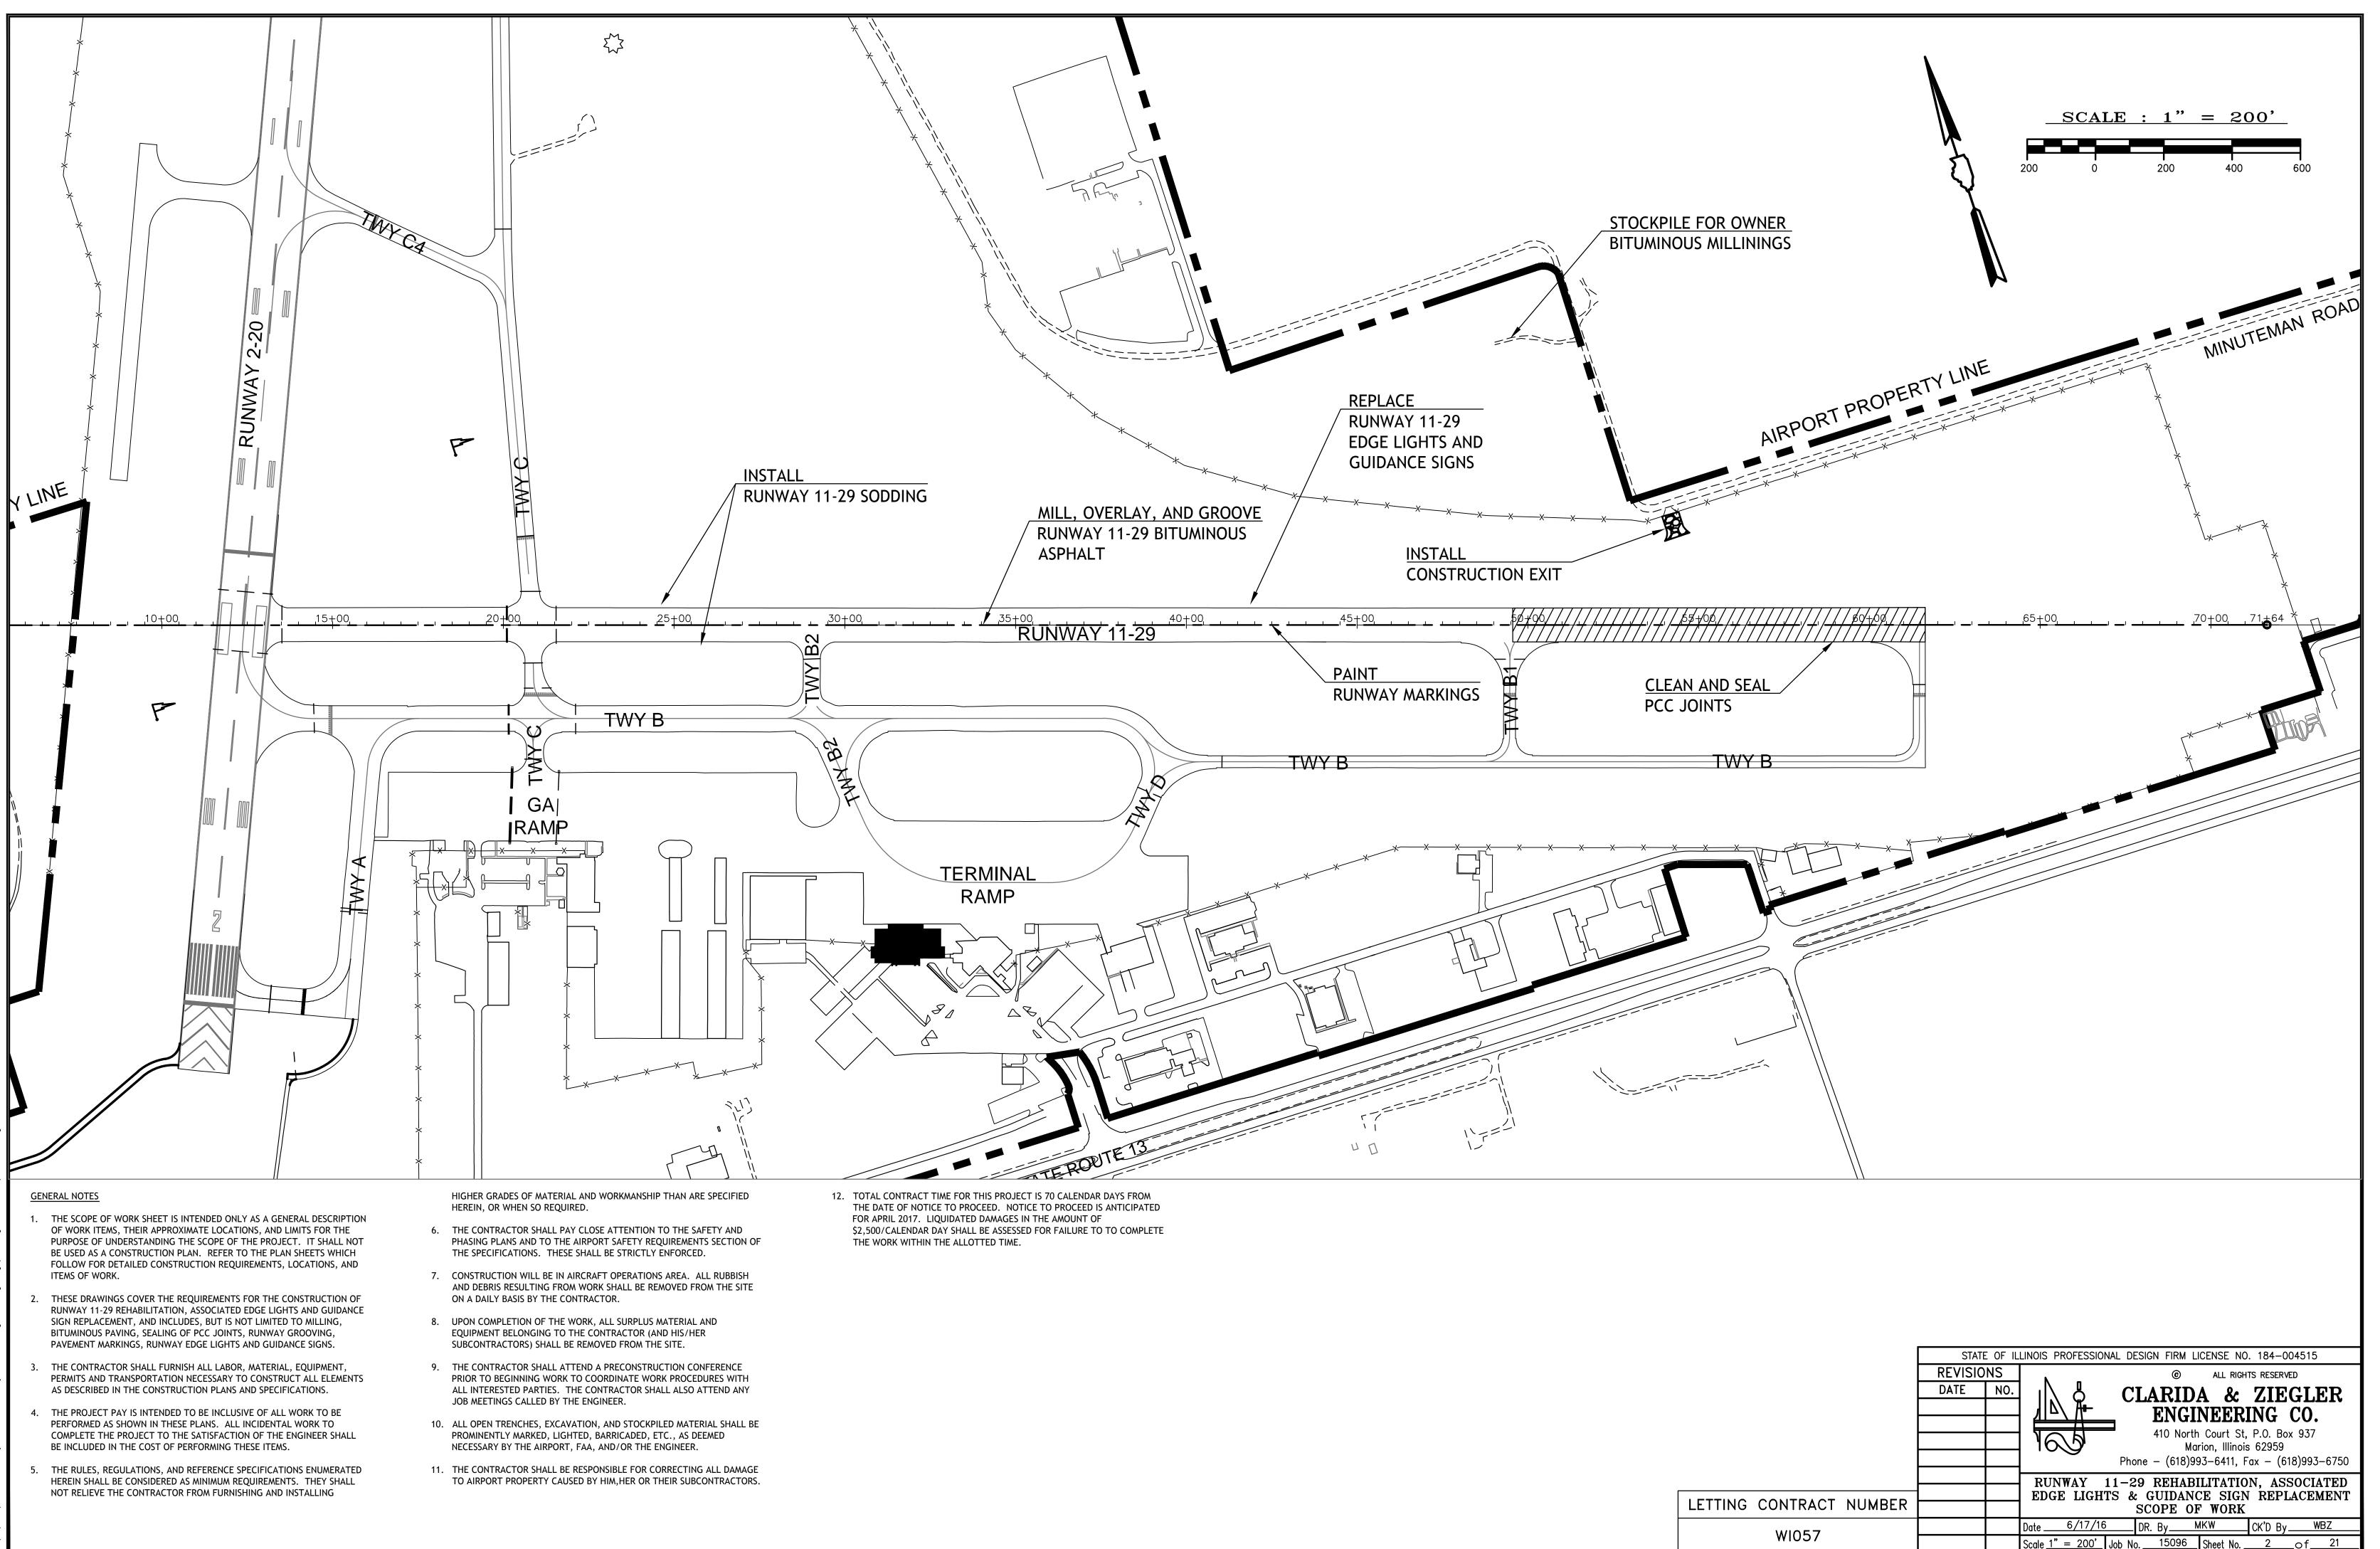

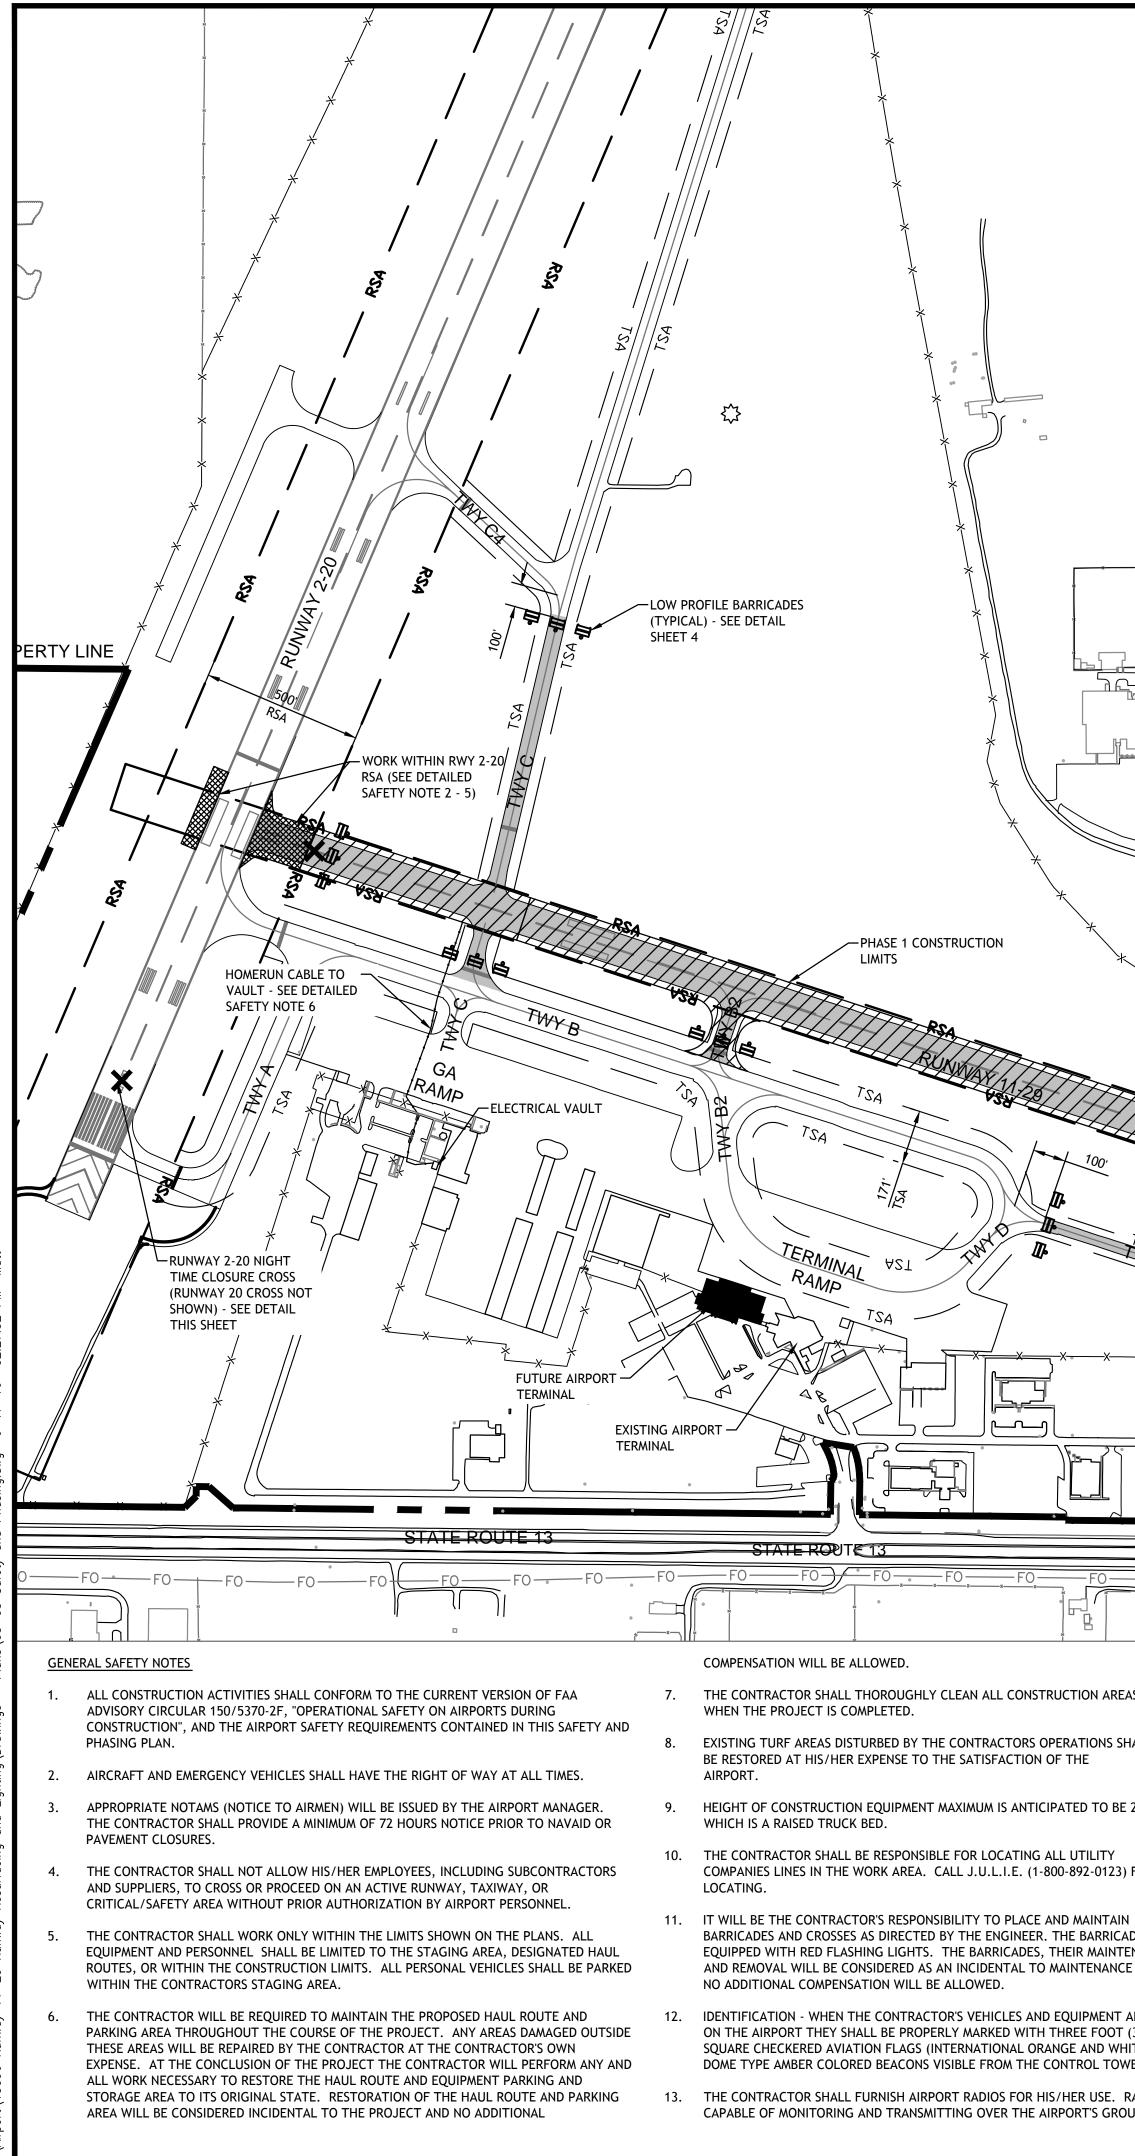

	р 	
AIRPORT PERIMI	-GATE ACCESS (SEE NOTE 15) MINUTEMAN ROAD	
TSA TSA TSA	CONSTRUCTION EXIT CONTRACTOR'S STAGING AND EMPLOYEE PARKING AREA RUNWAY CLOSURE CROSS (TYPICAL) - SE DETAIL THIS SHEET	E MINUTEMAN ROAD
HALL	FREQUENCY CONTINUOUSLY WHEN THE ATCT IS OPERATIONAL, 7:00 AM TO 7:00 PM. WHEN THE ATCT IS CLOSED THE CONTRACTOR SHALL MONITOR FREQUENCY (127.47).       1.         14.       CONTRACTOR PERSONNEL OPERATING VEHICLES ON THE AIRFIELD SHALL ATTEND AIRPORT DRIVERS TRAINING CLASS OR BE ESCORTED BY PERSONNEL WHO HAVE COMPLETED TRAINING PRIOR TO BEGINNING OF CONSTRUCTION.       2.         15.       THE CONTRACTOR SHALL MAINTAIN SECURITY (GATE GUARD) ON THE ACCESS GATE WHEN IT IS UNLOCKED. THE GATE SHALL BE CLOSED AND LOCKED AT THE END OF EACH WORK DAY. CONTRACTOR SHALL PROVIDE LOCK FOR GATE WITH KEYS FOR ESSENTIAL PERSONNEL ONLY.	LED SAFETY NOTES PHASE 1 SHALL CONSIST OF BITUMINOUS MILLING ON RUNWAY 11-29, BIT STRIP AND PAVING, RUNWAY ELECTRICAL, HOME RUN CABLE INSTALLATION JOINT SEALING. WORK WITHIN THE RUNWAY 2-20 SAFETY AREA (RSA) SHALL BE COMPLET 2-20 CLOSED BETWEEN THE HOURS OF 11:00 PM AND 5:00 AM. ALL TREM BACKFILLED AND ALL EQUIPMENT, MATERIALS, AND PERSONNEL SHALL BE LATER THAN 5:00 AM. THE CONTRACTOR SHALL NOT LEAVE THE SITE UN PERSONNEL HAVE CONDUCTED A SAFETY INSPECTION AND DEEMED RUNW REOPEN.
N ADES WILL BE ENANCE, PLACEMENT E OF TRAFFIC AND ARE	<ol> <li>RUNWAY AND TAXIWAY LIGHTS WITHIN CLOSED PORTIONS OF PROJECT SHALL BE DISCONNECTED OR COVERED.</li> <li>THE CONTRACTOR SHALL PREPARE AND SUBMIT TO THE ENGINEER A SAFETY PLAN COMPLIANCE DOCUMENT (SPCP) PRIOR TO BEGINNING WORK. THE INTENT OF THE SPCD IS TO DOCUMENT HOW THE CONTRACTOR WILL COMPLY WITH CONSTRUCTION SAFETY AND PHASING PLAN (CSPP). SEE FAA ADVISORY CIRCULAR (AC) 150/5370-2F FOR ADDITIONAL INFORMATION.</li> <li>COST FOR STAGING AREA, CONSTRUCTION AND RESTORATION OF HAUL ROUTES, AND TEMPORARY CONSTRUCTION EXIT SHALL BE INCIDENTAL TO MAINTENANCE OF TRAFFIC.</li> <li>7.</li> </ol>	THE CONTRACTOR SHALL TO THE BEST OF HIS/HER ABILITY NOT PARK EN MATERIALS ON THE PAVEMENT OF RUNWAY 2-20 DURING NIGHT TIME CLU RUNWAY 2-20 CLOSURE CROSSES SHALL BE REMOVED AT THE END OF EAC THE CONTRACTOR SHALL MONITOR COMMON TRAFFIC ADVISORY FREQUE MHZ DURING RUNWAY 2-20 CLOSURE. WORK ASSOCIATED WITH INSTALLING HOME RUN OUTSIDE CONSTRUCTIO SHALL BE COORDINATED WITH THE RESIDENT ENGINEER AND AIR TRAFFIC CONTRACT TIME FOR PHASE 1 SHALL BE 15 CALENDAR DAYS. RUNWAY 2 BE NO MORE THAN 3 CALENDAR DAYS.
RADIOS SHALL BE JUND CONTROL		

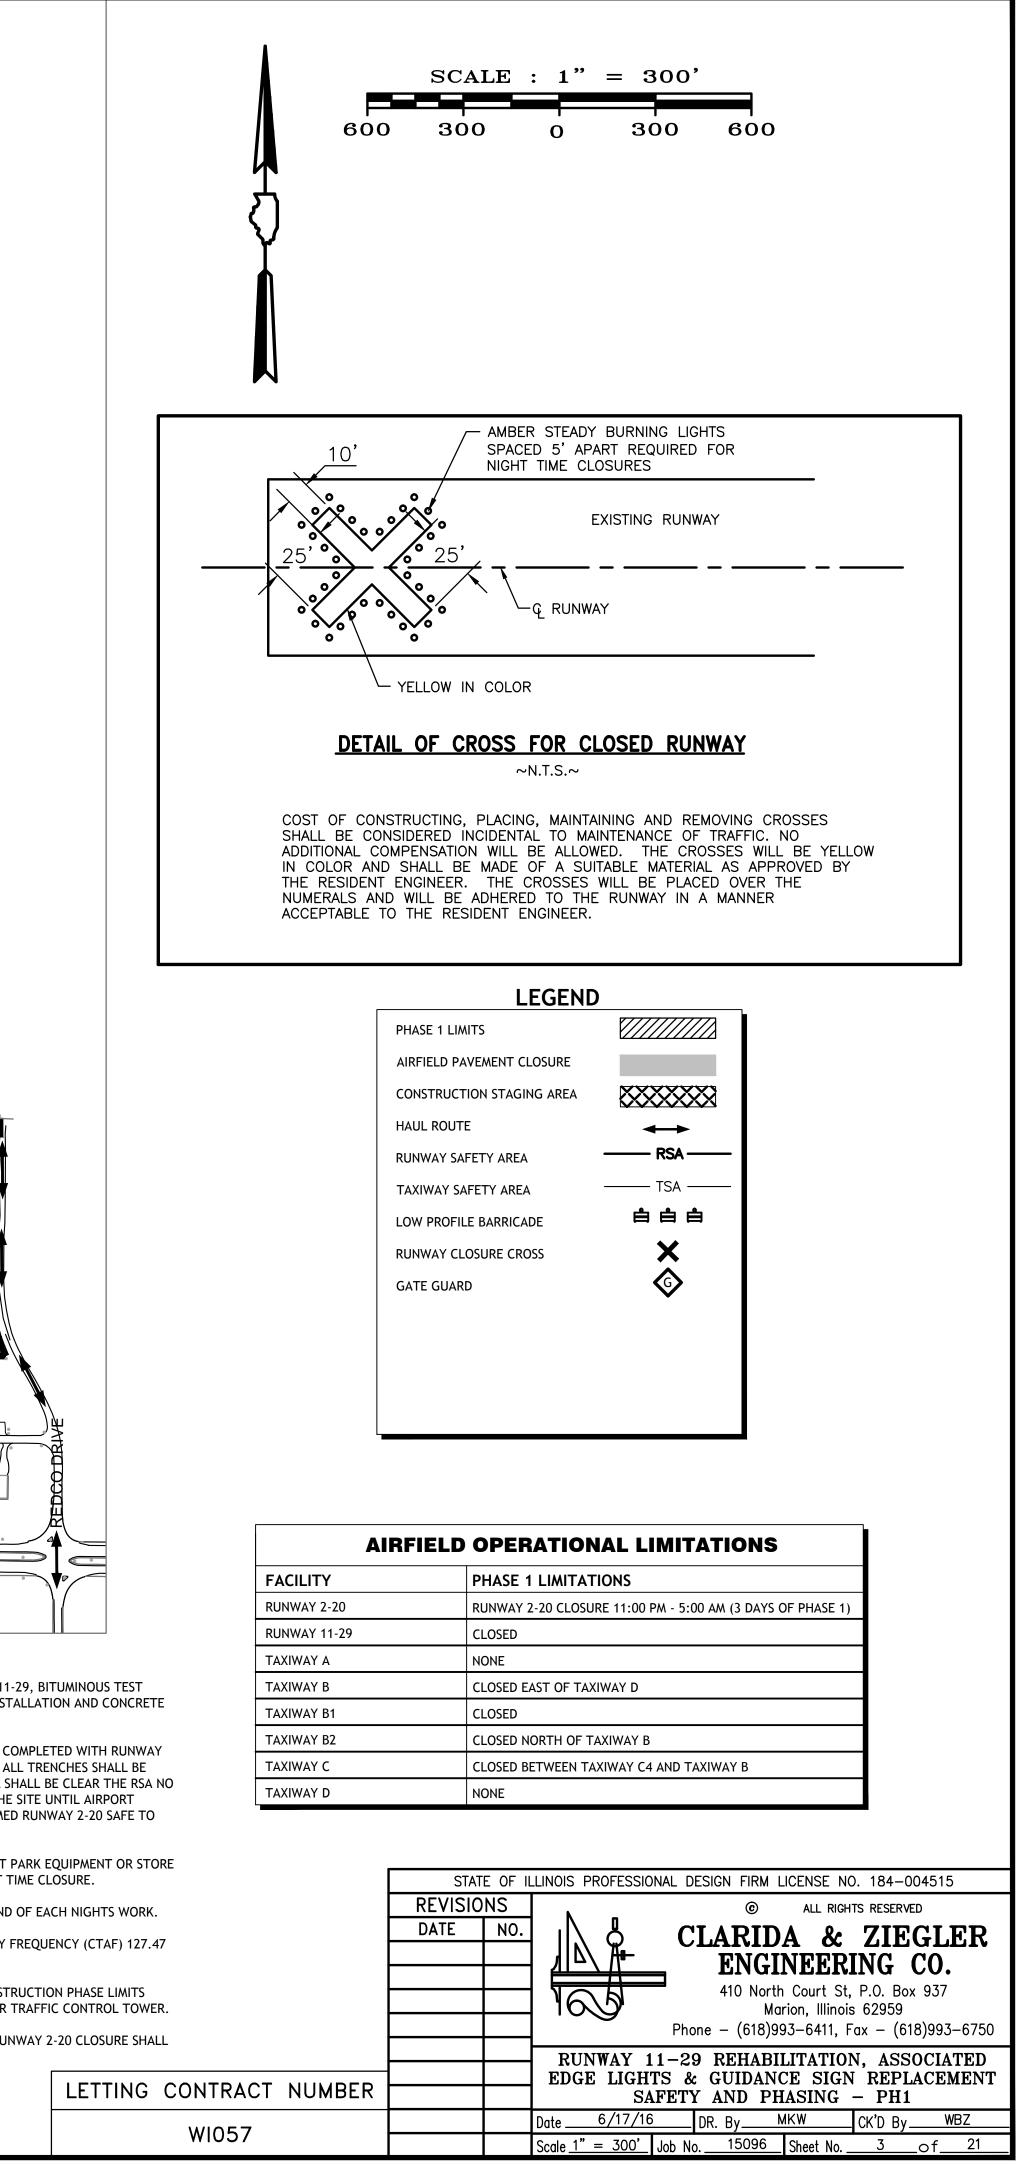



COMPLETED WITH RUNWAY ALL TRENCHES SHALL BE SHALL BE CLEAR THE RSA NO HE SITE UNTIL AIRPORT MED RUNWAY 2-20 SAFE TO


T PARK EQUIPMENT OR STORE TIME CLOSURE.


ND OF EACH NIGHTS WORK.

R TRAFFIC CONTROL TOWER.

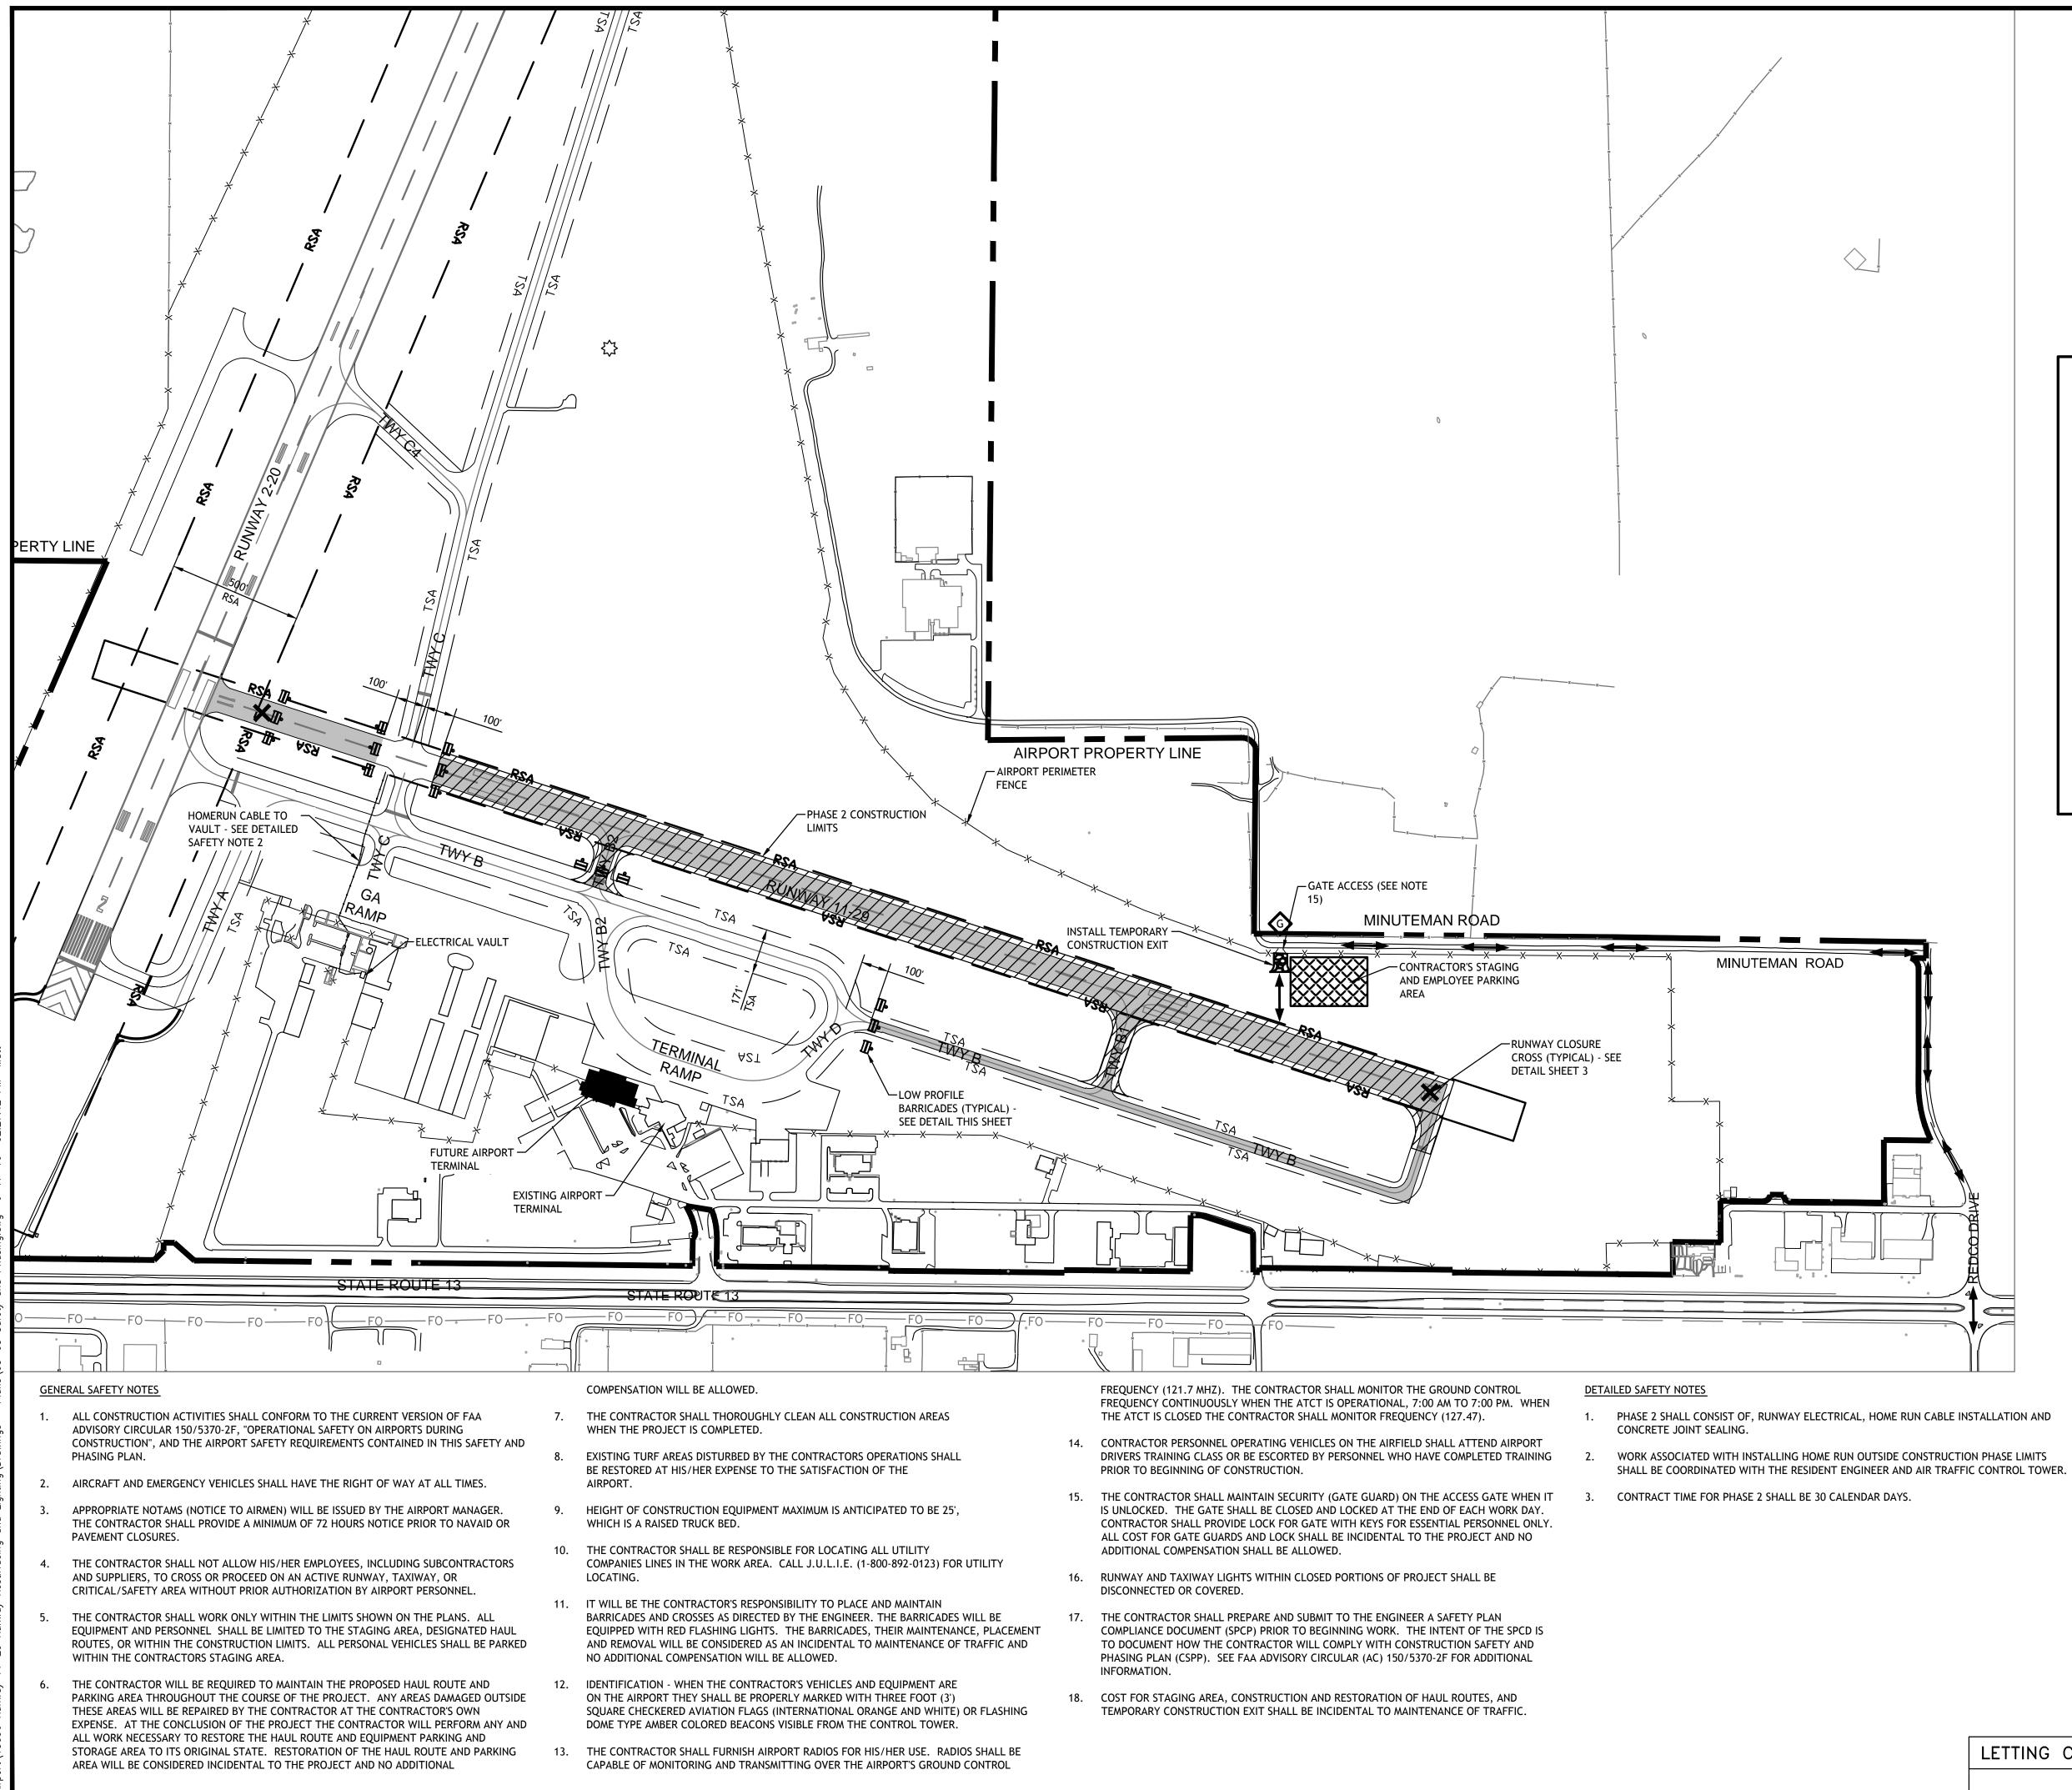

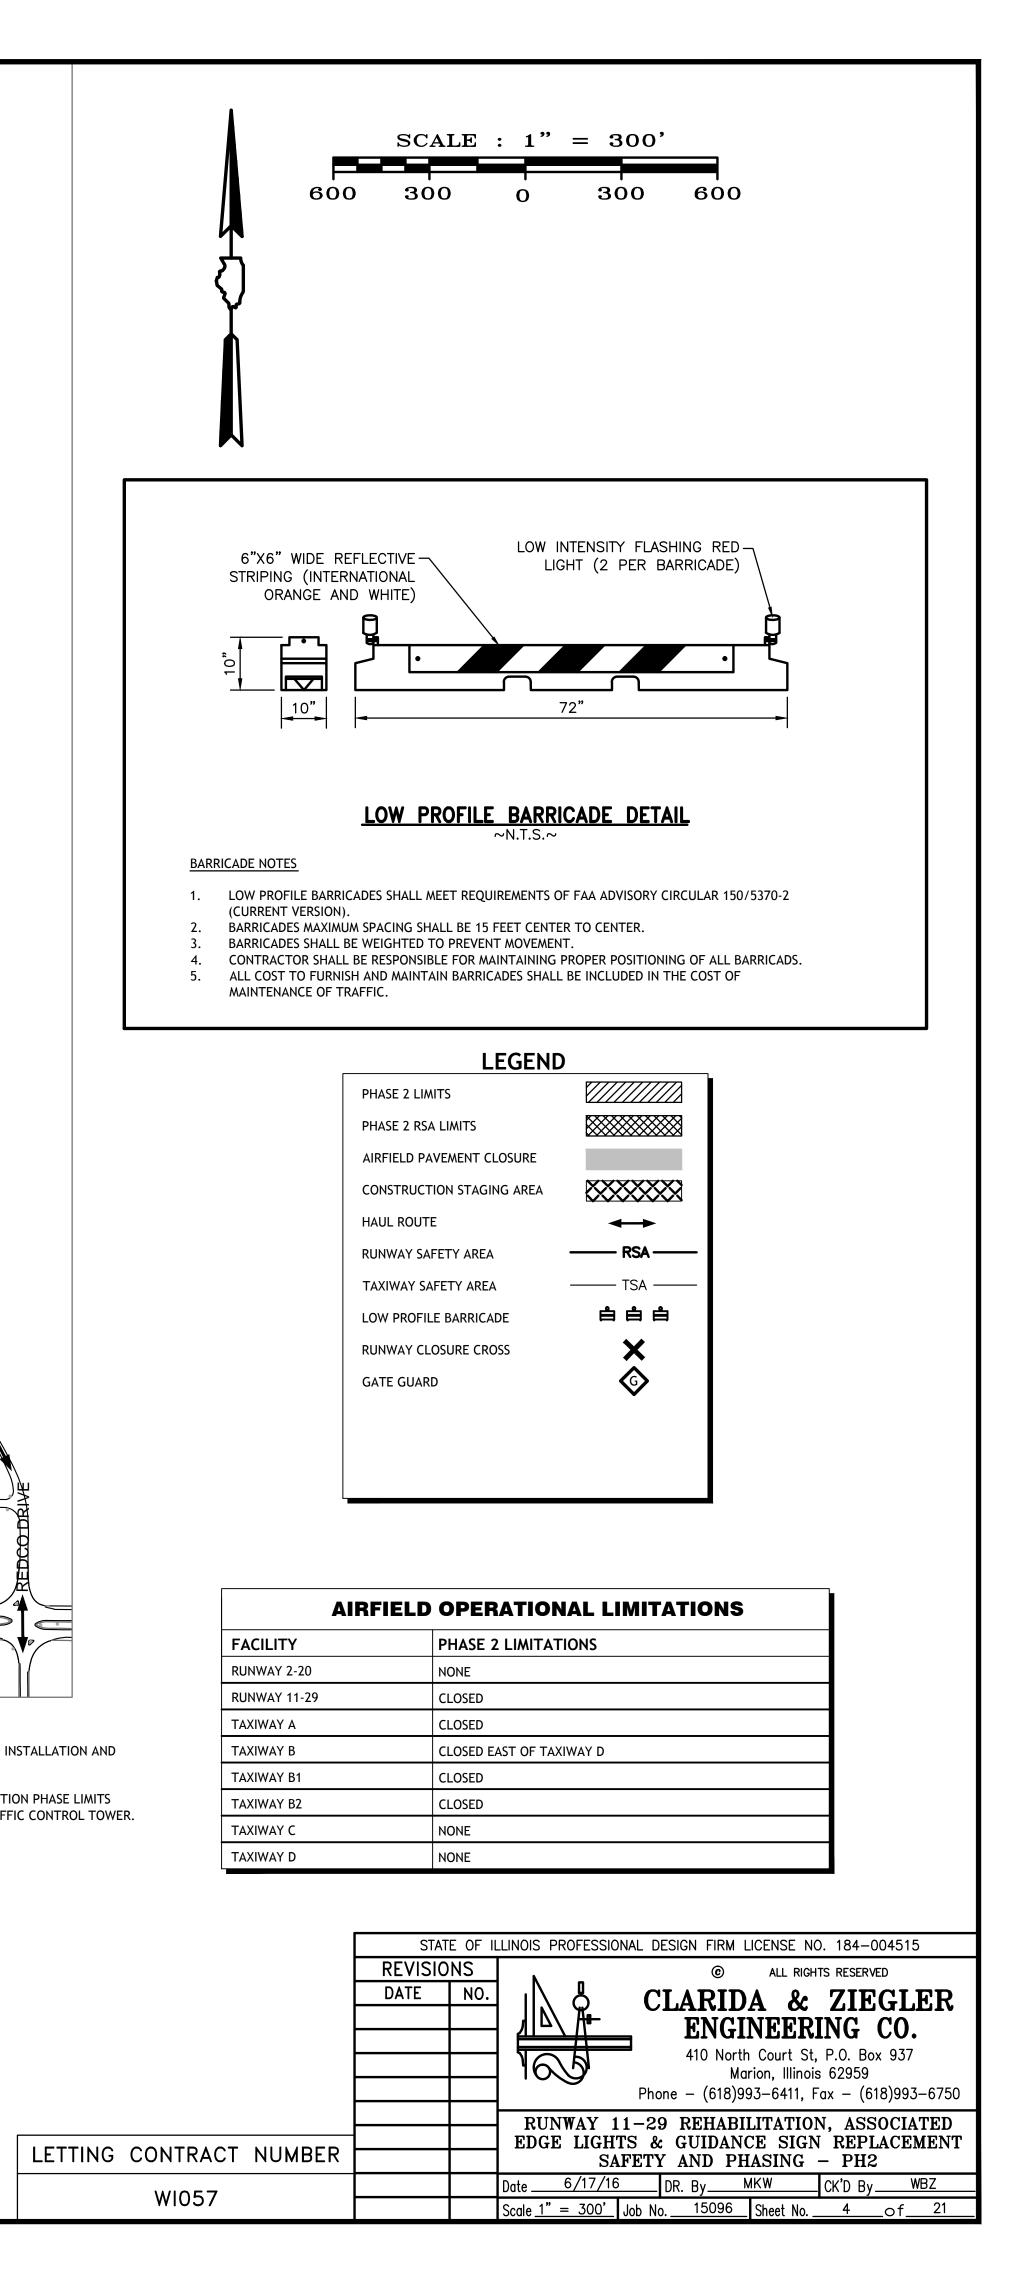

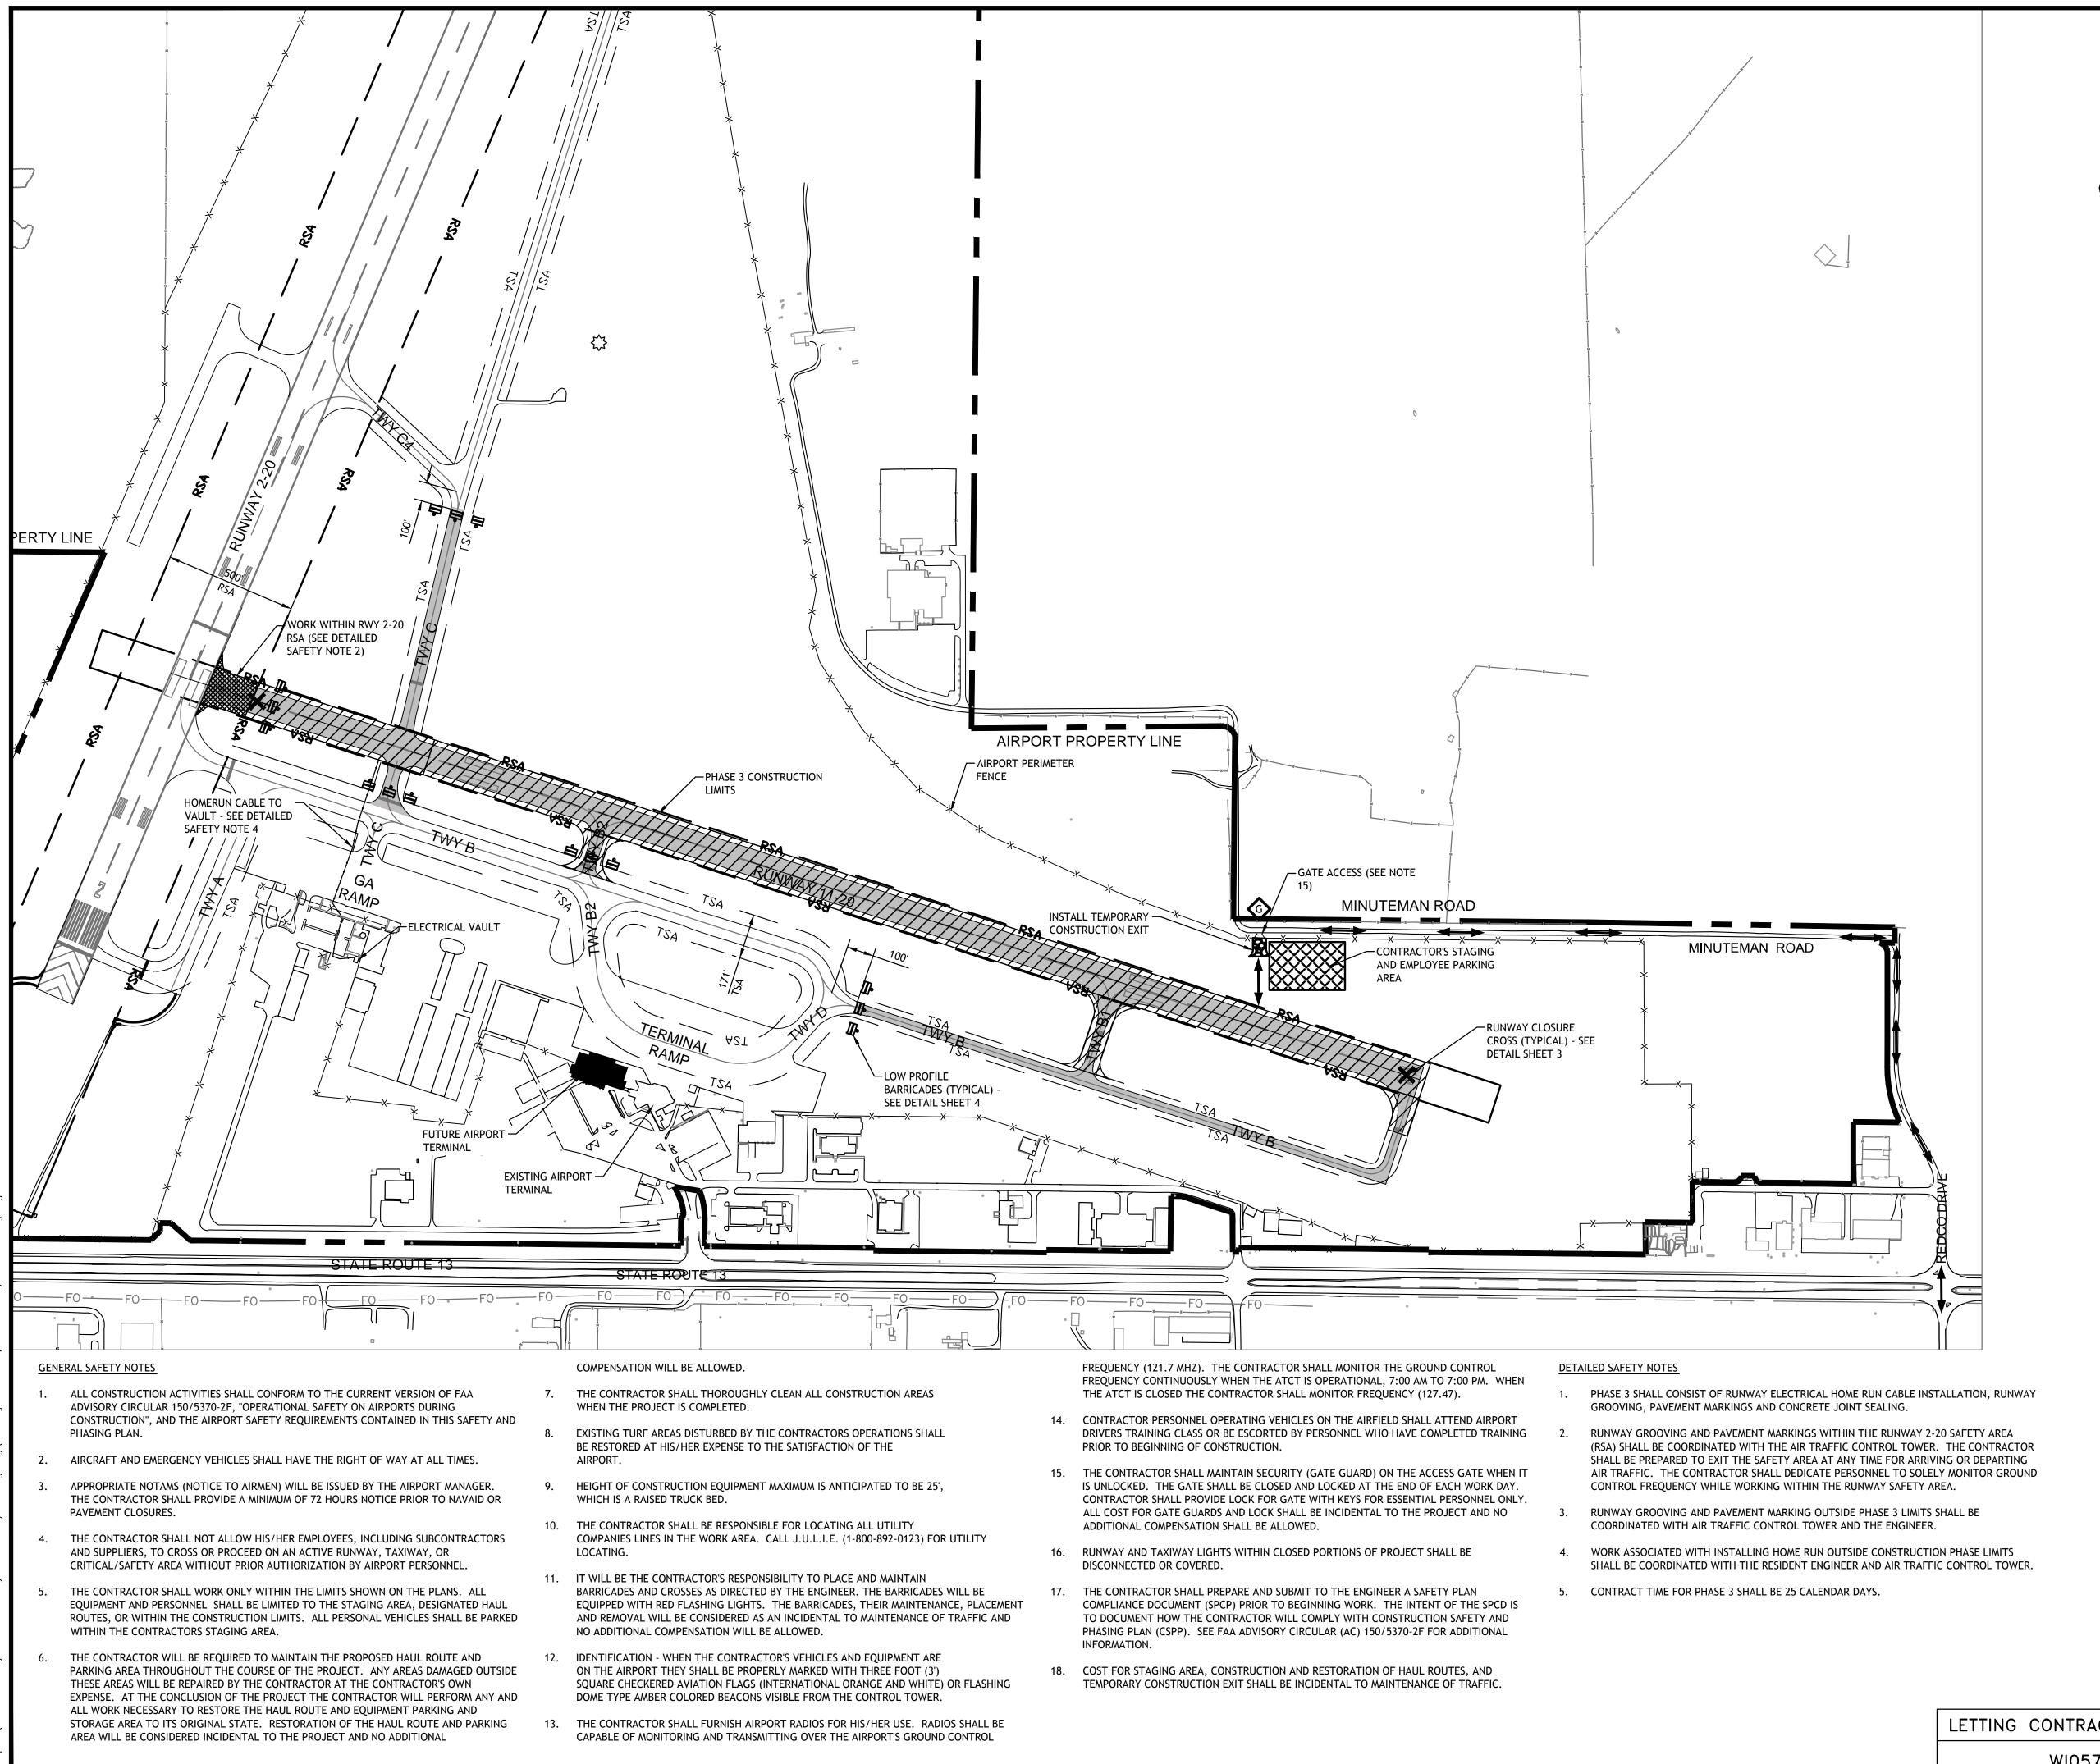

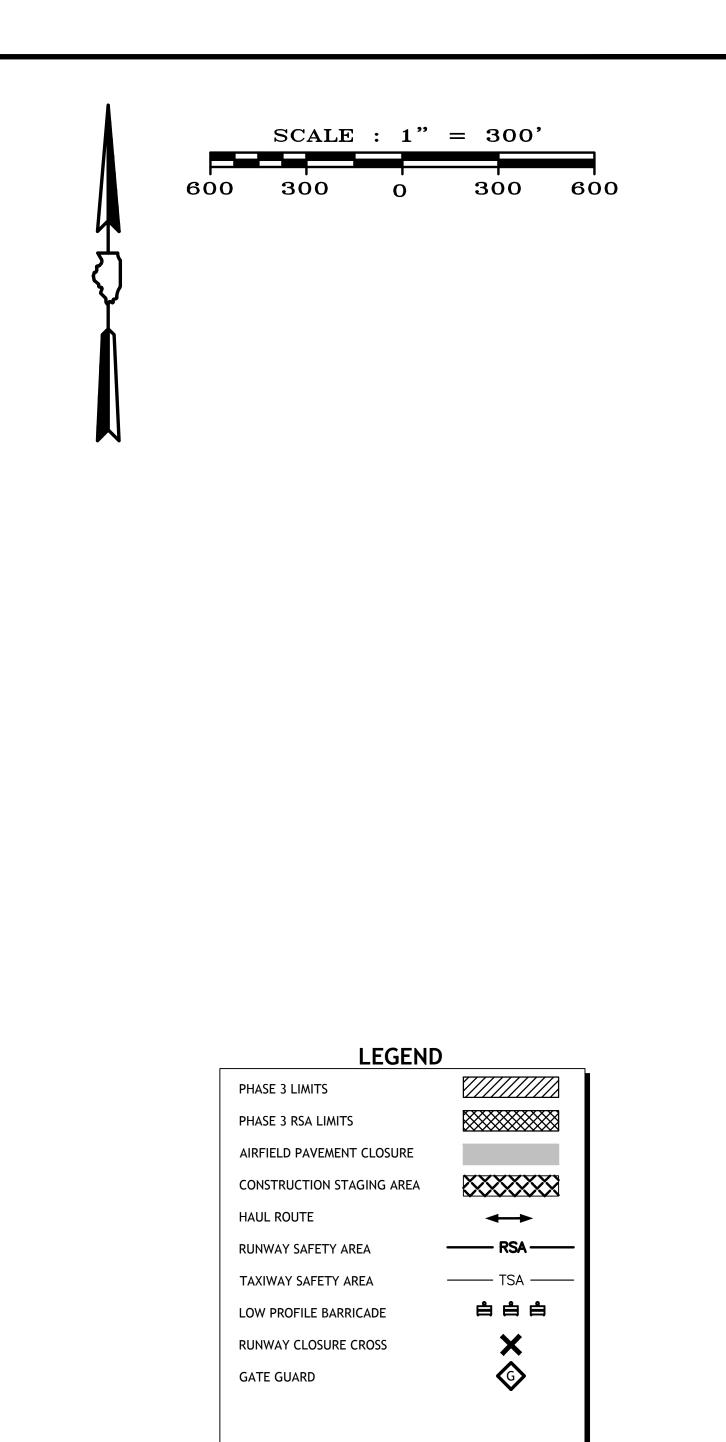



AIRFIELD	O OPERATIONAL LIMITATIONS
FACILITY	PHASE 3 LIMITATIONS
RUNWAY 2-20	NONE
RUNWAY 11-29	CLOSED
TAXIWAY A	NONE
TAXIWAY B	CLOSED EAST OF TAXIWAY D
TAXIWAY B1	CLOSED
TAXIWAY B2	CLOSED NORTH OF TAXIWAY B
TAXIWAY C	CLOSED BETWEEN TAXIWAY C4 AND TAXIWAY B

NONE

TAXIWAY D

	STATE OF ILLINOIS PROFESSIONAL DESIGN FIRM LICENSE NO. 184–004515		
	REVISIONS DATE NO.	© ALL RIGHTS RESERVED CLARIDA & ZIEGLER	
		<b>ENGINEERING CO.</b> 410 North Court St, P.O. Box 937	
		Marion, Illinois 62959 Phone – (618)993–6411, Fax – (618)993–6750	
		RUNWAY 11-29 REHABILITATION, ASSOCIATED EDGE LIGHTS & GUIDANCE SIGN REPLACEMENT	
CONTRACT NUMBER		SAFETY AND PHASING - PH3	
WI057		Date <u>6/17/16</u> DR. By <u>MKW</u> CK'D By <u>WBZ</u>	
¥¥1037		Scale <u>1" = 300'</u> Job No. <u>15096</u> Sheet No. <u>5</u> of <u>21</u>	

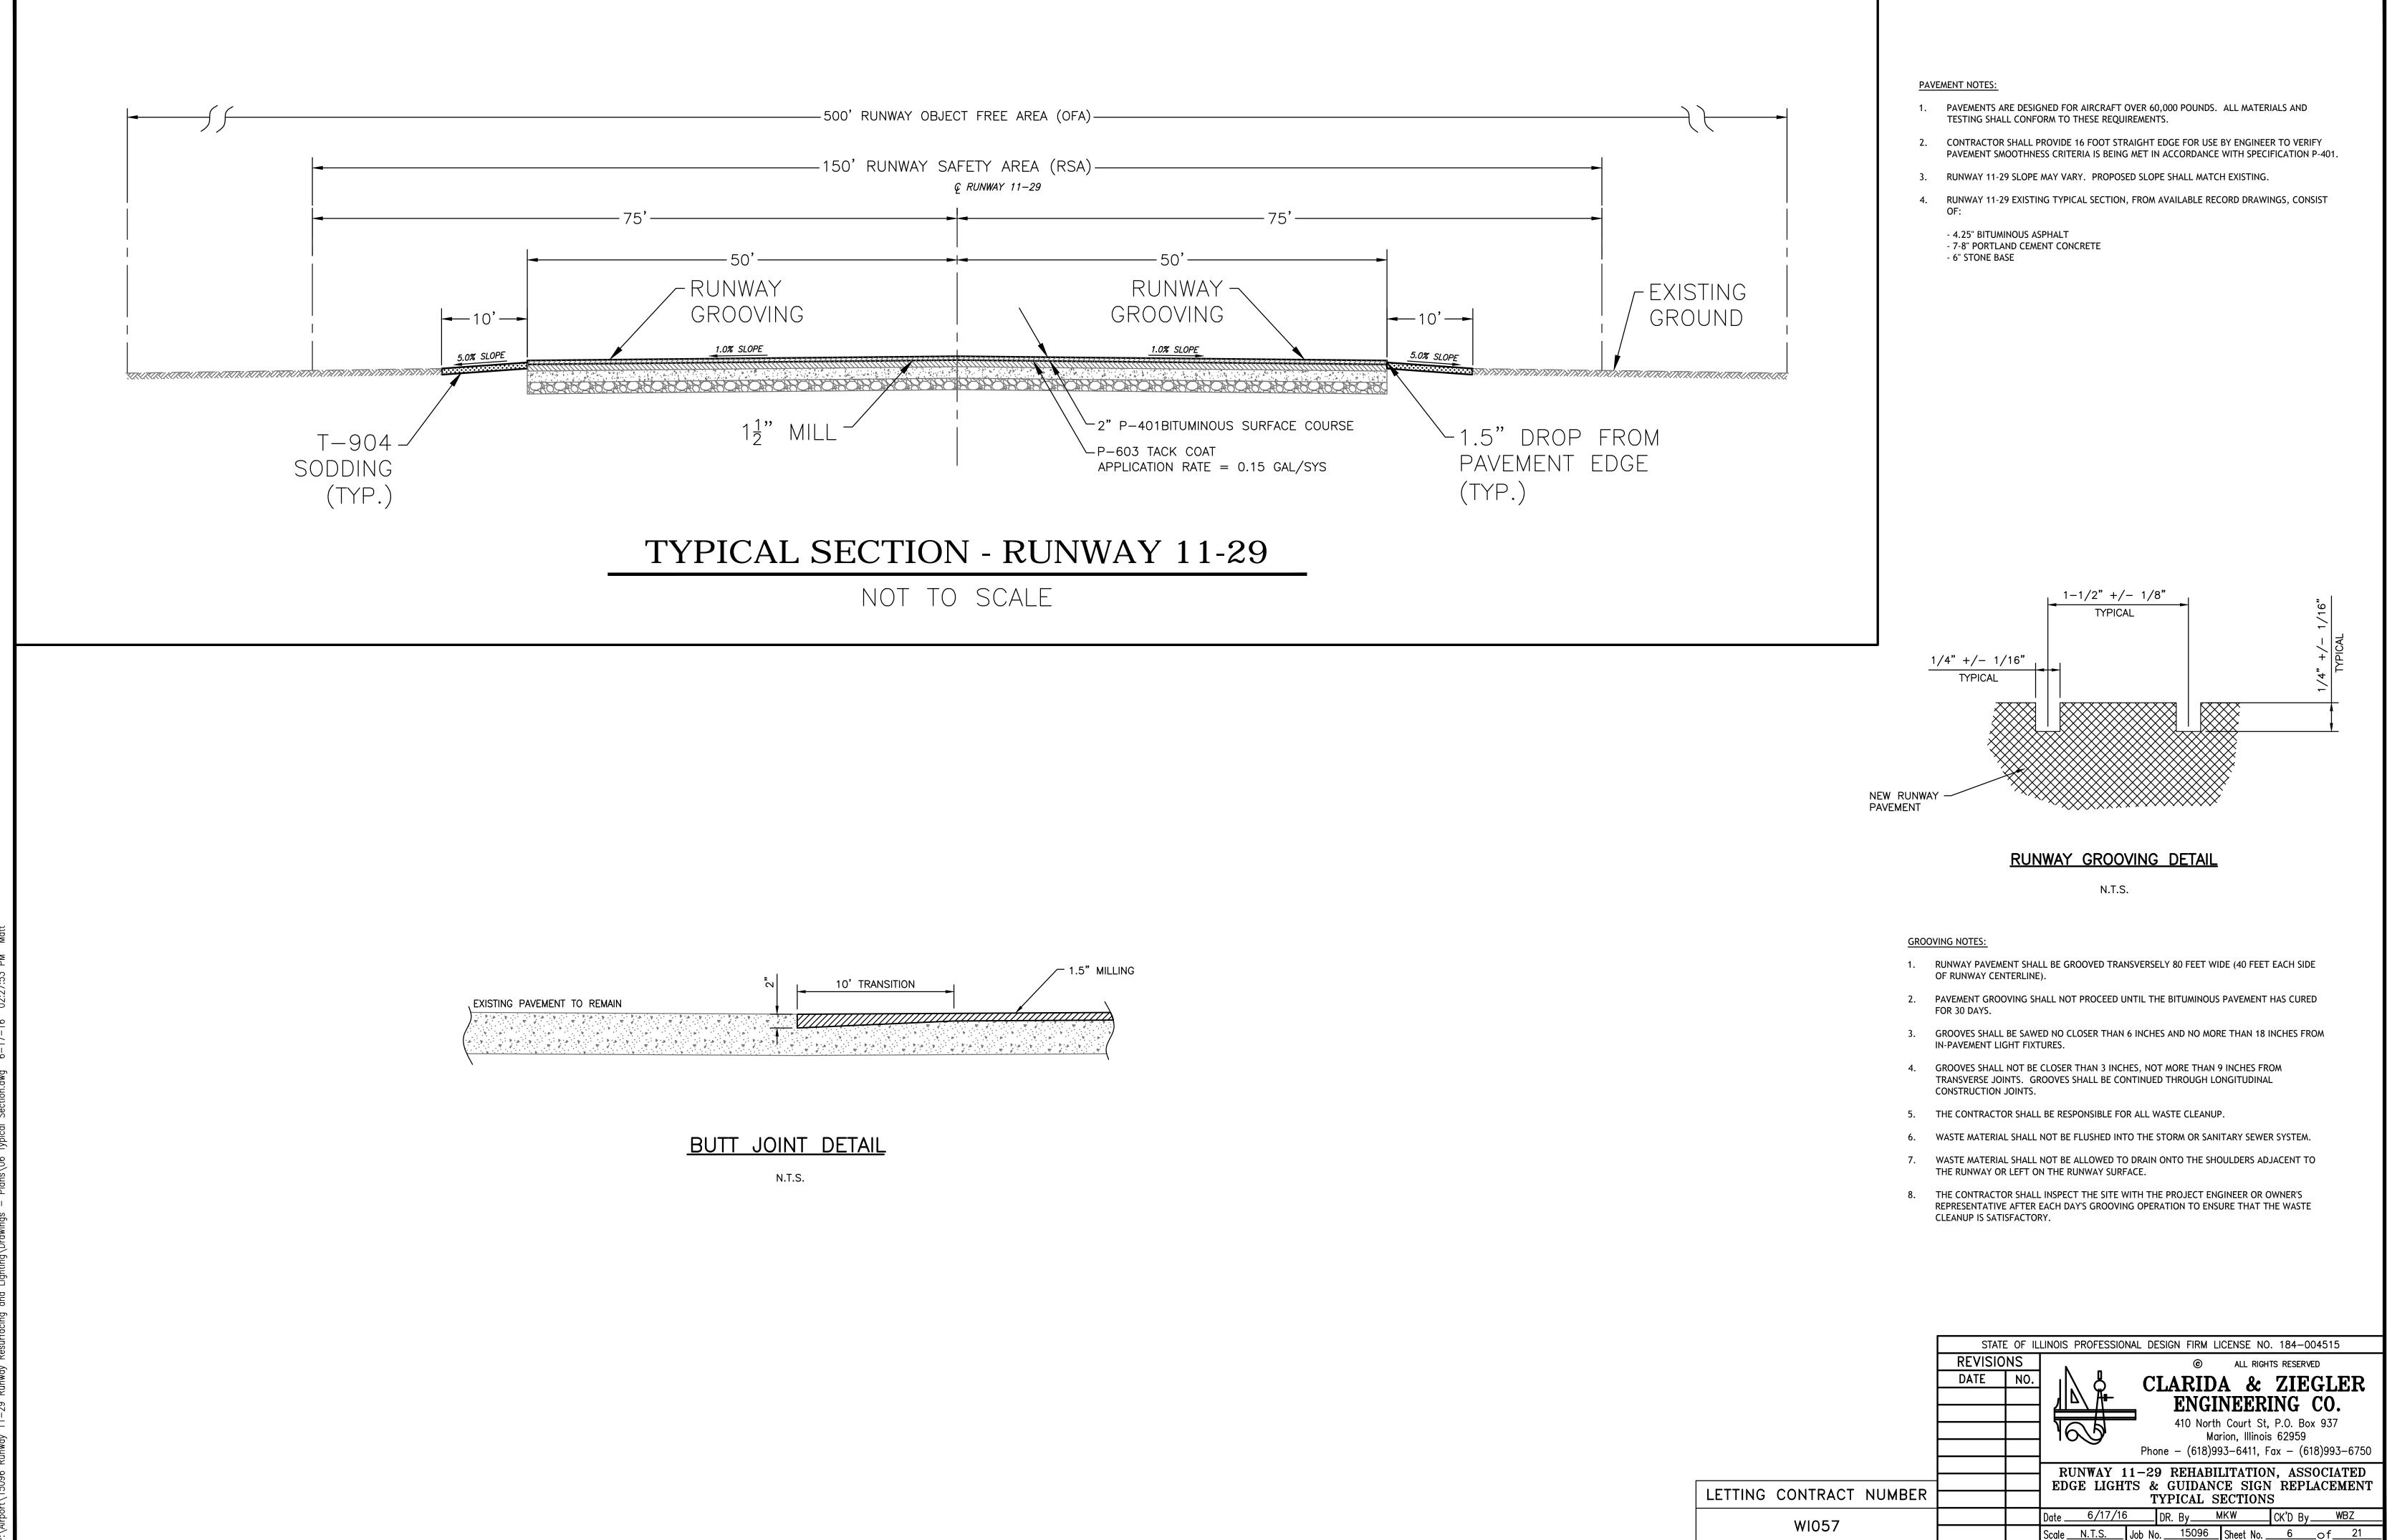

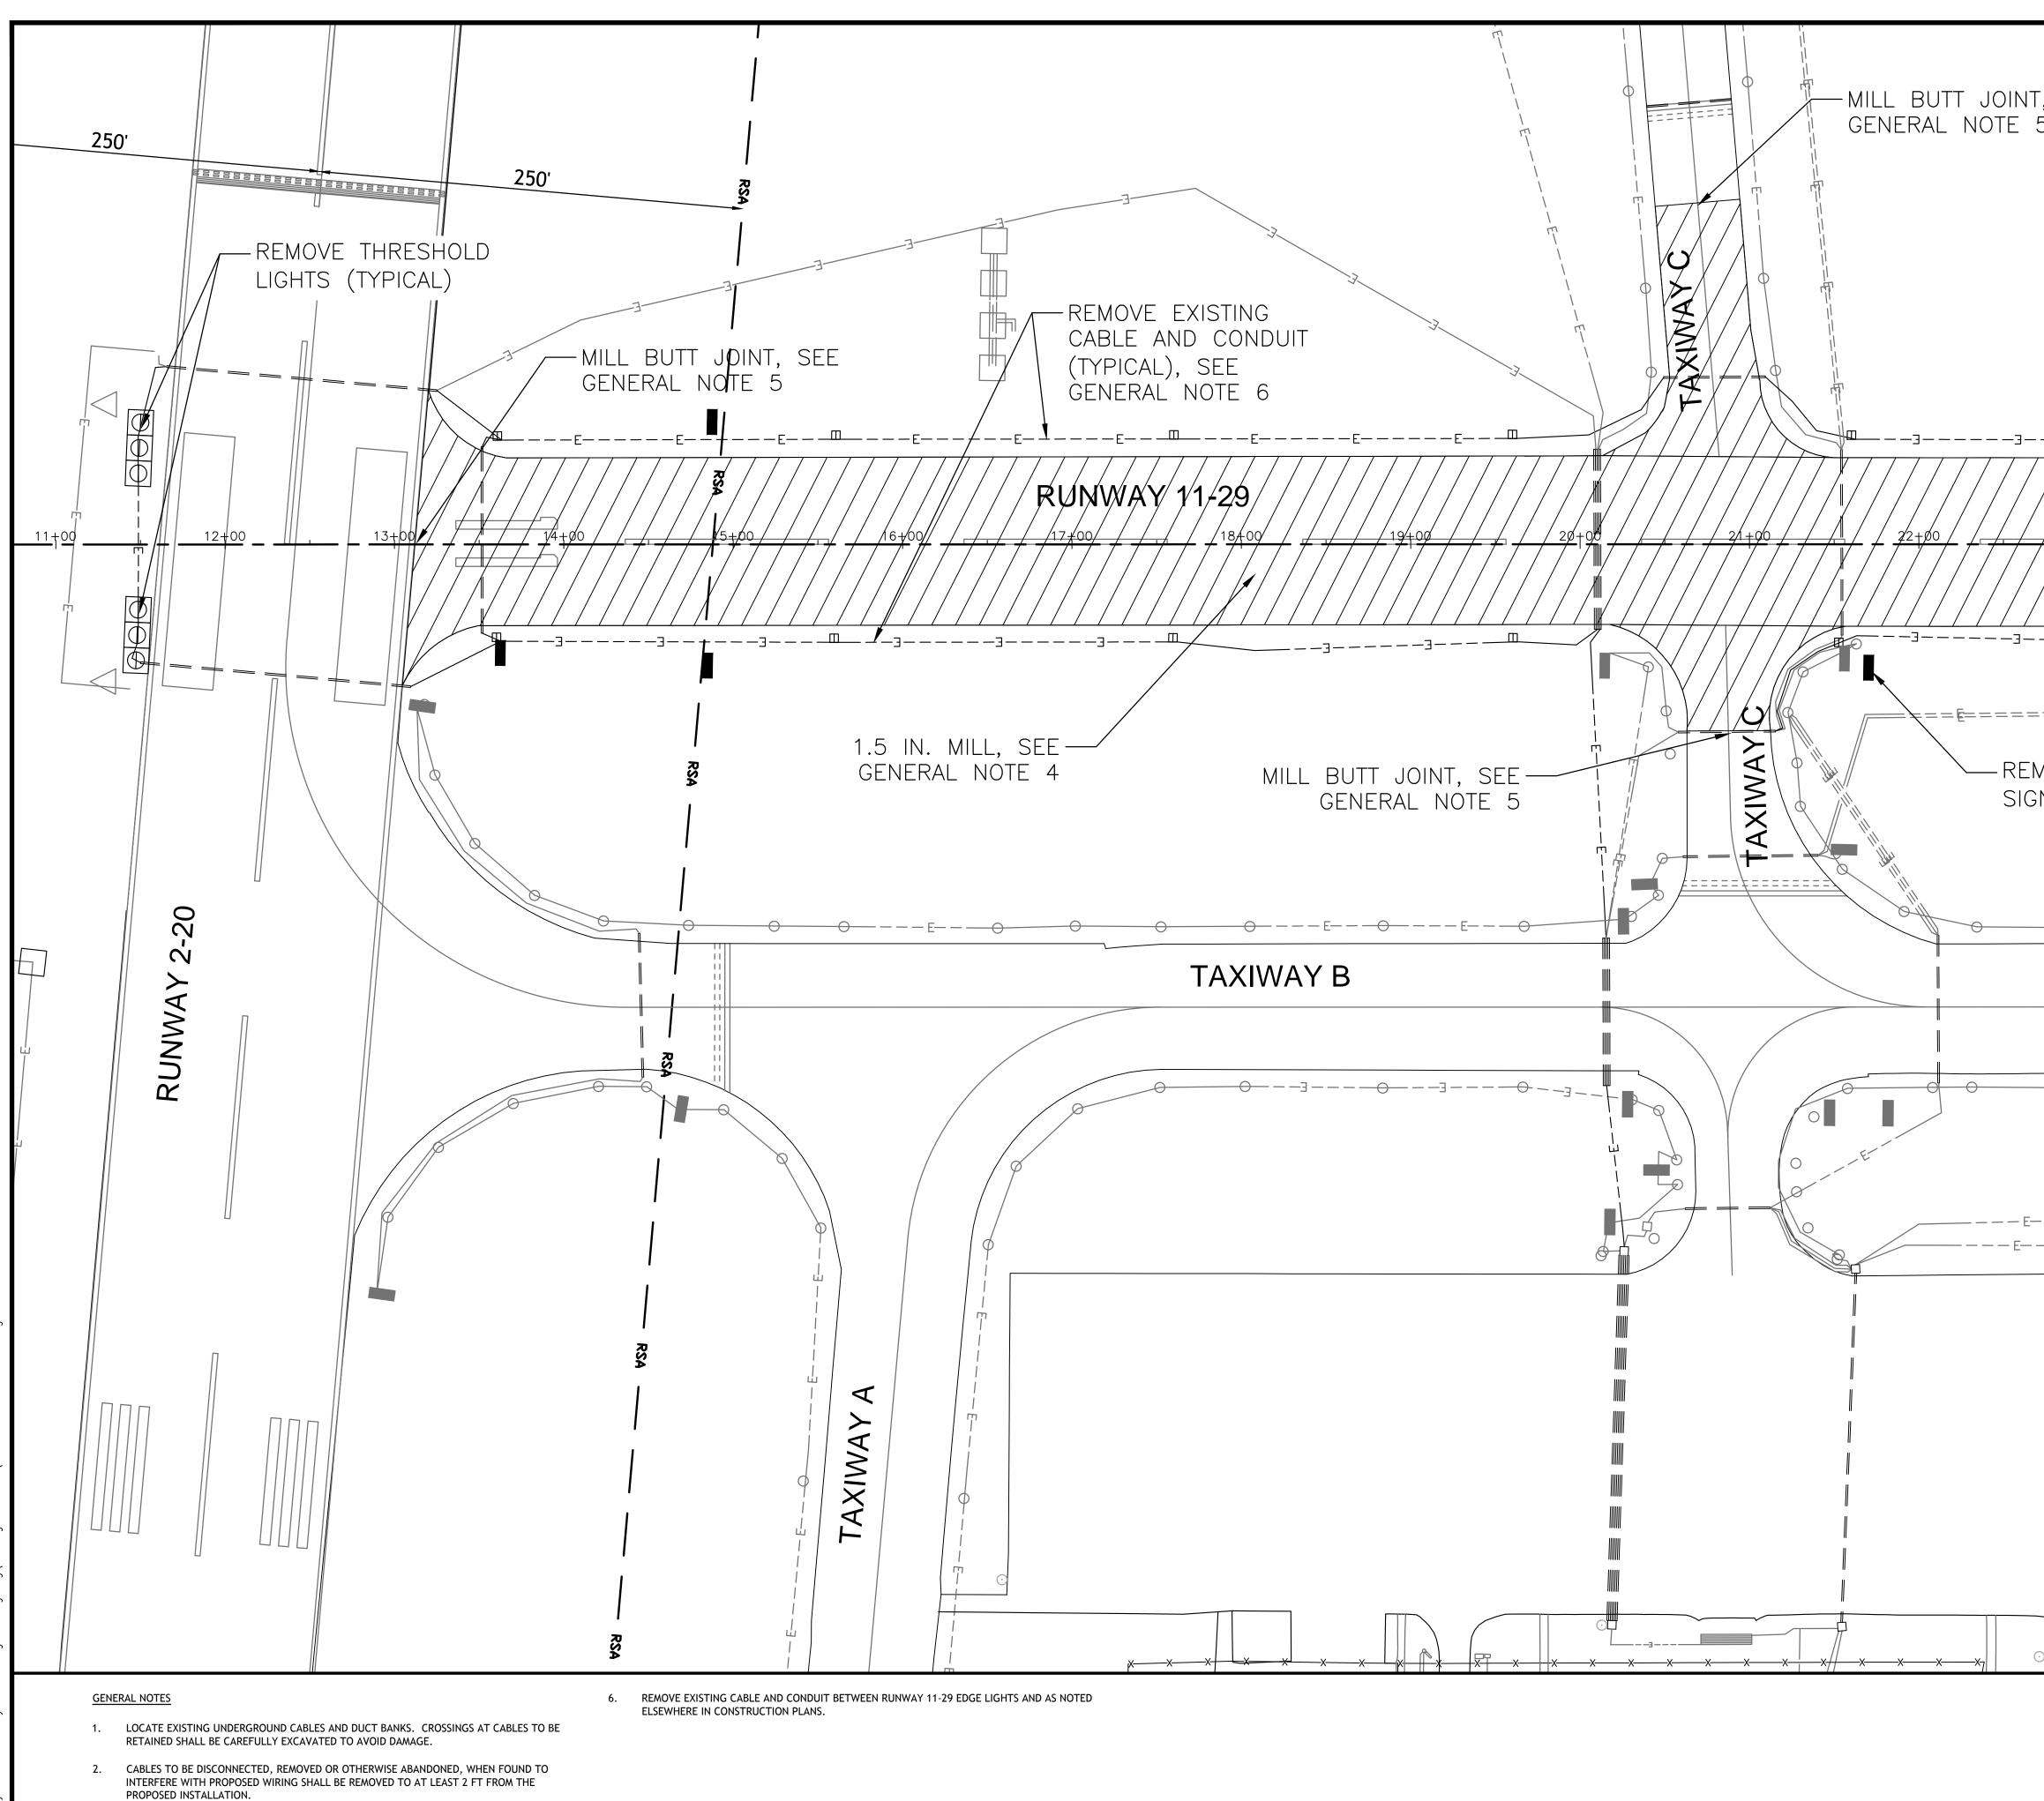


3. EXISTING RUNWAY 11-29 CABLES TO BE REMOVED FROM DUCK BANKS.

4. CONTRACTOR SHALL STOCKPILE MILLINGS AT LOCATION SPECIFIED ON SCOPE OF WORK SHEET.


5. BUTT JOINT SHALL BE CONSTRUCTED PER DETAIL ON TYPICAL SECTIONS. FIELD LOCATION OF JOINT SHALL BE DETERMINED BY THE ENGINEER. BUTT JOINT CONSTRUCTION SHALL BE INCIDENTAL TO BITUMINOUS PAVEMENT MILLING.


ort\15096 Runway 11—29 Runway Resurfacing and Lighting\Drawings — Plans\07—09 Demolition Plan.dwg 6—17—16 02

, SEE 5	SCALE : 1" = 50' 50 0 50 100 150
/ 11-	MOVE RUNWAY -29 EDGE LIGHT PICAL)
MOVE RUNWAY GUIDANCE N (TYPICAL)	<u></u>
— <del>○ — — — E — — — ○ — — — E — — — -</del>	− − − E − − − − E − − − E − − − E − − − E − − − E − − − E − − − E − − − E − − − − E − − − − E − − − − E − − − − E − − − − E − − − − E − − − − E − − − − E − − − − − E − − − − E − − − − − E − − − − − E − − − − − E − − − − − E − − − − E − − − − − E − − − − − E − − − − − − E −
	3
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Э [	STATE OF ILLINOIS PROFESSIONAL DESIGN FIRM LICENSE NO. 184–004515 REVISIONS DATE NO. ALL RIGHTS RESERVED CTARIDA & 7IFCIFR
	CLARTIDA & ZIEGLER ENGINEERING CO. 410 North Court St, P.O. Box 937 Marion, Illinois 62959 Phone - (618)993-6411, Fax - (618)993-6750 RUNWAY 11-29 REHABILITATION, ASSOCIATED EDGE LIGHTS & GUIDANCE SIGN REPLACEMENT
LETTING CONTRACT NUMBER WI057	DEMOLITION         PLAN           Date         6/17/16         DR. By         MKW         CK'D By         WBZ
	Scale <u>1" = 50'</u> Job No. <u>15096</u> Sheet No. <u>7</u> of <u>21</u>

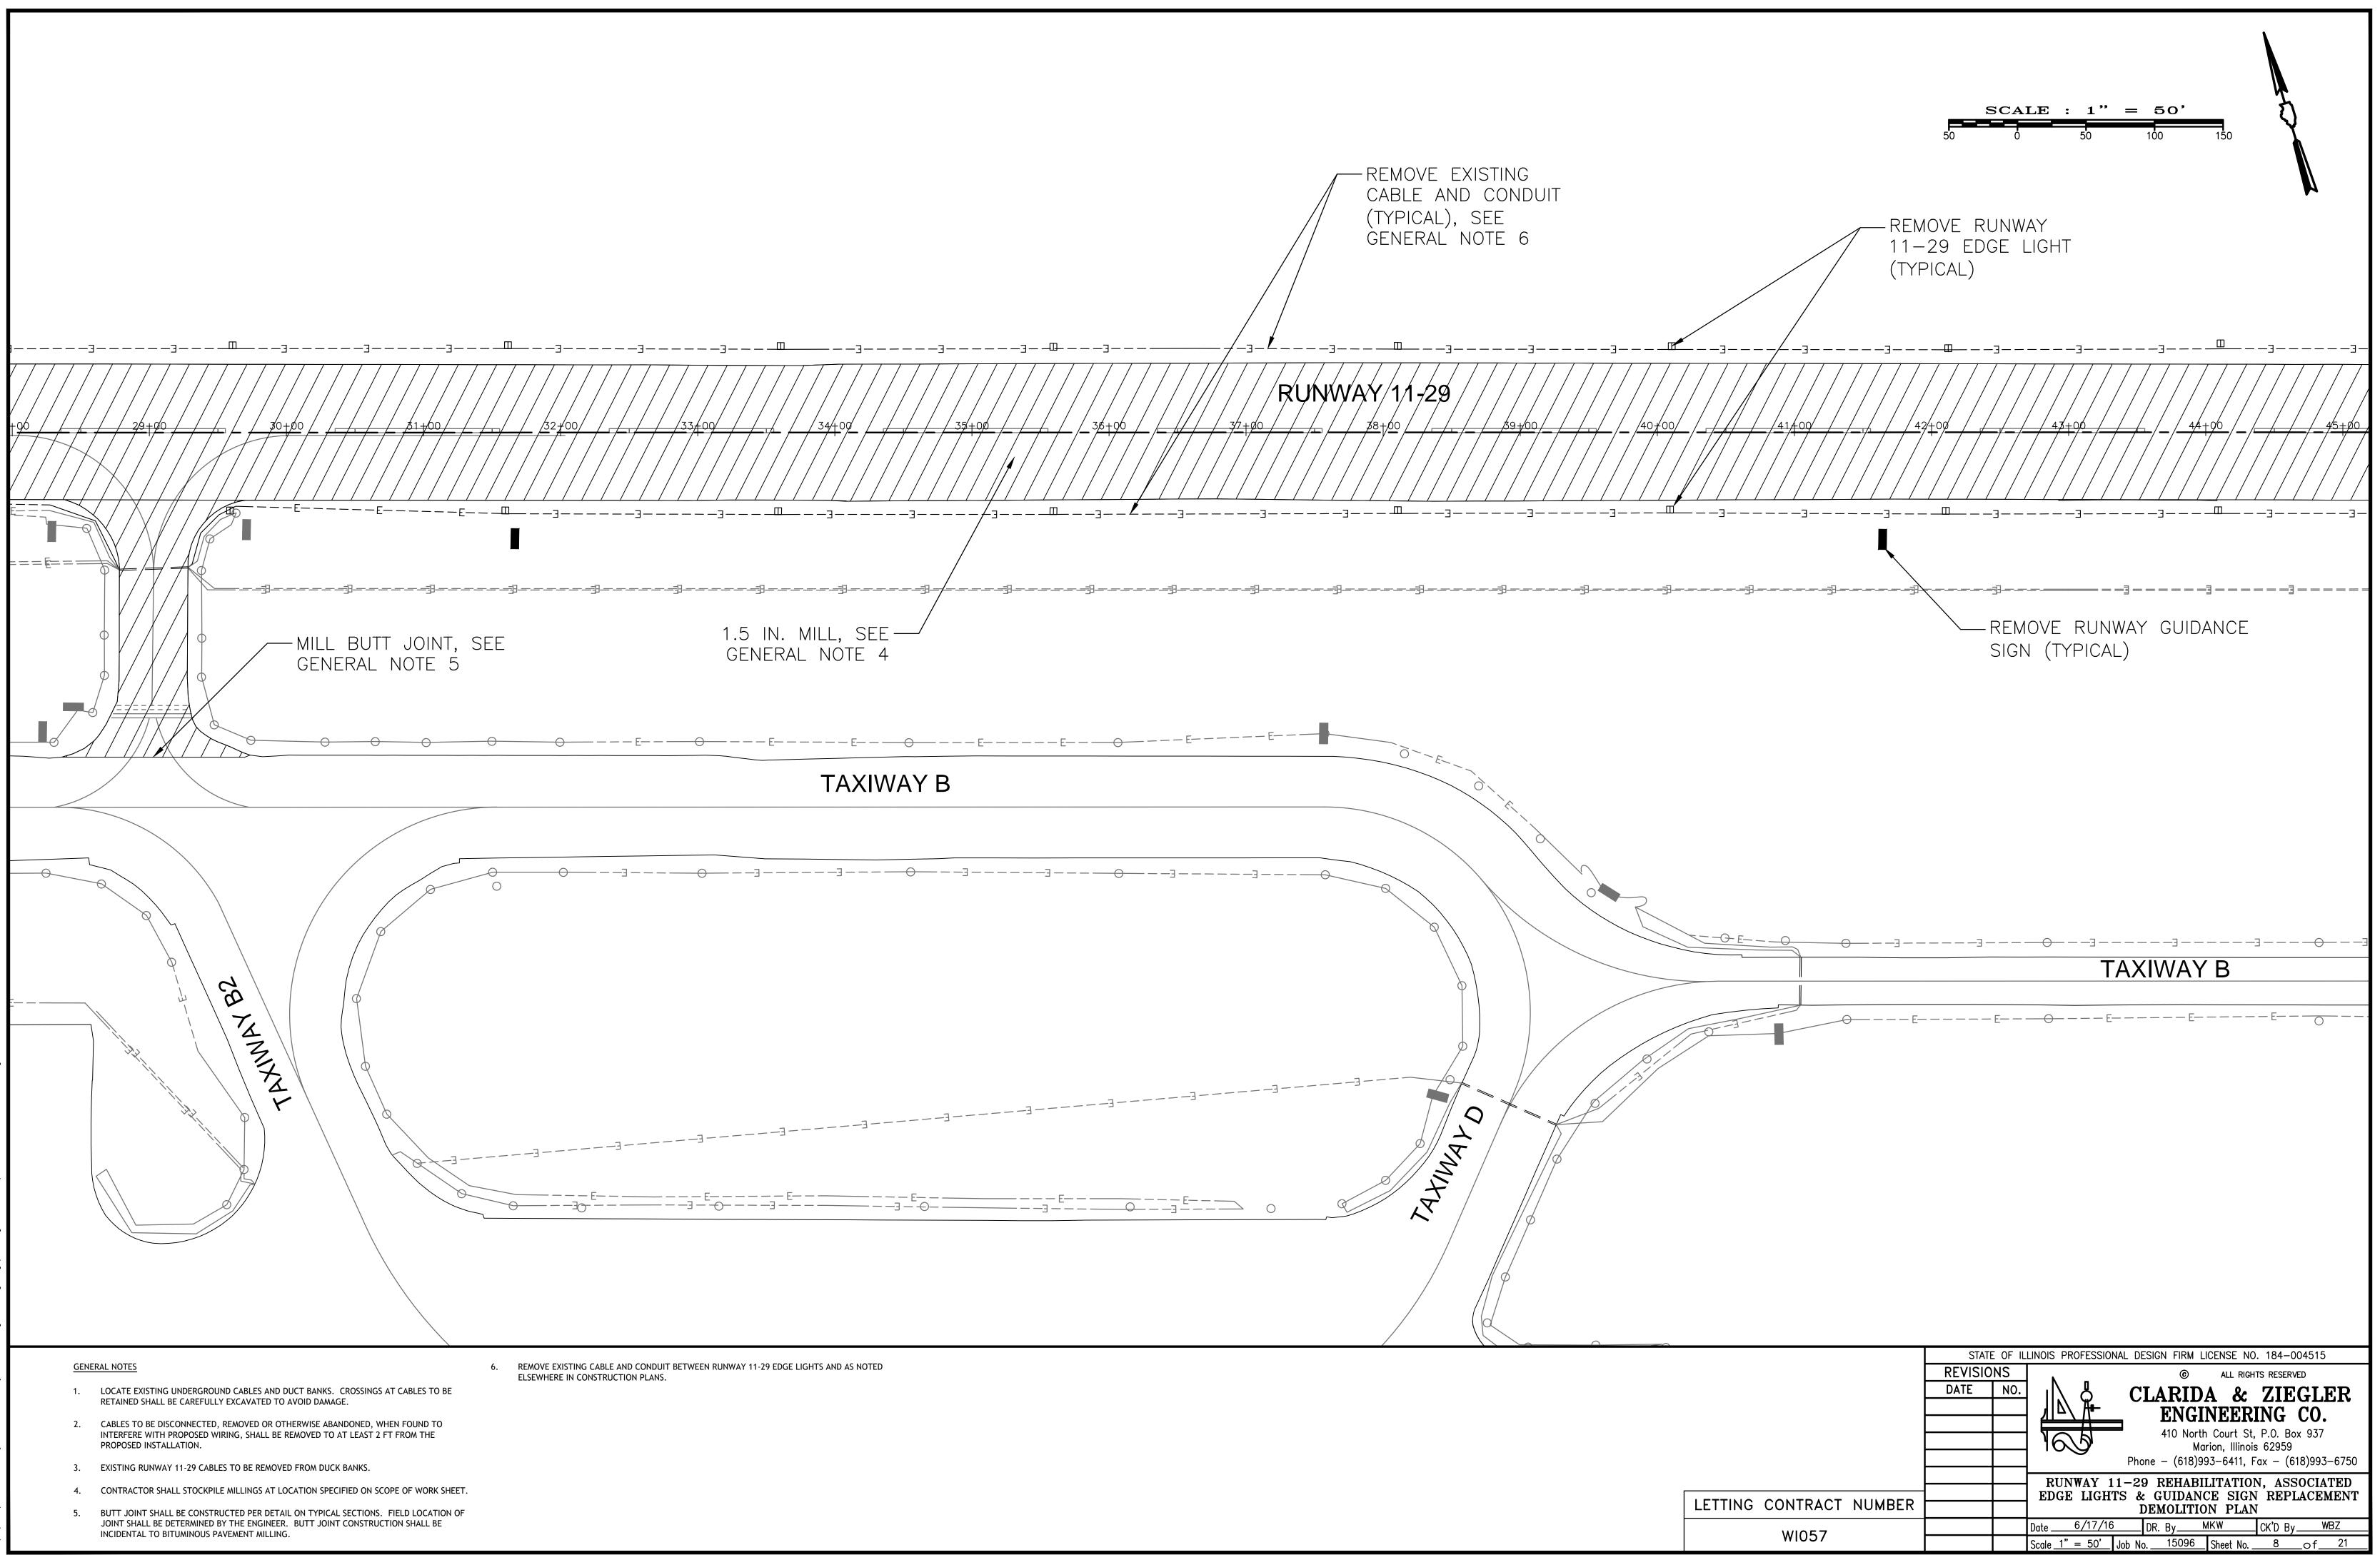


Airport\15096 Runway 11-29 Runway Resurfacing and Lighting\Drawings - Plans\07-09 Demolition Plan.dwg 6-17-16 02:28:11

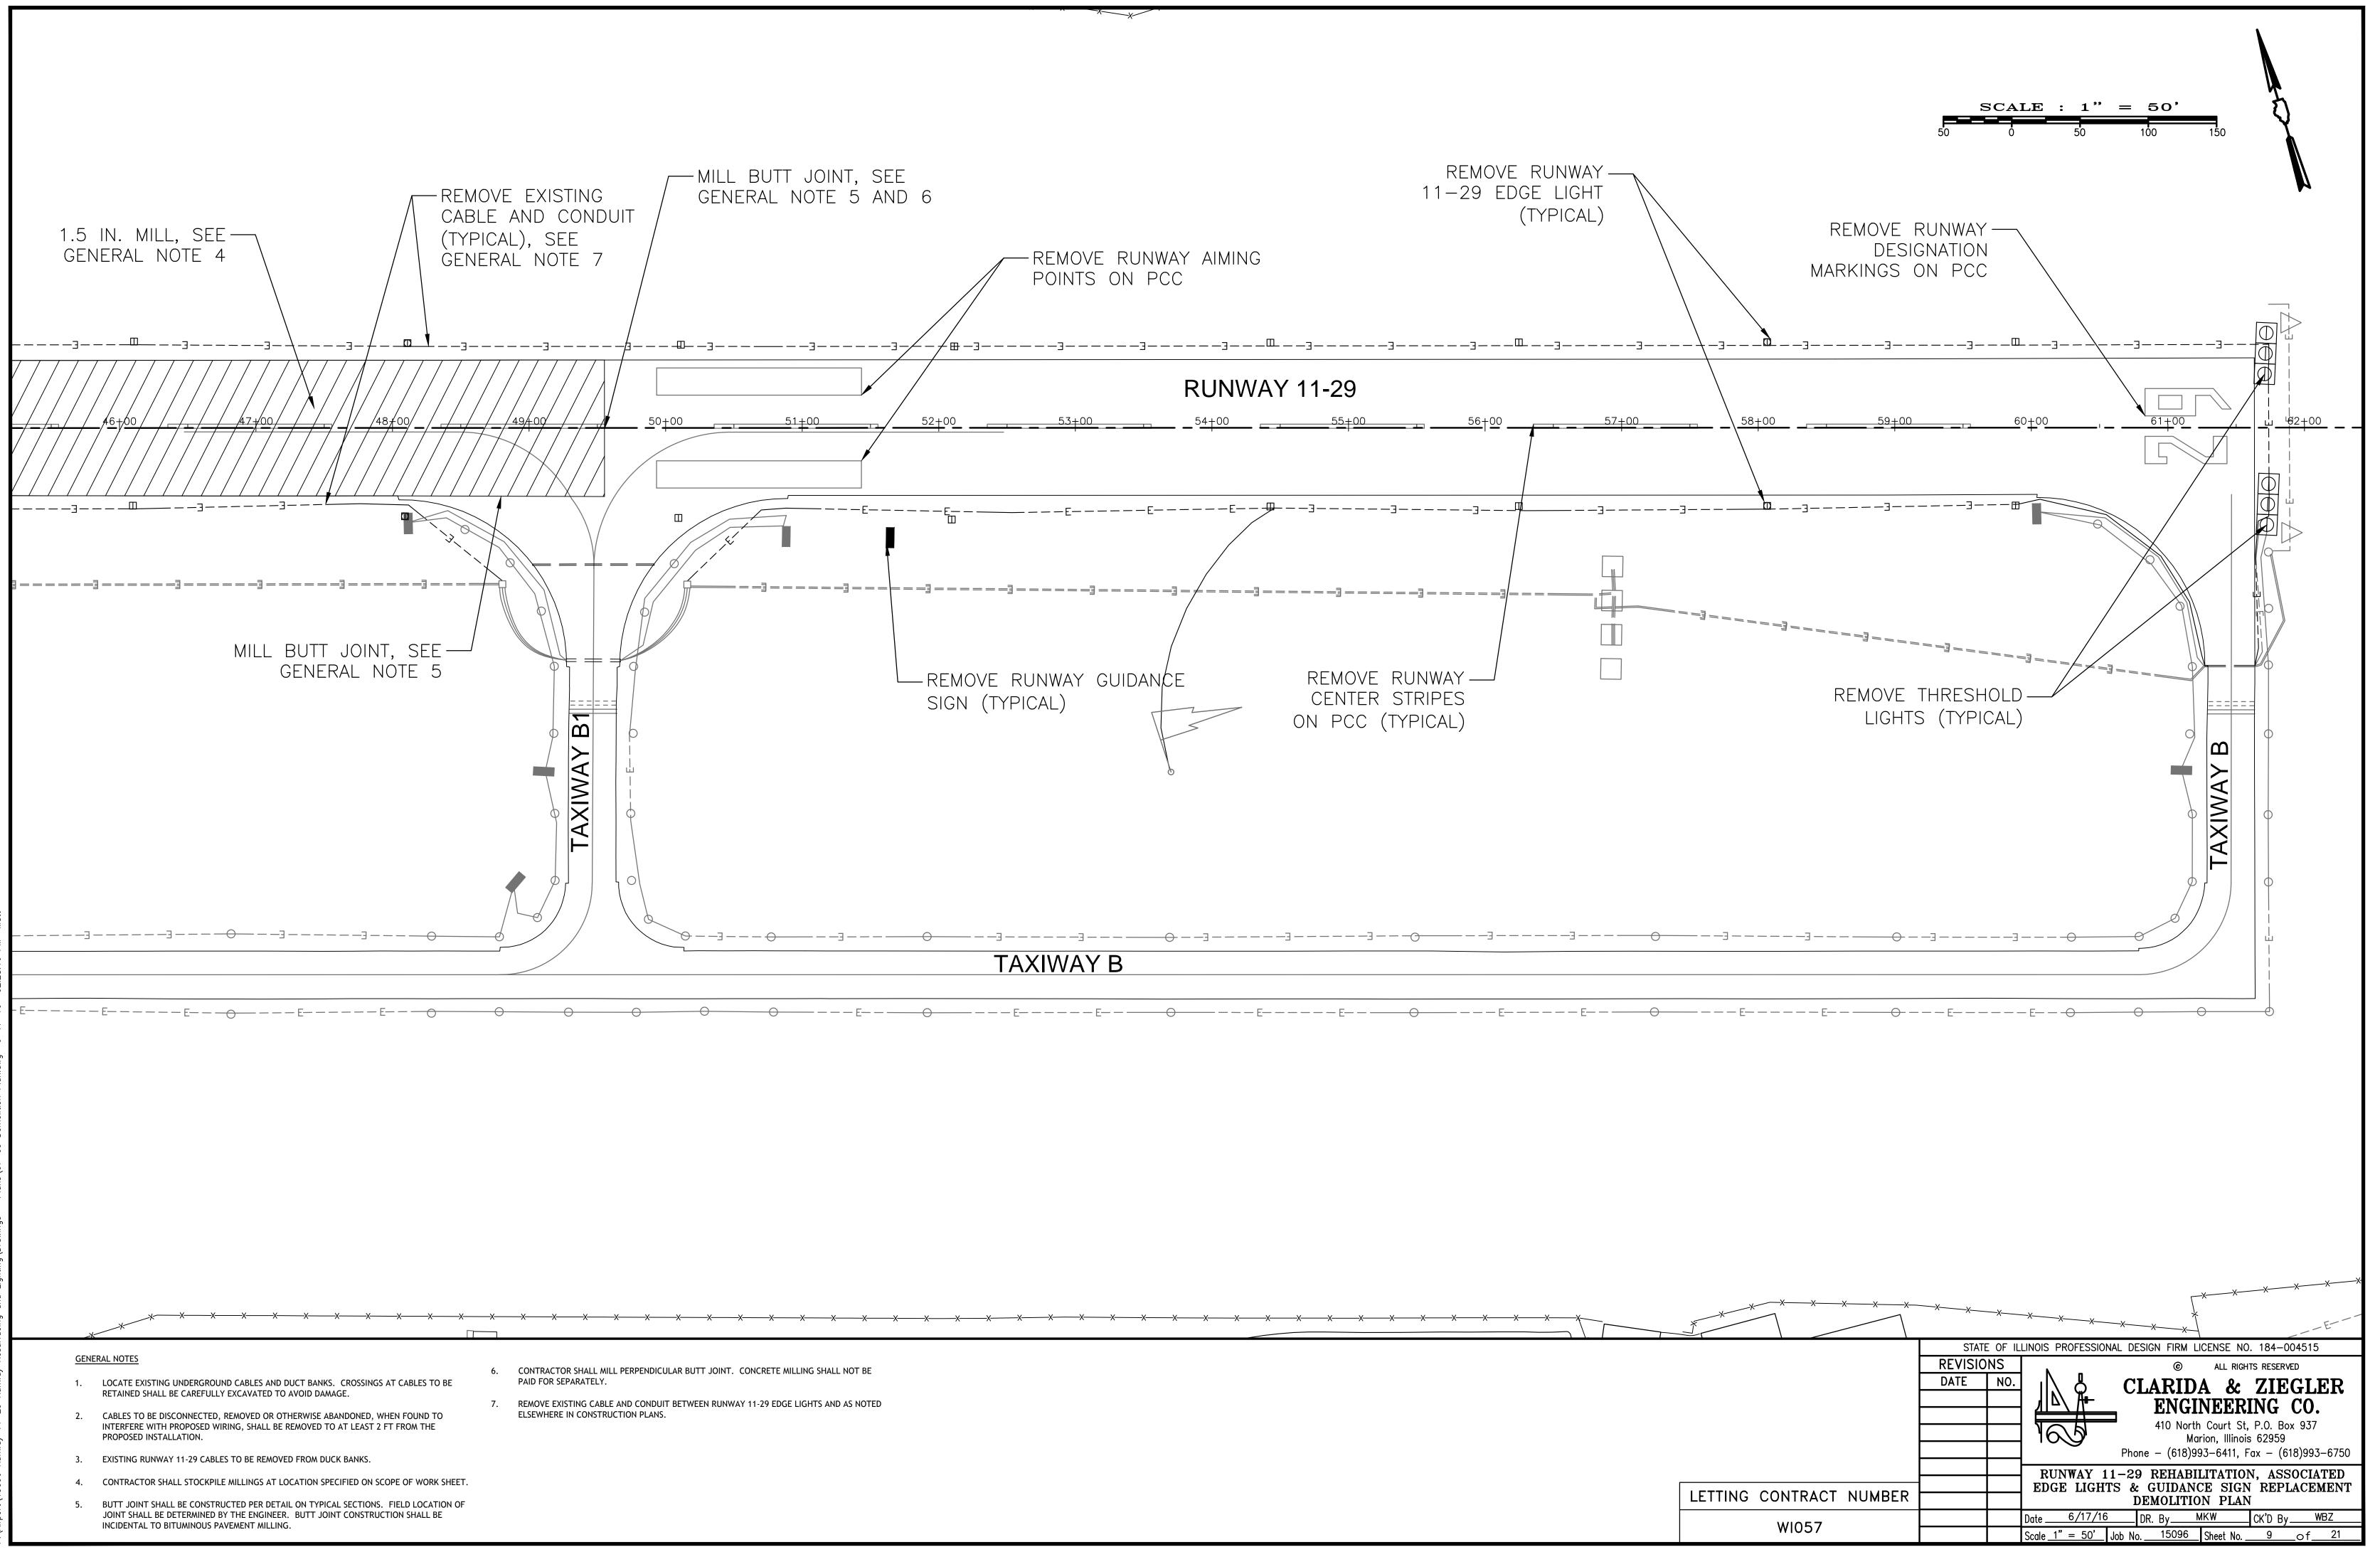

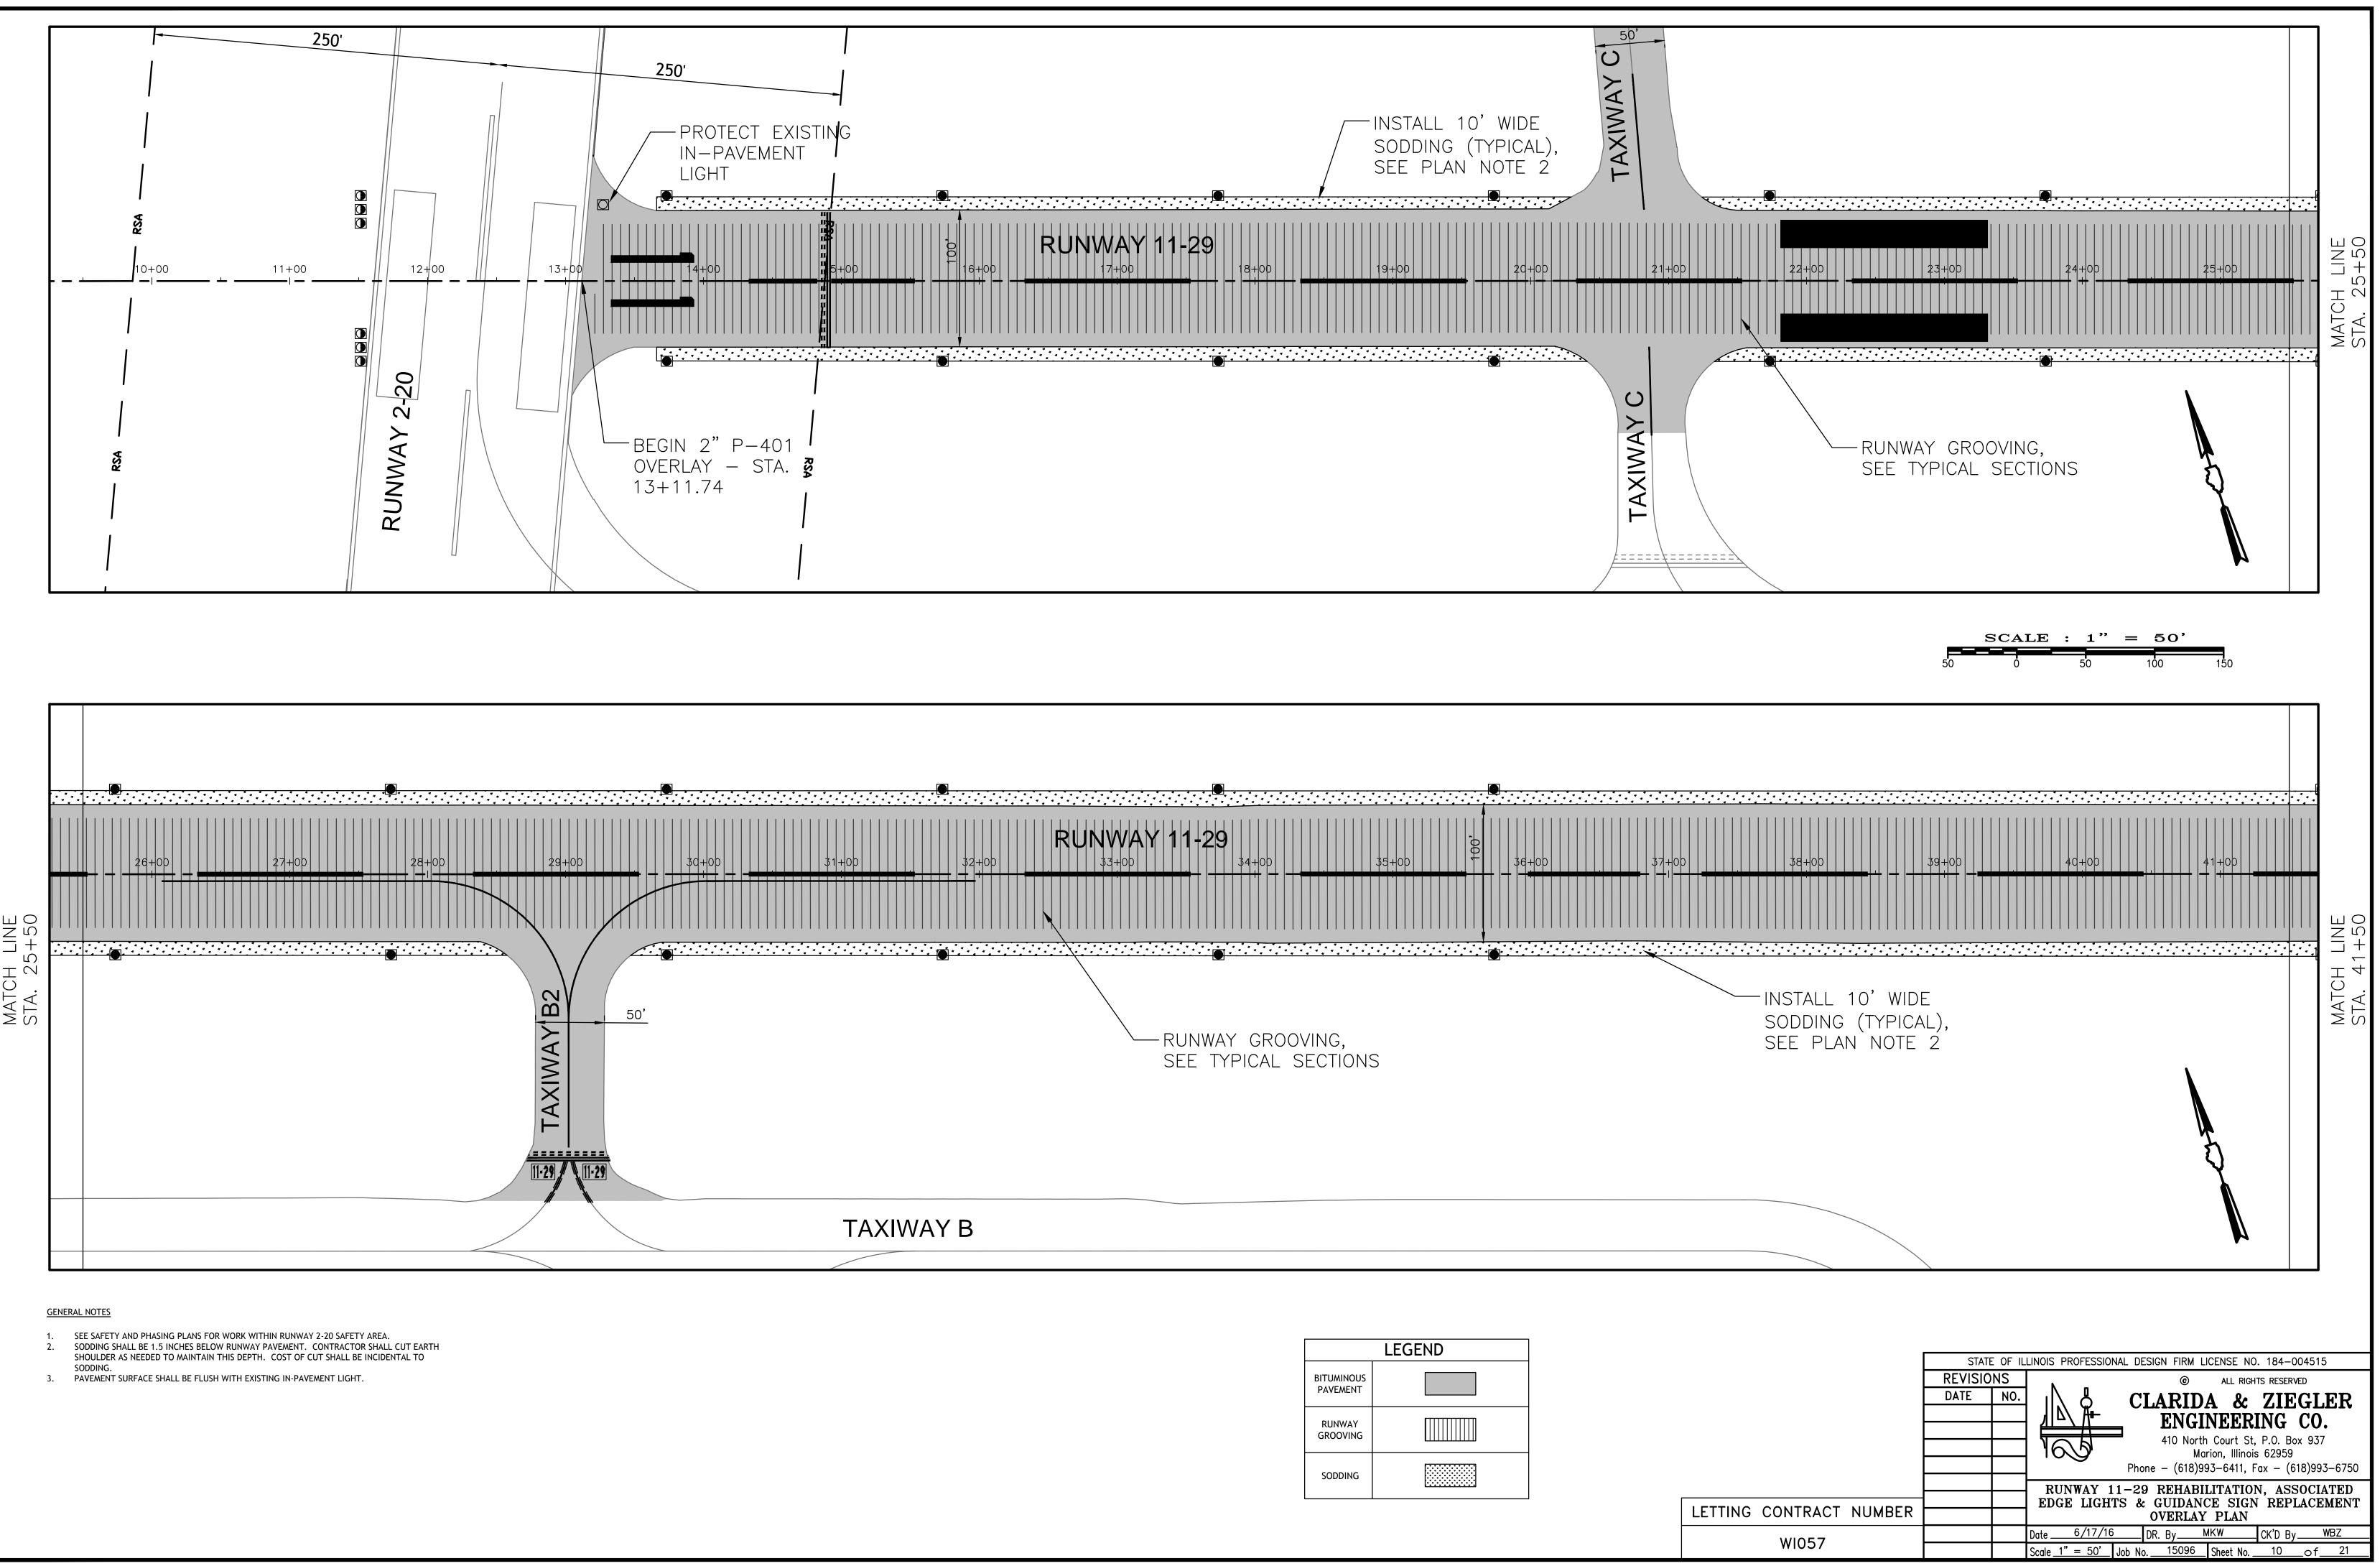


LEGEND		
BITUMINOUS PAVEMENT		
RUNWAY GROOVING		
SODDING		

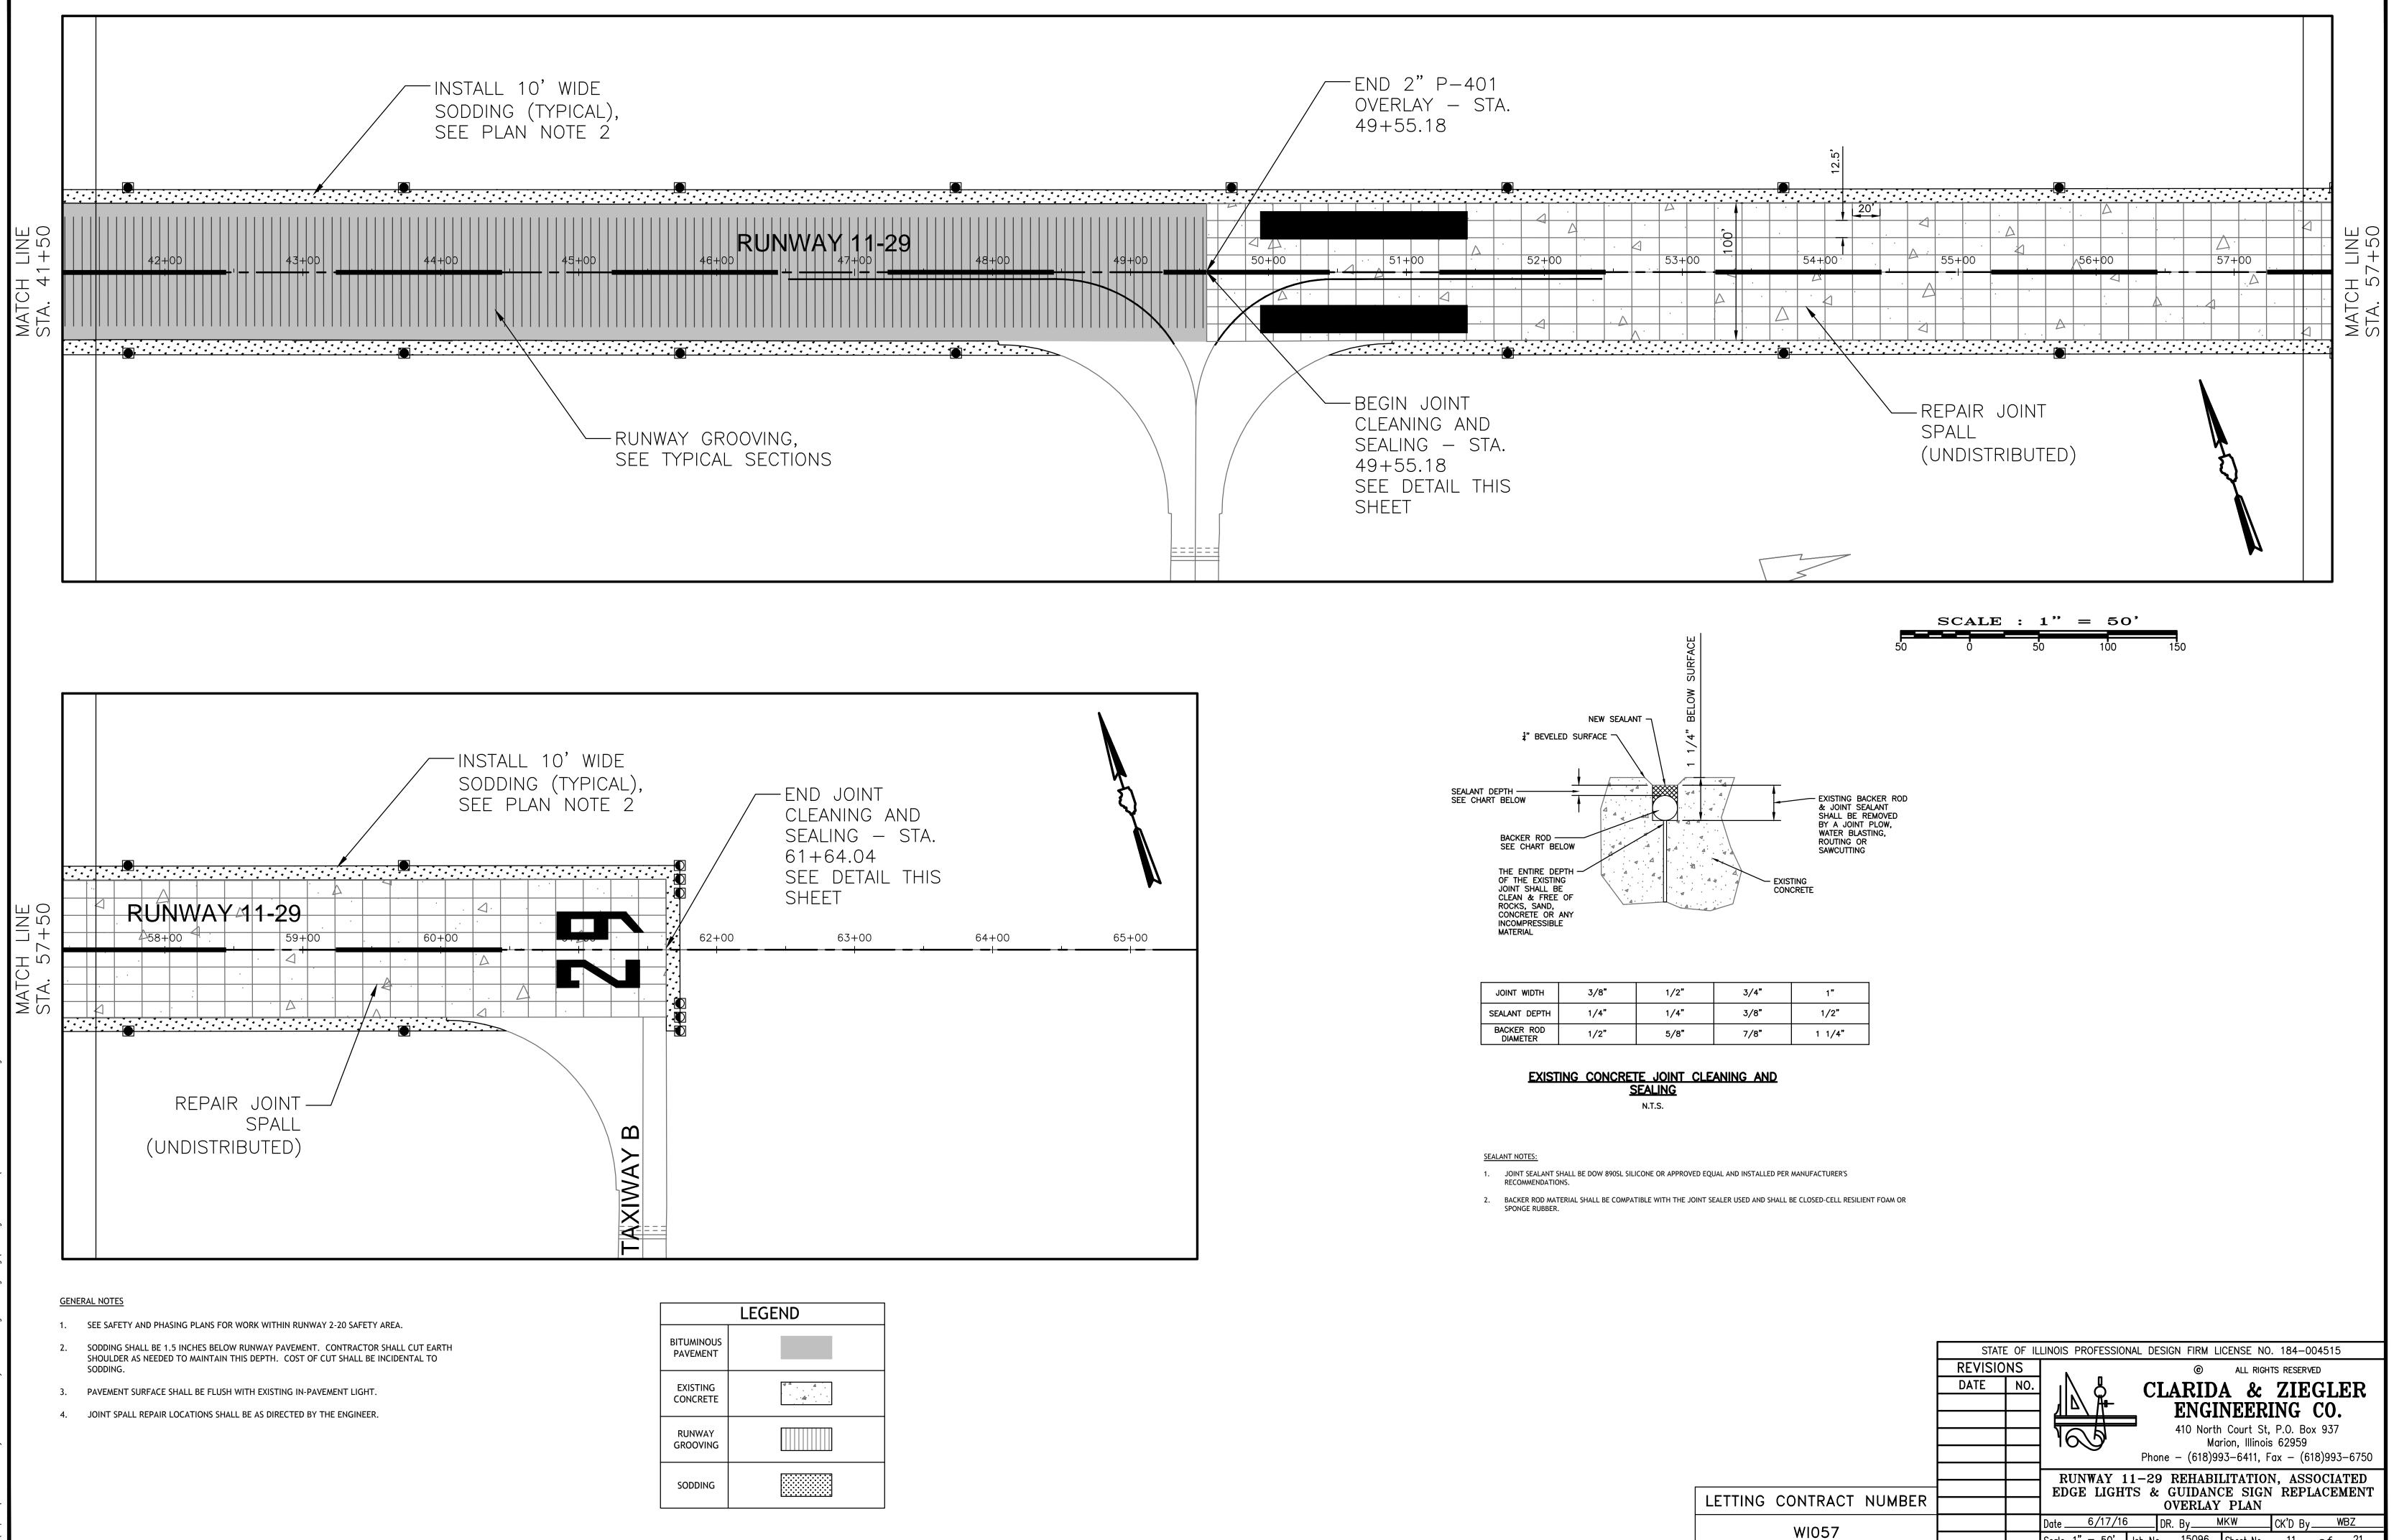

‡" BEVELI	NEW SEALAN	η _
T DEPTH ART BELOW		
BACKER ROD – SEE CHART BE	LOW	
THE ENTIRE DE OF THE EXISTIN JOINT SHALL B CLEAN & FREE ROCKS, SAND, CONCRETE OR INCOMPRESSIBL MATERIAL	IG E OF	a . A  
JOINT WIDTH	3/8"	1
SEALANT DEPTH	1/4"	1

Scale <u>1" = 50'</u> Job No. <u>15096</u> Sheet No. <u>11</u> of <u>21</u>

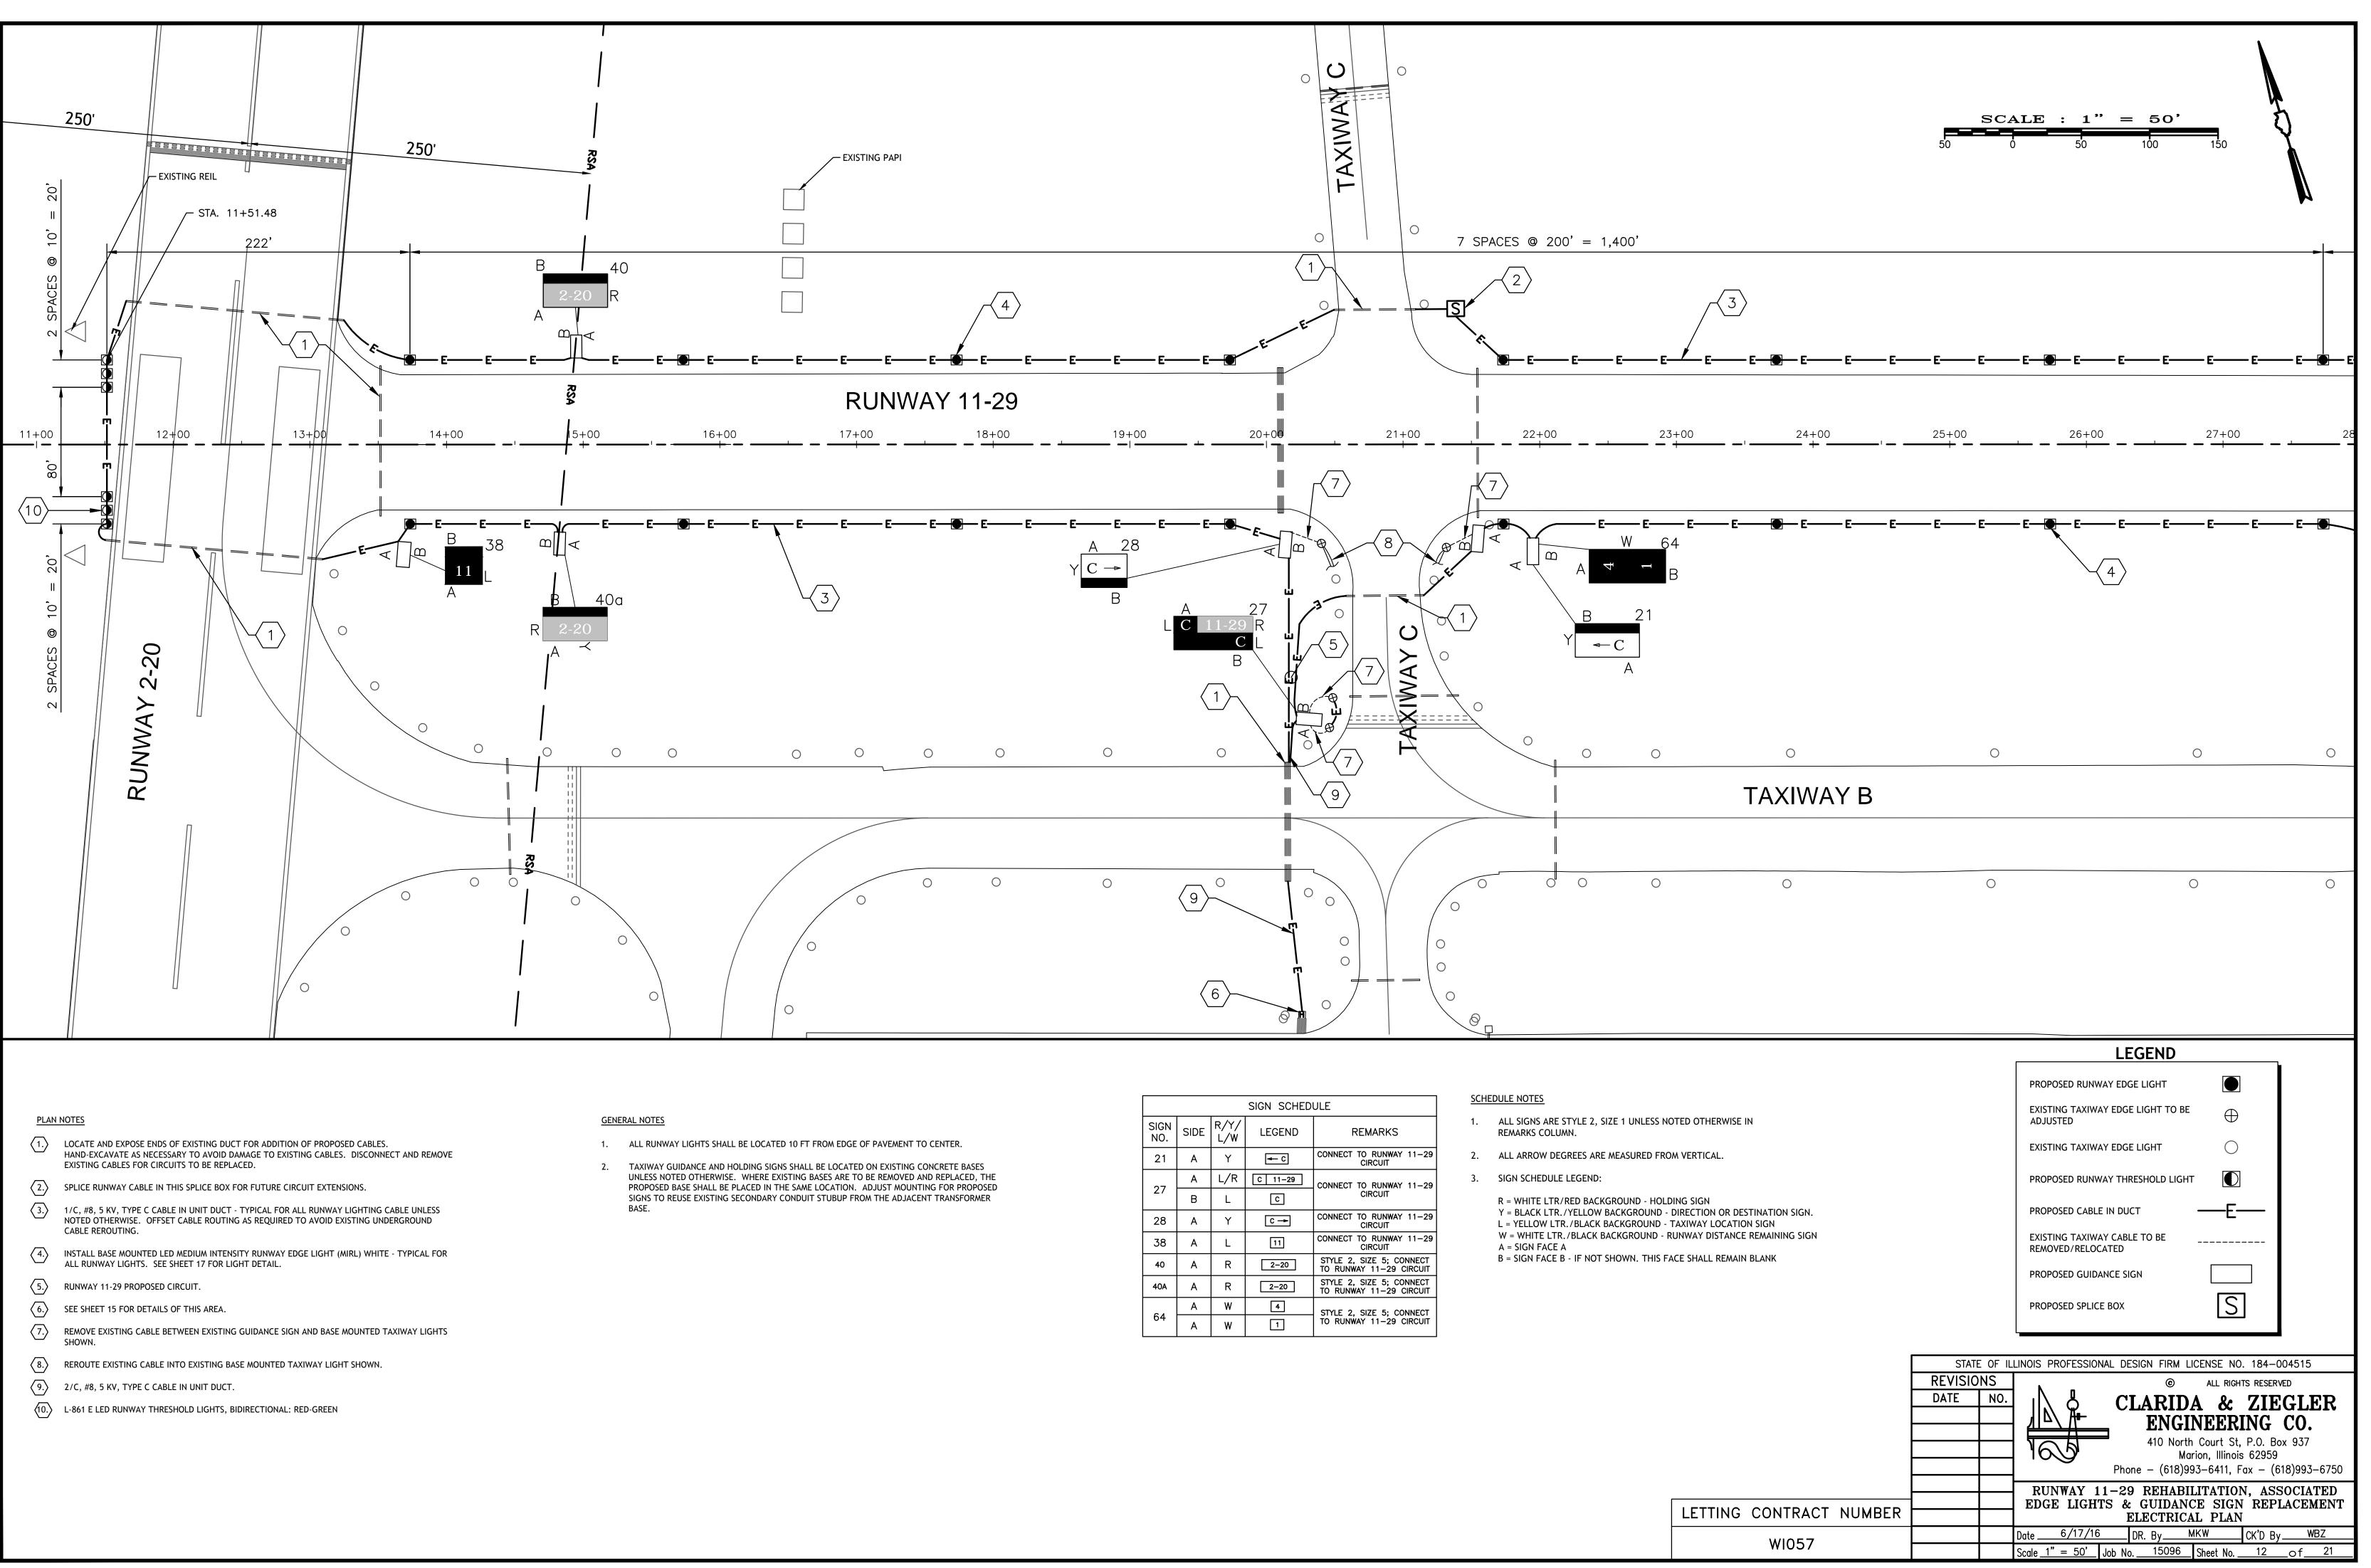


200' SPACING 31+00 32+00 30+00 33+00 29+00 -00 B2 ωN Ш ТАХІМАҮ ОВ 0 0 0 0 0 0  $\left( 5 \right)$ 0 0 0 0 0 0 Ο  $\bigcirc$ 


## PLAN NOTES

- 1. LOCATE AND EXPOSE ENDS OF EXISTING DUCT FOR ADDITION OF PROPOSED CABLES. HAND-EXCAVATE AS NECESSARY TO AVOID DAMAGE TO EXISTING CABLES. DISCONNECT AND REMOVE EXISTING CABLES FOR CIRCUITS TO BE REPLACED.
- $\langle 2. \rangle$  REMOVE AND REPLACE EXISTING CONCRETE FOUNDATION FOR THIS TAXI GUIDANCE SIGN ENTIRELY.
- 3.> 1/C, #8, 5 KV, TYPE C CABLE IN UNIT DUCT TYPICAL FOR ALL RUNWAY LIGHTING CABLE UNLESS NOTED OTHERWISE. OFFSET CABLE ROUTING AS REQUIRED TO AVOID EXISTING UNDERGROUND CABLE ROUTINGS.
- 4. INSTALL BASE MOUNTED LED MEDIUM INTENSITY RUNWAY EDGE LIGHT (MIRL) WHITE TYPICAL FOR ALL RUNWAY LIGHTS. SEE SHEET 17 FOR LIGHT DETAIL.
- 5. REMOVE EXISTING CABLE BETWEEN EXISTING GUIDANCE SIGN AND BASE MOUNTED TAXIWAY.
- $\langle 6. \rangle$  REROUTE EXISTING CABLE INTO EXISTING BASE MOUNTED TAXIWAY LIGHT SHOWN.


## GENERAL NOTES

- 1. ALL RUNWAY LIGHTS SHALL BE LOCATED 10 FT FROM EDGE OF PAVEMENT TO CENTER.
- TAXIWAY GUIDANCE AND HOLDING SIGNS SHALL BE LOCATED ON EXISTING CONCRETE BASES 2. UNLESS NOTED OTHERWISE. WHERE EXISTING BASES ARE TO BE REMOVED AND REPLACED, THE PROPOSED BASE SHALL BE PLACED IN THE SAME LOCATION. ADJUST MOUNTING FOR PROPOSED SIGNS TO REUSE EXISTING SECONDARY CONDUIT STUBUP FROM THE ADJACENT TRANSFORMER BASE.

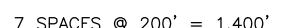

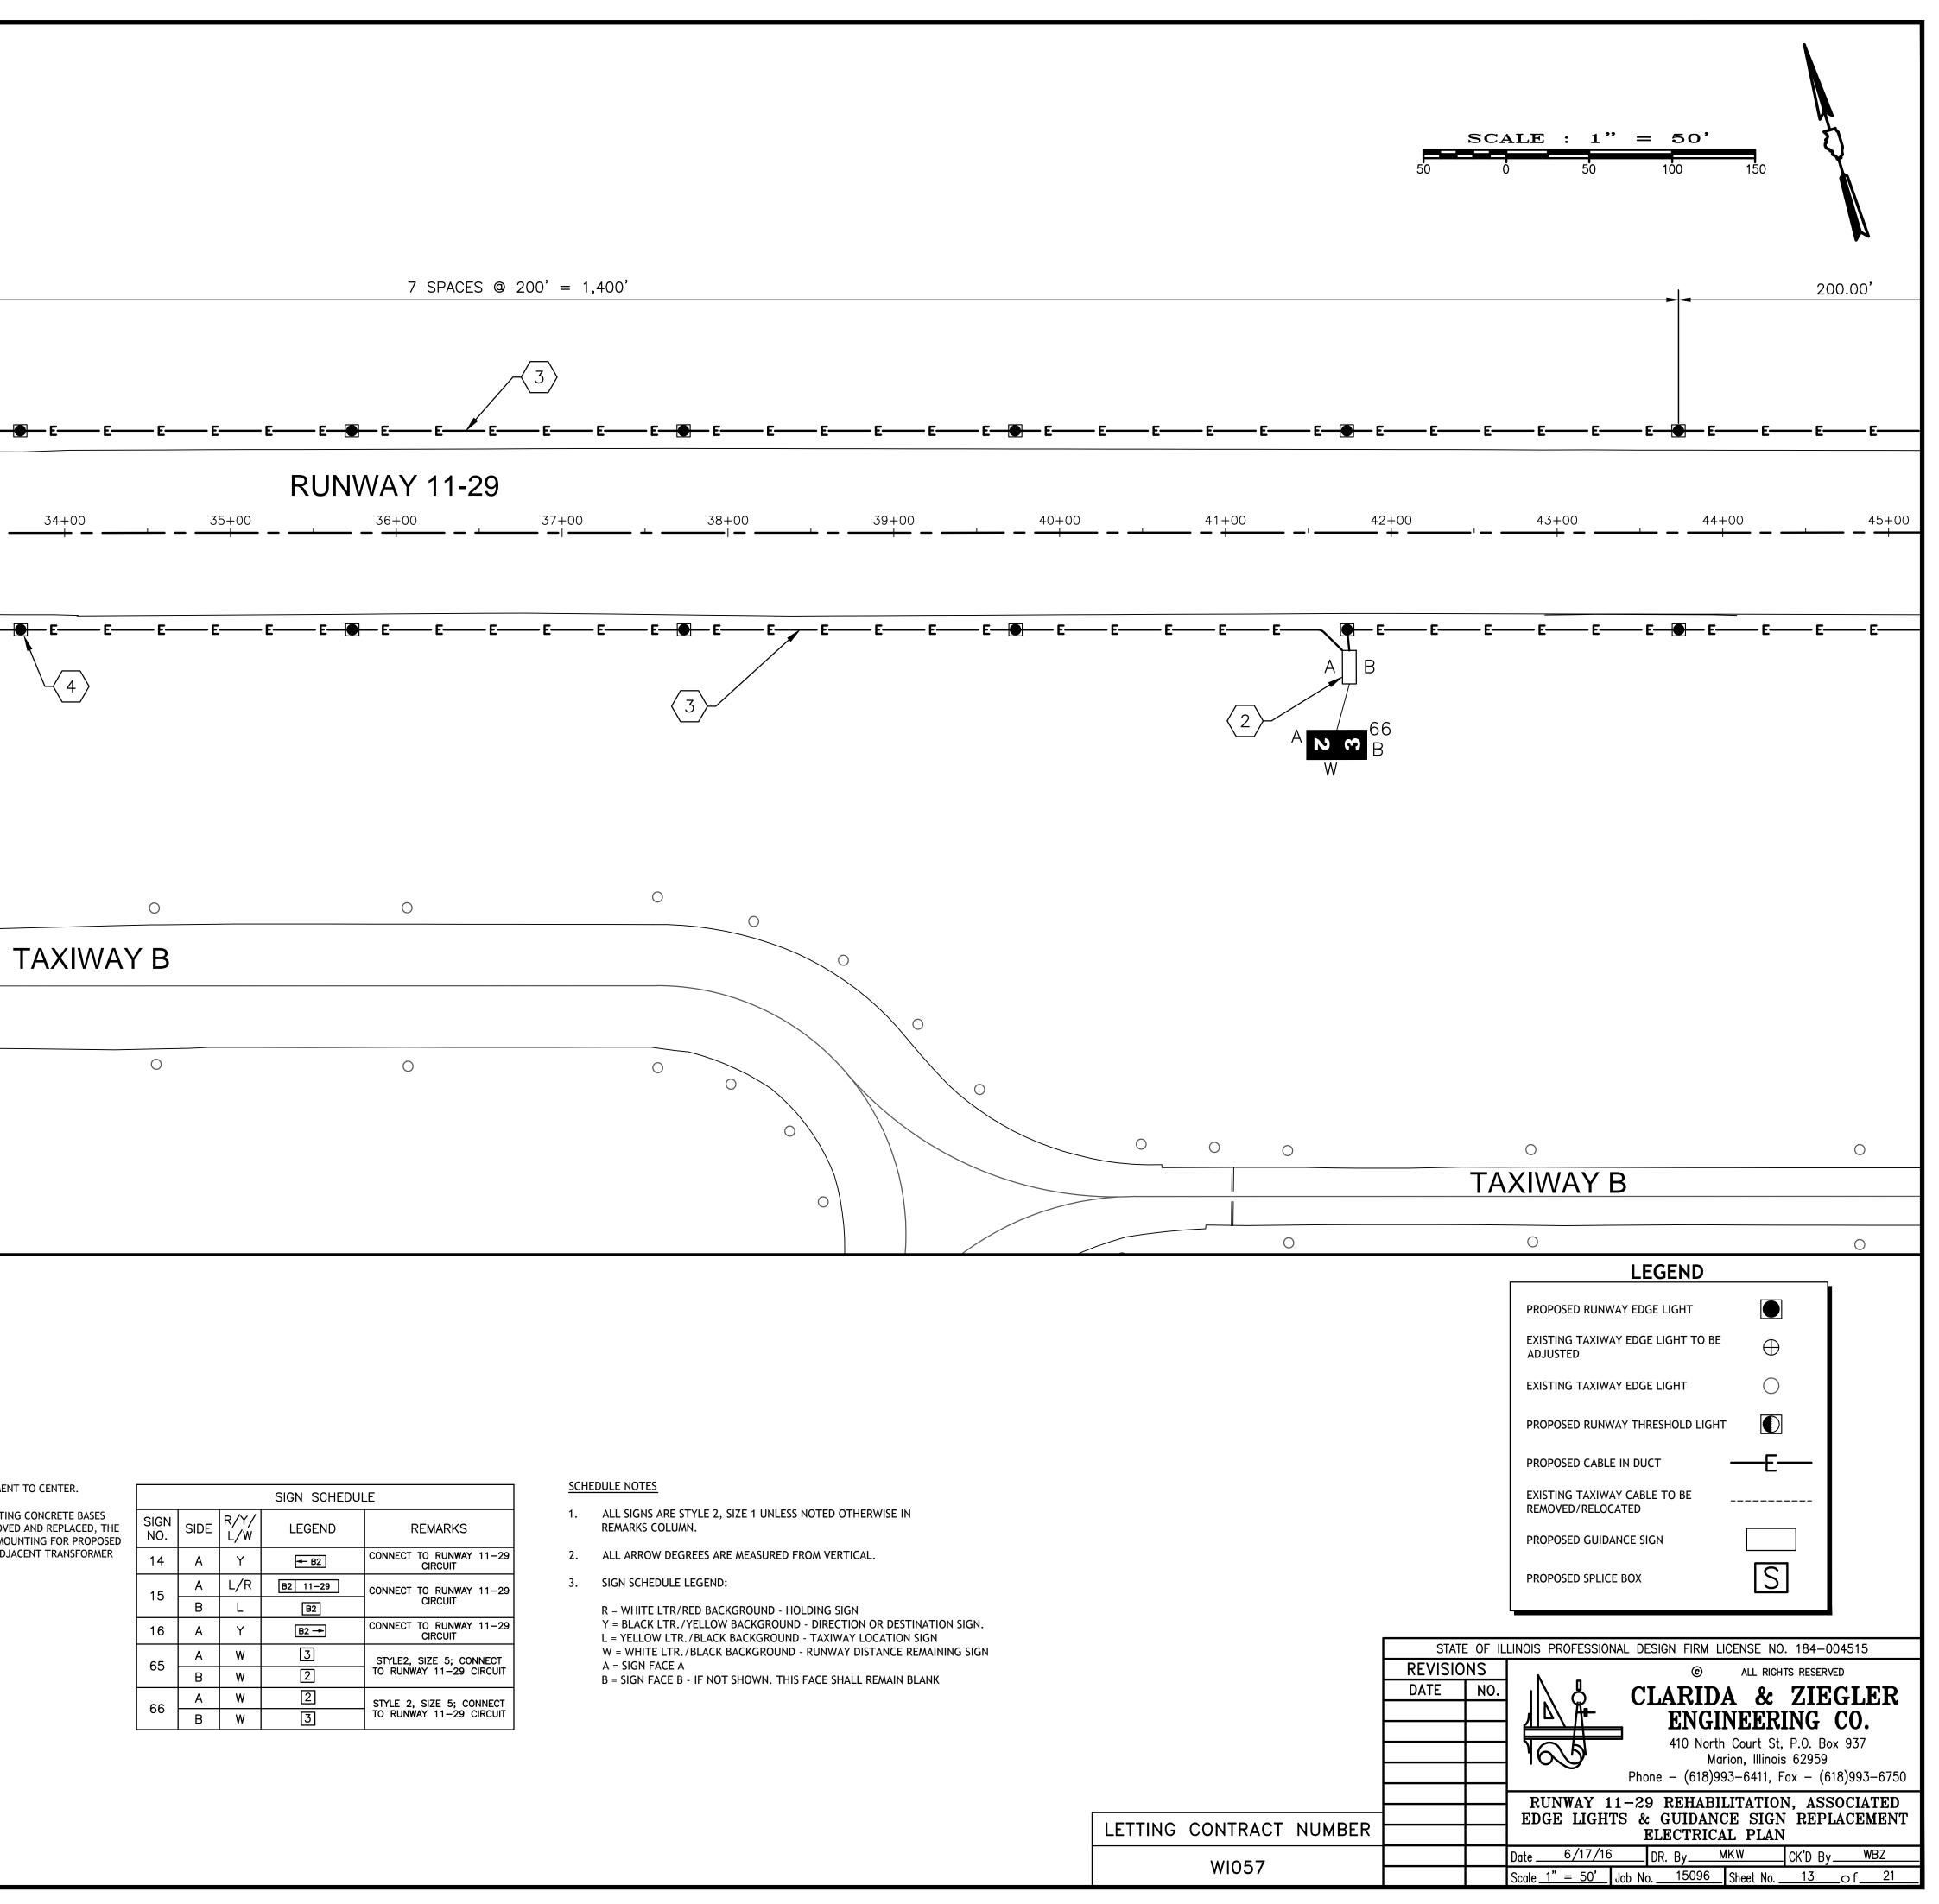


	SIGN SCHEDULE				
SIGN NO.	SIDE	R/Y/ L/W	LEGEND	REMARKS	
14	А	Y	<del>≪</del> B2	CONNECT TO RUNWAY 11-29 CIRCUIT	
15	А	L/R	B2 11-29	CONNECT TO RUNWAY 11-29	
15	В	L	B2	CIRCUIT	
16	А	Y	B2 ->	CONNECT TO RUNWAY 11-29 CIRCUIT	
65	А	W	3	STYLE2, SIZE 5; CONNECT	
05	В	W	2	TO RUNWAY 11-29 CIRCUI	
66	А	W	2	STYLE 2, SIZE 5; CONNECT	
00	В	W	3	TO RUNWAY 11-29 CIRCUIT	

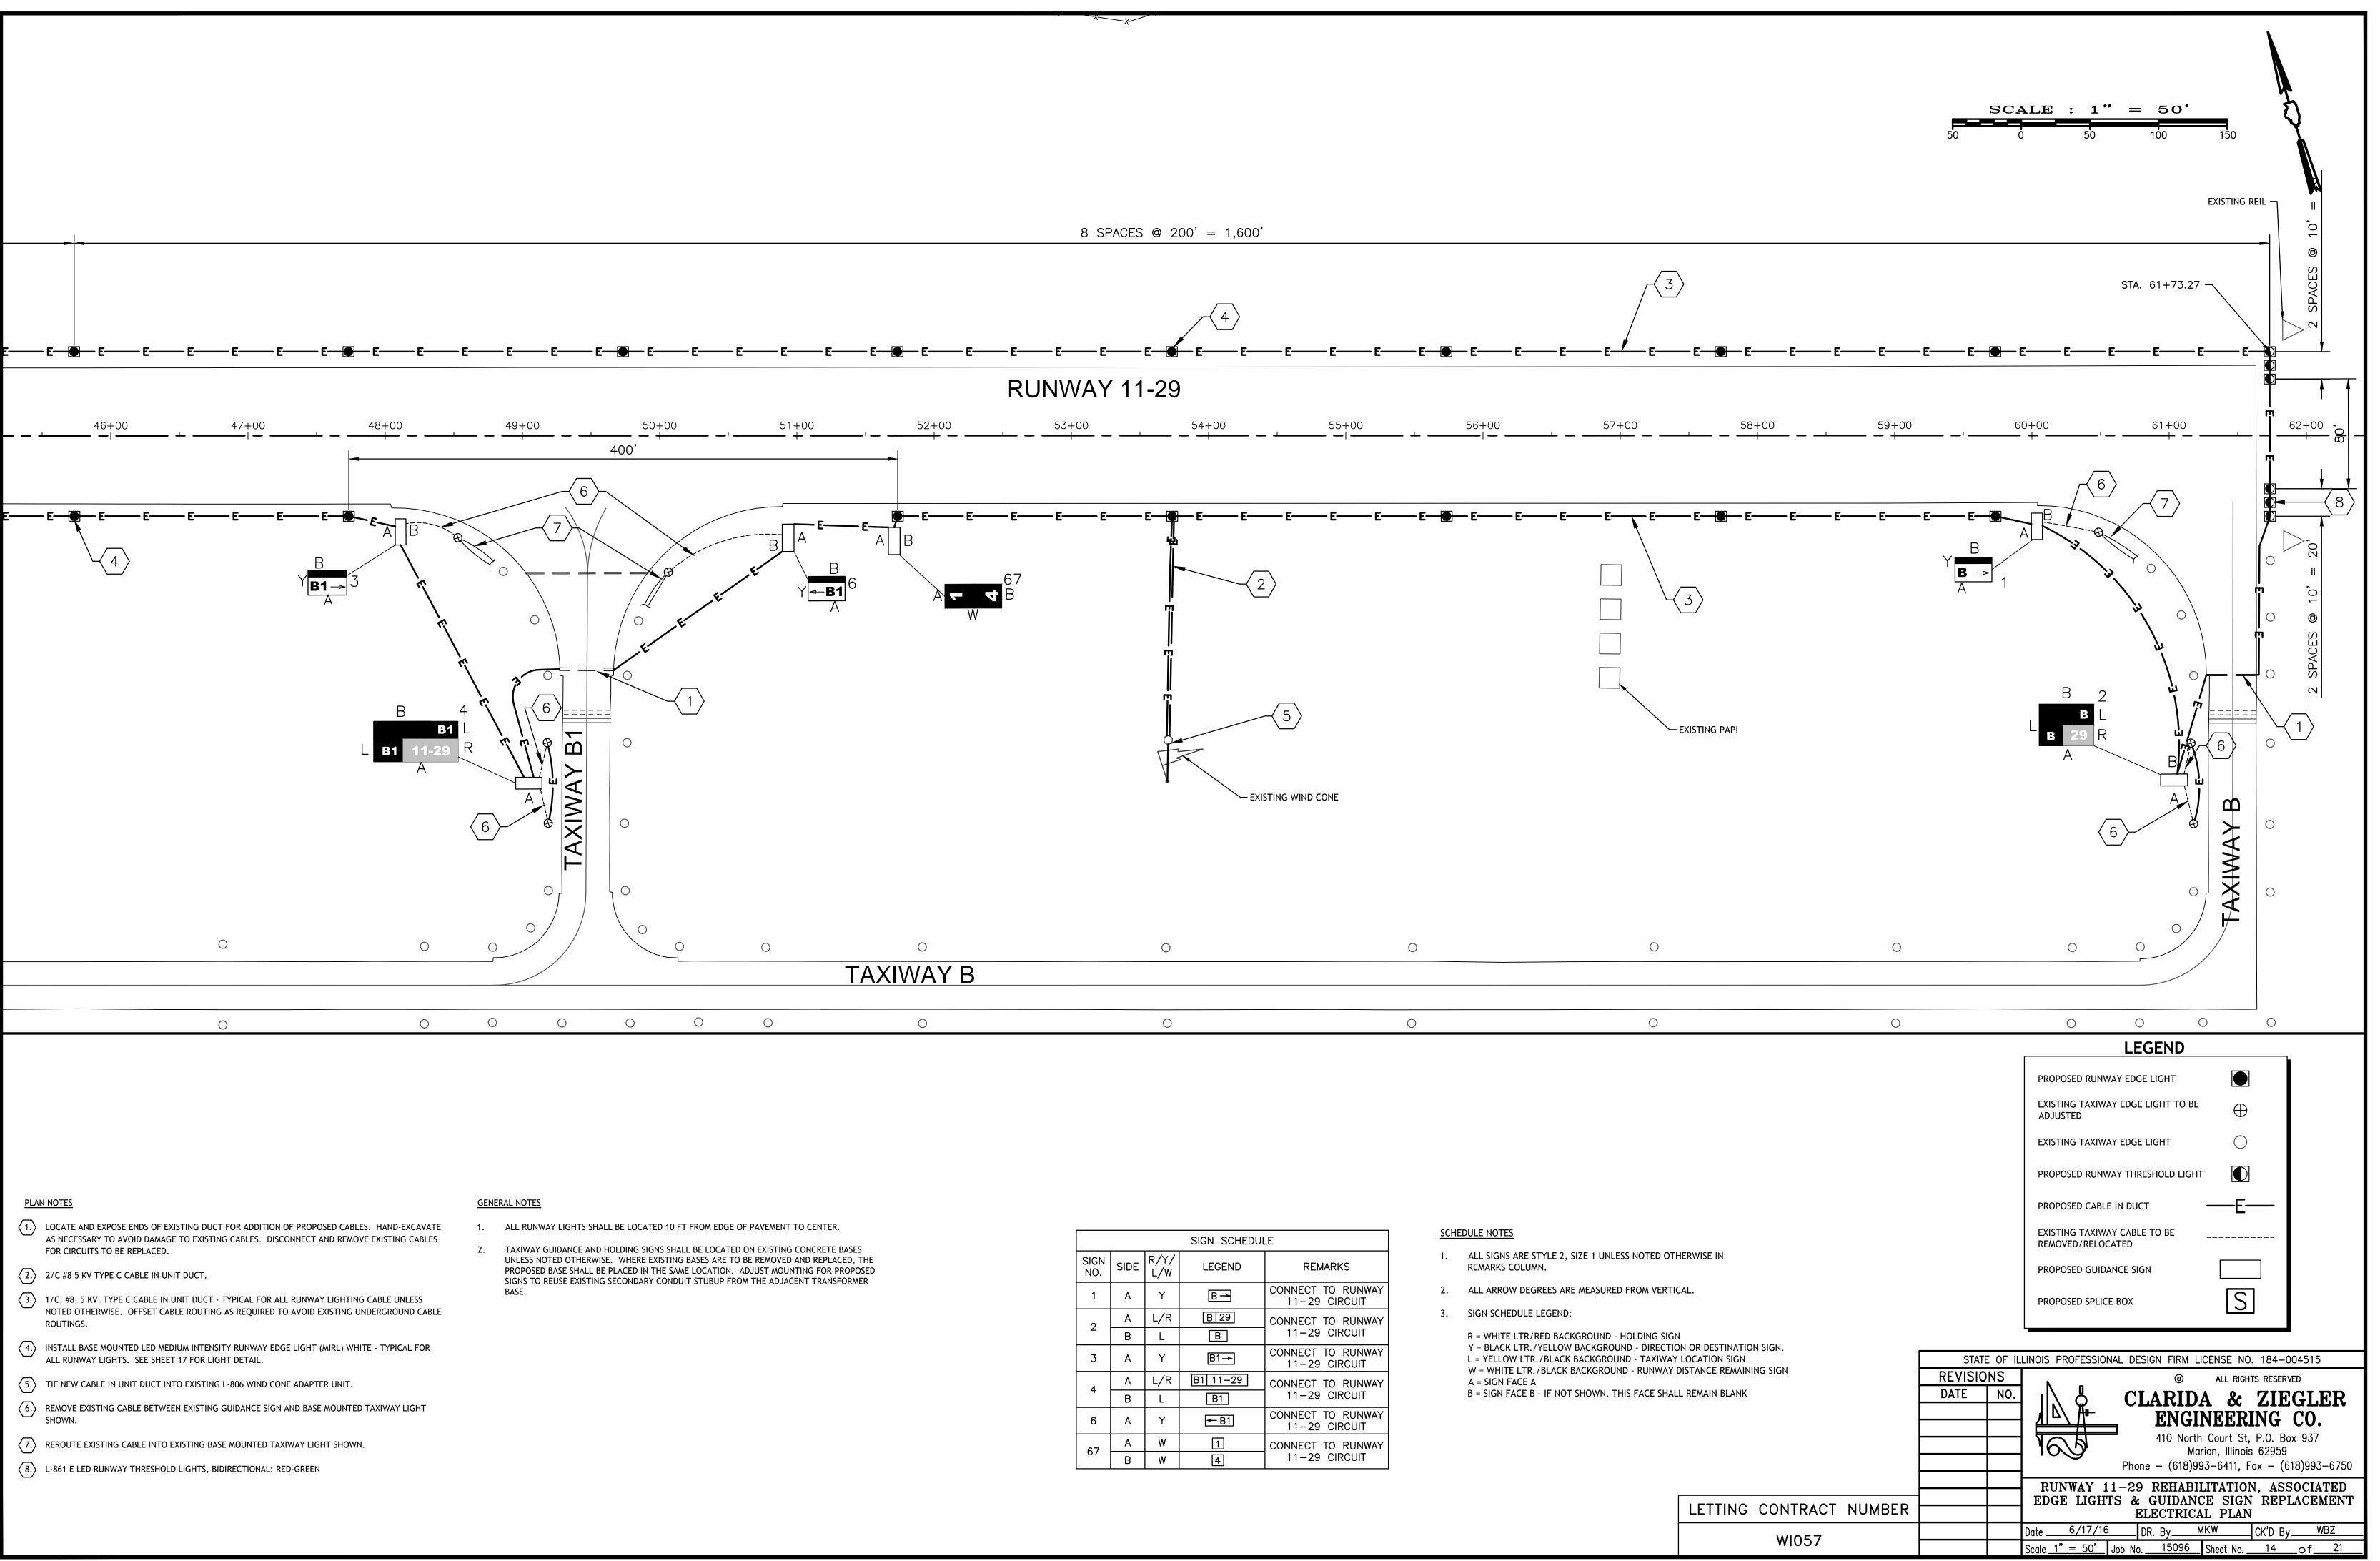


	NOTE
PLAN	NUTE

SIGN SCHEDULE								
SIGN NO.	SIDE	R/Y/ L/W	LEGEND	REMARKS				
1	A	Y	B→	CONNECT TO RUNWA 11-29 CIRCUIT				
2	A	L/R	B 29	CONNECT TO RUNWA				
Ζ	В	L	В	11-29 CIRCUIT				
3	A	Y	B1-→	CONNECT TO RUNWAY 11-29 CIRCUIT				
4	A	L/R	B1 11-29	CONNECT TO RUNWA 11–29 CIRCUIT				
+	В	L	B1					
6	А	Y	<b>←</b> B1	CONNECT TO RUNWAY 11-29 CIRCUIT				
67	А	W	1	CONNECT TO RUNWAY				
	В	W	4	11-29 CIRCUIT				

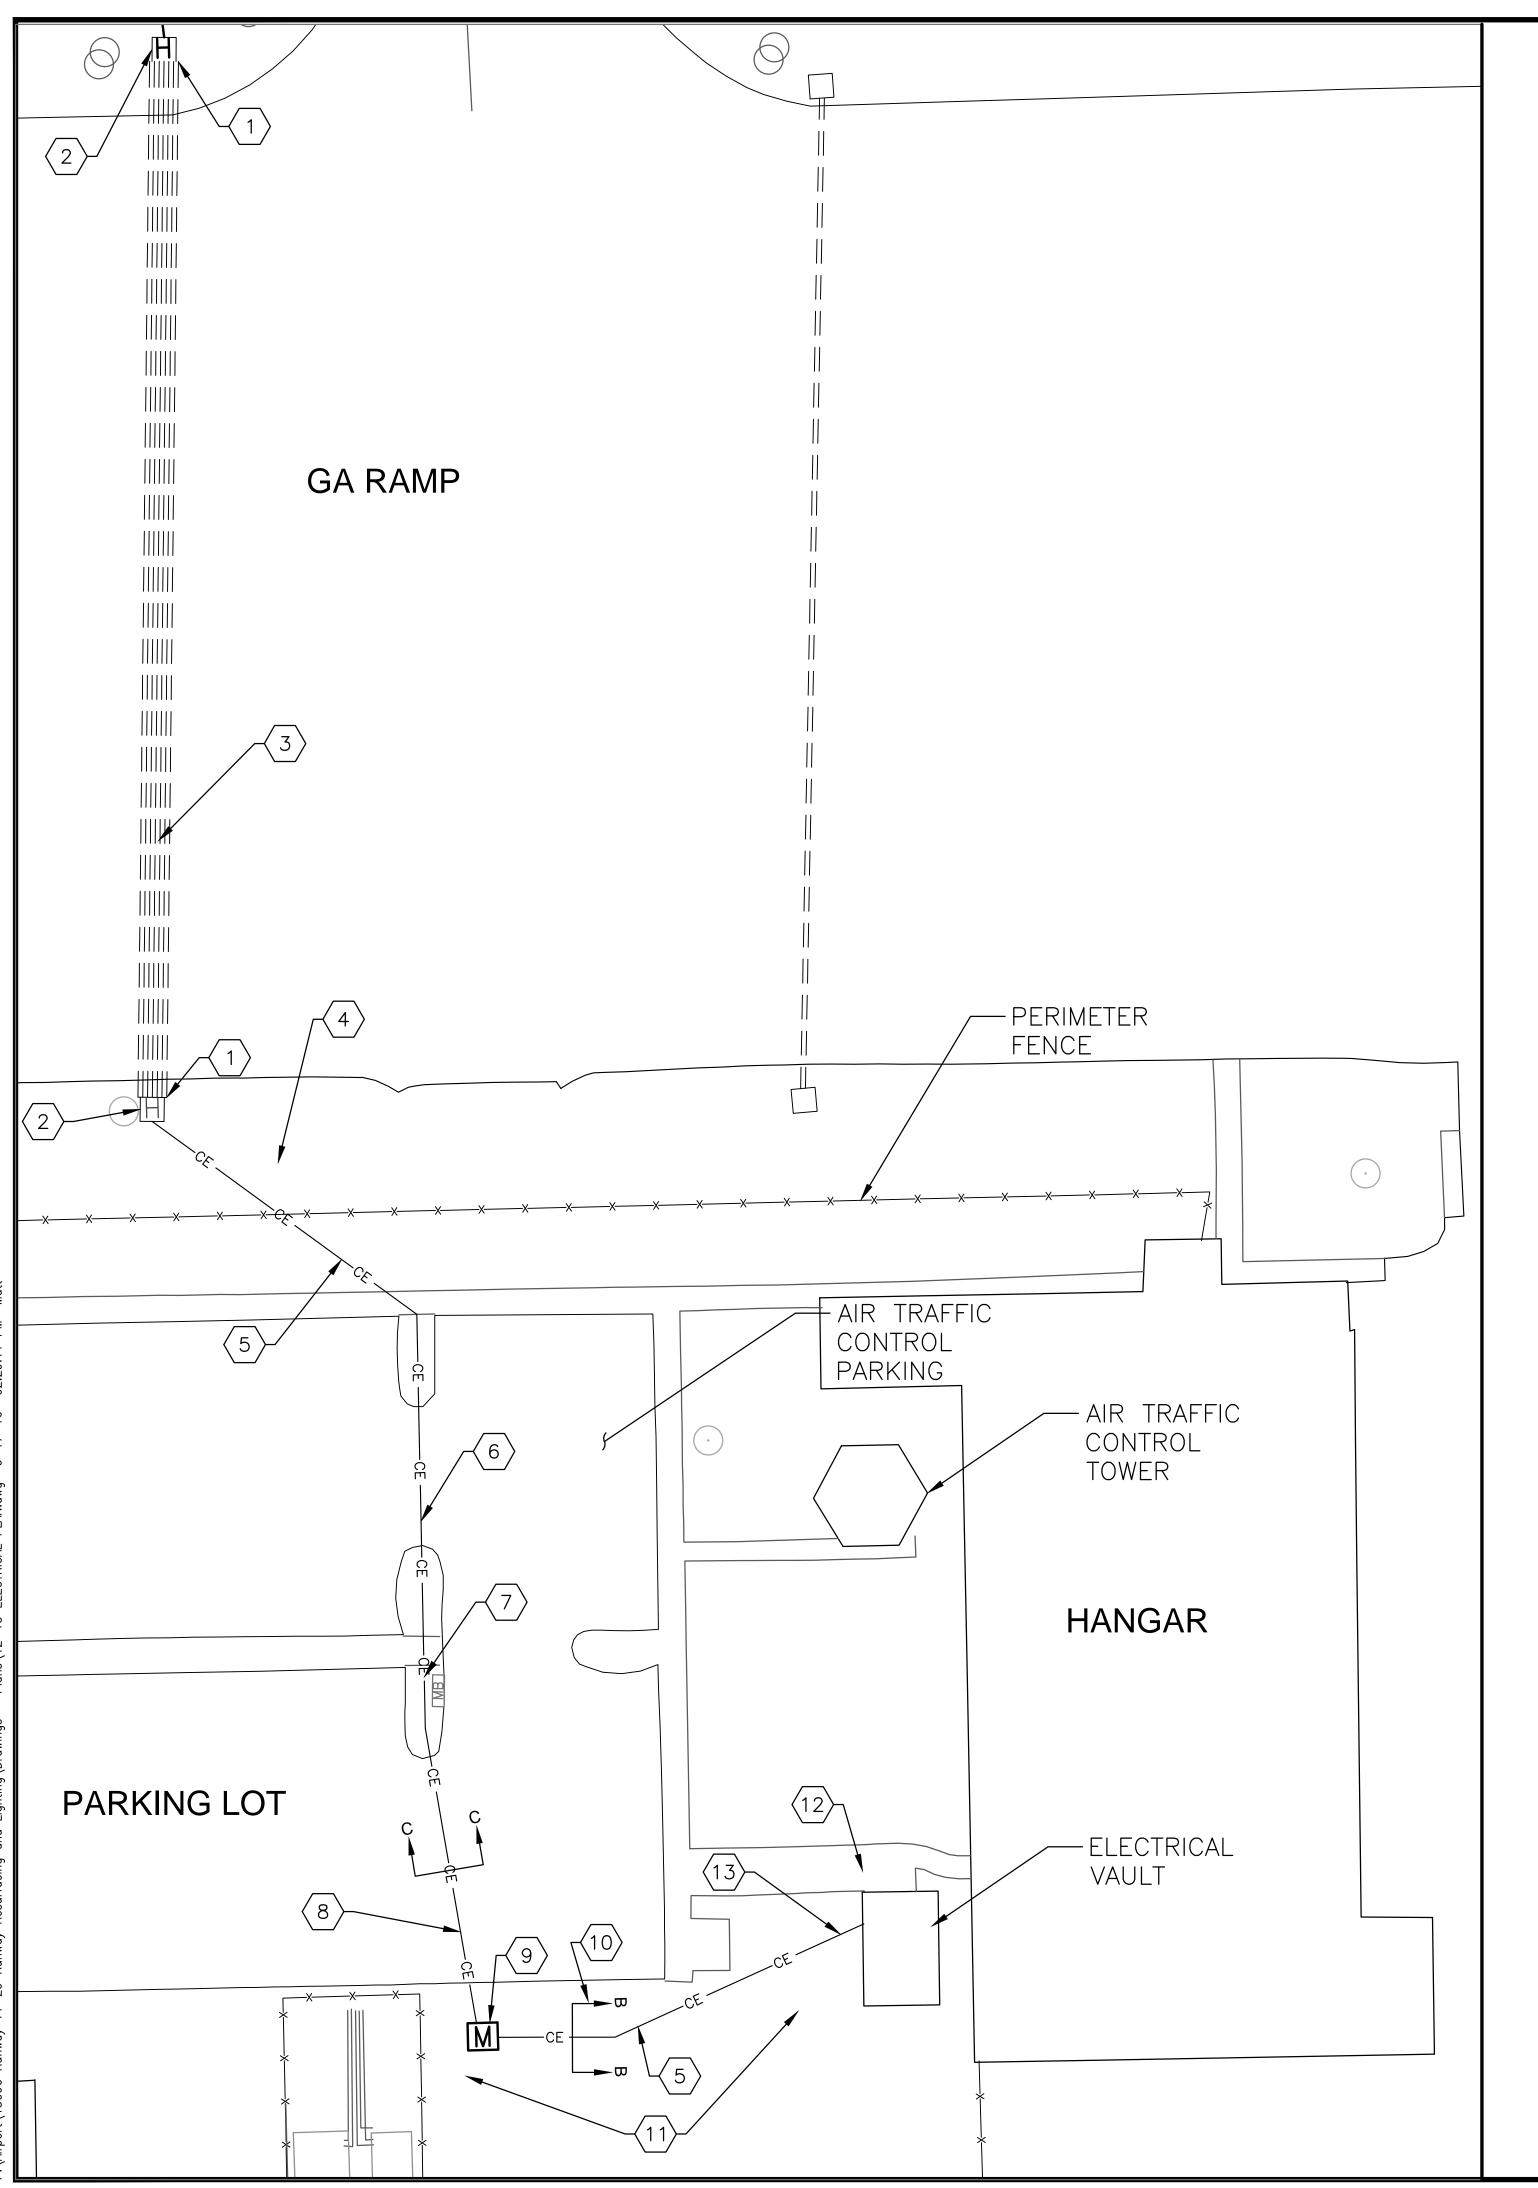

## PLAN NOTES

- (1.) LOCATE AND EXPOSE ENDS OF EXISTING DUCT BANK FOR ADDITION OF PROPOSED CABLES. HAND-EXCAVATE BETWEEN DUCT BANK AND EXISTING HANDHOLE TO AVOID DAMAGE TO EXISTING CABLES. DISCONNECT AND REMOVE EXISTING CABLES FOR CIRCUITS TO BE REPLACED.
- $\langle 2. \rangle$  TRACE AND IDENTIFY EXISTING HOME RUN CABLES TO BE RETAINED AND TO BE REMOVED IN EXISTING HANDHOLES. PROVIDE IDENTIFICATION TAGS ON ALL PROPOSED AND EXISTING CABLE PAIRS. THIS WORK SHALL BE CONSIDERED INCIDENTAL TO THE PROPOSED CABLE INSTALLATION. CORE-DRILL EXISTING EAST WALL OF HANDHOLE FOR PROPOSED CONDUIT ENTRY. SEAL PENETRATION WATERTIGHT WITH NON-SHRINK GROUT. THIS WORK SHALL BE CONSIDERED INCIDENTAL TO THE DUCT BANK PAY ITEM.
- 3. 2- 1C, #8, 5 KV, TYPE C CABLES IN EXISTING DUCT BANK SPARE CONDUIT. REMOVE EXISTING RUNWAY 11-29 CABLES.
- 4. HAND-EXCAVATE EXISTING UNDERGROUND CABLES BEFORE CROSSING WITH PROPOSED DUCT BANK. DEEPEN DUCT BANK AS REQUIRED TO AVOID DAMAGE.
- 5. PROPOSED CONCRETE-ENCASED DUCT BANK CONSISTING OF 4 4" PVC SCHED 40 CONDUITS. SEE DETAILS, SHEET 18. PROVIDE 2- 1/C, #8, 5 KV, TYPE C CABLES IN PROPOSED DUCT BANK TO VAULT. SEE VAULT DETAIL SHEET 18.
- 6. 30 LINEAL FEET OF PAVEMENT SHALL BE REMOVED AND REPLACED FOR DUCT BANK INSTALLATION. THIS WORK SHALL BE CONSIDERED INCIDENTAL TO THE DUCT BANK PAY ITEM.
- (7.) LOCATE AND EXPOSE EXISTING WATER LINE TO AVOID DAMAGE. DEEPEN DUCT BANK AS REQUIRED TO AVOID DAMAGE.
- (8.) 48 LINEAL FEET OF PAVEMENT SHALL BE REMOVED AND REPLACED FOR DUCT BANK INSTALLATION. THIS WORK SHALL BE CONSIDERED INCIDENTAL TO THE DUCT BANK PAY ITEM.
- $\langle 9. \rangle$  SEE SHEET 18 FOR MANHOLE DETAILS.
- (10.) EXISTING FUEL FARM PUMP STARTER TO REMAIN.
- LOCATE AND EXPOSE EXISTING FUEL PUMP UNDERGROUND FEEDS. DEEPEN DUCT BAN TO AVOID DAMAGE.
- 12. LOCATE EXISTING UNDERGROUND UTILITIES AND AVOID DAMAGING. NOTE AMEREN IL VOLTAGE CABLE IN THIS AREA.
- (13.) LOCATE EXISTING UNDERGROUND CONDUITS LEAVING BUILDING. LOWER DUCT BANK PASS BENEATH. SEE DETAIL, SHEET 18 FOR PROPOSED CONDUIT ENTRY INTO BUILDING

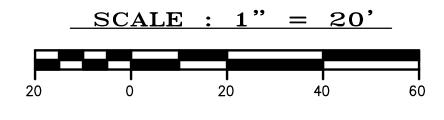


- 1. THE CONTRACTOR SHALL MAINTAIN ACCESS TO THE AIR TRAFFIC CONTROL TOWER PARKING AT ALL TIMES.
- 2. THE CONTRACTOR SHALL TEMPORARILY RELOCATE MAILBOX'S IF IN CONFLICT WITH DUCT INSTALLATION.
- 3. THE CONTRACTOR SHALL MAINTAIN THE INTEGRITY OF THE PERIMETER FENCE AT ALL TIMES. SHOULD THE FENCE REQUIRE TEMPORARY REMOVAL A GUARD SHALL BE PROVIDED AT ALL TIMES.
- 4. ALL COST ASSOCIATED WITH INSTALLATION OF CONCRETE ENCASED DUCT INCLUDING BUT NOT LIMITED TO REMOVAL AND REPLACEMENT OF PAVEMENT, CURB, SIDEWALK, AND SEEDING SHALL BE INCIDENTAL TO ITEM L-110, 4-WAY CONCRETE ENCASED DUCT. REPLACEMENT MATERIALS AND DIMENSIONS SHALL MATCH EXISTING.

		OTAT		
BANK AS I	REQUIRED	REVISIO		LINOIS PROFESSIONAL DESIGN FIRM LICENSE NO. 184–004515 © ALL RIGHTS RESERVED
N ILLINOIS	HIGH	DATE	NO.	CLARIDA & ZIEGLER
ANK AS NE	EDED TO			<b>ENGINEERING CO.</b> 410 North Court St, P.O. Box 937
DING.				Marion, Illinois 62959 Phone - (618)993-6411, Fax - (618)993-6750
				RUNWAY 11-29 REHABILITATION, ASSOCIATED
	LETTING CONTRACT NUMBER			EDGE LIGHTS & GUIDANCE SIGN REPLACEMENT ELECTRICAL PLAN
	WI057			Date <u>6/17/16</u> DR. By <u>MKW</u> CK'D By <u>WBZ</u>
	WI037			Scale <u>1" = 20'</u> Job No. <u>15096</u> Sheet No. <u>15</u> of <u>21</u>

## GENERAL NOTES

- 1. THE ELECTRICAL INSTALLATION, AS A MINIMUM, SHALL MEET THE NATIONAL ELECTRICAL CODE AND LOCAL REGULATIONS.
- 2. COLOR CODE ALL PHASE WIRING BY THE USE OF COLORED WIRE INSULATION AND/OR COLORED TAPE. WHERE TAPE IS USED, THE WIRE INSULATION SHALL BE BLACK. BLACK AND RED SHALL BE USED FOR SINGLE PHASE, THREE WIRE SYSTEMS, AND BLACK, RED AND BLUE SHALL BE USED FOR THREE PHASE SYSTEMS. NEUTRAL CONDUCTORS SIZE NO. 6 AWG OR SMALLER SHALL BE IDENTIFIED BY A CONTINUOUS WHITE OR NATURAL GRAY OUTER FINISH ALONG ITS ENTIRE LENGTH. NEUTRAL CONDUCTORS SIZE LARGER THAN NO. 6 SHALL BE IDENTIFIED EITHER BY A CONTINUOUS WHITE OR NATURAL GRAY OUTER FINISH ALONG ITS ENTIRE LENGTH OR BY THE USE OF WHITE TAPE AT ITS TERMINATIONS AND INSIDE ACCESSIBLE ENCLOSURES.
- 3. ALL BRANCH CIRCUIT CONDUCTORS CONNECTED TO A PARTICULAR PHASE SHALL BE IDENTIFIED WITH THE SAME COLOR. THE COLOR CODING SHALL BE EXTENDED TO THE POINT OF UTILIZATION.
- 4. NEATLY LACE WIRING IN DISTRIBUTION PANELS, SWITCHES AND JUNCTION/PULL BOXES.
- 5. GROUND ALL NONCURRENT-CARRYING METAL PARTS OF ELECTRICAL EQUIPMENT BY USING INSULATED COPPER WIRE TO BE RUN INSIDE CABINETS AND IN CONDUITS TOGETHER WITH OTHER WIRES.
- 6. ALL GROUND CONNECTIONS TO BUSSES, PANELS, ETC., SHALL BE MADE WITH PRESSURE TYPE SOLDERLESS LUG CLAMPS. SOLDERED OR BOLT & WASHER TYPE CONNECTIONS ARE NOT ACCEPTABLE. CLEAN ALL METAL SURFACES BEFORE MAKING GROUND CONNECTIONS. CONNECTIONS TO GROUND RODS SHALL BE MADE WITH EXOTHERMIC WELDING PROCESS.
- 7. SCHEDULE 40 RIGID STEEL CONDUIT SHALL BE USED THROUGHOUT THE INSTALLATION UNLESS OTHERWISE SPECIFIED.
- 8. ALL STEEL CONDUITS, FITTINGS, NUTS, BOLTS, ETC., SHALL BE GALVANIZED.
- 9. USE INSULATED CONDUIT BUSHINGS AT EACH CONDUIT TERMINATION.
- 10. USE DOUBLE LOCK NUTS AT EACH CONDUIT TERMINATION.
- 11. UNLESS OTHERWISE SHOWN, ALL EXPOSED CONDUITS SHALL BE RUN PARALLEL TO OR AT RIGHT ANGLES WITH THE LINES OF THE STRUCTURE.
- 12. UNLESS OTHERWISE NOTED, ALL SINGLE CONTROL CONDUCTORS SHALL BE NO. 12 AWG, THHN, STRANDED COPPER. EXTENSIONS TO EXISTING CONTROL CONDUCTORS SHALL BE THE SAME COLOR AS EXISTING.

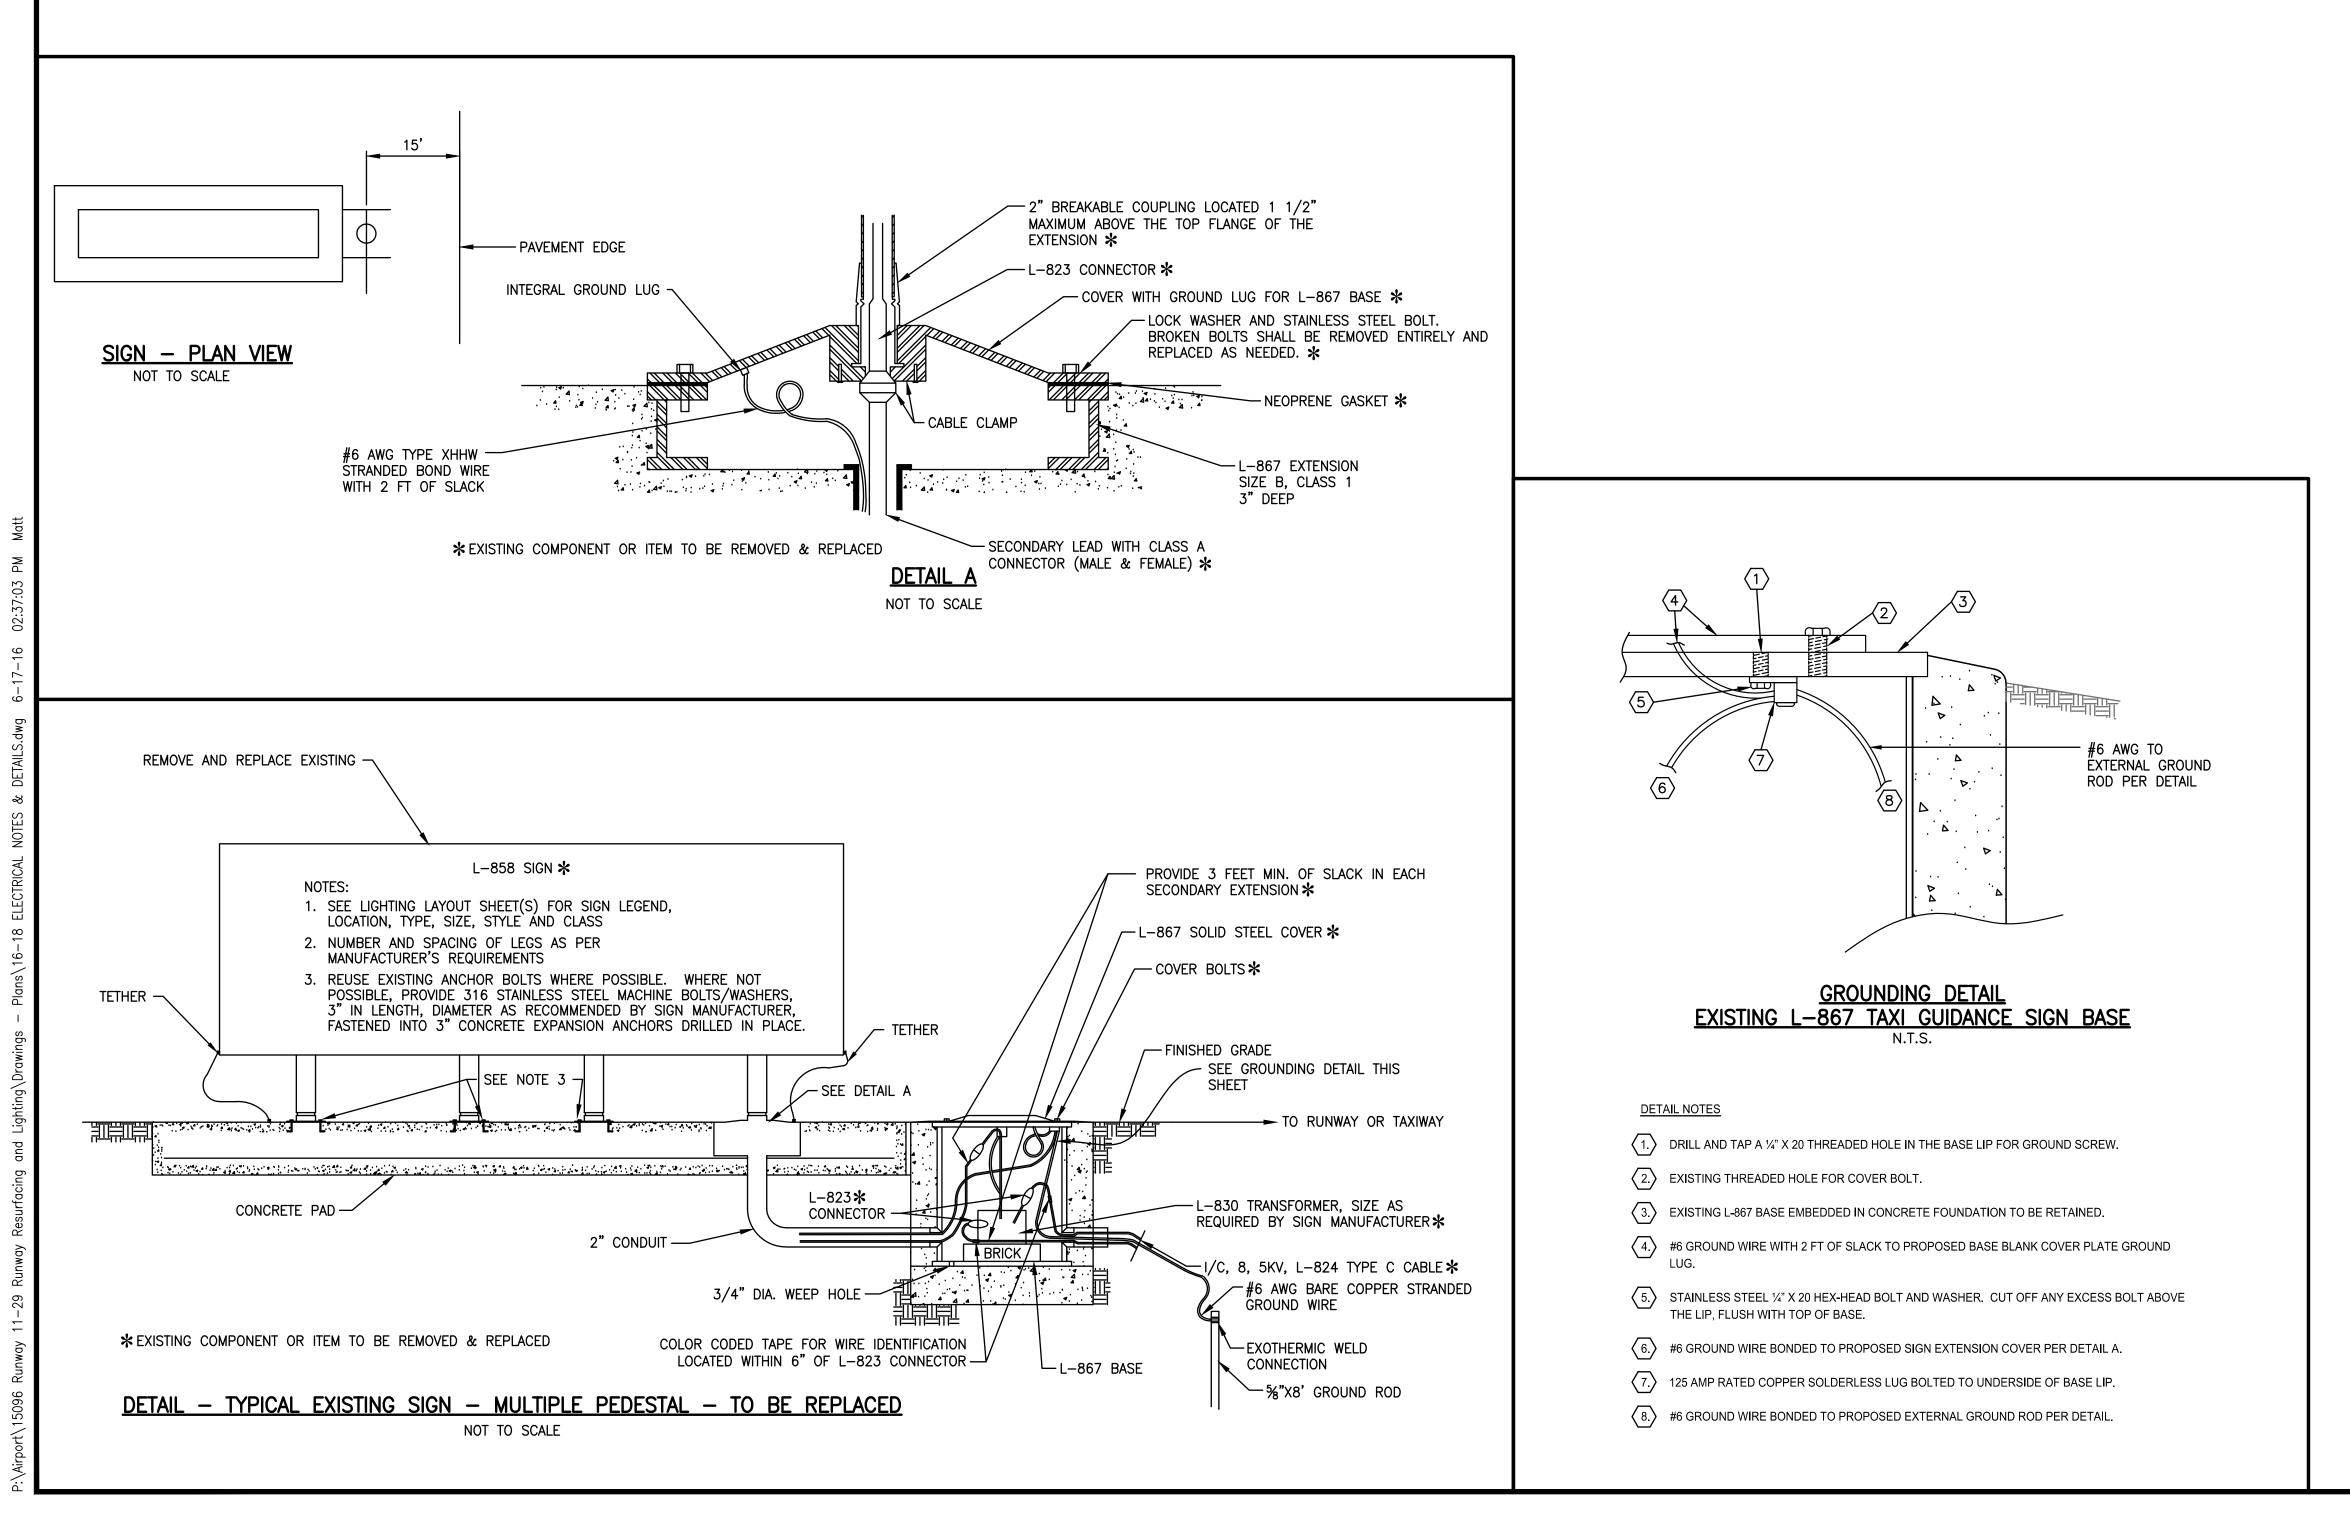

	GENERAL ELECTRICAL NOTES	
13.	BOTH ENDS OF EACH CONTROL CONDUCTOR SHALL BE TERMINATED AT A TERMINAL BLOCK. THE TERMINAL BLOCKS SHALL BE OF PROPER RATING AND SIZE AND THEY SHALL BE LOCATED IN EQUIPMENT ENCLOSURES OR SPECIAL TERMINAL CABINETS.	
14.	BOTH ENDS OF ALL CONTROL CONDUCTORS SHALL BE IDENTIFIED AS TO THE CIRCUIT, TERMINAL BLOCK, AND TERMINAL NUMBER. ONLY SHRINKABLE PERMANENT LABELS SHALL BE USED.	23.
15.	SPLICES AND JUNCTION POINTS SHALL BE PERMITTED ONLY IN JUNCTION BOXES, LIGHT BASES, WIREWAYS EQUIPPED WITH REMOVABLE COVERS AND AT EASILY ACCESSIBLE LOCATIONS.	24.
16.	UNLESS OTHERWISE NOTED, ALL UNDERGROUND FIELD POWER MULTIPLE AND SERIES CIRCUIT CONDUCTORS SHALL BE FAA APPROVED L—824, TYPE, INSULATION, VOLTAGE AND SIZE SHALL BE AS SPECIFIED.	
17.	THE JOINT OF THE PRIMARY L-823 PRIMARY CONNECTORS SHALL BE WRAPPED WITH AT LEAST ONE LAYER OF RUBBER OR	25.
	SYNTHETIC RUBBER TAPE AND ONE LAYER OF PLASTIC TAPE, ONE-HALF LAPPED, EXTENDING AT LEAST 1-1/2 INCHES ON EACH SIDE OF THE JOINT. HEAT-SHRINK TUBING SHALL BE APPLIED WHERE CABLE ENTERS BACK OF CONNECTOR, SEE DETAIL DWG., SHEET 17.	26.
18.	THE ID OF THE PRIMARY L-823 FIELD ATTACHED CONNECTORS SHALL MATCH THE CABLE OD TO PROVIDE A WATERTIGHT CABLE ENTRANCE.	27.
19.	THE RESISTANCE TO GROUND OF THE GROUNDING SYSTEM WITH COMMERCIAL POWER LINE NEUTRAL DISCONNECTED SHALL NOT EXCEED 25 OHMS.	
20.	ALL POWER AND CONTROL CIRCUIT CONDUCTORS SHALL BE COPPER, ALUMINUM SHALL NOT BE ACCEPTED. THIS INCLUDES WIRE, CABLE, BUSSES, TERMINALS, SWITCH/PANEL COMPONENTS, ETC.	28.
21.	CABLE/SPLICE/DUCT MARKERS SHALL BE PRECAST CONCRETE OF SIZE SHOWN. LETTERS/NUMBERS FOR THE LEGEND TO BE IMPRESSED INTO TOPS OF THE MARKERS SHALL BE PREASSEMBLED AND SECURED IN MOLD BEFORE CONCRETE IS POURED. LEGEND INSCRIBED BY HAND IN WET CONCRETE SHALL NOT BE ACCEPTABLE.	29.
22.	THE CONTRACTOR SHALL ASCERTAIN THAT ALL LIGHTING SYSTEM COMPONENTS FURNISHED BY HIM (INCLUDING FAA APPROVED EQUIPMENT) ARE COMPATIBLE IN ALL RESPECTS WITH EACH OTHER AND REMAINDER OF THE NEW/EXISTING SYSTEM. ANY NONCOMPATIBLE COMPONENTS FURNISHED BY THIS CONTRACTOR SHALL BE REPLACED BY HIM AT NO ADDITIONAL COST TO THE AIRPORT SPONSOR WITH A SIMILAR UNIT, APPROVED BY THE ENGINEER (DIFFERENT MODEL OF DIFFERENT MANUFACTURER) THAT	

IS COMPATIBLE WITH THE REMAINDER OF THE AIRPORT LIGHTING SYSTEM.

IN CASE THE CONTRACTOR SELECTS TO FURNISH AND INSTALL AIRPORT LIGHTING EQUIPMENT REQUIRING ADDITIONAL WIRING, TRANSFORMERS, ADAPTERS, MOUNTINGS, ETC., DIFFERENT FROM THOSE SHOWN ON THE DRAWINGS AND/OR LISTED IN THE SPECIFICATIONS, ANY COST FOR THESE ITEMS SHALL BE INCIDENTAL TO THE EQUIPMENT COST.


THE CONTRACTOR INSTALLED EQUIPMENT (INCLUDING FAA APPROVED) SHALL NOT GENERATE ANY ELECTRO-MAGNETIC INTERFERENCE IN THE EXISTING AND/OR NEW COMMUNICATIONS, WEATHER, AND AIR TRAFFIC CONTROL EQUIPMENT. ANY EQUIPMENT GENERATING SUCH INTERFERENCE SHALL BE REPLACED BY THE CONTRACTOR AT NO ADDITIONAL COST BY EQUIPMENT MEETING THE APPLICABLE SPECIFICATIONS AND NOT GENERATING ANY INTERFERENCE.

UNLESS NOTED OTHERWISE FOR IN PAVEMENT LIGHTS, WHERE EXISTING FIELD LIGHTS ARE TO BE REMOVED, THE AREA SHALL BE BACKFILLED WITH EARTH TO THE ORIGINAL GRADE, COMPACTED AND SEEDED. SUCH LIGHTS AND CONCRETE BASES SHALL BECOME CONTRACTOR SALVAGE AND SHALL BE REMOVED FROM THE PREMISES ENTIRELY. WHERE PROPOSED LIGHTS OR SIGNS ARE SHOWN IN THE SAME LOCATION AS EXISTING LIGHTS OR SIGNS, CONTRACTOR SHALL REMOVE THE EXISTING WIRING TO AT LEAST TWO FEET AWAY FROM PROPOSED WIRING.

CONTRACTOR SHALL LOCATE EXISTING UNDERGROUND CIRCUITS WITH A PORTABLE CABLE LOCATOR WHERE POSSIBLE TO AVOID DAMAGE TO EXISTING CIRCUITS TO BE RETAINED. EXCAVATION REQUIRED IN CONGESTED AREAS CONTAINING OTHER CIRCUITS SHALL BE DONE BY HAND. ANY SUCH WIRING DAMAGED DURING CONSTRUCTION SHALL BE REPAIRED IMMEDIATELY AFTER DISCOVERY AND NO ADDITIONAL COMPENSATION WILL BE ALLOWED. ALL UNDERGROUND SPLICES SHALL BE INSPECTED BY THE ENGINEER PRIOR TO BACKFILLING TRENCHES.


SHOP DRAWINGS SHALL BE REQUIRED FOR THE FOLLOWING ITEMS: CONDUIT, WIRE & CABLE, CABLE IN UNIT DUCT, FIELD LIGHTS, LAMPS, SPLICE CANS, FIELD LIGHT MODIFICATIONS, CABLE CONNECTORS, PULL BOXES, PRECAST CONCRETE MANHOLES, TAXI GUIDANCE SIGNS.


A MINIMUM OF FOUR HOURS SHALL BE PROVIDED FOR TRAINING AIRPORT MAINTENANCE PERSONNEL ON THE PROPOSED AIRFIELD LIGHTING SYSTEMS.

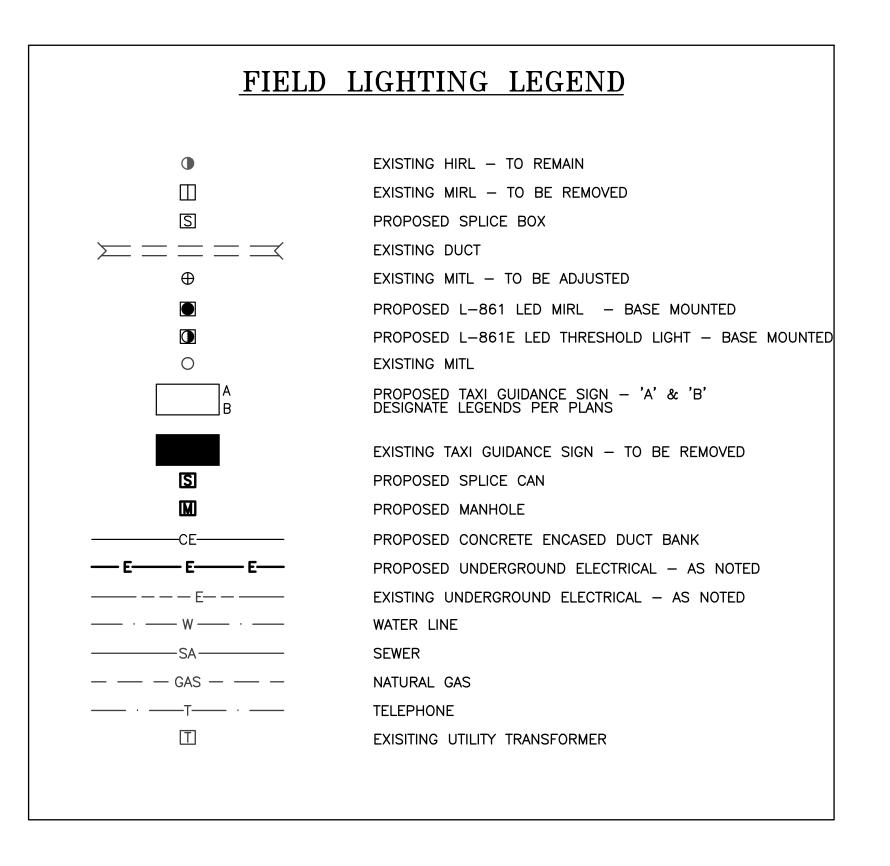


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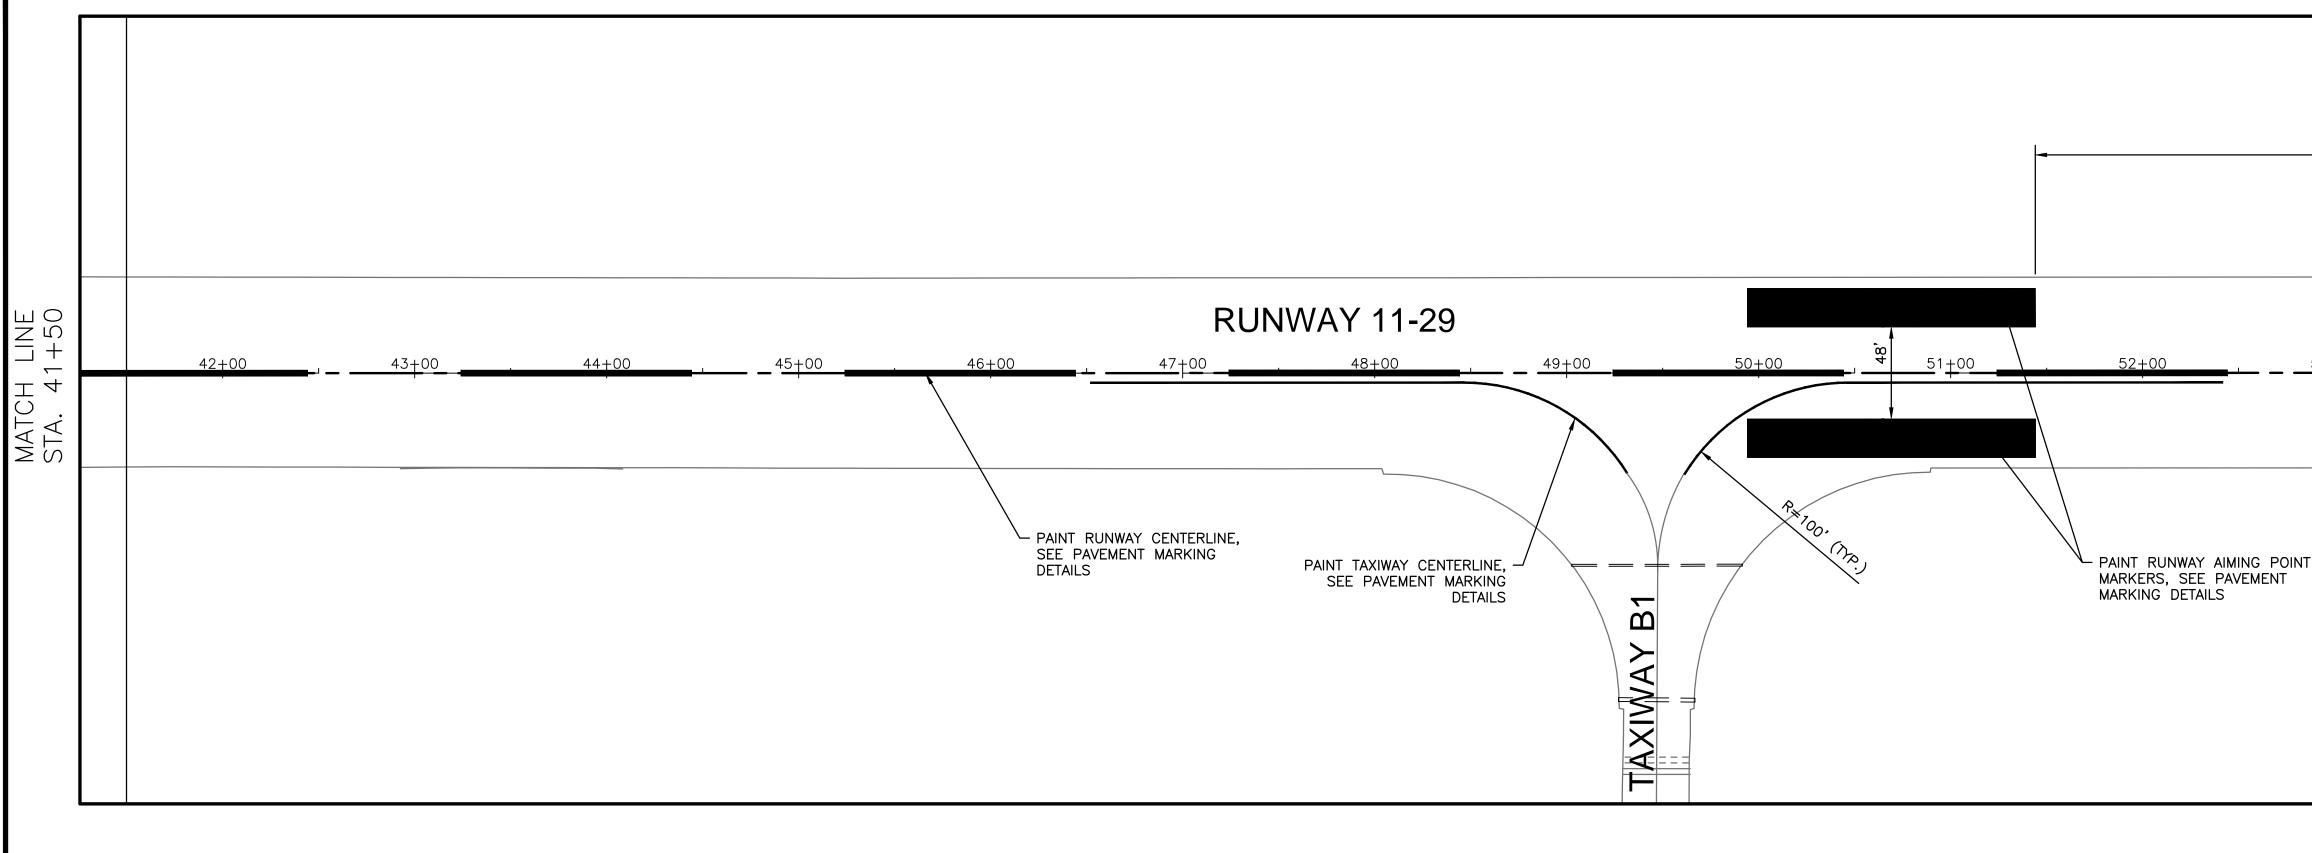
- HEAT-SHRINKABLE TUBING SHALL HAVE MINIMUM EXPANDED I.D. OF 1.200", MAXIMUM RECOVERED I.D. OF .300", MINIMUM APPLIED ON THE INSIDE, AND SHALL BE RAYCHEM NO. WCS-300-6-S OR APROVED EQUAL.
- CLEAN THE CABLE INSULATION BEFORE APPLYING THE TUBING WITH A SOLVENT SPECIFIED BY THE TUBING MANUFACTURER.




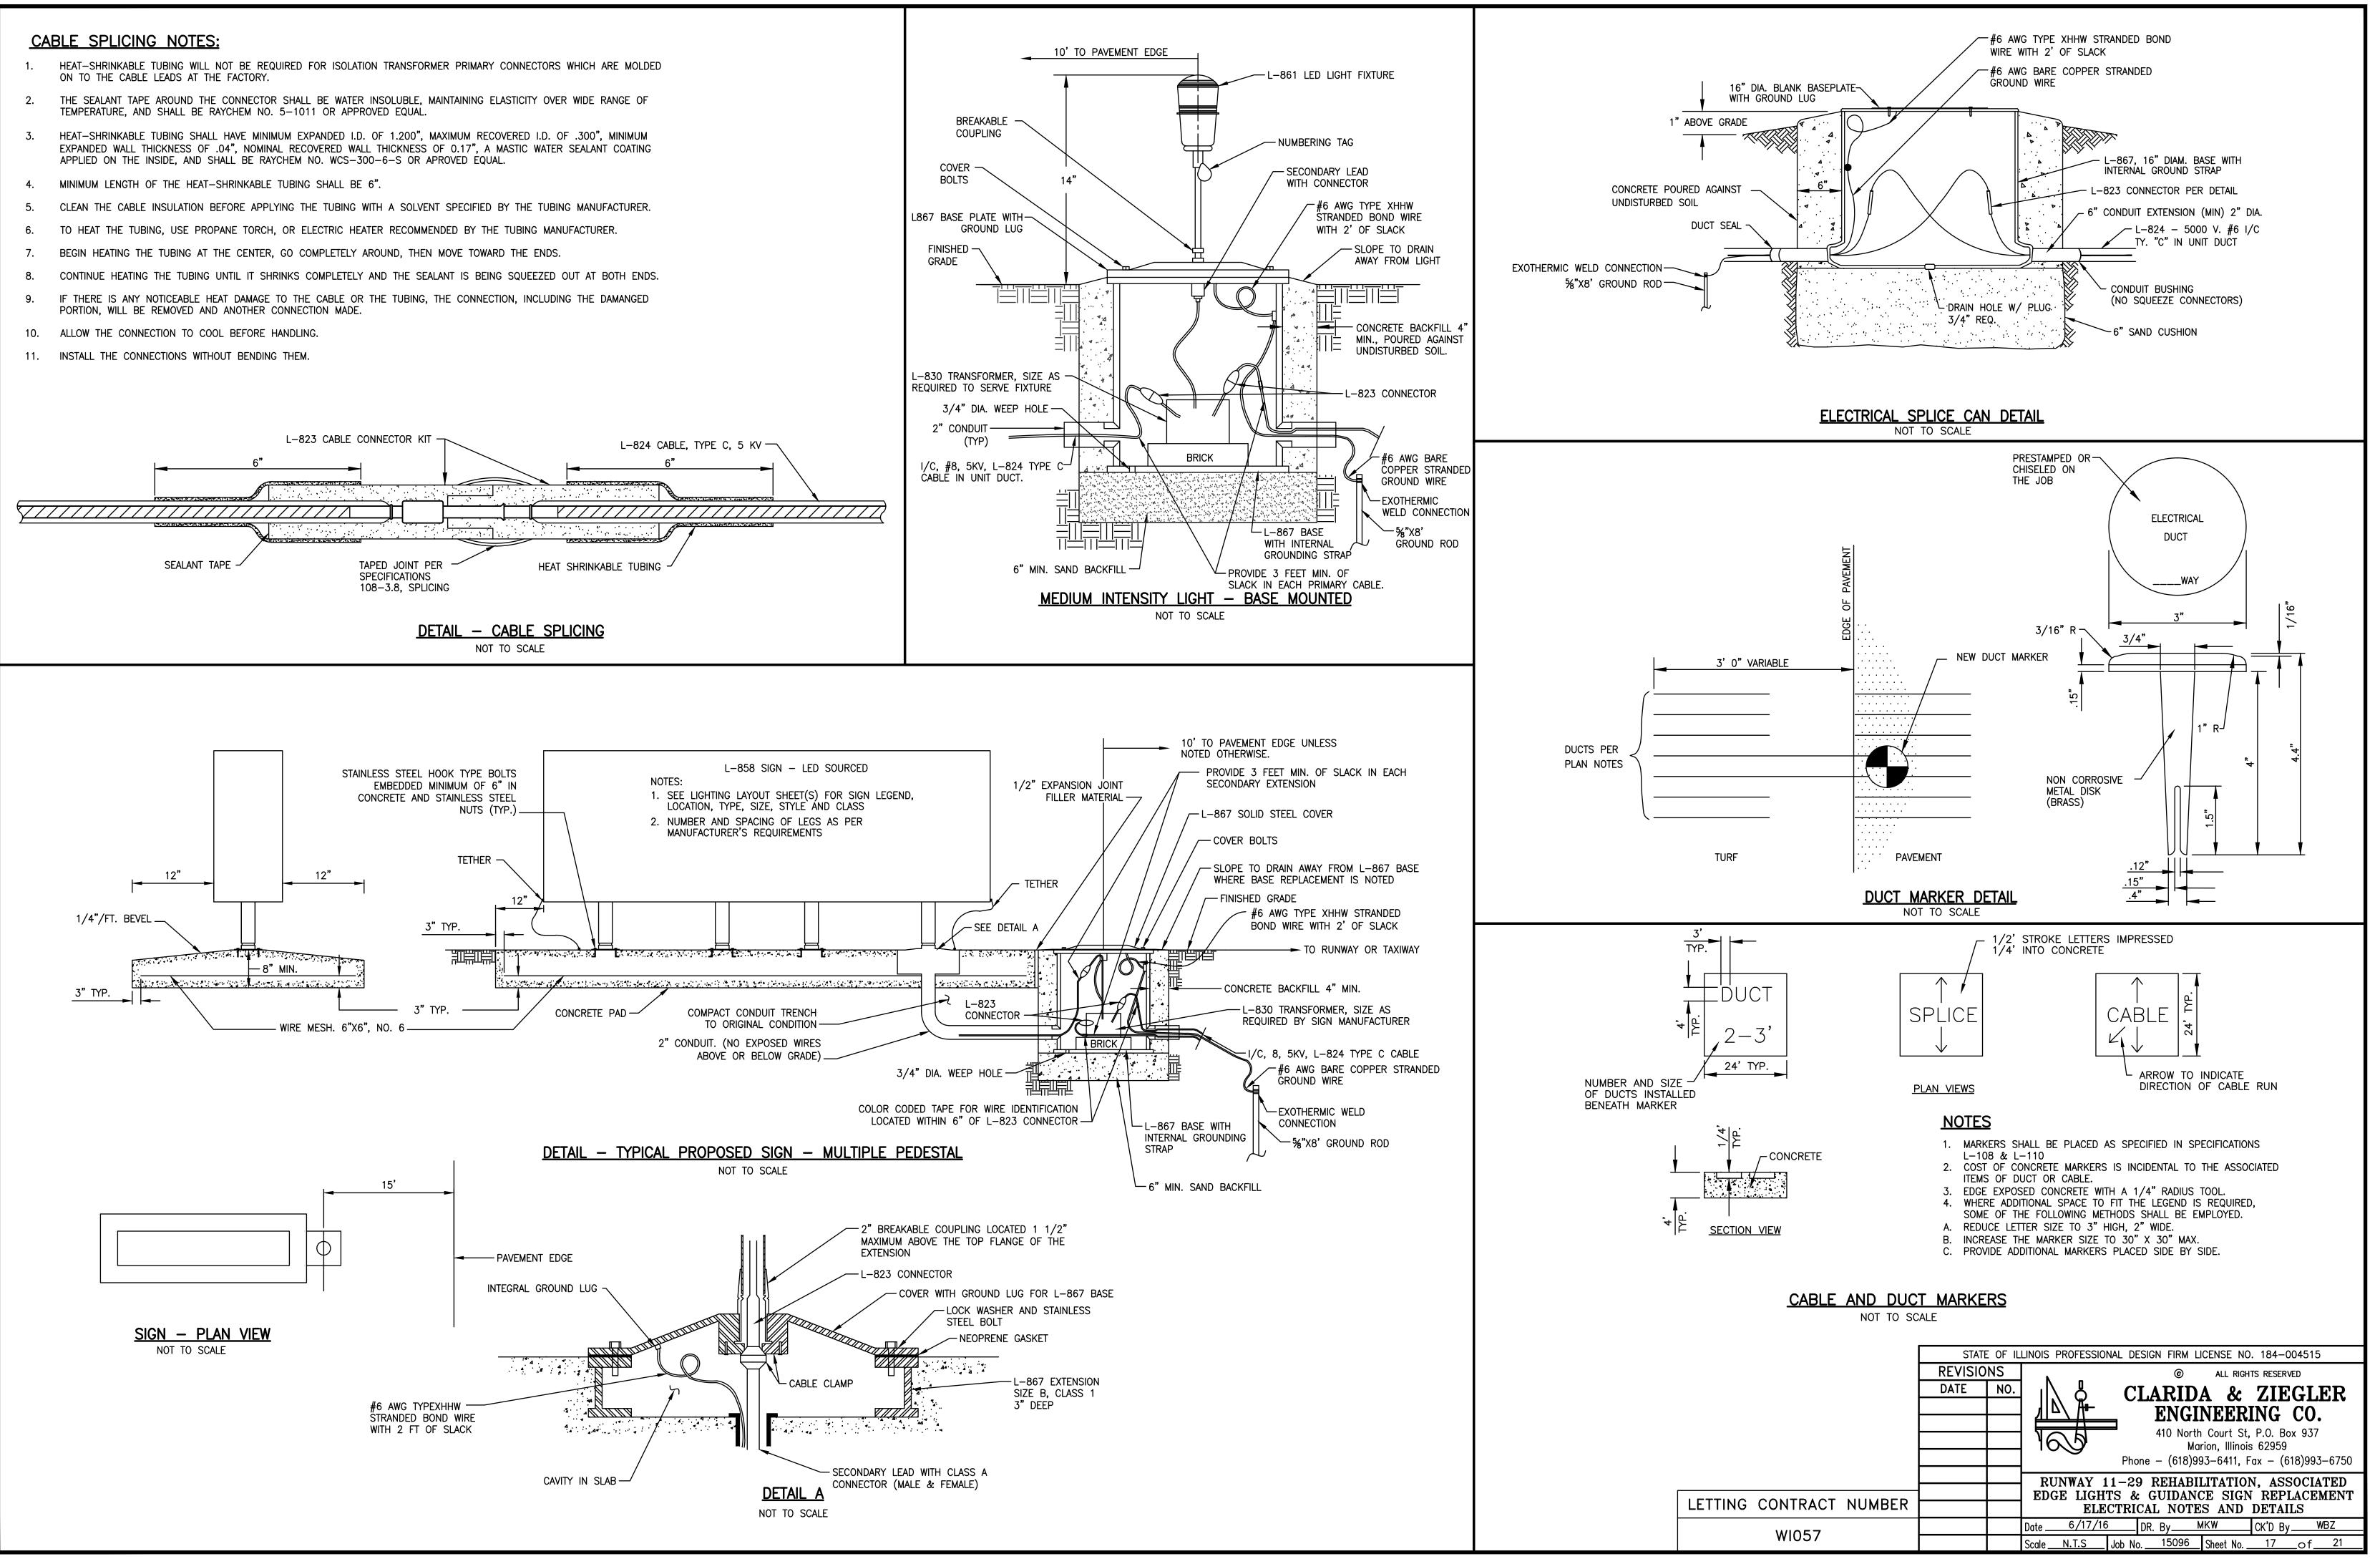
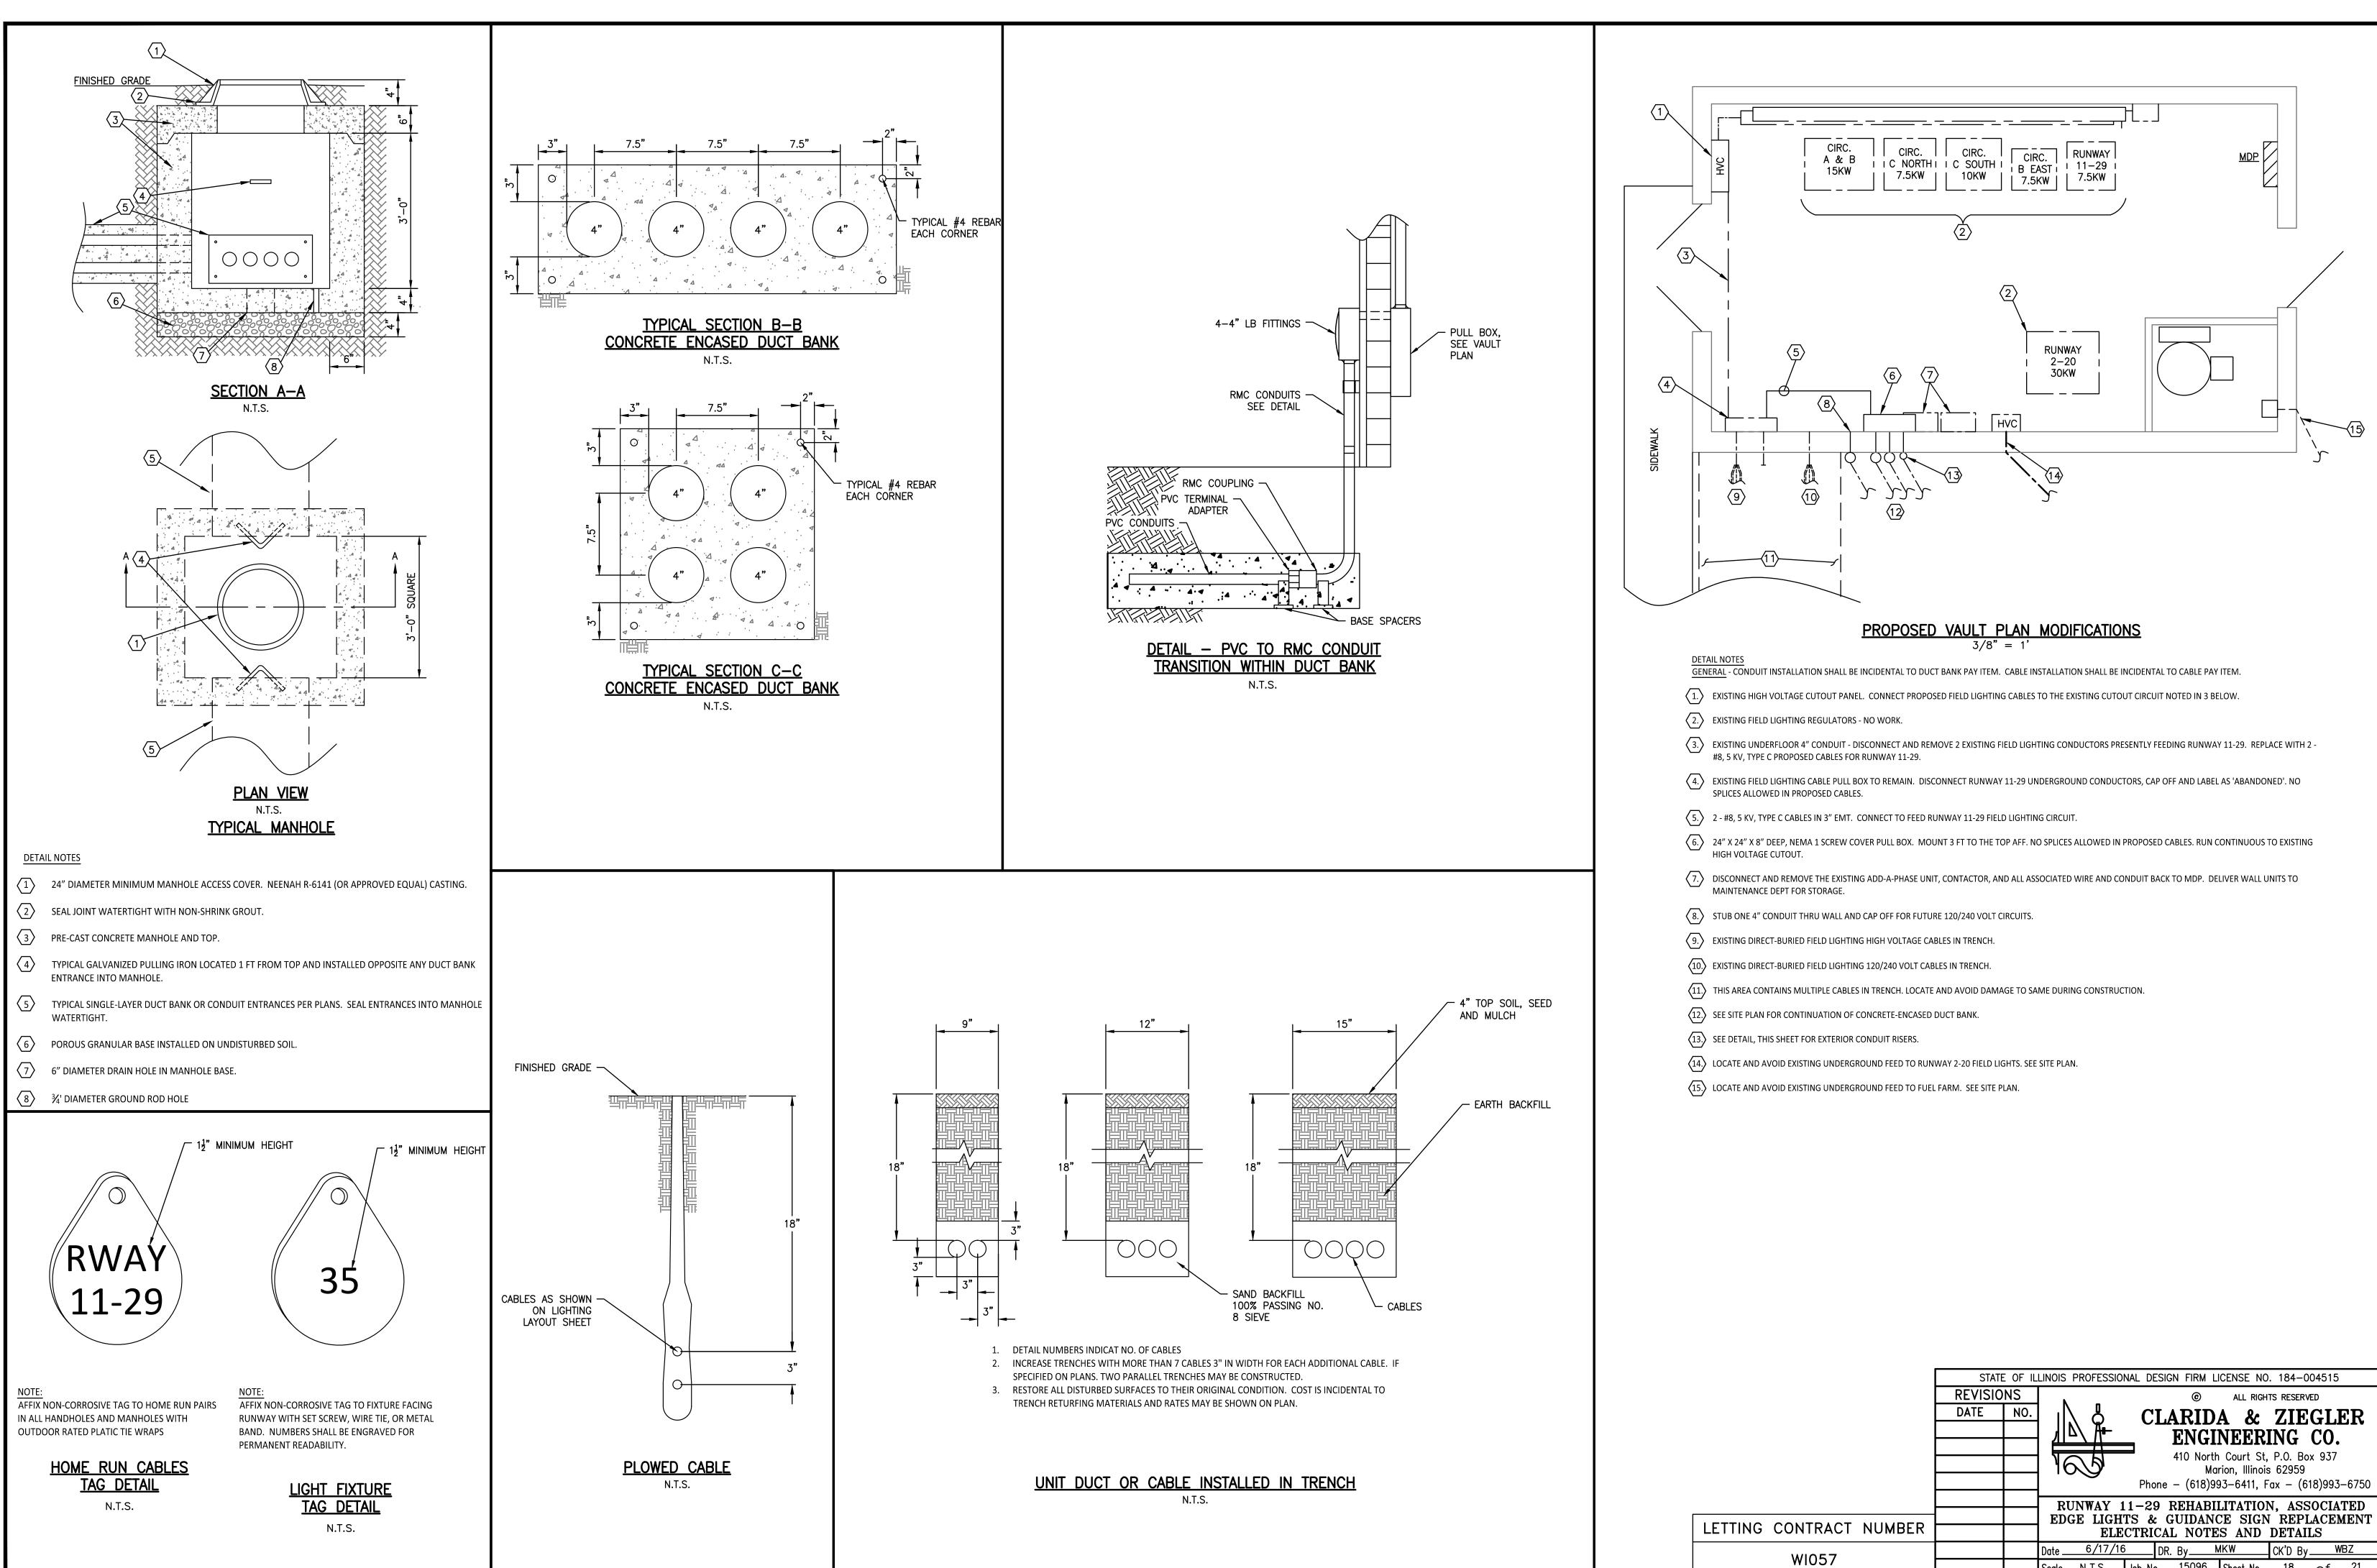
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			Marion, Illinois 62959 Phone - (618)993-6411, Fax - (618)993-6750					
			RUNWAY 11-29 REHABILITATION, ASSOCIATED					
			EDGE LIGHTS & GUIDANCE SIGN REPLACEMENT					
LETTING CONTRACT NUMBER			ELECTRICAL NOTES AND DETAILS					
WI057			Date <u>6/17/16</u> DR. By <u>MKW</u> CK'D By <u>WBZ</u>					
WI057			Scale <u>N.T.S</u> Job No. <u>15096</u> Sheet No. <u>18</u> of <u>21</u>					



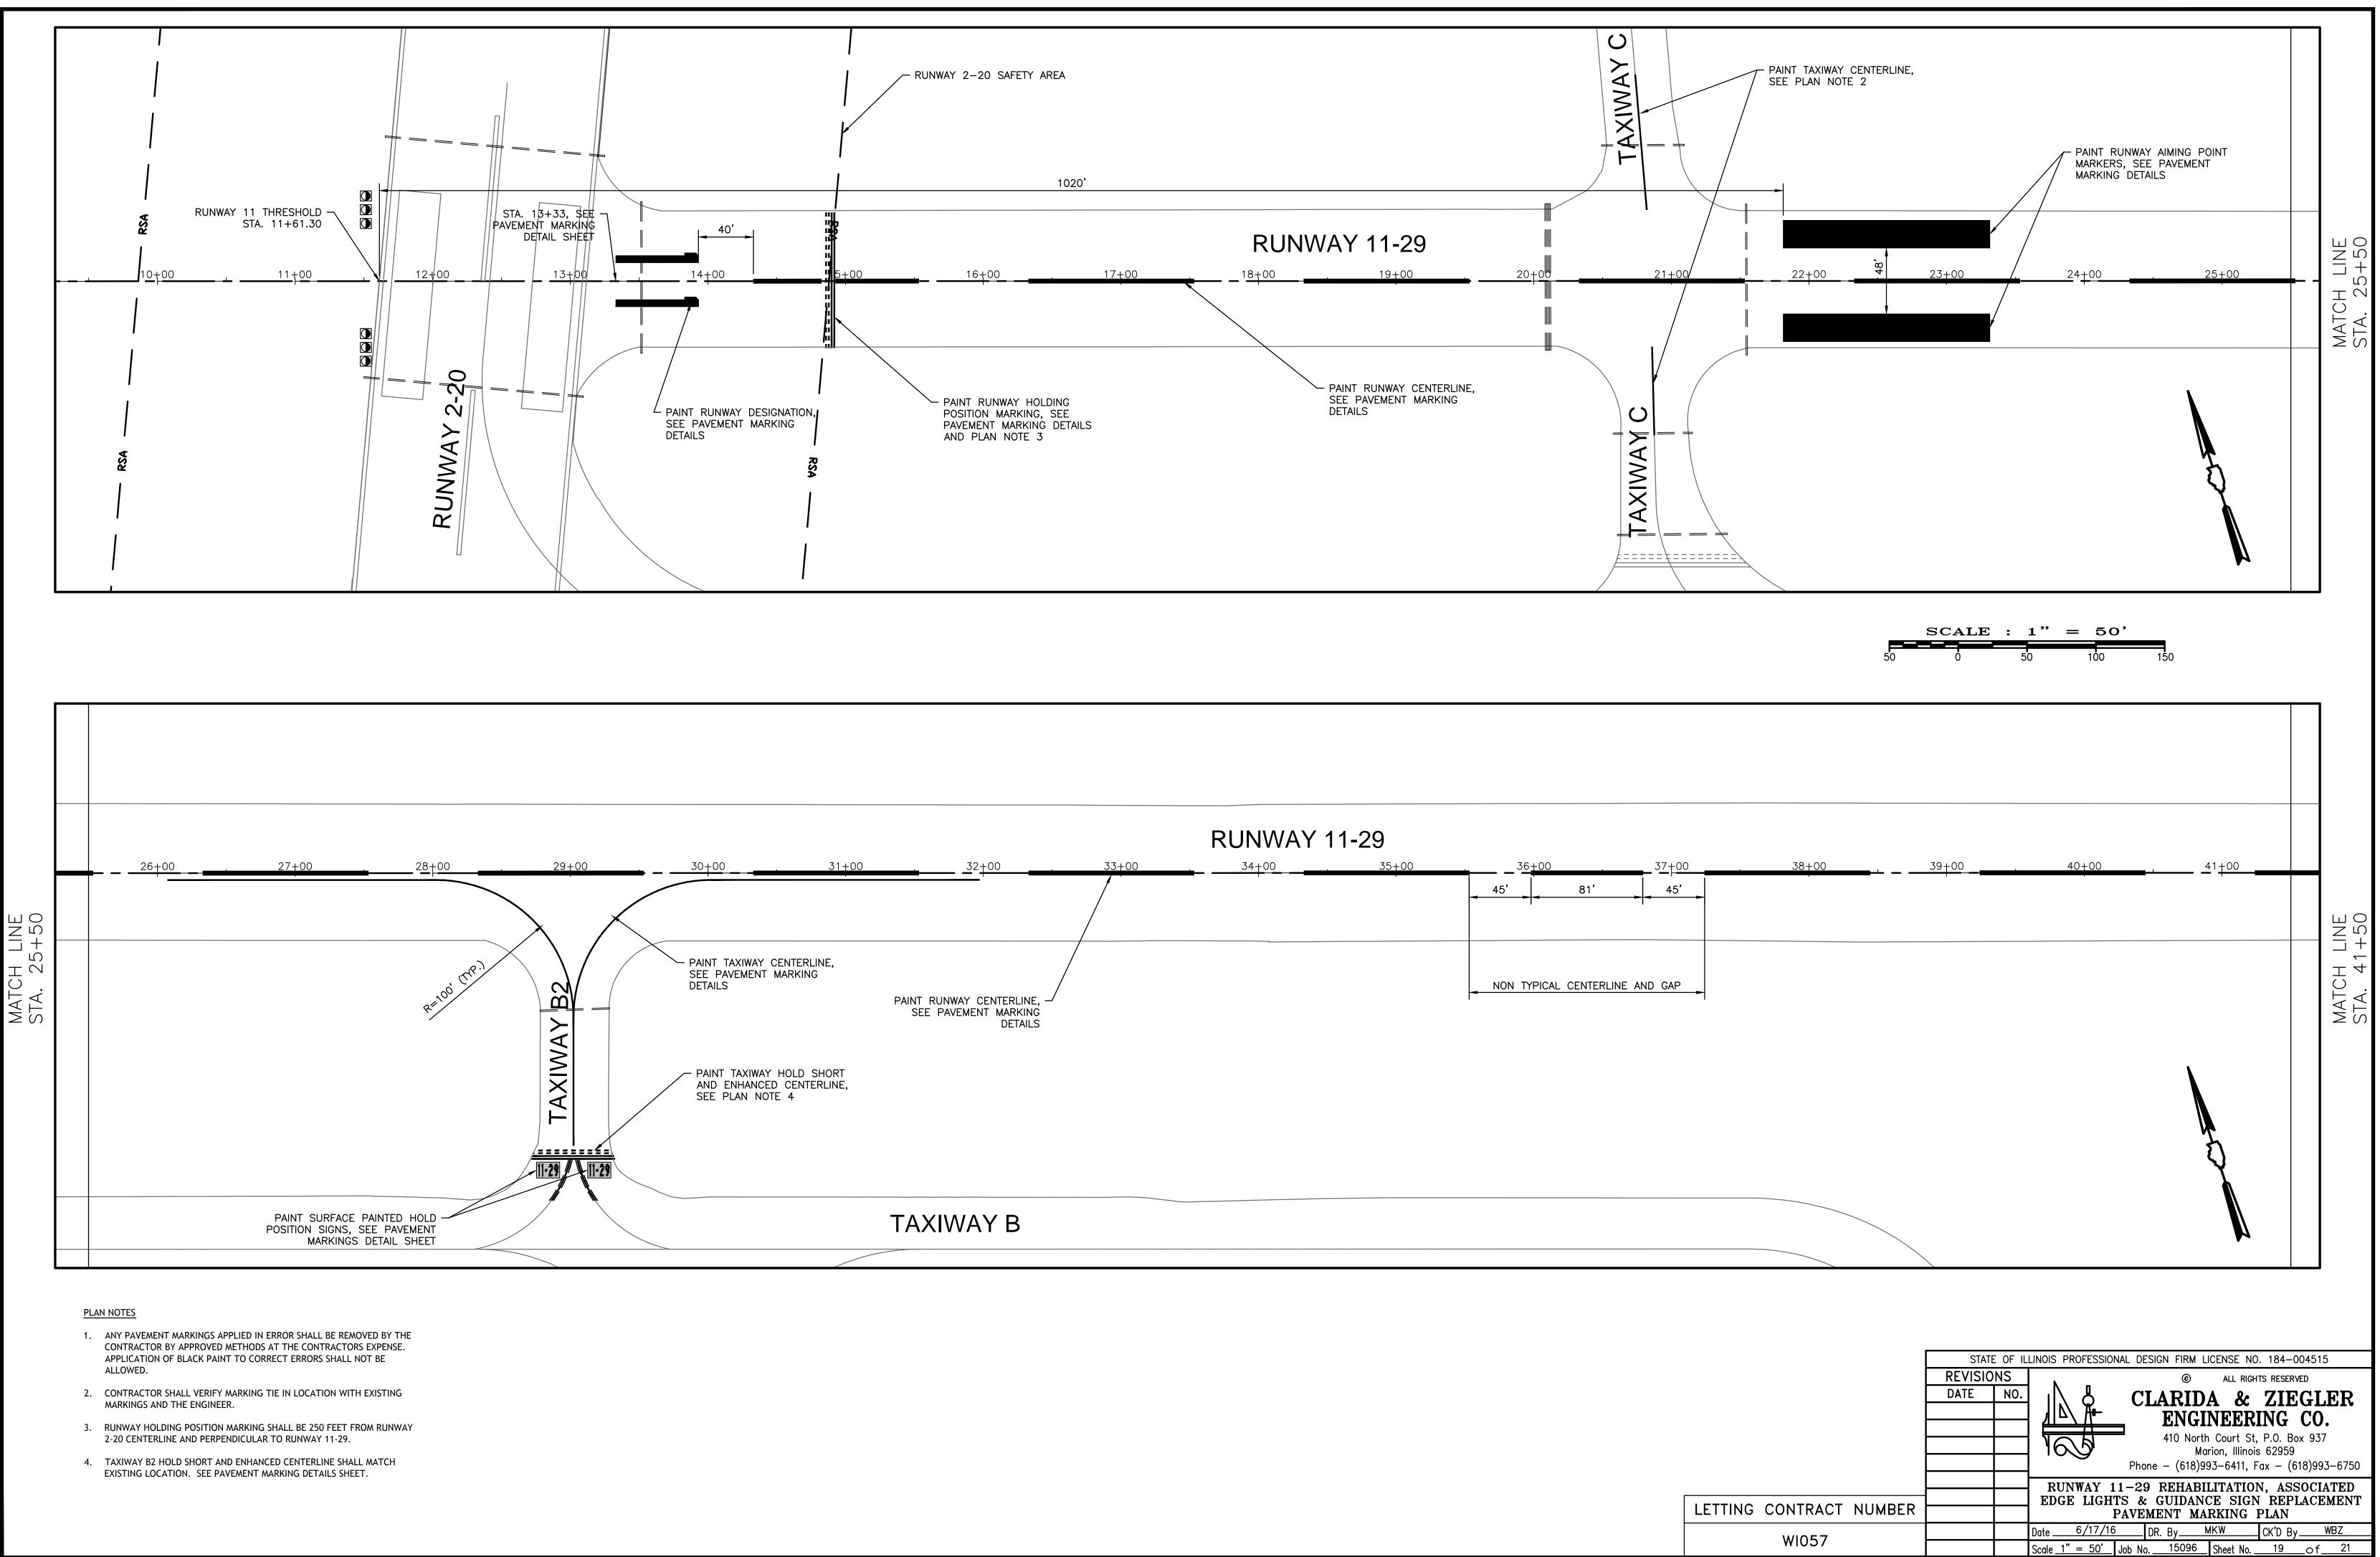


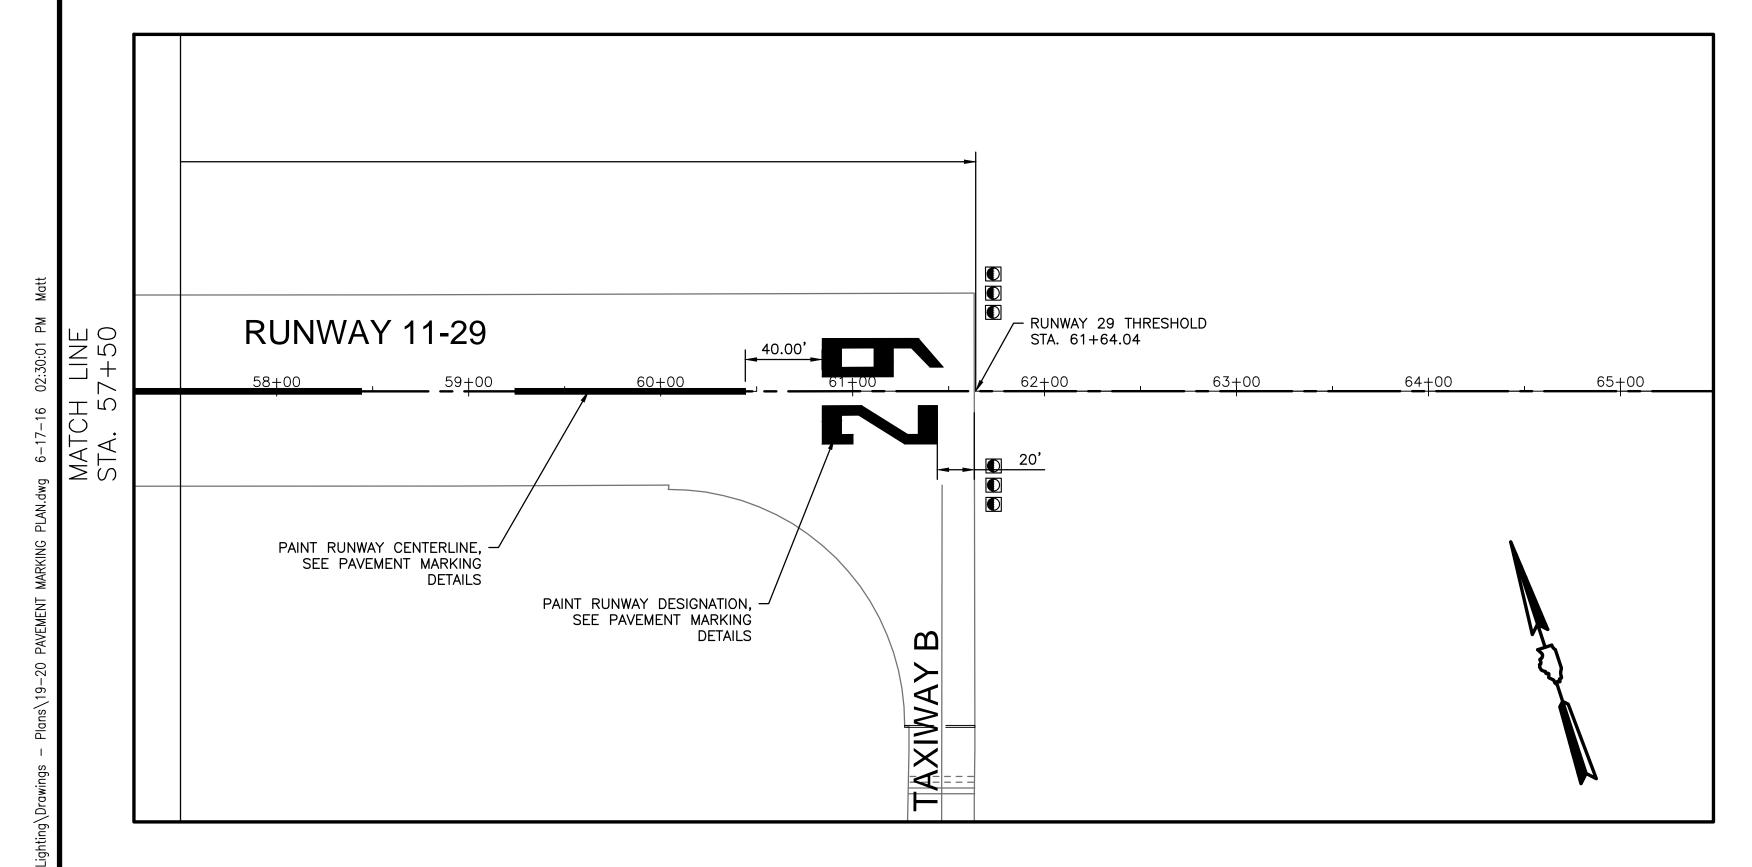


PLAN NOTES

- 1. ANY PAVEMENT MARKINGS APPLIED IN ERROR SHALL BE REMOVED BY THE CONTRACTOR BY APPROVED METHODS AT THE CONTRACTORS EXPENSE. APPLICATION OF BLACK PAINT TO CORRECT ERRORS SHALL NOT BE ALLOWED.
- 2. CONTRACTOR SHALL VERIFY MARKING TIE IN LOCATION WITH EXISTING MARKINGS AND THE ENGINEER.
- 3. EXISTING MARKINGS ON CONCRETE SHALL BE REMOVED.
- 4. RUNWAY MARKINGS ON CONCRETE SHALL HAVE A 6" BLACK BORDER.


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		STATE REVISIO DATE		Phone	© ALL RIGHTS <b>ARIDA &amp; ENGINEERI</b> 410 North Court St, Marion, Illinois – (618)993–6411, Fa	s reserved <b>ZIEGL</b> <b>NG CO</b> P.O. Box 937 62959 x - (618)99	<b>JER</b> 7 3–6750
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SURFACE PAINTED HOLDING POSITION

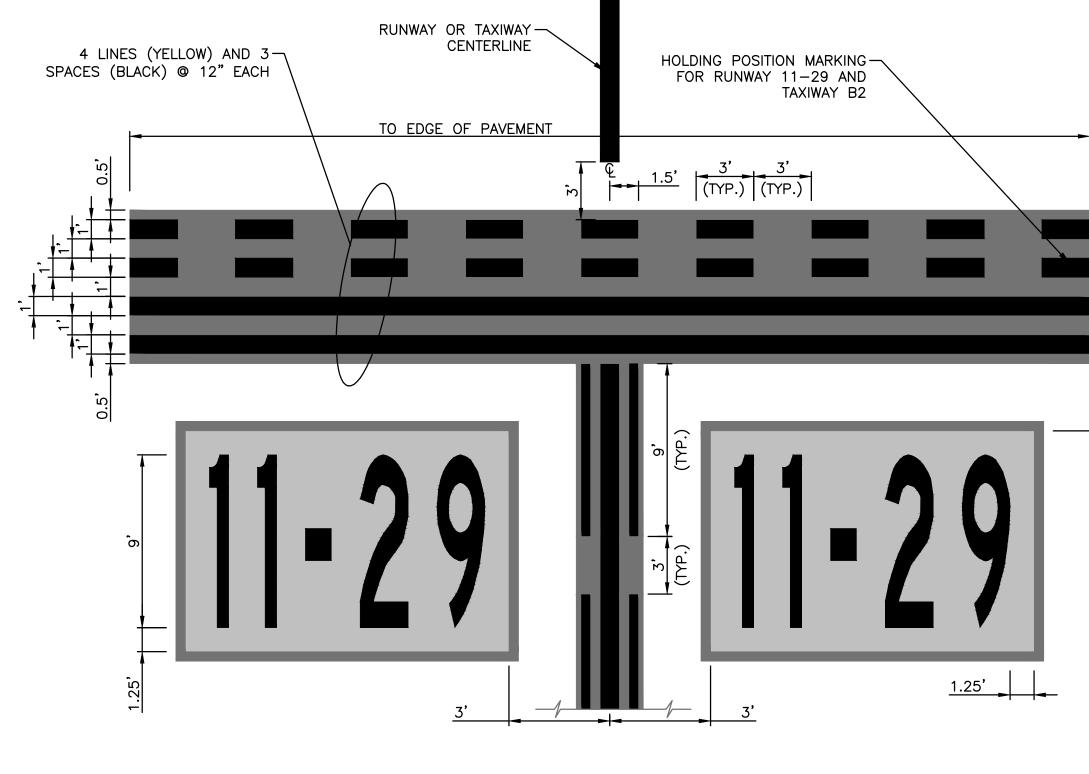

ENLARGEMENT OF ENHANCED MARKING

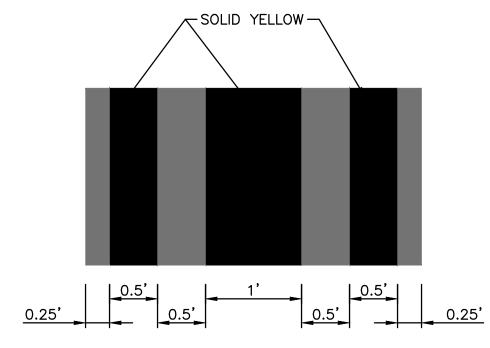


## DESIGNATION NOTES:

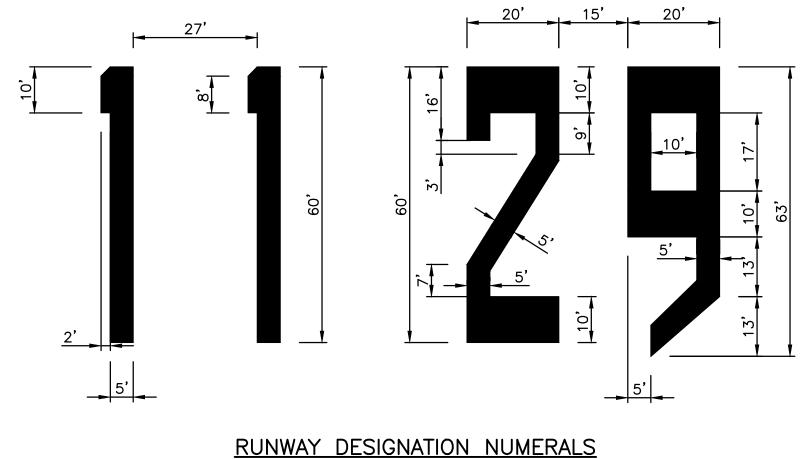- 1. RUNWAY DESIGNATION MARKINGS SHALL BE WHITE IN COLOR.
- 2. RUNWAY DESIGNATION MARKINGS SHALL BE CENTERED BETWEEN THE TWO NUMBERS ON THE RUNWAY CENTERLINE.



TAXIWAY CENTERLINE MARKING

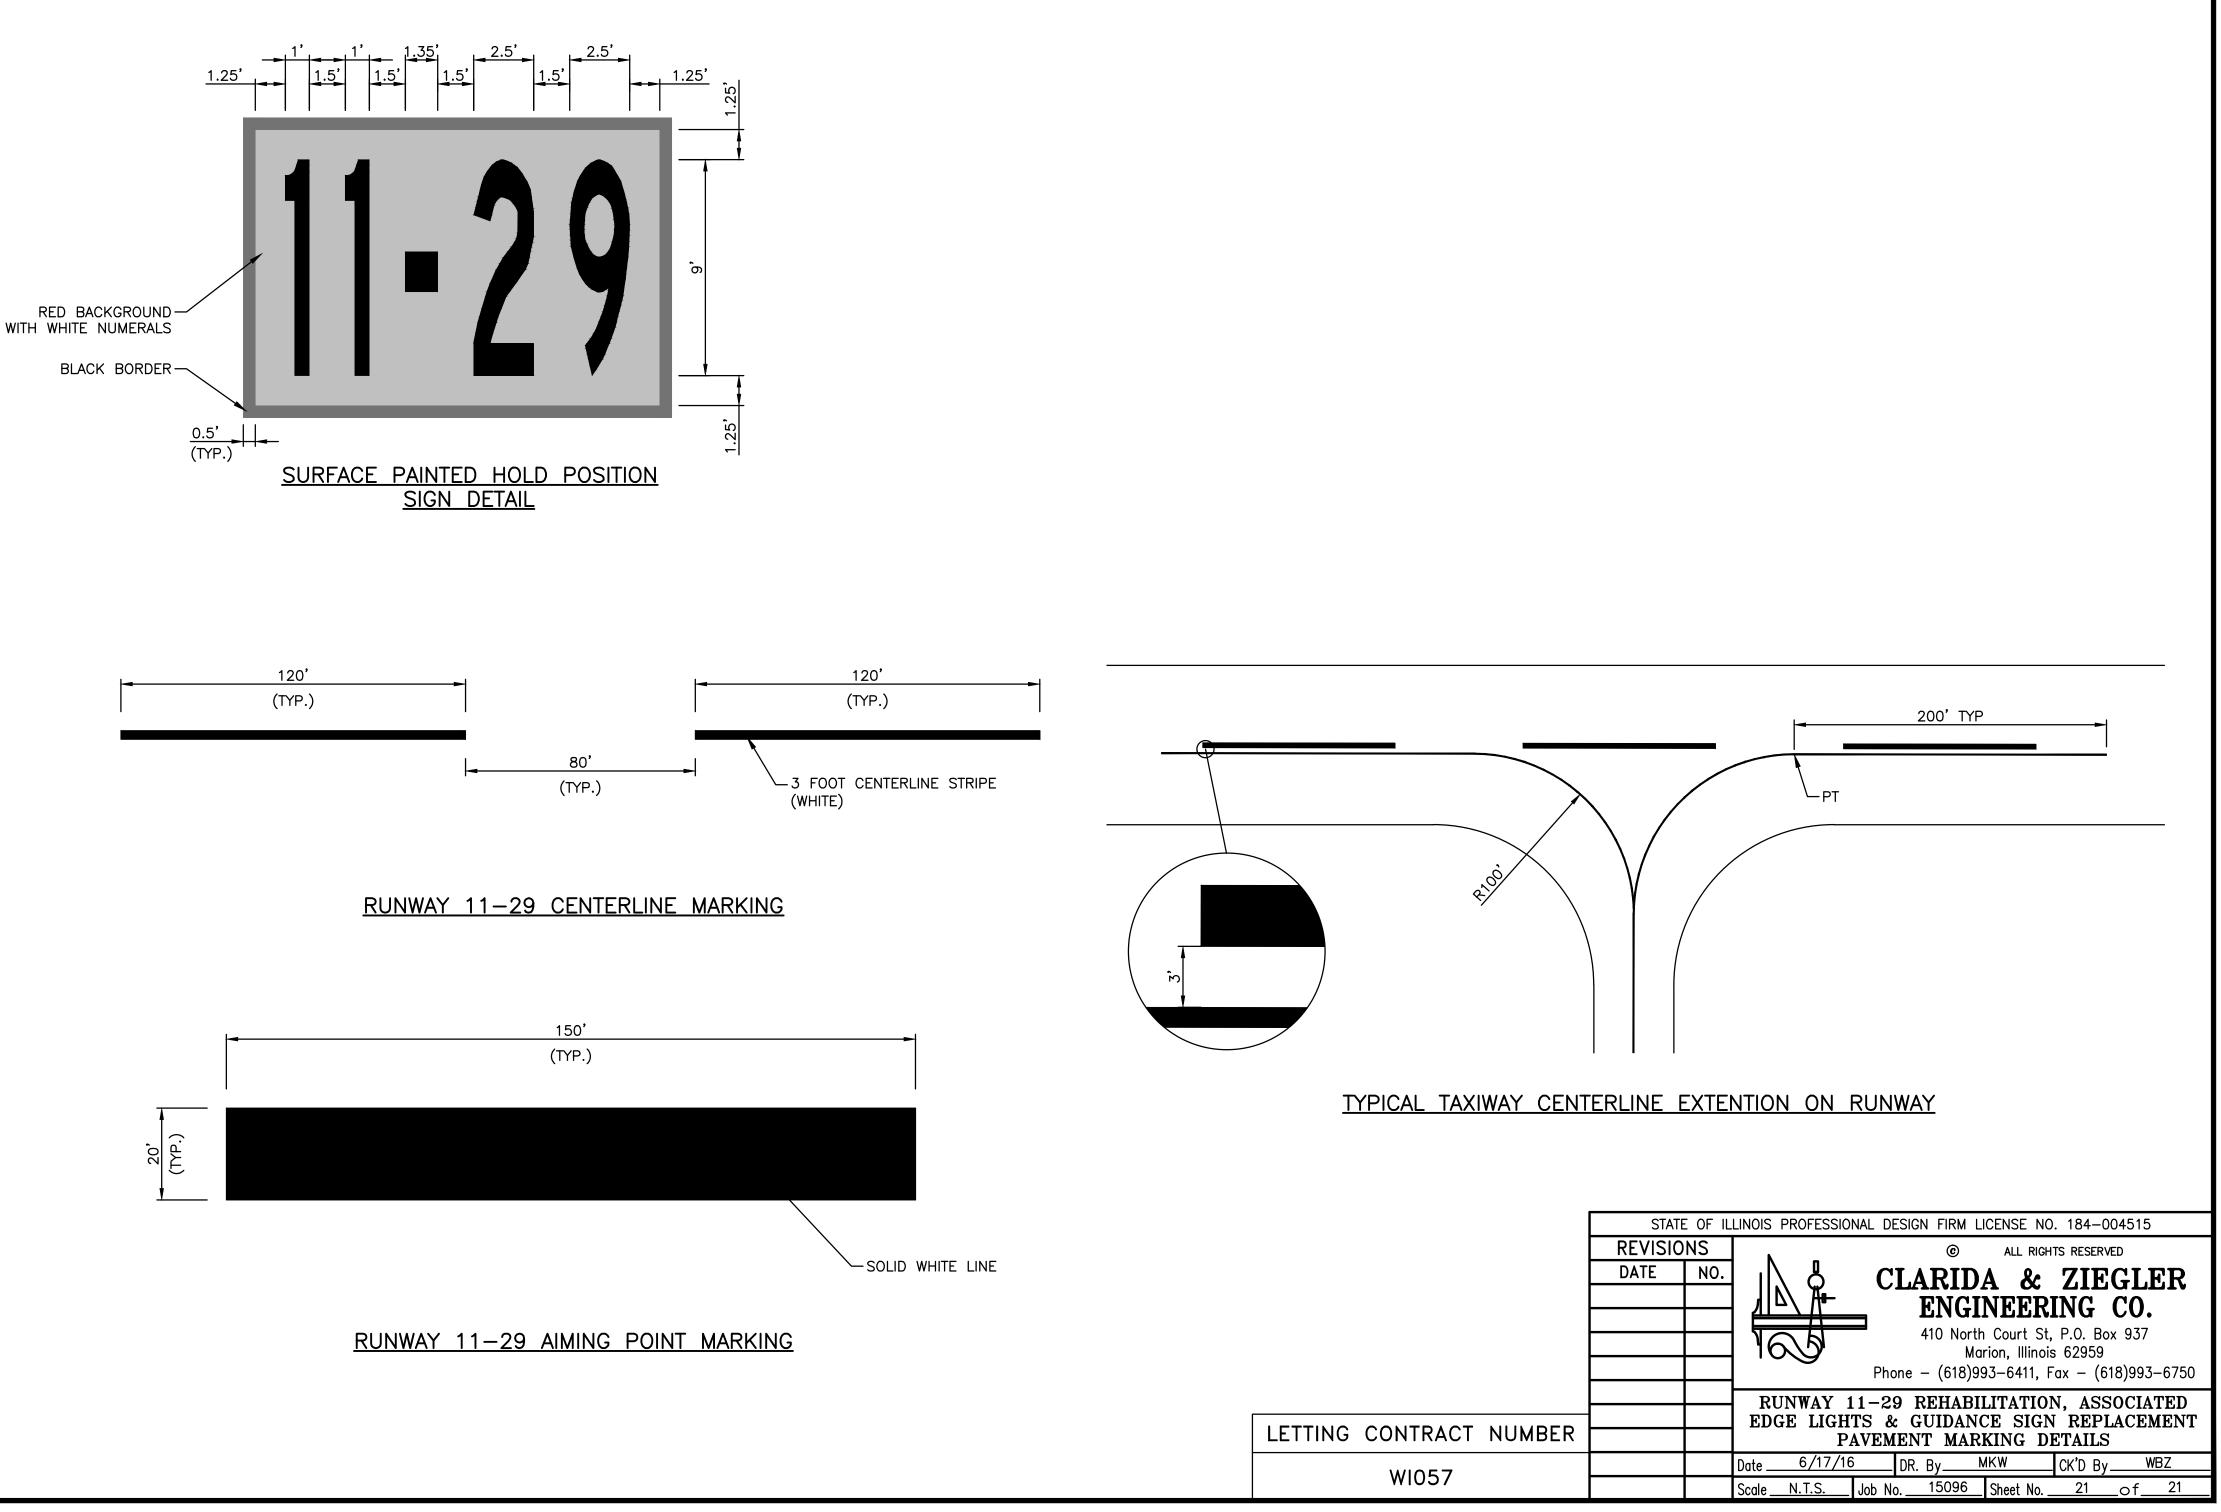

## **PAVEMENT MARKING NOTES:**

- 1. IMMEDIATELY PRIOR TO THE APPLICATION OF PAINT, ALL SURFACES SHALL BE DRY AND FREE FROM DIRT, GREASE, OIL, LAITANCE, OR OTHER FOREIGN MATERIAL WHICH WOULD REDUCE THE BOND BETWEEN THE PAINT AND THE PAVEMENT. THIS SHALL INCLUDE PAINTED AREAS ON THE EXISTING PAVEMENT.
- 2. SURFACE PAINTED HOLDING POSITION SIGNS SHALL BE RED BACKGROUND WITH WHITE NUMERALS.
- 3. RUNWAY MARKINGS PAINTED ON CONCRETE SHALL HAVE A 6 INCH BLACK BORDER.
- 4. ALL TAXIWAY MARKINGS SHALL HAVE A 6 INCH BLACK BORDER.