


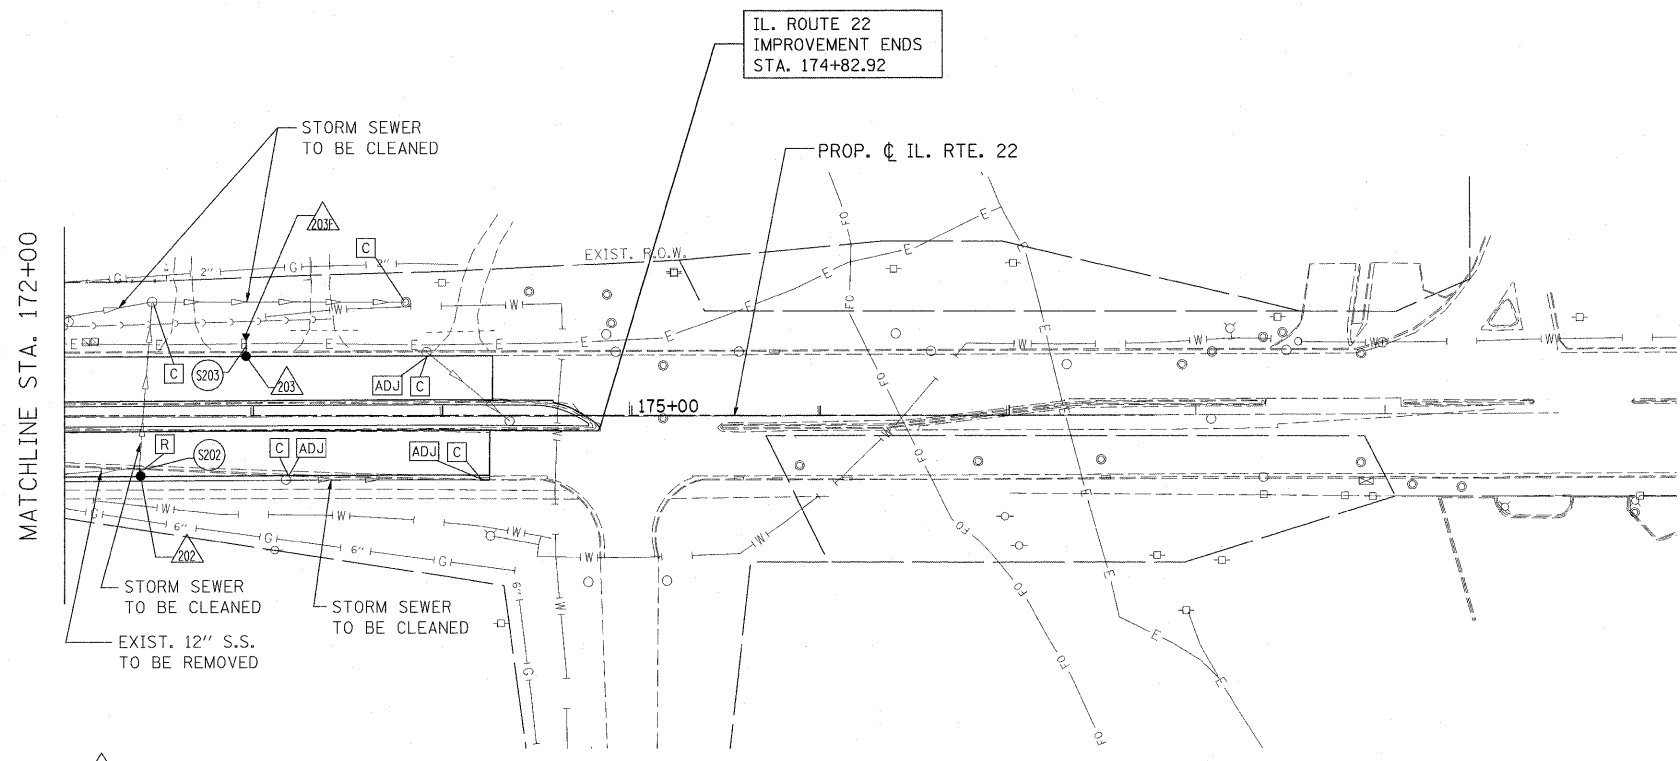

- LEGEND:**
- PROPOSED MANHOLE
 - PROPOSED CATCH BASIN
 - PROPOSED STORM SEWER
 - ▶ PROPOSED FLARED END SECTION
 - ⊙ EXISTING MANHOLE
 - EXISTING CATCH BASIN
 - ⊖ EXISTING INLET
 - ▽ EXISTING FLARED END SECTION
 - EXISTING STORM SEWER
 - - - EXISTING PIPE CULVERT


IL. ROUTE 22
IMPROVEMENT ENDS
STA. 174+82.92



- △ PROPOSED STORM STRUCTURE
- PROPOSED STORM SEWER
- R EXISTING STRUCTURE TO BE REMOVED
- AB EXISTING STORM SEWER TO BE ABANDONED
- ADJ EXISTING STRUCTURE TO BE ADJUSTED
- C EXISTING STRUCTURE TO BE CLEANED

FOR UTILITY INFORMATION ONLY

NOTE:
STORM WATER STRUCTURE OFFSET LOCATIONS GIVEN ON THE DETAILED PLANS ARE TO THE FOLLOWING POINTS: A) FOR STRUCTURES FALLING IN THE CURB LINE - TO THE EDGE OF PAVEMENT; B) FOR ALL OTHER STRUCTURE LOCATIONS - TO THE CENTER OF THE STRUCTURE.

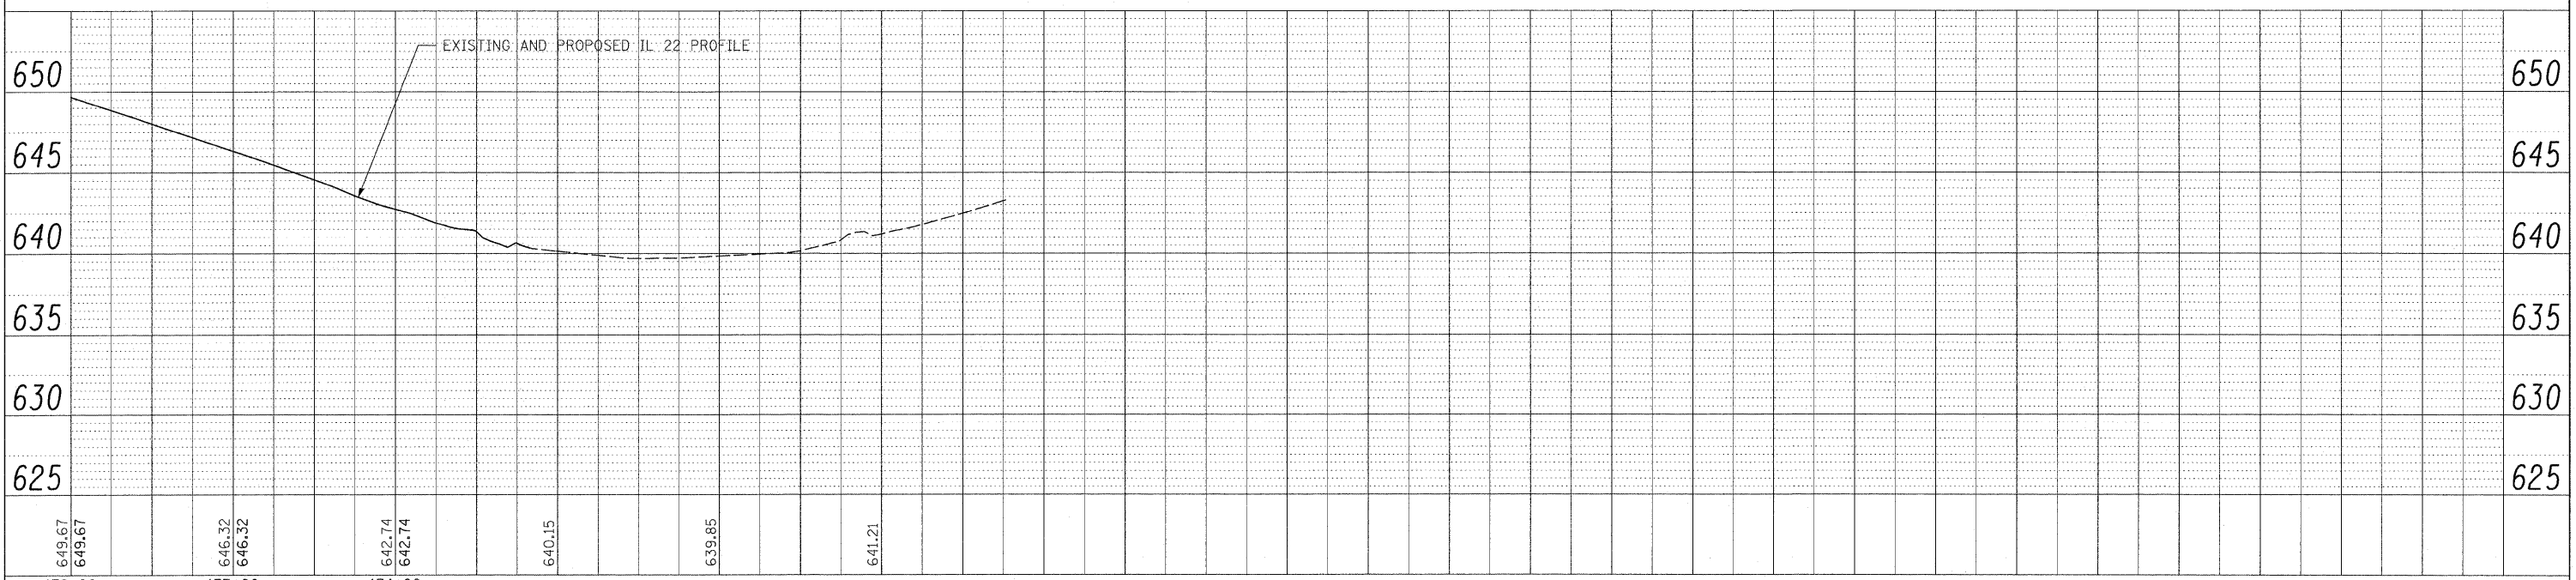

PLAN	REVISIONS	DATE
NO.		
NO.		
FILE	REVISIONS	DATE
NO.		
NO.		
FILE NAME =	USER NAME = #USER#	DESIGNED - LP	REVISED -	<p align="center">STATE OF ILLINOIS DEPARTMENT OF TRANSPORTATION</p>	<p align="center">IL. ROUTE 22 DRAINAGE PLAN AND PROFILE</p>	F.A.P. RTE.	SECTION	COUNTY	TOTAL SHEETS	SHEET NO.
W:\ILRTE22\2009 REVISIONS\Tree Remove\Contract\CADD Sheets\DI60L41-sht-drain.dgn	DRAWN - MC	REVISED -	337			2010-062-DTR	LAKE	56	32	
PLOT SCALE = #SCALE#	CHECKED - JP	REVISED -	CONTRACT NO. 60L41							
PLOT DATE = 5/13/2010	DATE - 05/14/2010	REVISED -	ILLINOIS FED. AID PROJECT							
SCALE: 1"=50'				SHEET NO. 32 OF 56 SHEETS		STA. 172+00 TO STA. 174+26.76				