


LEGEND:

- ⊙ PROPOSED MANHOLE
- PROPOSED CATCH BASIN
- PROPOSED STORM SEWER
- ▶ PROPOSED FLARED END SECTION
- EXISTING MANHOLE
- EXISTING CATCH BASIN
- EXISTING INLET
- ▶ EXISTING FLARED END SECTION
- EXISTING STORM SEWER
- - - EXISTING PIPE CULVERT

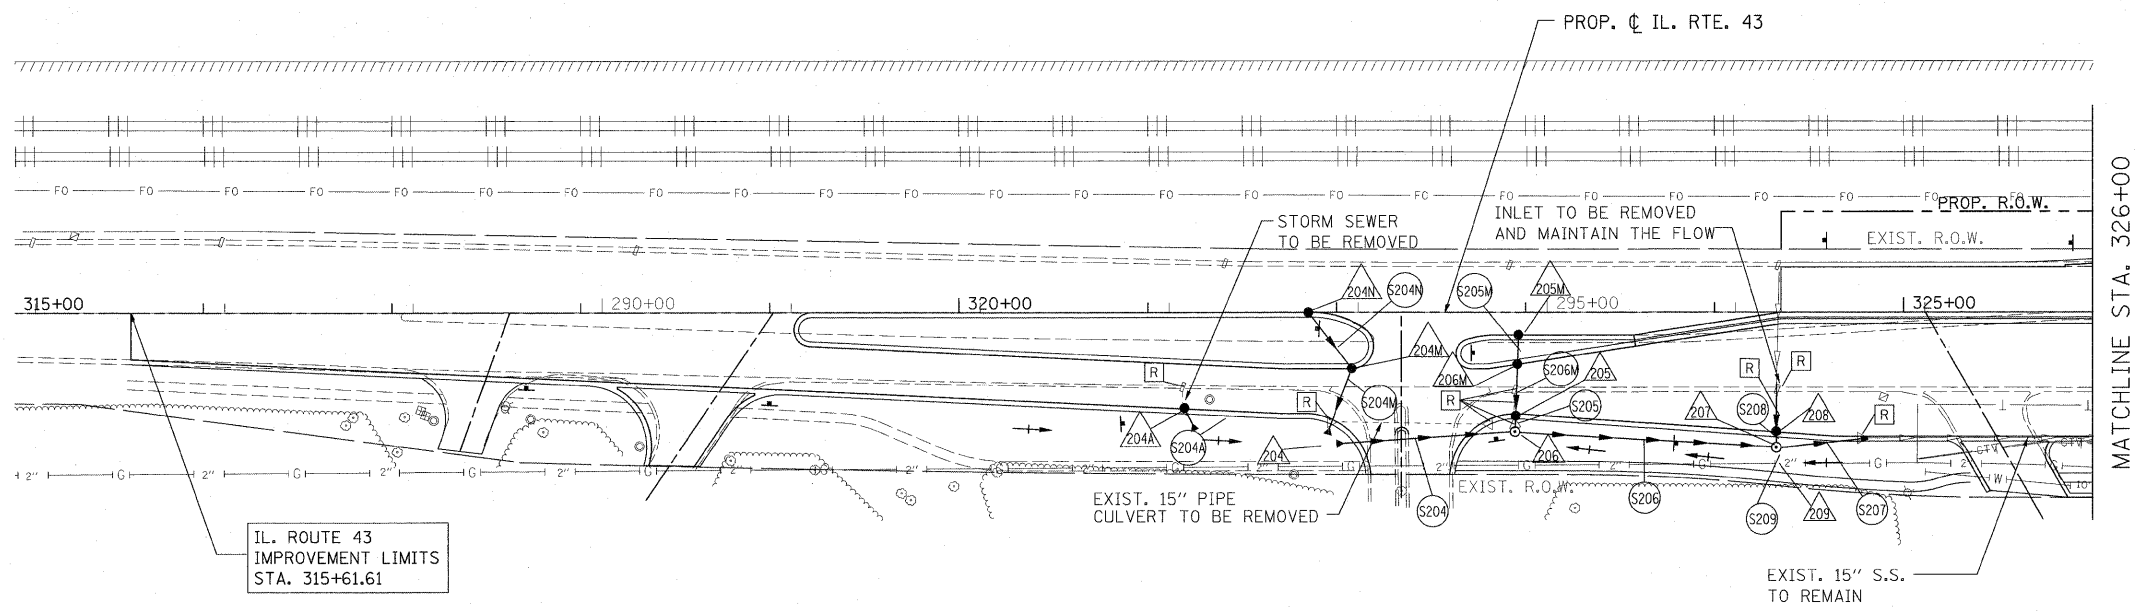


DATE	
BY	
REVISIONS	
FILE	
NO.	
NO.	
NO.	
NO.	
NO.	
NO.	



- ▲ PROPOSED STORM STRUCTURE
- PROPOSED STORM SEWER
- [R] EXISTING STRUCTURE TO BE REMOVED
- [AB] EXISTING STORM SEWER TO BE ABANDONED
- [ADJ] EXISTING STRUCTURE TO BE ADJUSTED
- [C] EXISTING STRUCTURE TO BE CLEANED

FOR UTILITY INFORMATION ONLY

NOTE:
STORM WATER STRUCTURE OFFSET LOCATIONS GIVEN ON THE DETAILED PLANS ARE TO THE FOLLOWING POINTS: A) FOR STRUCTURES FALLING IN THE CURB LINE - TO THE EDGE OF PAVEMENT; B) FOR ALL OTHER STRUCTURE LOCATIONS - TO THE CENTER OF THE STRUCTURE.

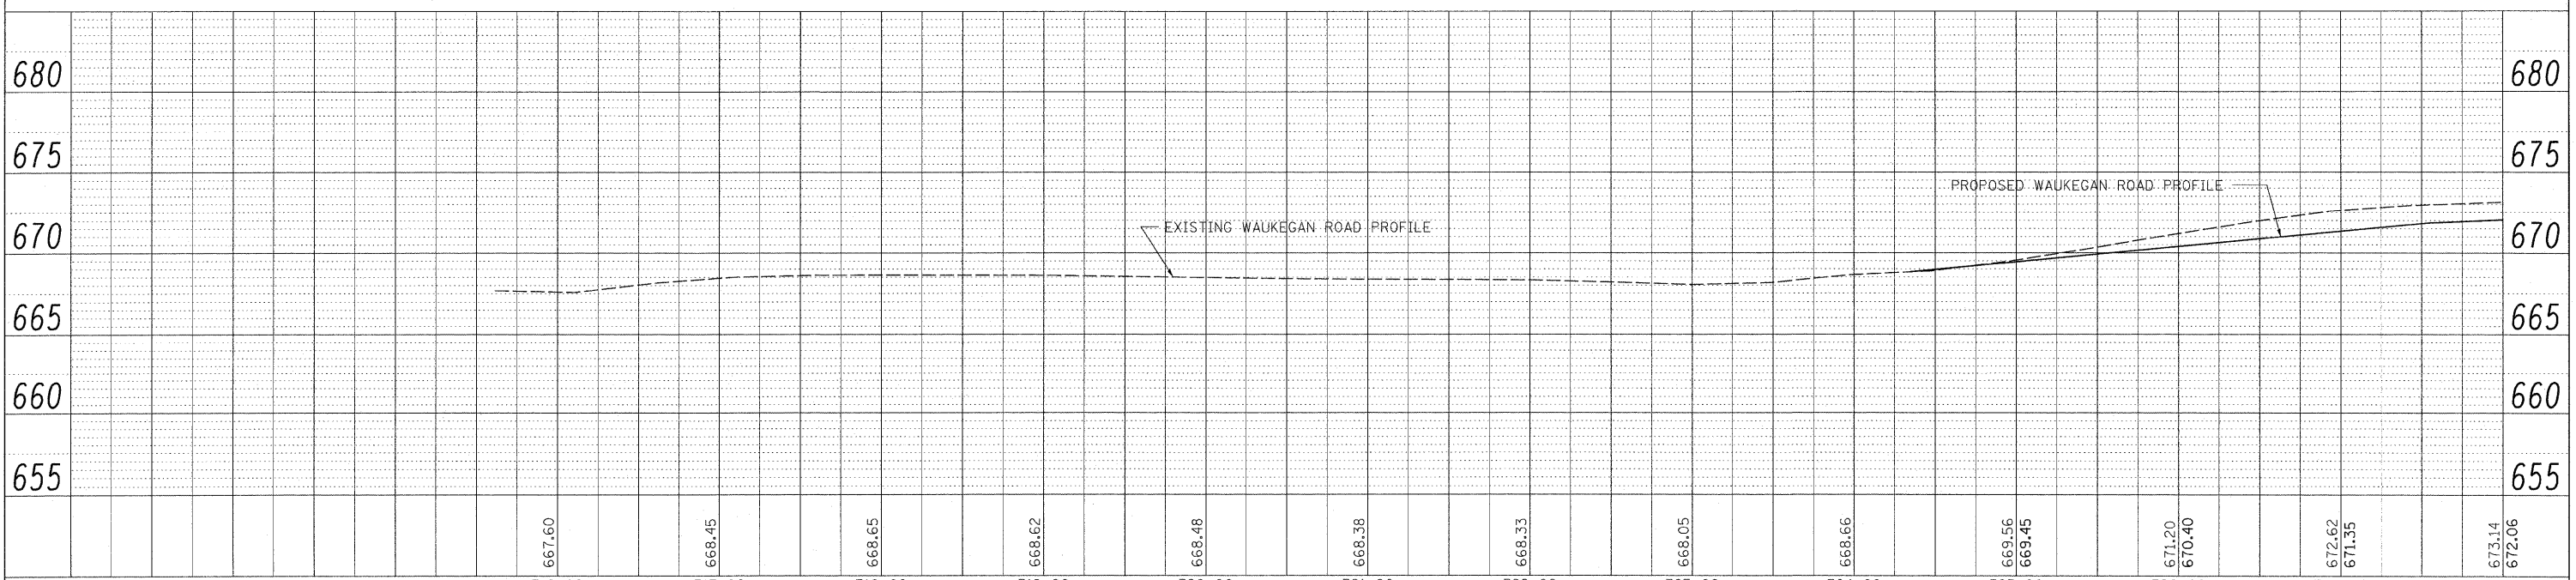

DATE	
BY	
REVISIONS	
FILE	
NO.	
NO.	
NO.	
NO.	
NO.	
NO.	

FILE NAME =	USER NAME = #USER#	DESIGNED - LP	REVISED -	STATE OF ILLINOIS DEPARTMENT OF TRANSPORTATION	WAUKEGAN ROAD DRAINAGE PLAN AND PROFILE	F.A.P. RTE.	SECTION	COUNTY	TOTAL SHEETS	SHEET NO.
W:\L\RT22\2009 REVISIONS\Tree Removal Contract\CADD Sheets\0160L41-shr-drain-wauk.dgn	DRAWN - DC	REVISED -	337			2010-062-DTR	LAKE	56	33	
PLOT SCALE = #SCALE#	CHECKED - JP	REVISED -	CONTRACT NO. 60L41							
PLOT DATE = 5/13/2010	DATE - 05/14/2010	REVISED -	ILLINOIS FED. AID PROJECT							
		SCALE: 1"=50'			SHEET NO. 33 OF 56 SHEETS		STA. 315+61.61 TO STA. 326+00.00			