07-30-2021 LETTING ITEM 054

INDEX OF SHEETS

COVER SHEET GENERAL NOTES 3 & 4 SUMMARY OF QUANTITIES PLAN AND ELEVATION DETAILS ORIGINAL BRIDGE PLANS (SECTION 85-00139-00-BR)-FOR REFERENCE ONLY

SOIL BORINGS B1 AND B2

HIGHWAY STANDARDS

000001-08
STANDARD SYMBOLS, ABBREVIATIONS AND PATTERNS
001001-02
AREAS OF REINFORCEMENT BARS
420001-09
PAYEMENT JOINTS
701901-08
BLR 17-4
BLR 26-3
BLR 23-4
BLR 23-4
BLR 23-4
BLR 26-3
BLR 27-1
BLR 26-1
BLR 27-1


FULL SIZE PLANS HAVE BEEN PREPARED USING STANDARD ENGINEERING SCALES. REDUCED SIZED PLANS WILL NOT CONFORM TO STANDARD SCALES. IN MAKING MEASUREMENTS ON REDUCED PLANS, THE ABOVE SCALES MAY BE USED.

JOINT UTILITY LOCATION INFORMATION FOR EXCAVATION 1-800-892-0123 OR 811

STATE OF ILLINOIS **DEPARTMENT OF TRANSPORTATION**

PLANS FOR PROPOSED FEDERAL AID HIGHWAY

FAS 1240 (PERU ROAD) VILLAGE OF SEATONVILLE SECTION 20-00008-00-BR PROJECT UTLN (920) **BUREAU COUNTY** C-93-026-22

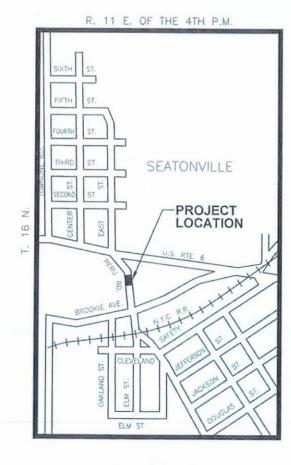

(3)

LOCATION MAP

PROJECT LOCATION MAP

NET LENGTH OF SECTION 122.67' (0.023 MILES) GROSS LENGTH OF SECTION 122.67' (0.023 MILES)

F.A.U. RTE.	SECTION	4	COUNTY	TOTAL	SHEET NO.	
	20-00008-0	00-BR	BUREAU	24	1	
FED. R	DAD DIST. NO	RUNOIS	CONTRAC	T NO. 8	37781	



FUNCTIONAL CLASSIFICATION

MAJOR COLLECTOR ADT = 450 (2017) POSTED SPEED 20 MPH DESIGN SPEED 20 MPH



PROFESSIONAL DESIGN FIRM LICENSE NO. 184-001717

STATE OF ILLINOIS DEPARTMENT OF TRANSPORTATION DIVISION OF HIGHWAYS PRESIDENT, VILLAGE OF SEATONVILLE DISTRICT 3 LOCAL ROADS AND STREETS ENGINEER RELEASED MAY FOR BID BASED ON LIMITED

CONTRACT NO. 87781

REGION 2 ENGINEER

GENERAL NOTES

EXCEPT AS NOTED ON THE PLANS, PAVEMENT GRADES SHOWN ARE AT THE TOP OF PAVEMENT SURFACES.

BEFORE ORDERING PIPE CULVERTS OR PIPE DRAINS, THE CONTRACTOR SHALL CONSULT THE ENGINEER FOR EXACT LENGTHS.

THE FINISHED EARTHWORK SHALL HAVE A VEGETATION SUSTAINING SOIL COVERING THE TOP FOUR INCHES (100 MILLIMETERS) IN AREAS TO BE SEEDED OR SODDED. THE VEGETATION SUSTAINING SOIL REQUIRED WILL NOT BE PAID FOR SEPARATELY BUT WILL BE INCLUDED IN THE COST OF STRUCTURE EXCAVATION.

THE FOLLOWING RATES OF APPLICATION HAVE BEEN USED IN CALCULATING PLAN QUANTITIES:

	GRANULAR MATERIALS	2.05	TONS / CU YD
	HMA RESURFACING	112	LBS / SQ YD / IN
	SHORT TERM PAVEMENT MARKING	10	FT /100 FT OF APPLICATION
Г	MIX FOR CRACKS, JTS & FLGWYS	0.0003	TONS / SQ YD
	LEVEL BINDER (HAND METHOD)	0.0005	TONS / SQ YD
Г	SUPPLEMENTAL WATERING	3	GAL / SQ YD / APPLICATION
	CALCIUM CHLORIDE	2	LB / SQ YD / APPLICATION
Г	AGGREGATE DITCH CHECKS	5	TONS AGGREGATE

THE WORK REQUIRED TO CONNECT ANY SEWER TO AN EXISTING DRAINAGE STRUCTURE OR PIPE WILL NOT BE PAID FOR SEPARATELY, BUT WILL BE CONSIDERED AS INCLUDED IN THE CONTRACT UNIT PRICE BID FOR THE SEWER ITEMS.

MEMBERS OF JULIE KNOWN TO BE WITHIN THE LIMITS OF THE IMPROVEMENT ARE:

AT&T AMEREN ILLINOIS FRONTIER COMMUNICATIONS

DUE TO THE CONFIGURATION OF THE EXISTING STRUCTURE, EXCAVATION BEHIND THE NORTH AND SOUTH ABUTMENT MUST BE COMPLETED SIMULTANEOUSLY SUCH THAT THE HEIGHT OF FILL BEHIND EACH ABUTMENT IS NEARLY EQUAL AT ANY GIVEN TIME. IN ORDER TO SAFEGUARD AGAINST COLLAPSE OF THE STRUCTURE, THE DIFFERENCE IN BACKFILL ELEVATION BEHIND THE NORTH AND SOUTH ABUTMENTS MUST NOT BE GREATER THAN 3' AT ANY GIVEN TIME DURING THE COURSE OF THE WORK.

AS SPECIFIED ABOVE FOR EXCAVATION, BACKFILLING BEHIND THE NORTH AND SOUTH ABUTMENT MUST BE COMPLETED SIMULTANEOUSLY SUCH THAT THE HEIGHT OF FILL BEHIND EACH ABUTMENT IS NEARLY EQUAL AT ANY GIVEN TIME. IN ORDER TO SAFEGUARD AGAINST COLLAPSE OF THE STRUCTURE, THE DIFFERENCE IN BACKFILL ELEVATION BEHIND THE NORTH AND SOUTH ABUTMENTS MUST NOT BE GREATER THAN 3° AT ANY GIVEN TIME DURING THE COURSE OF THE WORK.

TEMPORARY COFFERDAMS AND DEWATERING

ALL WORK NECESSARY TO ENSURE THAT THE SEAL COAT CONCRETE CAN BE PLACED IN SUBSTANTIALLY DRY CONDITIONS BENEATH UNDERMINED AREAS OF FOUNDATIONS SHALL BE PAID AT THE CONTRACT UNIT PRICE PER CUBIC YARD FOR CONCRETE SEAL COAT. THIS WORK SHALL INCLUDE THE CONSTRUCTION OF A SUBSTANTIALLY WATER-TIGHT BARRIER OR "COFFERDAM" BETWEEN THE STREAM AND THE UNDERMINED AREA. IT WILL BE THE CONTRACTOR'S RESPONSIBILITY TO PROPOSE A METHOD TO CREATE THE BARRIER AND TO IMPLEMENT ITS CONSTRUCTION. CONTRACTOR SHALL ALSO BE RESPONSIBLE FOR DEWATERING THE UNDERMINED AREA AND MAINTAINING A DEWATERED CONDITION IN THE UNDERMINED AREA THROUGH THE USE OF SUMPS AND PUMPS OR OTHER SUITABLE MEANS UNTIL SUCH TIME THAT THE SEAL COAT CONCRETE HAS BEEN PLACED AND HAS OBTAINED ITS INITIAL SET. SAND BAGGING MAY BE A VIABLE OPTION.

CONTRACT NO. 87781

SHEET 2

24

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	DRAWN BY: NV	LEVEL	BY	DATE	DESCRIPTION		- 4
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うる						4	
	DATE: 02/20					Chamli	lin



PERU MORRIS OTTAWA MENDOTA ILLINOIS

VILLAGE OF SEATONVILLE PERU ROAD BRIDGE REPAIR SECTION 20-00008-00-BR

GENERAL NOTES

NSTRUCTION	CURRENT AS OF: 05/20/2	021
INOTINUOTION	SCALE: AS NOTED	SHEET
PLANS	FILE NO.: 11593.03 Y-	OF

CONSTRUCTION CODE 0006

CODE NO	ITEM	UNIT	TOTAL QUANTITY
20300200	ROCK EXCAVATION IN CHANNEL	CUYD	10
25000210	SEEDING, CLASS 2A	ACRE	0.25
25000400	NITROGEN FERTILIZER NUTRIENT	POUND	25
25000500	PHOSPHORUS FERTILIZER NUTRIENT	POUND	25
25000600	POTASSIUM FERTILIZER NUTRIENT	POUND	25
25100630	EROSION CONTROL BLANKET	SQ YD	63
31101200	SUBBASE GRANULAR MATERIAL, TYPE B 4"	SQYD	258
42400200	PORTLAND CEMENT CONCRETE SIDEWALK 5 INCH	SQFT	400
44000100	PAVEMENT REMOVAL	SQYD	254
44000600	SIDEWALK REMOVAL	SQFT	400
48101200	AGGREGATE SHOULDERS, TYPE B	TON	36
48301000	PROTECTIVE COAT	SQYD	258
50105220	PIPE CULVERT REMOVAL	FOOT	60
50200100	STRUCTURE EXCAVATION	CUYD	1050

 Δ - SPECIAL PROVISION

CONTRACT NO. 87781

AWN BY: NV				REVISIONS	٠.
3000 01.100	LEVEL	BY	DATE	DESCRIPTION	á
ECKED BY: AJO					
					٦
TE: 02/20					C

CONSTRUCTION CODE 0006

			CONSTRUCTI	ON CODE 0008
	CODE NO.	ITEM	UNIT	TOTAL QUANTITY
	50300265	SEAL COAT CONCRETE	CUYD	88
	30300203	SEAL CONT CONCRETE	0018	00
Δ	550B0050	STORM SEWERS, CLASS B, TYPE 1 12"	FOOT	30
Δ	550B0120	STORM SEWERS, CLASS B, TYPE 1 24*	FOOT	30
	58600101	GRANULAR BACKFILL FOR STRUCTURES	CUYD	950
	59100100	GEOCOMPOSITE WALL DRAIN	SQ YD	240
	60100085	GEOTECHNICAL FABRIC FOR FRENCH DRAINS	SQ YD	800
	67100100	MOBILIZATION	L SUM	1
	63301210	REMOVE AND REERECT STEEL PLATE BEAM GUARDRAIL, TYPE A	FOOT	50
	63302400	REMOVE AND REERECT TRAFFIC BARRIER TERMINALS, TYPE 5	EACH	4
Δ	X0322906	WEEP HOLES CORED	EACH	3
Δ	X2200020	FENCE REMOVAL AND REINSTALLATION	FOOT	65
Δ	X4200412	PORTLAND CEMENT CONCRETE PAVEMENT 12", SPECIAL	QY DS	214
Δ	X7010216	TRAFFIC CONTROL AND PROTECTION, (SPECIAL)	L SUM	1

 Δ - SPECIAL PROVISION

* - SPECIALTY ITEMS

CONTRACT NO. 87781

DRAWN BY: NV CHECKED BY: AJO


PERU MORRIS OTTAWA MENDOTA ILLINOIS


VILLAGE OF SEATONVILLE PERU ROAD BRIDGE REPAIR SECTION 20-00008-00-BR

SUMMARY OF QUANTITIES

CONSTRUCTION SCALE: AS NOTED FILE NO.: 11593.03 Y-

CURRENT AS OF: 05/20/2021

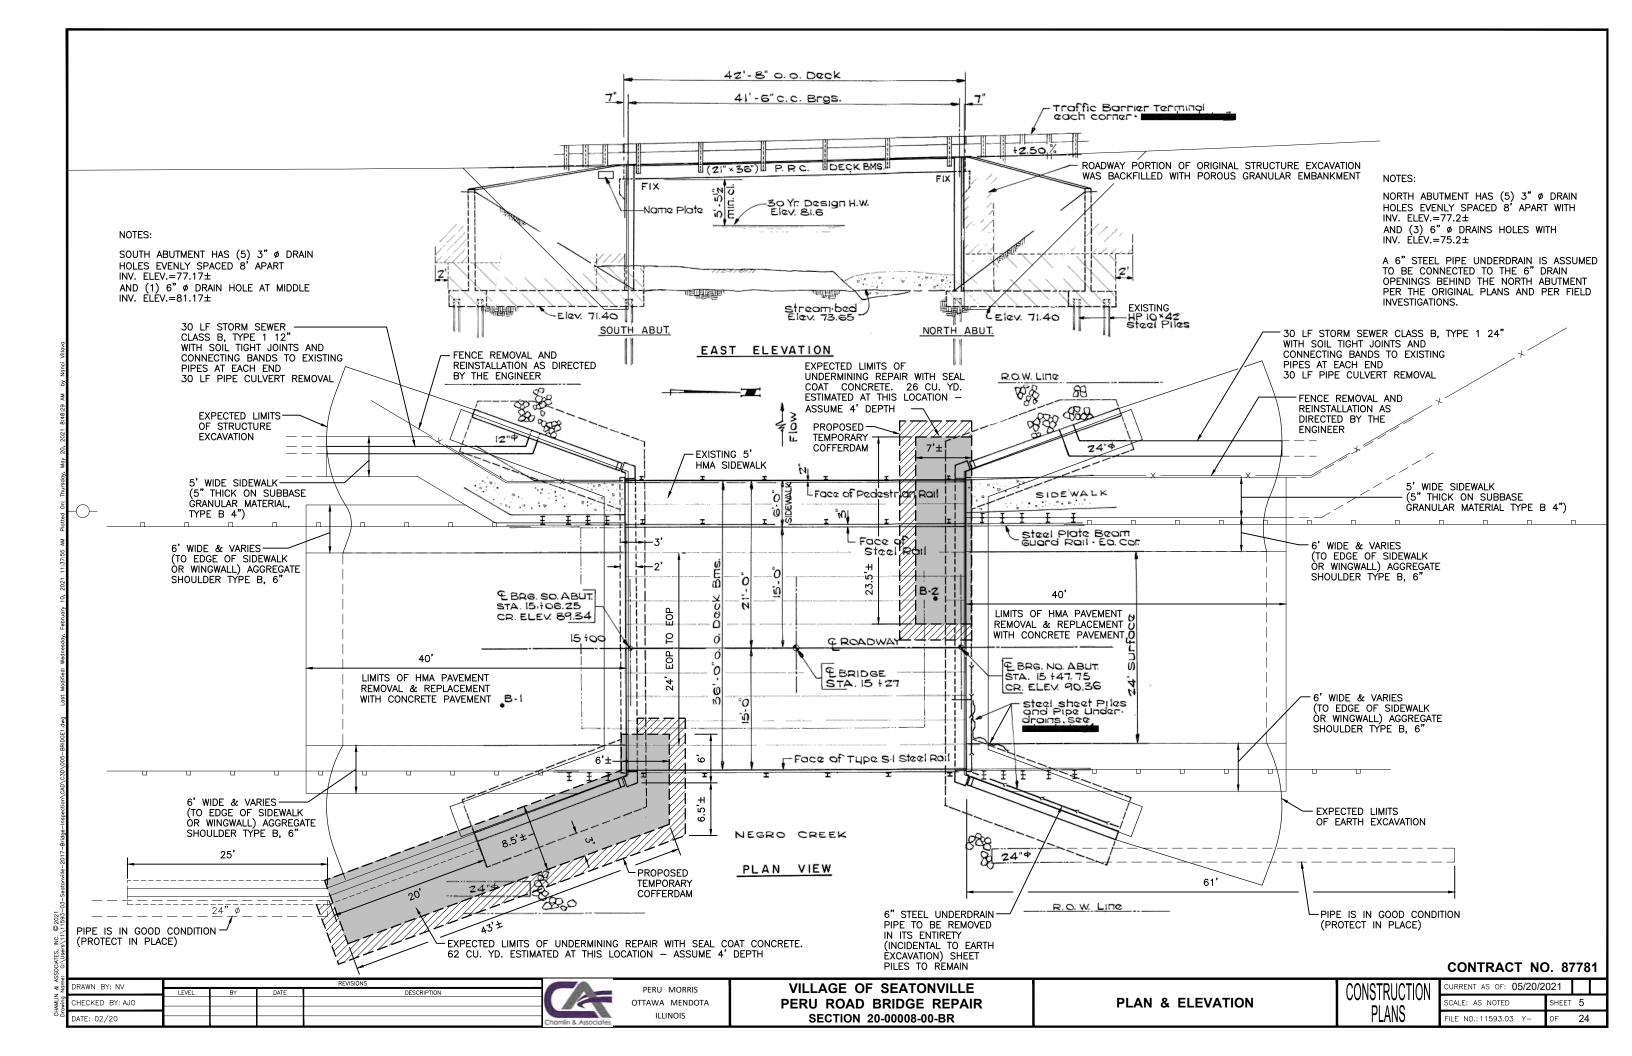

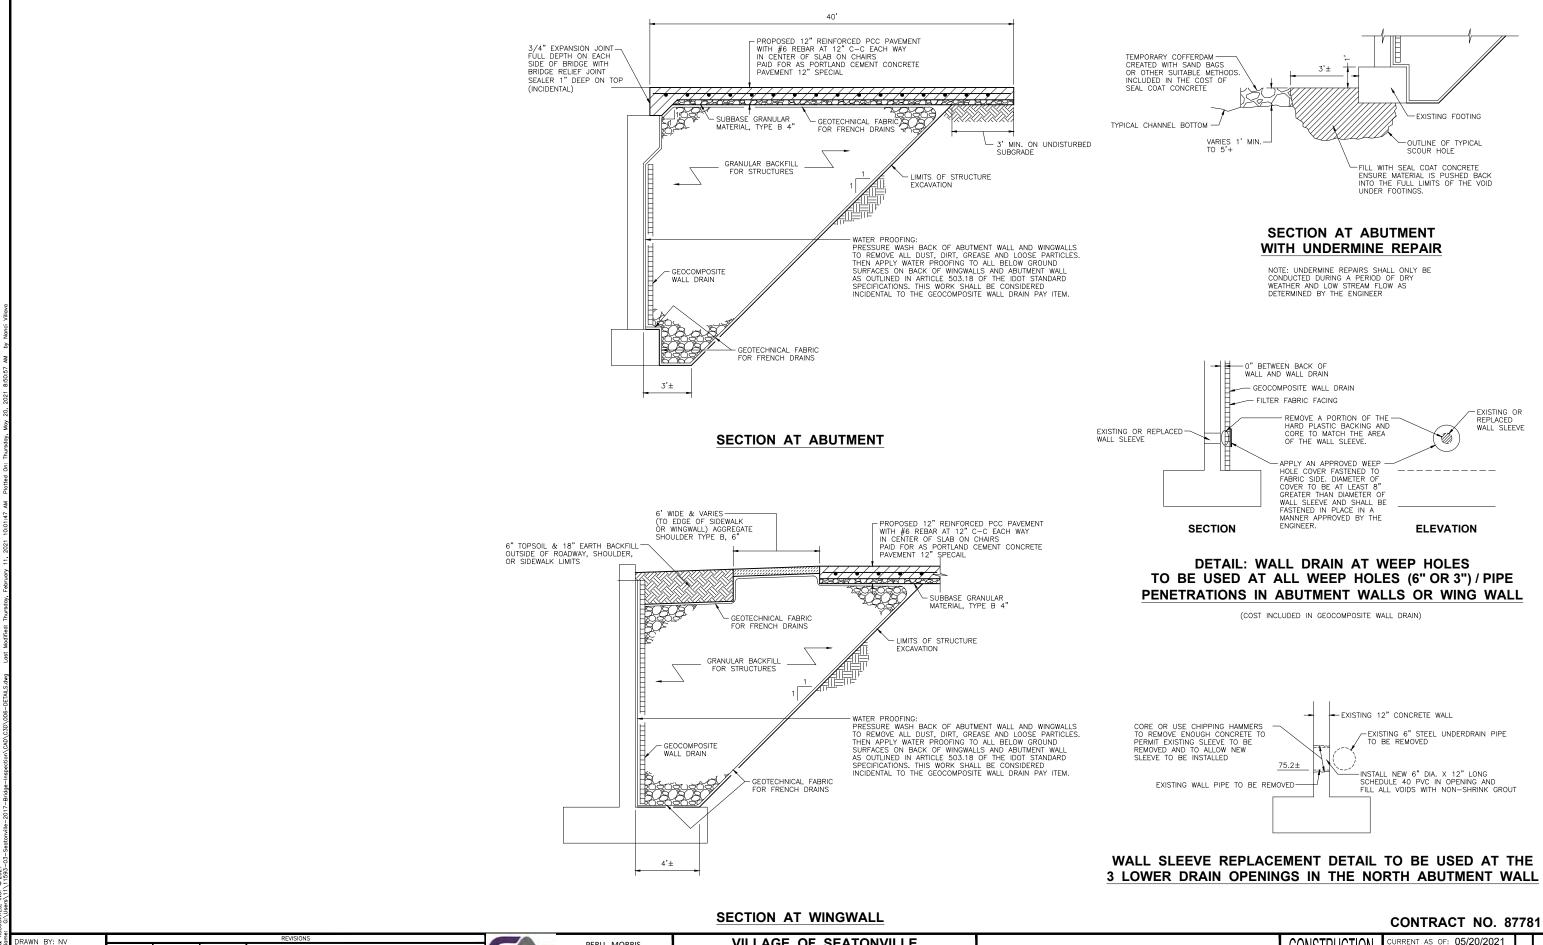

CHAMLIN & ASSOCIATES, INC
Drawing Name: G:\Users\1

HECKED BY: AJO

DATE: 02/20

PERU MORRIS OTTAWA MENDOTA ILLINOIS VILLAGE OF SEATONVILLE PERU ROAD BRIDGE REPAIR SECTION 20-00008-00-BR

DETAILS

ONSTRUCTION CURRENT SCALE: A

CURRENT AS OF: 05/20/2021

SCALE: AS NOTED SHEET 6

FILE NO.:11593.03 Y- OF 24

STATE OF ILLINOIS DEPARTMENT OF TRANSPORTATION

PLANS FOR PROPOSED LOCAL AGENCY IMPROVEMENT FEDERAL-AID BRRP PROJECT

PLAN I INCH = 20 FEET
PROFILE HOR. I INCH = 20 FEET
PROFILE VERT. I INCH = 5 FEET
CROSS SECTIONS I INCH = 5 FEET

INDEX OF SHEETS

- COVER SHEET
- SUMMARY OF QUANTITIES
- TYPICAL SECTIONS AND SCHEDULES
- PLAN AND PROFILE
- GENERAL PLAN AND ELEVATION
- DECK BEAM DETAILS
- STEEL RAILING TYPE S-1
- INTERIOR TRAFFIC RAIL
- STEEL PEDESTRIAN RAIL
- SOUTH ABUTMENT DETAILS
- NORTH ABUTMENT DETAILS
- PILING LAYOUT AND PIPE UNDERDRAINS

STEEL DITCH CHECKS

STANDARD 2230-14(1 4 2) STEEL PLATE BEAM GUARD RAIL

STANDARD 2336-3 TRAFFIC BARRIER TERMINAL TYPE 1 & 1A

STANDARD 2340-4 TRAFFIC BARRIER TERMINAL TYPE 5 & 5A

TRAFFIC CONTROL

STANDARD 2298-7(1 & 2) TRAFFIC CONTROL

STANDARD 2299-10 TRAFFIC CONTROL

STANDARD 2300-3 TRAFFIC CONTROL

STANDARD 2302-5 TRAFFIC CONTROL

STANDARD 2303-6

STANDARD 2305-5 TRAFFIC CONTROL

STANDARD 2307-6 TRAFFIC CONTROL STANDARD BLR 21-1

STANDARD 2381 TEMPORARY EROSION CONTROL

BRIDGE REPLACEMENT & REHABILITATION PROGRAM

SECTION 85-00139 - 00-BR

BUREAU COUNTY


PROJECT BR - OS - OII (28)

C. H. NO. 14 EXT.

VILLAGE OF SEATONVILLE

1987

NET LENGTH 60.0 FEET = 0.0114 MILES

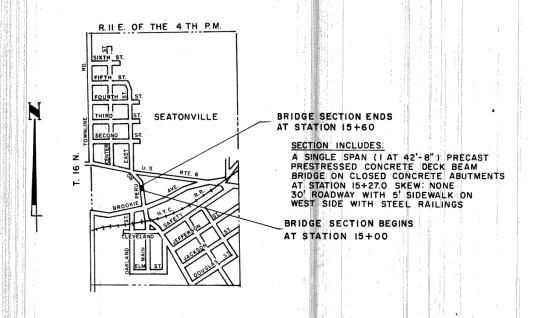

LOCATION MAP

JOB NO. C - 92 - 119 - 86 CONTRACT NO.

ADT = 700CLASS E DESIGN 30 MPH

800-892-0123



THE ACCEPTANCE OF THIS PROJECT IS BASED ON THE MINIMUM DESIGN CRITERIA FOR A FEDERAL AID BRIDGE REPLACEMENT IMPROVEMENT.

DISTRICT ENGINEER OF LOCAL ROADS & STREETS

APPROVED LOCAL AGENCY OFFICIAL

PÁSSED

DISTRICT ENGINEER

CONTRACT NO. 8778

ATE: 2/2021



OTTAWA MENDOTA ILLINOIS

VILLAGE OF SEATONVILLE PERU ROAD BRIDGE REPAIR **SECTION 20-00008-00-BR**

EXISTING PLANS FOR INFORMATION ONLY

CURRENT AS OF: 05/20/2021 SCALE: AS NOTED TLE NO.: 11593.03 Y-

SUMMARY OF QUANTITIES

SECTION
SHEET
S5-00139-00-BR
Z OF 15
COUNTY
BUREAU
PROJECT BR-OS-011 (28)

		NON			
CODE NO.	PARTICIPATING	PARTICIPATING	TOTAL	UNIT	DESCRIPTION
20100100	118	154	272 ^	IN DIA	TREE REMOVAL (6 TO 15 INCH DIAMETER)
20200100	156	259	415	CU YD	EARTH EXCAVATION
20300100	75		75	CU YD	CHANNEL EXCAVATION
20900200	486		486	CU YD	POROUS GRANULAR EMBANKMENT .
30101400	242	81	323	TON	AGGREGATE BASE COURSE, TYPE B
40600100	177	95	272	GAL	BITUMINOUS MATERIALS (PRIME COAT)
40600700	29	128	157	TON	BITUMINOUS CONCRETE BINDER COURSE
40601300	35	87	122	TON	BITUMINOUS CÓNCRETE SURFACE COURSE, MIXTURE D, CLASS I
50100100	1		1	EACH	REMOVAL OF EXISTING STRUCTURES
50200300	360		360	CU YD	COFFERDAM EXCAVATION
50200400	230.2		230.2	CU YD	ROCK EXCAVATION FOR STRUCTURES
50200500	2		2	EACH	COFFERDAMS
50400300	172.8		172.8	CU YD	CLASS X CONCRETE
50400400	5,0		5.0	CU YD	SEAL COAT CONCRETE
50500400	1536		1536	SQ FT	PRECAST PRESTRESSED CONCRETE DECK BEAMS (21" DEPTH)
50800200	43		43	LIN FT	STEEL RAILING TYPE S-1
50800800	43		43	LIN FT	PEDESTRIAN RAIL
50801100	43		43	LIN FT	STEEL RAILING
51100217	32	28	60	LIN FT	PIPE CULVERTS, TYPE 1, 12"
51100229	138		138	LIN FT	PIPE CULVERTS, TYPE 1, 24"
51200100	15310		15310	POUND	REINFORCEMENT BARS
51301400	288		288	LIN FT	FURNISHING STEEL PILES HP 10X42
51302700	288		288	LIN FT	DRIVING STEEL PILES
51303400	2		2	EACH	TEST PILE STEEL HP 10X42
513046ρ0	50		50	EACH	METAL SHOES
51304900	80		80	SQ FT	STEEL SHEET PILING
51400100	1		1	EACH	NAME PLATES
60100610	44		44	SQ YD	STONE DUMPED RIPRAP
60101900		522	522	SQ FT	STEEL DITCH CHECKS
60708700	38		38	LIN FT	PIPE UNDERDRAINS, PERFORATED CORRUGATED STEEL PIPE 6"
61242900		2	2	EACH	INLETS, SPECIAL, TYPE 1
61255500		1	1	EACH	MANHOLES TO BE ADJUSTED
61260100		1	1	EACH	INLETS TO BE ADJUSTED
61500300	I		1	EACH	FILL EXISTING INLETS
61700009		120	120	SQ YD	BITUMINOUS SURFACE REMOVAL 3"
624002\J0	510		510	SQ FT	PORTLAND CEMENT SIDEWALK 5 INCH
62800000	50		50	LIN FT	STEEL PLATE BEAM GUARD RAIL, TYPE A
62800035	4		4	EACH	TRAFFIC BARRIER TERMINAL TYPE 1
62800075	4		4	EACH	TRAFFIC BARRIER TERMINAL TYPE 5A
64201000	0.13	0.30	0.43	ACRE	SEEDING CLASS II SPECIAL
64700100	39	107	146	LIN FT	PAVEMENT MARKING TAPE
Z0042400	470		470	LIN FT	P.C. MORTAR FAIRING COURSE
Z0065000	50		50	EACH	SET PILES IN ROCK
Z0077500	171		171	SQ YD	WATERPROOFING MEMBRANE SYSTEM
T5020200	390	1070	1460	LIN FT	PAINT PAVEMENT MARKING LINE 4"

SUMMARY OF QUANTITIES
SECTION 85-00139-00-BR
SEATONVILLE
BUREAU COUNTY

CONTRACT NO. 87781

| REVISIONS | REVISIONS | | CHECKED BY: --- | DATE | DESCRIPTION | CHECKED BY: --- | DATE: 2/2021 | Checked BY: --- | Checked BY: --- | Checked BY: --- | DATE: 2/2021 | Checked BY: --- | Check

PERU MORRIS
OTTAWA MENDOTA
ILLINOIS

VILLAGE OF SEATONVILLE PERU ROAD BRIDGE REPAIR SECTION 20-00008-00-BR


EXISTING PLANS
FOR INFORMATION ONLY


CONSTRUCTION PLANS


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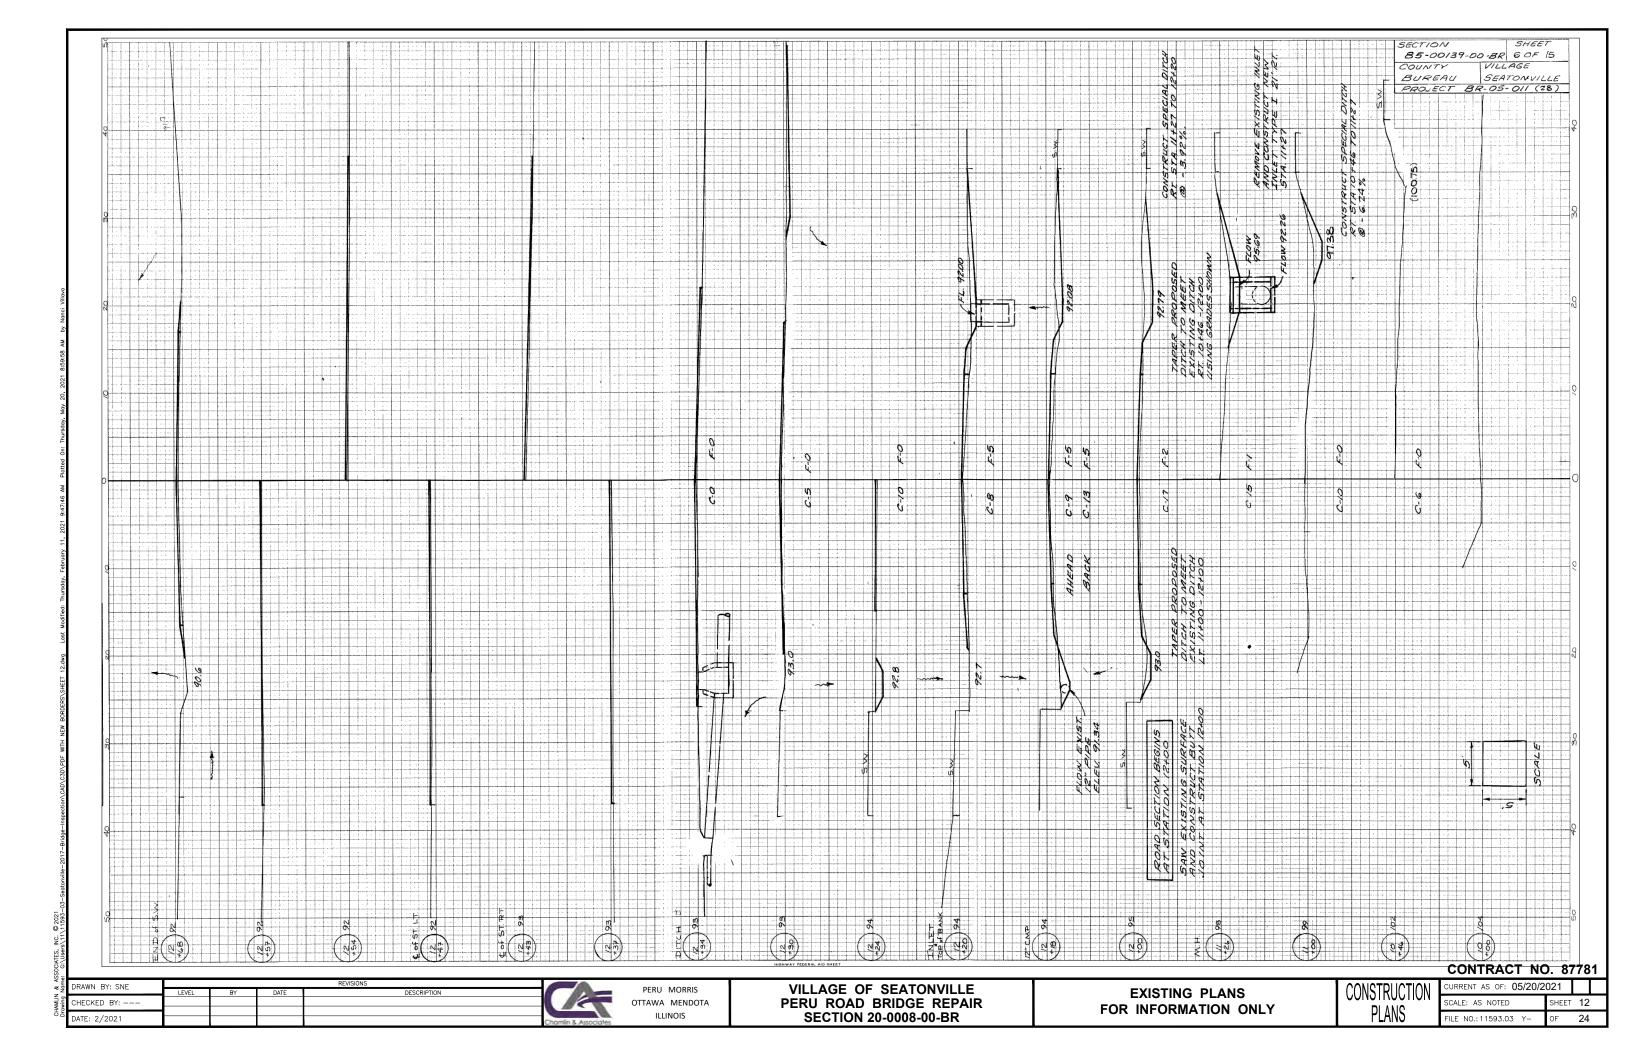
SCALE: AS NOTED SHEET 8


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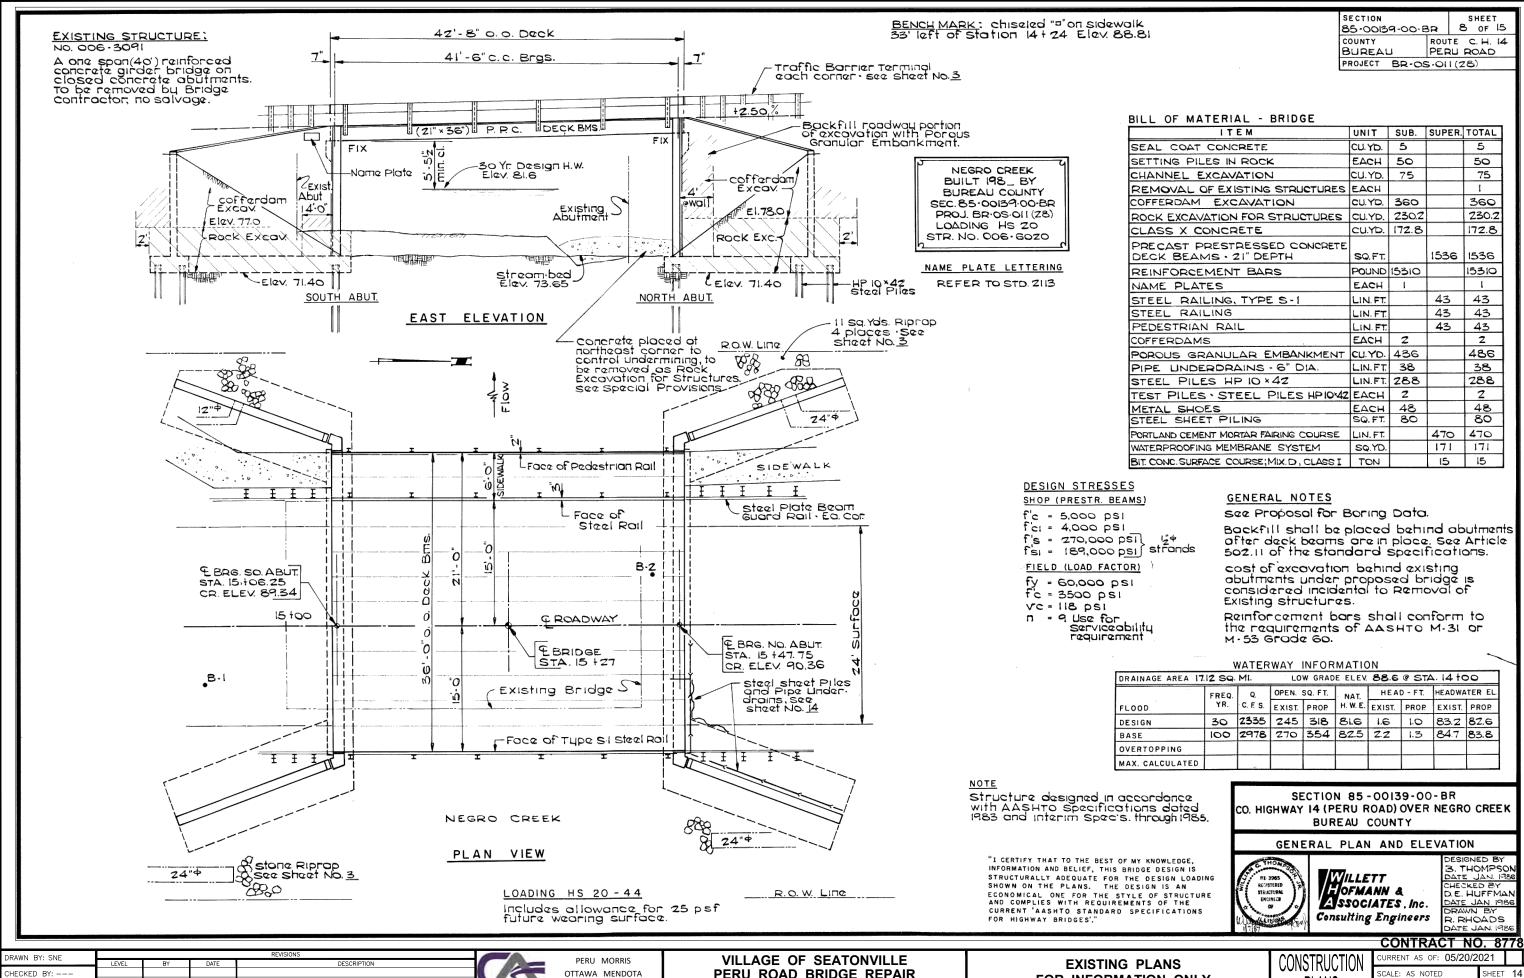




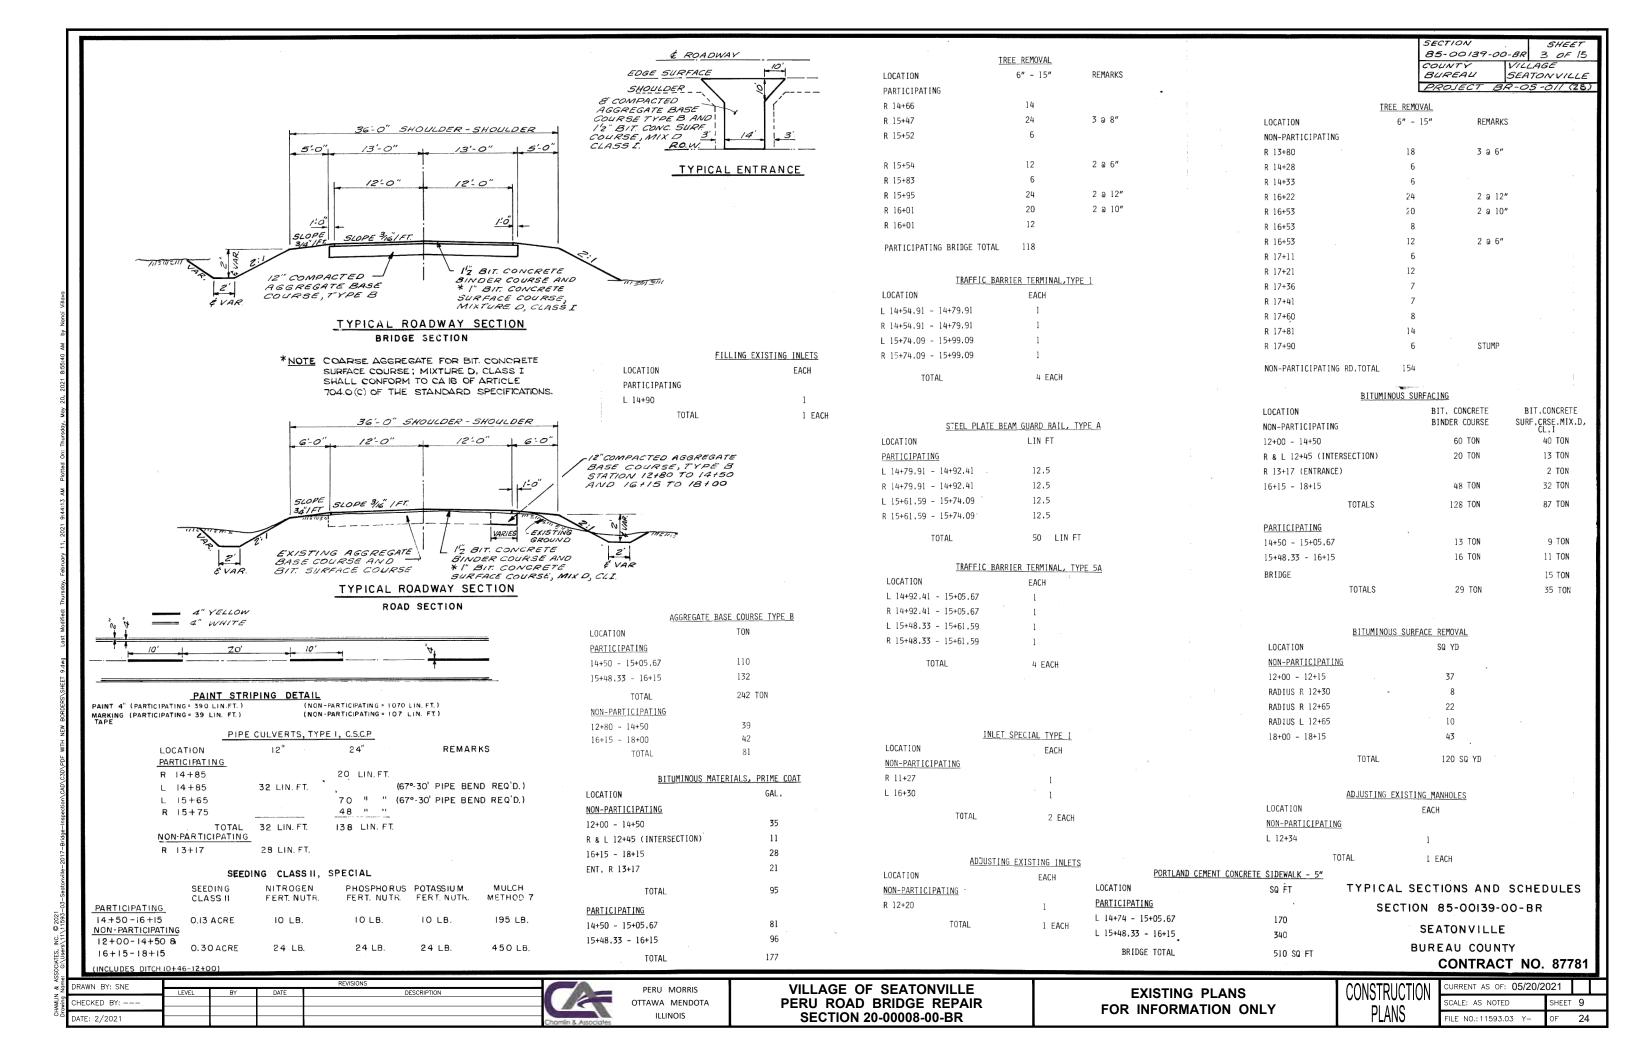

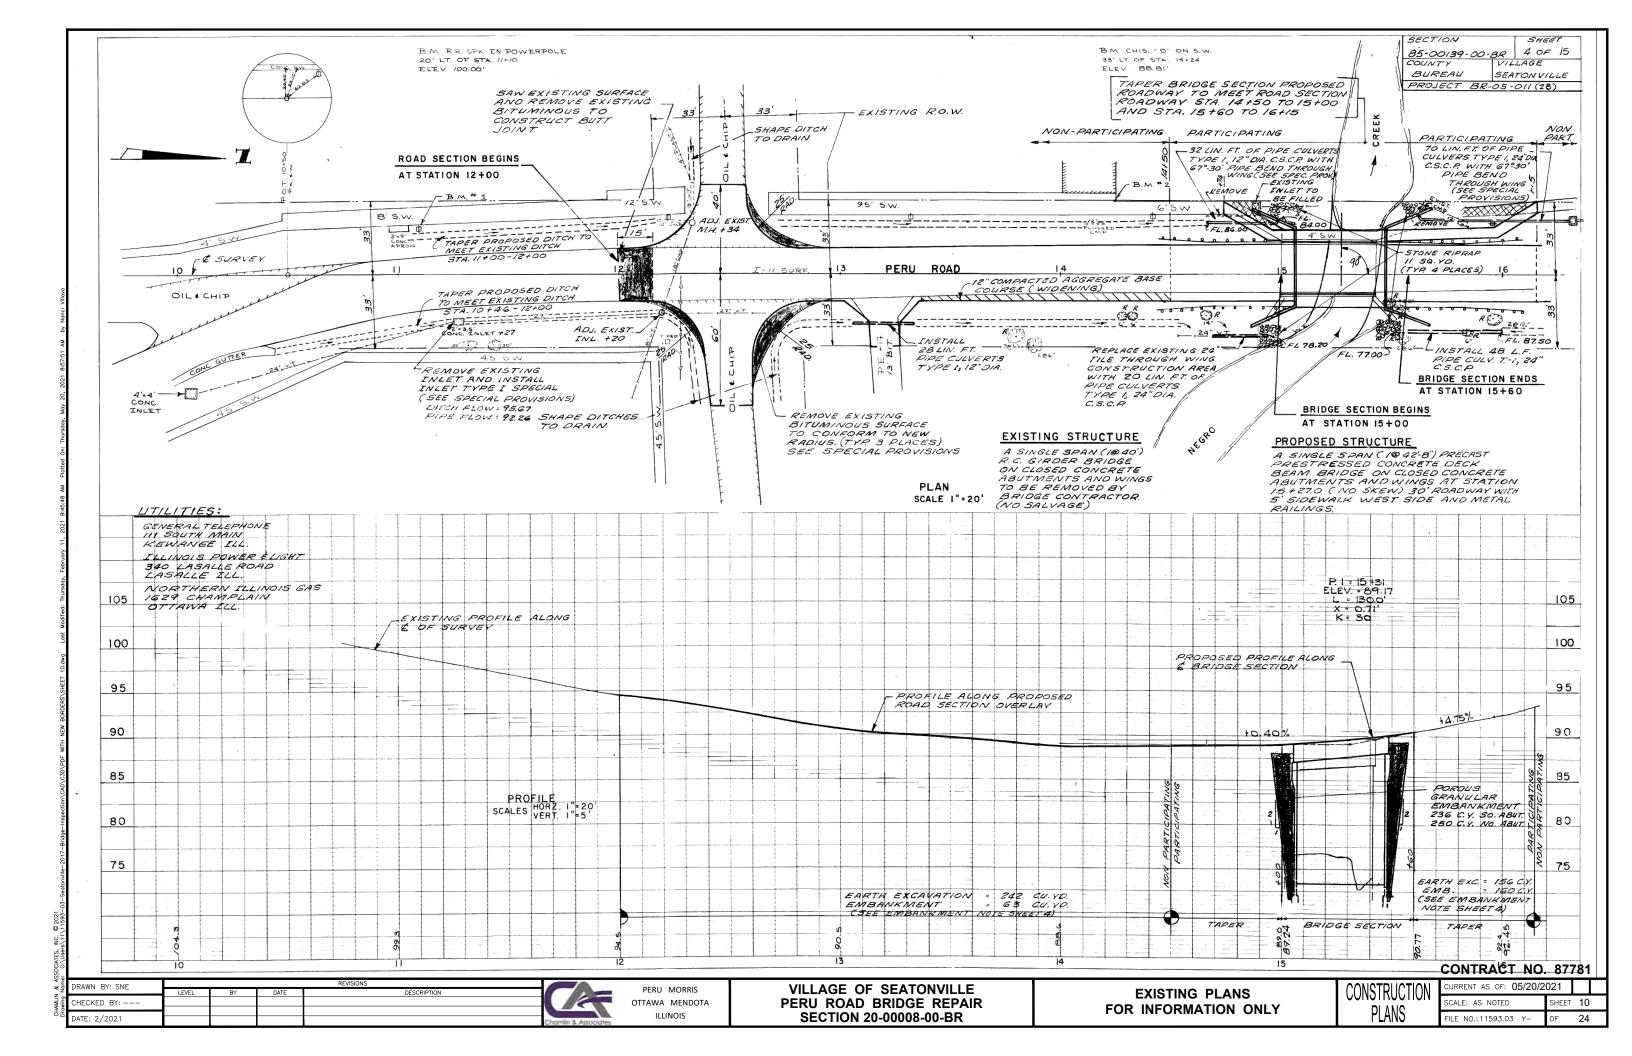

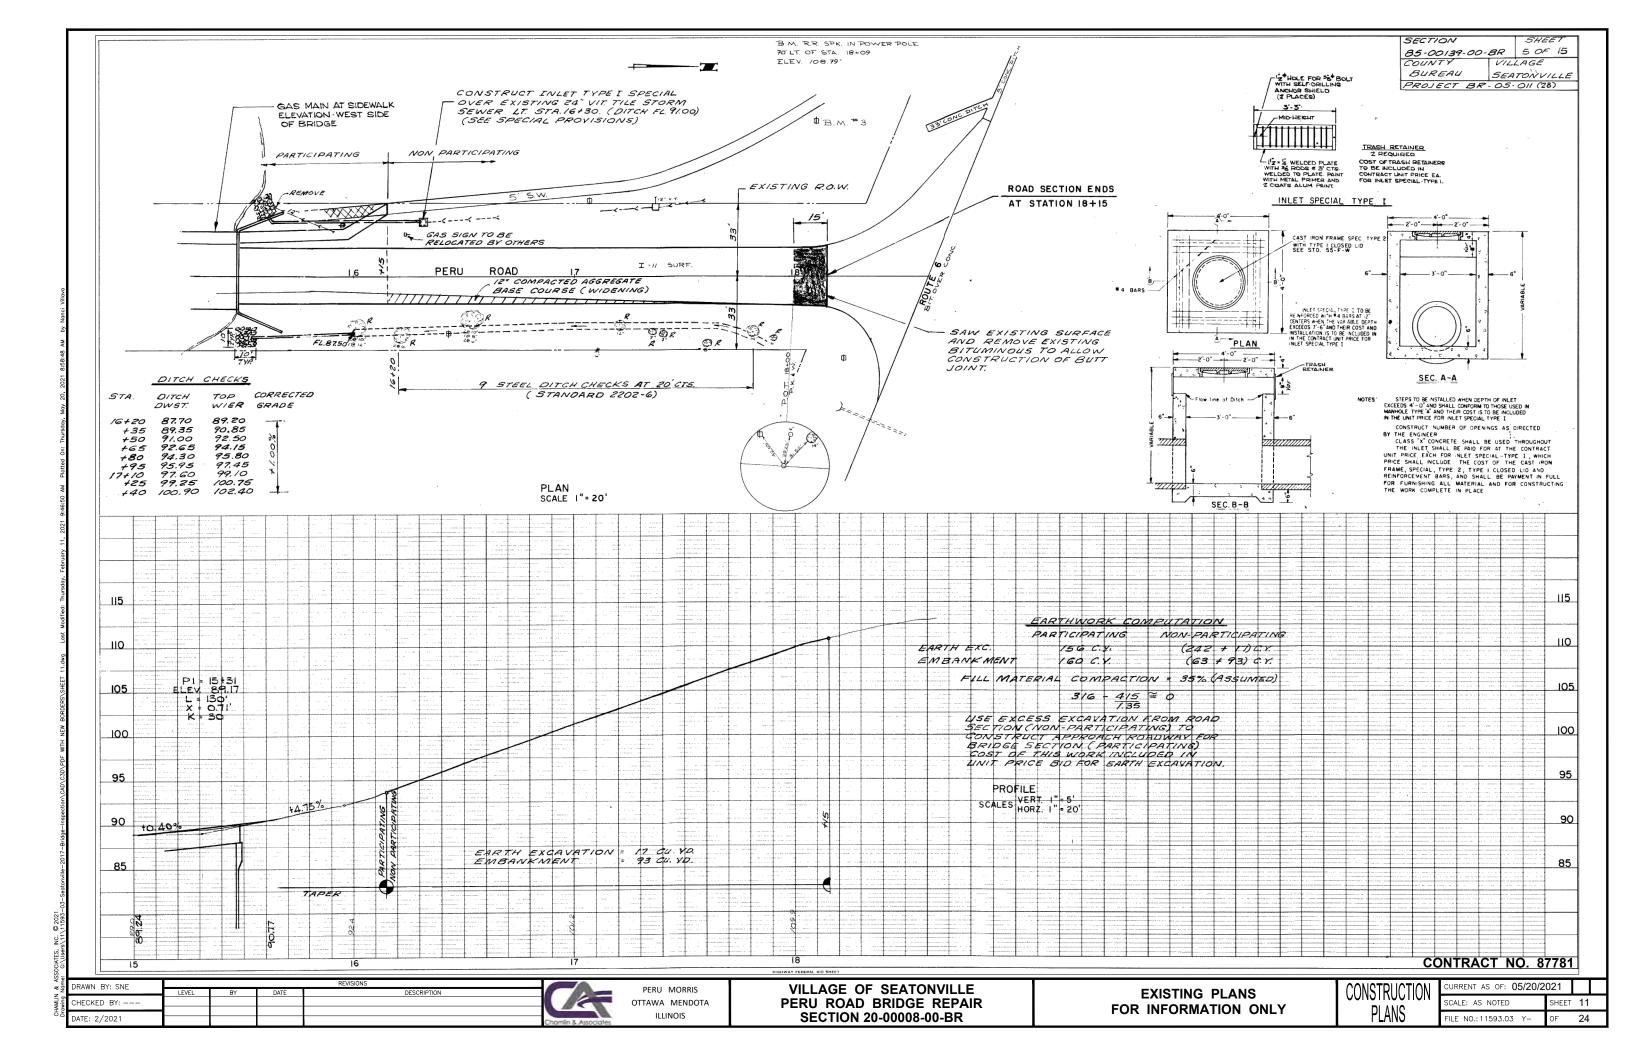

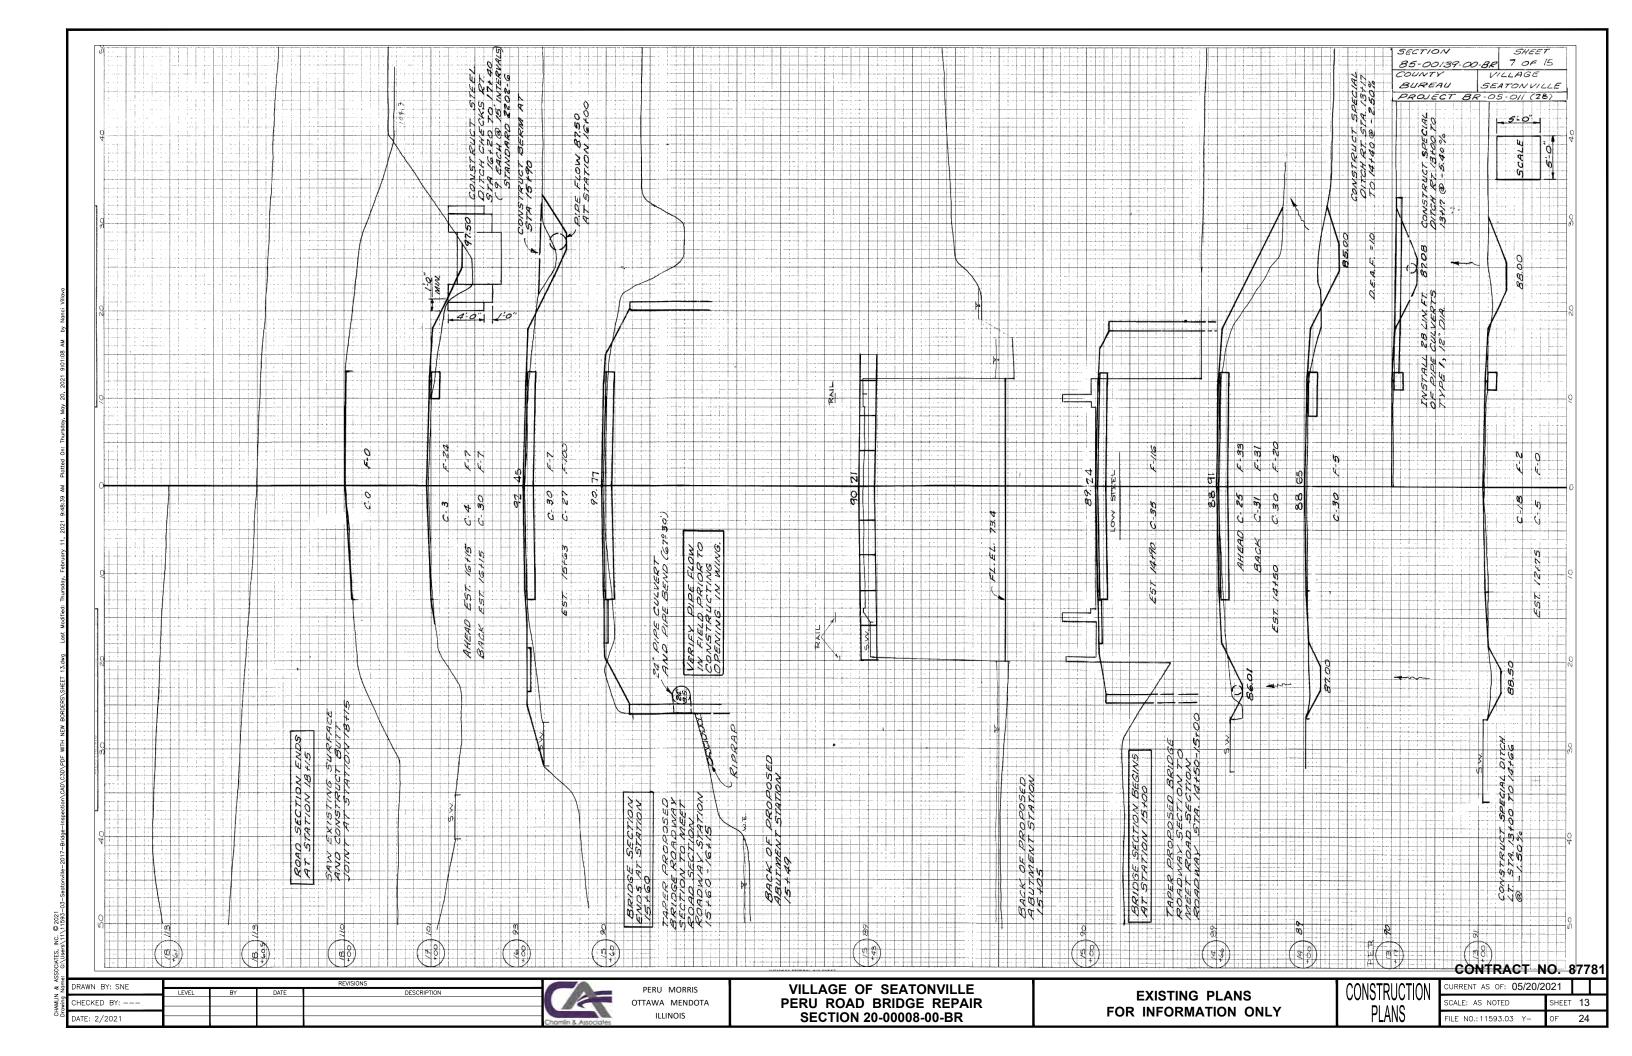


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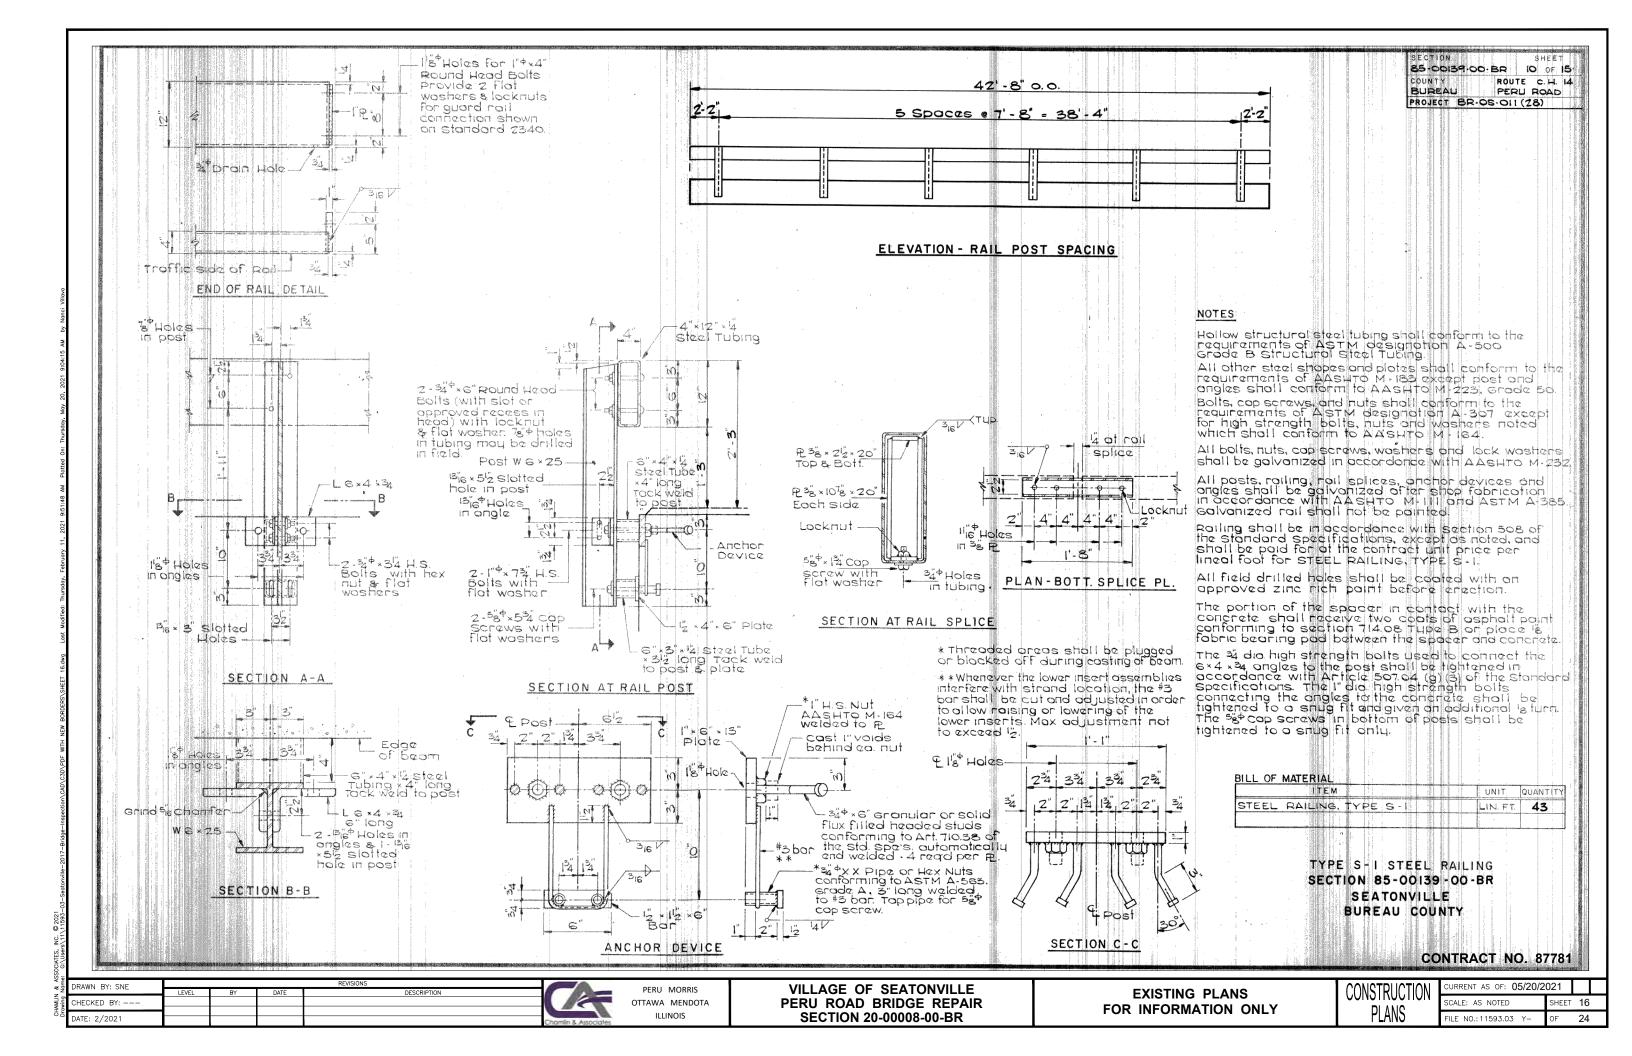
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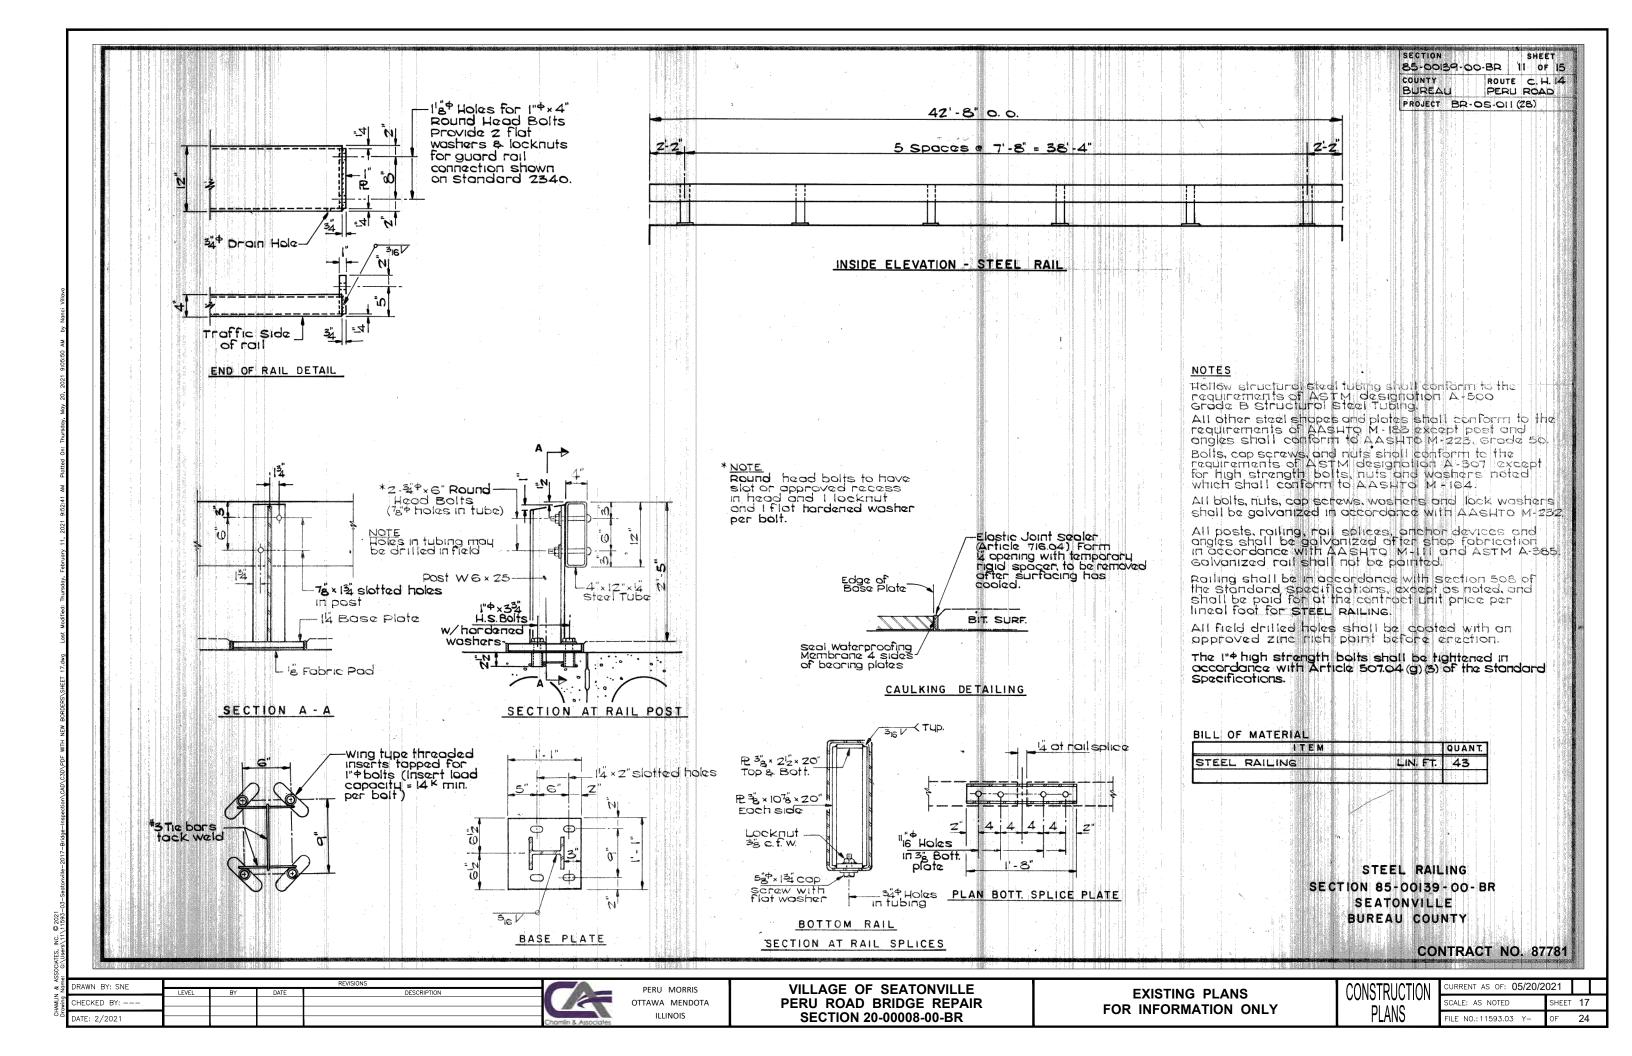
PERU ROAD BRIDGE REPAIR **SECTION 20-00008-00-BR**


FOR INFORMATION ONLY


SHEET **14** LE NO.: 11593.03 Y-24







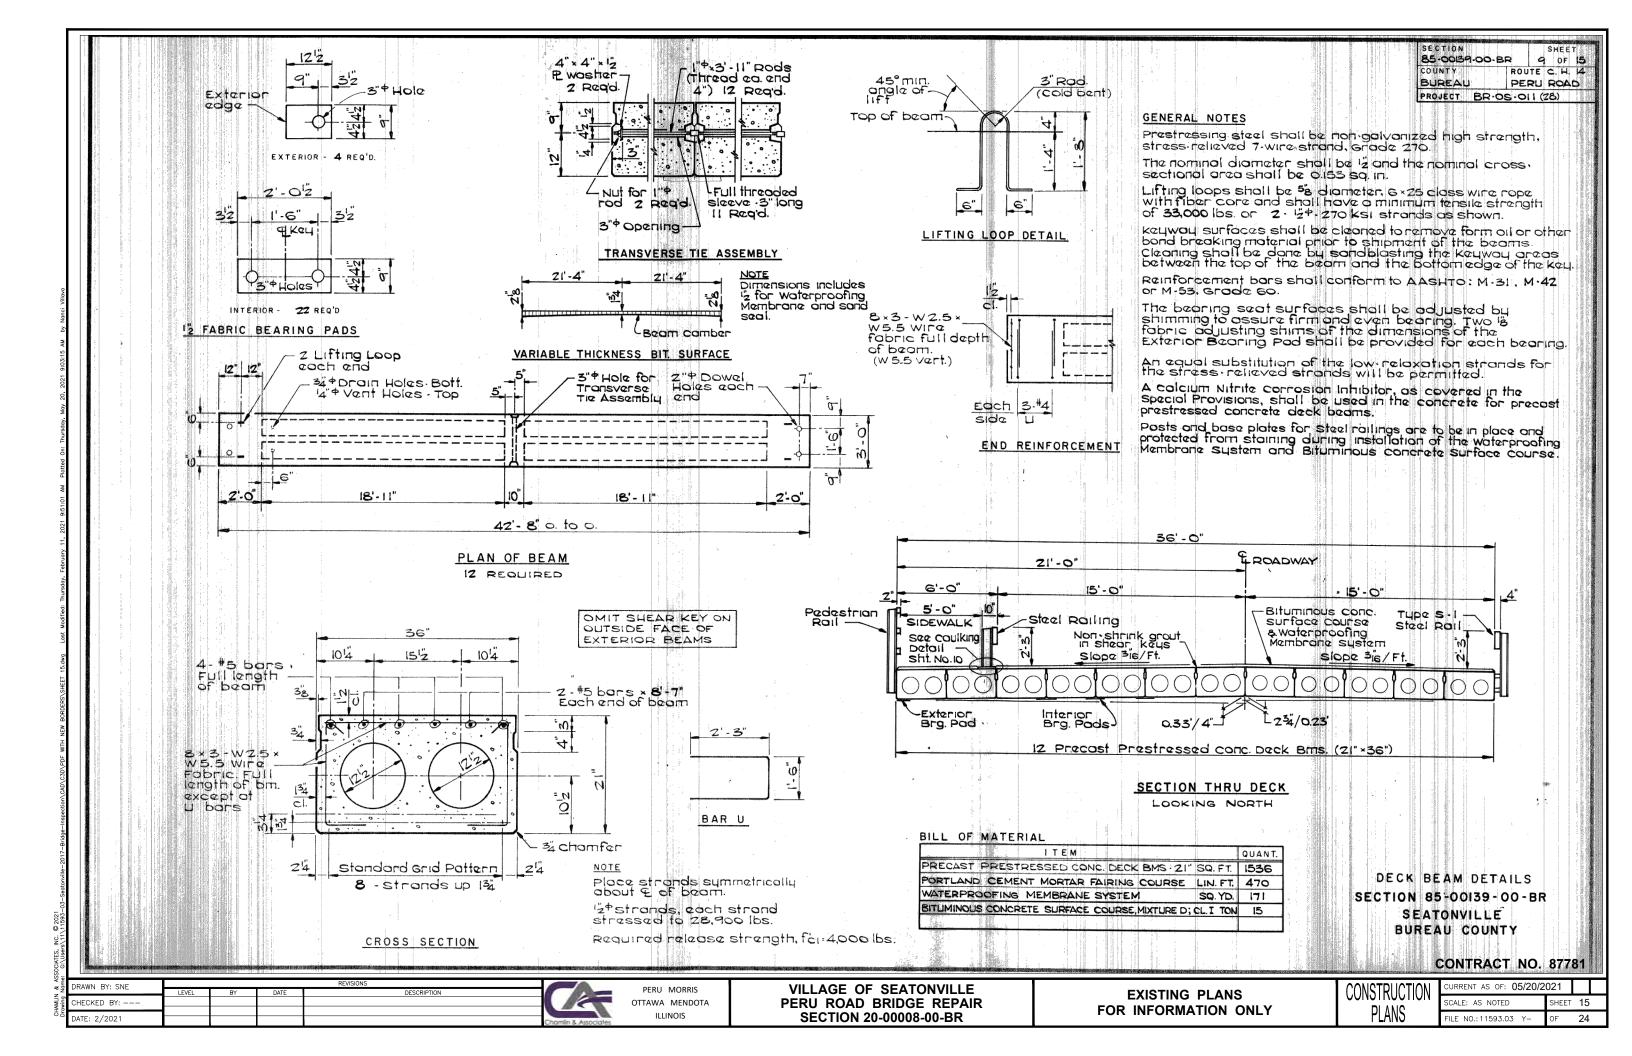

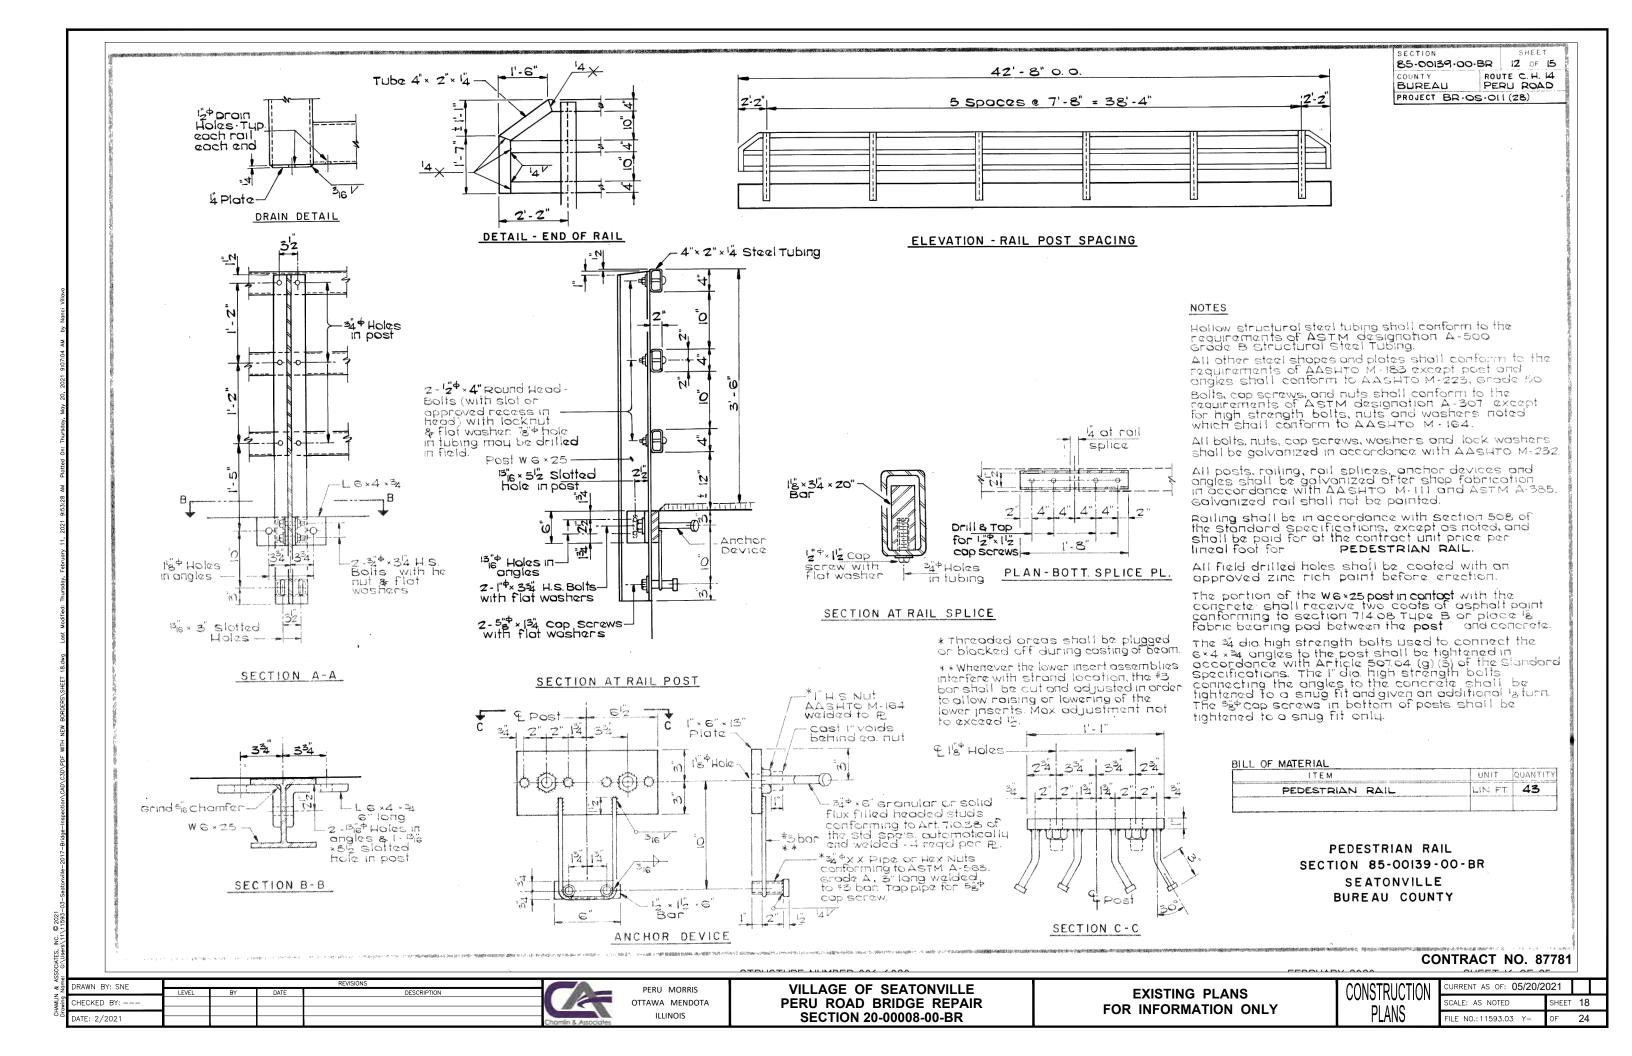

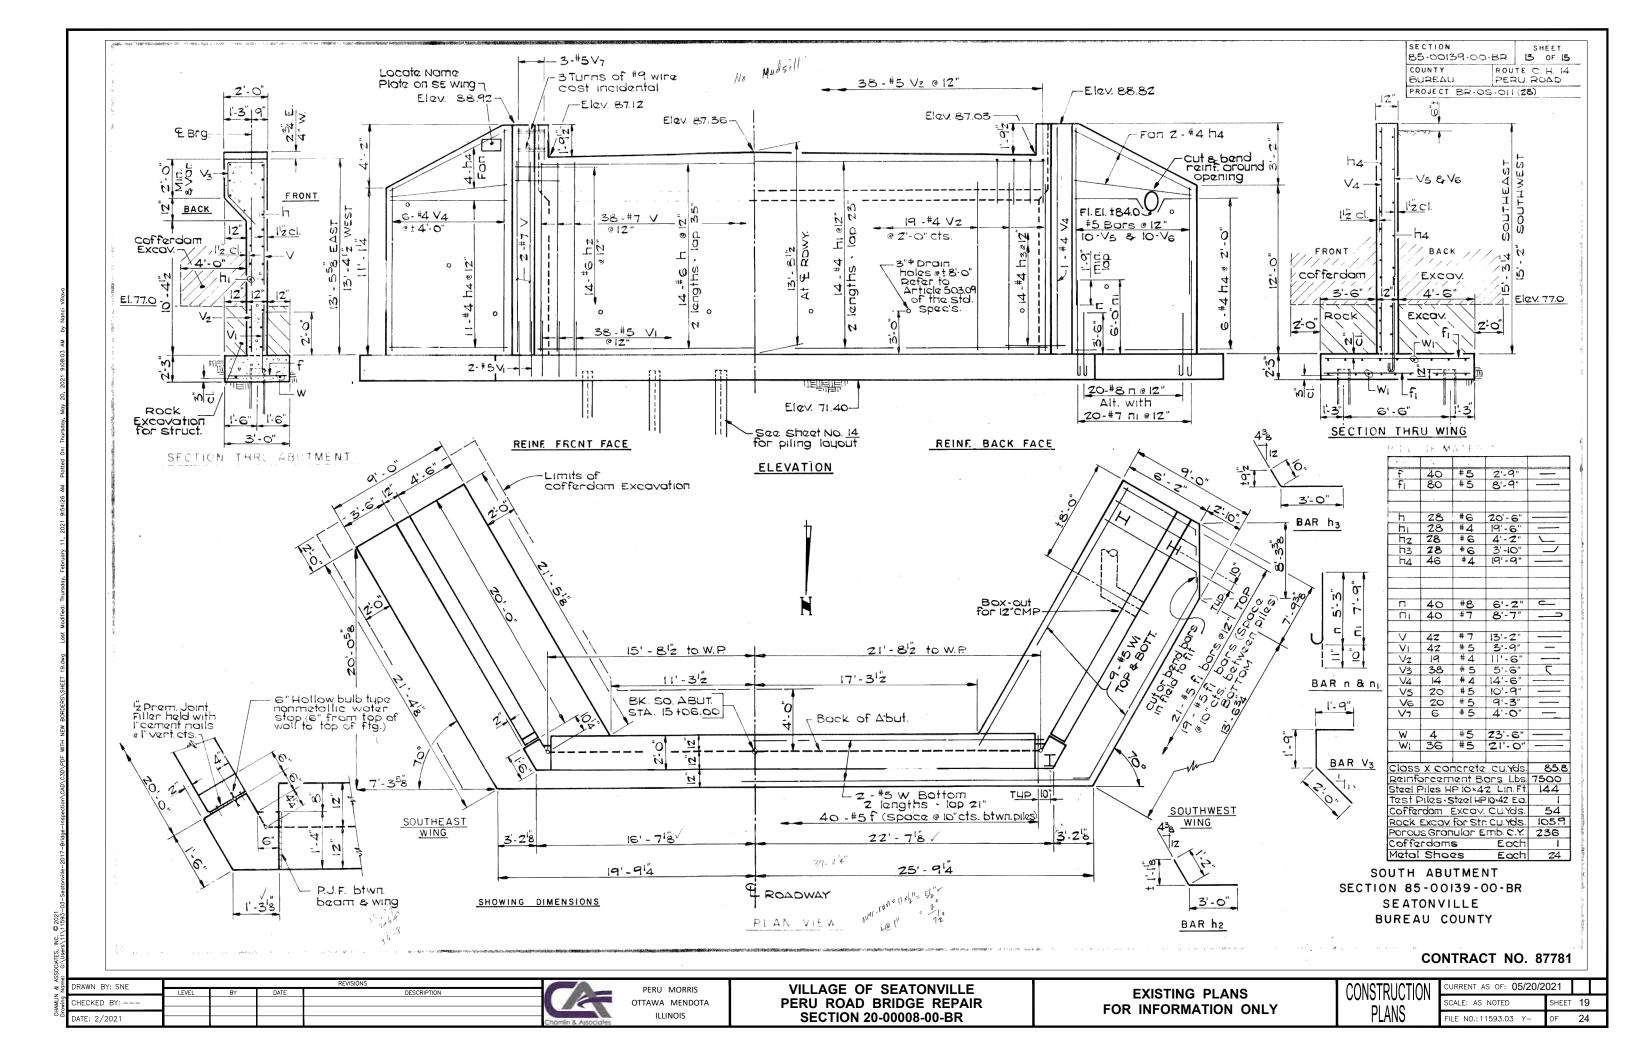

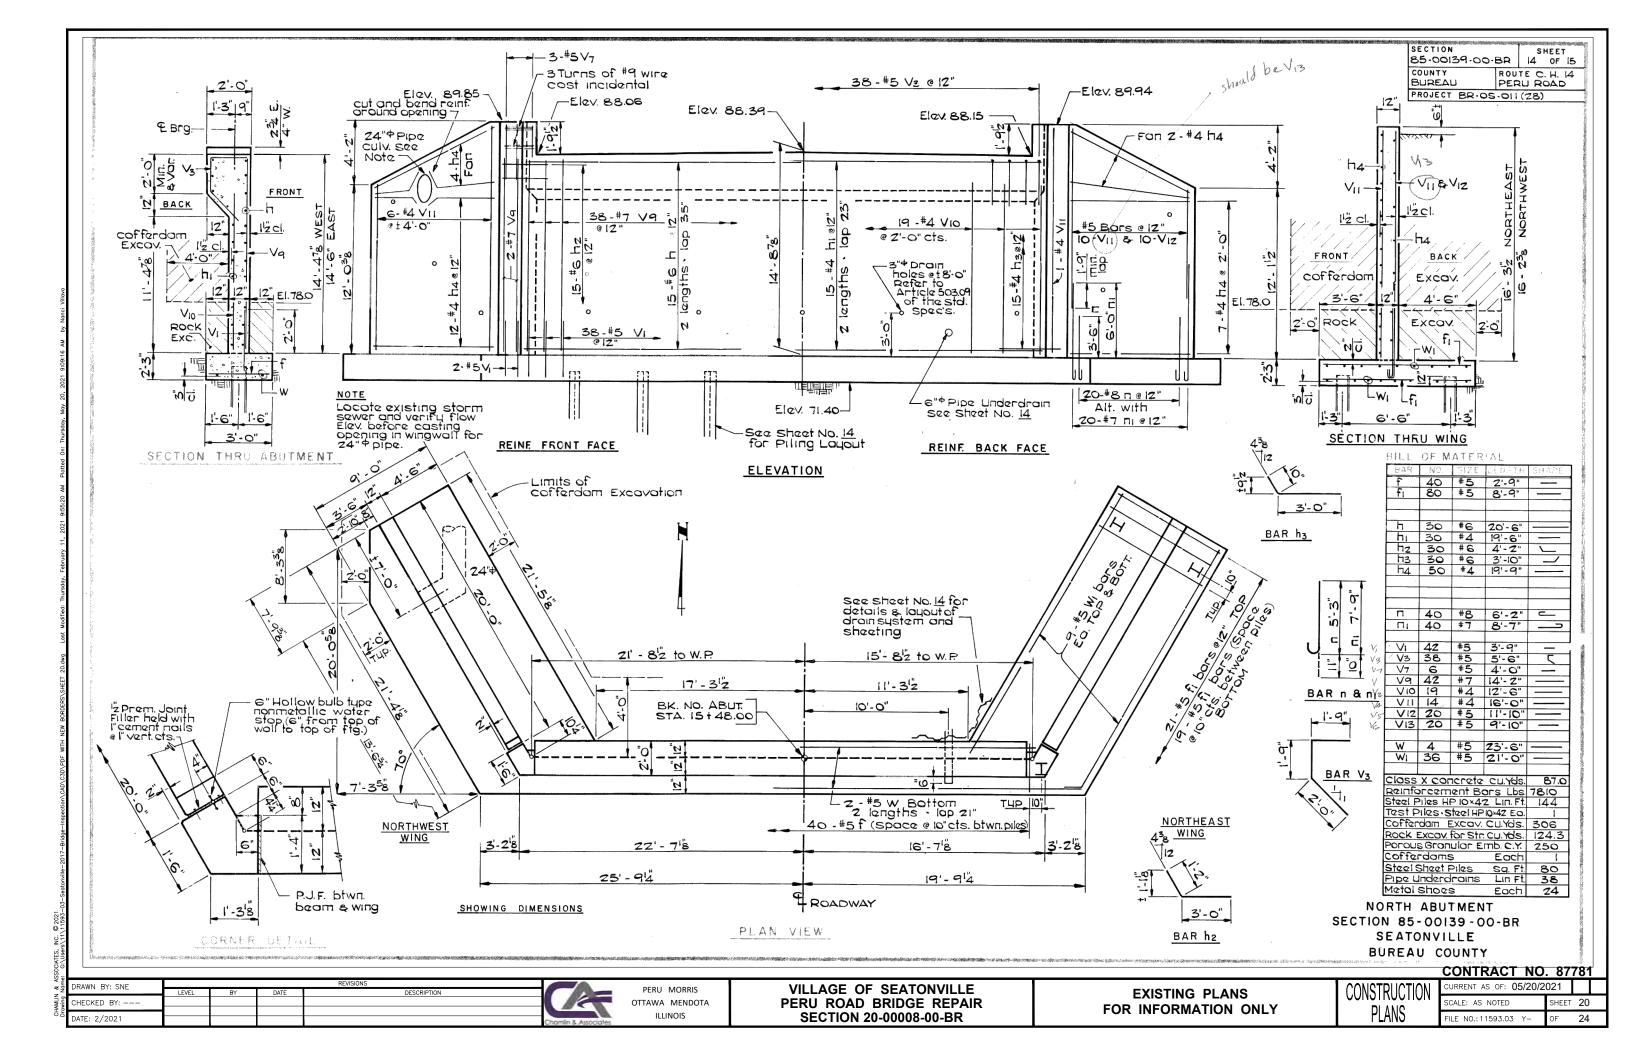

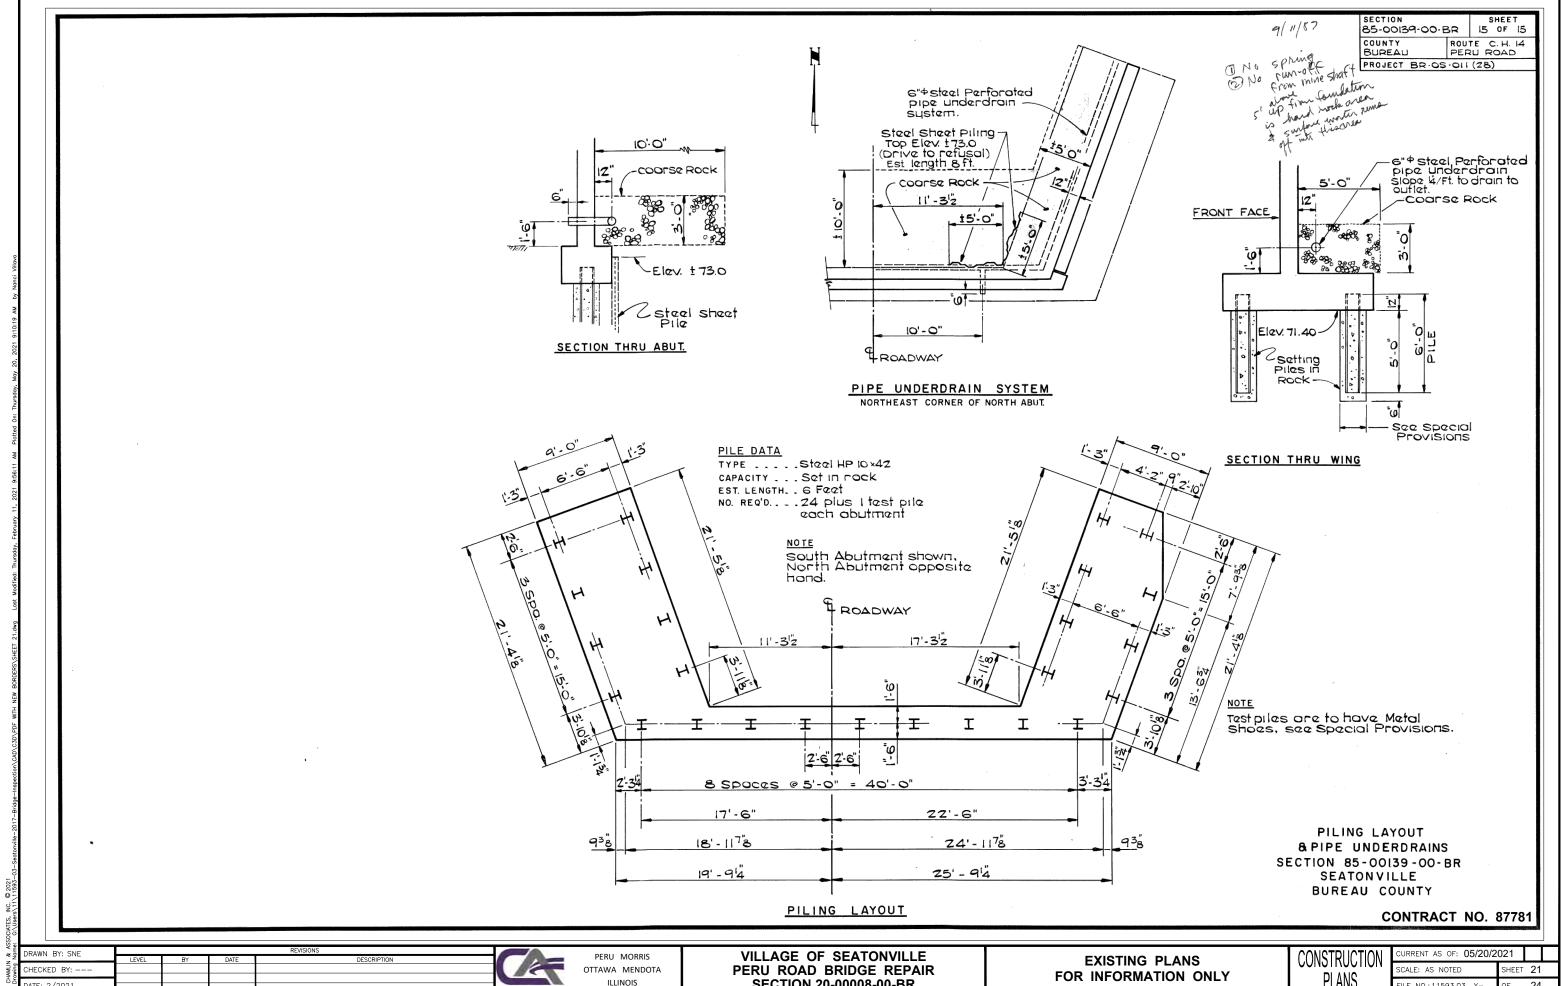


DATE: 2/2021

SECTION 20-00008-00-BR

FOR INFORMATION ONLY

TLE NO.: 11593.03 Y-

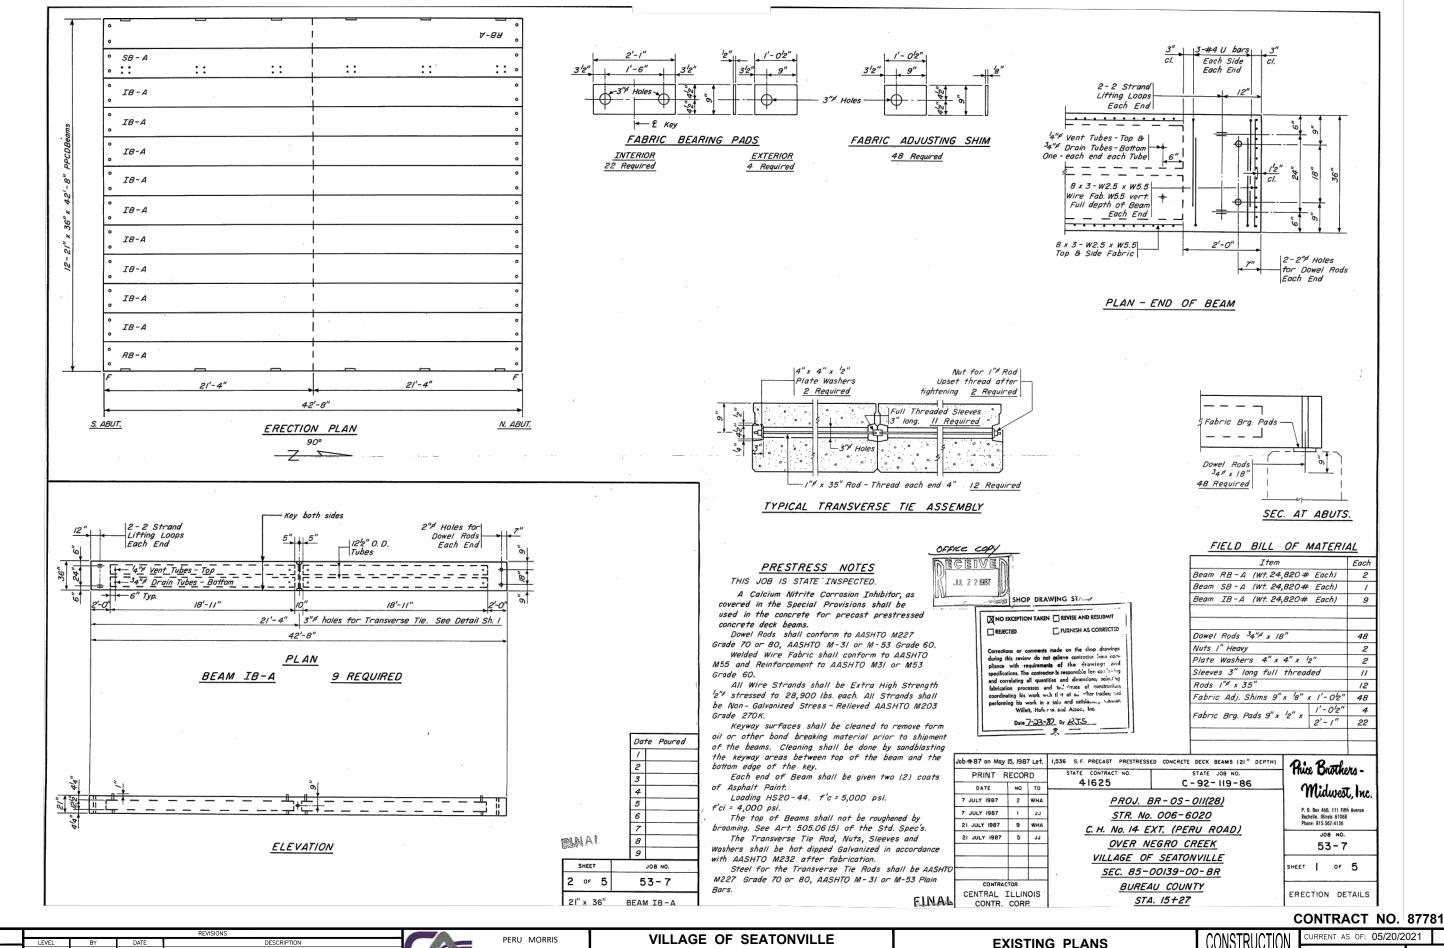

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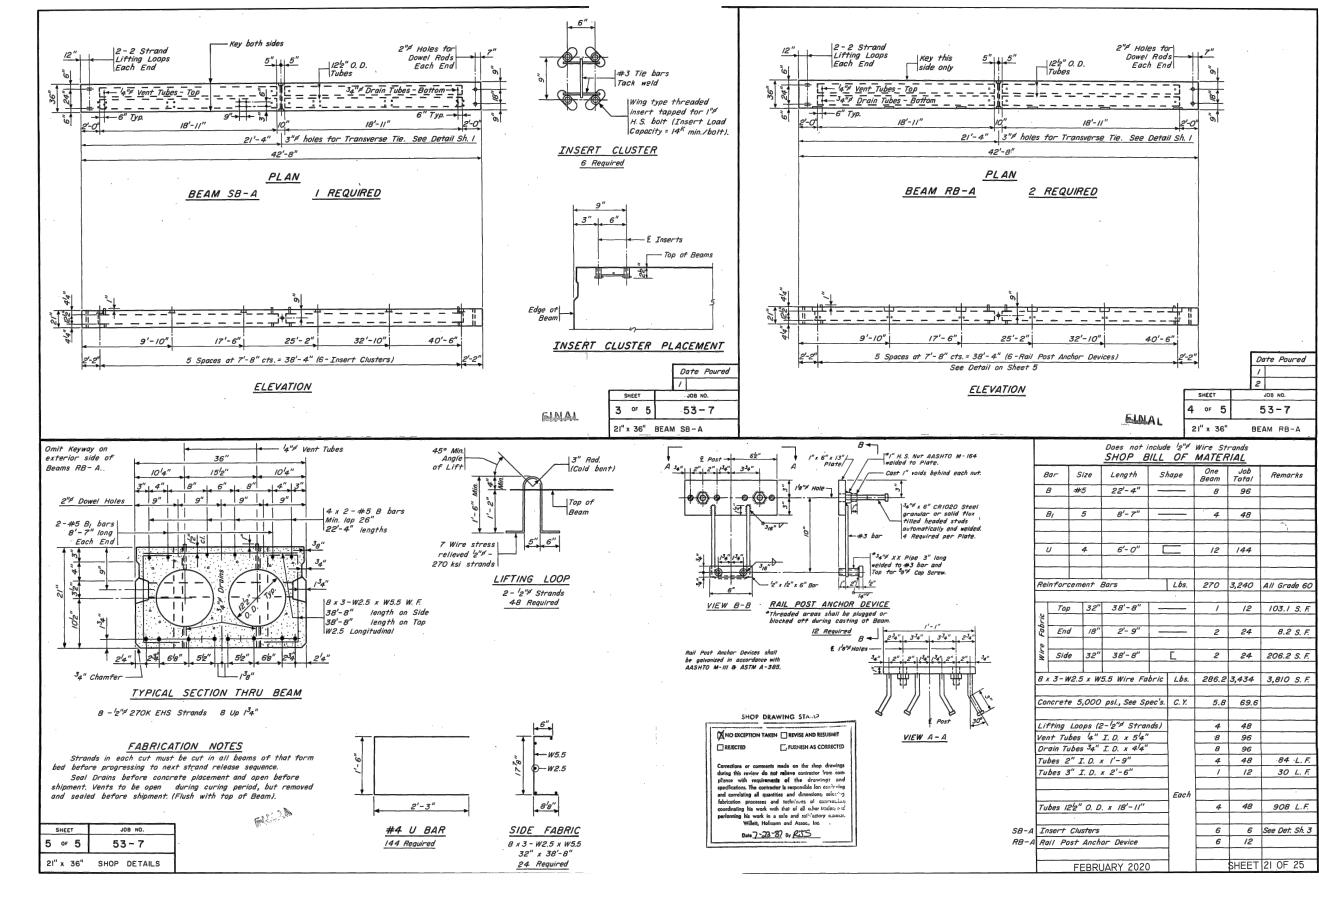
Chamlin & Associa

OTTAWA MENDOTA
ILLINOIS

PERU ROAD BRIDGE REPAIR SECTION 20-00008-00-BR EXISTING PLANS
FOR INFORMATION ONLY

CONSTRUCTION PLANS

CURRENT AS OF: 05/20/2021 SCALE: AS NOTED SHEET 22
FILE NO.:11593.03 Y- OF 24



CONTRACT NO. 87781

CURRENT AS OF: 05/20/2021 DRAWN BY: SNE PERU MORRIS VILLAGE OF SEATONVILLE **EXISTING PLANS** HECKED BY: -OTTAWA MENDOTA PERU ROAD BRIDGE REPAIR SCALE: AS NOTED SHEET **23** FOR INFORMATION ONLY ILLINOIS **SECTION 20-00008-00-BR** TLE NO.: 11593.03 Y-24 DATE: 2/2021

Project	Bridge _	CH.	14 F	eru Road	Da	ite	12-03-85	
Route C.H. 14 (Peru Road)		ov	er Ne	gro Creek	Во	ored By	G. Gentr	у.,
Sec85-00139-00-BR	STA	1.5	+ 27	'	cı	necked	Ву С. На	ge
County Bureau BC	ORING NO.	B-1	Stat	ion 14+90	O:	ffset	7'R	
Surface Water El. 78.0) Ground	dwater	E1. a	t Completion	Dry H	ole Aft	er Hour	s_
Ground Surface Deck 89.5	DEPTH N	Qu W	1%				DEPTH N	Ç
Loose Brown Silt w/gravel.			4	<u>Hard</u> gray	shale.		100	8
				451316 2014	Non Philo	65.		
Medium brown sandy silt	6	-7	—	END OF	BORING		25	
loam.	8 11	P 2	20		,			
84.5	-5							
Medium dirty brown sand	. 6		_ .				-	
and gravel.	- 8 - 12		6					
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Loose dirty brown sand and gravel.	- 6 3						<u>30</u>	
an glavol.	_ 3						_	
	10						_	
First Encounter Dense weathered 79.0	V 8 18							
limestone sand & gravel.	40	· · · · · · · · · · · · · · · · · · ·						
77.0	100						7F	
Hard Shale (Crumbly light gray) dry	100		3				35	
	PEN							
Hard shale (crumbly dark gr	ay 57							
dry)		, ,]	15				_	
	/ PEN		—				_	
Hard crumbly dry blue gray	30						40	
shale.	- 100 - 8" PEN	:	15					
			_				_	
Hard crumbly dry gray shale	100		14				_	
	— 8" — PEN	S					-	
			_					

Project	Bridge	on observe books	In-Ha	111-Township	Date	11-04-85	to discour
Route C.H. 14			over	Negro Creek	Bored	By G. Gent	ry
Sec 85-00139-00-BR····	STA		15 +	27 · · · · · · · · · · · · · · · · · · ·	Check	ed By C. H	age
County Bureau B	ORING NO.	B-2	St	tation 15 + 42	Offse	t 6' L	
Surface Water El. 78.	0 Groui	ndwate	r E1.	. at Completion 8	31:0 Af	ter Hour	s ·
	DEPTH N	Qu	W%	_		DEPTH N	Q
Ground Surface 90.0 Loose brown silt w/gravel.	<u> </u>	1	5	Hard dry gray	crumbly	shale. 100	18
	-		1			- 4" PEN	
Loose brown silt w/gravel.	- 2	.2	ļ			_	Τ
	_ 2 3	Е	7	Hard dry gray	y crumbly	25 100 3''	8
		T^-	一	END OF BORI	VC.	64.0 PEN	
Soft brown silt w/gravel.	5 2	.3	-	END OF BOKI			
84.0	-\ 3 5	P	15				
	-					678	
Medium dirty sand & gravel.	- 3 5		Π			30	
	6	ļ	<u> </u>			<u>30</u> —	
Dense dirty sand F grovel	10 7	<u> </u>		•			
Dense dirty sand & gravel. First Encounter	V 12	ĺ					
	_ 25					_	
78.0 Hard dry crumbly gray shale	100	 	 				
	— I'' — PEN		13			<u>35</u>	
	-					_	
Very stiff dry crumbly gray shale.	15 42 47	3.7 S	13			_	49
8-17 <u></u>	40	ļ.,	ļ			-	
Uand dur annu ammhlu ahal	- 72	6.0				'. -	
Hard dry, gray crumbly shal	100	6.0 S	13			<u>40</u>	
BH (8" PE		 			_	
Hard dry gray crumbly shale	20 100	8.7	\vdash			_	
	- 6" PEN	S	13				
	_	1				_	
	_						

SOIL BORINGS

CONTRACT NO. 87781

DRAWN BY: SNE PERU MORRIS OTTAWA MENDOTA ILLINOIS DATE: 2/2021

VILLAGE OF SEATONVILLE PERU ROAD BRIDGE REPAIR SECTION 20-00008-00-BR

CONSTRUCTION

CURRENT AS OF: 05/20/2021 SCALE: AS NOTED SHEET 24 FILE NO.: 11593.03 Y-24