

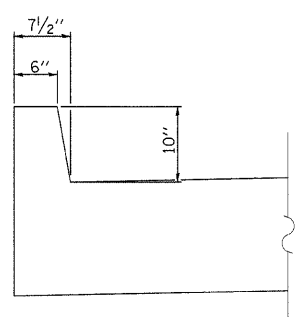


NOTE:

- BRIDGE APPROACH PAVEMENT WILL BE CONSTRUCTED IN ACCORDANCE WITH SECTION 420 OF THE STANDARD SPECIFICATIONS AND AS DETAILED ON THIS PLAN.
- PLAN DIMENSIONS AND ELEVATIONS PROVIDED ON THIS SHEET ARE SUBJECT TO CONSTRUCTION VARIATIONS. THE CONTRACTOR SHALL FIELD VERIFY THE EXISTING CONDITIONS AND ELEVATIONS, INCLUDING EXISTING GUARDRAIL POSTS, AND MAKE NECESSARY APPROVED ADJUSTMENTS PRIOR TO CONSTRUCTION.
- SEE STANDARD 421001-02 FOR REINFORCEMENT DETAILS NOT SHOWN.
- SEE STANDARD 420401-06 FOR OTHER DETAILS NOT SHOWN.
- DIMENSIONS AND ELEVATIONS OF BRIDGE APPROACH CONNECTOR PAVEMENT (NOT SHOWN) SHALL MATCH EXISTING PAVEMENT CROSS SECTION.

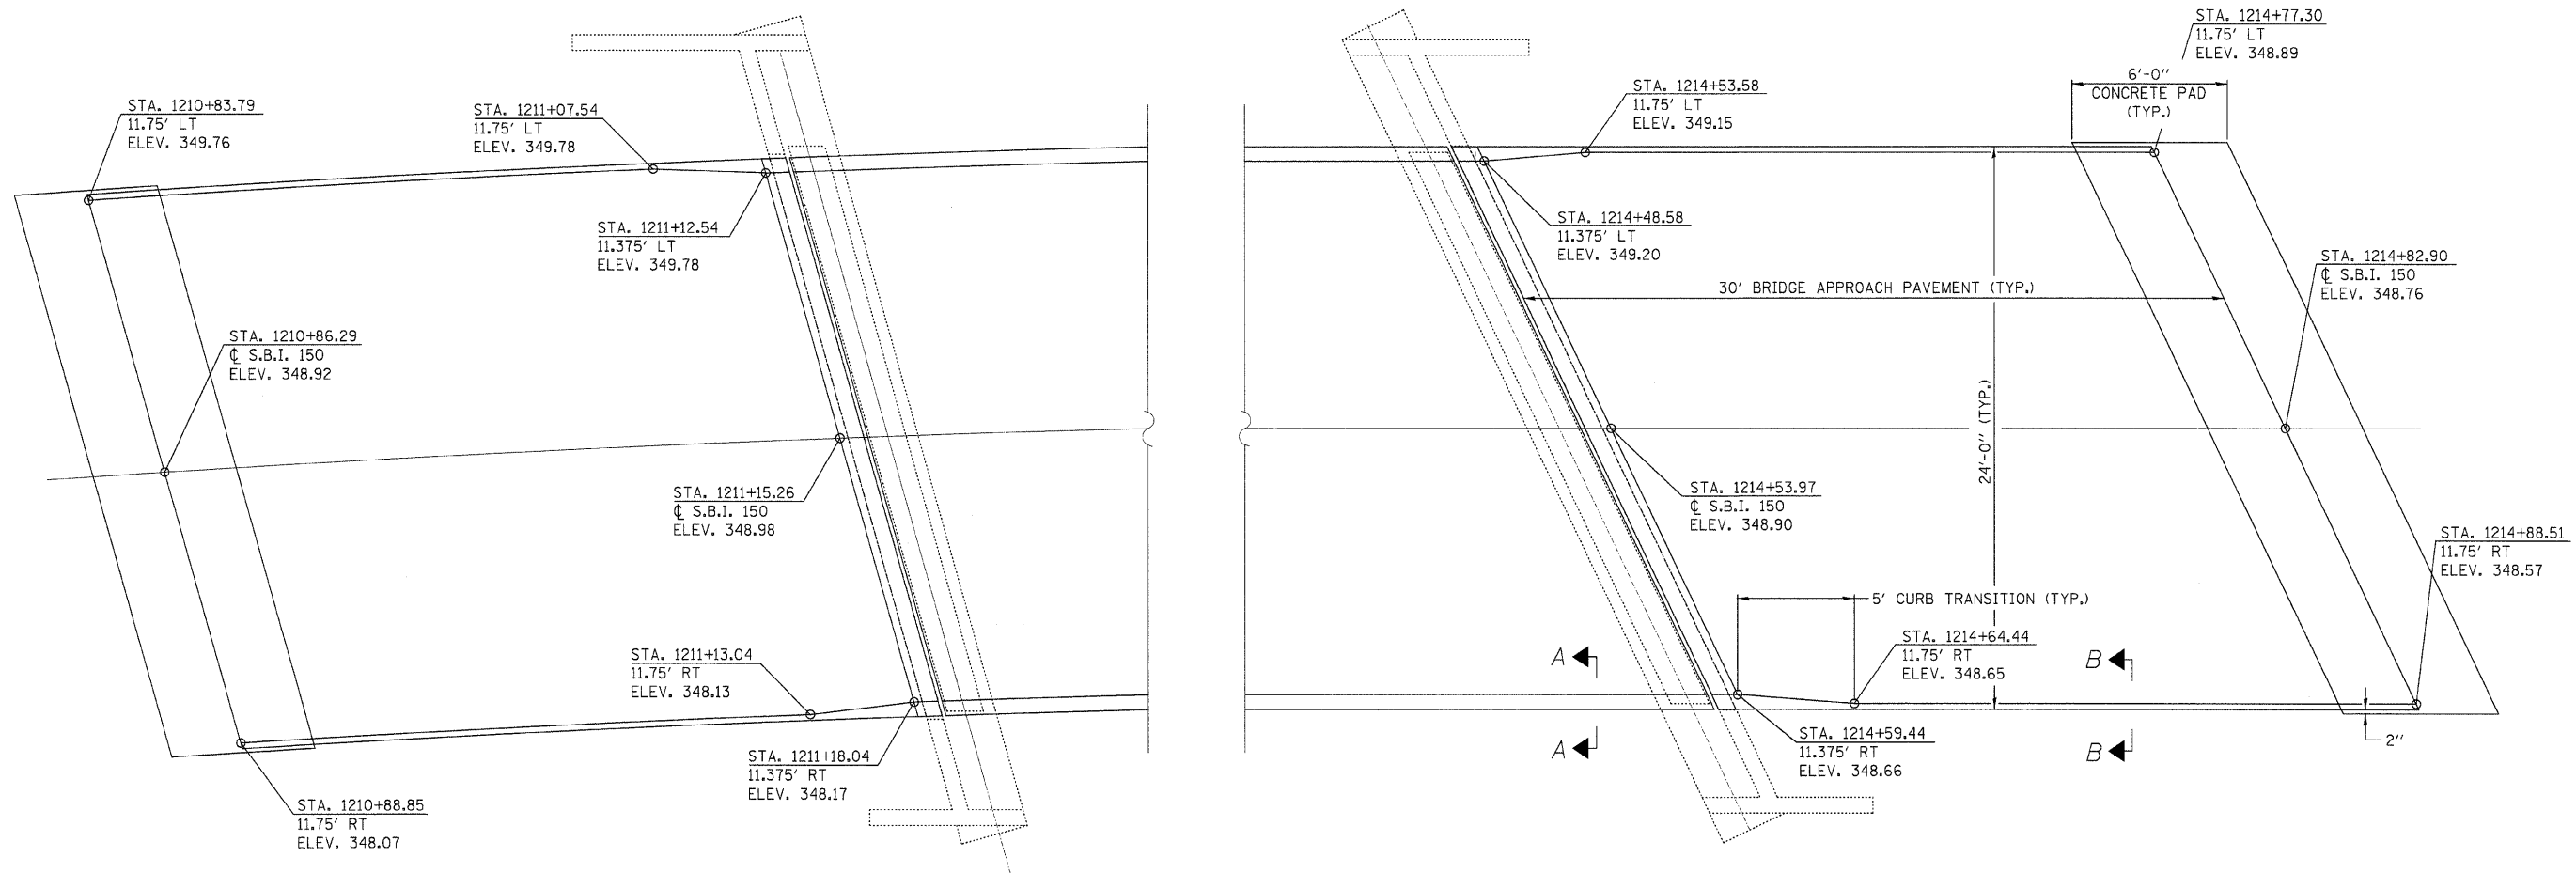

SECTION A-A

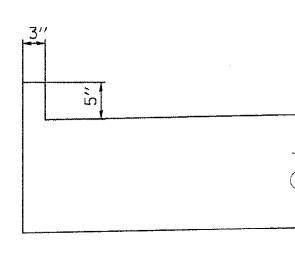

SECTION B-B

FILE NAME = ...Roadway\Sheets\Bridge appr.dgn	USER NAME = Plotted by Administrator	DESIGNED - KHH	REVISED - ----	STATE OF ILLINOIS DEPARTMENT OF TRANSPORTATION	BRIDGE APPROACH PAVEMENT DETAIL OLD IL ROUTE 3 OVER SEXTON CREEK			S.B.I. RTE. 150	SECTION (133A)D, I	COUNTY ALEXANDER	TOTAL SHEETS 32	SHEET NO. 32
PLOT SCALE = 1/8" = 1' IN.	CHECKED - FML	REVISED - ----	SCALE: N.T.S.		SHEET NO. ___ OF ___ SHEETS	STA. _____ TO STA. _____	FED. ROAD DIST. NO. _ ILLINOIS FED. AID PROJECT					
PLOT DATE = 4/16/2009	DATE - 11/2008	REVISED - ----	CONTRACT NO. 98910									